

Inspections copy  
2x6 Ext. Fl Garage Walls



# House Plan Zone, LLC.

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### STANDARD ABBREVIATIONS

AT	ATTACHMENT	LN	LIGHT
APPROX	APPROXIMATELY	LN	LINEN
BASE	BASEMENT	MANUF	MANUFACTURER
BT	BETWEEN	MAS	MASONRY
BLK	BLOCK	MAX	MAXIMUM
BLDG	BLOCKING	MTL	METAL
BD	BOARD	MIN	MINIMUM
BRD	BOARD	N.T.C.	NOT IN CONTRACT
BTM	BOTTOM	O.C.	ON CENTER
BLDG.	BUILDING	O.C.	ON CENTER
CAB	CABINET	O.S.B.	ORIENTED STRAND BOARD
CLS	CEILING	OTS	OWNER TO SELECT
CLR	CLEAR	O.T.S.	OWNER TO SELECT
CLS	CLOSET	Pg.	PAGE
COL	COLUMN	PAN	PANTRY
CLS	COLUMNS	PL	PLATE
CONC	CONCRETE	P	PLYWOOD
CMU	CONCRETE MASONRY UNIT	PLYD	PLYWOOD
C.U.	CONDENSOR UNIT	POLY	POLYETHYLENE
CONN	CONNECTION	PSI	POUNDS PER SQUARE INCH
CONT	CONTINUOUS	PRE-FAB	PRE-FABRICATED
COVERG	COVERING	REF	REFRIGERATOR
CS	CRACK SPACE	REIN	REINFORCED
DECO	DECORATIVE	R	RESISTANCE
DIAM	DIAMETER	R.A.	RETURN AIR
DM	DISHWASHER	R.A.G.	RETURN AIR GRILLE
DBL	DOUBLE	REQD	REQUIRED
DF	DOUGLAS FIR	SCR	SCREEN
D	DRYER	SHLV	SHELVES
EACH	EACH	SHR	SHOWER
ELEV	ELEVATION	SHWR	SHOWER
ENG.	ENGINEER	SST	SIMPSON STRONG TIE
FT.	FEET	SF	SQUARE FEET
F.F.L.	FINISHED FLOOR LINE	SPECS	SPECIFICATIONS
FIN	FINISH	SQ	SQUARE
F.C.	FIRE CODE	S.F.	SQUARE FOOTAGE
F.L.	FLOOR	STL	STEEL
FTG	FOOTING	THK	THICK
FOUND.	FOUNDATION	THK	THICKNESS
FND	FOUNDATION	TBD	TO BE DETERMINED
FR	FREEZER	TR	TRANSOM
GA	GAUGE	TYP	TYPICAL
GALV.	GALVANIZED	U.T.C.	UNDER THE COUNTER
GYP.	GYPSUM	UTIL	UTILITY
HDR	HEADER	VAN	VANITY
HVAC	HEATING VENTILATION & AIR CONDITIONING	VERT.	VERTICAL
HT	HEIGHT	WH	WATER HEATER
HTS	HEIGHTS	W	WASHER
HORIZ	HORIZONTAL	WT	WEIGHT
IN	INCHES	WIN	WINDOW
INCL	INCLUDE	WM	WIRE MESH
INSUL	INSULATION	W	WIRE
JT	JOINT	W.D.	WOOD
JOIST	JOIST	W.F.M.	WOOD FRAME
JOISTS	JOISTS		CONSTRUCTION MANUAL



### SHEET INDEX:

- 1 COVER SHEET
- 2 FOUNDATION PLAN
- 3 FLOOR PLANS
- 4 EXTERIOR VIEWS
- 5 EXTERIOR VIEWS
- 6 CROSS SECTION & CABINETS
- 7 ROOF PLAN
- 8 ELECTRICAL PLAN

MB Shower - Tile w/ 2' Niche  
 Roofing - 30yr Reck ~ Dark-wood  
 Siding - Vinyl ~ Mystic Blue, 8ft 8" Ceeding Shingle  
 Fireplace - Standard Ventless Gas, Marble ~ Walnut - No Mantel  
 4" Gas Box w/ Tube above Fireplace  
 Carpet - Secondary Beams ~ Marbles LVP ~ Coppertone MB Elements  
 Paint -  
 H.B. Tray

## BB-2086


**CODE DISCLAIMER:**  
 1. THESE PLANS WERE DESIGNED TO MEET IRC 2015 AT THE TIME OF THEIR CREATION AND MORE SPECIFICALLY THE MINIMAL LOCAL CODES OF THE SOUTH MISSISSIPPI AREA. IT IS HIGHLY RECOMMENDED THAT THESE PLANS BE REVIEWED BY A LOCAL STRUCTURAL ENGINEER PRIOR TO CONSTRUCTION.  
 2. BEAMS AND FLOOR JOISTS ARE NOT SIZED DUE TO THE MANY GEOGRAPHIC LOCATIONS THESE PLANS ARE SOLD. THESE ITEMS SHALL BE SIZED BY A LOCAL ENGINEER OR MANUFACTURER.  
 3. ALL CEILING & FLOOR JOISTS (IF CONVENTIONAL FRAMING) SHOULD BE SIZED USING THE LATEST VERSION OF THE IRC OR APPLICABLE CODES AT SITE TO MEET THE LOCAL REQUIREMENTS SUCH AS SNOW LOADS AND OTHER FACTORS. THE CEILING JOISTS SIZES LABELED (IF PRESENT) WERE SIZED USING THE 2015 IRC AT THE TIME OF THEIR CREATION. THEY MUST BE VERIFIED AND MODIFIED AS REQUIRED TO MEET THE LATEST EDITION OF THE (IRC) INTERNATIONAL RESIDENTIAL CODE.  
 4. ALL FOUNDATIONS AND FOOTING DETAILS SHALL BE REVIEWED AND APPROVED BY A LOCAL ENGINEER.  
 5. CONTRACTOR SHALL PROVIDE ALL HIGH WIND STRAPPING AND ANCHOR BOLTS AS REQUIRED BY THE LOCAL CODE REQUIREMENTS AND THE LATEST VERSION OF THE IRC.

# A | B D | D

HARNETT COUNTY CENTRAL PERMITTING  
 APPLICATION # BB-2086-1090  
 JOB NAME: 21011  
 DATE PLANS RECEIVED: 2/11/2021  
 SITE PLANS APPROVED: 8/22/2021  
 APPROVED BY: [Signature]

NOTICE TO CONTRACTOR  
 All construction must comply with current local building codes and is subject to local inspection and verification.

APPROVED  
 Limited building only review  
 Permit holder responsible for full compliance with the code

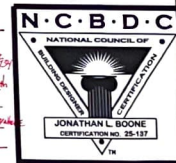

Date: 05.24.18  
 Drawn By: J.A.B.

SHEET NUMBER

# 1

69491 HWY 89 Lake Forest Trail

W4115

A



B

D



69491 AM

B4

HARNETT COUNTY CENTRAL PERMITTING  
APPLICATION # 21FD2102-0090  
JOB NAME S<sup>2</sup>R  
DATE PLANS RECEIVED 2/19/2021  
SITE PLANS APPROVED 3-22-2021  
APPROVED BY BSW

NOTICE TO CONTRACTOR  
All construction must comply with current NC Building Codes and is subject to field inspection and verification.

89 Lake forest Trail



SHEET INDEX:

- COVER SHEET
- FOUNDATION PLAN
- FLOOR PLANS
- EXTERIOR VIEWS
- EXTERIOR VIEWS
- CROSS SECTION & CABINETS
- ROOF PLAN
- ELECTRICAL PLAN

**APPROVED**

Limited building only review  
Permit holder responsible for full compliance with the code



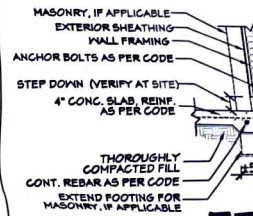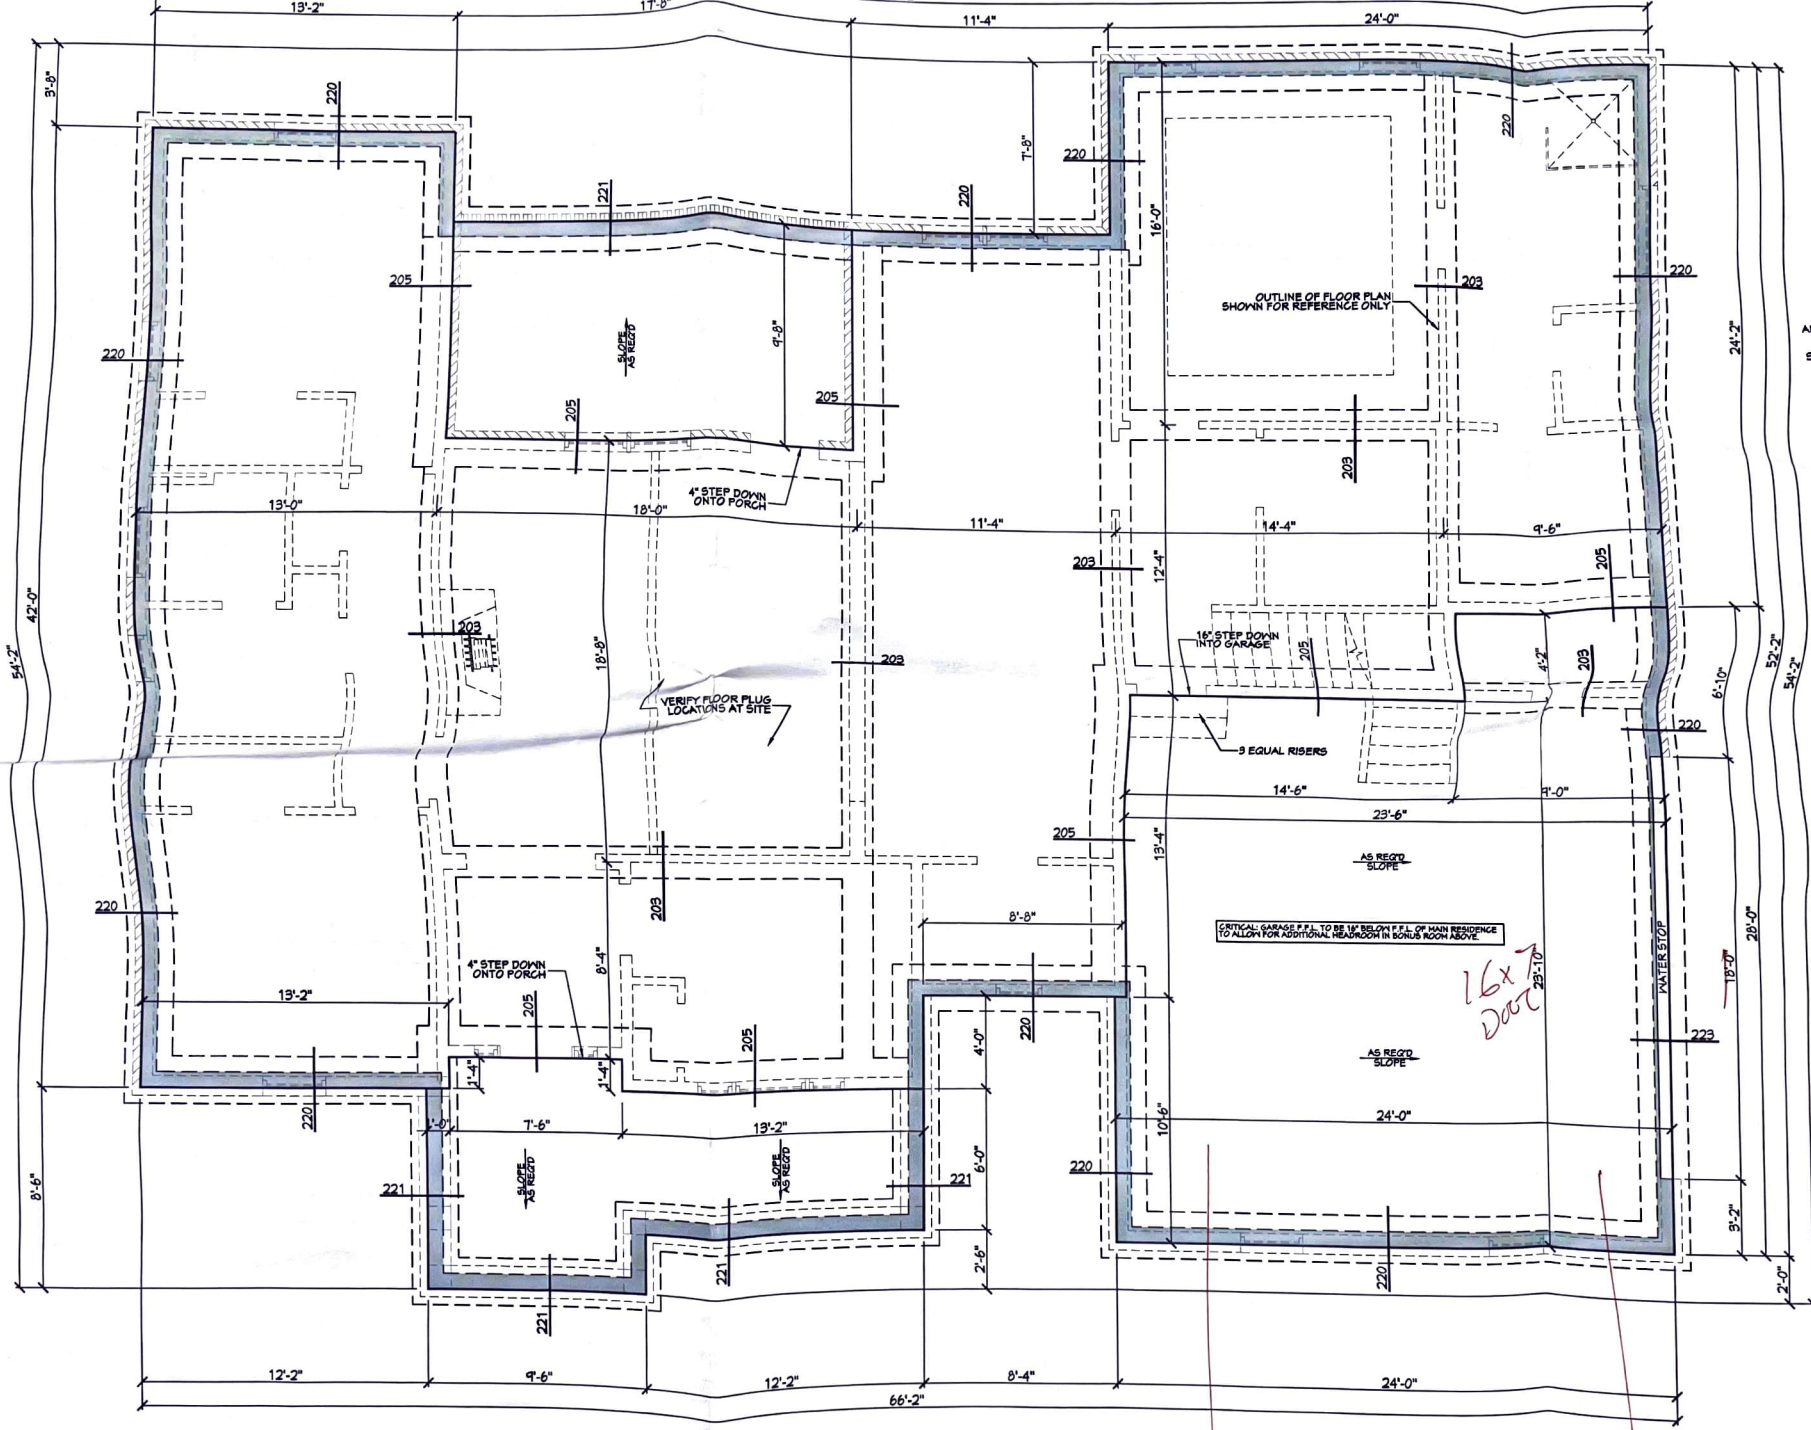

205



221

**SLAB**


1. ALL F...
2. CONT...
3. CONT...
4. CONT...
5. CONC...

**201 FOUNDATION PLAN**  
SCALE 1/4" = 1'-0"

*Front  
Road  
Door*

*16x7  
200c*

**CRITICAL GARAGE F.F.L. TO BE 18" BELOW F.F.L. OF MAIN RESIDENCE TO ALLOW FOR ADDITIONAL HEADROOM IN BOULDER ROOM ABOVE.**

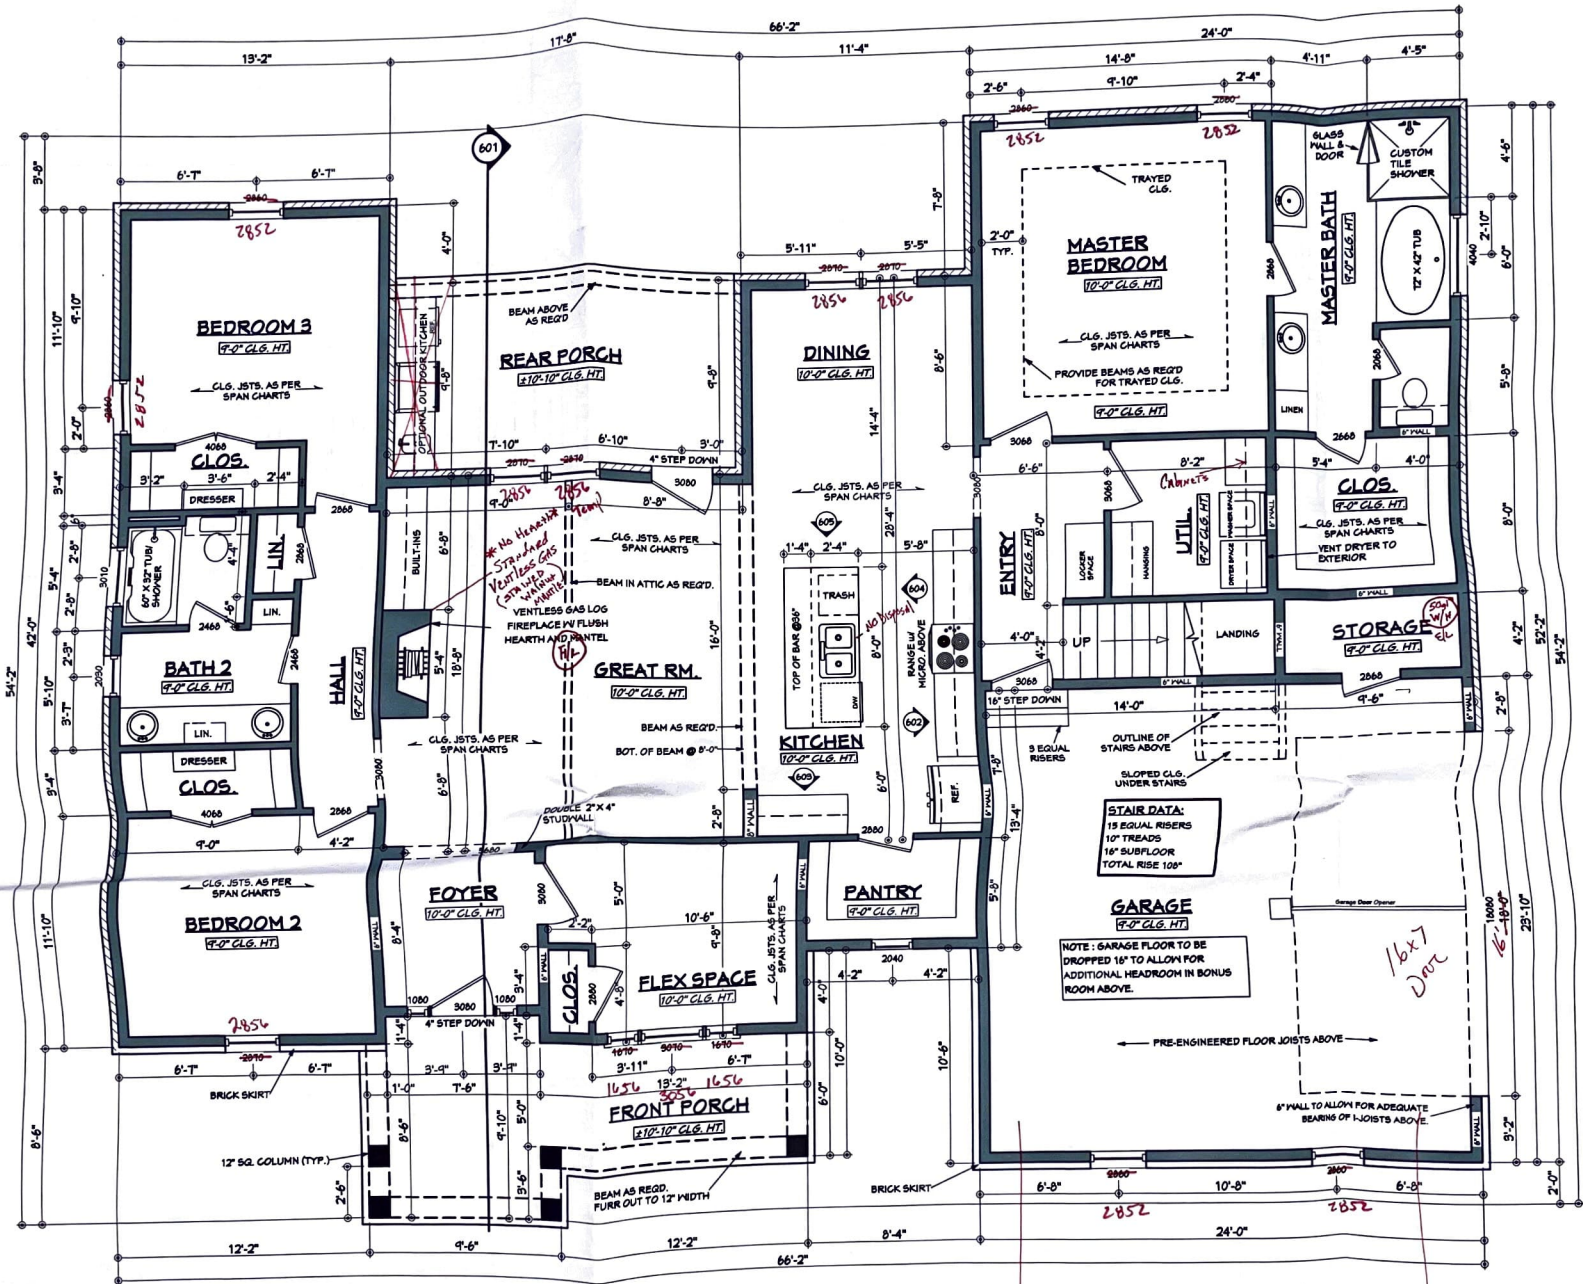

ALL EXTERIOR WALLS AND ALL WALLS AROUND THE PERIMETER OF THE HEATED AREA SHALL BE 2X6 CONSTRUCTION.

NOTES: CONTRACTOR SHALL LOCATE WATER HEATER & HVAC @ SITE.

# BB-2086 FLOOR PLAN

SCALE: 1/4" = 1'-0"

AREAS:	S.F. HEATED - NOT INCLUDING MASONRY
2090	S.F. UNHEATED - BONUS ROOM
395	S.F. UNHEATED - FRONT PORCH
164	S.F. UNHEATED - GARAGE
565	S.F. UNHEATED - STORAGE
30	S.F. UNHEATED - REAR PORCH
171	S.F. TOTAL UNHEATED
1333	S.F. TOTAL UNDER ROOF
3423	S.F. TOTAL MASONRY NOT INCLUDED**


Front  
10ae1

NO  
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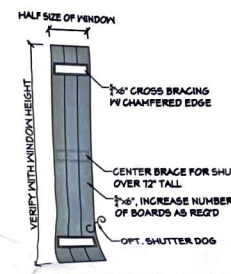


**EXTERIOR ELEVATION NOTES:**


1. CONTRACTOR TO VERIFY ALL WINDOW AND DOOR STYL AND SIZES WITH OWNER PRIOR TO CONSTRUCTION.
2. PROVIDE STEPS AND GUARD RAILS AS PER CODE BASE SITE CONDITIONS.
3. GROUND LINES SHOWN FOR REFERENCE ONLY AND VA DEPENDING ON SITE CONDITIONS.
4. ALL FINISH MATERIALS TO BE VERIFIED WITH OWNER P TO CONSTRUCTION.
5. REFER TO TYPICAL WALL DETAIL FOR FRAMING METHC AND OTHER MISC. INFORMATION.
6. CONTRACTOR TO PROVIDE ADEQUATE ROOF VENTILA AS REQ'D BY CURRENT CODES.

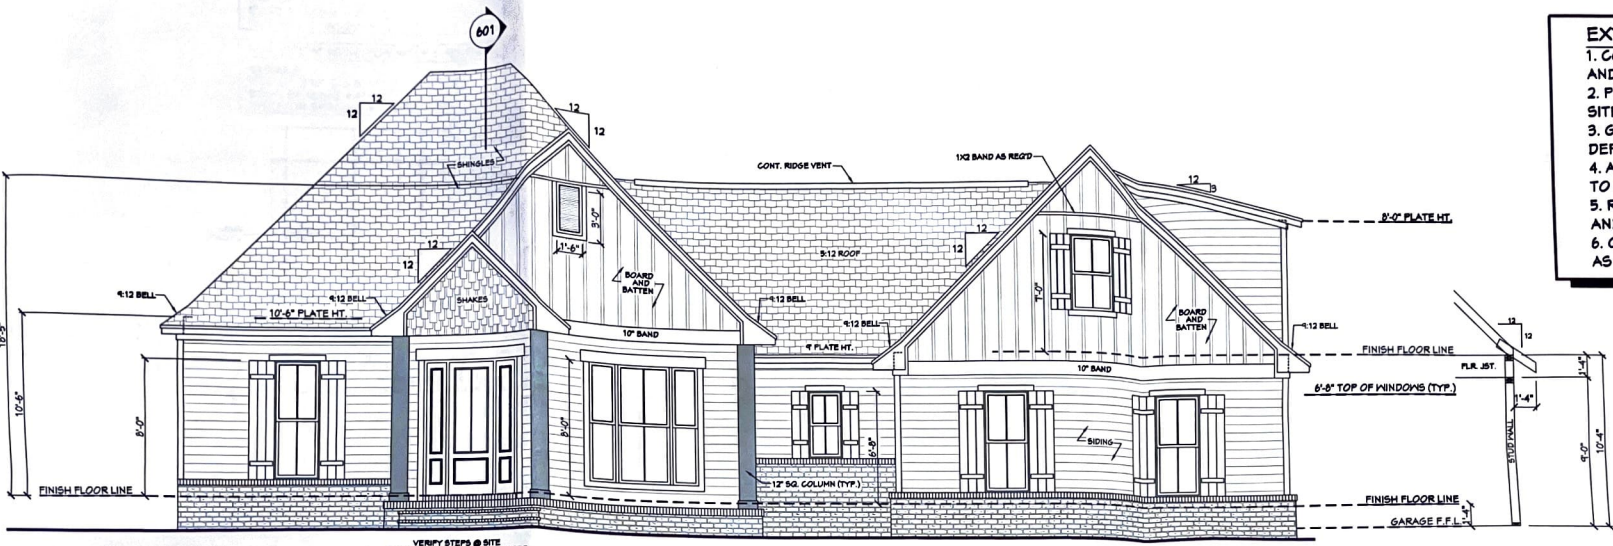


401 **BB-2086 FRONT VIEW**  
SCALE 1/4" = 1'-0"



403 **SHUTTER DETAIL**  
SCALE 1/2" = 1'-0"

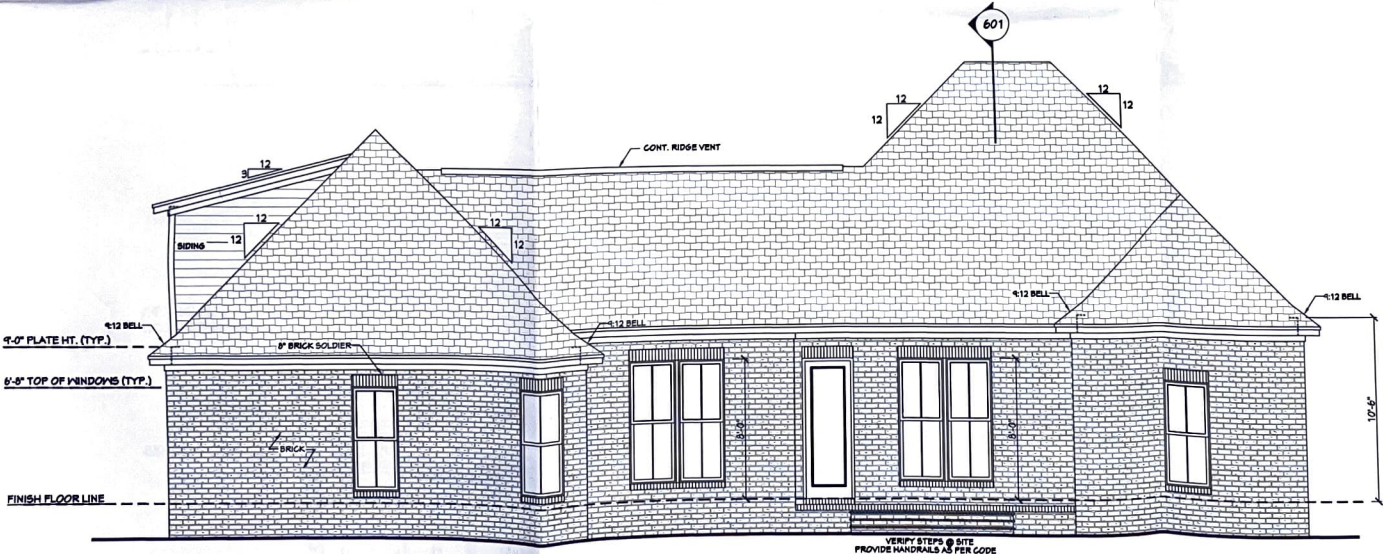

402 **REAR VIEW**  
SCALE 1/4" = 1'-0"

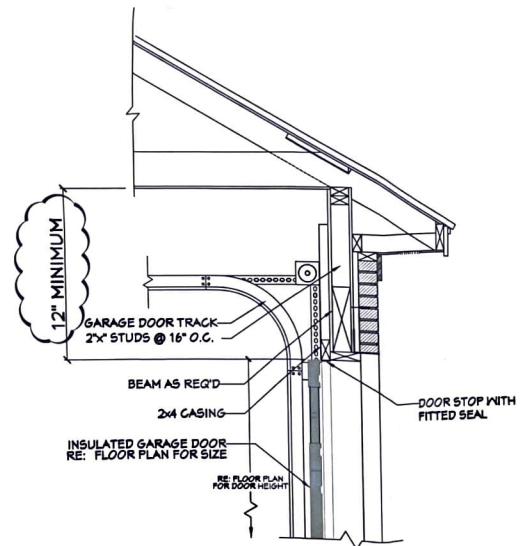


404 **GARAGE DOOR CLEARANCE**  
SCALE N.T.S.

THE INTENT OF THIS DETAIL IS TO SHOW THE MINIMUM REQUIRED DISTANCE FROM THE TOP OF THE GARAGE DOOR OPENING TO THE CEILING OF THE GARAGE.




**NAIL SIZE SPACING FOR WALL SHEATHING**  
 8d NAILS  
 MIN. OF 7/16" O.S.B.  
 EDGE SPACING = 4" O.C.  
 INTERIOR SPACING = 12" O.C.


**NAIL SIZE SPACING FOR ROOF SHEATHING**  
 8d NAILS  
 MIN. OF 7/16" O.S.B.  
 EDGE SPACING = 4" O.C.  
 INTERIOR SPACING = 12" O.C.

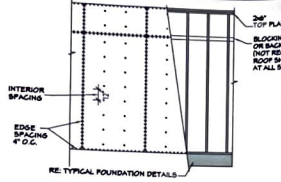


- NOTES:
1. ALL EXTERIOR SHEATHING TO EXTEND FROM BOTTOM OF BOTTOM PLATE TO THE TOP OF THE TOP PLATES.
  2. PROVIDE 2x4 OR GREATER COLLAR TIES ON EACH RAFTER IN THE UPPER THIRD OF ATTIC AND ATTACHED TO RAFTERS WITH 5-16d NAILS ON EACH SIDE.
  3. SHINGLES OR OTHER ROOF MATERIALS TO BE FASTENED AS PER MANUFACTURER'S INSTRUCTIONS FOR HIGH WIND APPLICATIONS.
  4. EXTERIOR WALL FINISHES TO BE INSTALLED AS PER MANUFACTURER'S INSTRUCTIONS BASED ON HIGH WIND APPLICATIONS.

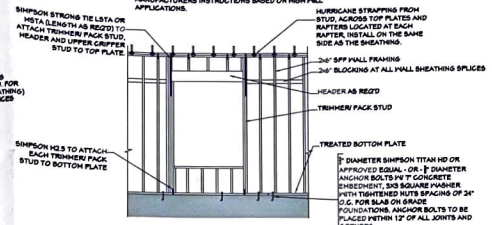


**503 WALL/ ROOF FASTENING DETAILS**  
 SCALE 1/4" = 1'-0"

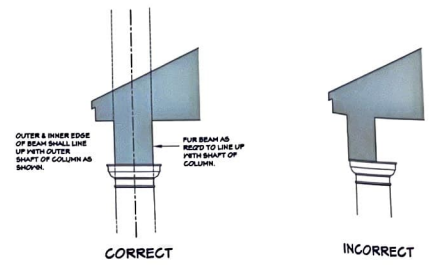


**504 COLUMN/ BEAM LOCATIONS**  
 SCALE N.T.S.

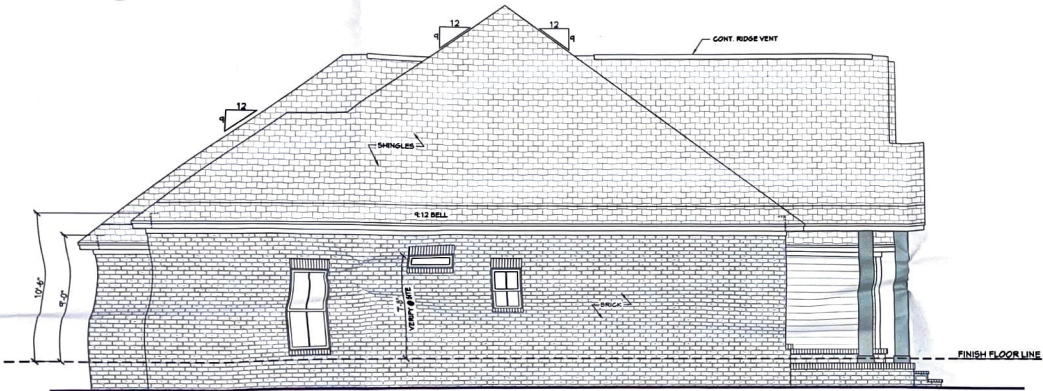

**501 LEFT VIEW**  
 SCALE 1/4" = 1'-0"

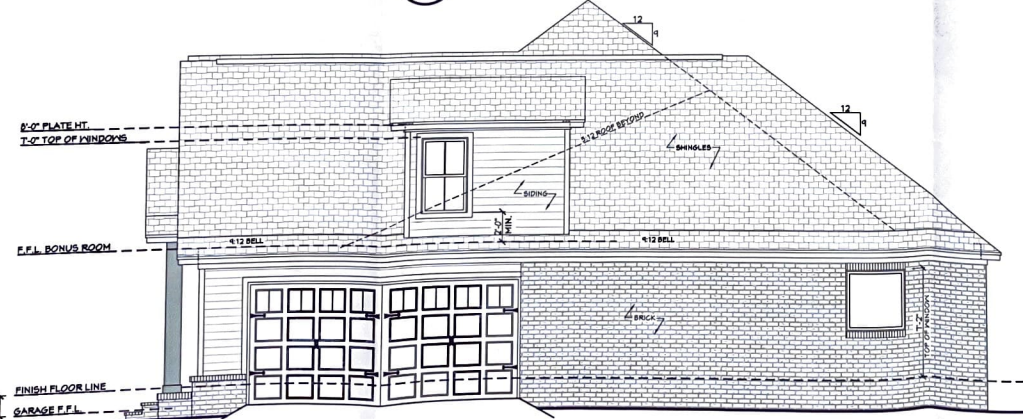

**502 RIGHT VIEW**  
 SCALE 1/4" = 1'-0"

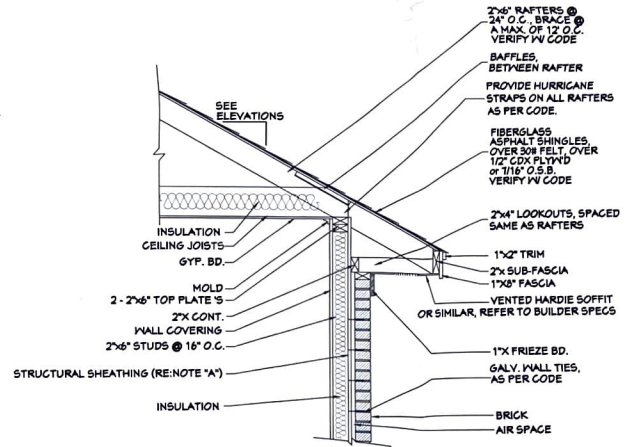

**505 TYP. CORNICE DETAIL**  
 SCALE 3/4" = 1'-0"

NOTE "A": PROVIDE A MINIMUM OF 7/16" STRUCTURAL WOOD PANEL ATTACHED W/ 8d COMMON OR 10d BOX NAILS AT 4" SPACING ON EDGE AND 12" IN FIELD.  
 NOTE "B": CORNICE DETAIL FOR REFERENCE ONLY. REFER TO BUILDER SPECS FOR ACTUAL MATERIALS.



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Pre-Drawn Plan ID:  
**BB-2086**

Date: 05.24.18  
 Drawn By: J.L.B.

Project Name:

SHEET NUMBER  
**5**

These plans were prepared by the author and are intended for use by the purchaser of these plans only. The purchaser of these plans shall be responsible for obtaining all necessary permits and for verifying the accuracy of the information shown on these plans. The author assumes no liability for any errors or omissions in these plans, or for any consequences arising from the use of these plans. The purchaser of these plans shall be responsible for obtaining all necessary permits and for verifying the accuracy of the information shown on these plans. The author assumes no liability for any errors or omissions in these plans, or for any consequences arising from the use of these plans.







602 KITCHEN  
SCALE: 3/8" = 1'-0"



603 KITCHEN  
SCALE: 3/8" = 1'-0"

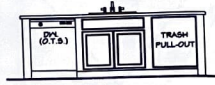

604 KITCHEN  
SCALE: 3/8" = 1'-0"

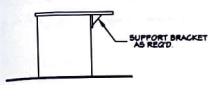


605 KITCHEN  
SCALE: 3/8" = 1'-0"


**CROSS SECTION NOTES:**

1. CONTRACTOR SHALL COMPLY WITH ALL APPLICABLE CODES AT SITE.
2. ALL RIDGE BEAMS, HIP RAFTERS, & VALLEY RAFTERS TO BE 2" x 10", OR AS REQ'D BY ENGINEER.
3. CONTRACTOR TO PROVIDE RAFTER BRACING TO MEET APPLICABLE CODES.
4. CONTRACTOR TO THOROUGHLY WATERPROOF ALL EXTERIOR INTERSECTIONS AS PER CODE AND TYPICAL BUILDING PRACTICES.
5. ALL BEAMS TO BE SIZED BY A LICENSED STRUCTURAL ENGINEER.
6. ALL LUMBER SIZES AND SPACING TO BE VERIFIED BY CONTRACTOR PRIOR TO CONSTRUCTION.
7. CONTRACTOR TO PROVIDE ADEQUATE ROOF VENTILATION AS REQ'D. BY CURRENT CODES.


**KITCHEN**

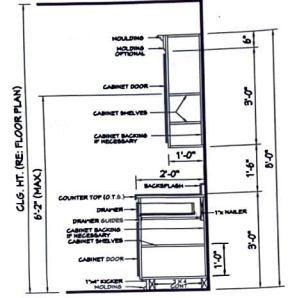

**BATH**

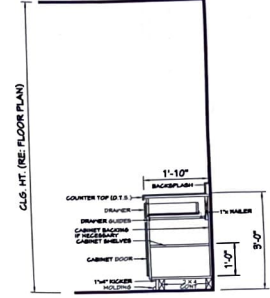


606 TYP. CAB. SECTIONS  
SCALE: N.T.S.

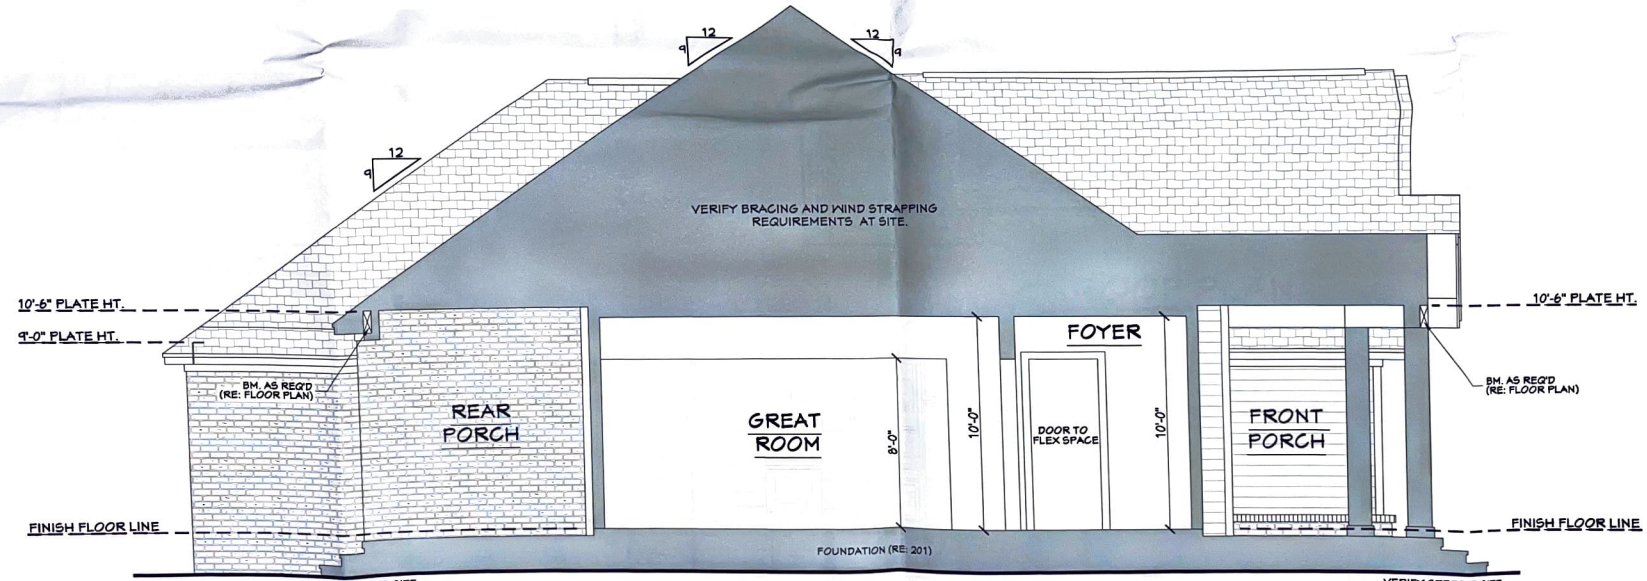

601 CROSS SECTION  
SCALE: 3/8" = 1'-0"

Inspiring Homes  
**HOUSE PLAN ZONE**  
 Building Relationships

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Pre-Drawn Plan ID:  
**BB-2086**

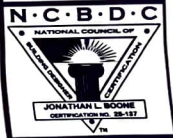Date:  
 05.24.18  
 Drawn By:  
 C.T.B.

SHEET NUMBER  
**6**

House Plan Zone, LLC has provided general information for informational purposes only. It is not intended to constitute an offer of insurance or any other financial product. The information is not intended to be used as a basis for any investment decision. The information is not intended to be used as a basis for any investment decision. The information is not intended to be used as a basis for any investment decision. The information is not intended to be used as a basis for any investment decision.

### ROOF PLAN NOTES:

- CONTRACTOR SHALL COMPLY WITH ALL APPLICABLE CODES AT SITE.
- ALL RIDGE BEAMS, HIP RAFTERS, & VALLEY RAFTERS TO BE 2" X 10", No.2 S.Y.F. OR AS REQ'D BY ENGINEER.
- ALL RAFTERS TO BE SIZED AS PER SPAN CHART.
- CONTRACTOR TO WATERPROOF ALL ROOF INTERSECTIONS AS PER CODE.
- CONTRACTOR TO VERIFY ALL ROOF PITCHES WITH EXTERIOR ELEVATIONS PRIOR TO CONSTRUCTION.
- CONTRACTOR TO PROVIDE ADEQUATE ROOF VENTILATION AS REQ'D BY CURRENT CODES.
- ALL ROOF PENETRATIONS TO BE ON SIDES OR REAR OF RESIDENCE. ALL PVC VENTS SHALL BE PAINTED BLACK OR TO MATCH ROOFING.

### CEILING JOIST SPANS

CEILING JOIST SPANS FOR SOUTHERN PINE SPECIES  
(UNINHABITABLE ATTICS WITH LIMITED STORAGE,  
LIVE LOAD = 30psf, L<sub>0</sub>=240' DEAD LOAD = 10psf)  
\*\*\* IF HABITABLE ATTIC SPACE IS DESIRED,  
REFER TO THE INTERNATIONAL RESIDENTIAL CODE SPAN TABLES \*\*\*

SIZE	SPACING (INCHES)	VISUALLY GRADED #2 SOUTHERN PINE (MAXIMUM CEILING JOIST SPANS)
2 x 4	12.0	4-3
	16.0	5-0
	19.2	7-4
	24.0	8-7
2 x 6	12.0	13-11
	16.0	12-0
	19.2	11-0
	24.0	9-10
2 x 8	12.0	17-7
	16.0	15-3
	19.2	13-11
	24.0	12-6
2 x 10	12.0	23-7
	16.0	19-1
	19.2	16-6
	24.0	14-4

NOTES:  
The above tables are based on the IRC 2015 TABLE R802.4(2)

### RAFTER SPANS

RAFTER SPANS FOR SOUTHERN PINE SPECIES  
LIVE LOAD=30psf, L<sub>0</sub>=180' DEAD LOAD = 10psf

SIZE	SPACING (INCHES)	SPANS (MAXIMUM RAFTER SPANS BETWEEN BRACKING) (FT. - IN.)
2 x 6	12.0	12-11
	16.0	11-2
	19.2	10-2
	24.0	9-2
2 x 8	12.0	16-4
	16.0	14-2
	19.2	12-11
	24.0	11-7
2 x 10	12.0	19-5
	16.0	16-10
	19.2	15-4
	24.0	13-4
2 x 12	12.0	22-10
	16.0	19-10
	19.2	16-1
	24.0	16-2

NOTES:  
The above tables are based on the IRC 2015 TABLE R802.5.1(3)

### RAFTER LENGTH CHART


ROOF PITCH	FACTOR
3/12	1.09
4/12	1.07
5/12	1.10
6/12	1.14
7/12	1.17
8/12	1.20
9/12	1.25
10/12	1.30
11/12	1.35
12/12	1.40
14/12	1.54
16/12	1.70

MULTIPLY HORIZONTAL SPAN OF MEMBER BY FACTOR.  
CHOOSE APPROPRIATE FACTOR BY ROOF PITCH.

### HIP/VALLEY CONVERSION

IF COMMON RAFTER ROOF PITCH IS:	THEN HIP/VALLEY RAFTER ROOF PITCH BECOMES:		
RISE/RUN	SLOPE	RISE/RUN	SLOPE
1/12	9°	1/11	9°
2/12	10°	2/11	7°
3/12	14°	3/11	10°
4/12	18°	4/11	13°
5/12	23°	5/11	16°
6/12	27°	6/11	19°
7/12	30°	7/11	22°
8/12	34°	8/11	25°
9/12	37°	9/11	28°
10/12	40°	10/11	30°
11/12	42°	11/11	33°
12/12	45°	12/11	35°


CONVERSION CHART FOR SIMPLE ROOFS ONLY.  
CHART DOES NOT APPLY FOR DUAL PITCH ROOFS.

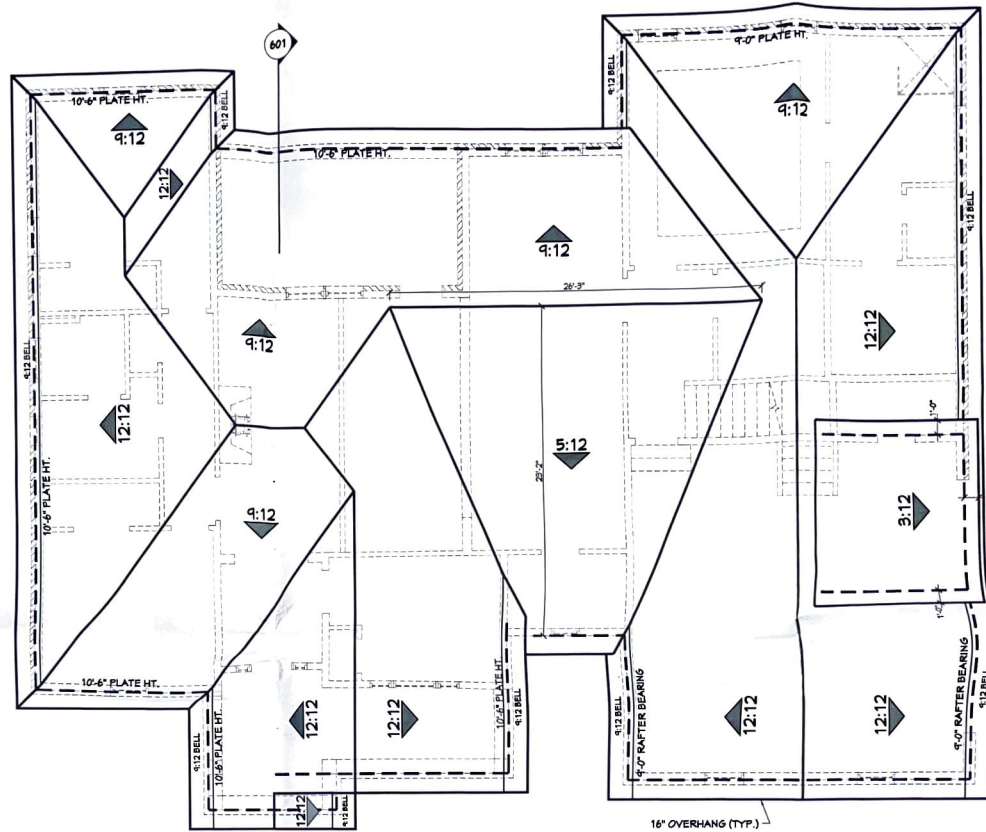

**701 ROOF PLAN**  
SCALE: 1/4" = 1'-0"



Website:  
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Pre-Drawn Plan ID:  
**BB-2086**


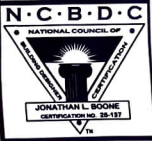
Date:  
05.24.18  
Drawn By:  
J.L.B.

Project Name:  
  
SHEET NUMBER

**7**

House Plan Zone, LLC, has prepared great care and effort in the development of these plans and the drawings. We warrant that the drawings were prepared by a professional drafter and that they conform to the requirements of the International Residential Code (IRC) and the International Building Code (IBC). We do not warrant that the drawings are suitable for any use other than that intended. The drawings are provided for your information only and are not to be used for any other purpose. The drawings are the property of House Plan Zone, LLC and are not to be reproduced or distributed without our written consent. The drawings are provided on the understanding that you are a licensed professional and shall be held liable for any errors or omissions in the drawings. The drawings are provided on the understanding that you are a licensed professional and shall be held liable for any errors or omissions in the drawings.



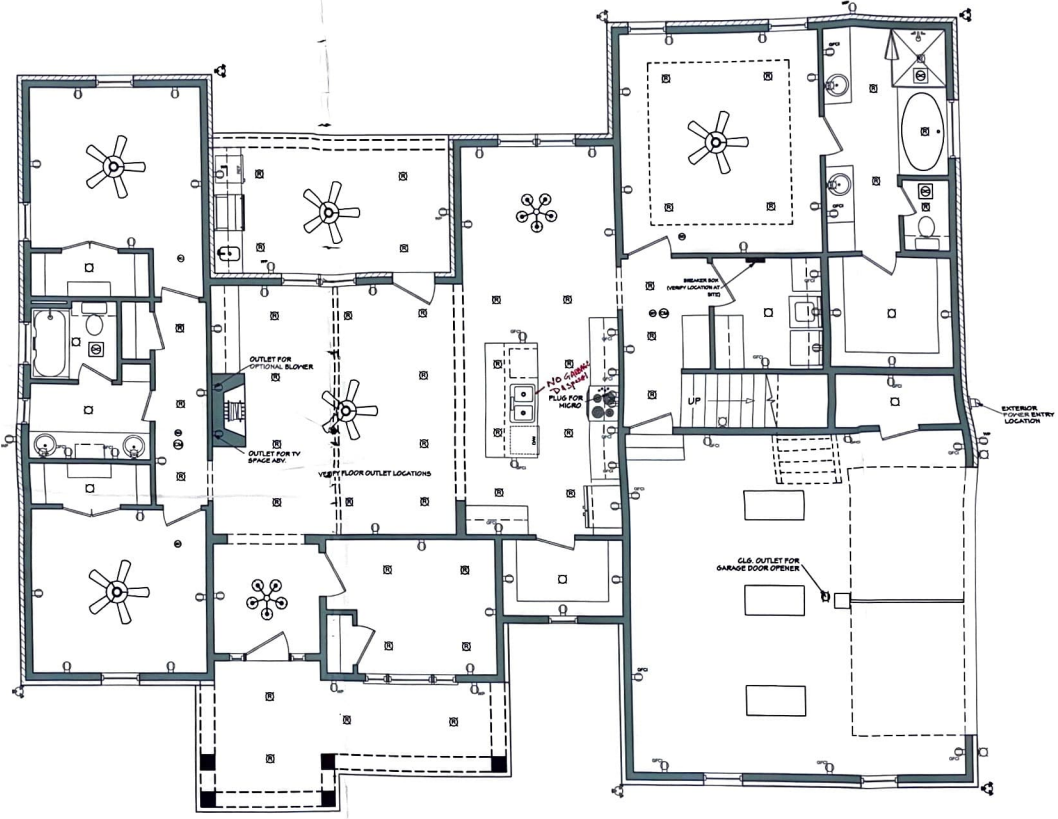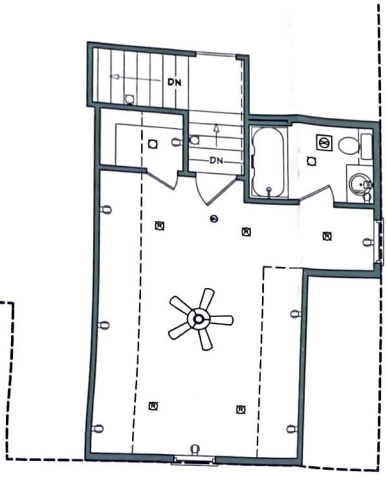

**ELECTRICAL SYMBOLS LEGEND**

SYMBOL	DESCRIPTION
[Symbol]	110 VOLT OUTLET
[Symbol]	GROUND FAULT PROTECTED OUTLET
[Symbol]	WEATHERPROOF OUTLET
[Symbol]	220 VOLT RECEPTACLE
[Symbol]	FLOOR OUTLET (OWNER TO LOCATE)
[Symbol]	CEILING HUNG FIXTURE
[Symbol]	OVER-HUNG MOUNTED FLOODLIGHTS
[Symbol]	WALL MOUNTED FLOODLIGHTS
[Symbol]	RECESSED CEILING FIXTURE
[Symbol]	FLUORESCENT LIGHT
[Symbol]	CARBON MONOXIDE DETECTOR
[Symbol]	SMOKE DETECTOR
[Symbol]	SWITCH
[Symbol]	THREE WAY SWITCH
[Symbol]	WALL MOUNTED LIGHT
[Symbol]	DIMMER SWITCH (OWNER TO LOCATE)
[Symbol]	DOOR ACTIVATED SWITCH
[Symbol]	WEATHERPROOF OUTLET
[Symbol]	CATS NETWORKING JACK (OWNER TO LOCATE)
[Symbol]	TELEPHONE OUTLET (OWNER TO LOCATE)
[Symbol]	TELEVISION OUTLET (OWNER TO LOCATE)
[Symbol]	DOORBELL BUTTON (CONTRACTOR TO LOCATE)
[Symbol]	THERMOSTAT (CONTRACTOR TO LOCATE)
[Symbol]	CEILING EXHAUST FAN, VENT TO EXTERIOR

SYMBOL	DESCRIPTION
[Symbol]	TV SPEAKER
[Symbol]	RADIO SPEAKER
[Symbol]	CEILING FAN ONLY, NO LIGHT KIT
[Symbol]	CEILING FAN WITH LIGHT KIT
[Symbol]	TRACK LIGHTING (OWNER TO LOCATE)
[Symbol]	WALL SCONCE (OWNER TO LOCATE)
[Symbol]	CHANDELIER 1 (O.T.S.)
[Symbol]	CHANDELIER 2 (O.T.S.)
[Symbol]	UNDER COUNTER LIGHTING
[Symbol]	EMERGENCY LIGHTING/EXIT SIGN


**ELECTRICAL NOTES:**  
 1. ALL WORK SHALL COMPLY WITH ALL CODES APPLICABLE AT SITE.  
 2. SMOKE ALARMS SHALL BE INSTALLED IN THE FOLLOWING LOCATIONS: EACH SLEEPING ROOM, OUTSIDE EACH SEPARATE SLEEPING AREA IN THE IMMEDIATE VICINITY OF THE BEDROOMS, ON EACH ADDITIONAL STORY OF THE DWELLING, INCLUDING BASEMENTS AND HABITABLE ATTICS. WHEN MORE THAN ONE SMOKE ALARM IS REQUIRED TO BE INSTALLED WITHIN A DWELLING THE ALARM DEVICES SHALL BE INTERCONNECTED IN SUCH A MANNER THAT THE ACTIVATION OF ONE ALARM WILL ACTIVATE ALL OF THE ALARMS IN THE UNIT. SMOKE ALARMS SHALL BE HARD WIRED WITH A BATTERY BACK UP.  
 3. CARBON MONOXIDE ALARMS SHALL BE INSTALLED OUTSIDE OF EACH SEPARATE SLEEPING AREA IN THE IMMEDIATE VICINITY OF THE BEDROOMS IN DWELLING UNITS WITHIN PITCHED FUEL-FIRED APPLIANCES ARE INSTALLED AND IN DWELLING UNITS WITH ATTACHED GARAGES.  
 4. A 120 VOLT, SINGLE PHASE, 15-20 AMPERE RATED RECEPTACLE OUTLET SHALL BE INSTALLED AT AN ACCESSIBLE LOCATION FOR THE SERVICING OF HEATING, AIR CONDITIONING AND REFRIGERATION EQUIPMENT. THE RECEPTACLE SHALL BE LOCATED ON THE SAME LEVEL AND WITHIN 25 FEET OF THE EQUIPMENT. THE RECEPTACLE OUTLET SHALL NOT BE CONNECTED TO THE LOAD SIDE OF THE HVAC EQUIPMENT DISCONNECTING MEANS.

**ELECTRICAL PLAN**

SCALE: 1/4" = 1'-0"



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Pre-Drawn Plan ID:

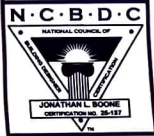**BB-2086**

Date: 05.24.18

Drawn By: J.L.B.

Project Name:

SHEET NUMBER

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House Plan Zone, LLC, has made every effort to ensure the accuracy of these plans. However, the user of these plans is responsible for verifying the accuracy of the information shown on these plans. The user of these plans is advised that the user of these plans is responsible for obtaining all necessary permits and for complying with all applicable codes and regulations. The user of these plans is advised that the user of these plans is responsible for obtaining all necessary permits and for complying with all applicable codes and regulations. The user of these plans is advised that the user of these plans is responsible for obtaining all necessary permits and for complying with all applicable codes and regulations.