LOT 1130 - ANDERSON CREEK ACADEMY - 02.02.2021



ELEVATION - CLASSIC

Covered Porch - Front Garage - Two Car Rear Patio Unfin, Attic Storage ELEVATION - EURO

#### OWNER / CONTRACTOR NOTES:

THE SEALING OF THIS PLAN FOR A LOT SPECIFIC ISSUE, AUTHORIZES THE CONSTRUCTION FROM THESE PLANS FOR ONE HOUSE ON ONE LOT FOR THE LOT SPECIFIC REFERENCED IN ITLEBLOCK, UNSEALED PLANS MUST NOT BE USED FOR CONSTRUCTION CONSTRUCTION FROM THESE PLANS MUST BE FROM THE ATEST APPROVED DATE PLANS, INCLUDING REVISIONS AND ADENDA.

THE SEALING OF THIS PLAN FOR A MASTER PLAN SET ISSUE, AUTHORIZES TO CONSTRUCTION FROM THESE PLANS FOR MULTIPLE HOUSES ON MULTIPLE LOTS FOR BUILDER WITH DESIGNER'S WOULDEDGE OF CONSTRUCTION CONSTRUCTION. FOR UNSEALED PLANS THIS TOP SEE USED FOR CONSTRUCTION CONSTRUCTION FROM THESE PLANS THIST BE FROM THE LATEST APPROVED DATE PLANS, NOLUDING

CONSTRUCTION DEVIATING FROM THESE PLANS WILL INVALIDATE THEIR
PLANS REVIEW PERMITTED UB. THE DESIGNER MUST BE NOTIFIED IMMEDIATELY
FO CONSTRUCTION DEVIATING FROM DEPICTED OR MPH. LIED INFORMATION
FIREIN. LETTER FROM THE DESIGNER MAY BE OBTAINED FOR A FEE TO VERIFY
THE FEASIBILITY AND COMPILABILITY OF ANY CHANGES, HOUSVER THE
DUNER/CONTRACTOR ASSUMES ALL RISK FROM DEVIATING FROM THESE PLANS.

4. DO NOT SCALE DRAWINGS, BUT RATHER INQUIRE INFORMATION FROM DESIGNER. REPRODUCTION OF THESE DRAWINGS ARE PROHIBITED UNLESS GRANTED WRITTEN CONSENT FROM DESIGNER.

5. THE OWNER AND/OR CONTRACTOR IS RESPONSIBLE FOR OBTAINING THE FOLLOWING INFORMATION (NON-EXHAUSTIVE): BUILDING PERMITS, SITE EXPORTERING INCLIDING SURVEYING, TOPOGRAPHIC STUDIES, GEOTECHNICAL REPORTS, AND SEPTIC PERMITS! INTERIOR CASEWORK DESIGNS PLUMBING, IECHANICAL, AND ELECTRICAL DESIGNS.

#### BUILDING CODE NOTES

THIS PLAN HAS BEEN DESIGNED UNDER THE 2018 NORTH CAROLINA RESIDENTIAL CODE.

APPLICABLE CODES:

N.C. FIRE CODE, 2018 N.C. MECHANICAL CODE, 2018 N.C. PLUMBING CODE, 2018

N.C. ENERGY CODE, 2018 N.C. ELECTRICAL CODE, 2017

N.C. GAS CODE 2018

BUILDING DATA:

Construction Type: V-B
Use Group: R-3
Number of Stories: 2

Building Ridge Height: (Elevation A) = (+/-)35'-0" Building Ridge Height: (Elevation B) = (4/-)35'-0''Building Ridge Height: (Elevation C) = (N/A)Building Ridge Height: (Elevation D) = (+/-)35'-0" Building Ridge Height: (Elevation E) Mean Roof Height: Mean Roof Height: (Elevation A) = (+/-) 2T'-I" (Elevation B) = (+/-) 27'-I" Mean Roof Height: (Elevation C) = 1ean Roof Height: (Elevation D) = (+/-) 27'-|" Mean Roof Height: (Elevation E) = (+/-) 27'-1"

NOTE: HEIGHTS LISTED ABOVE ARE BASED ON MONO SLAB GRADE LINES PROVIDED ON EXTERIOR ELEVATIONS SHEETS. BUILDER: NOPECTIONS OFFICIAL TO VERIFY FINAL GRADE HEIGHT IN FIELD AS REQUIRED.

#### CONSTRUCTION NOTES:

THE FOLLOWING IS A NON-EXHAUSTIVE LIST OF SOME COMMONLY MISSED CODE REQUIREMENTS AND ARE ENFORCEABLE IN THE CONSTRUCTION FROM THESE PLANS, SEE THE NC. RESIDENTIAL CODE BOOK FOR MORE INFO.

I. (R308.4) ALL GLAZING WITHIN 24" OF EITHER RIDE OF A DOOR IN A CLOSED POSITION, AND ON THE SAME WALL PLANE SHALL BE TEMPERED. ALL WINDOWS THAT MEET ALL OF THE FOLLOWING CONDITIONS SHALL BE TEMPERED. A. NOIVIDIAL PANES OF MIN. 9 SP. B) BOTTOM EDGE IS WITHIN 18" OF FLOOR, C) TOP EDGE IS AT LEAST 36" ABOVE FLOOR, AND D) GLAZING IS WITHIN 18" OF PLOOR, C) TOP EDGE IS AT LEAST 36" ABOVE FLOOR, AND D) GLAZING IS WITHIN 56" OF HOT TUES OR STAIR LEADING. AND PINISH EDGES, TEMPERED WINDOWS ALSO REQUIRED WERE REMAINDER OF THIS CODE SECTION.

2. (RSIQI) ALL BLEEPING ROOMS AND BASEMENTS WITH HABITABLE SPACE SHALL HAVE AT LEAST ONE EGRESS WINDOW CORPORTING TO THE FOLLOWING. A) HIN 40 SF. CLEAR OPENING 1B MIN 10 TAL GLASS AREA OF 50 SQ (GROUND FLOOR WINDOW) AND 51 SF. (WPTER STORT WINDOW). IT IS THE CONTRACTOR'S RESPONSIBILITY TO CHOSE THE PROPER CORPORTING WINDOW) AND HAVE EGRESS WINDOWS PROPERLY DISTRIBUTED AND INSTALLED AS REQUIRED.

3. (R3112) ALL INTERIOR EGRESS DOORS AND A MINIMUM OF ONE EXTERIOR EGRESS DOOR SHALL BE READILY OPENABLE FROM THE EGRESS SIDE WITHOUT USE OF A KEY OR SPECIAL KNOWLEDGE.

4. (R3II.7.5) MAXIMUM STAIR RISER HEIGHT SHALL BE 8-1/4", AND MINIMUM TREAD SHALL BE 9".

5, (R3143) SMOKE ALARMS SHALL BE INSTALLED AND INTERCONNECTED, WITH BATTERY BACK-UP IN THE FOLLOWING AREAS. EACH SLEEPING ROOMS IN THE AREA (HALLWAY) RIGHT OUTSIDE THE SLEEPING ROOMS AND EACH STORY. THE ONE OUTSIDE THE SLEEPING ROOMS WILL SATISFY THAT STORY.

6. (R402.12) ALL LUMBER SHALL BE PRESSURE TREATED AND DRIED AFTER TREATMENT IN ACCORDIANCE WITH AWPA UI AND SHALL BEAR THE LABEL OF AN ACCREDITED AGENCY.

7. (R406.1) BITUMINOUS DAMPPROOFING SHALL BE APPLIED TO EXTERIOR FOUNDATIONS OF ALL HABITABLE AND USABLE (STORAGE, ETC.) SPACES.

8. (R408,12) INSTALL ONE FOUNDATION VENT WITHIN 3' OF EACH CORNER (NOT ONE EACH SIDE OF EACH CORNER).

(Ø, (R8ØT1)) BUILDER TO LOCATE 22'93Ø" ATTIC ACCESS IN ALL ATTICS WITHOUT STAIR ACCESS, LOCATE ACCESS TO PROVIDE A 3Ø" CLEAR SPACE ABOVE ACCESS DOOR-TIP. II. (RIØØI) MASONRY FIREPLACE WALLS TO BE MIN. 8" THICK, AND MIN. 2" TO FRAMING, POURED HEARTHS TO HAVE MIN "4012" O.C. EACH WAY. HEARTHS TO BE MIN. 20" FROM FIREBOX AND HAVE MIN. 2" WIDER THAN FIREBOX AND HAVE MIN. 2" WIDER THAN FIREBOX AND HEACH SIDE.

12. (R403.1.6) ANCHOR BOLTS SHALL BE MIN, ½" DIAMETER 4 SHALL EXTEND A MINIMUM T"INTO MASONRY OR CONCRETE, ANCHOR BOLTS TO BE NO MORE THAN 6" O.C. AND WITHIN 12" OF THE

13. (R315) INSTALL APPROVED CARBON MONOXIDE ALARM OUTSIDE EACH BEDROOM AND IN IMMEDIATE VICINITY OF EACH SEPARATE SLEEPING AREA.

14. ALL WINDOWS SHALL BE LABELED TO CONFORM WITH AAMANWUDA WILS2 BUILDER TO VERIFY MIN DP CLASSIFICATION FOR ALL WINDOWS BASED ON LOCATION SHALE HOMES ARE BUILT BASED ON REQUIREMENTS FOR THAT WIND ZONE AREA.

IB. IF CRAILL SPACE FOUNDATION OPTION IS USED BUILDER TO LOCATE ACCESS PER CURRENT CODE REG. WITH 36">24" (MIN.) CLEAR OPENING IF NO HYAC LOCATED IN CRAILL, OR 36">356" (MIN.) WITH HYAC LOCATED IN CRAILL SPACE AREA.

### CLIMATIC AND GEOGRAPHIC NOTES:

	TABLE NIIØ2,12 (R4Ø2,12)								
CLIMATE ZONE		FENEST. SHGC	CEILING R-VALUE	FRAME WALL R-VALUE	R-VALUE	BASEMENT WALL R-VALUE	R-VALUE	CRAWL WALL R-YALUE	
3	Ø.35	0.30	38 OR 30 CONT.	15, 13+2,5	19	5/13	ø	5/13	
4	Ø35	Ø.3Ø	38 OR 30 CONT.	15, 13+2.5	19	10/15	Ю	10/15	
5	Ø35	NR	38 OR 30 CONT.	19 , 13+5, OR 15+3	3Ø	10/15	Ø	10/19	

#### STRUCTURAL DESIGN FIRM DATA:

Structural Designer Engineering Tech Associates ENGNINEER NAME

NOTE: PLANS ARE TO BE COORDINATED WITH STRUCTURAL DESIGNS AND TRUSS PLANS BY BUILDER THE COORDINATION AND/OR VERRICATION OF ANY STRUCTURAL MEMBERS, TRUSS PLANS AND/OR INFORMATION FROM OTHERS IS NOT THE RESPONSIBILITY OF PLAN DESIGN FIRM IF ANY DISCREPTANCIES WITH FLOOR PLANS, BLEVATIONS OR DETAILS ARE DISCOVERED THE BUILDER SHALL NOTIFY PLANGORY PRIOR TO SUBMITTING PLANS FOR PRIOTY DESIGNS FROM TO ADJUST PLANS AS NEEDED TO MEET NEEDS.

TELEPHONE NUMBER

919-844-1661

#### PROJECT SQUARE FOOTAGES

CLARK II - CLASSIC				
Heated Square Footage				
irst Floor Htd.	1,716			
Becond Floor Htd.	1,641			
TOTAL HTD. =	3,357			
Inheated Square Footage				
Covered Porch - Front	155			
Sarage - Two Car	501			
Rear Patio	144			
Infin. Attic Storage	353			

#### OPT. CRAWL SPACE VENTLATION INFO.

Α	Crawl Space Area	1,716
В	Ventable Area Required by Code (without vapor barrier)	11.44
С	Ventable Area Required by Code (with vapor barrier)	1.1
D	Number of vents required (without vapor barrier)	25.0
Е	Number of vents required (with vapor barrier). (See notes)	3.0
	Formulas:	
	B = A / 150	
	C = A / 1500	
	D = B / 0.47 (sqft of net venting area per vent)	
	E = C / 0.47 (sqft of net venting area per vent)	
	Notes:	
	1. Builder must adjust ventilation calculations if using vents	
	with a net area that is different than 0.47 sqft per vent.	
	<ol><li>One foundation vent must be placed within 3 feet of each n in the building.</li></ol>	najor comer
	3. Foundation vents must be placed to allow for cross ventilati	ion

NOTE: BUILDER TO SIZE AND LOCATE FOUNDATION VENTS 18 USED PER THE 2018 N.C. RESIDENTIAL BUILDING CODE BASED ON SITE CONDITIONS. OR OPT. CLOSED CRAWLSPACE

NOT APPLICABLE ON THIS ARCHITECTURAL BASE MASTER PLAN SET - SEE STRUCTURAL FILES

#### ROOF VENTLATION INFO.

	Ceiling area (square footage)	2,372
В	Sqft. of ventilation required	15.8
Formula	s: B = A / 150	
Notes:		
minimur	to calculate quantities and types of vents to m n requirement. Attic ventilation shall be approxi and 50% high (gable end or ridge vents).	ake up the mately 50%

### INDEX OF DRAWINGS:

SHEET	SHEET NAME - Clark II - Master Plan
CS-1	Cover Sheet
A-1-0	Elevations - Front and Left - Classic
A-2-0	Elevations - Rear and Right - Classic
A-3-0	Roof Plate Details
A-4-0	First Floor Plan
A-5-0	Second Floor Plan
A-6-0	Attic Floor Plan
AE-1-0	First Floor Lighting
AE-2-0	Second Floor Lighting
O-1-0	Optional Sunroom - Elevs-Floors-Lights
O-2-0	Optional Covered Patio - Archs
O-3-0	Optional Master Sitting - Archs
0-4-0	Optional Master Sitting Deluxe - Archs
OA-1-0	Optional 3 Car Garage - Elevs-Floors-Lights
OA-2-0	Optional Flush Porch - Elevs-Floors-Lights
OB-1-0	Exterior Elevations - Coastal
OB-2-0	Wall Section Details
OB-3-0	Floors and Lighting
OB-8-0	Opt. 3rd Bay Garage - Elevs-Floors-Lights
OB-9-0	Opt. Sideload Garage - Elevs-Floors-Lights
OB-10-0	Opt. Flush Porch - Elevs-Floors-Lights
OD-1-0	Exterior Elevations - Craftsman
OD-2-0	Wall Section Details
OD-3-0	Floors and Lighting
OD-8-0	Opt. 3rd Bay Garage - Elevs-Floors-Lights
OD-9-0	Opt. Sideload Garage - Elevs-Floors-Lights
OD-10-0	Opt. Flush Porch - Elevs-Floors-Lights
OD-11-0	Opt. Extended Porch - Elevs-Floors-Lights
OD-12-0	Opt. 2 Garage Doors - Elevs-Floors-Lights
OE-1-0	Exterior Elevations - Euro
OE-2-0	Wall Section Details
OE-3-0	Floors and Lighting
OE-8-0	Opt. 3rd Bay Garage - Elevs-Floors-Lights
OE-9-0	Opt. Sideload Garage - Elevs-Floors-Lights
OE-10-0	Opt. Flush Porch - Elevs-Floors-Lights
AD-1	Standard Details
AD-2	Standard Details
	Structural Plans
Sheet	See Structural Plans (Done by Others)

Homes,

Architectural McKee For the McKee II Base Pla -21-17 BB Master Plan Set - Archs i-25-18 BB Master Plan Set - Archs 23-18 BB Master Plan Set-Archs (Log

Scales UNO: 22X34: 1/4"=1'-0"

11x17: 1/8"=1'-0"

Set (2-19-19)

e - Classic lev. A (LHG) Master Plan S

Elev.

Plan

Base

Cover Sheet

**CS-1-0** 

## ARCHITECTURAL PLANS EXTERIOR MATERIALS = SHINGLE ROOF PER BUILDER METAL ROOF PER BUILDER HORIZONTAL SIDING PER BUILDER = SHAKE SIDING PER BUILDER BOARD-N-BATTEN PER BUILDER BRICK PER BUILDER STONE PER BUILDER STUCCO PER BUILDER SCREEN PER BUILDER = BRICK ROWLOCK/90LDIER PER BUILDER = STONE ROWLOCK/SOLDIER PER BUILDER

#### GENERAL NOTES

\* USE ICE AND WATER SHIELD AT ALL ROOF PLANES SLOPED BELOW 4:12.

SEE FLOOR PLANS, ROOF PLAN, AND/OR ROOF FRAMING DETAIL SHEET FOR PLATE HEIGHTS AT RAFTER AND/OR TRUSS BEARING LOCATIONS.

SEE ROOF PLANS FOR ATTIC VENTILATION CALCULATIONS.

SEE SHEET D-2 FOR FLASHING DETAILS AND REQUIRED LOCATIONS.

#### REQUIRED FLASHING LOCATIONS

1) ALL MATERIAL CHANGE INTERSECTIONS, 2) ALL WINDOW / DOOR OPENINGS, 3) ALL ROOF VALLEYS,

BUILDER TO VERIFY ON SITE FLASHING IS INSTALLED TO MEET CODE REQUIREMENTS

1) PLANS HAVE BEEN 199UED TO MCKEE HOMES LLC. AS A BASE PLAN MASTER SET.

2) PLANS AND OPTIONS ARE DESIGNED FOR SINGLE USE ONLY AND NOT IN COMBINATION WITH EACH OTHER THE USE OF MULTIPLE OPTIONS TOGETHER MAY CAUSE ADDITIONAL CHANGES TO ORIGINAL STRUCTURE AND ARCHITECTURAL

3, ANY ON SITE CHANGES OR VARIATIONS FROM PLANS SHOUN MUST BE VERIFIED WITH DESIGNER OR ENGINEER TO MEET LOCAL CODES, GUIDELINES, LOAD CALCULATIONS ETC.

11x17 PRINTS SCALE: 1/8"=1'-0"

**EURO ELEVATION** SEE PG. OE-1-0

EURO ELEVATION SEE PG. OE-1-0 MONO SLAB FOUNDATION (SHOWN) IS STANDARD. CRAWL/STEM FOUNDATION IS OPTIONAL (NOT SHOWN) WALL HEIGHTS AND PORCH LOCATIONS WILL VARY WITH CRAWL/STEM FOUNDATION. OPTIONAL DOOR 22×34 PRINTS SCALE: 1/4"=1'-@'

ADD FOUNDATION BRICK WRAP (3 SIDES)

Scales UNO: 22X34: 1/4"=1'-0" 11x17: 1/8"=1'-0"


Clark II - Base - Classic Base Plan - Elev. A (LHG) Architectural Master Plan McKee Homes, LLC Clark II - Base - Class Base Plan - Elev. A (I


Set (2-19-19)

3-21-17 BB Master Plan Set - Archs 5-25-18 BB Master Plan Set - Archs -23-18 BB Master Plan Set-Archs (Logo

-19-19 BB 2018 Codes - Plan mode Front & Left Elevations

A-1-0

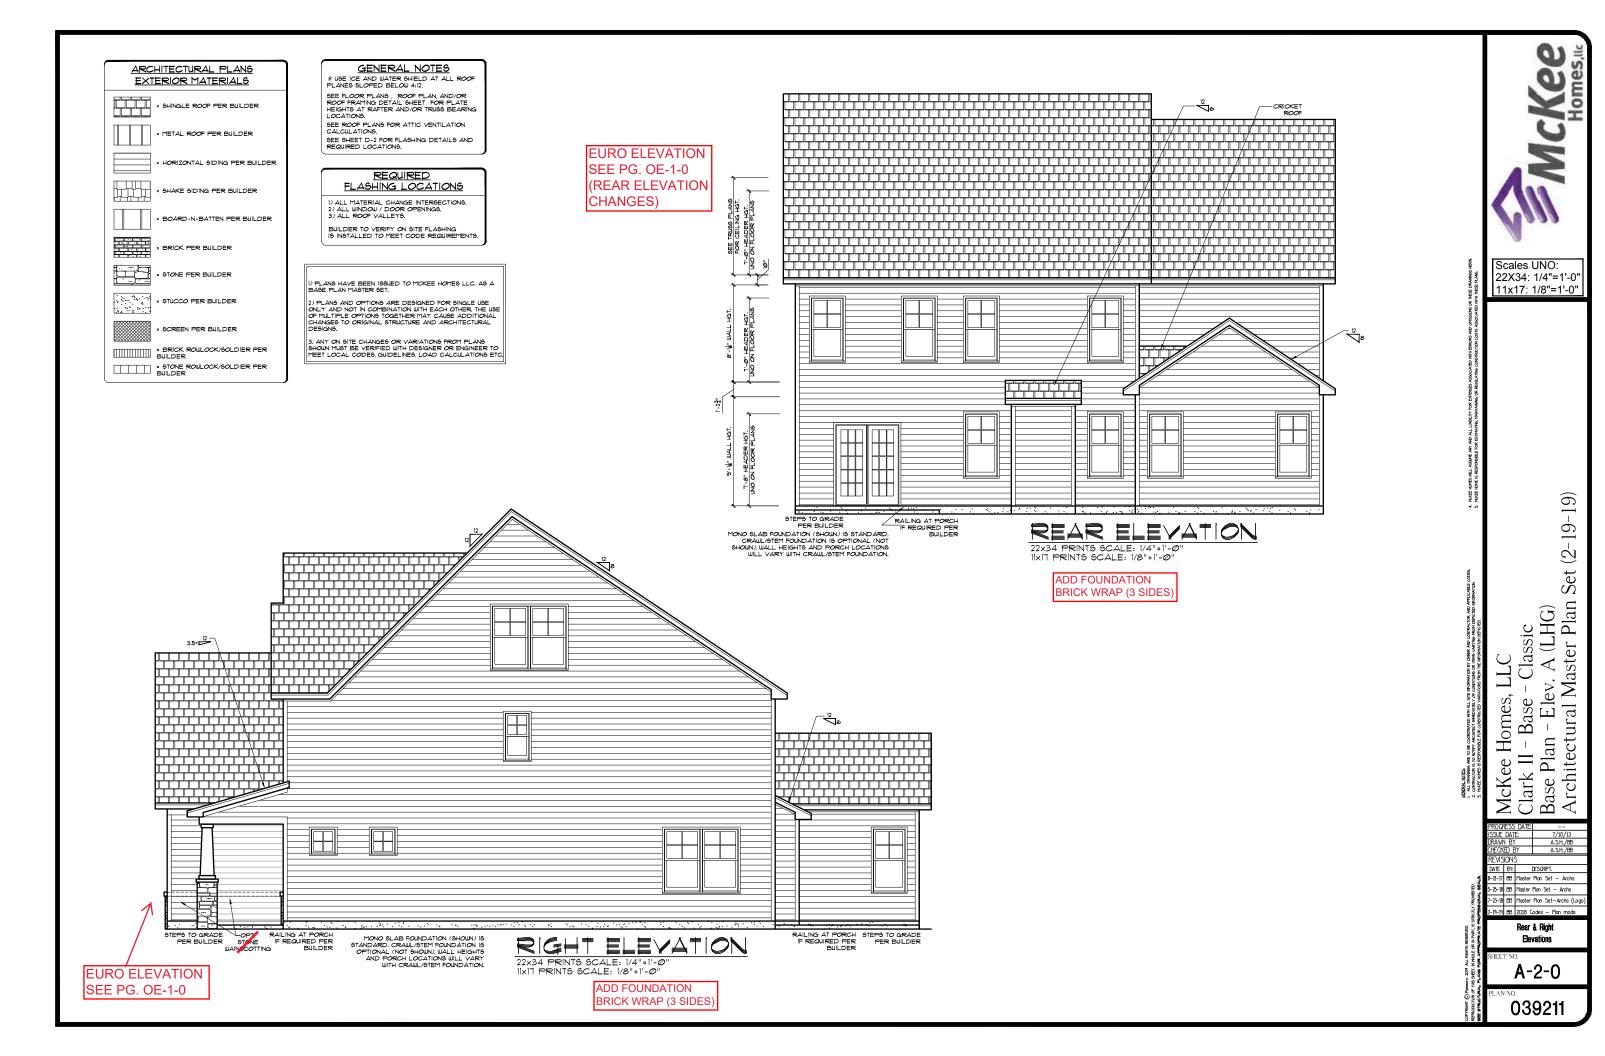

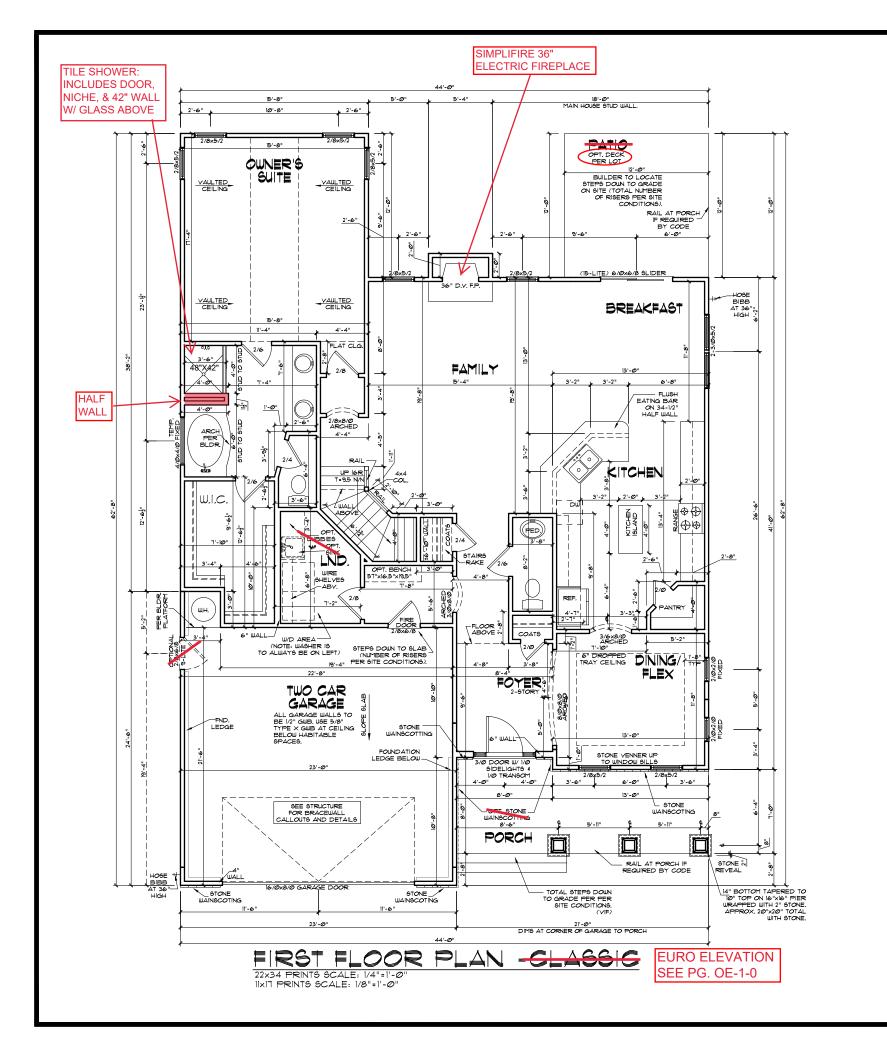

EXTERIOR DOORS/WINDOWS (DP RATING)

- ALL EXTERIOR DOORS TO BE DP4T WHEN BUILT IN HIGH WIND ZONE. - ALL EXTERIOR WINDOWS TO BE DP50 WHEN BUILT IN HIGH WIND ZONE.

#### GENERAL NOTES

WALL THICKNESS / ANGLES
ALL EXTERIOR STUD WALLS ARE DRAWN 4" THICK UNO ALL INTERIOR STUD WALLS ARE DRAWN 4" THICK UN.O. ANGLED WALLS ARE DRAWN @ 45° UN.O.

#### EGRESS

ALL BEDROOMS MUST HAVE AT LEAST ONE MINDOW WHICH CONFORMS TO EGRESS REQUIREMENTS FOR CLEAR OPENING HEIGHT AND MIDTH. IT STHE CONTRACTOR'S RESPONSIBILITY TO VERIFY EGRESS SIZING PER CODE BASED ON CHOSEN MANUFACTURER, AS PRODUCT SIZES MAY VARY.

#### WALL/CEILING HEIGHTS

WALL AND CEILING HEIGHTS NOTES ARE BASED ON NOMINAL WALL SIZE (I.E. A 3'-1 1/8" ACTUAL WALL HEIGHT IS LABELED 9/O ON THE PLANS).

ALL VAULTED OR SLOPED CEILINGS ARE TO BE FURRED DOWN TO ACCOMMODATE REQUIRED CEILING INSULATION AND I" AIRSPACE, VERIFY CODES FOR INFORMATION ON INSULATION

STAIRS

STAIR TREADS ARE MEASURED FROM NOSING TO NOSING (NA).

MAXIMUM STAIR RISE HEIGHT TO BE NO GREATER THAN 8-1/4"

## ARCHITECTURAL PLANS WALL LEGEND

= STANDARD STUD WALL INT OR EXT IF EXT SEE ELEVATIONS FOR SIDING STYLE THICKNESS OF WALL NOTED IN PLAN NOTES OR AT WALL LOCATIONS

= STANDARD STUD WALL WITH 5" BRICK VENEER

FOUNDATION WALL LEDGE
STUD THICKNESS AS NOTED IN PLAN
NOTES OR AT WALL LOCATIONS

= STANDARD STUD WALL WITH STACKED STONE VENEER STUD THICKNESS AS NOTED IN PLAN NOTES OR AT MUALL LOCATIONS

UNDER THE TO VERIFY STONE THICKNESS

4 NOTIFY PLAN DESIGNER IF THICKNESS IS

MORE THAN 5" BEFORE FOOTINGS ARE POURED)

STANDARD STUD WALL WITH APPLIED STONE VENEER
STUD THICKNESS AS NOTED IN PLAN NOTES OR AT
WALL LOCATIONS
(NOTE: NO FOUNDATION SUPPORT IS REPRESENTED
ON STRUCTURAL PLANS)
IF STACKED STONE IS TO BE USED BUILDER MUST
NOTIFY PLAN DESIGNER BEFORE FOOTINGS ARE
POURED

= STANDARD STUD WALL WITH LOW APPLIED STONE
WANSCOTING.
SEE ELEVATIONS FOR HEIGHT 4 FINISH MATERIAL
AT EXT STUD WALL ABOVE.
STUD THICKNESS AS NOTED IN PLAN
NOTES OR AT WALL LOCATIONS

\* STANDARD STUD WALL WITH 5" FOUNDATION LEDGE FOR LOW BRICK OR STACKED STONE WAINSCOTING SEE ELEVATIONS FOR HEIGHT & FINISH MATERIAL AT EXT STUD WALL ABOVE, STUD THICKNESS AS NOTED IN PLAN NOTES OR AT WALL LOCATIONS

= HALF WALL WITH IX CAP (42" HEIGHT UNLESS NOTED OTHERWISE ON PLANS,

1) PLANS HAVE BEEN 199UED TO MCKEE HOMES LLC. AS A BASE PLAN MASTER SET.

2) PLANS AND OPTIONS ARE DESIGNED FOR SINGLE USE ONLY AND NOT IN COMBINATION WITH EACH OTHER THE USE OF MULTIFLE OPTIONS TOGETHER MAY CAUSE ADDITIONAL CHANGES TO ORIGINAL STRUCTURE AND ARCHITECTURAL DESIGNS.

3, ANY ON SITE CHANGES OR VARIATIONS FROM PLANS SHOUN MUST BE VERIFIED WITH DESIGNER OR ENGINEER TO MEET LOCAL CODES, GUIDELINES, LOAD CALCULATIONS ETC.

#### WINDOW FALL PREVENTION PROTECTION

WINDOW FALL PREVENTION FOR JECTION OF A WINDOW IS LOCATED MORE THAN 12" ABOVE THE AVERTICAL GREAT OF THE CLEAR OPENING OF THE OPERABLE PORTION OF A WINDOW IS LOCATED MORE THAN 12" ABOVE THE AVERTICAL GREAT OF THE THE THE ROOM IN WHICH IT IS LOCATED.

- EXCEPTIONS:

  1. THE WINDOW IS A FIXED UNIT

  2. THE OPENING DOES NOT ALLOW THE PASSAGE OF A 4- INCH DIAMETER SPHERE.

  3. THE WINDOW IS EQUIPPED WITH A WINDOW FALL PREVENTION DEVICE MEETING ASTM F2090.

  4. THE WINDOW IS EQUIPPED WITH AN APPROVED WINDOW OPENING LIMITING DEVICE.
- NOTE: WHEN USED WITH AN EMERGENCY ESCAPE AND RESCUE WINDOW, OPENING LIMITING DEVICES AND FALL PREVENTION DEVICES MUST BE APPROVED FOR EMERGENCY ESCAPE AND RESCUE PROVISIONS.

Scales UNO: 22X34: 1/4"=1'-0" 11x17: 1/8"=1'-0"

Set (2-19-19)


Architectural

lev. A (LHG) Master Plan S Classic Elev. Homes, Base Plan McKee | lark Clark Base

-21-17 BB Master Plan Set - Archs i-25-18 BB Master Plan Set - Archs -23-18 BB Master Plan Set-Archs (Log

19-19 BB 2018 Codes - Plan ma First Floor Plan

A-4-0

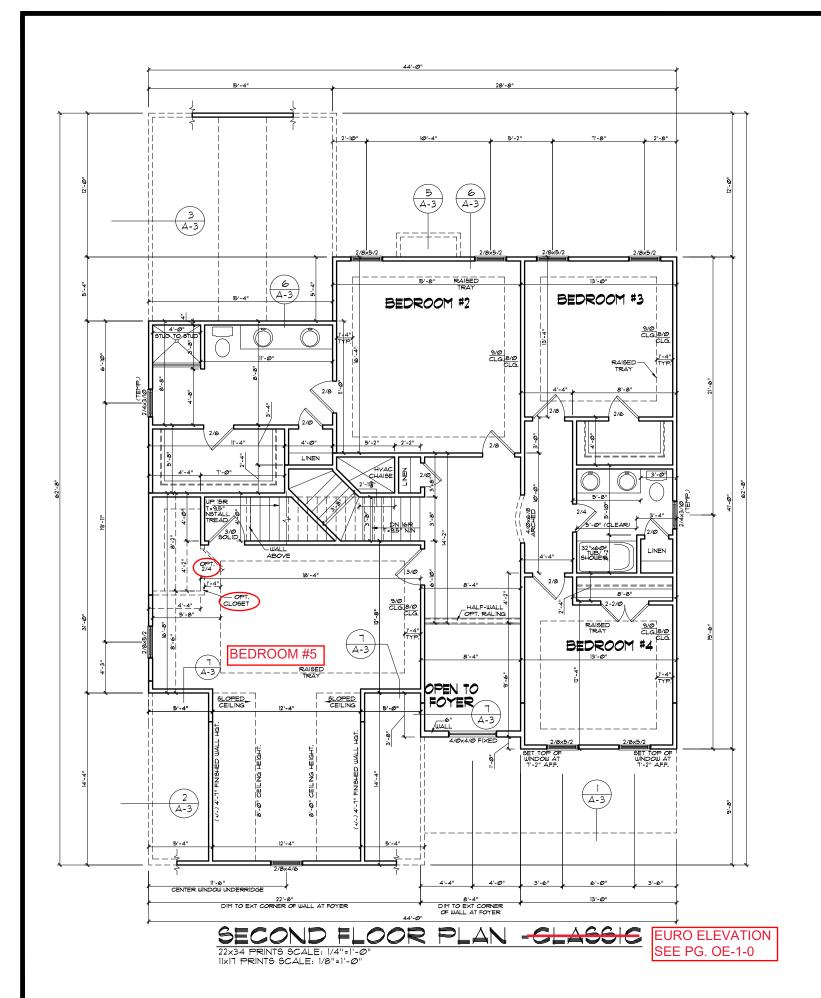

2) PLANS AND OPTIONS ARE DESIGNED FOR SINGLE USE ONLY AND NOT IN COMBINATION WITH EACH OTHER THE USE OF MULTIFILE OPTIONS TOGETHER MAY CAUSE ADDITIONAL CHANGES TO ORIGINAL STRUCTURE AND ARCHITECTURAL DESIGNS.

1) PLANS HAVE BEEN ISSUED TO MCKEE HOMES LLC. AS A BASE PLAN MASTER SET.

3. ANY ON SITE CHANGES OR VARIATIONS FROM PLANS SHOUN MUST BE VERIFIED WITH DESIGNER OR ENGINEER TO MEET LOCAL CODES, GUIDELINES, LOAD CALCULATIONS ETC.

EXTERIOR DOORS/WINDOWS (DP RATING)

- ALL EXTERIOR WINDOWS TO BE DP50 WHEN BUILT IN HIGH WIND ZONE.

## GENERAL NOTES

WALL THICKNESS / ANGLES
ALL EXTERIOR STUD WALLS ARE DRAWN 4" THICK UNO
ALL INTERIOR STUD WALLS ARE DRAWN 4" THICK UNO. ANGLED WALLS ARE DRAWN # 45° UN.O.

## EGRESS

EUNEXX
ALL BEDROOMS MUST HAVE AT LEAST ONE
MINDOW WHICH CONFORMS TO EGRESS
REQUIREMENTS FOR CLEAR OPENING HEIGHT AND
MIDTH. IT IS THE CONTRACTOR'S RESPONSIBILITY
TO VERIFY EGRESS SIZING PER CODE BASED ON
CHOSEN MANUFACTURER, AS PRODUCT SIZES MAY
VARY.

#### WALL/CEILING HEIGHTS

WALL AND CEILING HEIGHTS NOTES ARE BASED ON NOMINAL WALL SIZE (I.E. A 9'-1 1/8" ACTUAL WALL HEIGHT IS LABELED 9/O ON THE PLANS).

ALL VAULTED OR SLOPED CEILINGS ARE TO BE FURRED DOWN TO ACCOMMODATE REQUIRED CEILING INSULATION AND IN ARSPACE, VERIFY CODES FOR INFORMATION ON INSULATION

#### STAIRS

STAIR TREADS ARE MEASURED FROM NOSING TO MOSING (NN).

MAXIMUM STAIR RISE HEIGHT TO BE NO GREATER
THAN 8-1/4"

#### ARCHITECTURAL PLANS WALL LEGEND

STANDARD STUD WALL INT OR EXT
 IF EXT SEE ELEVATIONS FOR SIDING
 STYLE THICKNESS OF WALL NOTED IN PLAN NOTES
 OR AT WALL LOCATIONS

= STANDARD STUD WALL WITH 5" BRICK VENEER FOUNDATION WALL LEDGE STUD THICKNESS AS NOTED IN PLAN NOTES OR AT WALL LOCATIONS

# STANDARD STUD WALL WITH STACKED STONE VENEER
STUD THICKNESS AS NOTED IN PLAN NOTES OR AT
WALL LOCATIONS
(NOTE BUILDER TO VERIFY STONE THICKNESS)
4 NOTIFY PLAN DESIGNER IF THICKNESS IS
MORE THAN 5" BEFORE FOOTINGS ARE POURED)

STANDARD STUD WALL WITH APPLIED STONE VENEER STUD THICKNESS AS NOTED IN PLAN NOTES OR AT WALL LOCATIONS
(NOTE: NO FOUNDATION SUPPORT IS REPRESENTED ON STRUCTURAL PLANS)
IF STACKED STONE IS TO BE USED BUILDER MUST NOTIFY PLAN DESIGNER BEFORE FOOTINGS ARE POURED.

= STANDARD STUD WALL WITH LOW APPLIED STONE
WANGCOTING.
SEE ELEVATIONS FOR HEIGHT & FINISH MATERIAL
AT EXT STUD WALL ABOVE.
STUD THICKNESS AS NOTED IN PLAN
NOTES OR AT WALL LOCATIONS STANDARD STUD WALL WITH 5" FOUNDATION LEDGE
FOR LOW BRICK OR STACKED STONE WAINSCOTING
SEE ELEVATIONS FOR HEIGHT 4 FINISH MATERIAL
AT EXT STUD WALL ABOVE, STUD THICKNESS
AS NOTED IN PLAN NOTES OR AT WALL LOCATIONS

= HALF WALL WITH IX CAP (42" HEIGHT UNLESS NOTED OTHERWISE ON PLANS)

WINDOW FALL PREVENTION PROTECTION

WINDOW FALL PREVENTION FOR THE OPERABLE PORTION OF A WINDOW IS LOCATED MORE THAN 12" ABOVE THE EXTERIOR GRADE THEN THE LOWEST PART OF THE CLEAR OPENING WIST BE AT LEAST 24" ABOVE THE LOOP OF THE THE ROOM IN WHICH IT IS LOCATED.

EXCEPTIONS:

I. THE MINDOW IS A FIXED UNIT

2. THE OPENING DOES NOT ALLOW THE PASSAGE OF A 4- INCH DIAMETER SPHERE.

3. THE MINDOW IS EQUIPPED WITH A MINDOW FALL PREVENTION DEVICE MEETING ASTM F2090.

4. THE MINDOW IS EQUIPPED WITH AN APPROVED WINDOW OPENING LIMITING DEVICE.

NOTE: WHEN USED WITH AN EMERGENCY ESCAPE AND RESCUE WINDOW, OPENING LIMITING DEVICES AND FALL PREVENTION DEVICES MUST BE APPROVED FOR EMERGENCY ESCAPE AND RESCUE PROVISIONS.

Scales UNO: 22X34: 1/4"=1'-0" 11x17: 1/8"=1'-0"

Set (2-19-19)

e - Classic lev. A (LHG) Master Plan S Homes, Base McKee I Clark II Base Pla

Elev.

1


Plan

Architectural

-21-17 BB Master Plan Set - Archs i-25-18 BB Master Plan Set - Archs -23-18 BB Master Plan Set-Archs (Log -19-19 BB 2018 Codes - Plan mod

Second Floor Plan

A-5-0

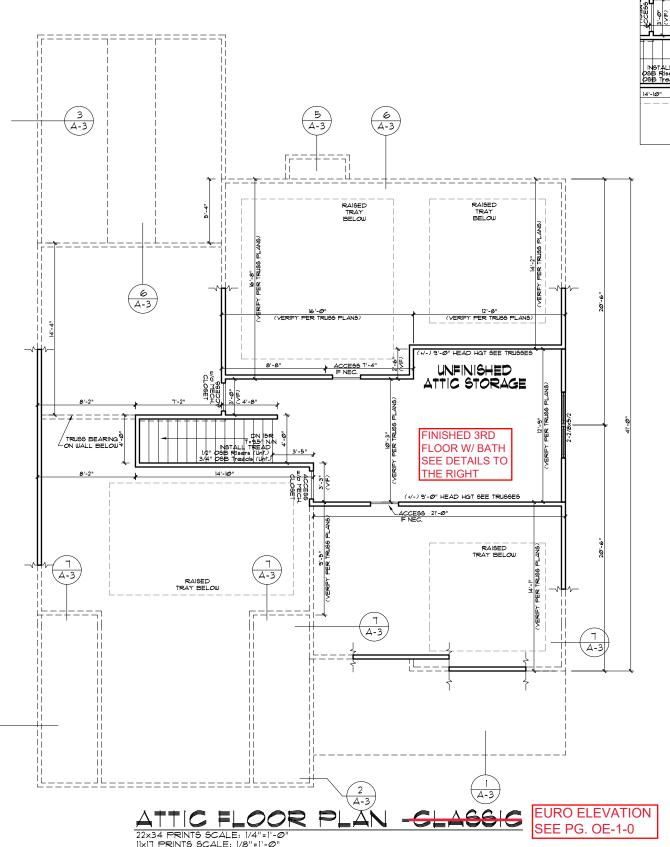

2 A-3


I) PLANS HAVE BEEN ISSUED TO MCKEE HOMES LLC. AS A BASE PLAN MASTER SET. 2) PLANS AND OPTIONS ARE DESIGNED FOR SINGLE USE ONLY AND NOT IN COMBINATION WITH EACH OTHER, THE USE OF MULTIPLE OPTIONS TOGETHER MAY CAUSE ADDITIONAL CHANGES TO ORIGINAL STRUCTURE AND ARCHITECTURAL DESIGNS.

EXTERIOR DOORS/WINDOWS (DP RATING)
- ALL EXTERIOR DOORS TO BE DP41 WHEN
BUILT IN HIGH WIND ZONE.
- ALL EXTERIOR WINDOWS TO BE DP50 WHEN
BUILT IN HIGH WIND ZONE. 3. ANY ON SITE CHANGES OR VARIATIONS FROM PLANS SHOWN MUST BE VERIFIED WITH DESIGNER OR ENGINEER TO MEET LOCAL CODES, GUIDELINES, LOAD CALCULATIONS ETC.

MECH. CLOSET \*
- WITH FINISHED
ATTIC ONLY ) 9'-0" HEAD HGT SEE TRUSSE SEE BELOW FINISHED FRONT SINGLE ATTIC ₽Š튜® (+/-) 9'-@" HEAD HGT SEE TRUSSES -ACCESS 21'-@"

## FINISHED ATTIC FLOOR PLAN

22×34 PRINTS SCALE: 1/4"=1'-0"
11×17 PRINTS SCALE: 1/8"=1'-0"

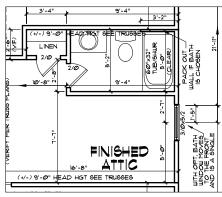

OPT. BATH FLOOR PLAN 22×34 PRINTS SCALE: 1/4"=1'-@ 11×17 PRINTS SCALE: 1/8"=1'-@"

#### ATTIC NOTES

I, KNEEWALLS IN UNFINISHED ATTIC ARE OPTIONAL, UNLESS USED TO SUPPORT RAFTERS (SEE STRUCTURAL SHEETS), KNEEWALL LOCATION/HEIGHT MAY BE ADJUSTED IN THE FIELD IF THESE WALLS ARE NOT LOAD BEARING.

2. CEILING LINES SHOUN IN UNFINISHED ATTIC MAY BE JUST FOR REPRESENTATION OF FUTURE FLAT CEILINGS, IF A FLAT CEILING IS DESIRED, THIS WILL HAVE TO BE COORDINATED WITH THE STRUCTURAL PLANS.

## GENERAL NOTES

ANGLED WALLS ARE DRAWN @ 45° UN.O.

WALL THICKNESS / ANGLES
ALL EXTERIOR STUD WALLS ARE DRAWN 4" THICK UNO ALL INTERIOR STUD WALLS ARE DRAWN 4" THICK UN.O.

#### EGRESS

ALL BEDROOMS MUST HAVE AT LEAST ONE MINDOW MHICH CONFORMS TO EGRESS REQUIREMENTS FOR CLEAR OPENING HEIGHT AND MIDTH. IT IS THE CONTRACTOR'S RESPONSIBILITY TO VERIFY EGRESS SIZING PER CODE BASED ON CHOSEN MANUFACTURER, AS PRODUCT SIZES MAY VARY.

#### WALL/CEILING HEIGHTS

WALL AND CEILING HEIGHTS NOTES ARE BASED ON NOMINAL WALL SIZE (I.E. A 9'-1 1/8" ACTUAL WALL HEIGHT IS LABELED 9/O ON THE PLANS).

ALL VAULTED OR SLOPED CEILINGS ARE TO BE FURRED DOWN TO ACCOMMODATE REQUIRED CEILING INSULATION AND I" AIRSPACE, VERIFY CODES FOR INFORMATION ON INSULATION

STAIRS

STAIR TREADS ARE MEASURED FROM NOSING TO NOSING (NA).

MAXIMUM STAIR RISE HEIGHT TO BE NO GREATER THAN 8-1/4"

#### ARCHITECTURAL PLANS WALL LEGEND

= STANDARD STUD WALL INT OR EXT IF EXT SEE ELEVATIONS FOR SIDING STYLE THICKNESS OF WALL NOTED IN PLAN NOTES OR AT WALL LOCATIONS

= STANDARD STUD WALL WITH 5" BRICK VENEER

FOUNDATION WALL LEDGE
STUD THICKNESS AS NOTED IN PLAN
NOTES OR AT WALL LOCATIONS = STANDARD STUD WALL WITH STACKED STONE VENEER STUD THICKNESS AS NOTED IN PLAN NOTES OR AT

MURL LOCATIONS

WALL LOCATIONS

(NOTE BUILDER TO VERIFY STONE THICKNESS IS

MOTER THAN 5" BEFORE FOOTINGS ARE POURED)

= 9TANDARD STUD WALL WITH APPLIED STONE VENEER
STUD THICKNESS AS NOTED IN PLAN NOTES OR AT
WALL LOCATIONS
(NOTE: NO TENDATION SUPPORT IS REPRESENTED
ON STRUCTURAL PLANS)
IF STACKED STONE IS TO BE USED BUILDER MUST
NOTIFY PLAN DESIGNER BEFORE FOOTINGS ARE
POURED

= 9TANDARD STUD WALL WITH LOW APPLIED STONE
WANSCOTING.
9EE ELEVATIONS FOR HEIGHT 4 FINISH MATERIAL
AT EXT STUD WALL ABOVE.
9TUD THICKNESS AS NOTED IN PLAN
NOTES OR AT WALL LOCATIONS

= STANDARD STUD WALL WITH 5" FOUNDATION LEDGE FOR LOW BRICK OR STACKED STONE WAINSCOTING SEE ELEVATIONS FOR HEIGHT & FINISH MATERIAL AT EXT STUD WALL ABOVE, STUD THICKNESS AS NOTED IN PLAN NOTES OR AT WALL LOCATIONS

= HALF WALL WITH IX CAP (42" HEIGHT UNLESS NOTED OTHERWISE ON PLANS,

#### WINDOW FALL PREVENTION PROTECTION

IF ANY PART OF THE CLEAR OPENING OF THE OPERABLE PORTION OF A WINDOW IS LOCATED MORE THAN 12' ABOVE THE EXTERIOR GRADE THEN THE LONEST PART OF THE CLEAR OPENING MUST BE AT LEAST 24' ABOVE THE FLOOR OF THE ROOM IN WHICH IT IS LOCATED.

EXCEPTIONS:

1. THE WINDOW IS A FIXED UNIT

2. THE OPENING DOES NOT ALLOW THE PASSAGE OF A 4- INCH DIAMETER SPHERE.

3. THE WINDOW IS EQUIPPED WITH A WINDOW FALL PREVENTION DEVICE MEETING ASTM F2090.

4. THE WINDOW IS EQUIPPED WITH AN APPROVED WINDOW OPENING LIMITING DEVICE.

NOTE: WHEN USED WITH AN EMERGENCY ESCAPE AND RESCUE WINDOW, OPENING LIMITING DEVICES AND FALL PREVENTION DEVICES MUST BE APPROVED FOR EMERGENCY ESCAPE AND RESCUE PROVISIONS.

-23-18 BB Master Plan Set-Archs (Log 19-19 BB 2018 Codes - Plan n

Attic Floor Plan

-21-17 BB Master Plan Set - Archs i-25-18 BB Master Plan Set - Archs

Scales UNO:

22X34: 1/4"=1'-0" 11x17: 1/8"=1'-0"

Set (2-19-19)

e - Classic lev. A (LHG) Master Plan S

Elev.


Plan

McKee I Clark II Base Pla

Architectural

Homes, Base

A-6-0

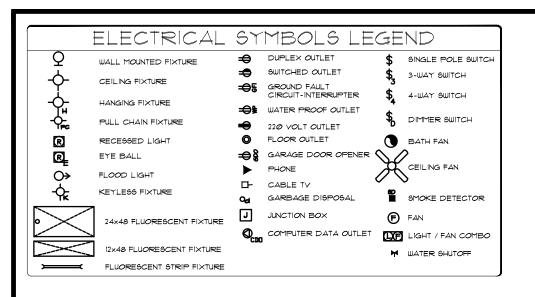

#### ELECTRICAL:

- ALL SWITCHES TO BE MOUNTED 3'-10" ABOVE FINISHED FLOOP UNLESS OTHERWISE NOTED.
- UL. SMOKE DETECTORS SHALL BE LOCATED IN ALL BEDROOM AND ONE EACH ADDITIONALLY AT EACH LEVEL, OTHER LOCAT SHOWN ON DRAWINGS. HARDWIRE ALL DETECTORS TOGETHER, AND PROVIDE BATTERY BACK-UP.

ELECTRICAL NOTES

- LAYOUT WITH BUILDER AND/OR HOMEOUNER.
  BUILDER/HOMEOWNER SPECIFICATIONS WILL OVERRIDE
  THESE DOCUMENTS.

- UPGRADED LIGHTING PACKAGE

  1. ALL CELING MOUNTS TO BE REPLACED WITH RECESSE
  CAN LIGHTS IN MAIN LIVING AREAS INCLUDING:
   FAMILY
   KICHEN
   HALLWAYS

- ELECTRICAL NOTES


   ONLY ONE PHONE LINE IS INCLUDED IN BASE HOUSE

  -- ALL OTHER PHONE LINES ARE OPTIONAL
- UNDER-CABINET LIGHTING 18 OPTIONAL RECEPTACLES ARE TO BE INSTALLED AS STANDARI PER LATEST CODE REQUIREMENTS

PLANS HAVE BEEN 16SUED TO MCKEE HOMES LLC. AS A BASE PLAN MASTER SET.

2) PLANS AND OPTIONS ARE DESIGNED FOR SINGLE USE ONLY AND NOT IN COMBINATION WITH EACH OTHER, THE USE OF MULTIPLE OPTIONS TOGETHER MAY CAUSE ADDITIONAL CHANGES TO ORIGINAL STRUCTURE AND ARCHITECTURAL


3. ANY ON SITE CHANGES OR VARIATIONS FROM PLANS SHOUN MUST BE VERIFIED WITH DESIGNER OR ENGINEER TO MEET LOCAL CODES, GUIDELINES, LOAD CALCULATIONS ETC.

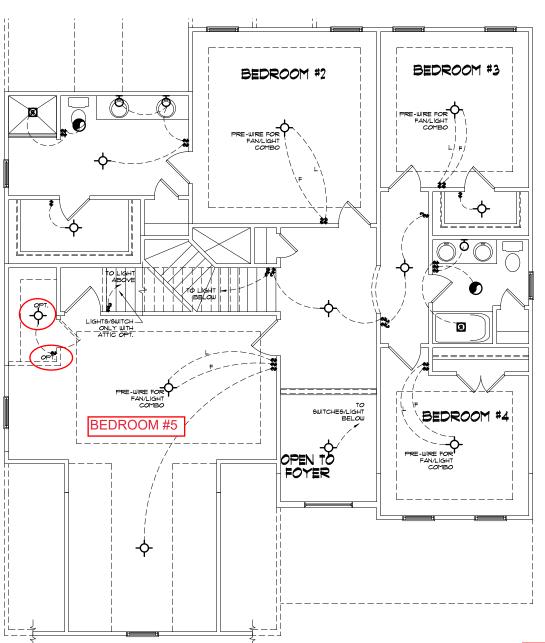

SECOND FLOOR LIGHTING - CLASSIC

IIXIT PRINTS SCALE: 1/8"=1'-0"

**EURO ELEVATION** SEE PG. OE-1-0

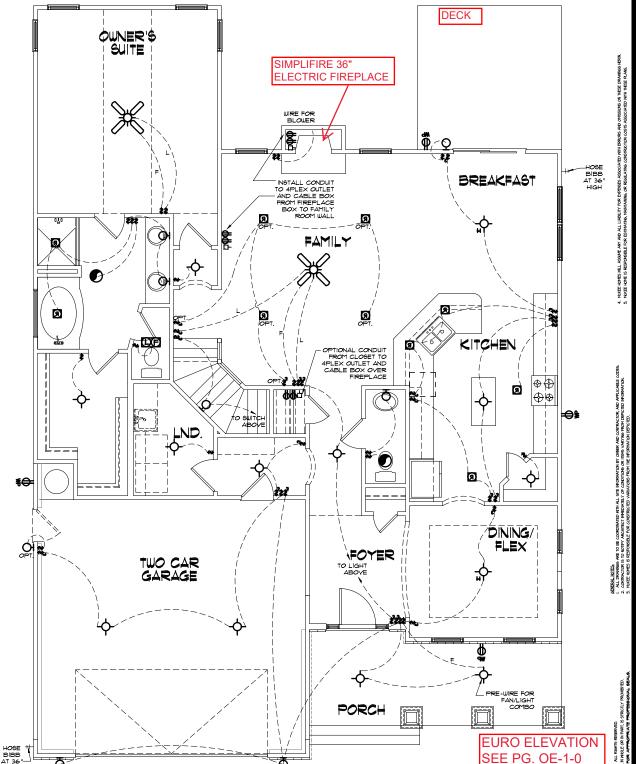

Scales UNO:

22X34: 1/4"=1'-0" 11x17: 1/8"=1'-0"

McKee Homes, Architectural Plan Clark Base F 21-17 BB Master Plan Set - Archs -25-18 BB Master Plan Set - Archs 3-18 BB Master Plan Set-Archs (L First & Second Floor

Set (2-19-19)


e - Classic lev. A (LHG) Master Plan S

Elev.

Lighting **AE-1-0** 

039211

FIRST FLOOR LIGHTING -CLASSIC 22x34 PRINTS SCALE: 1/4"=1'-0 11x17 PRINTS SCALE: 1/8"=1'-0"

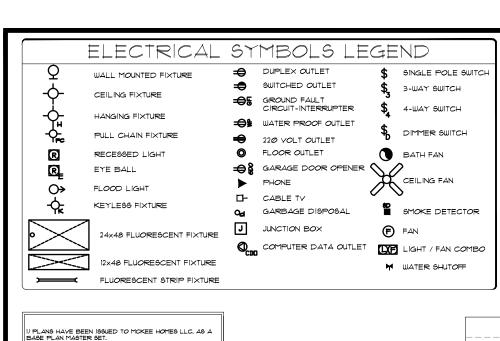

2) PLANS AND OPTIONS ARE DESIGNED FOR SINGLE USE ONLY AND NOT IN COMBINATION WITH EACH OTHER. THE USE OF MULTIFILE OPTIONS TOGETHER MAY CAUSE ADDITIONAL CHANGES TO ORIGINAL STRUCTURE AND ARCHITECTURAL DESIGNS.

3, ANY ON SITE CHANGES OR VARIATIONS FROM PLANS SHOWN MUST BE VERIFIED WITH DESIGNER OR ENGINEER TO MEET LOCAL CODES, GUIDELINES, LOAD CALCULATIONS ETC.

INSTALL GROUND FAULT RECEPTACLES IN BATHROOMS, KITCHENS, AND OTHER WET LOCATIONS AS REQUIRED BY N.E.C. 210-8. ELECTRICAL NOTES

1. ELECTRICAL CONTRACTOR MUST CONFIRM ELECTRICAL LAYOUT WITH BUILDER AND/OR HOMEOUNER.
BUILDER/HOMEOUNER SPECIFICATIONS WILL OVERRIDE THESE DOCUMENTS. 2. VERIFY LOCATION OF 240V. RECEPTACLES, AS GAS APPLIANCES MAY BE SUBSTITUTED FOR ELECTRICAL IN SOME CASES. UPGRADED LIGHTING PACKAGE

1. ALL CELING MOUNTS TO BE REPLACED WITH RECESSE
CAN LIGHTS IN MAIN LIVING AREAS INCLUDING:
FAMILY
KITCHEN
HALLWAYS

FINISHED ATTIC

22X34 PRINTS SCALE: 1/4"=1'-0"
11x17 PRINTS SCALE: 1/8"=1'-0"

ADD BATH

SEE DETAIL TO LEFT

FINISHED ATTIC

PRE-WIRE FOR

FAN/LIGHT COMBO

ALL ELECTRICAL DESIGN AND INSTALLATION IS TO CONFORM TO THE NATIONAL ELECTRICAL CODE, LATEST EDITION. ALL EQUIPMENT SHALL BE U.L. LABELED.

ALL SWITCHES TO BE MOUNTED 3'-10" ABOVE FINISHED FLOOR UNLESS OTHERWISE NOTED.

INSTALL CONVENIENCE OUTLETS AT 18" ABOVE FINISHED FLOOR MAXIMM SPACING 12"-0" O.C. INSTALL AT ALL WALLS OF 24" OR GREATER WIDTH,

UL. SMOKE DETECTORS SHALL BE LOCATED IN ALL BEDROOMS, AND ONE EACH ADDITIONALLY AT EACH LEVEL, OTHER LOCATIONS SHOWN ON DRAWINGS, HARDWIRE ALL DETECTORS TOGETHER, AND PROVIDE BATTERY BACK-UP.

ELECTRICAL NOTES

- ONLY ONE PHONE LINE 15 INCLUDED IN BASE HOUSE

-- ALL OTHER PHONE LINES ARE OPTIONAL


ELECTRICAL

3,52

UNFINISHED ATTIC STORAGE **₽** SWITCH BELOW FINISHED 3RD FLOOR W/ BATH SEE DETAILS TO THE LEFT **EURO ELEVATION** SEE PG. 0E-1-0

ATTIC FLOOR LIGHTING

22×34 PRINTS SCALE: 1/4"=1'-0"
11×17 PRINTS SCALE: 1/8"=1'-0"

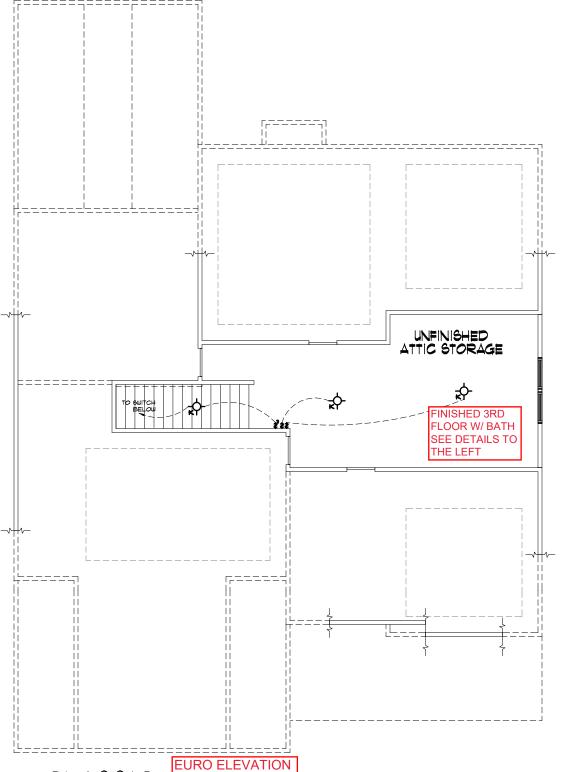

Scales UNO:

22X34: 1/4"=1'-0"

11x17: 1/8"=1'-0"


Clark II - Base - Classic Base Plan - Elev. A (LHG) Architectural Master Plan McKee Homes, I Clark II - Base -Base Plan - Elev.

Set (2-19-19)


21-17 BB Moster Plan Set - Archs i-25-18 BB Master Plan Set - Archs 23-18 BB Master Plan Set-Archs (Log

Attic Floor Lighting

**AE-2-0** 

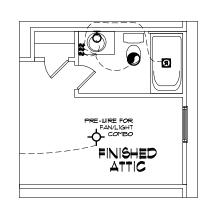

OPT. BATH 22×34 PRINTS SCALE: 1/4"=1"-@" 11x17 PRINTS SCALE: 1/8"=1'-0"

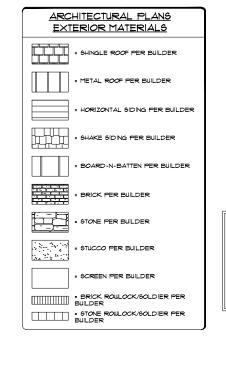

## GENERAL NOTES

¥ USE ICE AND WATER SHIELD AT ALL ROOF PLANES SLOPED BELOW 4:12.

SEE FLOOR PLANS, ROOF PLAN, AND/OR ROOF FRAMING DETAIL SHEET FOR PLATE HEIGHTS AT RAFTER AND/OR TRUSS BEARING LOCATIONS.

SEE ROOF PLANS FOR ATTIC VENTILATION CALCULATIONS.

SEE SHEET D-2 FOR FLASHING DETAILS AND REQUIRED LOCATIONS.

#### REQUIRED FLASHING LOCATIONS

1) ALL MATERIAL CHANGE INTERSECTIONS. 2) ALL WINDOW / DOOR OPENINGS. 3) ALL ROOF VALLEYS.

BUILDER TO VERIFY ON SITE FLASHING IS INSTALLED TO MEET CODE REQUIREMENTS


1) PLANS HAVE BEEN ISSUED TO MCKEE HOMES LLC. AS A BASE PLAN MASTER SET.

2) PLANS AND OPTIONS ARE DESIGNED FOR SINGLE USE ONLY AND NOT IN COMBINATION WITH EACH OTHER. THE USE OF MULTIFLE OPTIONS TOGETHER MAY CAUSE ADDITIONAL CHANGES TO ORIGINAL STRUCTURE AND ARCHITECTURAL

3. ANY ON SITE CHANGES OR VARIATIONS FROM PLANS SHOUN MUST BE VERIFIED WITH DESIGNER OR ENGINEER TO MEET LOCAL CODES, GUIDELINES, LOAD CALCULATIONS ETC.

THIS IS MEANT TO BE AN OPTION SHEET. SEE BASE PLAN FOR MORE INFORMATION




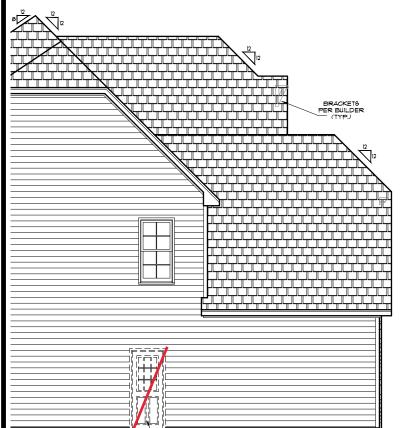

MONO SLAB FOUNDATION (SHOUN) IS ITANDARD, CRAWL/STEM FOUNDATION IS OPTIONAL (NOT SHOUN), WALL HEIGHTS AND PORCH LOCATIONS WILL VARY WITH CRAWL/STEM FOUNDATION.

ADD FOUNDATION **BRICK WRAP (3 SIDES)** 

ELEVATION 22×34 PRINTS SCALE: 1/4"=1'-@' 11x17 PRINTS SCALE: 1/8"=1"-0"

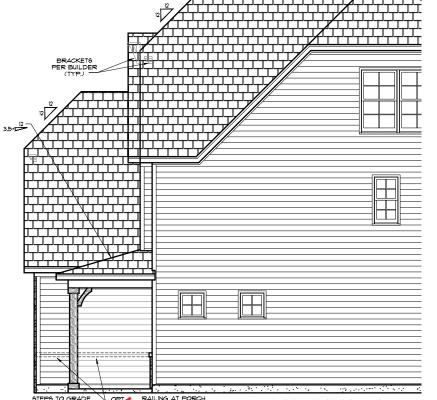

11x17 PRINTS SCALE: 1/8"=1'-0"

MONO SLAB FOUNDATION (SHOUN) IS STANDARD, CRAWL/STEM FOUNDATION IS OPTIONAL (NOT SHOUN), WALL HEIGHTS AND PORCH LOCATIONS WILL YARY WITH CRAWL/STEM FOUNDATION.

ADD FOUNDATION BRICK WRAP (3 SIDES)



NOTE: THIS PLAN ELEVATION PRODUCED BY GMD DESIGN GROUP, IS DERIVATIVE WORKS OF THE CLARK IF BY PLANWORK ARCHITECTURE, P.A. FOR MCKEE HOMES WITH WRITTEN PERMISSION OBTAINED BY THE BUILDERFOWNER FOR REPRODUCTION WITH MODIFICATION NOT THE PURCHASE LETTER DATED. JANUARY 20th, 2014; ADDRESSED TO PAT MCKEE AT MCKEE HOMES, THE BUILDERFOWNER ES TO REVIEW AND APPROVED PLANS COORDINATION PRIOR TO CONSTRUCTION BEGINNING.

22×34 PRINTS SCALE: 1/4"=1"-@ IIXIT PRINTS SCALE: 1/8"=1'-0"



REAR ELEVATION

22×34 PRINTS SCALE: 1/8"=1'-0"
11×17 PRINTS SCALE: 1/16"=1'-0"

ADD FOUNDATION BRICK WRAP (3 SIDES Scales UNO:

22X34: 1/4"=1'-0" 11x17: 1/8"=1'-0"

– Euro E (LHG) McKee Homes, LLC Clark II - Option - Eu Base Plan - Elev. E (I

Set (2-19-19)

Architectural Master Plan 21-17 BB Moster Plan Set - Archs

-25-18 BB Master Plan Set - Archs 23-18 BB Master Plan Set-Archs (Loc Exterior Elevations

Elevations

OE-1-0

GENERAL NOTES

\* USE ICE AND WATER SHIELD AT ALL ROOF PLANES SLOPED BELOW 4:12.

SEE FLOOR PLANS, ROOF PLAN, AND/OR ROOF FRAMING DETAIL SHEET FOR PLATE HEIGHTS AT RAFTER AND/OR TRUSS BEARING LOCATIONS.

SEE ROOF PLANS FOR ATTIC VENTILATION CALCULATIONS.

SEE SHEET D-2 FOR FLASHING DETAILS AND REQUIRED LOCATIONS.

#### REQUIRED FLASHING LOCATIONS

ALL MATERIAL CHANGE INTERSECTIONS.
 ALL WINDOW / DOOR OPENINGS.
 ALL ROOF VALLEYS.

BUILDER TO VERIFY ON SITE FLASHING IS INSTALLED TO MEET CODE REQUIREMENTS.

I) PLANS HAVE BEEN ISSUED TO MCKEE HOMES LLC. AS A BASE PLAN MASTER SET.


2) PLANS AND OPTIONS ARE DESIGNED FOR SINGLE USE ONLY AND NOT IN COMBINATION WITH EACH OTHER THE USE OF MULTIPLE OPTIONS TOGETHER MAY CAUSE ADDITIONAL CHANGES TO ORIGINAL STRUCTURE AND ARCHITECTURAL DESIGNS.


3. ANY ON SITE CHANGES OR VARIATIONS FROM PLANS SHOWN MUST BE VERIFIED WITH DESIGNER OR ENGINEER TO MEET LOCAL CODES, GUIDELINES, LOAD CALCULATIONS ETC.


NOTE: THIS PLAN ELEVATION PRODUCED BY GMD DESIGN GROUP, IS DERIVATIVE WORKS OF THE CLARK IF BY PLANWORK ARCHITECTURE, P.A. FOR MKNEE HOMES WITH WRITTEN PERMISSION OBTAINED BY THE BUILDERCOWNEE FOR REPRODUCTION WITH MODIFICATION IN THE PURCHASE, LETTER DATED, JACKARY 28th, 2014; ADDRESSED TO PAT MKREE AT MKKEE HOMES, THE BUILDERCOWNER IS TO REVIEW AND APPROVED HANS COORDINATION PRIOR TO CONSTRUCTION BEGINNING.

REFER TO STRUCTURAL SHEETS & TRUSS LAYOUT PLANS TO CONFIRM FLOOR MEMBER SIZE & DIRECTIONS, RAFTER / TRUSS SIZES

\*\*NOTE: DETAILS PROVIDED ARE FOR PLATE DETAILS ONLY. 4 DIRECTIONS, TRUSS WEBBING AND ROOF OVERHANGS.

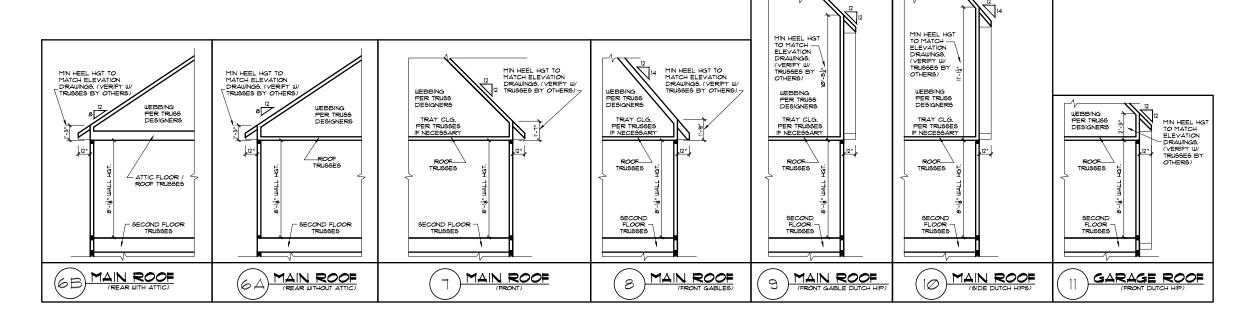

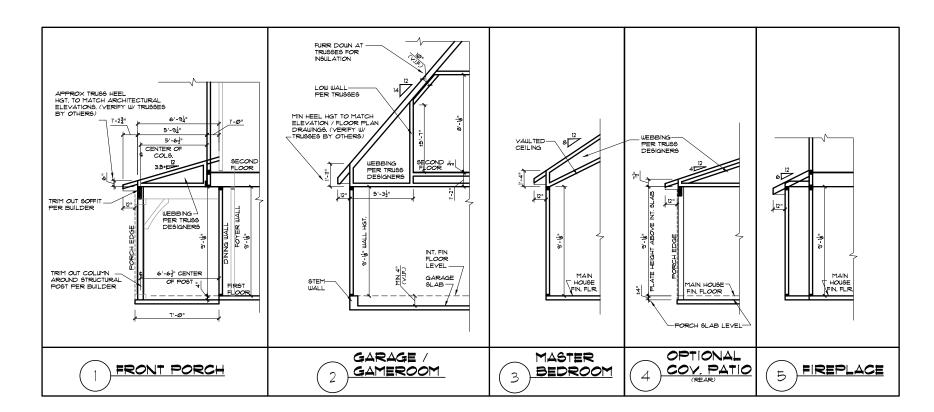

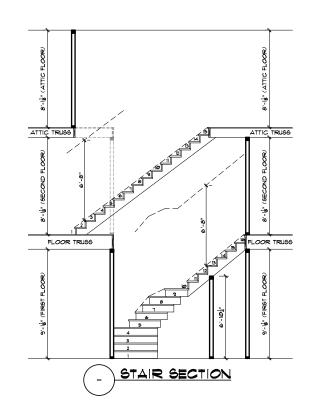

McKee

Scales UNO: 22X34: 1/4"=1'-0" 11x17: 1/8"=1'-0"


Set (2-19-19)

Architectural Master Plan McKee Homes, LLC Clark II - Option - Eu Base Plan - Elev. E (I 21-17 BB Master Plan Set - Archs i-25-18 BB Master Plan Set - Archs 23-18 BB Master Plan Set-Archs (Log 19-19 BB 2018 Codes - Plan mode

– Euro E (LHG)

**Roof Plate Details** 

OE-2-0

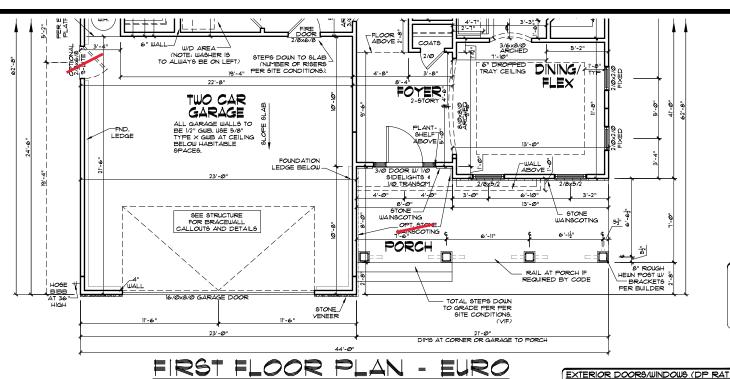

\_ PRE-WIRE FOR FAN/LIGHT COMBO PORCH

FIRST FLOOR LIGHTING

IIXIT PRINTS SCALE: 1/8"=1'-0"

NOTE: THIS PLAN ELEVATION PRODUCED BY GMD DESIGN GROUP, IS DERIVATIVE WORKS OF "THE CLARK IF BY PLANWORX ARCHITECTURE, P.A. FOR MCKEE HOMES WITH WRITTEN PERMISSION OBTAINED BY THE BUILDER/OWNER FOR REPRODUCTION WITH MODIFICATION IN THE PURCHASE LETTER DATED, JANUARY 20th, 2014. ADDRESSED TO PAT MCKEE AT MCKEE HOMES. THE BUILDER/OWNER IS TO REVIEW AND APPROVE PLANS COORDINATION PRIOR TO CONSTRUCTION BEGINNING


#### ELECTRICAL:

- ALL ELECTRICAL DESIGN AND INSTALLATION IS TO CONFORM TO THE NATIONAL ELECTRICAL CODE, LATEST EDITION. ALL EQUIPMENT SHALL BE U.L. LABELED.
- ALL SMITCHES TO BE MOUNTED 3'-10" ABOVE FINISHED FLOOR UNLESS OTHERWISE NOTED.
- INSTALL CONVENIENCE OUTLETS AT 18" ABOVE FINISHED FLOOR, MAXIMUM SPACING 12"-0" O.C. INSTALL AT ALL WALLS OF 24" OR GREATER WIDTH.
- 4) U.I. SMOKE DETECTORS SHALL BE LOCATED IN ALL BEDROOMS, AND ONE EACH ADDITIONALLY AT EACH LEVEL, OTHER LOCATIONS SHOWN ON DRAWINGS. HARDWIRE ALL DETECTORS TOGETHER, AND PROVIDE BATTERY BACK-UP.
- INSTALL GROUND FAULT RECEPTACLES IN BATHROOMS, KITCHENS, AND OTHER WET LOCATIONS AS REQUIRED BY N.E.C. 210-8.

ELECTRICAL NOTES

1. ELECTRICAL CONTRACTOR MUST CONFIRM ELECTRICAL
LAYOUT WITH BUILDER AND/OR HOMEOUNER
BUILDER/HOMEOUNER SPECIFICATIONS WILL OVERRIDE
THESE DOCUMENTS.

2. VERIFY LOCATION OF 240V. RECEPTACLES, AS GAS APPLIANCES MAY BE SUBSTITUTED FOR ELECTRICAL IN SOME CASES

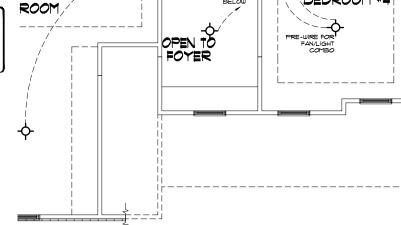

SECOND FLOOR LIGHTING 22x34 PRINTS SCALE: 1/4"=1"-0"

1) PLANS HAVE BEEN ISSUED TO MOKEE HOMES LLC. AS A BASE PLAN MASTER SET.

2) PLANS AND OPTIONS ARE DESIGNED FOR SINGLE USE ONLY AND NOT IN COMEINATION WITH EACH OTHER THE USE OF MULTIFLE OPTIONS TOGETHER MAY CAUSE APDITIONAL CHANGES TO ORIGINAL STRUCTURE AND ARCHITECTURAL DESIGNS.


3. ANY ON SITE CHANGES OR VARIATIONS FROM PLANS SHOUN MUST BE VERIFIED WITH DESIGNER OR ENGINEER TO MEET LOCAL CODES, GUIDELINES, LOAD CALCULATIONS ETC.

CLARK II - EU	RO
Heated Square Footage	
First Floor Htd.	1,716
Second Floor Htd.	1,648
TOTAL HTD. =	3,364
Unheated Square Footage	
Covered Porch - Front	155
Garage - Two Car	5Ø1
Rear Patio	144
Unfin Attic Storage	353

- ALL EXTERIOR DOORS T BUILT IN HIGH WIND ZONE.

EXTERIOR DOORS/WINDOWS (DP RATING)
- ALL EXTERIOR DOORS TO BE DP41 WHEN

- ALL EXTERIOR WINDOWS TO BE DP50 WHEN BUILT IN HIGH WIND ZONE.

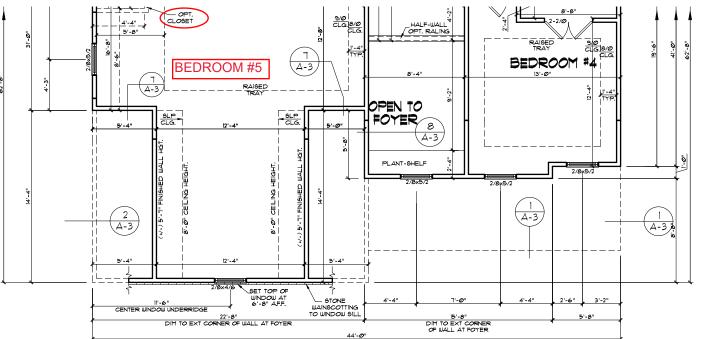

SECOND FLOOR PLAN - EURO

22x34 PRINTS SCALE: 1/4"=1'-0"
IIxIT PRINTS SCALE: 1/8"=1'-0"

22x34 PRINTS SCALE: 1/4"=1'-@

11x17 PRINTS SCALE: 1/8"=1'-0'

#### GENERAL NOTES WALL THICKNESS / ANGLES

ALL EXTERIOR STUD WALLS ARE DRAWN 4" THICK UNC ALL INTERIOR STUD WALLS ARE DRAWN 4" THICK UN.O. ANGLED WALLS ARE DRAWN # 45° UN.O.

#### EGRESS

EGRESS
ALL BEDROMS MUST HAVE AT LEAST ONE
MINDOM WHICH CONFORMS TO EGRESS
REQUIRENEMTS FOR CLEAR OFENING HEIGHT AND
MIDTH, IT IS THE CONTRACTOR'S RESPONSIBILITY
TO VERIFY EGRESS SIZING PER CODE BASED ON
CHOSEM MANUFACTURER, AS PRODUCT SIZES MAY

### WALL/CEILING HEIGHTS

WALL AND CEILING HEIGHTS NOTES ARE BASED ON NOMINAL WALL SIZE (I.E. A 9'-1 1/8" ACTUAL WALL HEIGHT IS LABELED 9/O ON THE PLANS).

ALL VAULTED OR SLOPED CEILINGS ARE TO BE FURRED DOWN TO ACCOMMODATE REQUIRED CEILING. INSULATION AND I" AIRSPACE, VERIFY CODES FOR INFORMATION ON INSULATION REQUIREMENTS.

#### STAIRS

STAIR TREADS ARE MEASURED FROM NOSING TO NOSING (NN.). MAXIMUM STAIR RISE HEIGHT TO BE NO GREATER THAN 8-1/4-1

## ARCHITECTURAL PLANS WALL LEGEND

■ • STANDARD STUD WALL INT OR EXT IF EXT SEE ELEVATIONS FOR SIDING STYLE THICKNESS OF WALL NOTED IN PLAN NOTES OR AT WALL LOCATIONS

STANDARD STUD WALL WITH 5" BRICK VENEER FOUNDATION WALL LEDGE STUD THICKNESS AS NOTED IN PLAN NOTES OR AT WALL LOCATIONS

= 9TANDARD STUD WALL WITH STACKED STONE VENEER
STUD THICKNESS AS NOTED IN PLAN NOTES OR AT
WALL LOCATIONS
(NOTE BUILDER TO VERIFY STONE THICKNESS)
4 NOTIFY PLAN DESIGNER IF THICKNESS IS
MORE THAN 5" BEFORE FOOTINGS ARE POWRED.)

\* \$1.AND.ARD \$1UD WALL WITH APPLIED \$1.ONE VENEER
\$1UD THICKNESS AS NOTED IN PLAN NOTES OR AT
WALL LOCATIONS
(NOTE: NO FOUND.ATION SUPPORT IS REPRESENTED
ON \$1RUCTURAL PILANS)
IF \$1.ACKED \$1.ONE IS 10 BE USED BUILDER MUST
NOTIFY PLAN DESIGNER BEFORE FOOTINGS ARE
POURED

\* STANDARD STUD WALL WITH LOW APPLIED STONE
WAINSCOTING.

SEE ELEVATIONS FOR HEIGHT & FINISH MATERIAL
AT EXT STUD WALL ABOVE.

STUD THICKNESS AS NOTED IN PLAN
NOTES OR AT WALL LOCATIONS

STANDARD STUD WALL WITH 5" FOUNDATION LEDGE
FOR LOW BRICK OR STACKED STONE WANGCOTING,
SEE ELEVATIONS FOR HEIGHT I FINISH MATERIAL
AT EXT STUD WALL ABOVE, STUD THICKNESS
AS NOTED IN PLAN NOTES OR AT WALL LOCATIONS

= HALF WALL WITH IX CAP (42" HEIGHT UNLESS NOTED OTHERWISE ON PLANS)

### WINDOW FALL PREVENTION PROTECTION

WINDOW FALL PREVENTION TO THE OFFINAD PROTON OF A WINDOW IS LOCATED MORE THAN 12" ABOVE THE EXTERIOR GRADE THEN THE LOCATE THAT OF THE CLEAR OPENING WIST BE AT LEAST 24" ABOVE THE FLOOR OF THE TROOM IN WHICH IT IS LOCATED.

- RCEPTIONS: THE MINDOW IS A FIXED UNIT . THE OPENING DOES NOT ALLOW THE PASSAGE OF A 4- INCH DIAMETER SPHERE, THE MINDOW IS EQUIPPED MITH A MINDOW FALL PREVENTION DEVICE MEETING ASTM F2090, THE MINDOW IS EQUIPPED WITH AN APPROVED WINDOW OPENING LIMITING DEVICE.

NOTE; MHEN USED WITH AN EMERGENCY ESCAPE AND RESCUE WINDOW, OPENING LIMITING DEVICES AND FALL PREVENTION DEVICES MUST BE APPROVED FOR EMERGENCY ESCAPE AND RESCUE PROVISIONS.

-21-17 BB Master Plan Set - Archs i-25-18 BB Master Plan Set - Archs 23-18 BB Master Plan Set-Archs (Loc


Scales UNO: 22X34: 1/4"=1'-0" 11x17: 1/8"=1'-0"


Set (2-19-19) Ilev. E (LHG) Il Master Plan S - Euro E (LHG) Option Homes, Architectural  $\Xi$ 1 Plan McKee I Clark II Base Pla


19-19 BB 2018 Codes - Plan ma Floor Plans & Lighting


OE-3-0




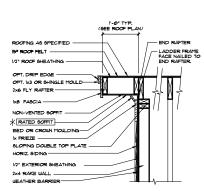

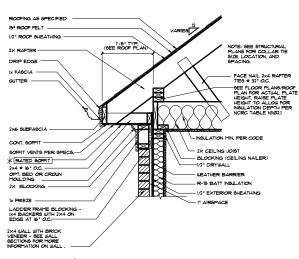

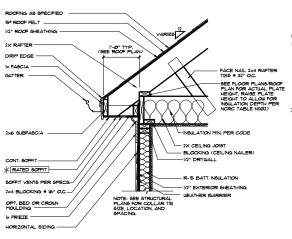

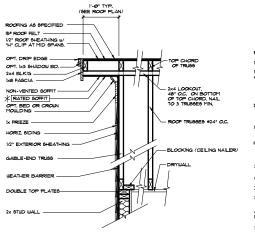

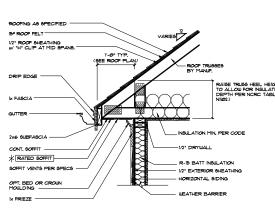


9 RAKE OVERHANG - STICK

(8) CORNICE AT BRICK STICK)


CORNICE AT SIDING (STICK)

(6) RAKE OVERHANG - (TRUSSES)


5 CORNICE AT SIDING (TRUSSES)

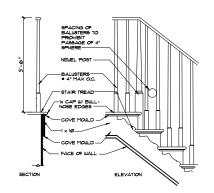


## STAIR TRIM - OPEN RISERS

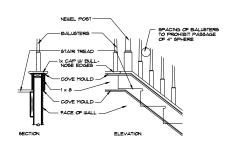

STAIR TRIM - CLOSED RISERS

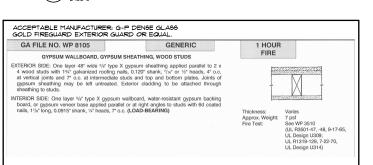


\* SEE STRUCTURAL SHEETS, NOTES AND DETAILS FOR MORE INFORMATION. ALL STRUCTURAL INFORMATION OVER-RIDES THESE ARCHITECTURAL DETAILS

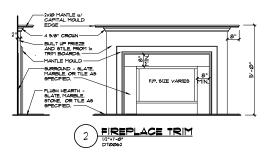


) PLANS HAVE BEEN 199UED TO MCKEE HOMES LLC. AS A BASE PLAN MASTER SET.

2) PLANS AND OPTIONS ARE DESIGNED FOR SINGLE USE ONLY AND NOT IN COMBINATION WITH EACH OTHER. THE USE OF MULTIPLE OPTIONS TOGETHER MAY CAUSE ADDITIONAL CHANGES TO ORIGINAL STRUCTURE AND ARCHITECTURAL DESIGNS.

3, ANY ON SITE CHANGES OR VARIATIONS FROM PLANS SHOUN MUST BE VERIFIED WITH DESIGNER OR ENGINEER TO MEET LOCAL CODES, GUIDELINES, LOAD CALCULATIONS ETC.

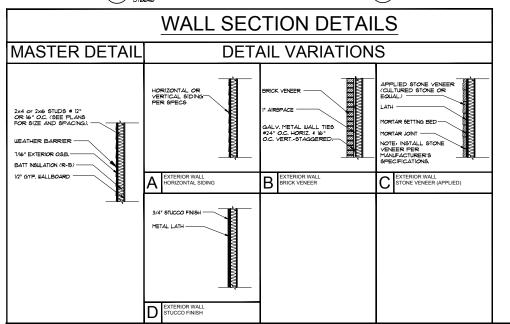

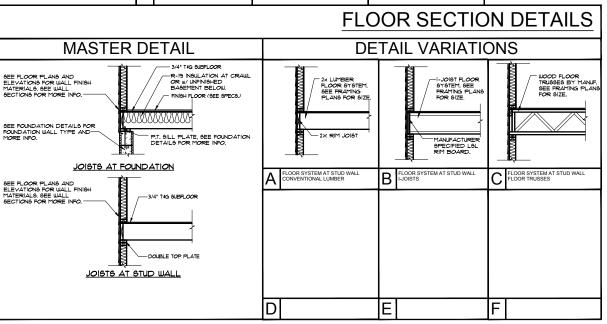

Scales UNO: 22X34: 1/4"=1'-0" 11x17: 1/8"=1'-0"


ase - Options Left Hand Garage al Master Plan Set (2-19-19) McKee Homes, I Clark II - Base -Base Plan - Left


3-31-15 BB (MM) Plan Updates 1-30-16 BB Master Plan Set - Archs -23-18 BB Master Plan Set-Archs (Log

Architectural

**Architectural Details** 

AD-1

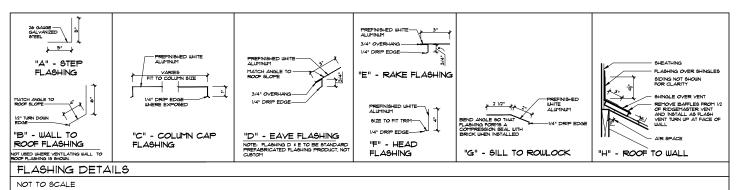

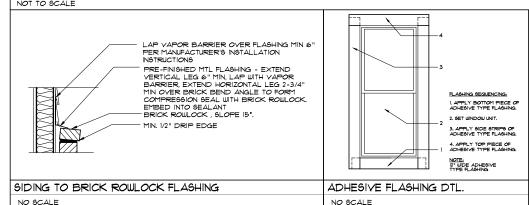



\* SEE STRUCTURAL SHEETS, NOTES AND DETAILS FOR MORE INFORMATION, ALL STRUCTURAL INFORMATION OVER-RIDES THESE ARCHITECTURAL DETAILS

I) PLANS HAVE BEEN ISSUED TO MCKEE HOMES LLC. AS A BASE PLAN MASTER SET.

2) PLANS AND OPTIONS ARE DESIGNED FOR SINGLE USE ONLY AND NOT IN COMBINATION WITH EACH OTHER THE USE OF MULTIFLE OPTIONS TOGETHER MAY CAUSE ADDITIONAL CHANGES TO ORIGINAL STRUCTURE AND ARCHITECTURAL DESIGNS.

3. ANY ON SITE CHANGES OR VARIATIONS FROM PLANS SHOUN MUST BE VERIFIED WITH DESIGNER OR ENGINEER TO MEET LOCAL CODES, GUIDELINES, LOAD CALCULATIONS ETC.

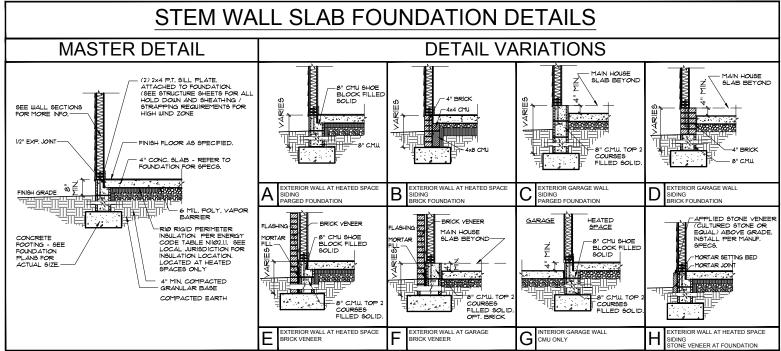

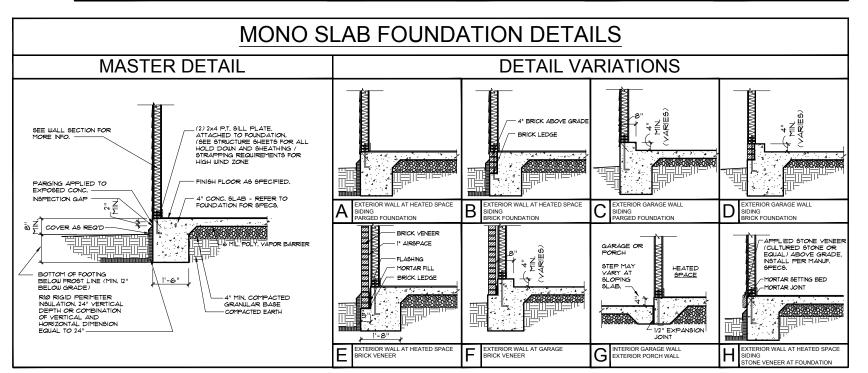


Scales UNO: 22X34: 1/4"=1'-0" 11x17: 1/8"=1'-0"


Clark II - Base - Options Base Plan - Left Hand Garage Architectural Master Plan Set (2-19-19) McKee Homes,

Clark Base F 3-31-15 BB (MM) Plan Updates I-30-16 BB Master Plan Set - Archs -23-18 BB Master Plan Set-Archs (Log

**Architectural Details** 

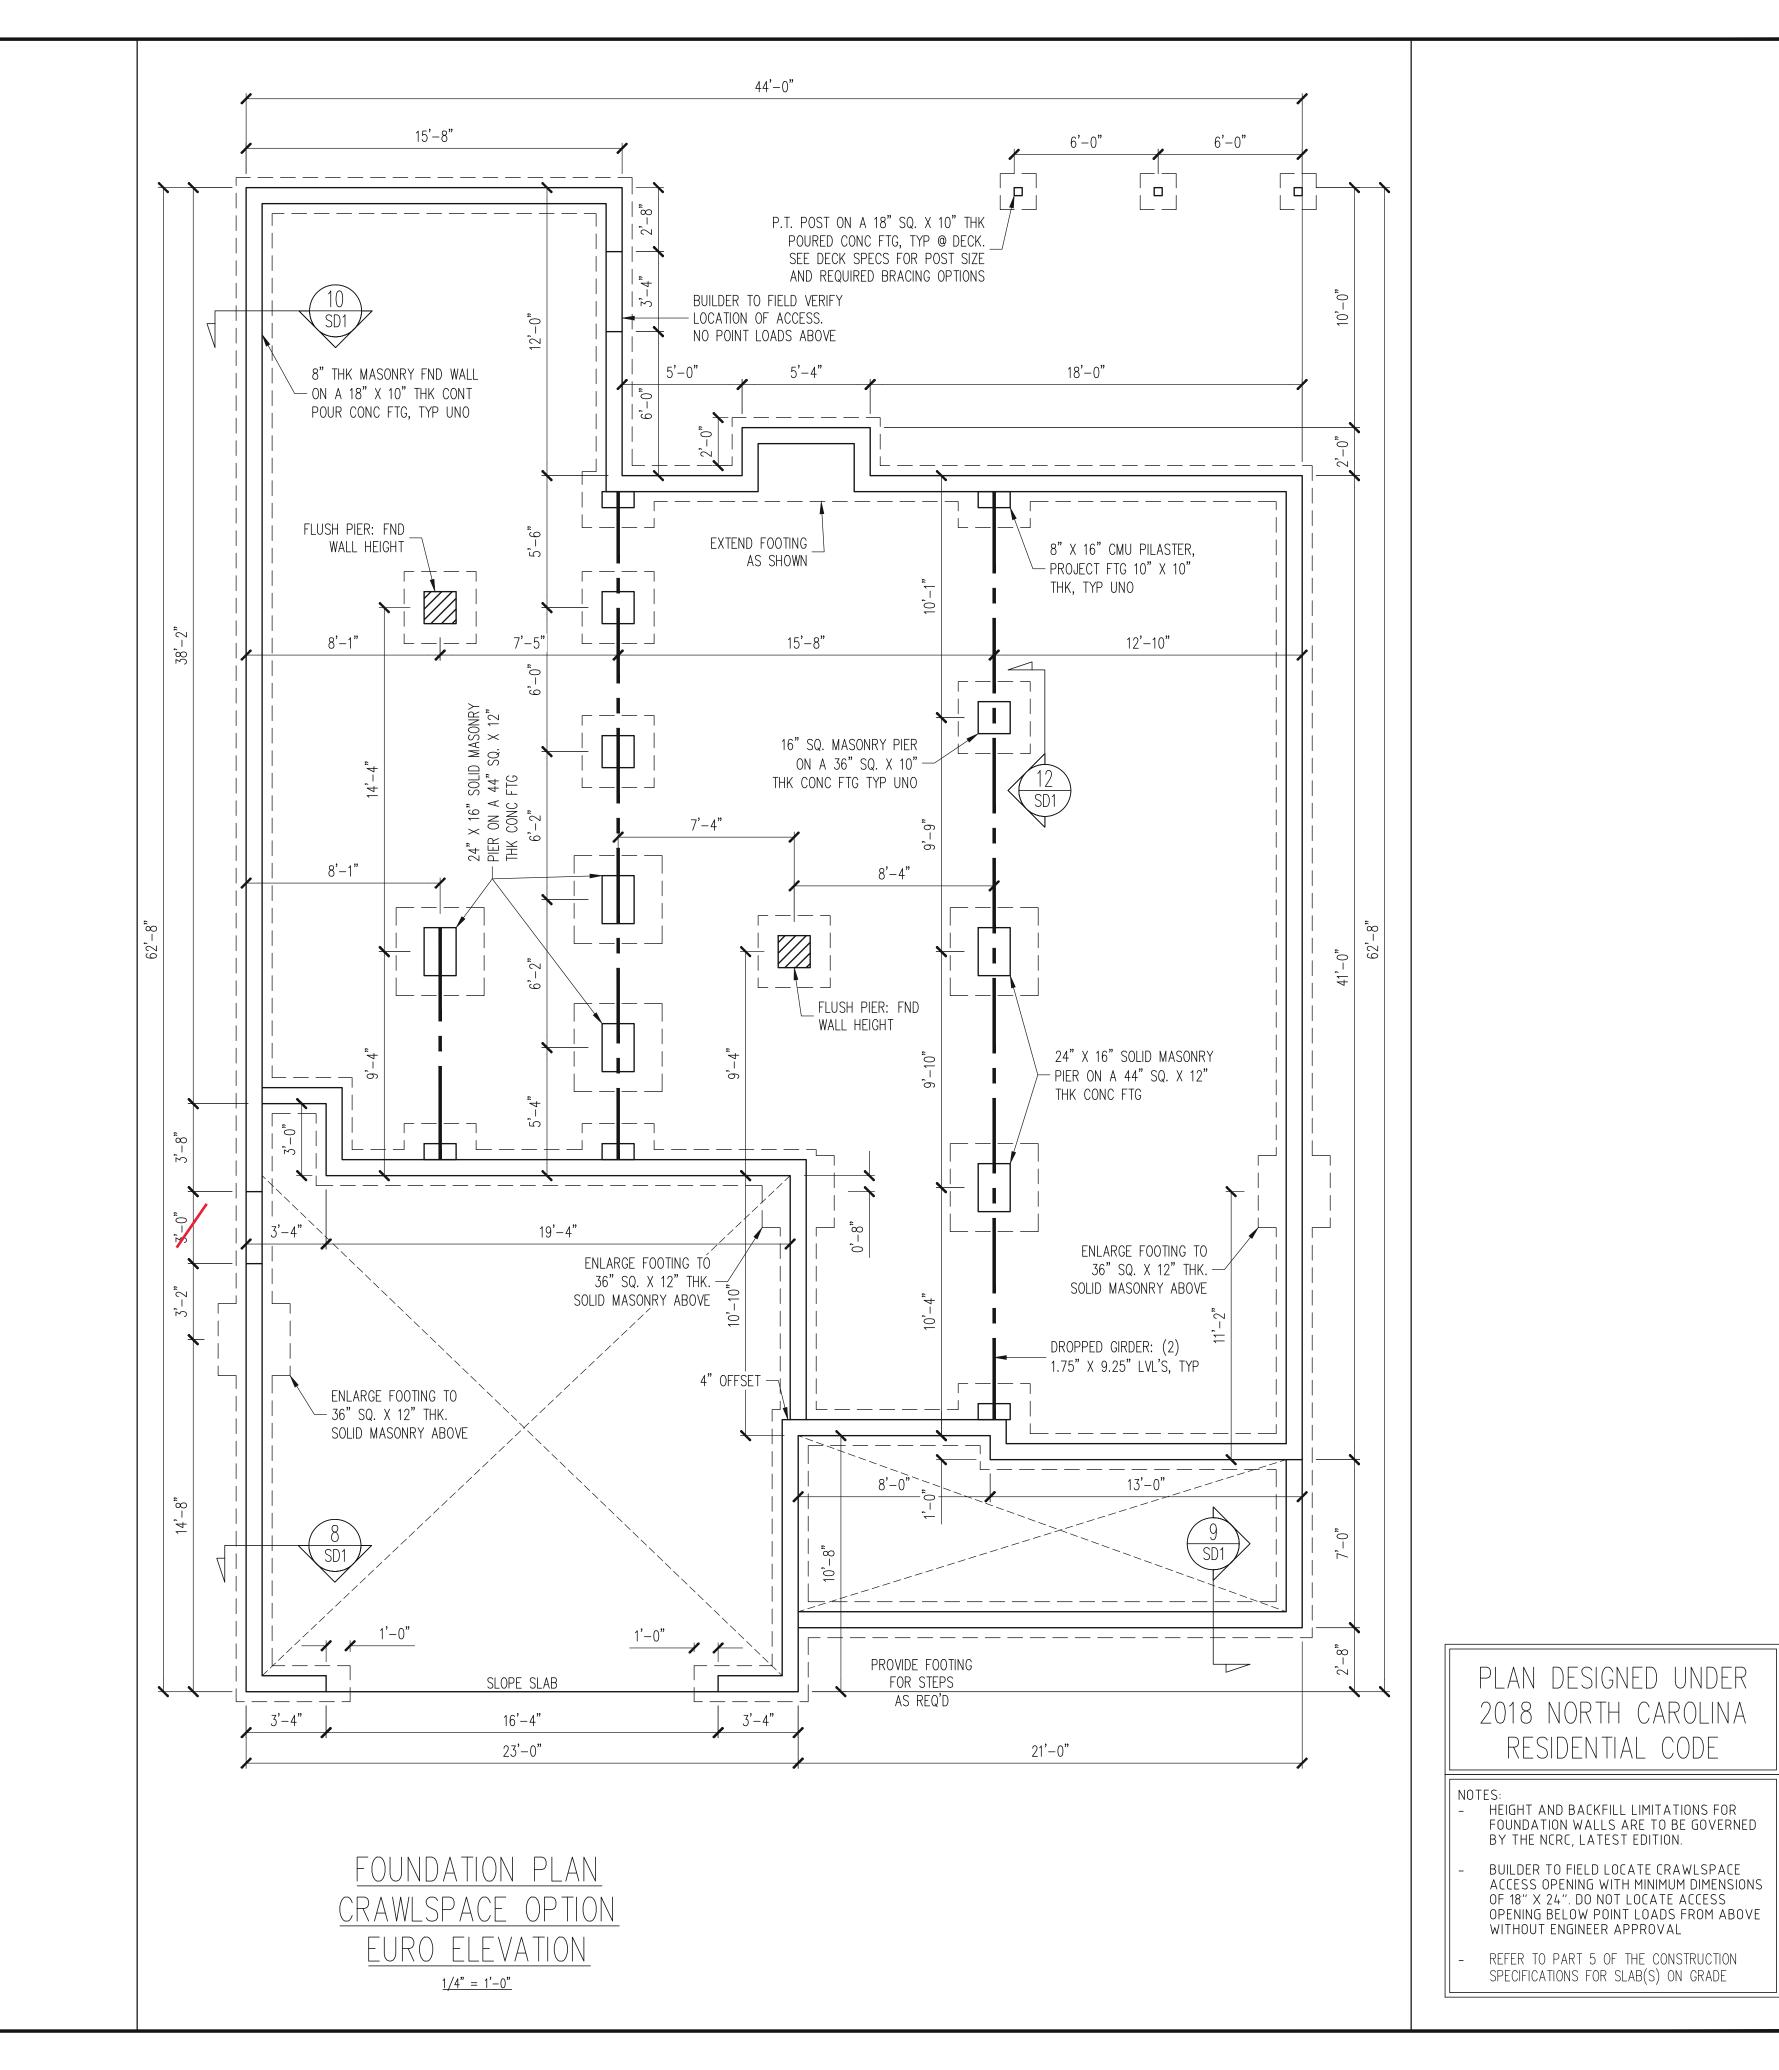



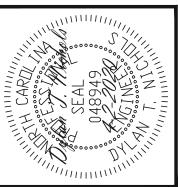

		DTN		DATE 4-2-2020
	WNC	ENG	REV:	DATE
MCKEE HOMES	STRUCTURAL ADDENDUM			
CLIENT:	SCOPE	<b>:#</b> 101		


PLAN NO. CLARK LH

PROJECT NO. 20-29-018L

SHEET NO. **S6** 

6 of 37

REFER TO PART 5 OF THE CONSTRUCTION SPECIFICATIONS FOR SLAB(S) ON GRADE

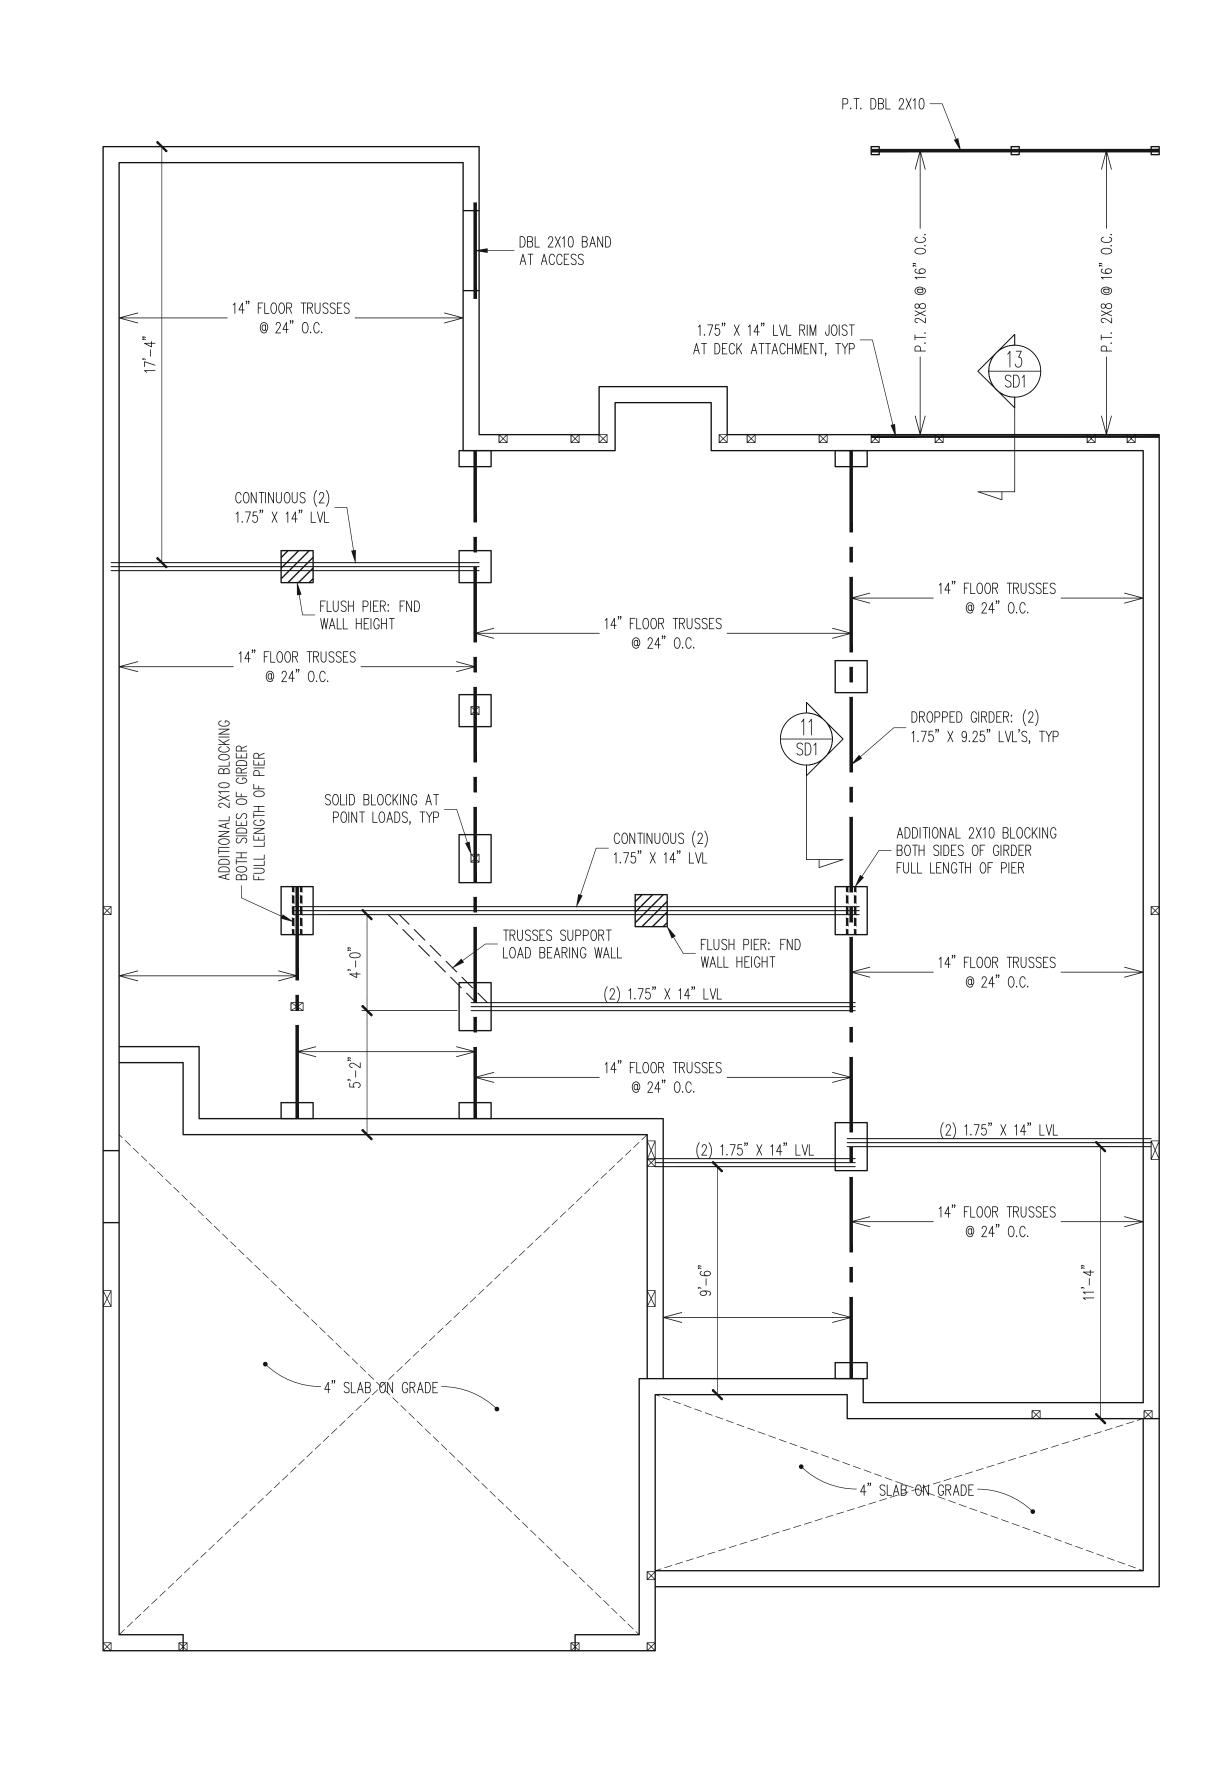

CRAWL SPACE FRAMING PLAN EURO ELEVATION


1/4" = 1'-0"

NOTES:
- HEIGHT AND BACKFILL LIMITATIONS FOR
FOUNDATION WALLS ARE TO BE GOVERNED
BY THE NCRC, LATEST EDITION.

BUILDER TO FIELD LOCATE CRAWLSPACE ACCESS OPENING WITH MINIMUM DIMENSIONS OF 18" X 24". DO NOT LOCATE ACCESS OPENING BELOW POINT LOADS FROM ABOVE WITHOUT ENGINEER APPROVAL

REFER TO PART 5 OF THE CONSTRUCTION SPECIFICATIONS FOR SLAB(S) ON GRADE



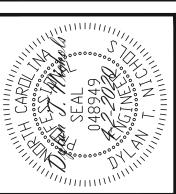


		DTN		DATE: 4-2-2020
	MDQN	ENG	REV:	DATE
NT: MCKEE HOMES	PE. STRUCTURAL ADDENDUM	<b>;</b> # J		
CLIENT:	SCOPE	# 101		

PLAN NO. CLARK LH

PROJECT NO. 20-29-018L

SHEET NO. **S8** 

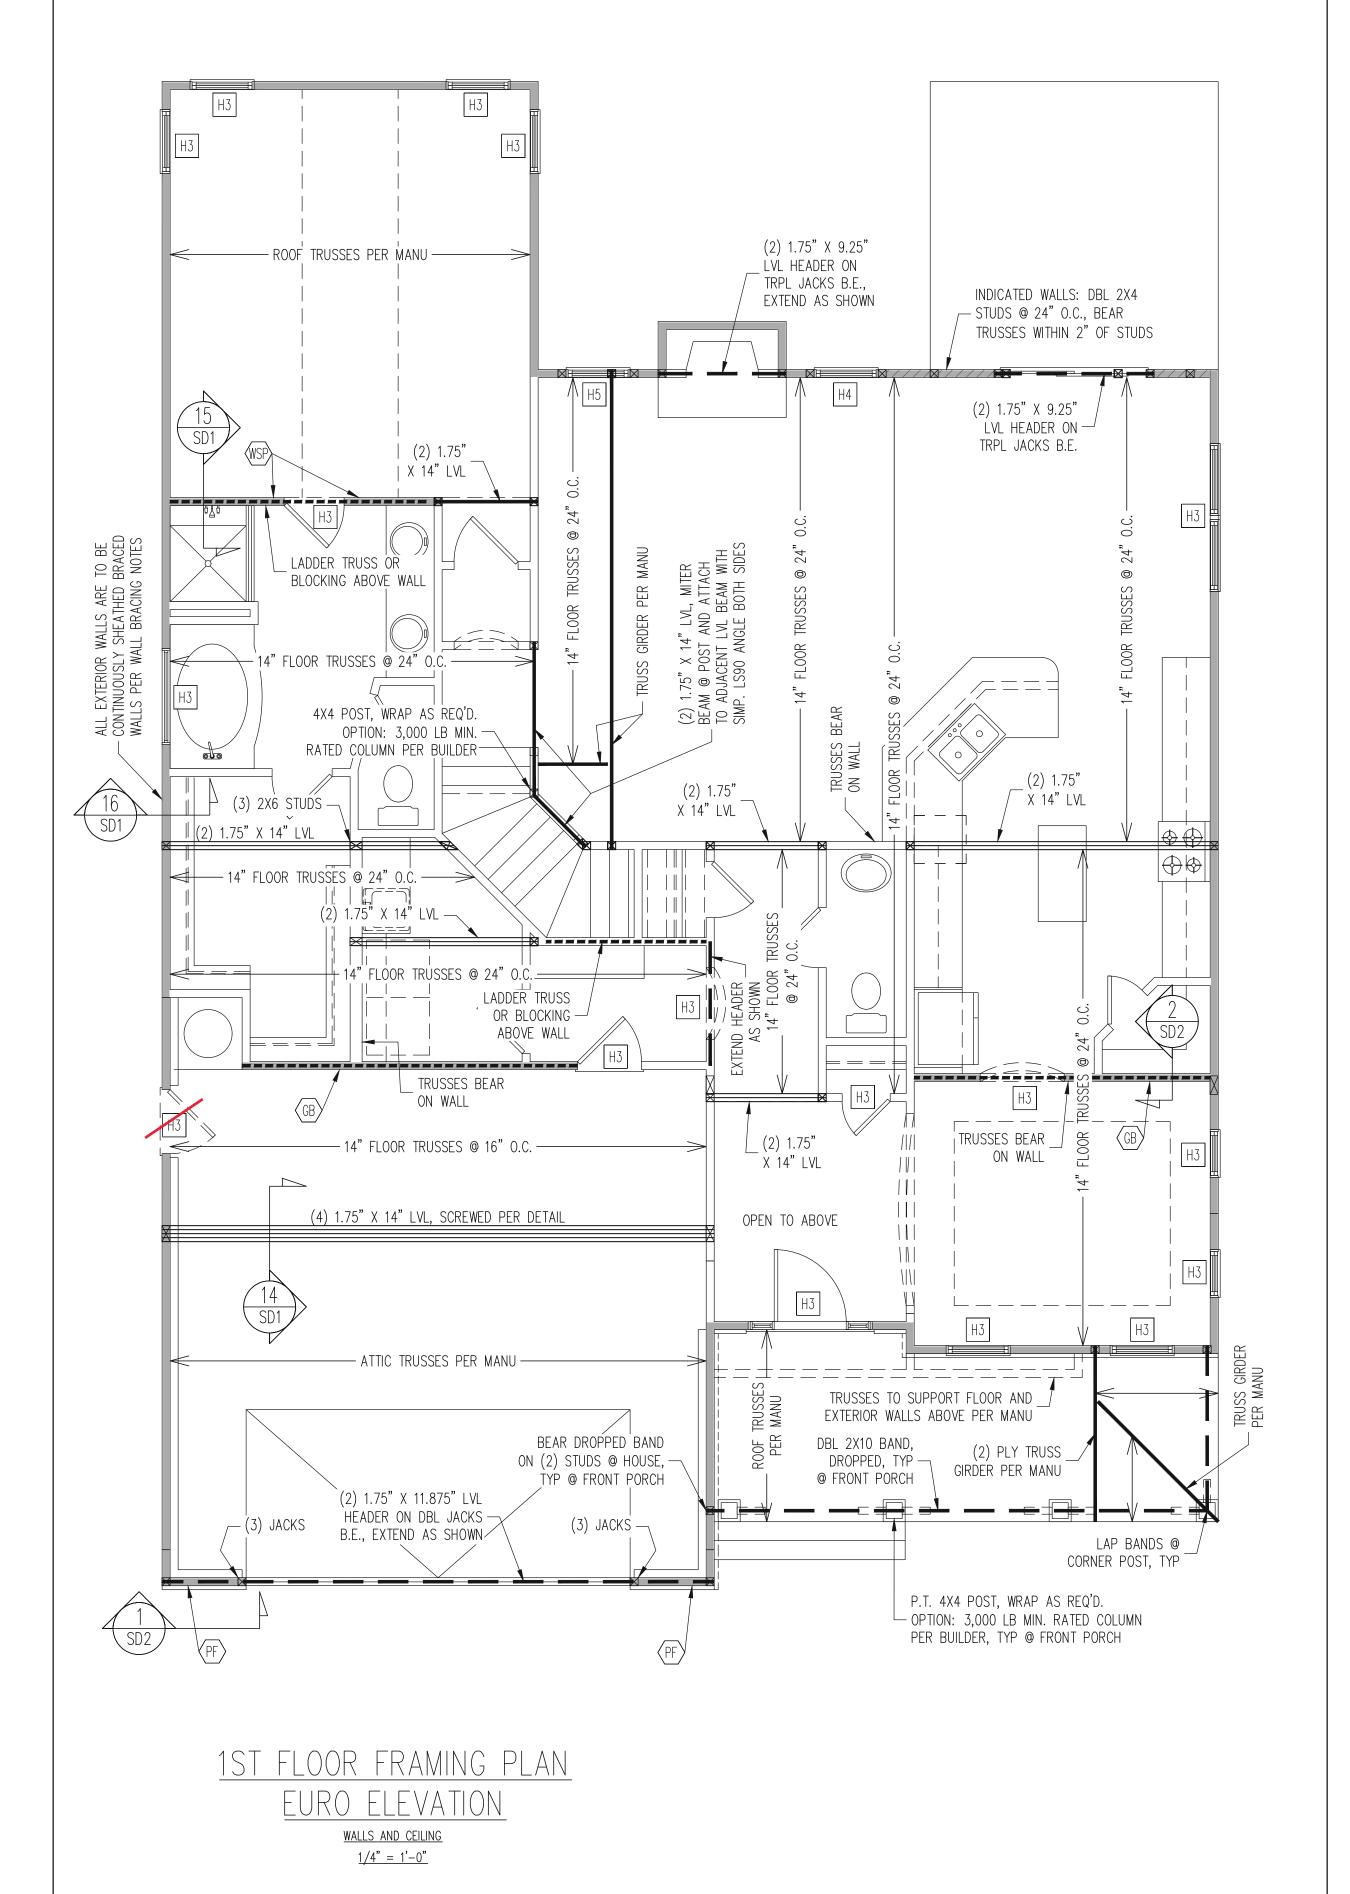

## WALL BRACING

ALL EXTERIOR STUD WALLS ARE TO BE CONTINUOUSLY SHEATHED WITH 7/16 APA RATED OSB NAILED TO STUDS WITH 8d NAILS @ 6" O.C. AT PANEL EDGES, 12" O.C. IN PANEL FIELD.

BUILDER PERMITTED TO SUBSTITUTE INTERIOR OSB SHEATHING WITH THERMO-PLY BLUE PROTECTIVE SHEATHING, REFERENCE TECHNICAL EVALUATION REPORT COL#P-1038 PROVIDED BY DRJ ENGINEERING, LLC AND SEALED BY RYAN DEXTER, P.E.

-BRACED WALL PANELS SHALL BE FASTENED IN ACCORDANCE WITH TABLE 602.3(1) TO PROVIDE CONTINUOUS PANEL UPLIFT RESISTANCE AND COMPLIANCE WITH NCRC R602.3.5 AND R802.11 UNLESS NOTED OTHERWISE ON STRUCTURAL PLANS.

## REQUIRED STUDS FOR BEAM SUPPORT

REFER TO PART 14 OF THE CONSTRUCTION SPECIFICATIONS FOR REQUIRED NUMBER OF STUDS FOR BEAM SUPPORT, TYP UNO.

# HEADER SCHEDULE

- H2 (2) 2X4'S ON SINGLE JACKS (B)
- H3 (2) 2X10'S ON SINGLE JACKS (C)
- | H4 (2) 1.75" X 9.25" LVL'S ON DBL JACKS
- H5 (2) 2X10'S ON DBL JACKS
- \_\_\_\_\_
- (A) TYPICAL FOR INTERIOR NON LOAD BEARING WALLS ONLY, ROUGH OPENING 38" MAX.
- (C) TYPICAL FOR ALL CONDITIONS NOT LISTED IN

-HEADERS IN NON LOAD BEARING INTERIOR WALLS ARE NOT LABELED. -REFER TO PART 17 OF THE CONSTRUCTION SPECIFICATIONS FOR REQUIRED NUMBER OF KING STUDS AT OPENINGS

TRUSS OR BLOCKING IS REQUIRED ABOVE ALL BRACED WALLS. NAIL BLOCKING ABOVE WALL TO DBL TOP PLATE WITH 16d TOE NAILS @ 6" O.C. ATTACH SOLE PLATE TO FRAMING / FND BELOW PER TYPICAL BRACED WALL DETAILS. BLOCKING AT HORIZONTAL JOINTS IN BRACED WALL LINES ONLY REQUIRED AT SHADED WALLS, UNO.

SHADED WALLS:


- GB INTERIOR BRACED WALL WITH GYPSUM BOARD. 1/2" GB BOTH SIDES OF WALL ATTACHED TO PANEL EDGES, INCLUDING TOP AND BOTTOM PLATES, AT 7" O.C.. BUILDER PERMITTED TO USE WSP IN LIEU OF GB UNO.
- WSP INTERIOR BRACED WALL WITH 3 MIN. THICKNESS WOOD STRUCTURAL PANELING, (1) SIDE. ATTACH WSP TO STUD WALL WITH 8d NAILS @ 6" O.C. AT PANEL EDGES, 12" O.C. IN PANEL FIELD. BLOCK AT ALL PANEL EDGES.
- PF PORTAL FRAME PER TYPICAL DETAIL.

PROVIDED CONTINUOUS SHEATHING = 219' MIN. -WALL BRACING IS BY ENGINEERED DESIGN AND NOT PRESCRIPTIVE PER SECTION 602.10 OF THE 2018 NCRC. CONTINUOUS SHEATHING HAS BEEN PROVIDED, ALONG WITH ALTERNATIVE METHODS TO INSURE THE MINIMUM INTENT OF SECTION 602.10 OF THE 2018 NCRC HAS BEEN MET AND EXCEEDED.

- H1 SINGLE 2X4 TURNED FLAT (A)

- H6 (3) 2X10'S ON SINGLE 2X6 JACKS
- (B) TYPICAL FOR INTERIOR NON LOAD BEARING WALLS ONLY, ROUGH OPNG 38" TO 74" MAX.
- (A) OR (B) UNO.



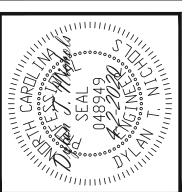


 $\neg \vdash \exists \vdash \forall \vdash \vdash \neg$ 

		DTN		DATE 4.2.2020
	MNG	ENG	REV:	DATE.
MCKEE HOMES	STRUCTURAL ADDENDUM			
MCKI	STRUCTUR			
	3,			
CLIENT:	SCOPE	1OI #:		
٥	Š	7		

PLAN NO. CLARK LH

PROJECT NO. 20-29-018L

> SHEET NO. S<sub>10</sub>

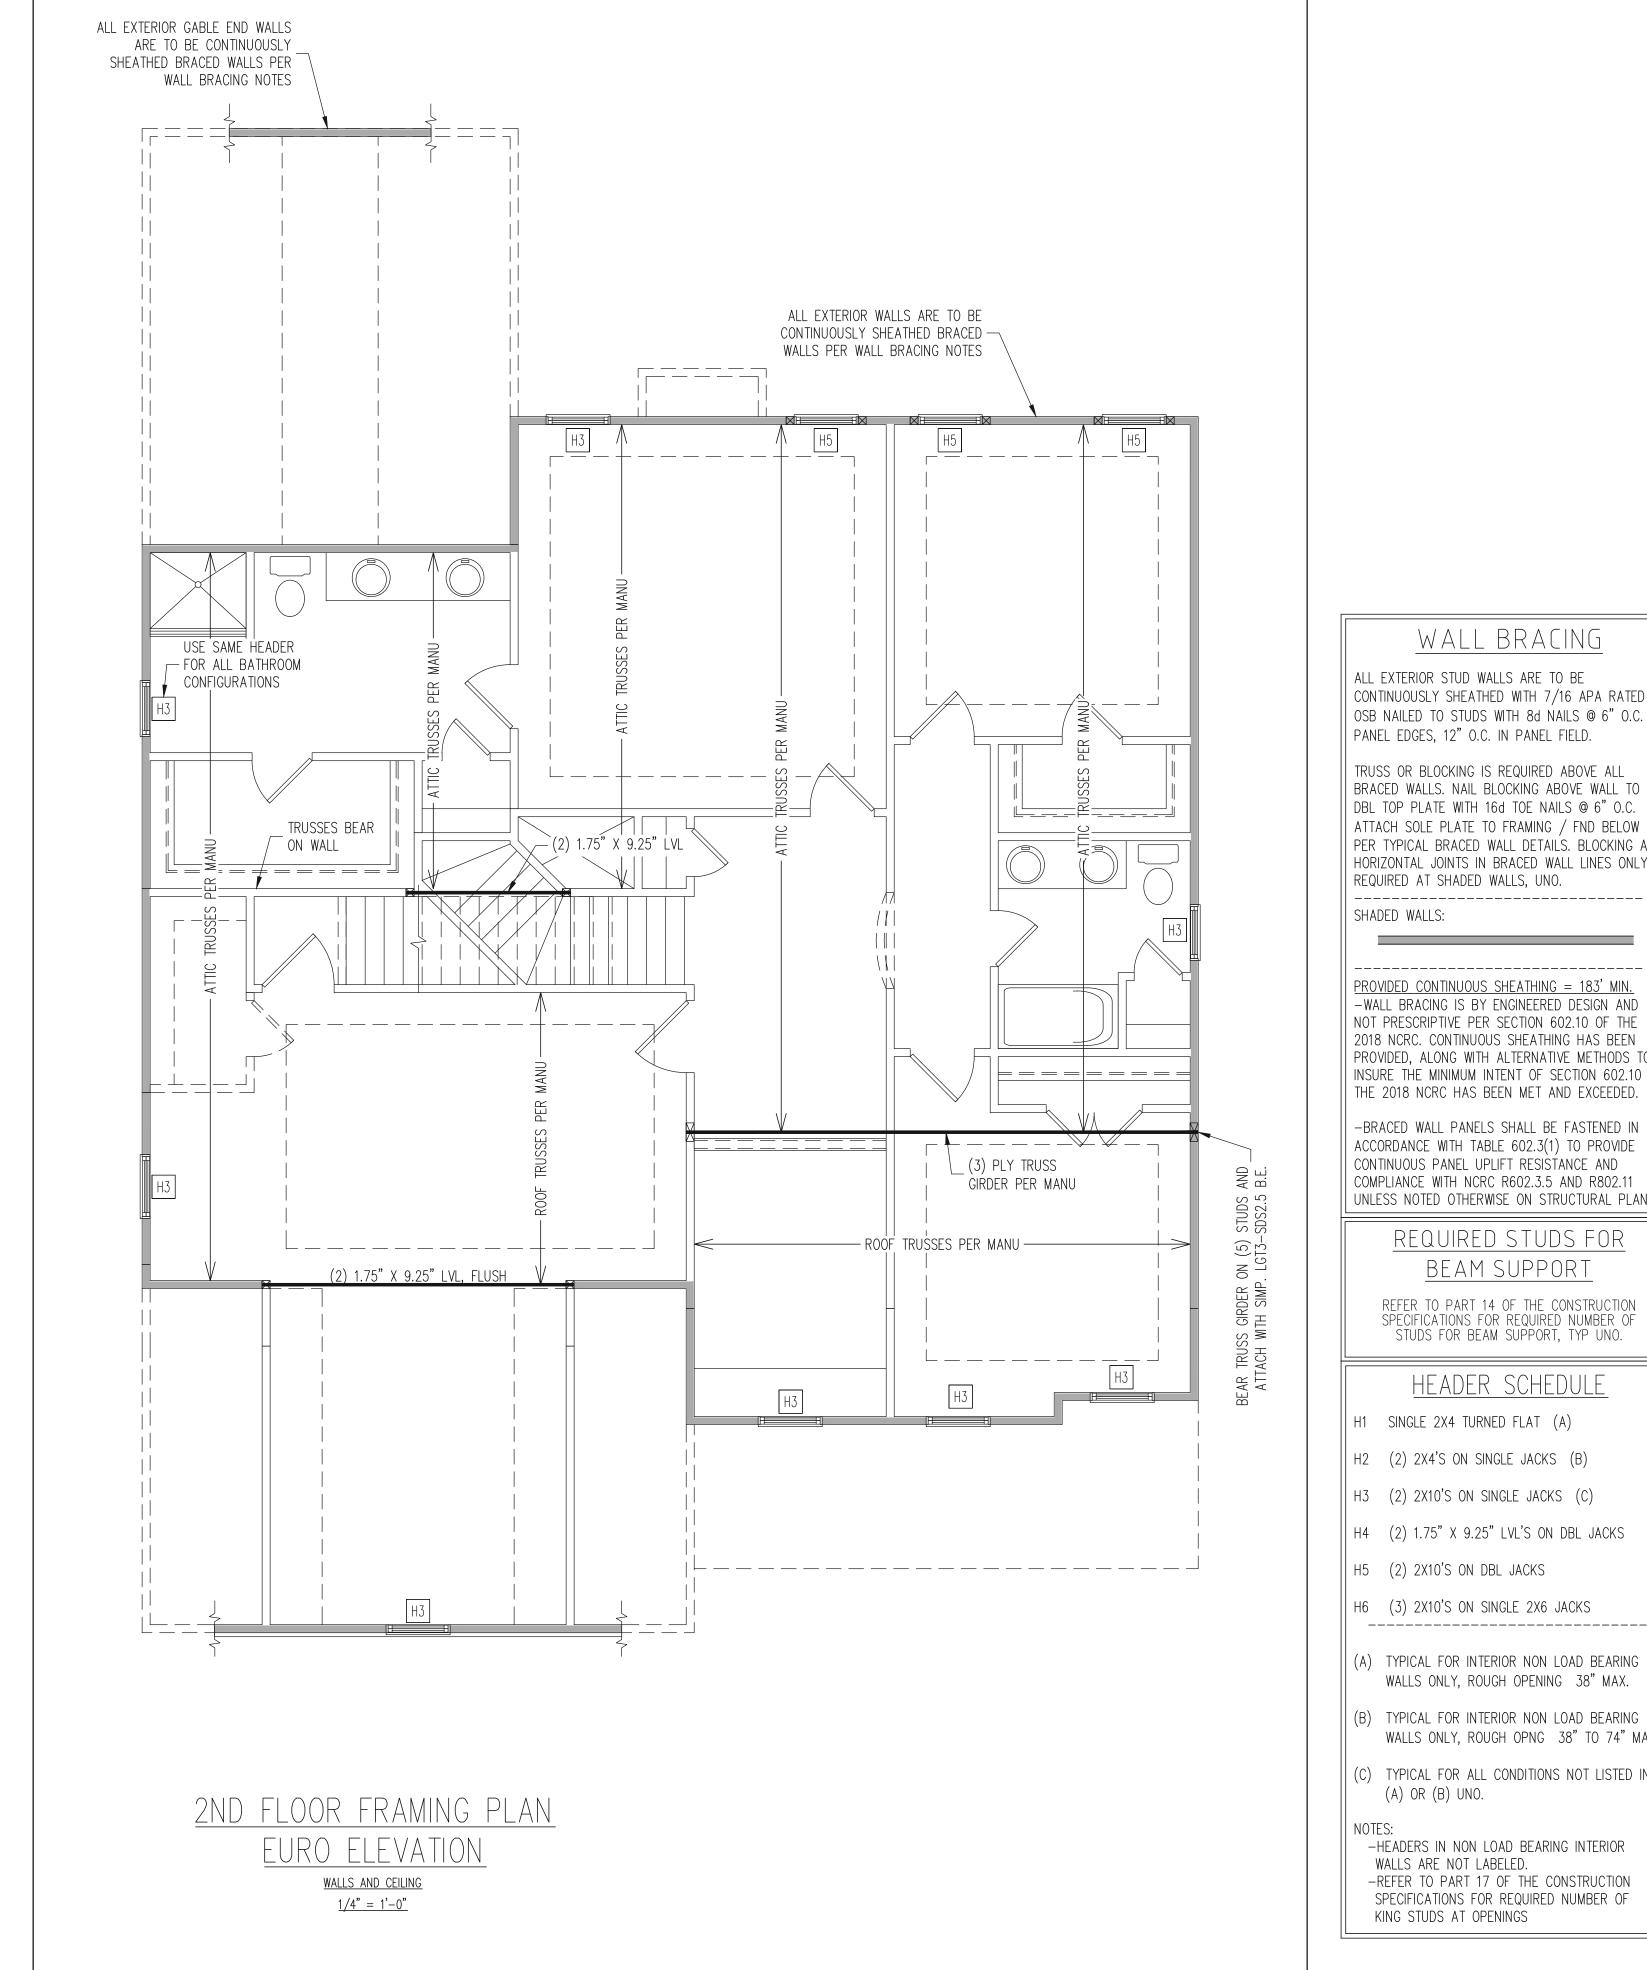

WALL BRACING

ALL EXTERIOR STUD WALLS ARE TO BE CONTINUOUSLY SHEATHED WITH 7/16 APA RATED OSB NAILED TO STUDS WITH 8d NAILS @ 6" O.C. AT PANEL EDGES, 12" O.C. IN PANEL FIELD.

TRUSS OR BLOCKING IS REQUIRED ABOVE ALL BRACED WALLS. NAIL BLOCKING ABOVE WALL TO DBL TOP PLATE WITH 16d TOE NAILS @ 6" O.C. ATTACH SOLE PLATE TO FRAMING / FND BELOW PER TYPICAL BRACED WALL DETAILS. BLOCKING AT HORIZONTAL JOINTS IN BRACED WALL LINES ONLY REQUIRED AT SHADED WALLS, UNO.

SHADED WALLS:

PROVIDED CONTINUOUS SHEATHING = 183' MIN. -WALL BRACING IS BY ENGINEERED DESIGN AND NOT PRESCRIPTIVE PER SECTION 602.10 OF THE 2018 NCRC. CONTINUOUS SHEATHING HAS BEEN PROVIDED, ALONG WITH ALTERNATIVE METHODS TO INSURE THE MINIMUM INTENT OF SECTION 602.10 OF

-BRACED WALL PANELS SHALL BE FASTENED IN ACCORDANCE WITH TABLE 602.3(1) TO PROVIDE CONTINUOUS PANEL UPLIFT RESISTANCE AND COMPLIANCE WITH NCRC R602.3.5 AND R802.11 UNLESS NOTED OTHERWISE ON STRUCTURAL PLANS.

# REQUIRED STUDS FOR BEAM SUPPORT


REFER TO PART 14 OF THE CONSTRUCTION SPECIFICATIONS FOR REQUIRED NUMBER OF STUDS FOR BEAM SUPPORT, TYP UNO.

# HEADER SCHEDULE

- H1 SINGLE 2X4 TURNED FLAT (A)
- H2 (2) 2X4'S ON SINGLE JACKS (B)
- H3 (2) 2X10'S ON SINGLE JACKS (C)
- H4 (2) 1.75" X 9.25" LVL'S ON DBL JACKS
- H5 (2) 2X10'S ON DBL JACKS
- H6 (3) 2X10'S ON SINGLE 2X6 JACKS \_\_\_\_\_
- (A) TYPICAL FOR INTERIOR NON LOAD BEARING WALLS ONLY, ROUGH OPENING 38" MAX.
- (B) TYPICAL FOR INTERIOR NON LOAD BEARING WALLS ONLY, ROUGH OPNG 38" TO 74" MAX.
- (C) TYPICAL FOR ALL CONDITIONS NOT LISTED IN (A) OR (B) UNO.

-HEADERS IN NON LOAD BEARING INTERIOR WALLS ARE NOT LABELED. -REFER TO PART 17 OF THE CONSTRUCTION SPECIFICATIONS FOR REQUIRED NUMBER OF KING STUDS AT OPENINGS



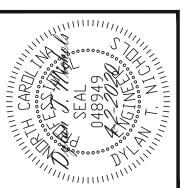


		DTN		DATE 4-2-2020
	MUQ	ENG	REV:	DATE
MCKEE HOMES	STRUCTURAL ADDENDUM			
MCKI	STRUCTUR			
	<b>3</b> 7			
CLIENT:	SCOPE	1OI #:		
	SC	)]		

PLAN NO. CLARK LH

PROJECT NO. 20-29-018L

> SHEET NO. S12

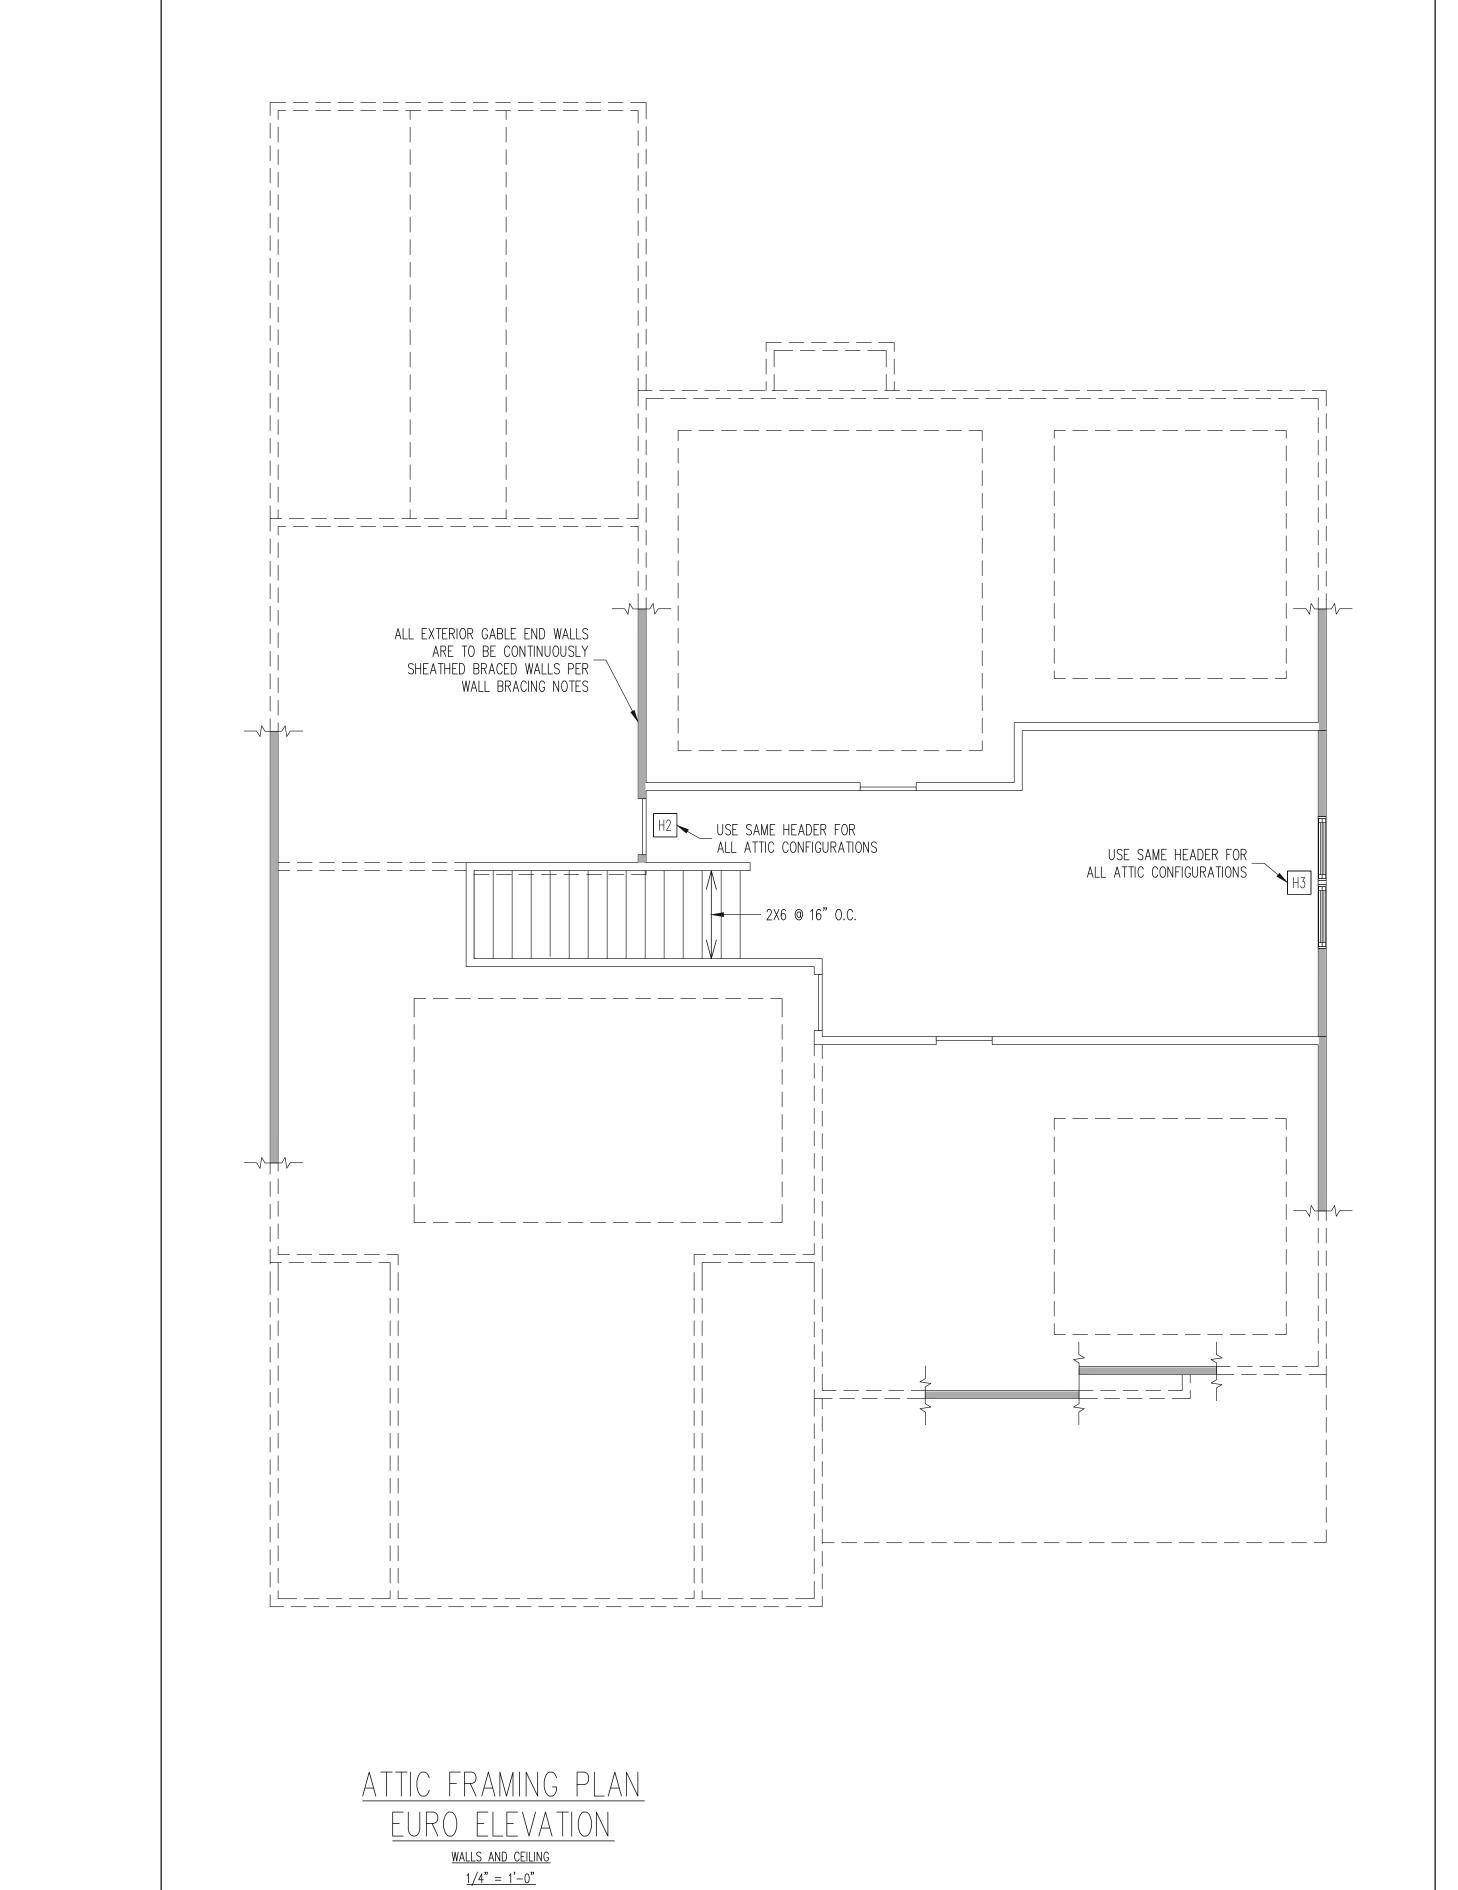

# WALL BRACING

ALL EXTERIOR STUD WALLS ARE TO BE CONTINUOUSLY SHEATHED WITH 7/16 APA RATED OSB NAILED TO STUDS WITH 8d NAILS @ 6" O.C. AT PANEL EDGES, 12" O.C. IN PANEL FIELD.

TRUSS OR BLOCKING IS REQUIRED ABOVE ALL BRACED WALLS. NAIL BLOCKING ABOVE WALL TO DBL TOP PLATE WITH 16d TOE NAILS @ 6" O.C. ATTACH SOLE PLATE TO FRAMING / FND BELOW PER TYPICAL BRACED WALL DETAILS. BLOCKING AT HORIZONTAL JOINTS IN BRACED WALL LINES ONLY REQUIRED AT SHADED WALLS, UNO.

\_\_\_\_\_\_

SHADED WALLS:

PROVIDED CONTINUOUS SHEATHING = 67' MIN.

-WALL BRACING IS BY ENGINEERED DESIGN AND NOT PRESCRIPTIVE PER SECTION 602.10 OF THE 2018 NCRC. CONTINUOUS SHEATHING HAS BEEN PROVIDED, ALONG WITH ALTERNATIVE METHODS TO INSURE THE MINIMUM INTENT OF SECTION 602.10 OF

-BRACED WALL PANELS SHALL BE FASTENED IN ACCORDANCE WITH TABLE 602.3(1) TO PROVIDE CONTINUOUS PANEL UPLIFT RESISTANCE AND COMPLIANCE WITH NCRC R602.3.5 AND R802.11 UNLESS NOTED OTHERWISE ON STRUCTURAL PLANS.

THE 2018 NCRC HAS BEEN MET AND EXCEEDED.

# REQUIRED STUDS FOR BEAM SUPPORT

REFER TO PART 14 OF THE CONSTRUCTION SPECIFICATIONS FOR REQUIRED NUMBER OF STUDS FOR BEAM SUPPORT, TYP UNO.

# HEADER SCHEDULE

- H1 SINGLE 2X4 TURNED FLAT (A)
- H2 (2) 2X4'S ON SINGLE JACKS (B)
- H3 (2) 2X10'S ON SINGLE JACKS (C)
- H4 (2) 1.75" X 9.25" LVL'S ON DBL JACKS
- H5 (2) 2X10'S ON DBL JACKS
- (A) TYPICAL FOR INTERIOR NON LOAD BEARING
  WALLS ONLY, ROUGH OPENING 38" MAX.

| H6 (3) 2X10'S ON SINGLE 2X6 JACKS


- (B) TYPICAL FOR INTERIOR NON LOAD BEARING WALLS ONLY, ROUGH OPNG 38" TO 74" MAX.
- (C) TYPICAL FOR ALL CONDITIONS NOT LISTED IN (A) OR (B) UNO.

# NOTES:

-HEADERS IN NON LOAD BEARING INTERIOR
WALLS ARE NOT LABELED.
-REFER TO PART 17 OF THE CONSTRUCTION
SPECIFICATIONS FOR REQUIRED NUMBER OF
KING STUDS AT OPENINGS

STRUCTURAL ENGINEERS
License No. C-3870
183 Wind Chime Court, Suite 100
Raleigh, North Carolina 27615
19) 844-1661 Fax: (919) 844-1665



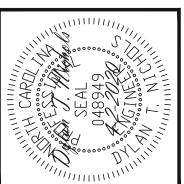

ENGINEERING SEAL VALID FOR 1 YEAR ONLY.


The structural design of this plan is the property of Engineering Tech Associates, P.A. These plans are for the client listed only. Engineering Tech Associates, P.A. assumes no liability for these plans if construction or permitting takes place more than 1 year after the seal date without written permission from Engineering Tech Associates, P.A.

		DTN		DATE: 4-2-2020
	WNC	ENG	REV:	DATE
MCKEE HOMES	STRUCTURAL ADDENDUM			
CLIENT:	SCOPE	:# IOI		


PLAN NO. CLARK LH

PROJECT NO. 20-29-018L

SHEET NO.

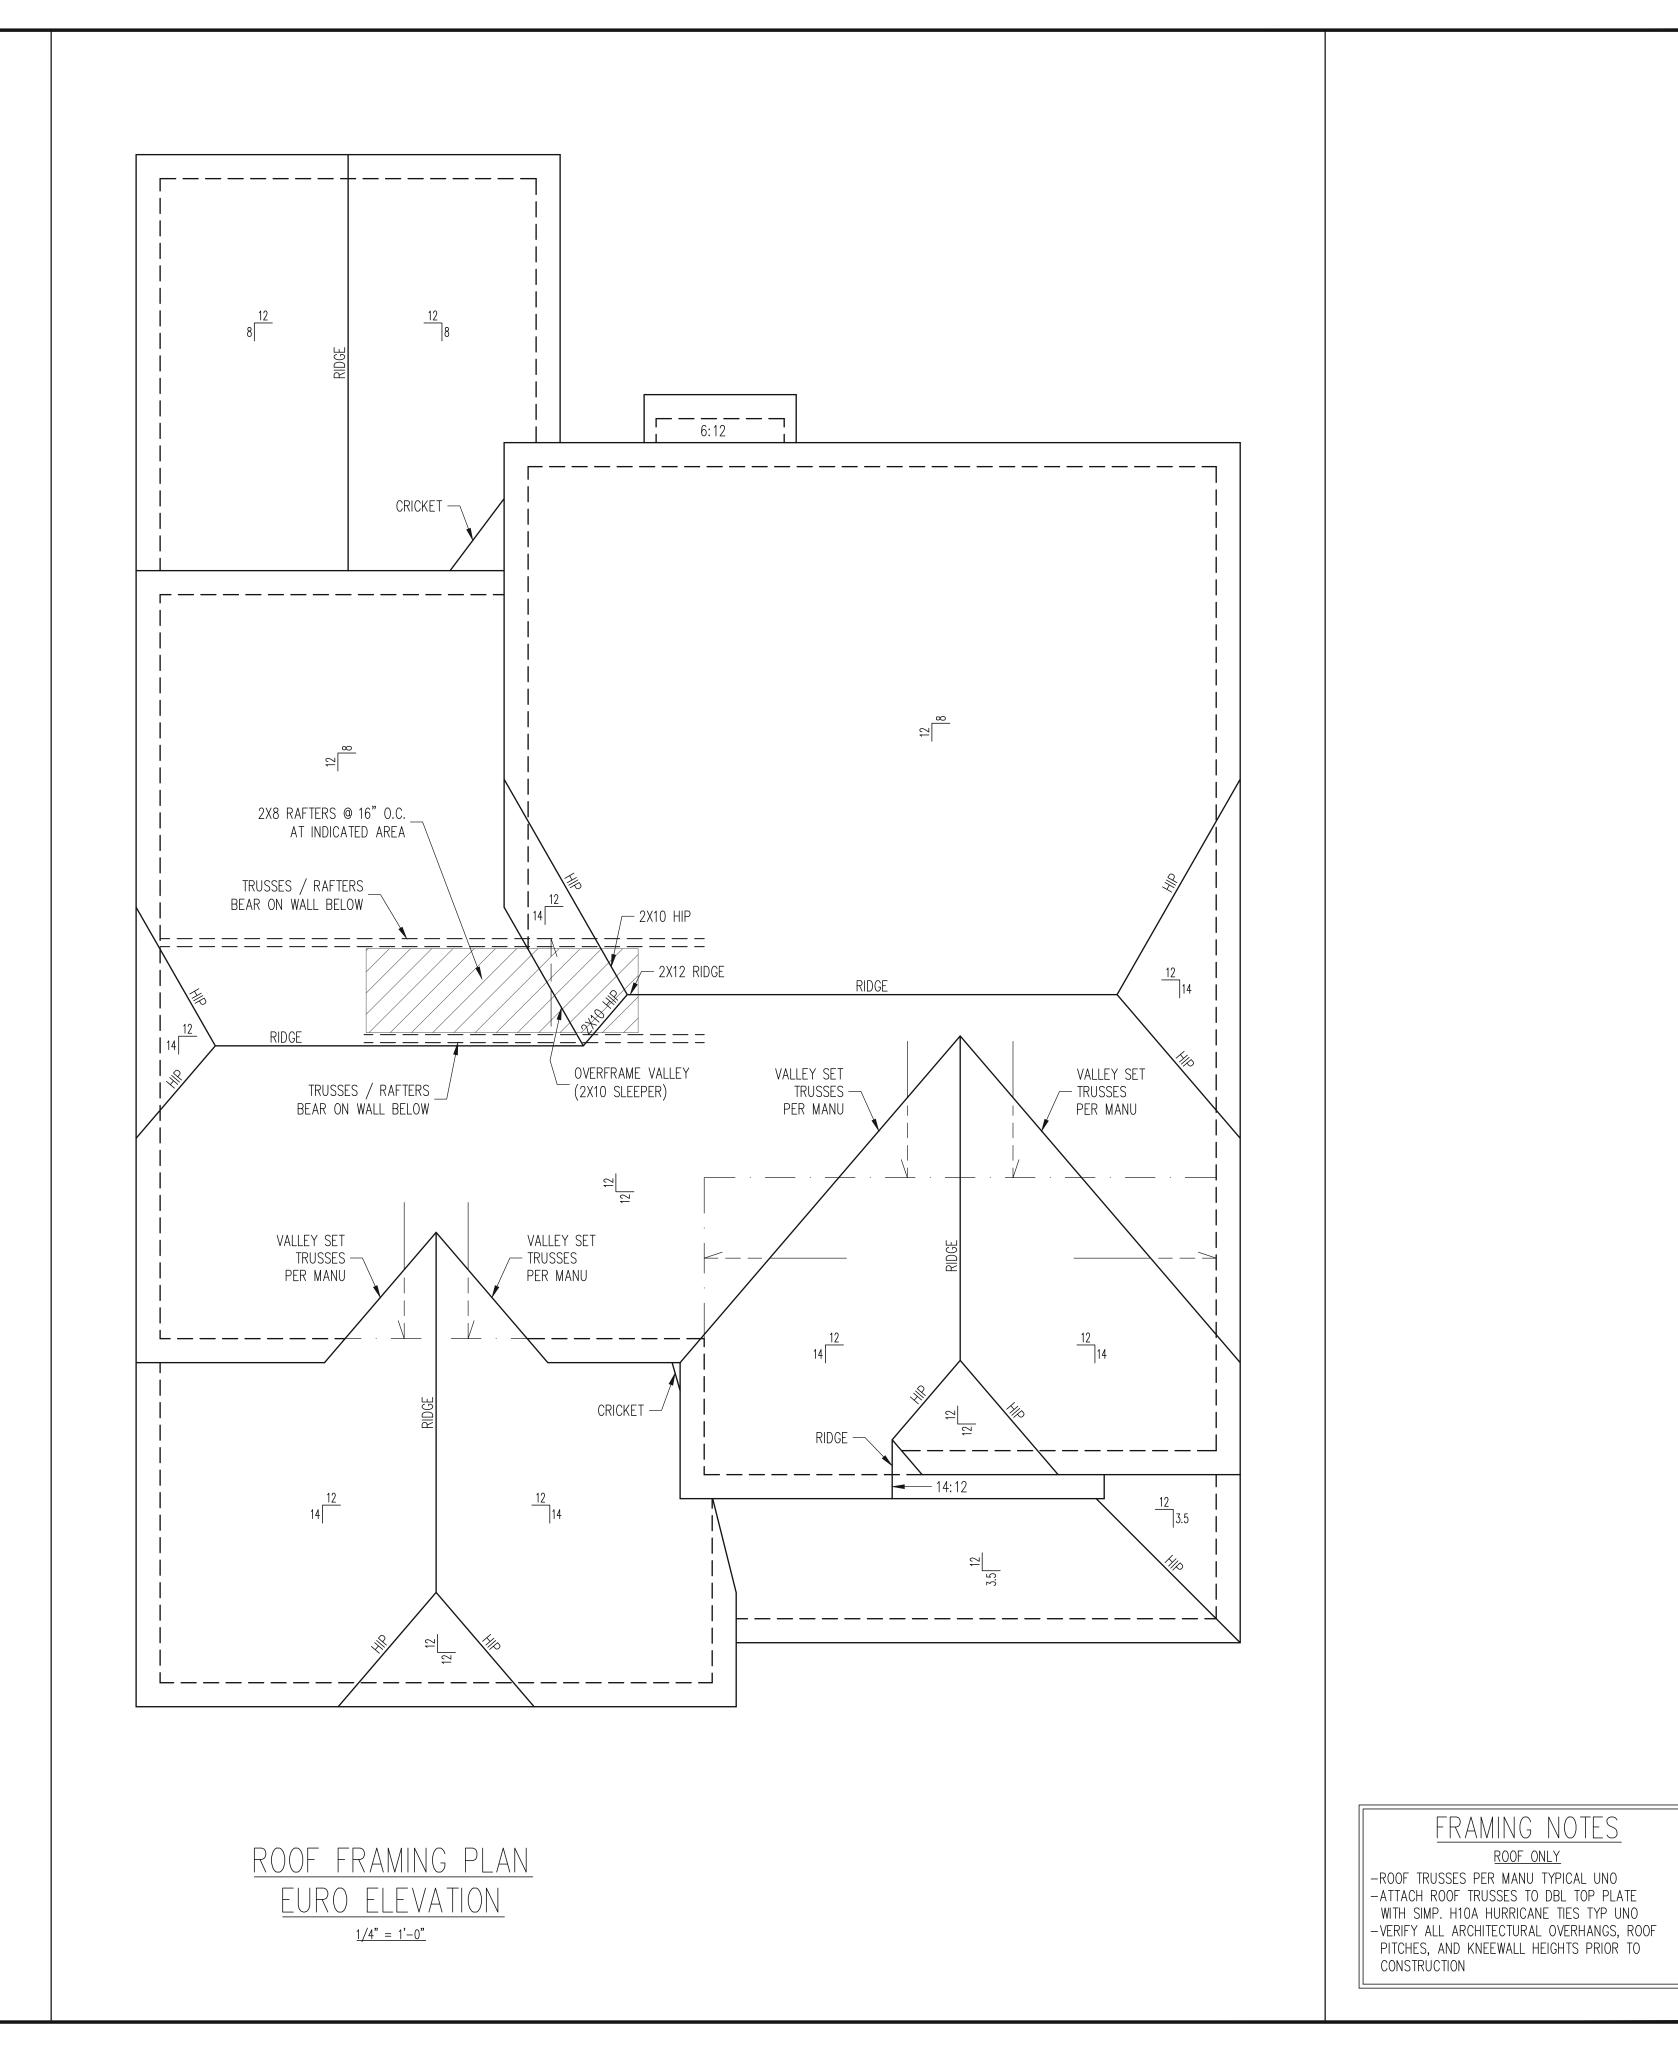



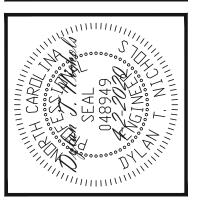


		DTN		DATE 4-2-2020
S	WDQN:	ENG	REV:	DATE
MCKEE HOMES	STRUCTURAL ADDENDUM			
CLIENT:	SCOPE	<b>#</b> 101		


PLAN NO. CLARK LH

PROJECT NO. 20-29-018L

FRAMING NOTES

SHEET NO. S16

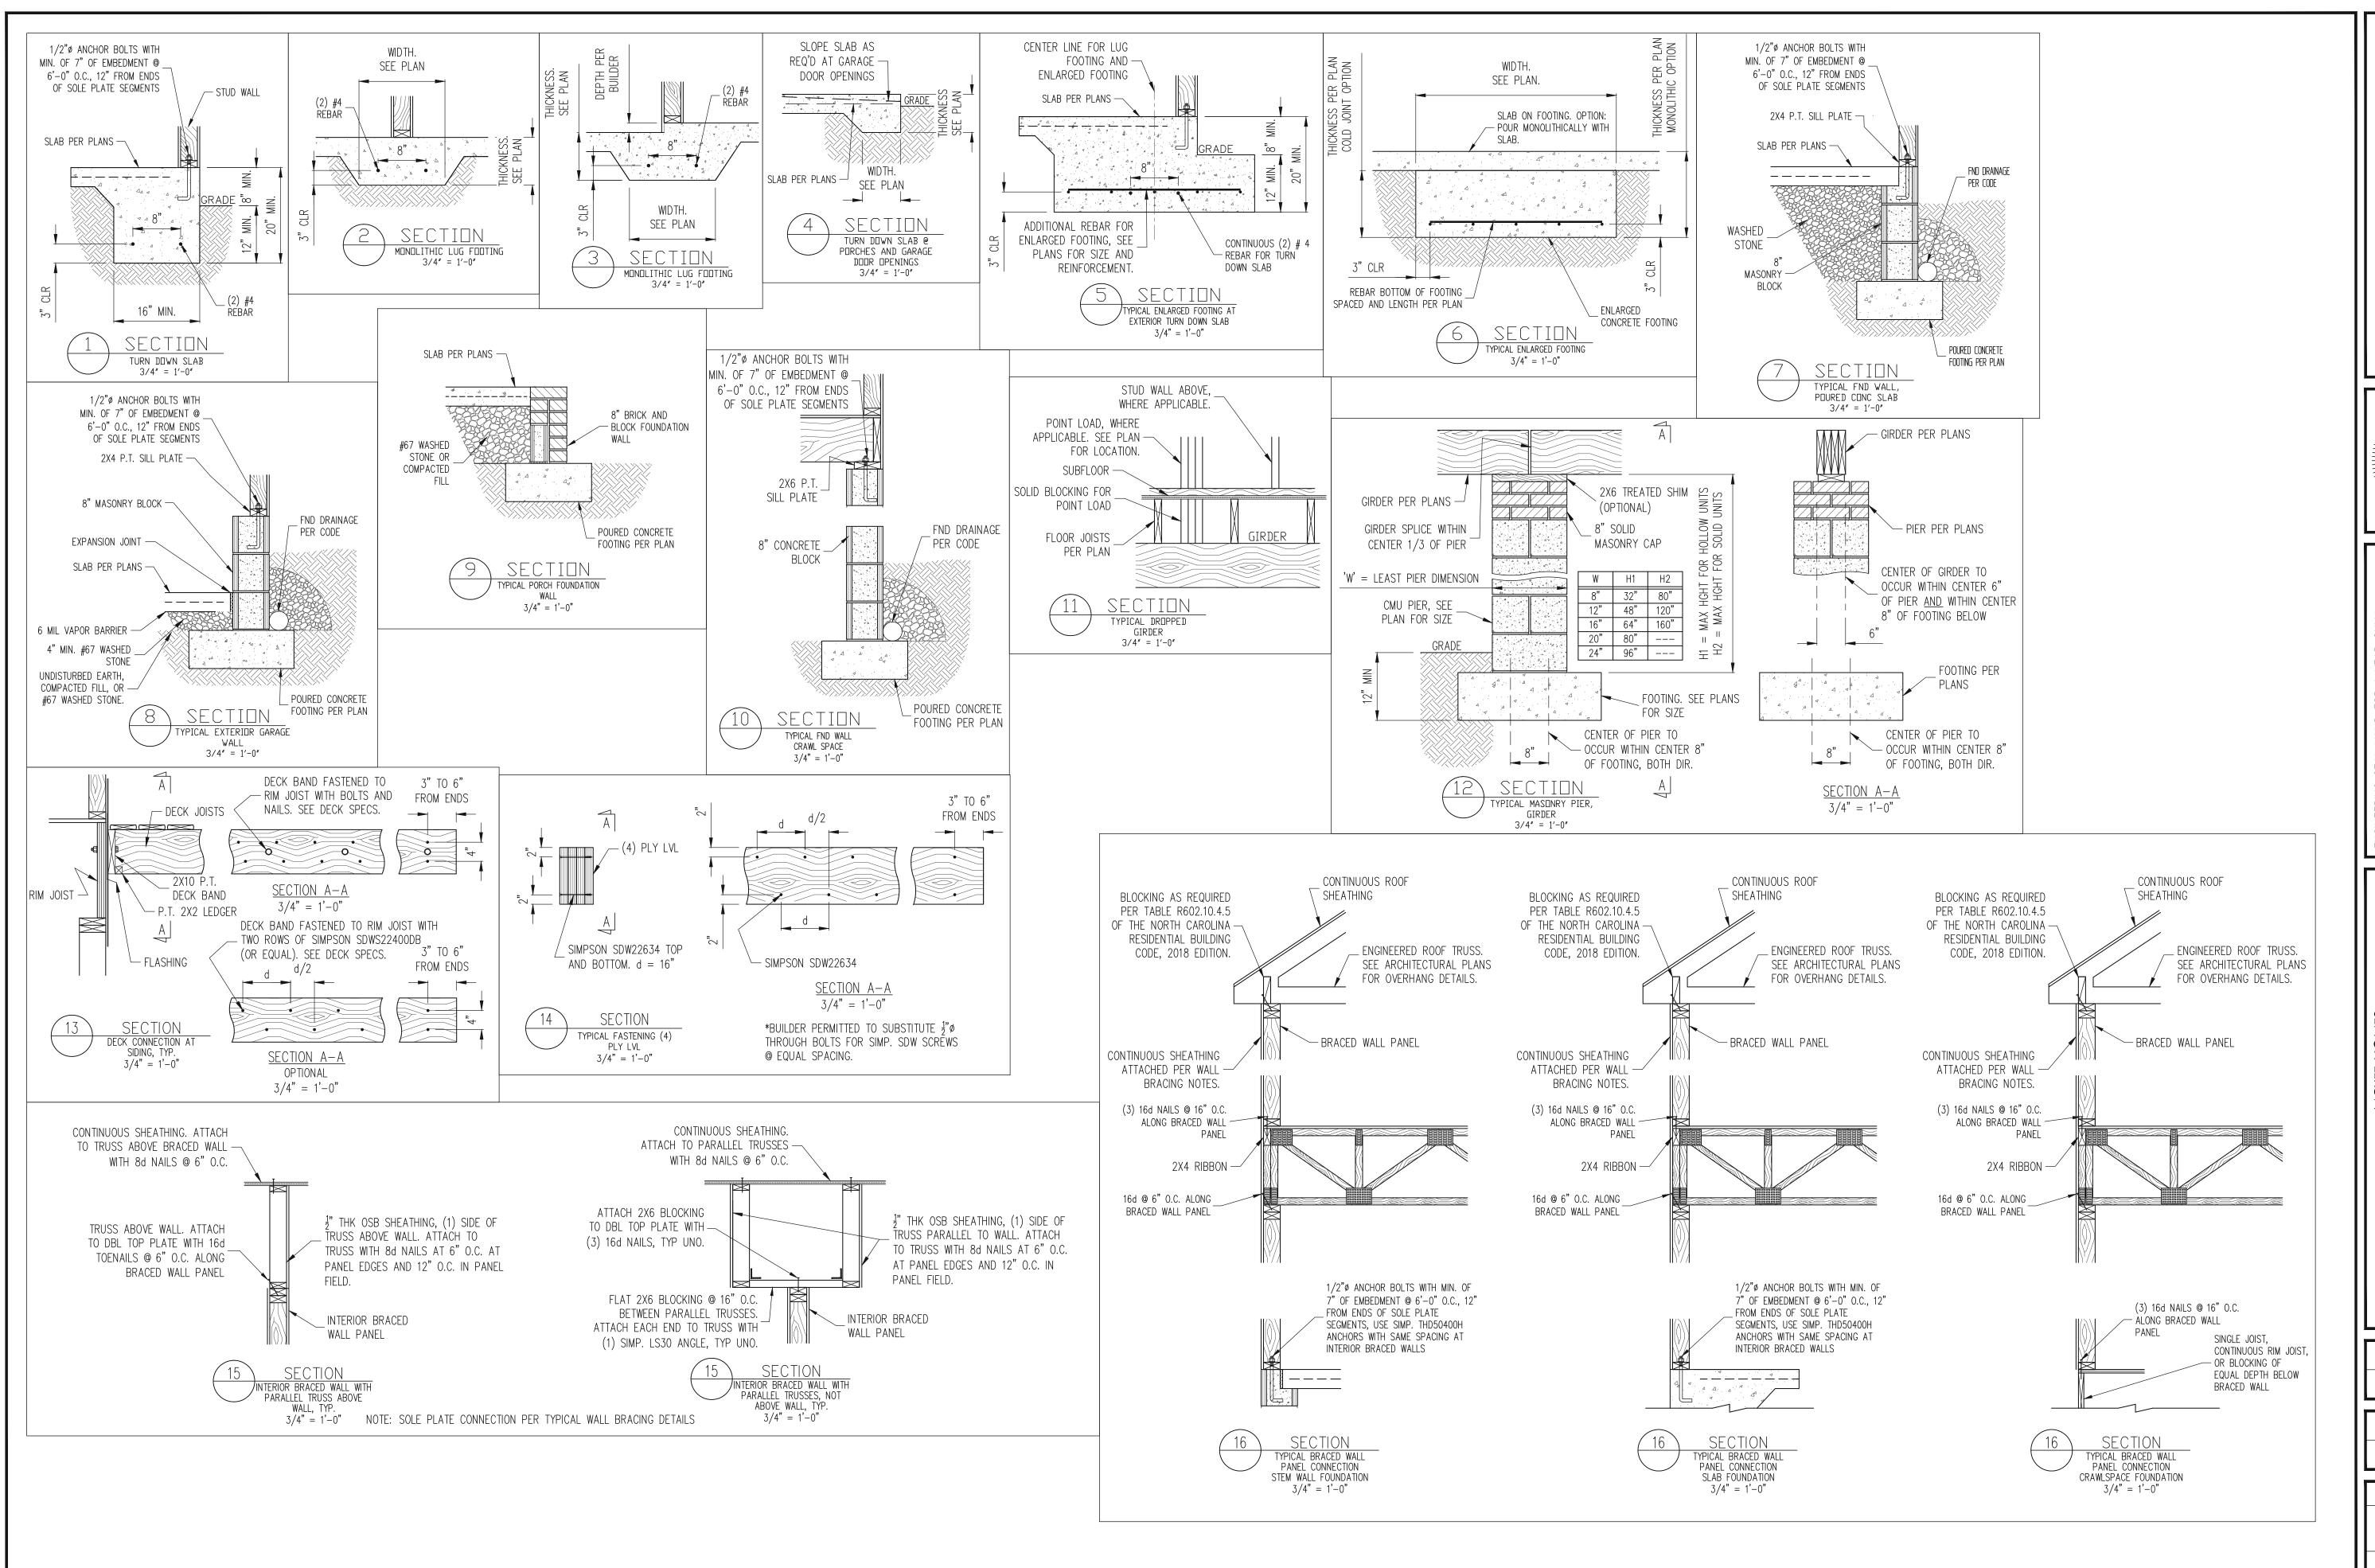

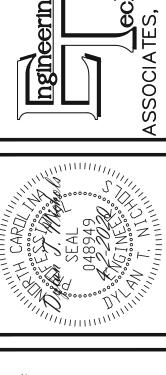

ENGINEERING SEAL VALID FOR 1 YEAR ONLY.

The structural design of this plan is the property Engineering Tech Associates, P.A. These plans ar for the client listed only. Engineering Tech Associates, P.A. assumes no liability for these plif construction or permitting takes place more that year after the seal date without written permission from Engineering Tech Associates, P.A.

		DTN		4-2-2020
	MDUM	ENG	REV:	DATE
MCKEE HOMES	STRUCTURAL ADDENDUM			
MCK	STRUCTUR			
CLIENT:	SCOPE	LOT #:		
IJ	)S	Γί		


PLAN NO. CLARK LH

PROJECT NO. 20-29-018L

SD1

36 of 37

SHEET NO.

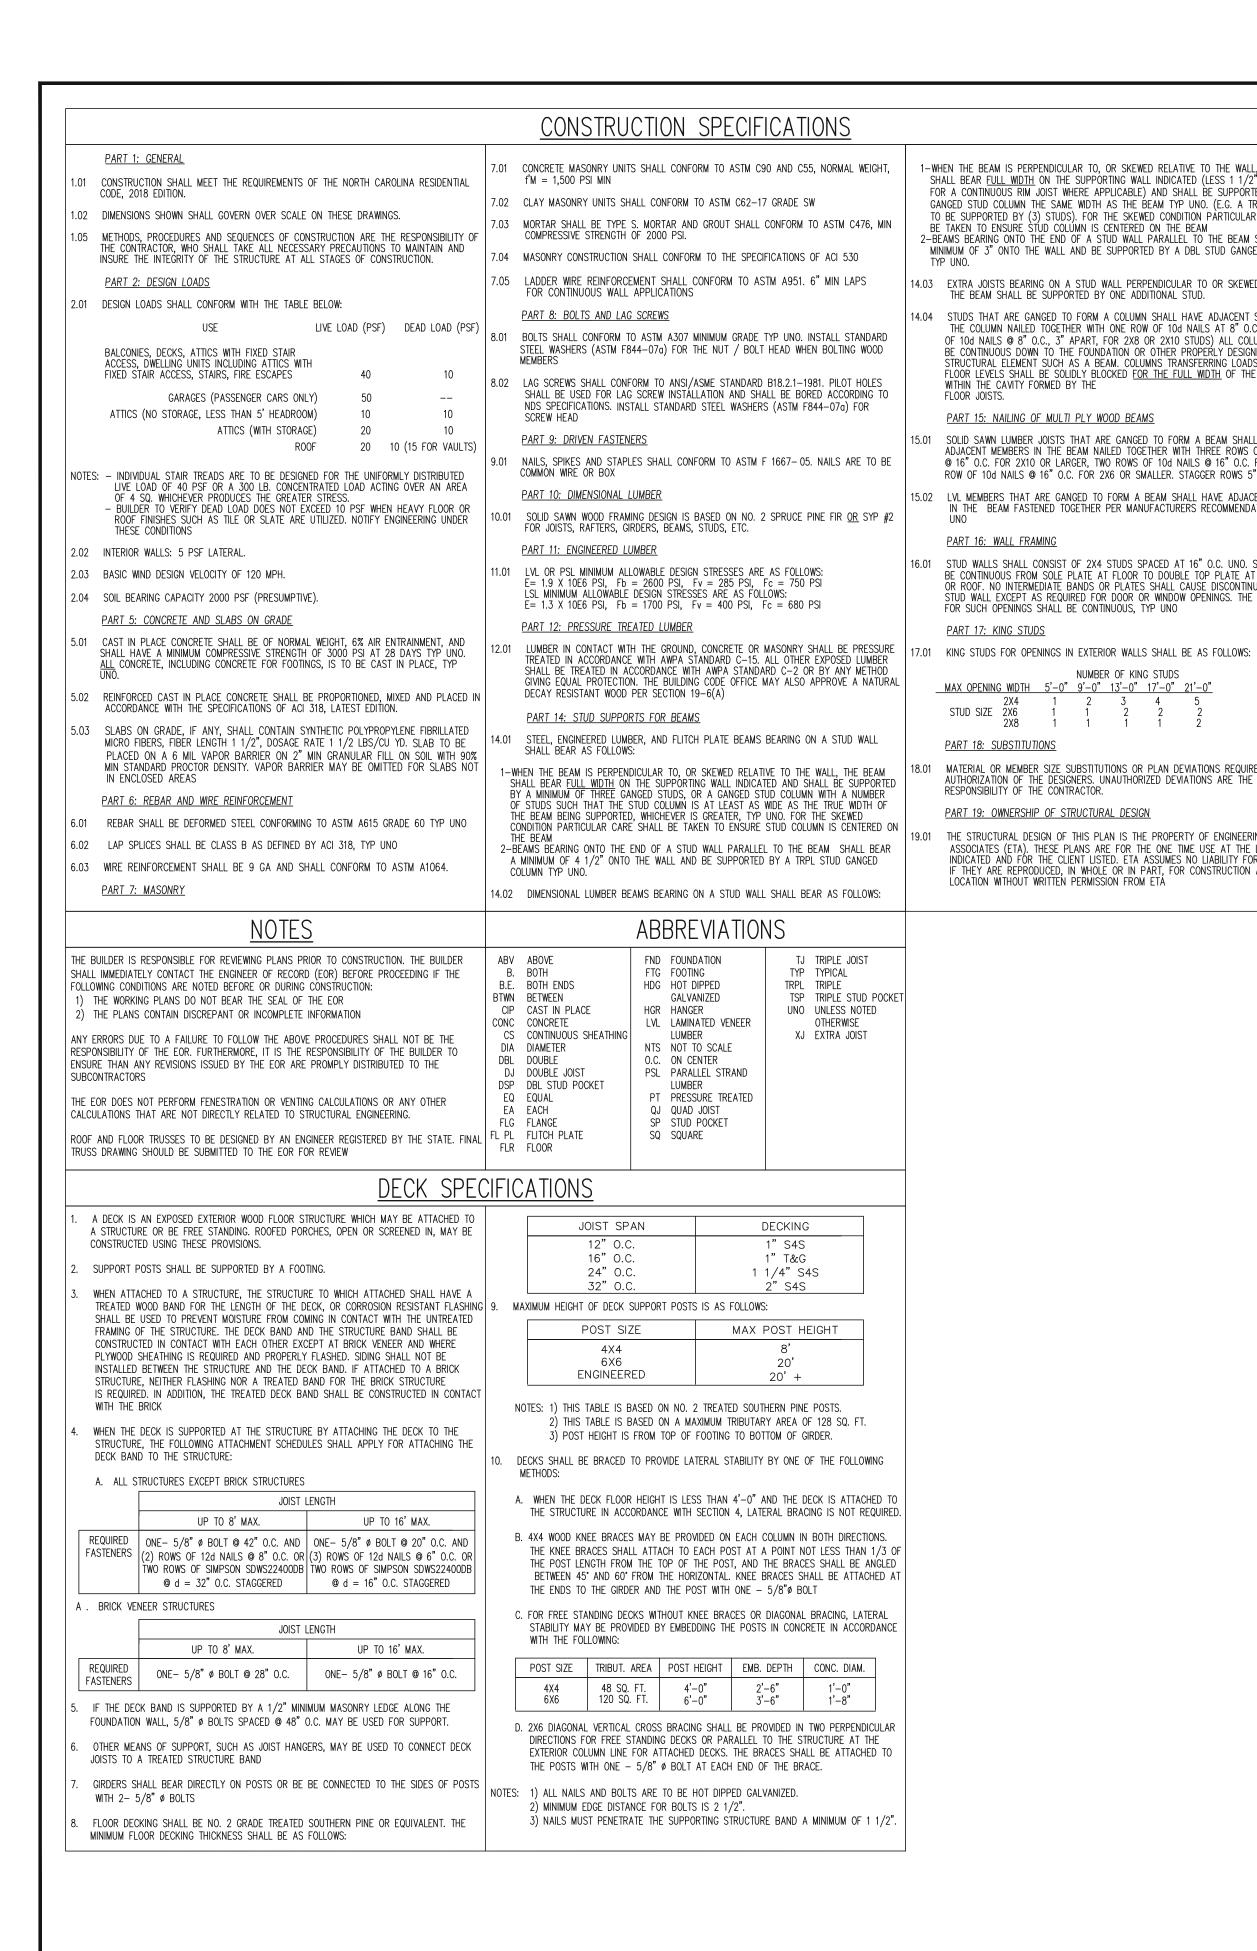



(2) CONT. 2X TOP PLATES, EXTEND EACH END 1-WHEN THE BEAM IS PERPENDICULAR TO, OR SKEWED RELATIVE TO THE WALL, THE BEAM SHALL BEAR FULL WIDTH ON THE SUPPORTING WALL INDICATED (LESS 1 1/2" TO ALLOW INTO ADJACENT WALL. NAIL SPLICES WITH -FOR A CONTINUOUS RIM JOIST WHERE APPLICABLE) AND SHALL BE SUPPORTED BY A 8-16d NAILS PER SPLICE/LAP. GANGED STUD COLUMN THE SAME WIDTH AS THE BEAM TYP UNO. (E.G. A TRIPLE 2X10 IS TO BE SUPPORTED BY (3) STUDS). FOR THE SKEWED CONDITION PARTICULAR CARE SHALL CONT. 2X PLATE WITH 10d NAILS AT 2-BEAMS BEARING ONTO THE END OF A STUD WALL PARALLEL TO THE BEAM SHALL BEAR A 16" O.C. INTO HEADER/BEAM MINIMUM OF 3" ONTO THE WALL AND BE SUPPORTED BY A DBL STUD GANGED COLUMN 4.03 EXTRA JOISTS BEARING ON A STUD WALL PERPENDICULAR TO OR SKEWED RELATIVE TO 7/16" O.S.B. OR 15/32" PLYWOOD EXTERIOR WALL /•/*•*/•/•/•/ MINIMUM 3"x111/4" CONTINUOUS BEAM FULL SHEATHING AT UNSHADED AREAS (BEAM, INFILL 4.04 STUDS THAT ARE GANGED TO FORM A COLUMN SHALL HAVE ADJACENT STUDS WITHIN LENGTH OF FRAME, SEE PLANS FOR SIZE THE COLUMN NAILED TOGETHER WITH ONE ROW OF 10d NAILS AT 8" O.C. (TWO ROWS WALL ABOVE BEAM, AND CENTER WALL). NAIL OF 10d NAILS @ 8" O.C., 3" APART, FOR 2X8 OR 2X10 STUDS) ALL COLUMNS SHALL SHEATHING TO ALL SUPPORTS (STUDS, PLATES, BE CONTINUOUS DOWN TO THE FOUNDATION OR OTHER PROPERLY DESIGNED STRUCTURAL ELEMENT SUCH AS A BEAM. COLUMNS TRANSFERRING LOADS THROUGH BLOCKING, ETC.) WITH 8d NAILS AT 6" O.C. AT FLOOR LEVELS SHALL BE SOLIDLY BLOCKED FOR THE FULL WIDTH OF THE STUD COLUMN NAIL THE SHEATHING IN SHADED SHEET EDGES AND 12" O.C. IN THE FIELD. - AREA TO BEAM WITH 8d NAILS AT 3" O.C. EACH WAY SOLID SAWN LUMBER JOISTS THAT ARE GANGED TO FORM A BEAM SHALL HAVE ADJACENT MEMBERS IN THE BEAM NAILED TOGETHER WITH THREE ROWS OF 10d NAILS @ 16" O.C. FOR 2X10 OR LARGER, TWO ROWS OF 10d NAILS @ 16" O.C. FOR 2X8, ONE WHERE FULL HEIGHT PANEL WIDTH EXCEEDS 16",  $\sim$  (2) ROWS 16d NAILS AT 3" O.C. ROW OF 10d NAILS @ 16" O.C. FOR 2X6 OR SMALLER. STAGGER ROWS 5" MIN. PROVIDE ADDITIONAL STUDS AT 16" O.C. NAIL -LVL MEMBERS THAT ARE GANGED TO FORM A BEAM SHALL HAVE ADJACENT MEMBERS 900 /0 /0/ 0 /0 /0/ 90 IN THE BEAM FASTENED TOGETHER PER MANUFACTURERS RECOMMENDATIONS, TYP SHEATHING TO ALL STUDS WITH 8d NAILS AT 3" O.C. (2) SIMPSON CS16 x 48" LONG COIL - STRAPS WITH 10d NAILS EACH HOLE ON INSIDE FACE OF WALL FOR A PANEL SPLICE (IF NEEDED), PANEL STUD WALLS SHALL CONSIST OF 2X4 STUDS SPACED AT 16" O.C. UNO. STUDS SHALL BE CONTINUOUS FROM SOLE PLATE AT FLOOR TO DOUBLE TOP PLATE AT THE CEILING EDGES SHALL OCCUR OVER AND BE NAILED OR ROOF. NO INTERMEDIATE BANDS OR PLATES SHALL CAUSE DISCONTINUITIES IN A TO COMMON BLOCKING AND OCCUR WITHIN — STUD WALL EXCEPT AS REQUIRED FOR DOOR OR WINDOW OPENINGS. THE KING STUDS 24" OF WALL HEIGHT. ONE ROW OF 3" O.C. NAILING IS REQUIRED IN EACH PANEL EDGE. 7/16" O.S.B. OR 15/32" PLYWOOD PORTAL FRAME WALL EXTERIOR WALL SHEATHING. AT SHADED 3/4" = 1'-0" AREAS NAIL SHEATHING TO ALL SUPPORTS -(STUDS, PLATES, BLOCKING, ETC.) WITH 8d NAILS AT 3" O.C. MATERIAL OR MEMBER SIZE SUBSTITUTIONS OR PLAN DEVIATIONS REQUIRE THE WRITTEN AUTHORIZATION OF THE DESIGNERS. UNAUTHORIZED DEVIATIONS ARE THE SOLE (2)2x STUD MIN. AT START AND END OF CONCRETE OR MASONRY FND WALL. WALL SEGMENTS EACH SIDE OF OPENING. -SEE PLANS FOR ADDITIONAL STUDS THE STRUCTURAL DESIGN OF THIS PLAN IS THE PROPERTY OF ENGINEERING TECH ASSOCIATES (ETA). THESE PLANS ARE FOR THE ONE TIME USE AT THE LOCATION INDICATED AND FOR THE CLIENT LISTED. ETA ASSUMES NO LIABILITY FOR THESE PLAN IF THEY ARE REPRODUCED, IN WHOLE OR IN PART, FOR CONSTRUCTION AT ANY OTHER 2x4 P.T. PLATE WITH TWO 1/2" DIA x 7" EMBED

ANCHOR BOLTS WITH A 3/16"x2"x2" PLATE -

WASHERS OR ADDITIONAL HOLDOWN PER PLANS

NUMBER OF KING STUDS

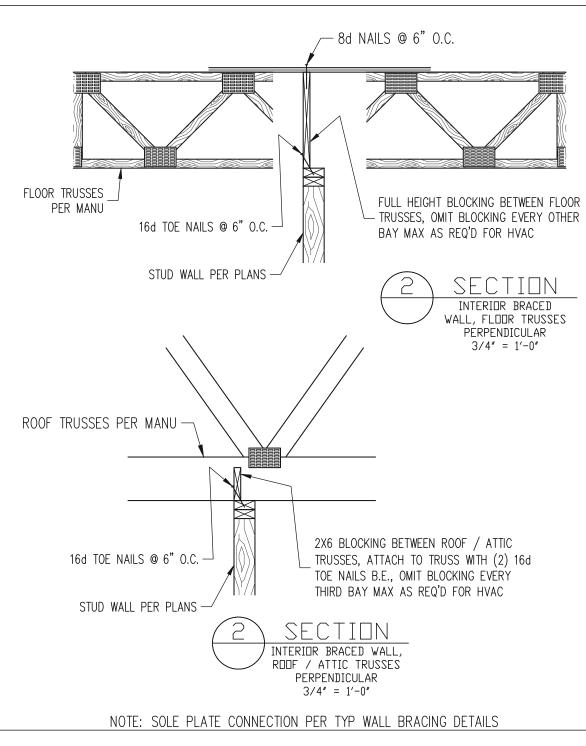

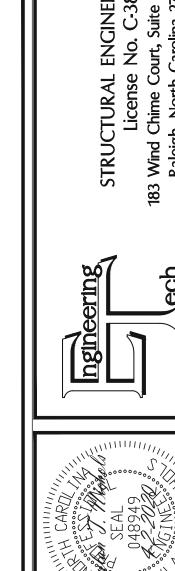

ე <u>გ</u> >

		DIN		DATE 4-2-2020
	WNC	ENG	REV:	DATE
MCKEE HOMES	STRUCTURAL ADDENDUM			
CLIENT:	SCOPE	FOI #:		

PLAN NO. CLARK LH

PROJECT NO. 20-29-018L

37 of 37

SHEET NO.