

- EXTERIOR SHEATHING OR INSULATION BD, SEE BUILDER'S SPECS.

SEE BUILDER'S SPECS

- EXTERIOR FINISH


- SOFFIT WITH VENTS

PROVIDE GUTTERS AND DOWNSPOLITS PER CODE


— TRUSS OR RAFTERS PER SPECIFICATION


— ROOF SHEATHING (SEE SPEC.)

— ASPHALT SHINGLES — #15 FELT (SEE SPEC,)

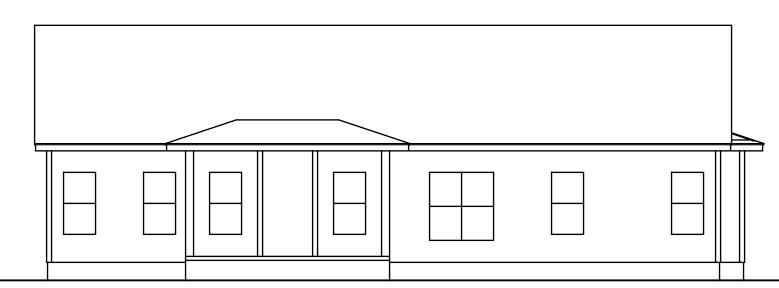


REAR ELEVATION SCALE:1/8"=1'-0"

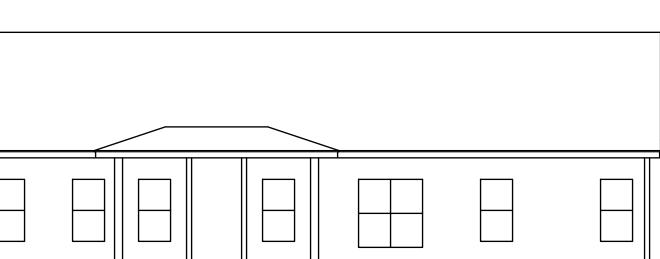

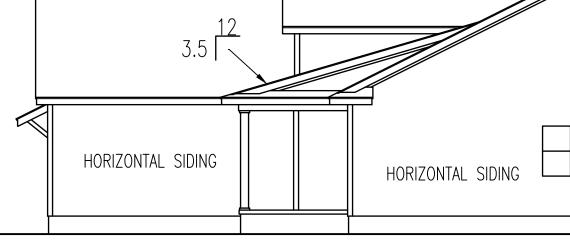




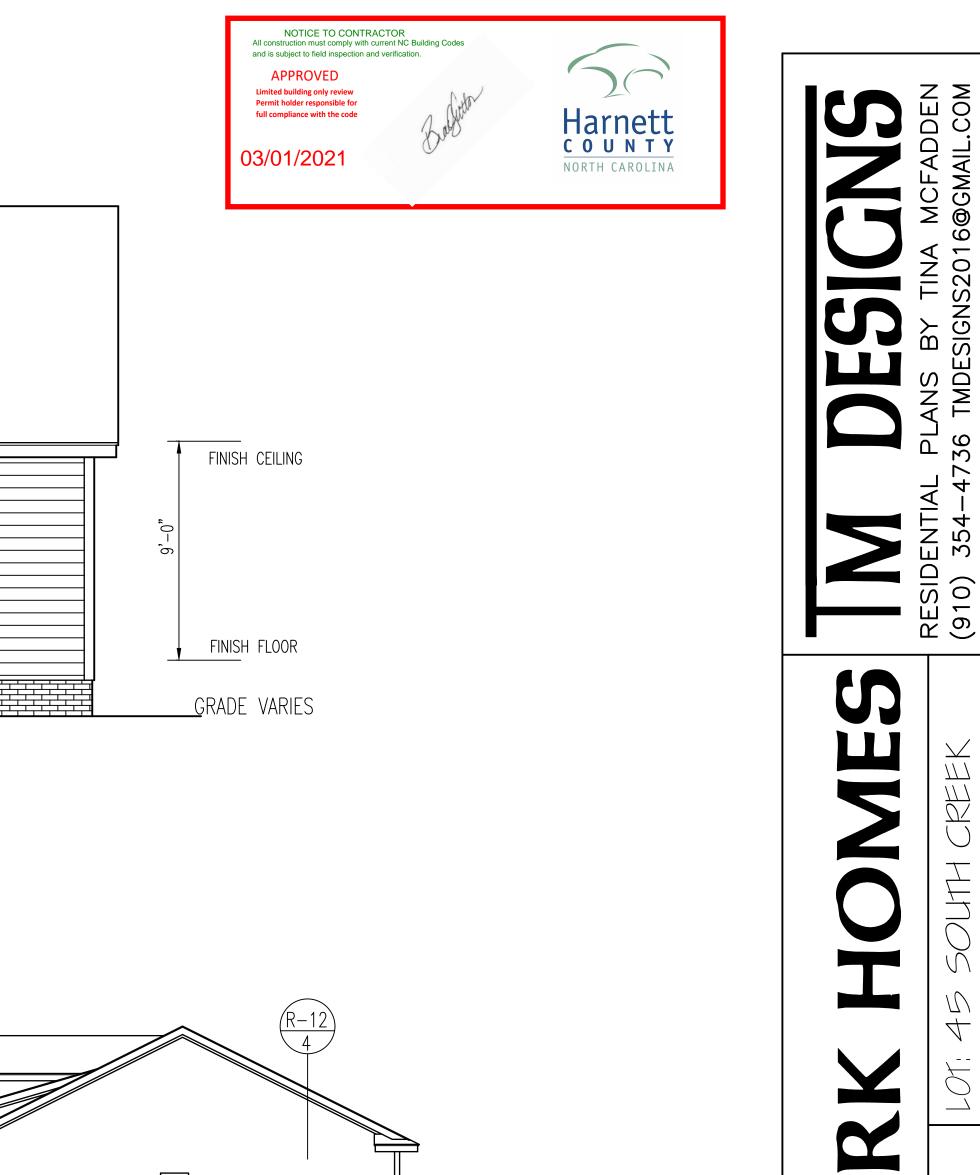

RIGHT ELEVATION

INE RESIDENCE DESIGN F		RED CAMELLIA		
EXCLUS		NAME		
○ 2019 COPYRIGHT ALL RIGHTS RESERVED TM DESIGNS WILL NOT BE LIABLE FOR ANY ERRORS NOT BROUGHT TO THEIR ATTENTION PRIOR TO THE START OF CONSTRUCTION, WHILE EVERY EFFORT WAS MADE IN THE PREPARATION OF THESE DRAWINGS AND DIMENSIONS TO AVOID ERRORS THE OWNER AND / OR BUILDER SHALL VERIFY ALL DIMENSIONS, DETAILS, LOCAL AND STATE CODES.				
I HEREBY CERTIF MEETS LOCAL (INTERNATIONAL THIS IS FOR TI OF ONE HOU? LOT, NOT TO	CODES, 20 BUILDING (HE CONST SE ON A S	18 CODES RUCTION FINGLE		
plan number RG21—A02F				
	GARAGE DATE: 10/2	FL 9/20		

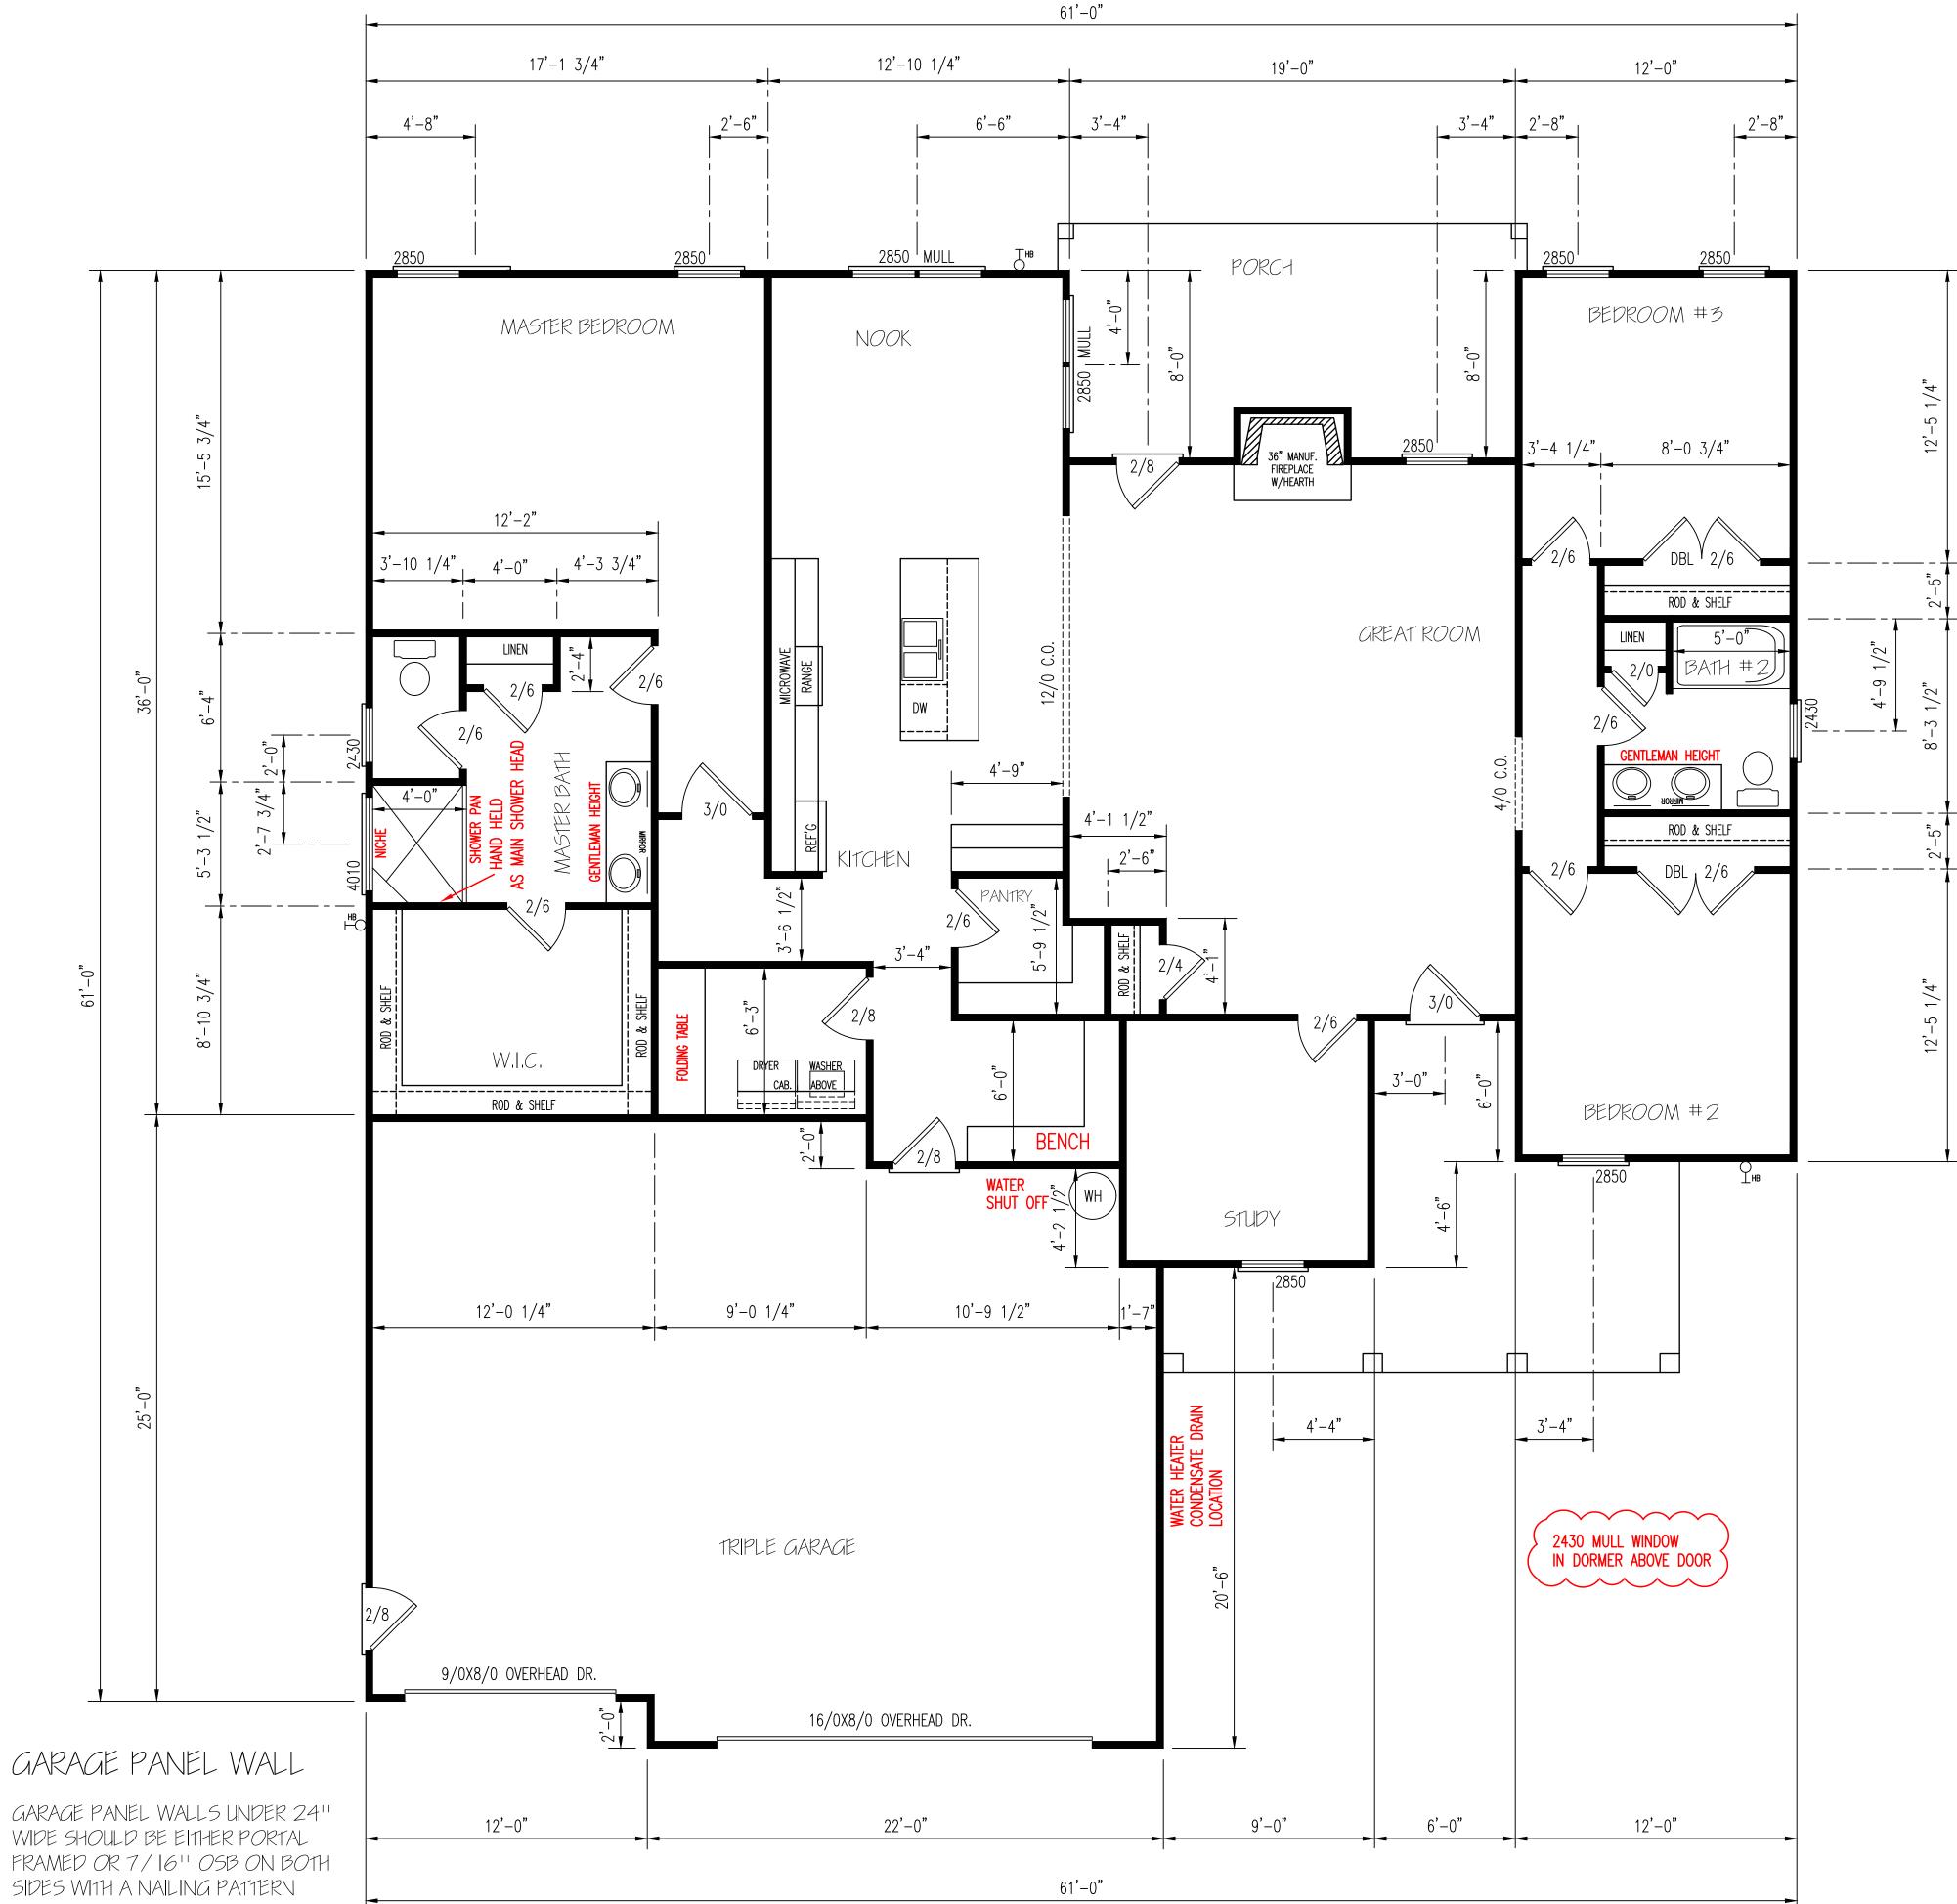


OF 311 ON ALL PANEL EDGES AND 6" IN THE FIELD,





GARAGE F.PORCH R.PORCH

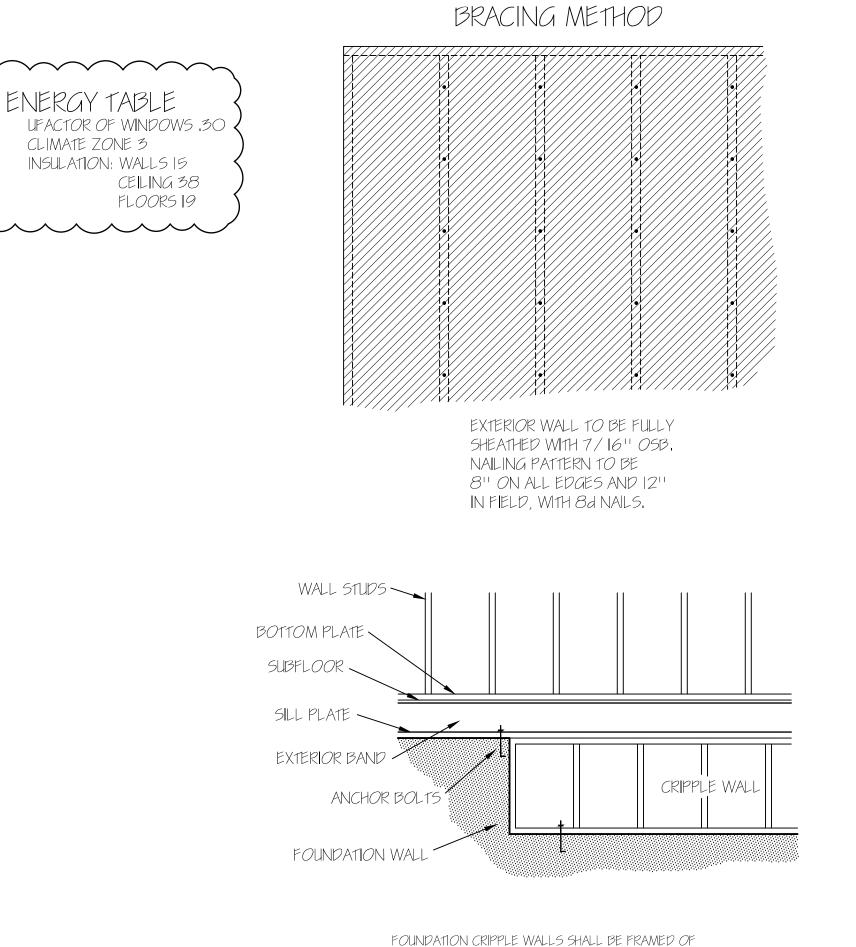

XERIOR WALLS					
2X10 HEADERS					
SPAN	NUMBER OF STUDS				
HEADER	JACKS	KINGS			
Ŗ & C.O. ⊦	1	1			
R & C.O. '-11"	2	2			
R & C.O. ABOVE	Sized by Engineer				
S NOTED	OTHER	WISE**			

FLOOR PLAN SCALE:1/4''=1'-0''

HEATED AREA


<u>2|46</u> SQ FT


<u>OTHER AREAS</u>

85	SQ FT
194	SQ FT
92	SQ FT


- FOUNDATION CRIPPLE WALLS SHALL BE FRAMED OF STUDS NOT SMALLER THAN THE STUDDING ABOVE. WHEN EXCEEDING 4 FT. IN HEIGHT, SUCH WALLS SHALL BE FRAMED OF STUDS HAVING THE SIZE REQUIRED FOR AN ADDITIONAL STORY,
- CRIPPLE WALLS WITH A STUD HEIGHT LESS THAN 14 INCHES SHALL BE CONTINUOUSLY SHEATHED ON ONE SIDE WITH WOOD STRUCTURAL PANELS FASTENED TO BOTH THE TOP AND BOTTOM PLATES IN ACCORDANCE WITH TABLE R602.3(1), OR CRIPPLE WALLS SHALL BE CONSTRUCTED OF SOLID BLOCKING.


HERO PACKAGE

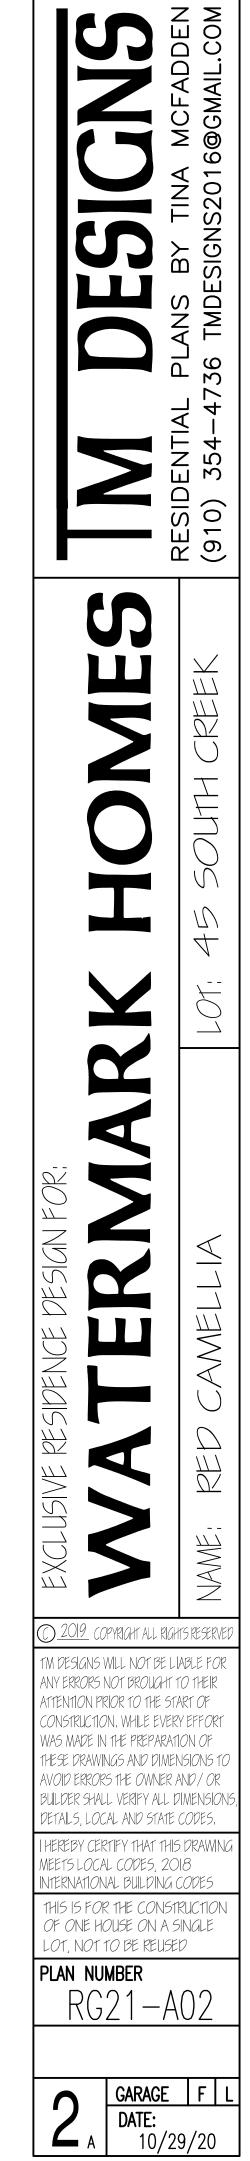

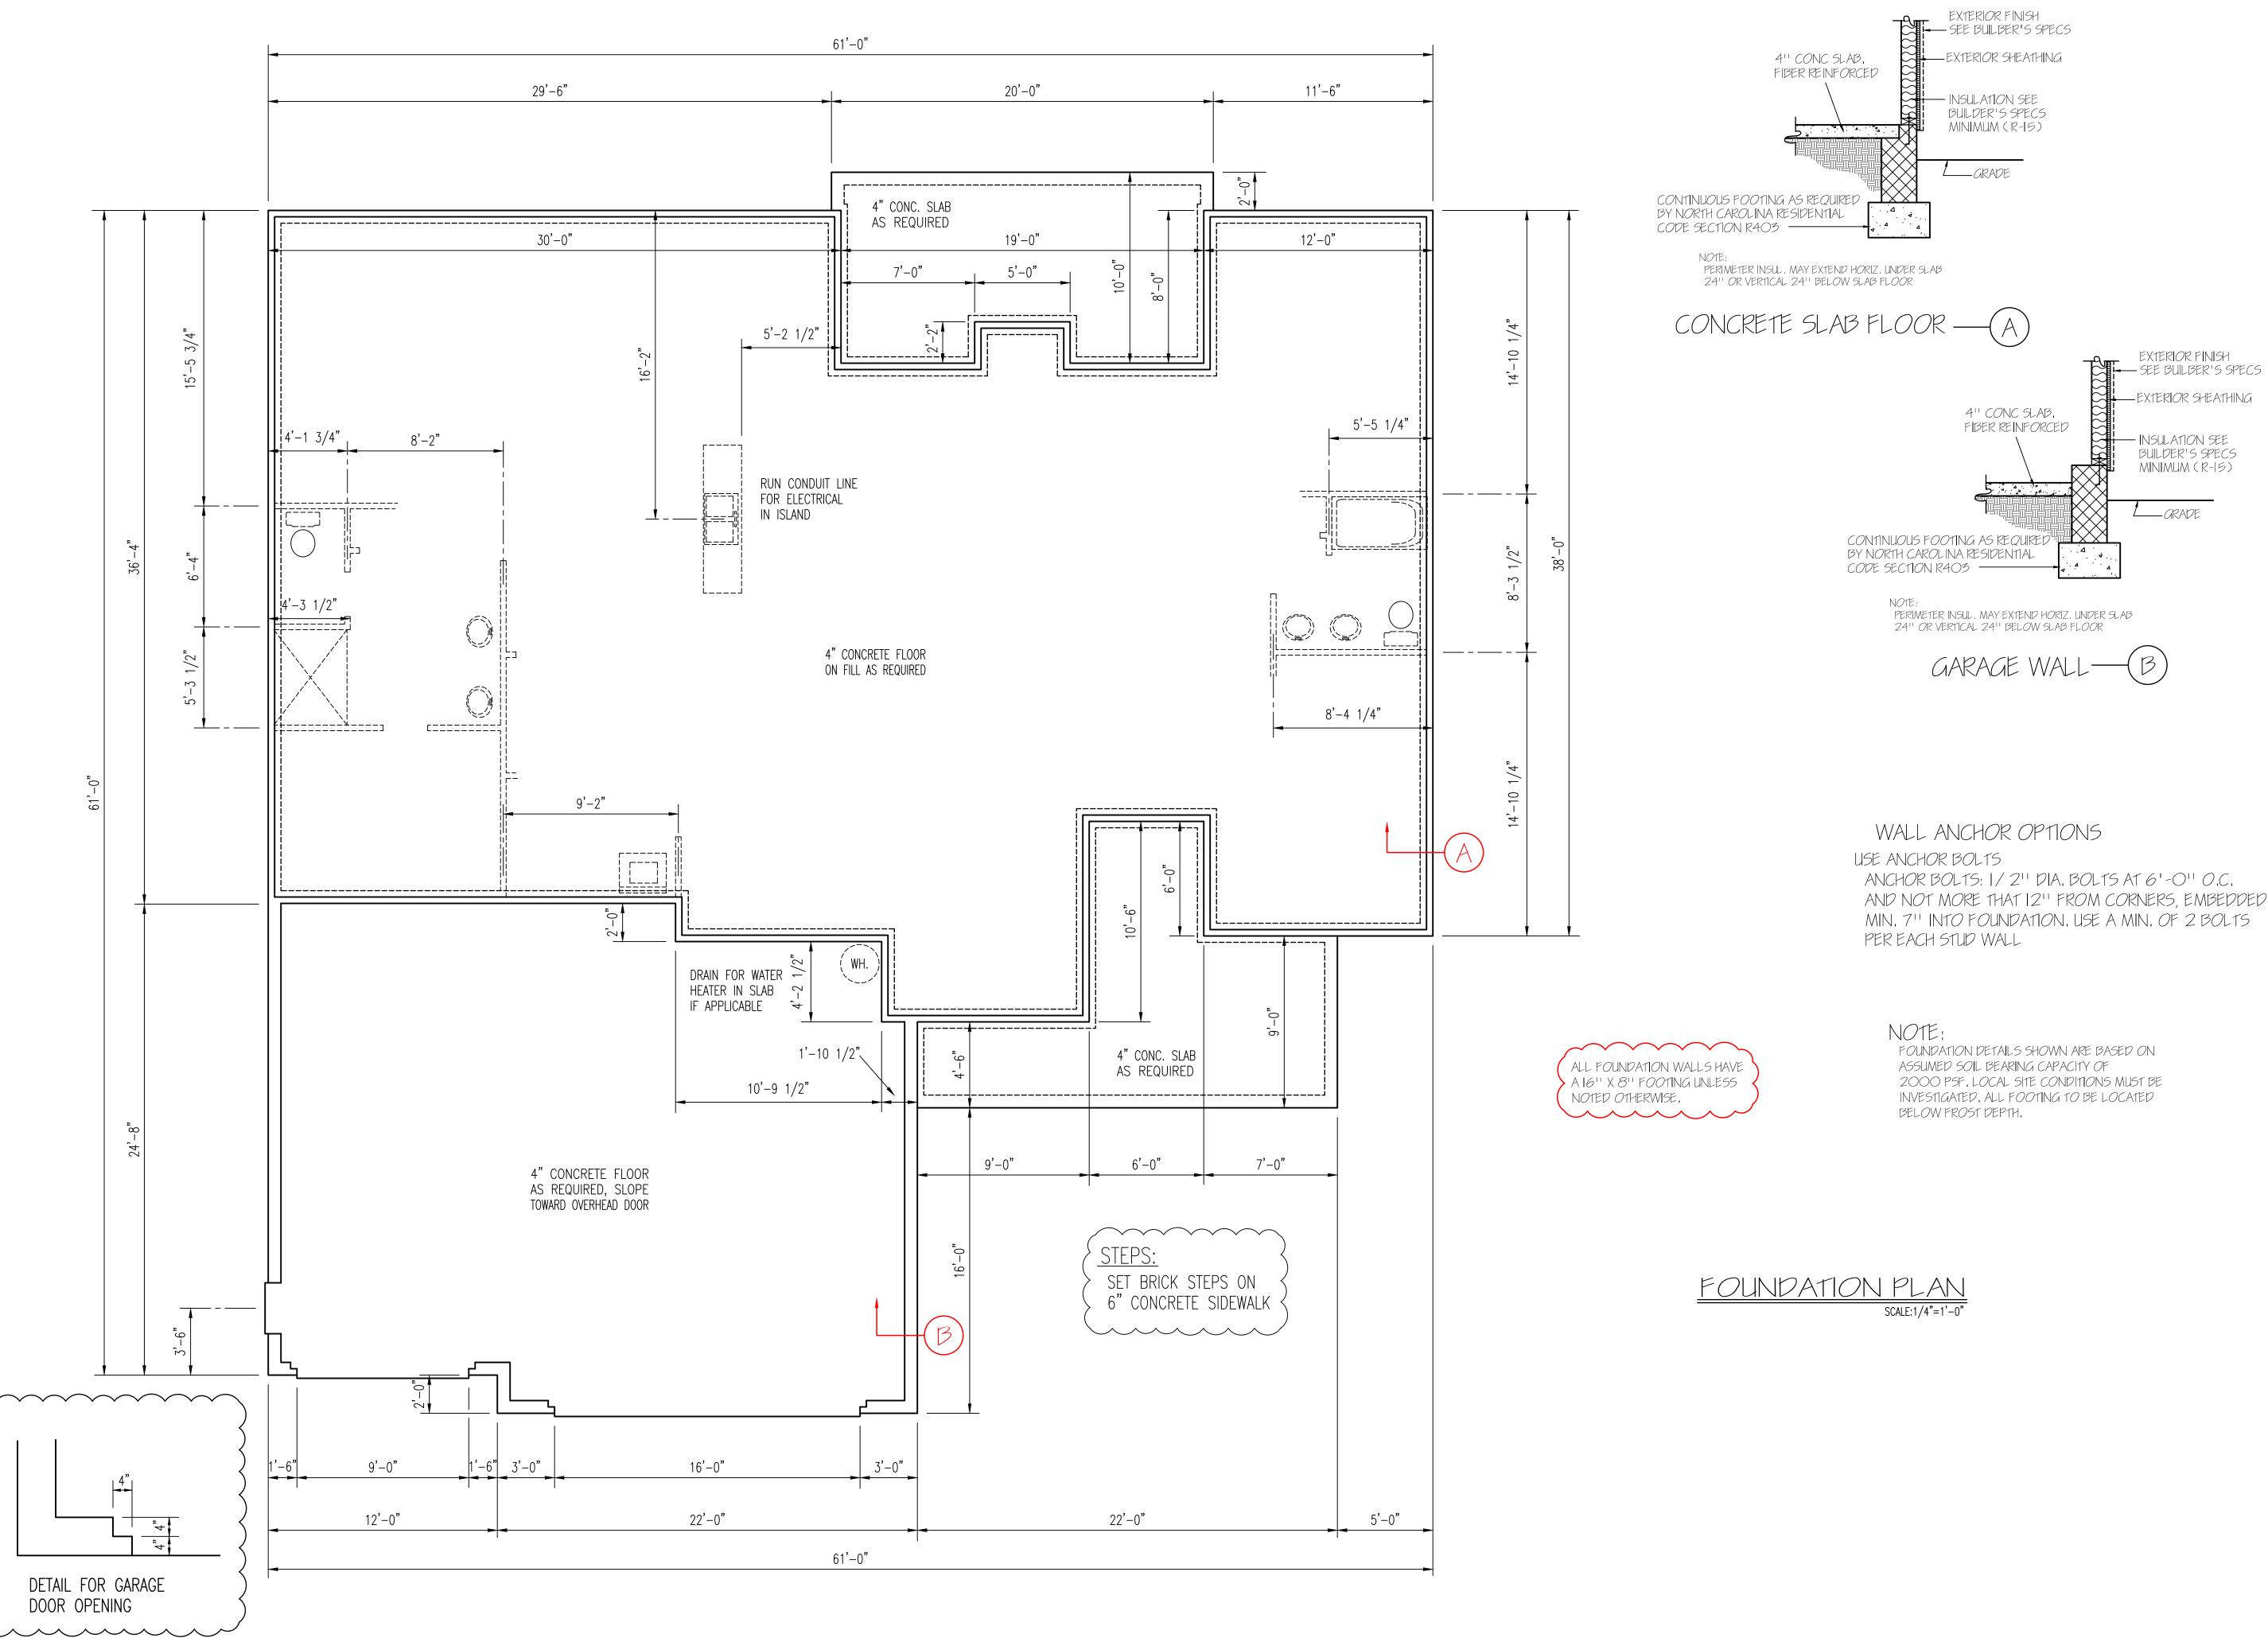


AND NOT MORE THAT 12" FROM CORNERS, EMBEDDED MIN, 7" INTO FOUNDATION, USE A MIN, OF 2 BOLTS

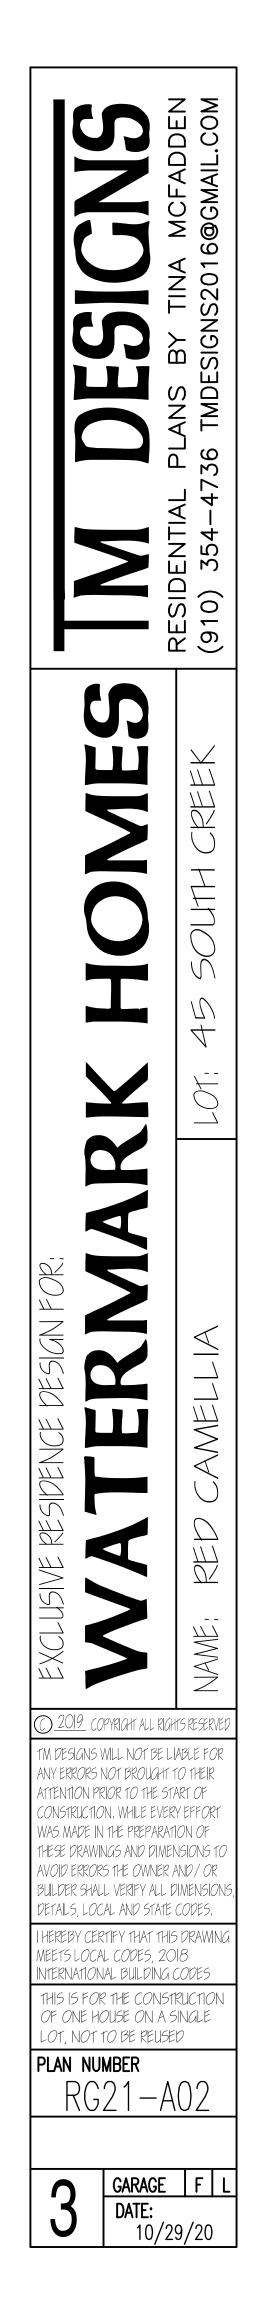

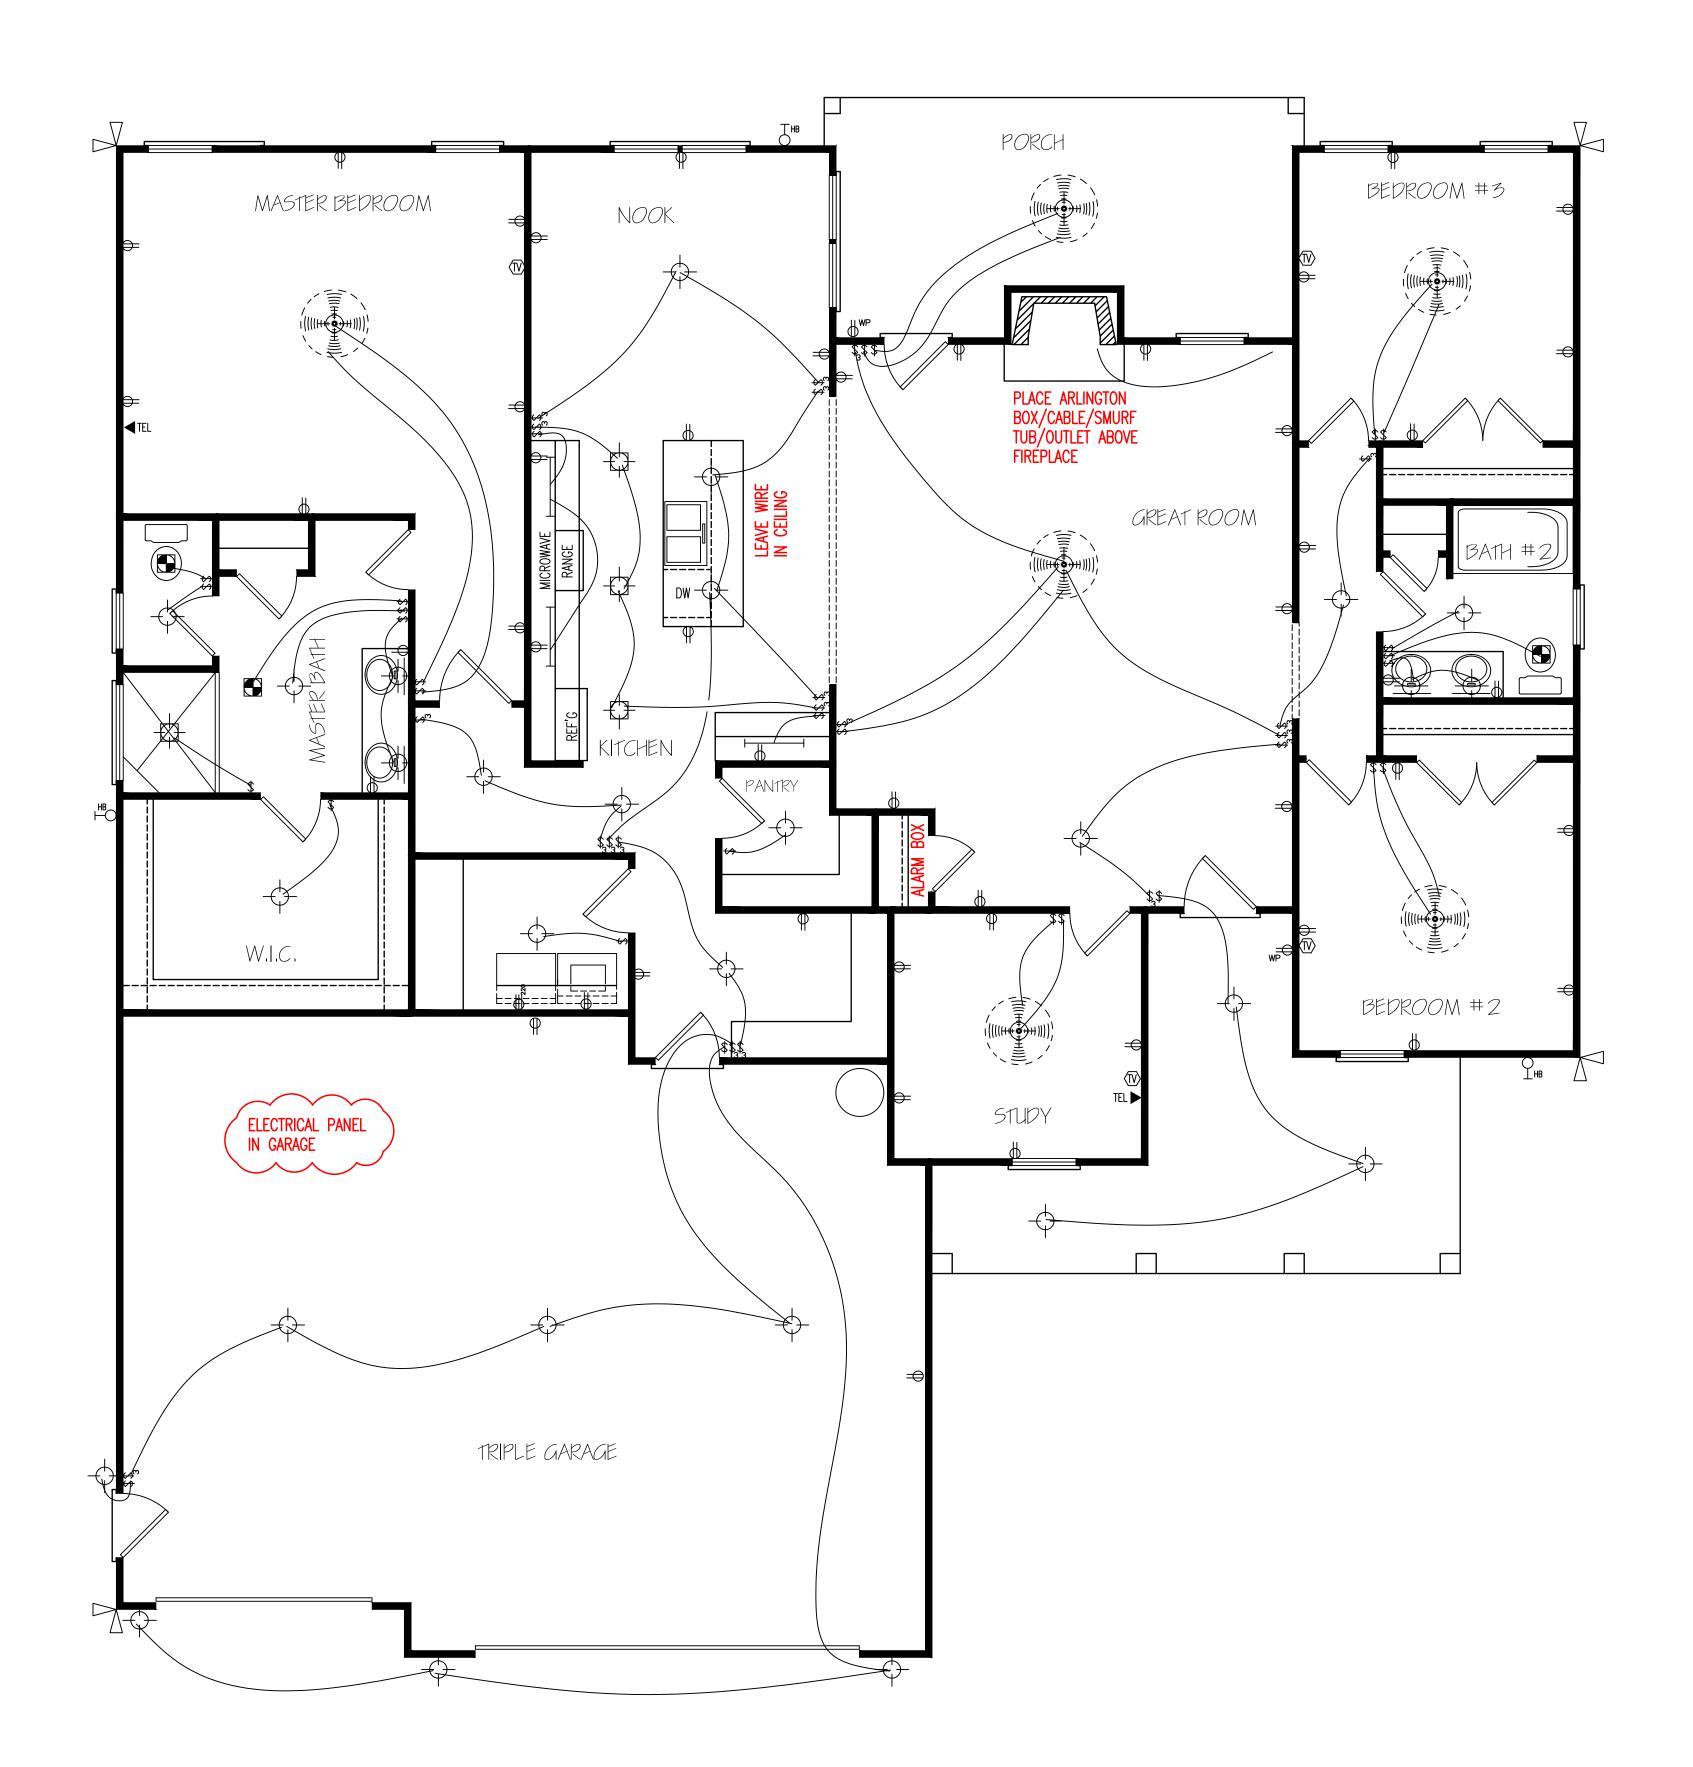



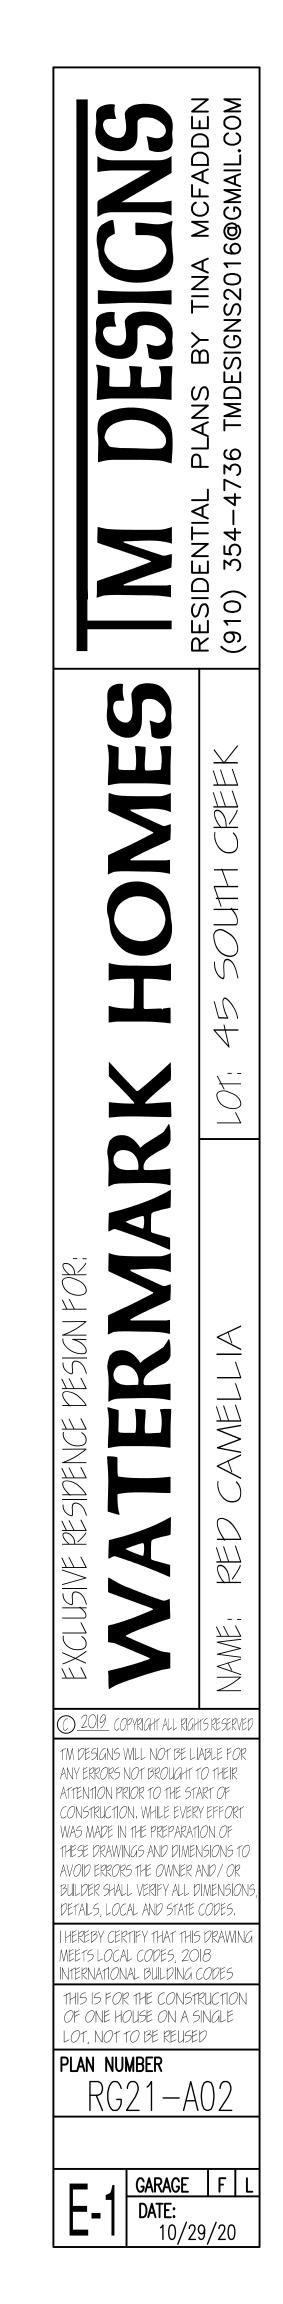


** UNDER CABINET LIGHTING NO SURROUND SOUND NO PREWIRE FOR CAMERA _____

 \frown

HERO PACKAGE

NOTE: SWITCHED RECEPTACLES ARE HOT

ELECTRICAL LAYOUT

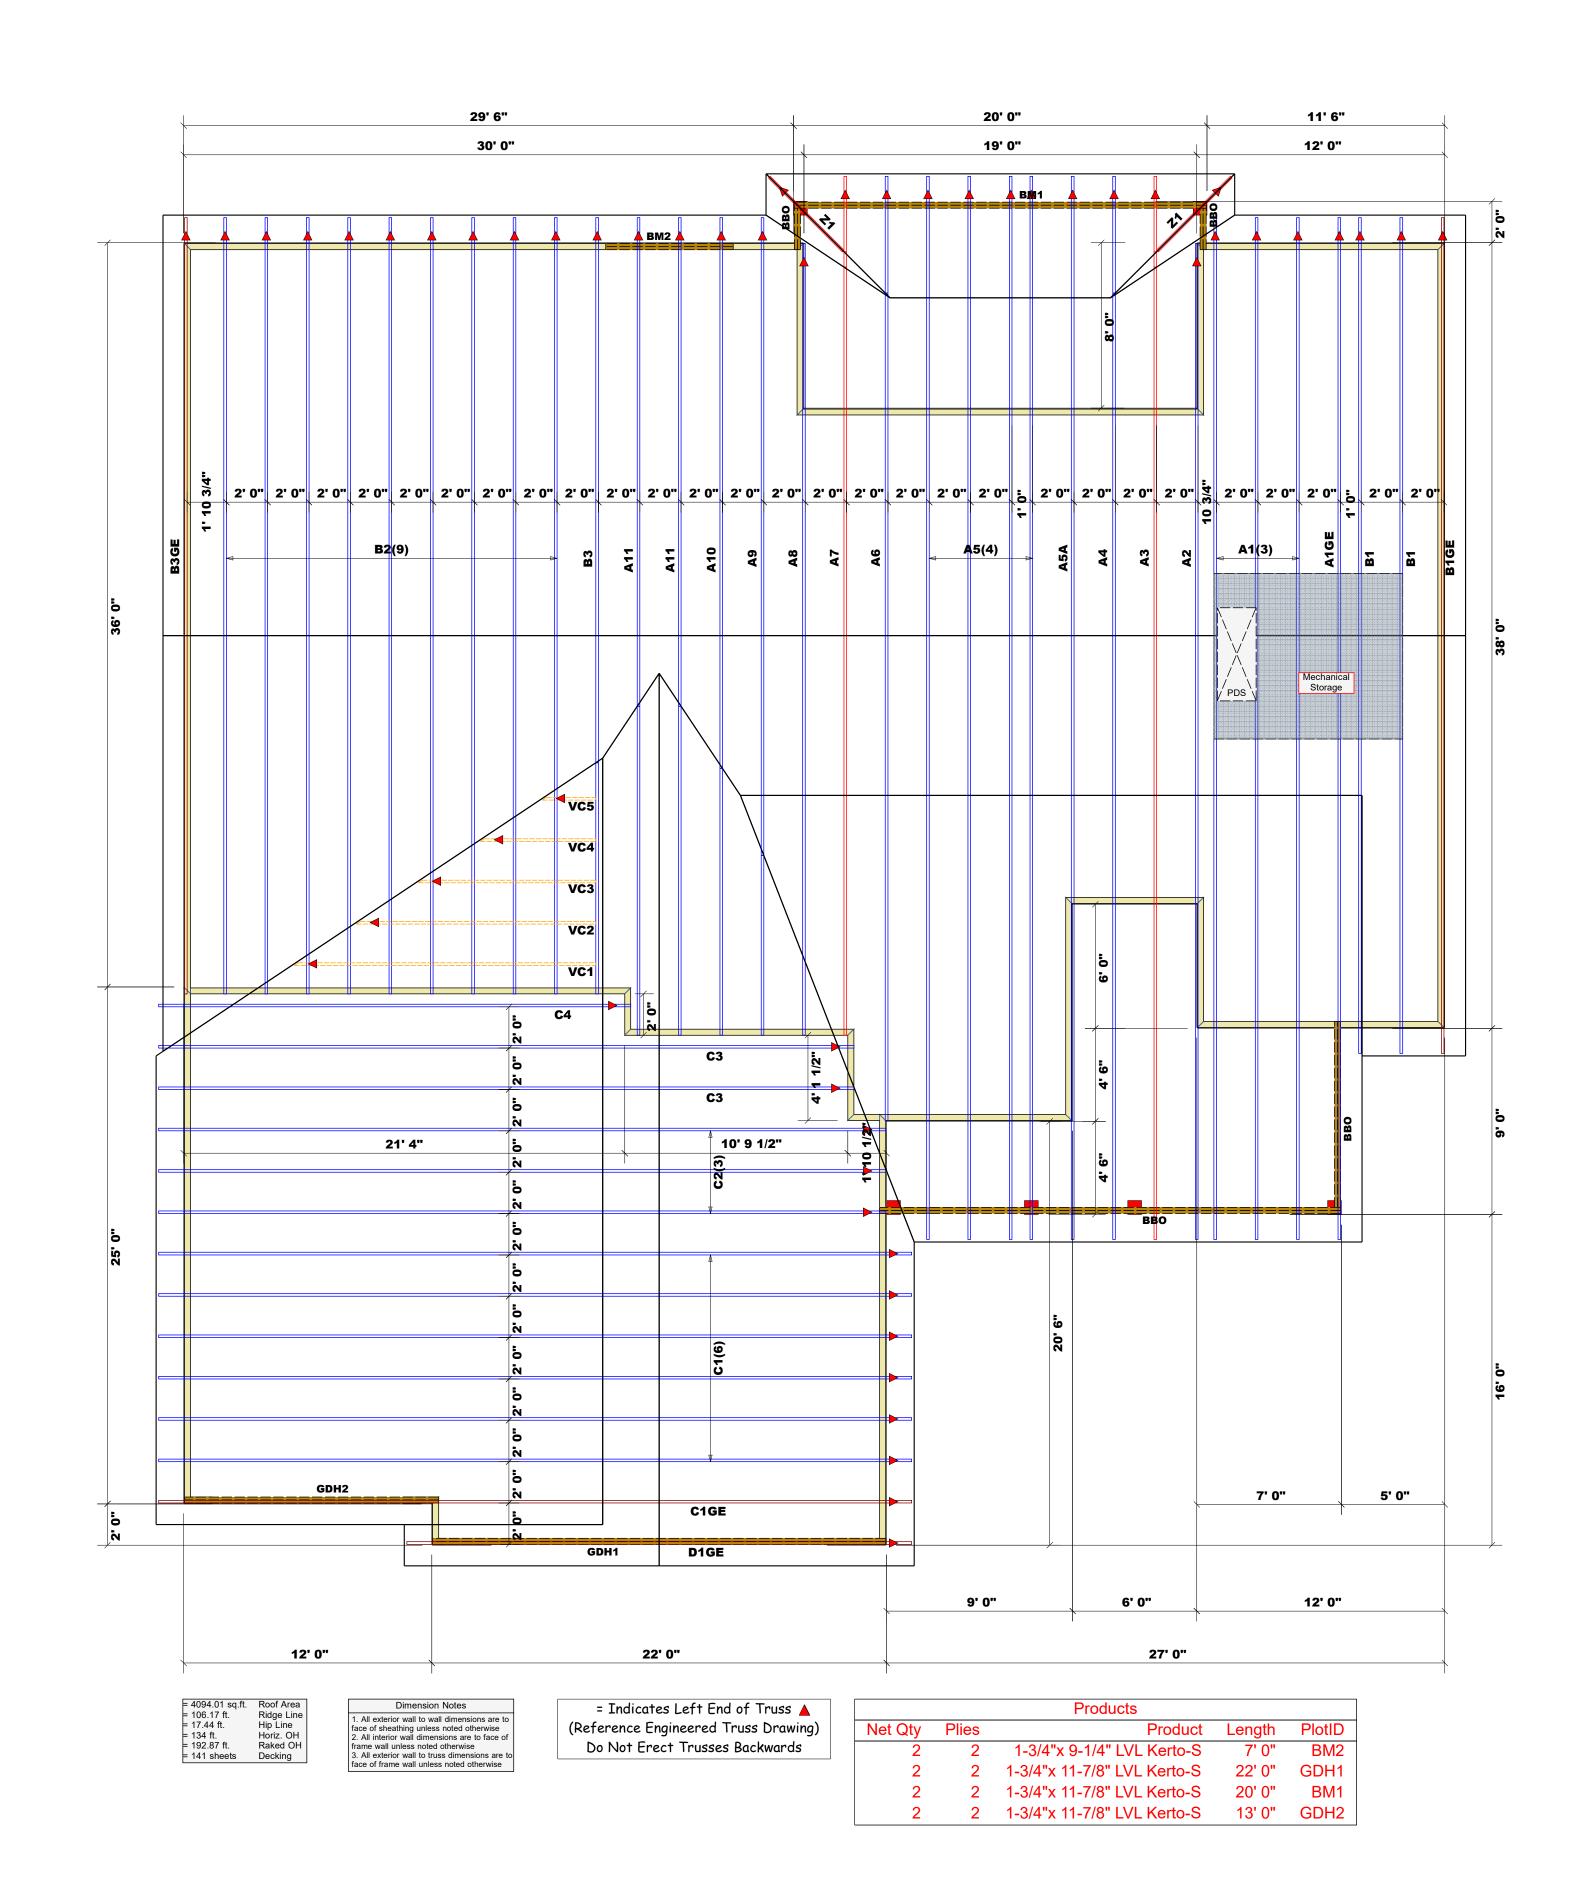

Truss Placement Plan	
SCALE: NTS	

LOAD CHART FOR JACK STUDS (BASED ON TABLES R502.5(1) & (b)) NUMBER OF JACK STUDS REQUIRED @ FA END OF		BUILDER	Watermark Homes	COUNTY	Harnett	THIS IS A TRUSS PLACEMENT DIAGRAM ONLY. These trusses are designed as individual building components to be incorporated into the building design at the specification of the building designer. See individual design sheets for each truss design identified on the placement drawing. The building designer is								
	(UP TO) (UP TO) (UP TO) REQ D STUDS FOR (2) PLY HEADER (2) PLY HEADER (3) PLY HEADER (3) PLY HEADER (3) PLY HEADER (1) PLO (UP TO) (UP TO) (UP TO) (UP TO)	CO CO CO CO CO CO CO CO CO CO CO CO CO C	JOB NAME	Lot 45 South Creek	ADDRESS	Lot 45 South Creek	responsible for temporary and permanent bracing of the roof and floor system and for the overall structure. The design of the truss support structure including headers, beams, walls, and columns is the responsibility of the building designer. For general guidance regarding bracing, consult BCSI-B1 and BCSI-B2 provided with the truss delivery package	сотесн						
END REA (UP ' REQ D ST (2) PLY H		END F (4) PI	END REAC (UP T (4) PLY H	END REAC (UP T (UP T (4) PLY H	END REAC (UP T (UP T (4) PLY H	END REAC (UP T (UP T) (4) PLY H	END REAC (UP T (4) PLY H	END REAC (UP T (UP T (4) PLY H	END REAC (UP T (4) PLY H	PLAN	Red Camellia GL	MODEL	Roof	or online @ sbcindustry.com Bearing reactions less than or equal to 3000# are deemed to comply with the prescriptive Code requirements. The contractor shall refer to the attached Tables
1700 1 3400 2 5100 3	2550 1 5100 2 7650 3	3400 1 6800 2 10200 3	SEAL DATE	10/17/20	DATE REV.	11/17/20	lerived from the prescriptive Code requirements) to determine the minimum undation size and number of wood studs required to support reactions greater an 3000# but not greater than 15000#. A registered design professional shall a retained to design the support system for any reaction that exceeds those	TRUSSES & BEAMS Reilly Road Industrial Park						
8500 5 10200 6	10200 6 15300 6 11900 7 13600 8		5 17000 5	5 17000 5	QUOTE #		DRAWN BY	Hampton Horrocks	specified in the attached Tables. A registered design professional shall be retained to design the support system for all reactions that exceed 15000#.	Fayetteville, N.C. 28309 Phone: (910) 864-8787				
13600 7 13600 8 15300 9			JOB #	J1120-5305	SALESMAN	Anthony Williams	signature Hampton Horrocks	Fax: (910) 864-4444						

