

DRAWN BY:
TOMMY BASS
 3003 WIGGINS ROAD
 SPRING HOPE, N.C. 27882
 DRAWN FOR: BEASLEY (2056H)

Approved with notes


NOTICE TO CONTRACTOR
 All construction must comply with current NC Building Codes and is subject to field inspection and verification.

APPROVED
 Limited building only review
 Permit holder responsible for full compliance with the code

03/15/2021





CONTRACTOR / SUBCONTRACTOR:
 Check plans carefully for dimensions, material size accuracy, and any code violations. All LVL's and engineered joists should be checked by product manufacturer's ENGINEER or STRUCTURAL ENGINEER to confirm sizes. If any corrections need to be made, contact the owner so that corrections can be made before construction begins.

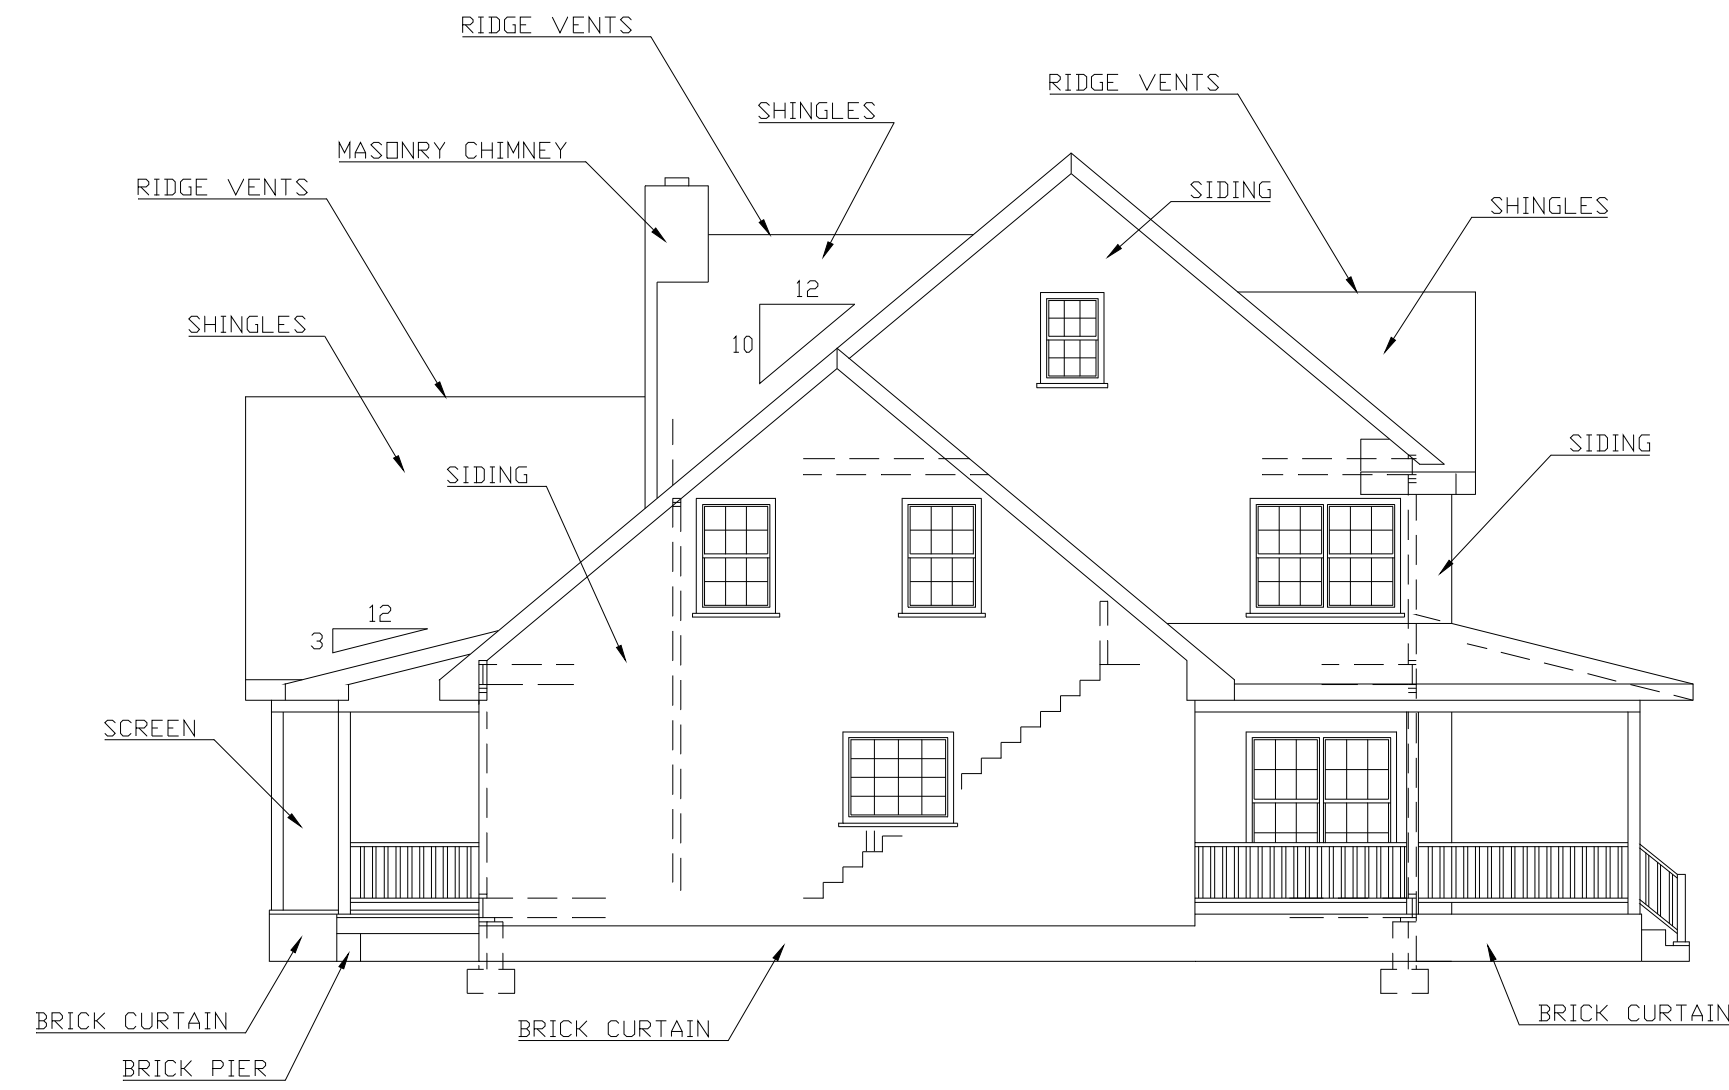


LEFT ELEVATION

SCALE 1/8" = 1'-0"

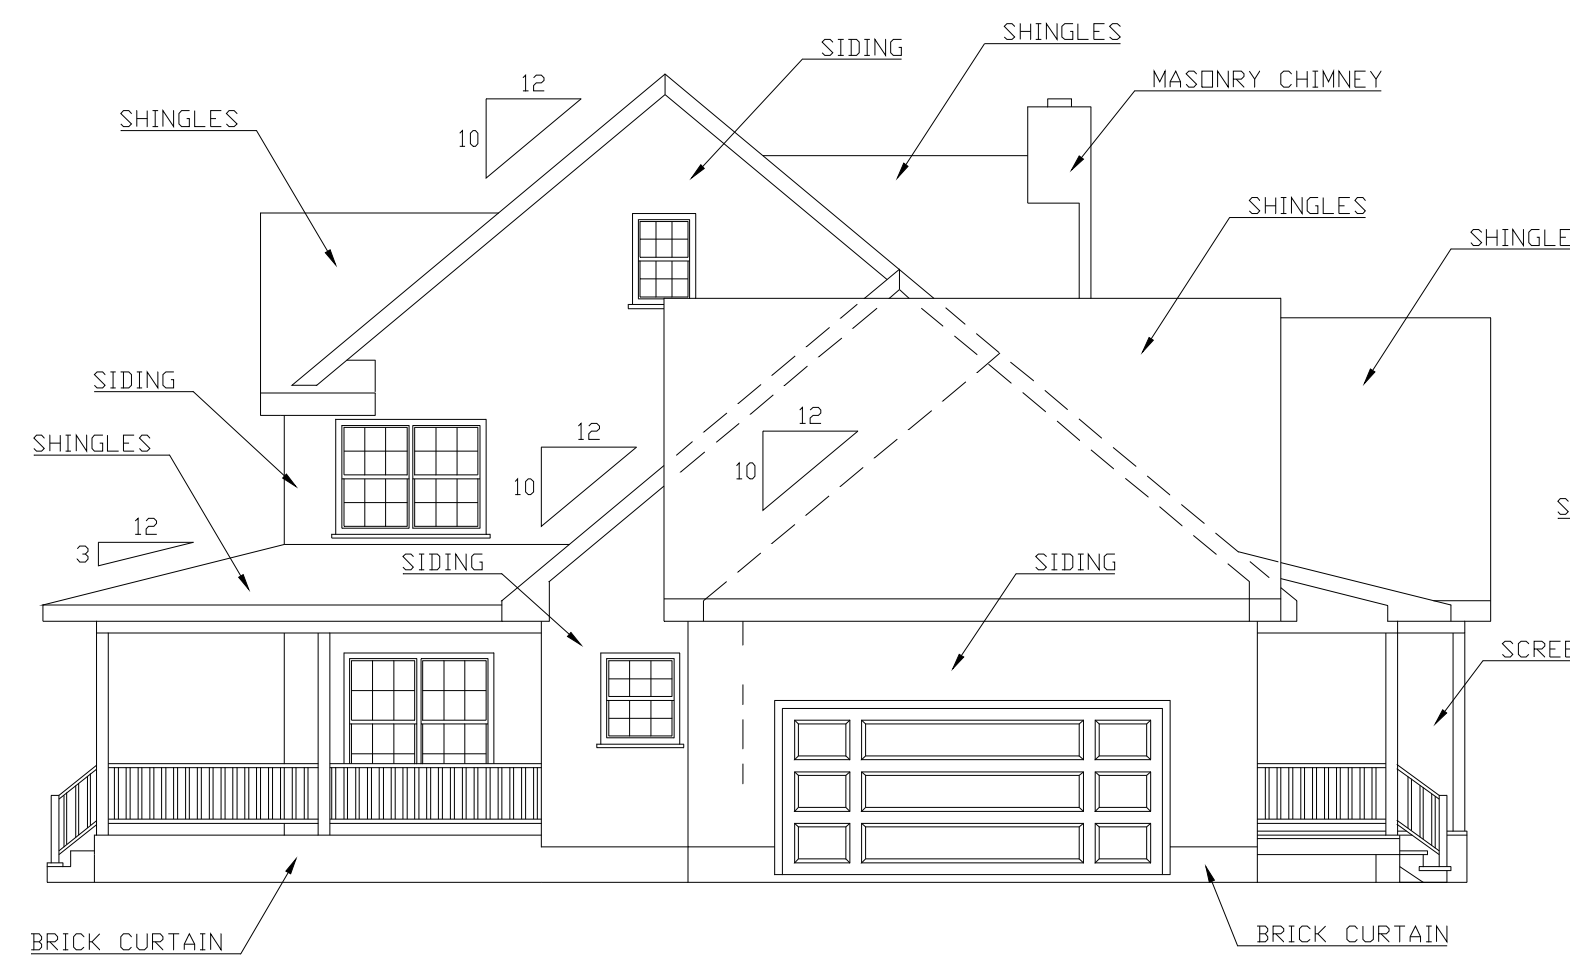

RIGHT ELEVATION

SCALE 1/8" = 1'-0"

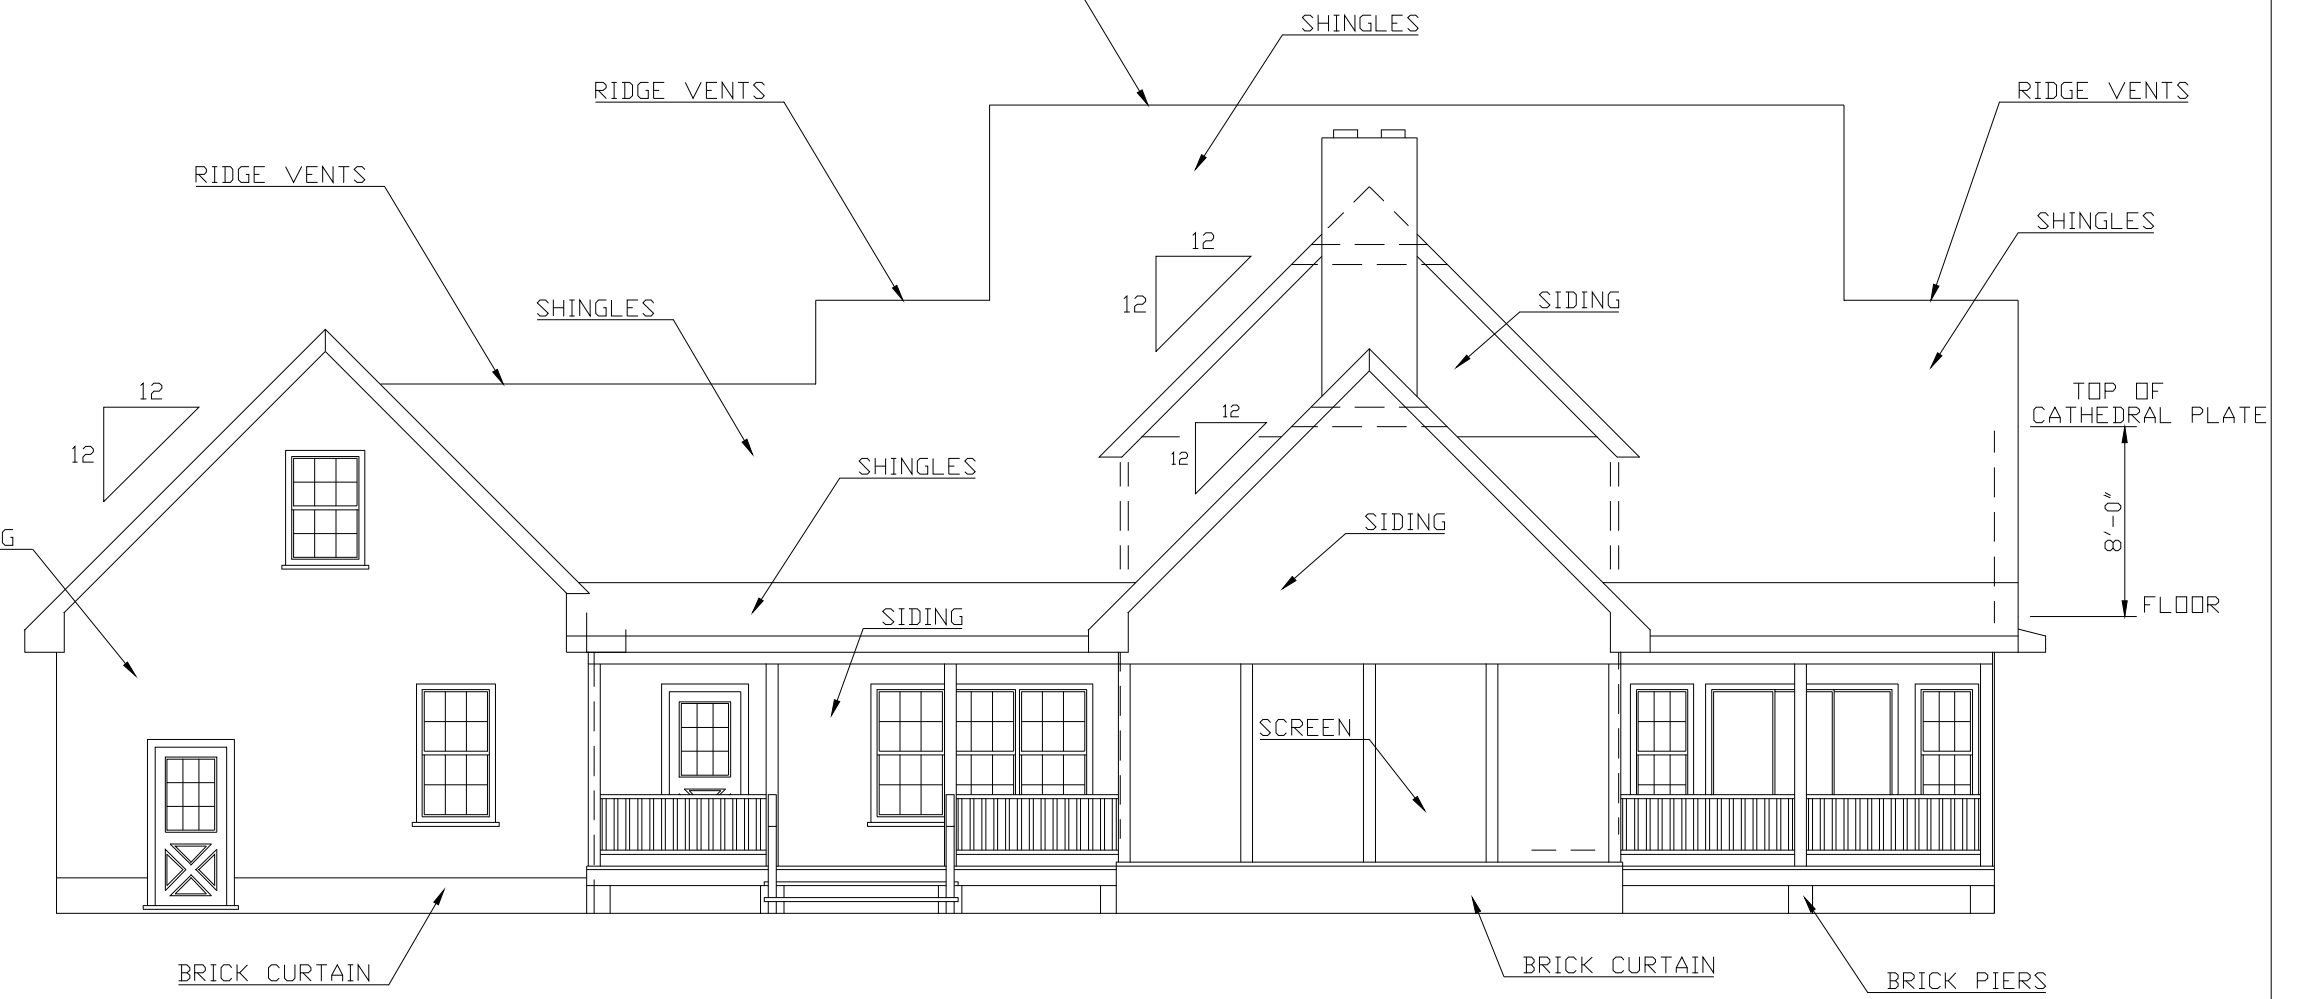


REAR ELEVATION

SCALE 1/8" = 1'-0"




FRONT ELEVATION

SCALE 1/4" = 1'-0"

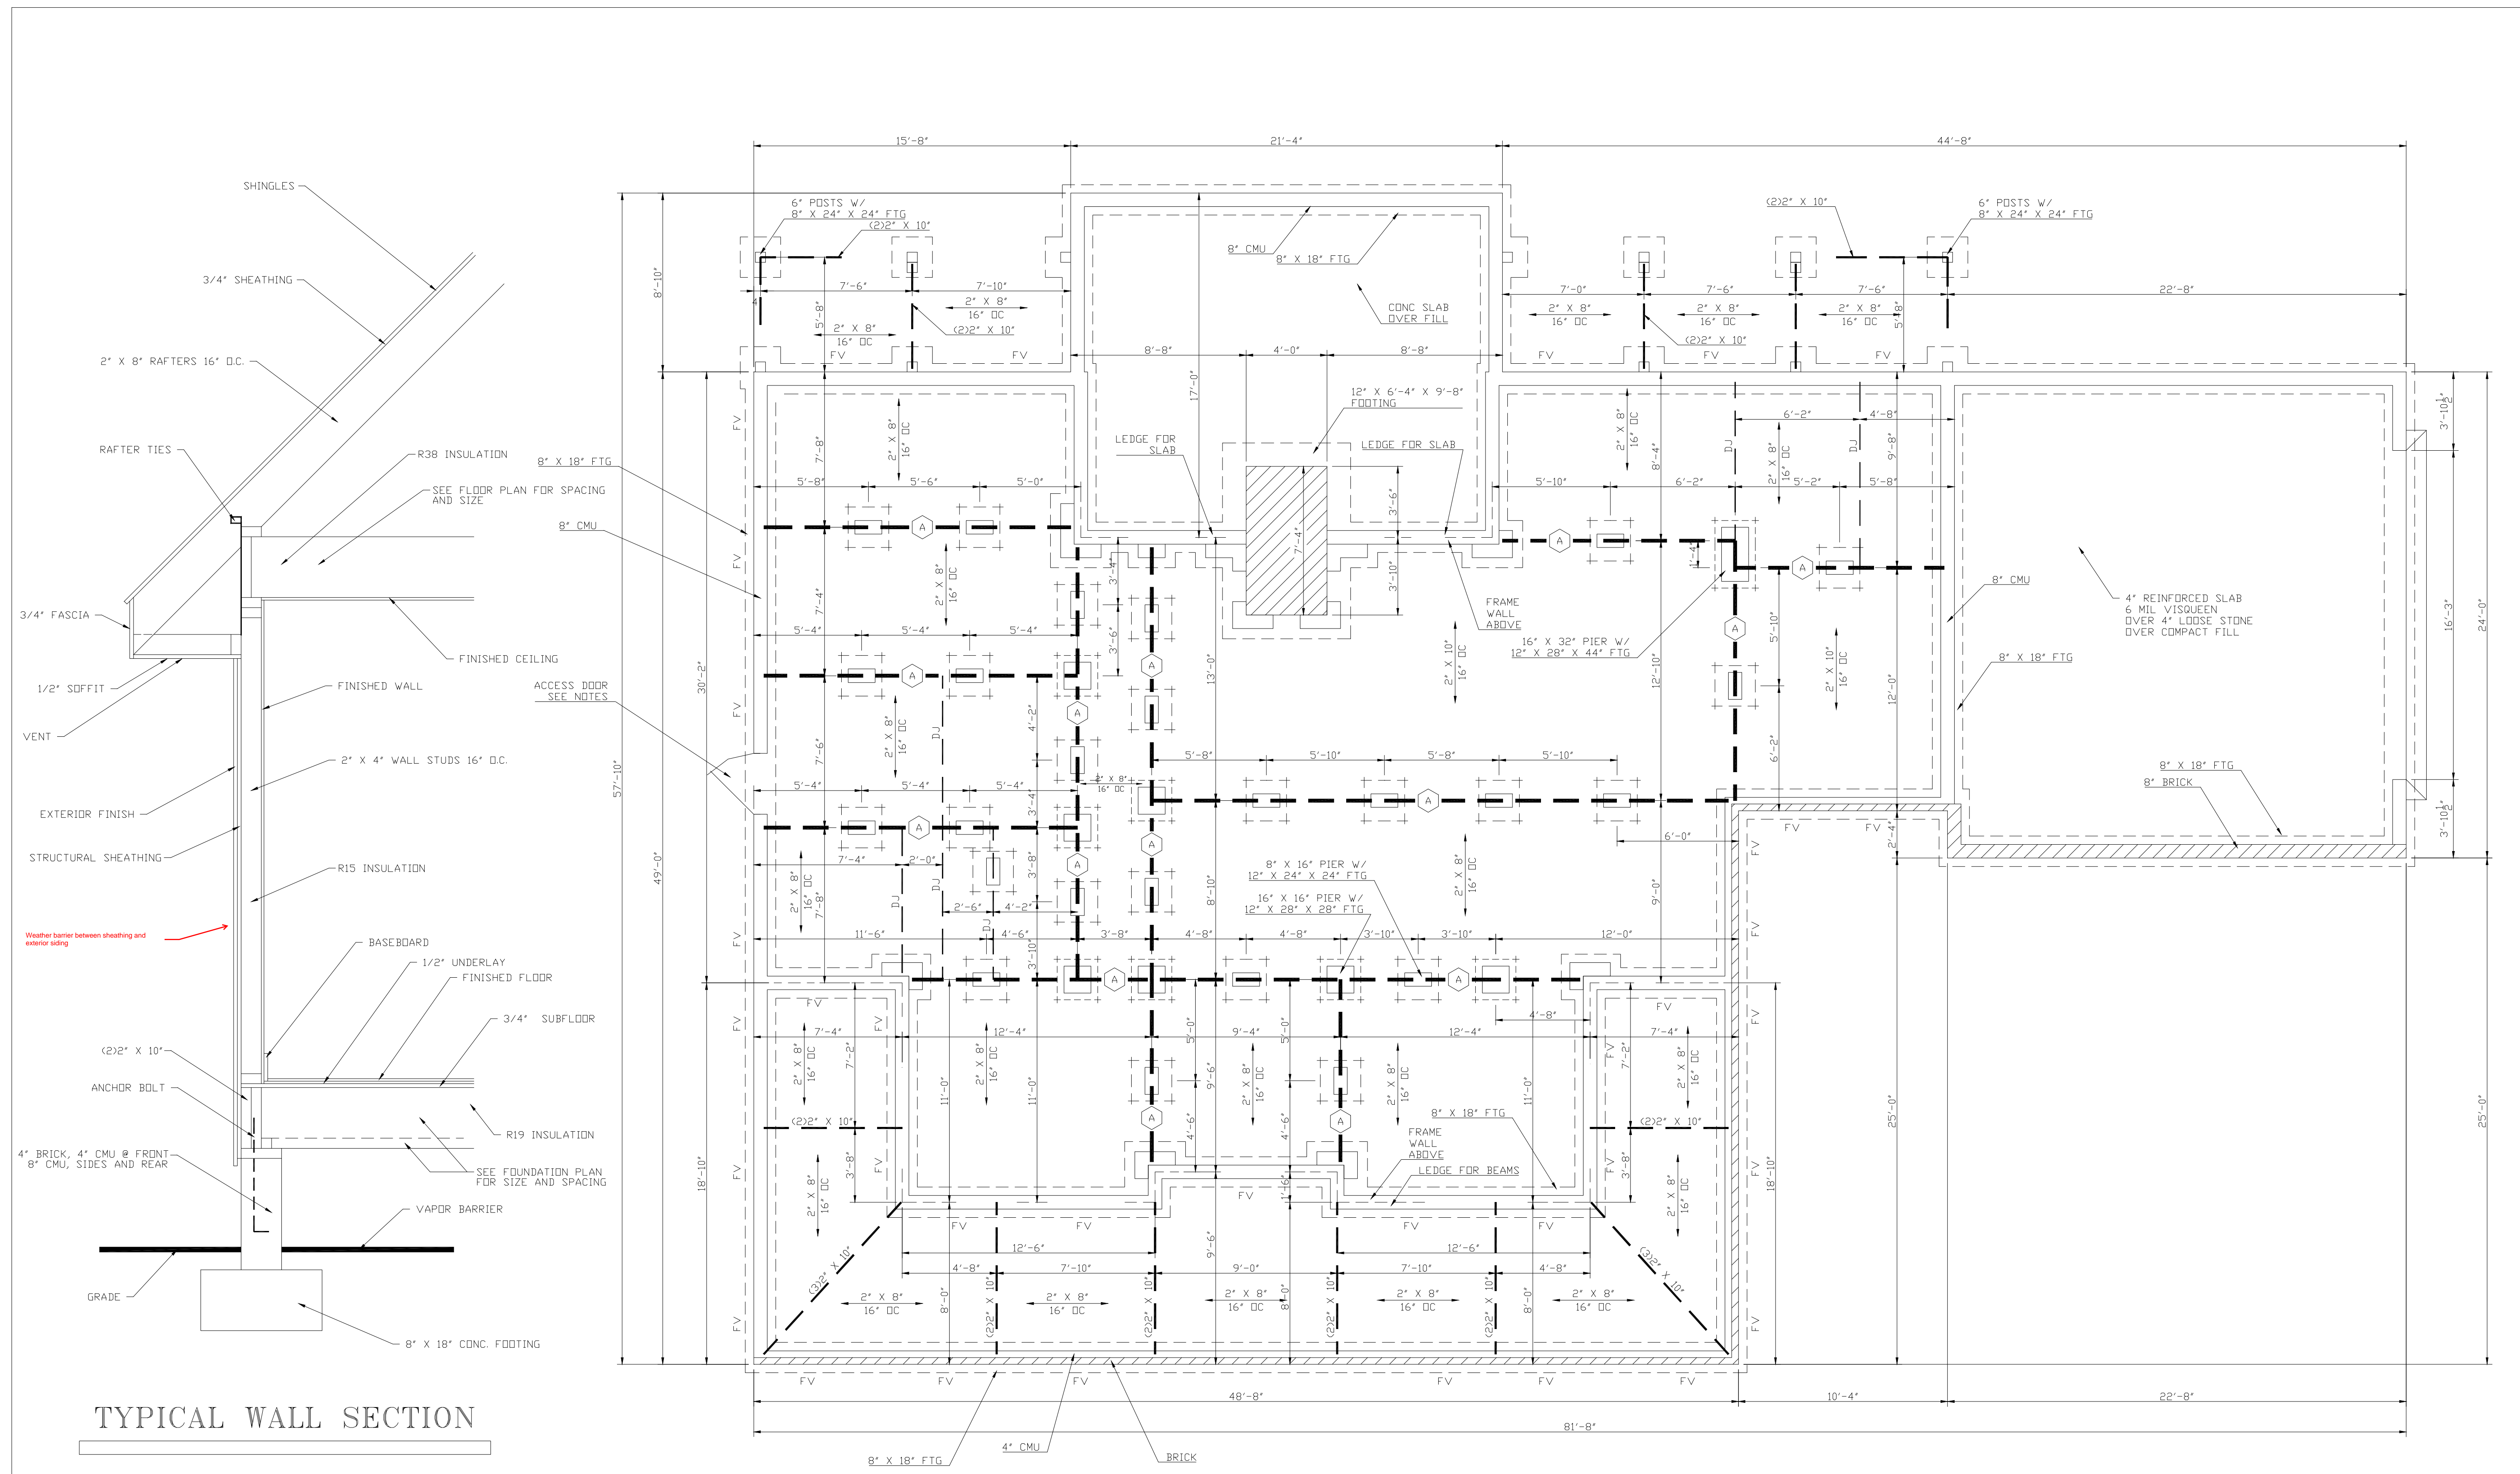

- FOUNDATION NOTES:**
1. ACCESS DOOR TO BE SEALED, W/ LATCH MECHANISM
 2. PLACE HWH DN 4" SLAB NEAR ACCESS
 3. ACCESS SIZE 24" X 36" MIN.
 4. PLACE FOUNDATION VENTS AS REQUIRED (36" MIN. FROM CORNERS)
 5. PLACE ANCHOR BOLTS @ 72" O.C.


- FOUNDATION VENT DATA:**
1. 1888 SQ FT CRAWL SPACE / 150 = 13 SQ FT VENTS MIN.
 2. (A) = (3)2" X 10" GIRDER
 3. ACCESS SIZE
 4. DJ = DOUBLE JOISTS
 5. FV = FOUNDATION VENT

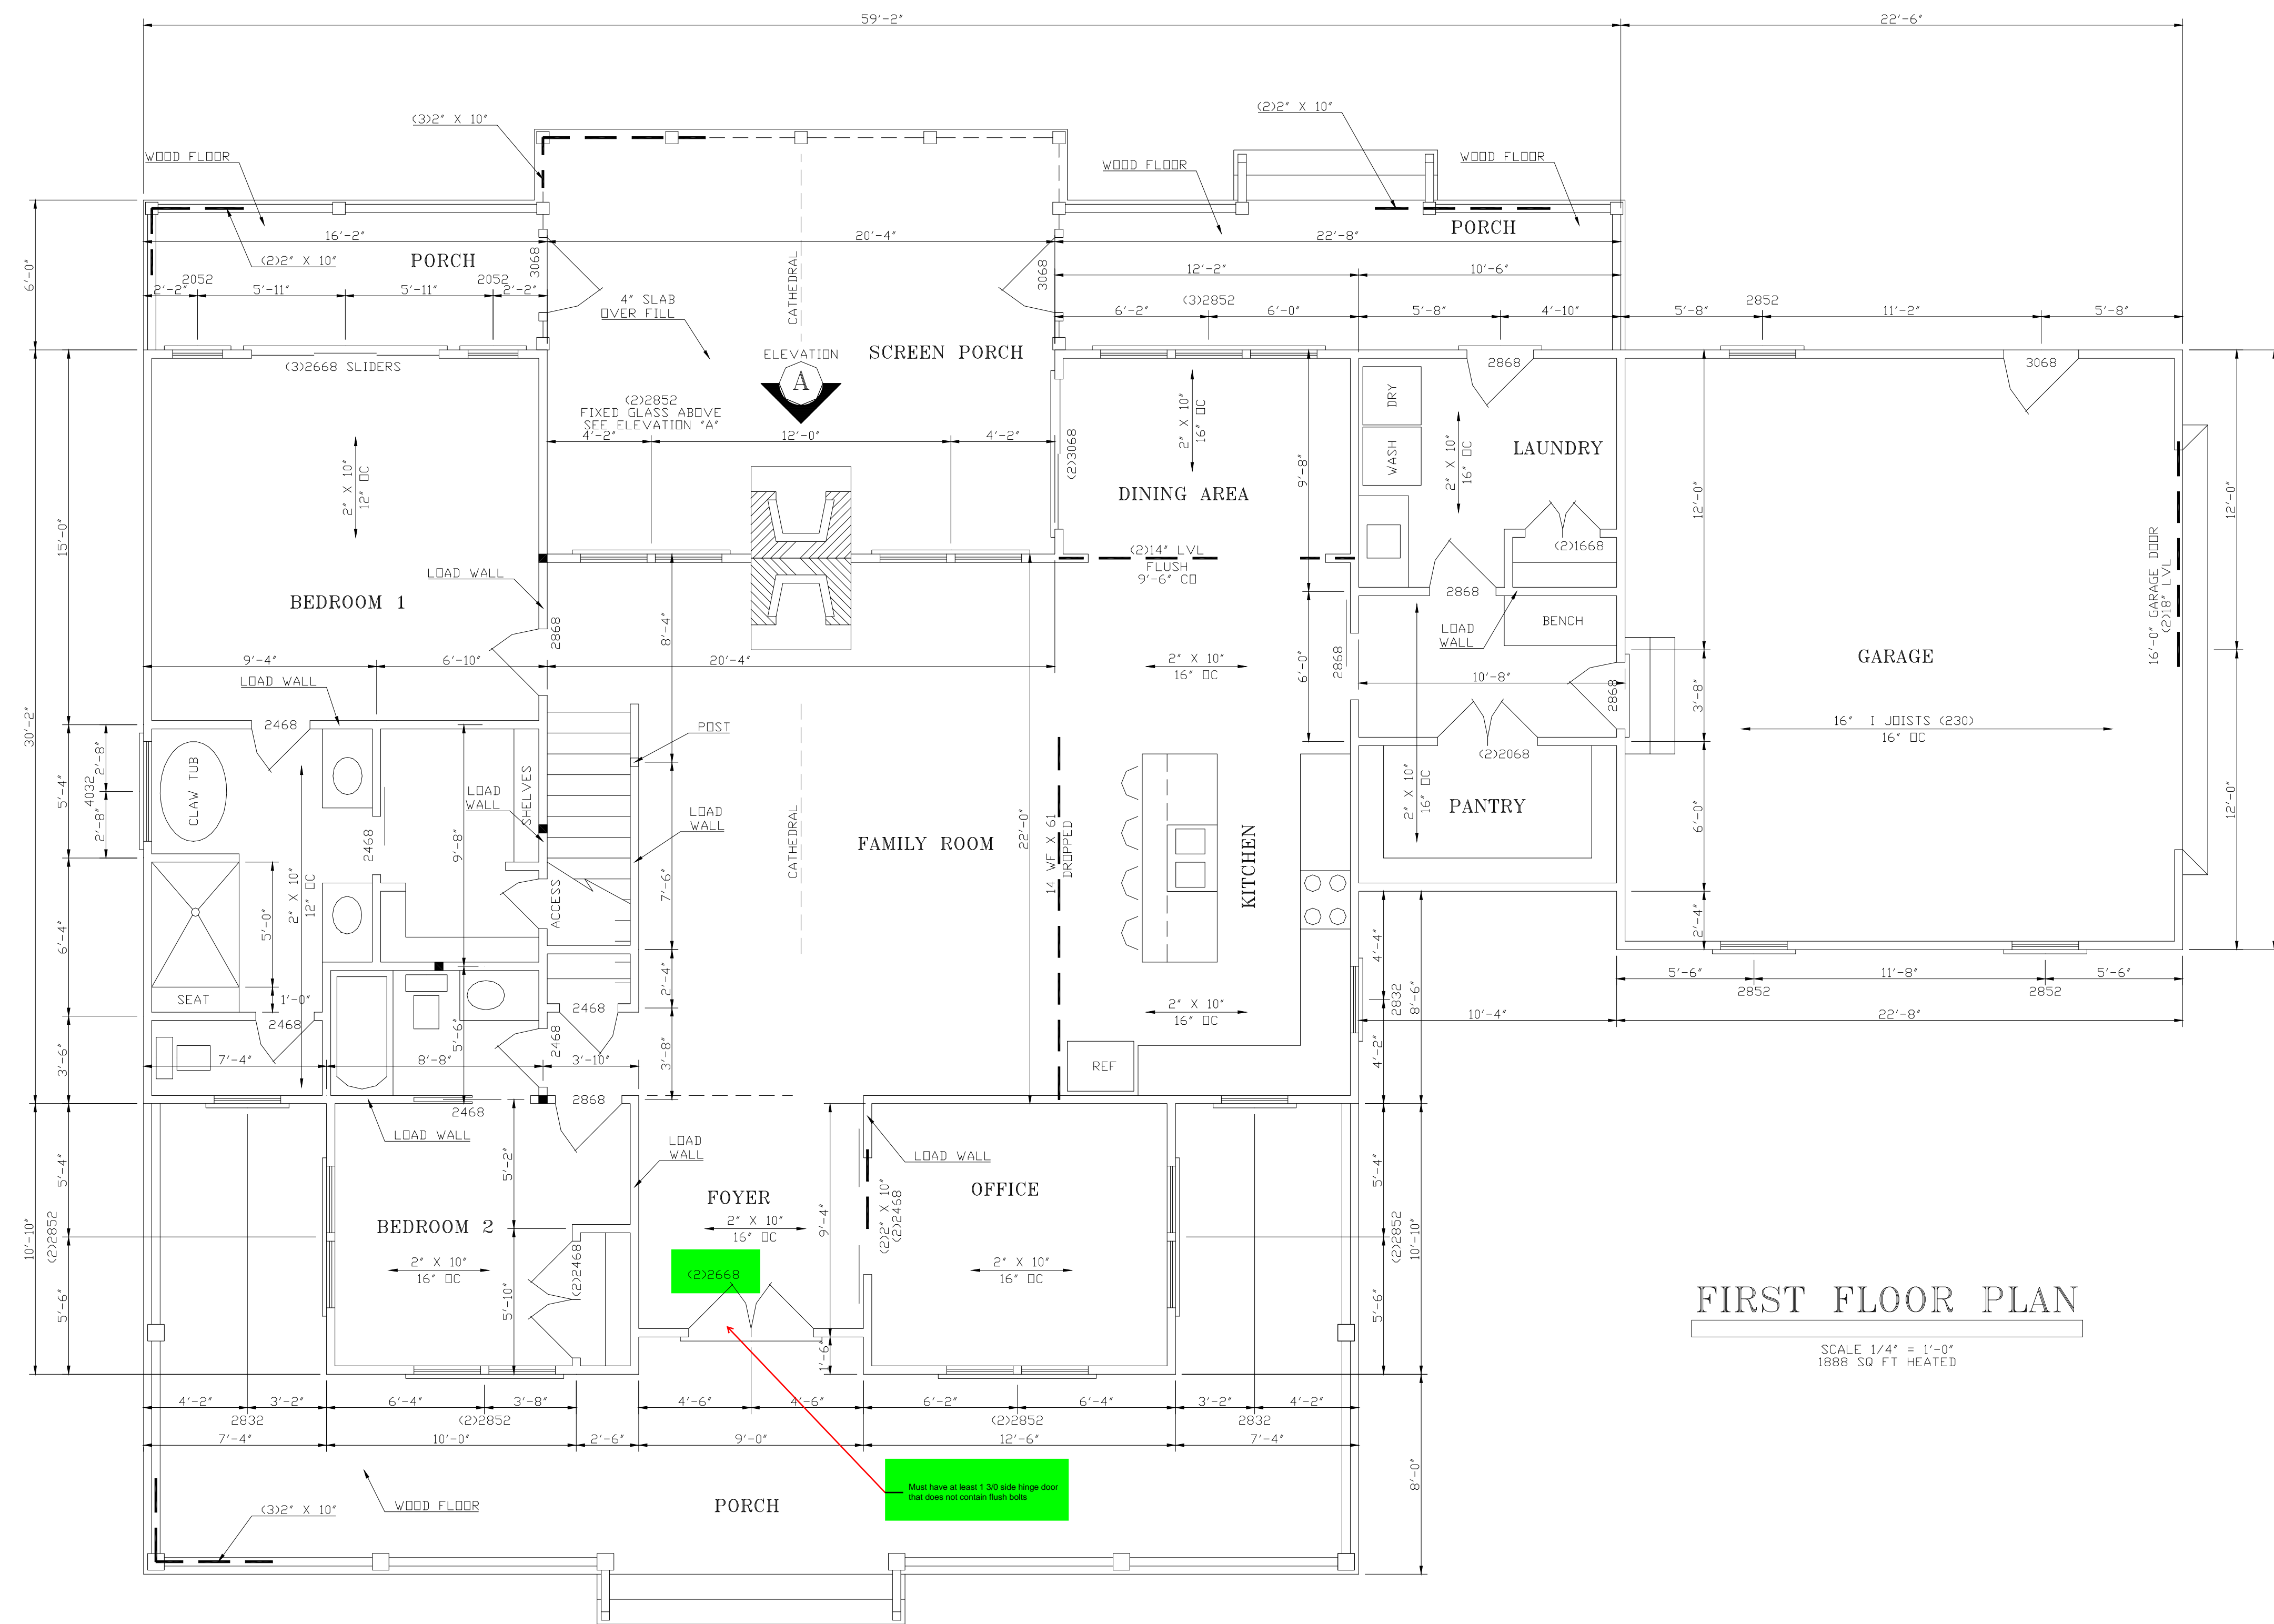

FIRST FLOOR PLAN


SCALE 1/4" = 1'-0"
1888 SQ FT HEATED

Mail track at base of 230 side floor that does not contain flush bolts

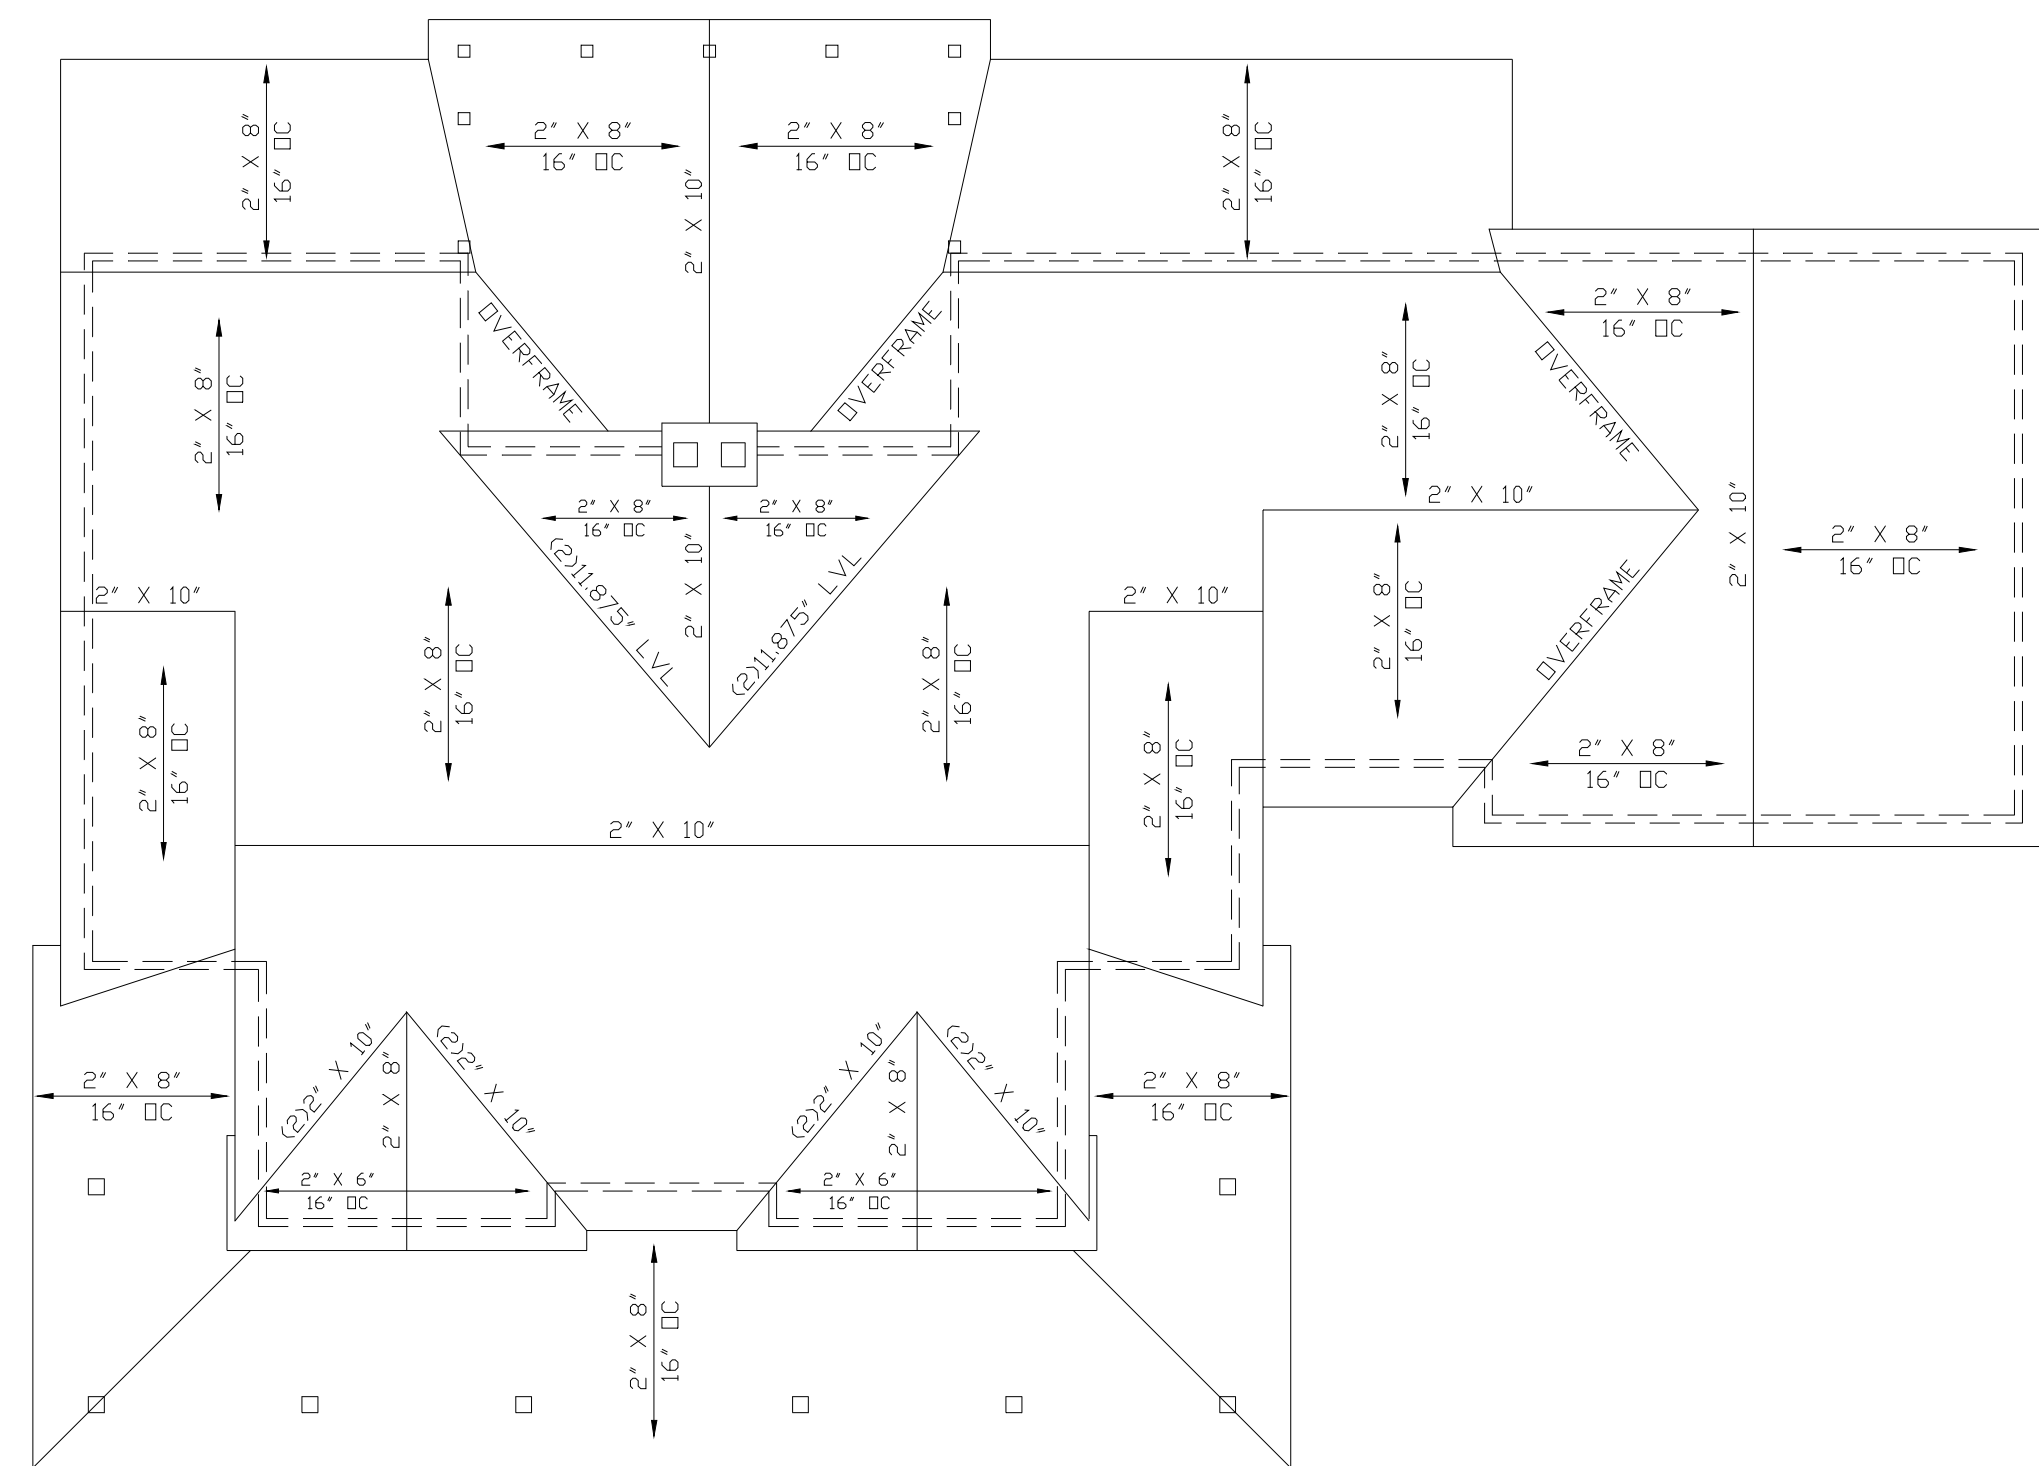


ROOF PLAN

SCALE 1/8" = 1'-0"

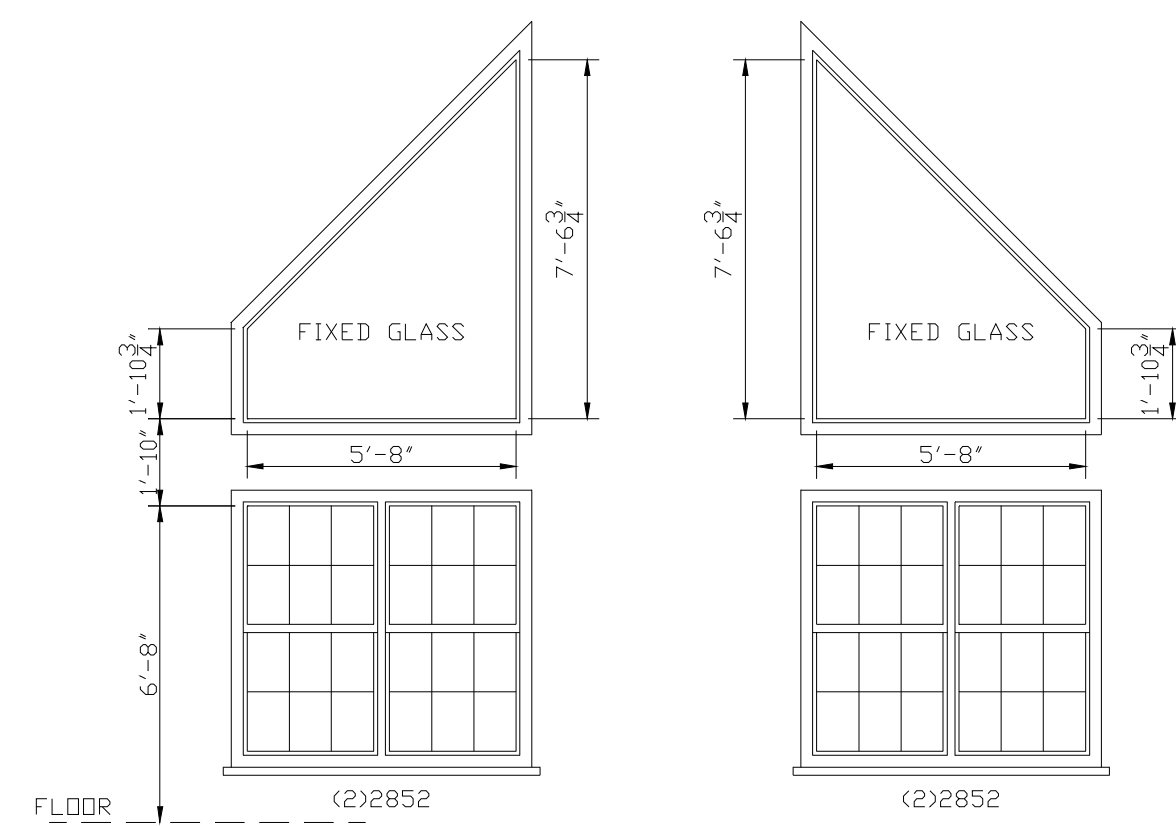


ELEVATION "A"

SCALE 1/4" = 1'-0"

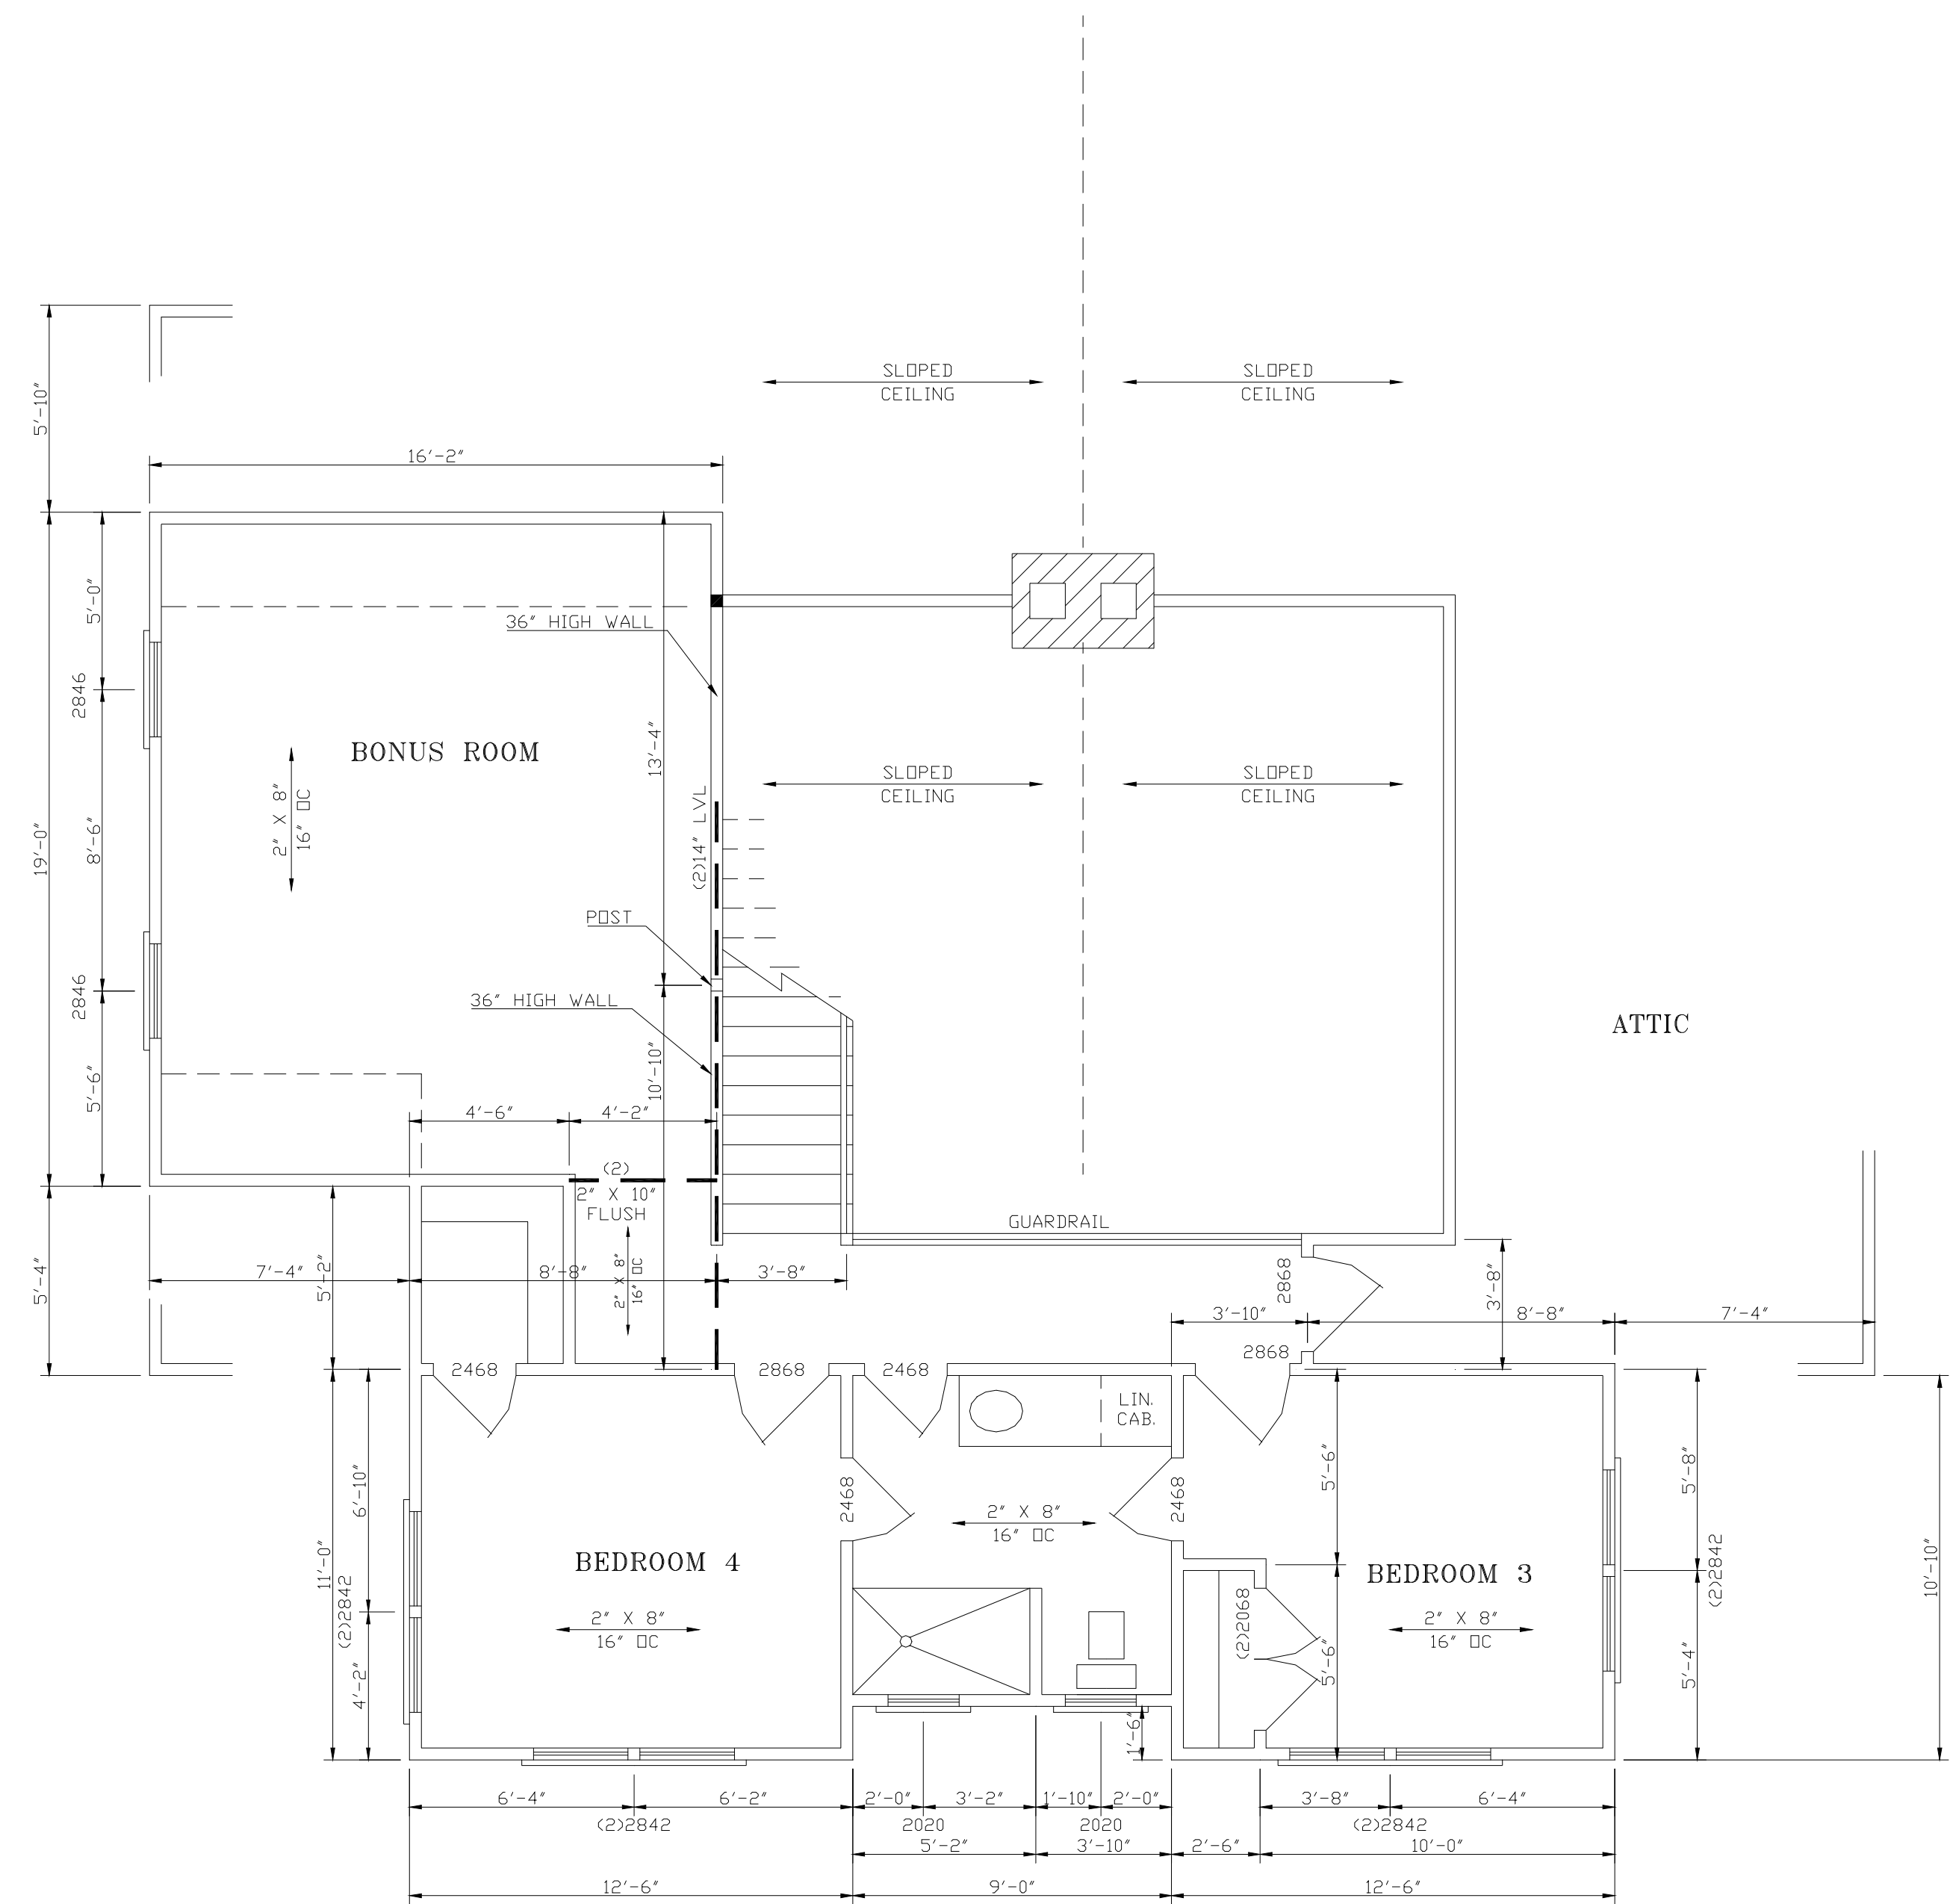


SECOND FLOOR PLAN

SCALE 1/4" = 1'-0"
775 SQ. FT. FINISHED

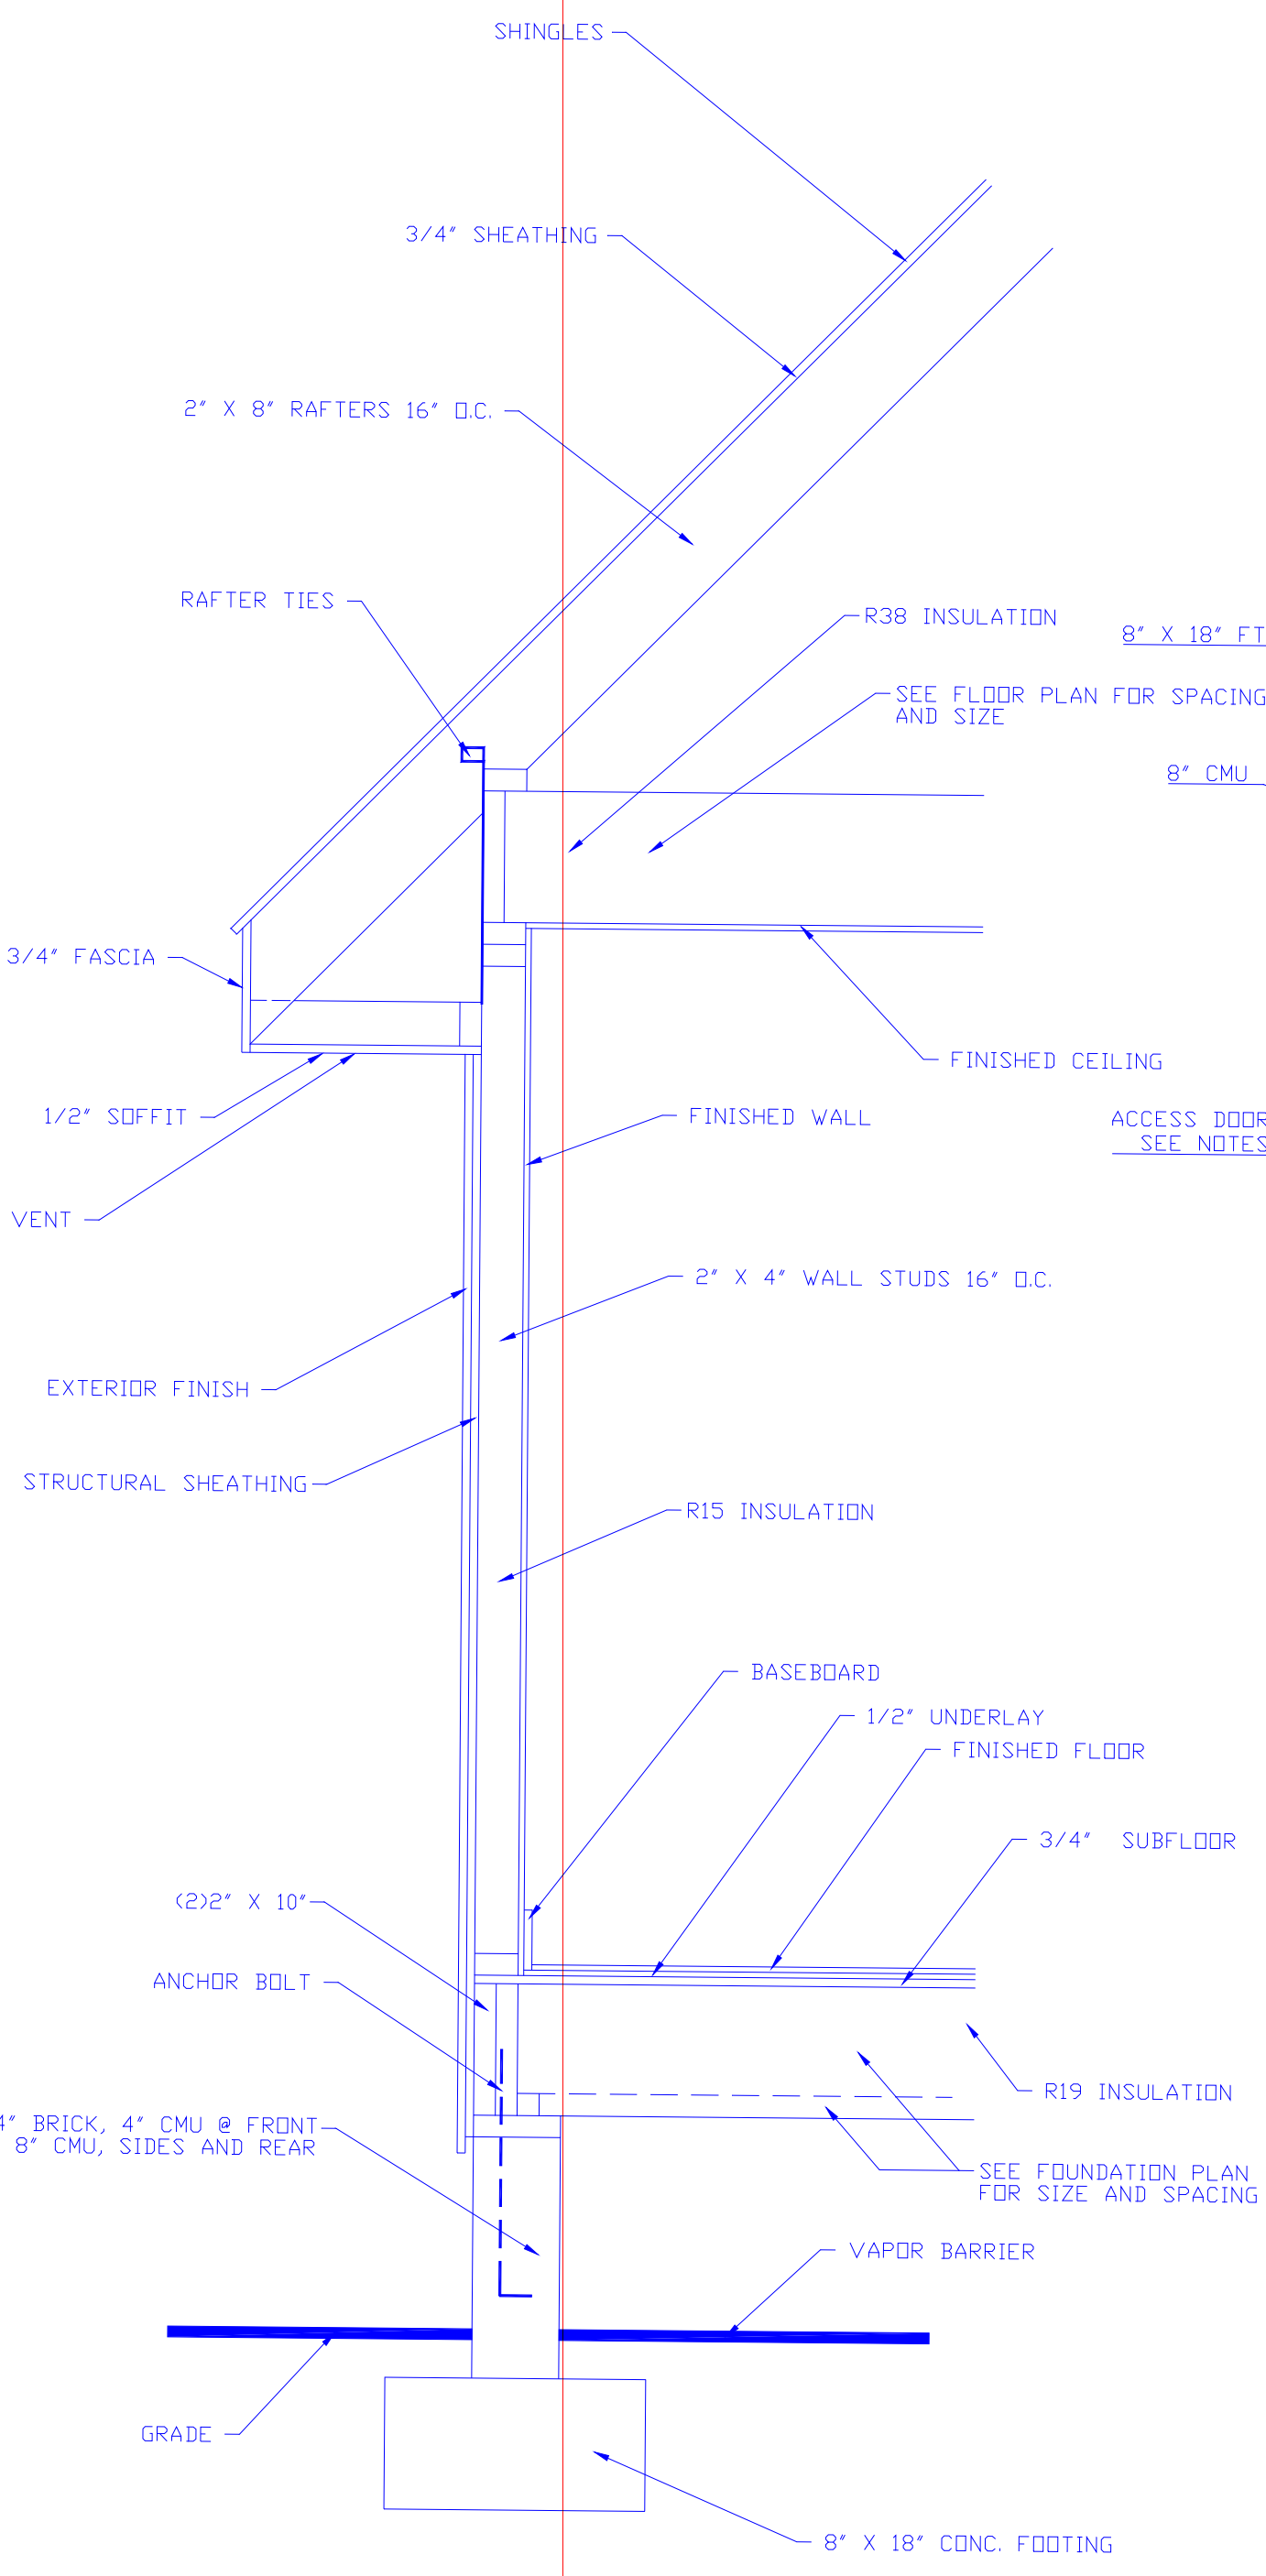

TYPICAL WALL SECTION

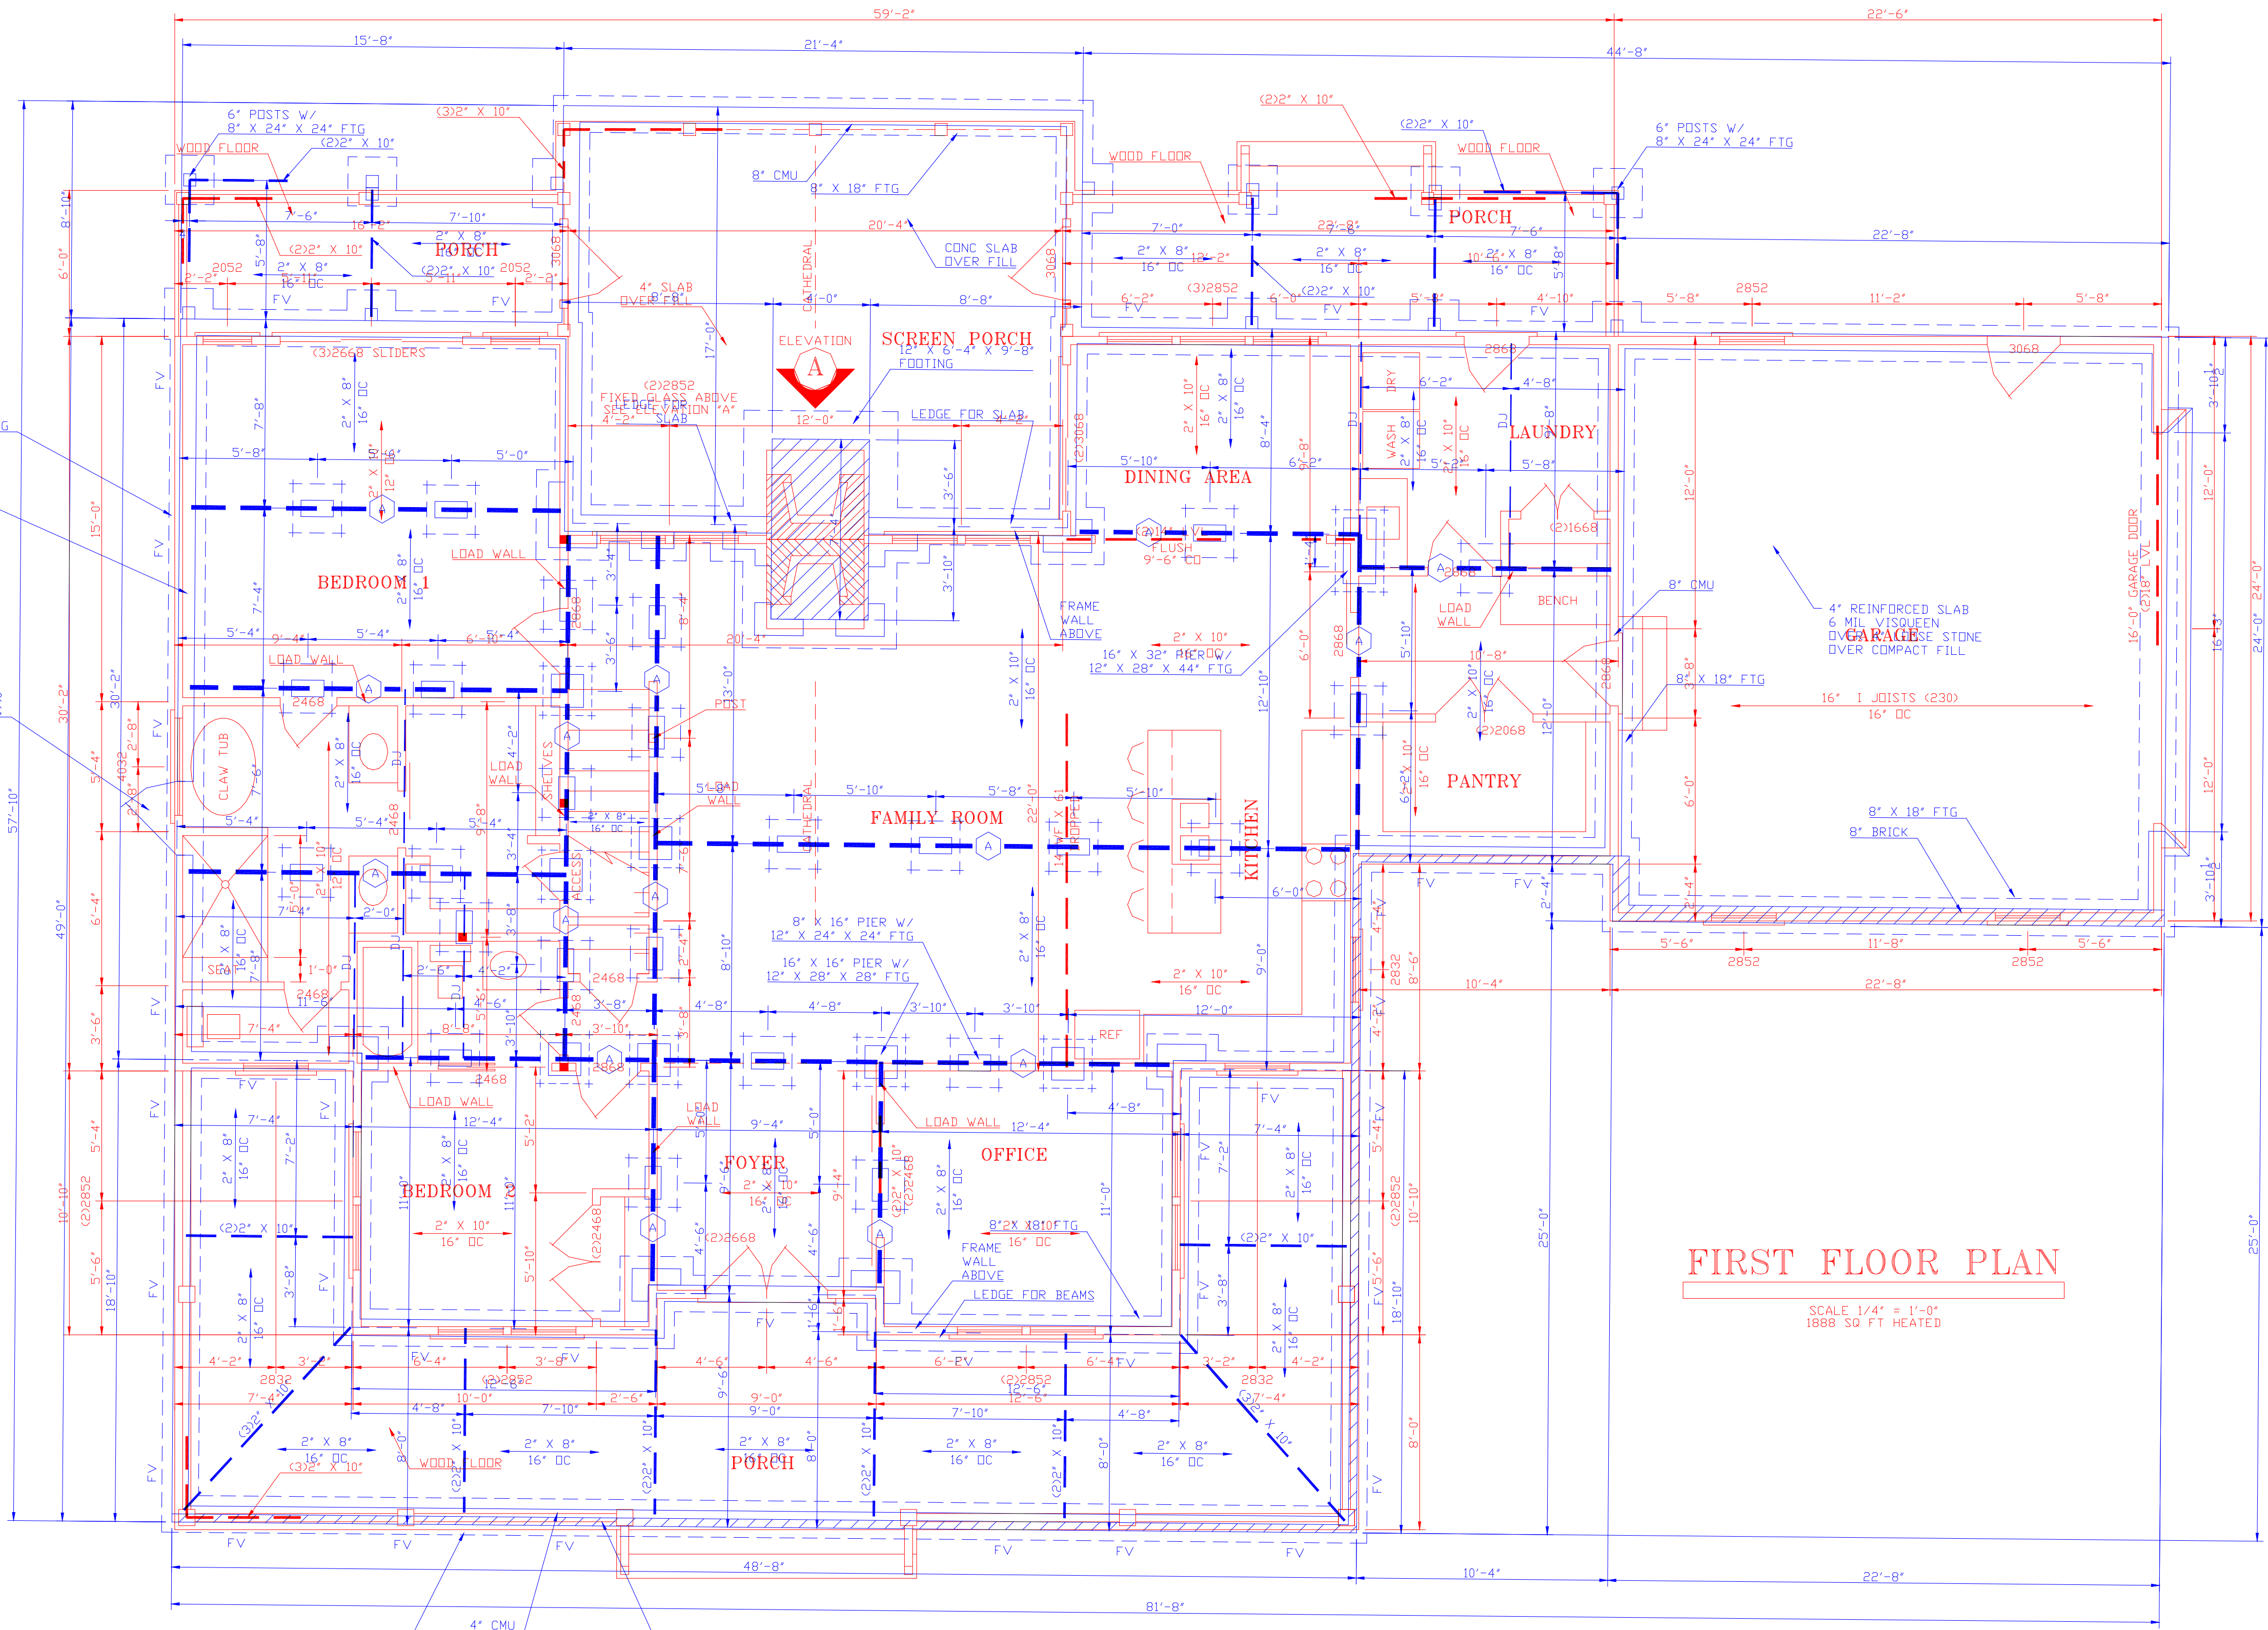

FOUNDATION PLAN

FOUNDATION NOTES:

1. ACCESS DOOR TO BE SEALED, W/ LATCH MECHANISM
2. PLACE HWH ON 4\"/>

FOUNDATION VENT DATA:

1. 1888 SQ FT CRAWL SPACE / 150 = 13 SQ FT VENTS MIN.
2. (A) = (3)2\"/>

FIRST FLOOR PLAN

SCALE 1/4\"/>