
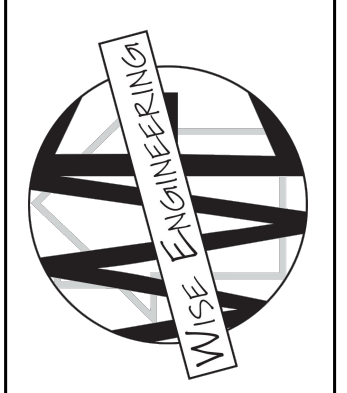


FOUNDATION PLAN

1/4" = 1'-0"


*ALL LUMBER TO BE #2 SYP, UNO

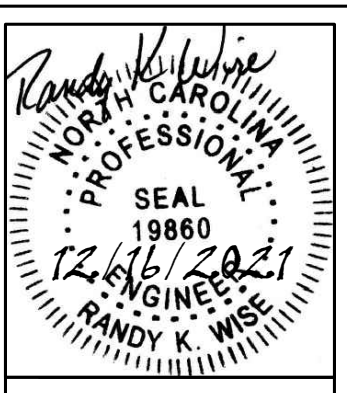

Client: **Jon Taylor**
 Project: **PERSONAL RESIDENCE**

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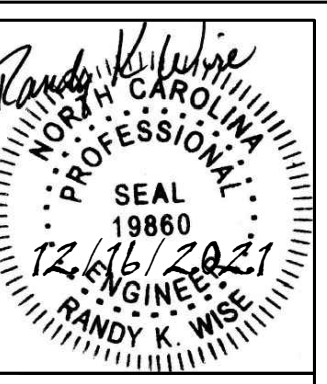
Sheet Number
S1
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BASEMENT PLAN

1/4" = 1'-0" CEILING HGT. = 9'-0"

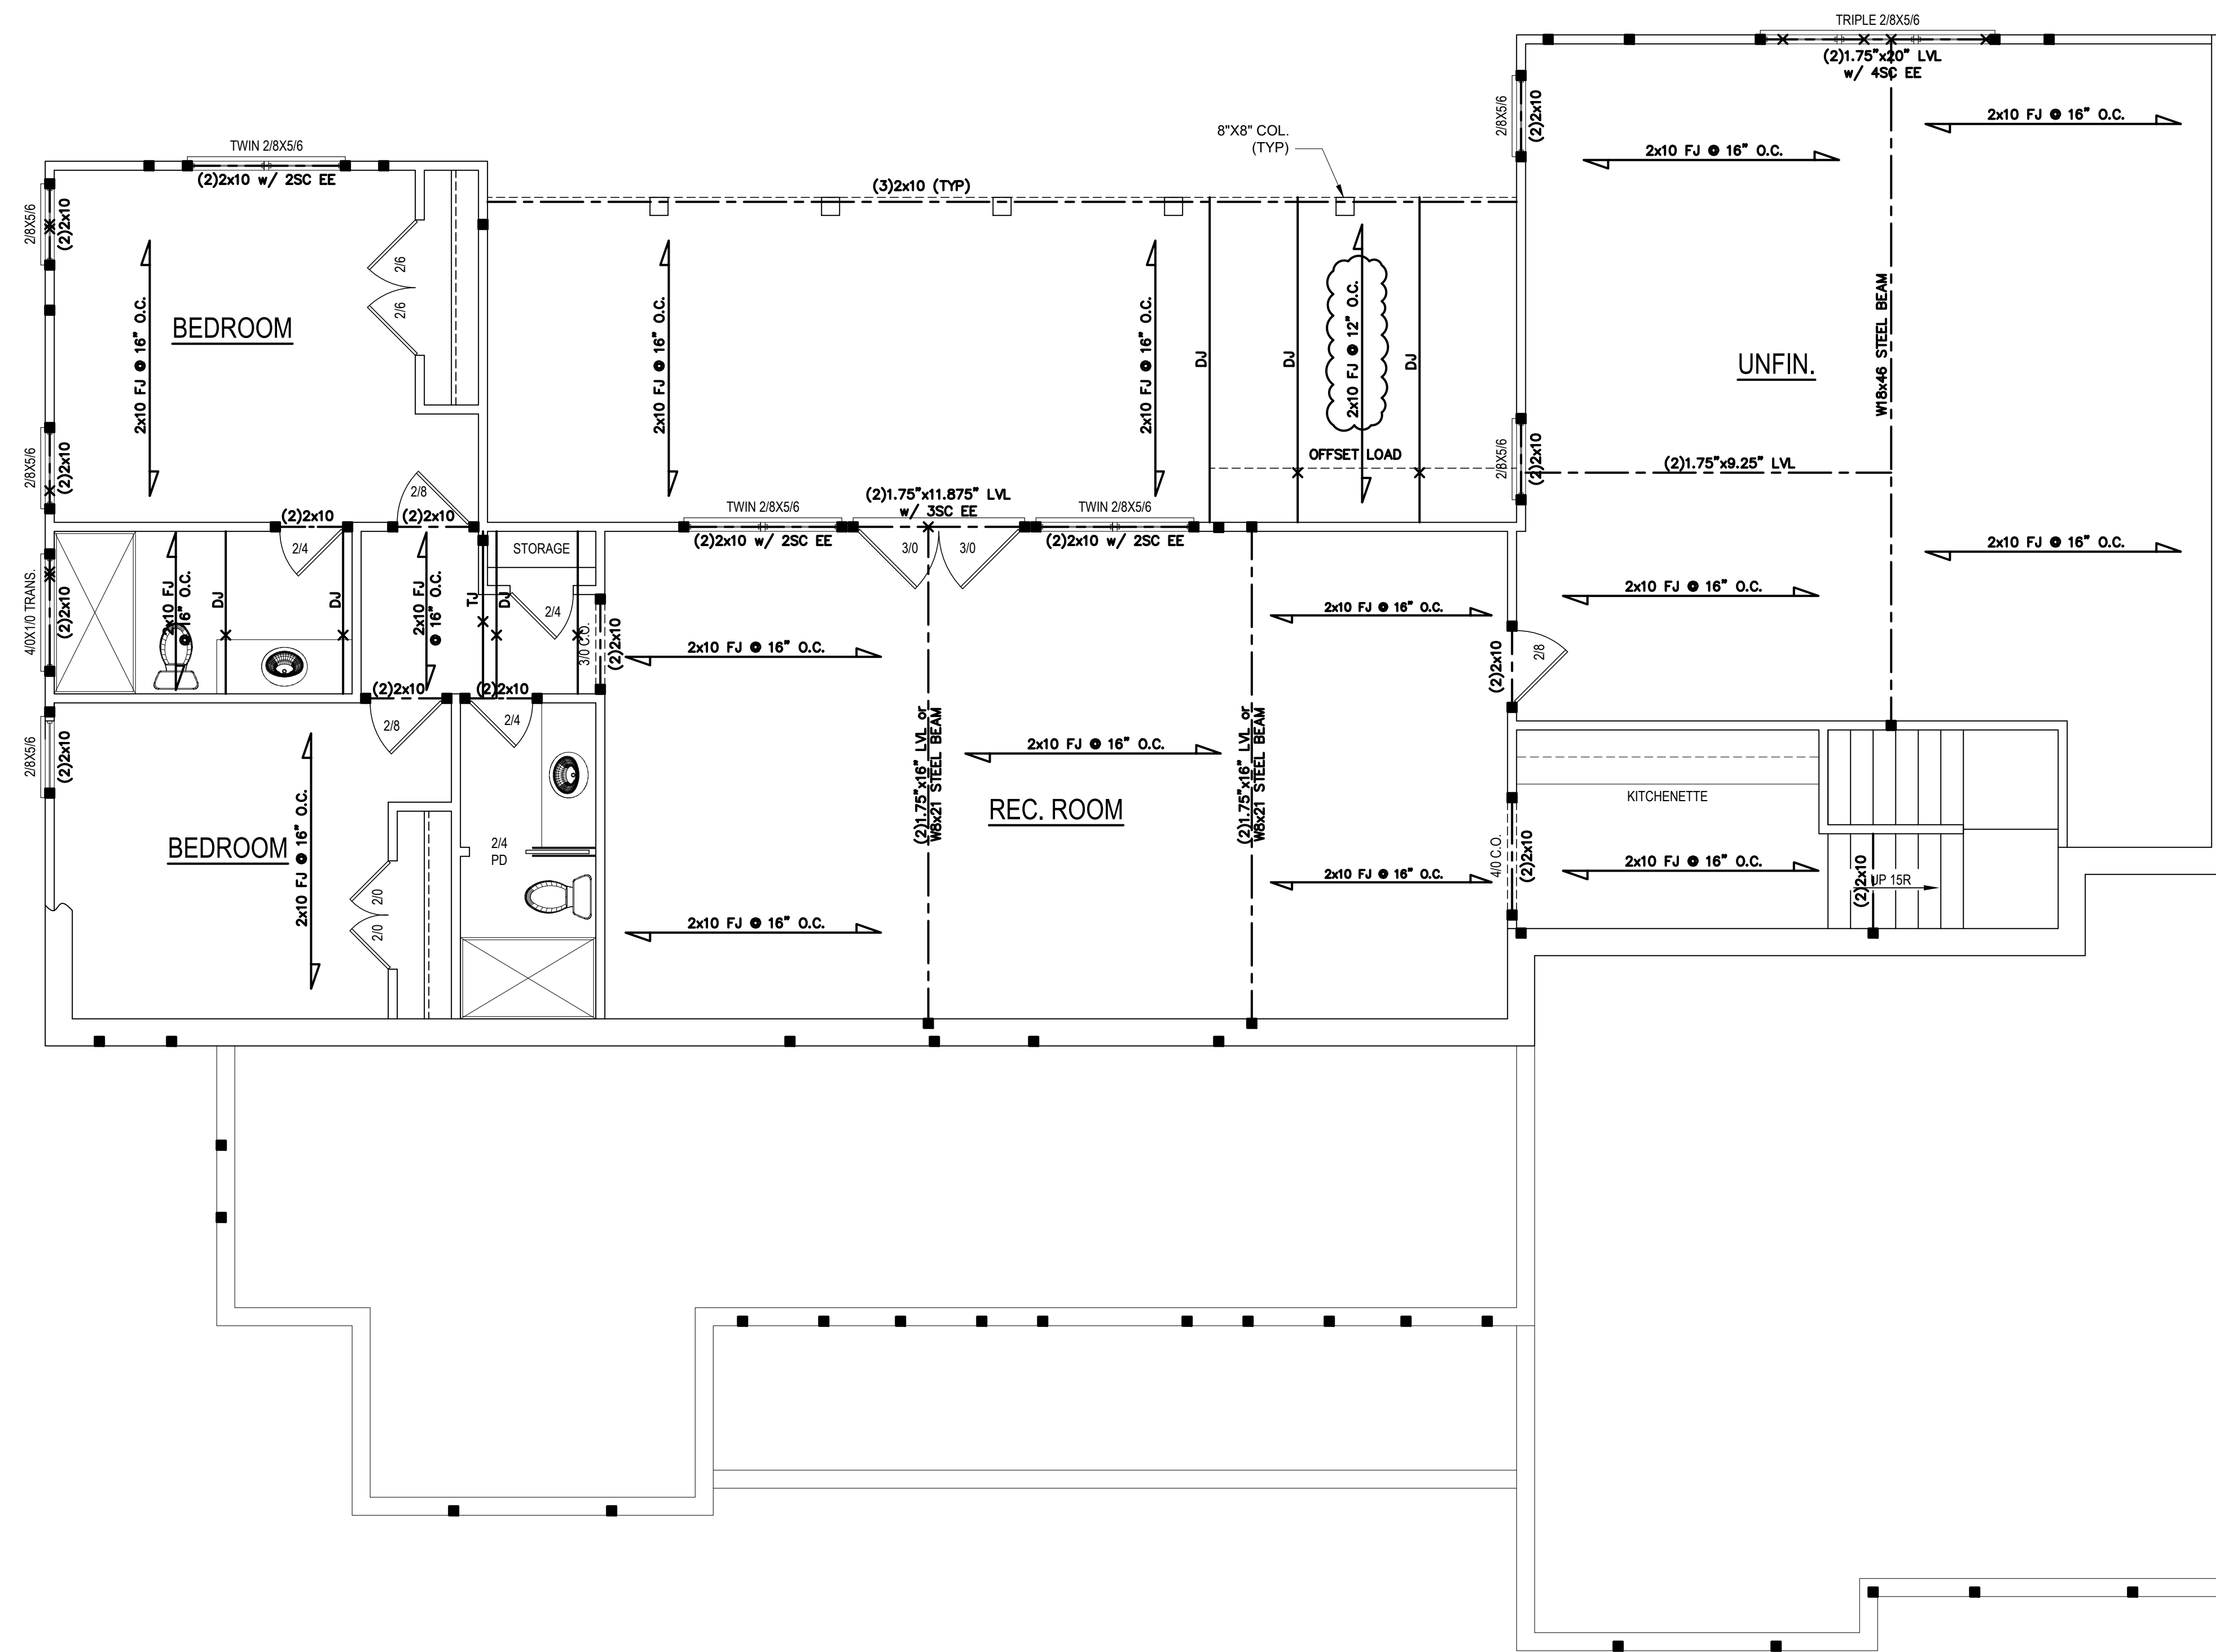*ALL LUMBER TO BE #2 SYP, UNO
 ALL WALLS TO BE 4" THICK
 BASEMENT WALLS TO BE 12" THICK




Client: **Jon Taylor**
 Project: **PERSONAL RESIDENCE**

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Sheet Number

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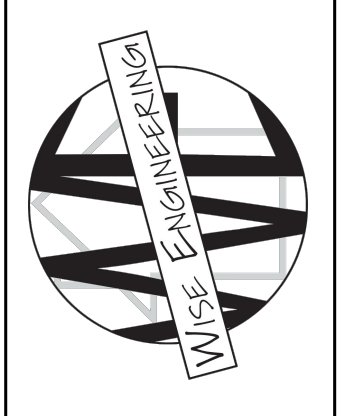
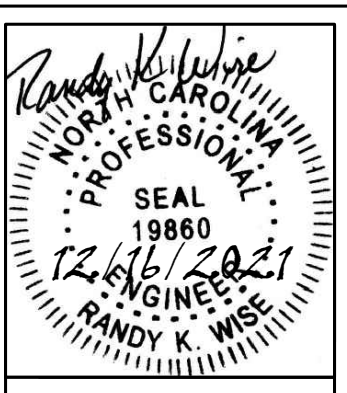


FIRST FLOOR PLAN

1/4" = 1'-0" CEILING HGT. = 10'-0"

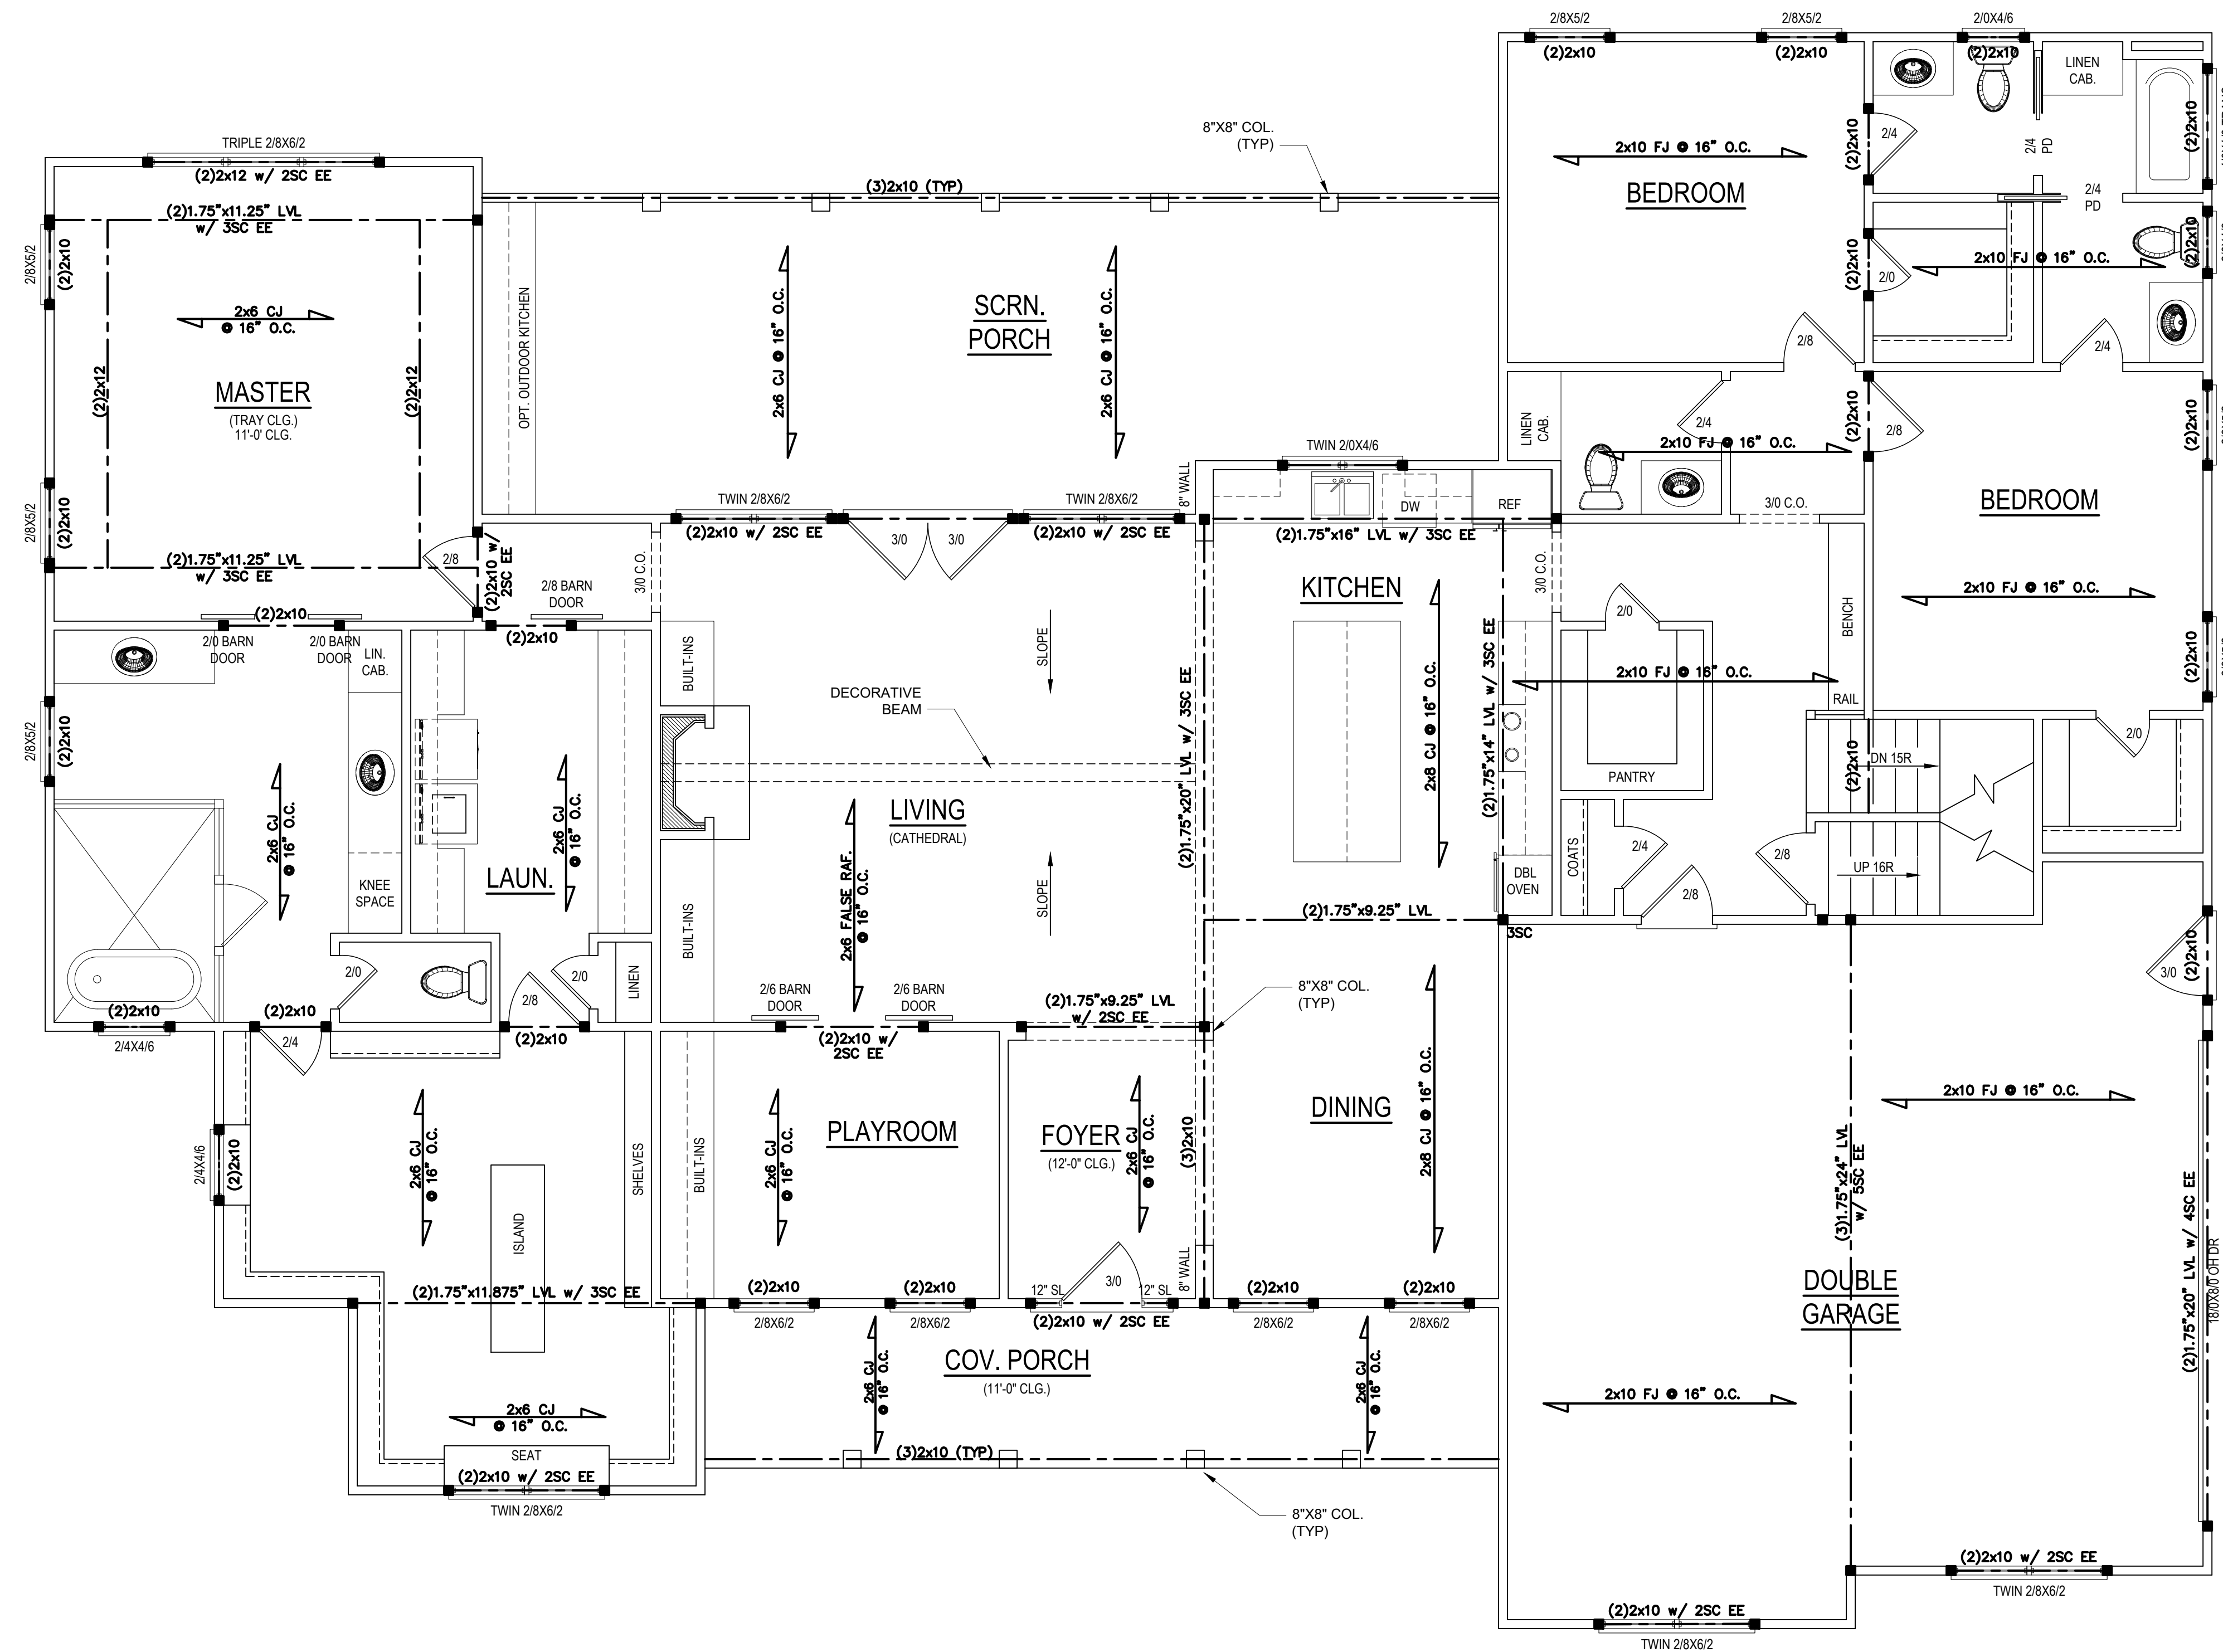
*ALL LUMBER TO BE #2 SYP. UNO
ALL WALLS TO BE 4" THICK

HEATED SF	
Basement	1357
First Floor	2759
TOTAL HEATED	4116
UNHEATED SF	
Garage	686
Front Porch	178
Rear Porch	433
Unfin. Basement	711



Client: **Jon Taylor**
Project: **PERSONAL RESIDENCE**


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Angier, NC 27501

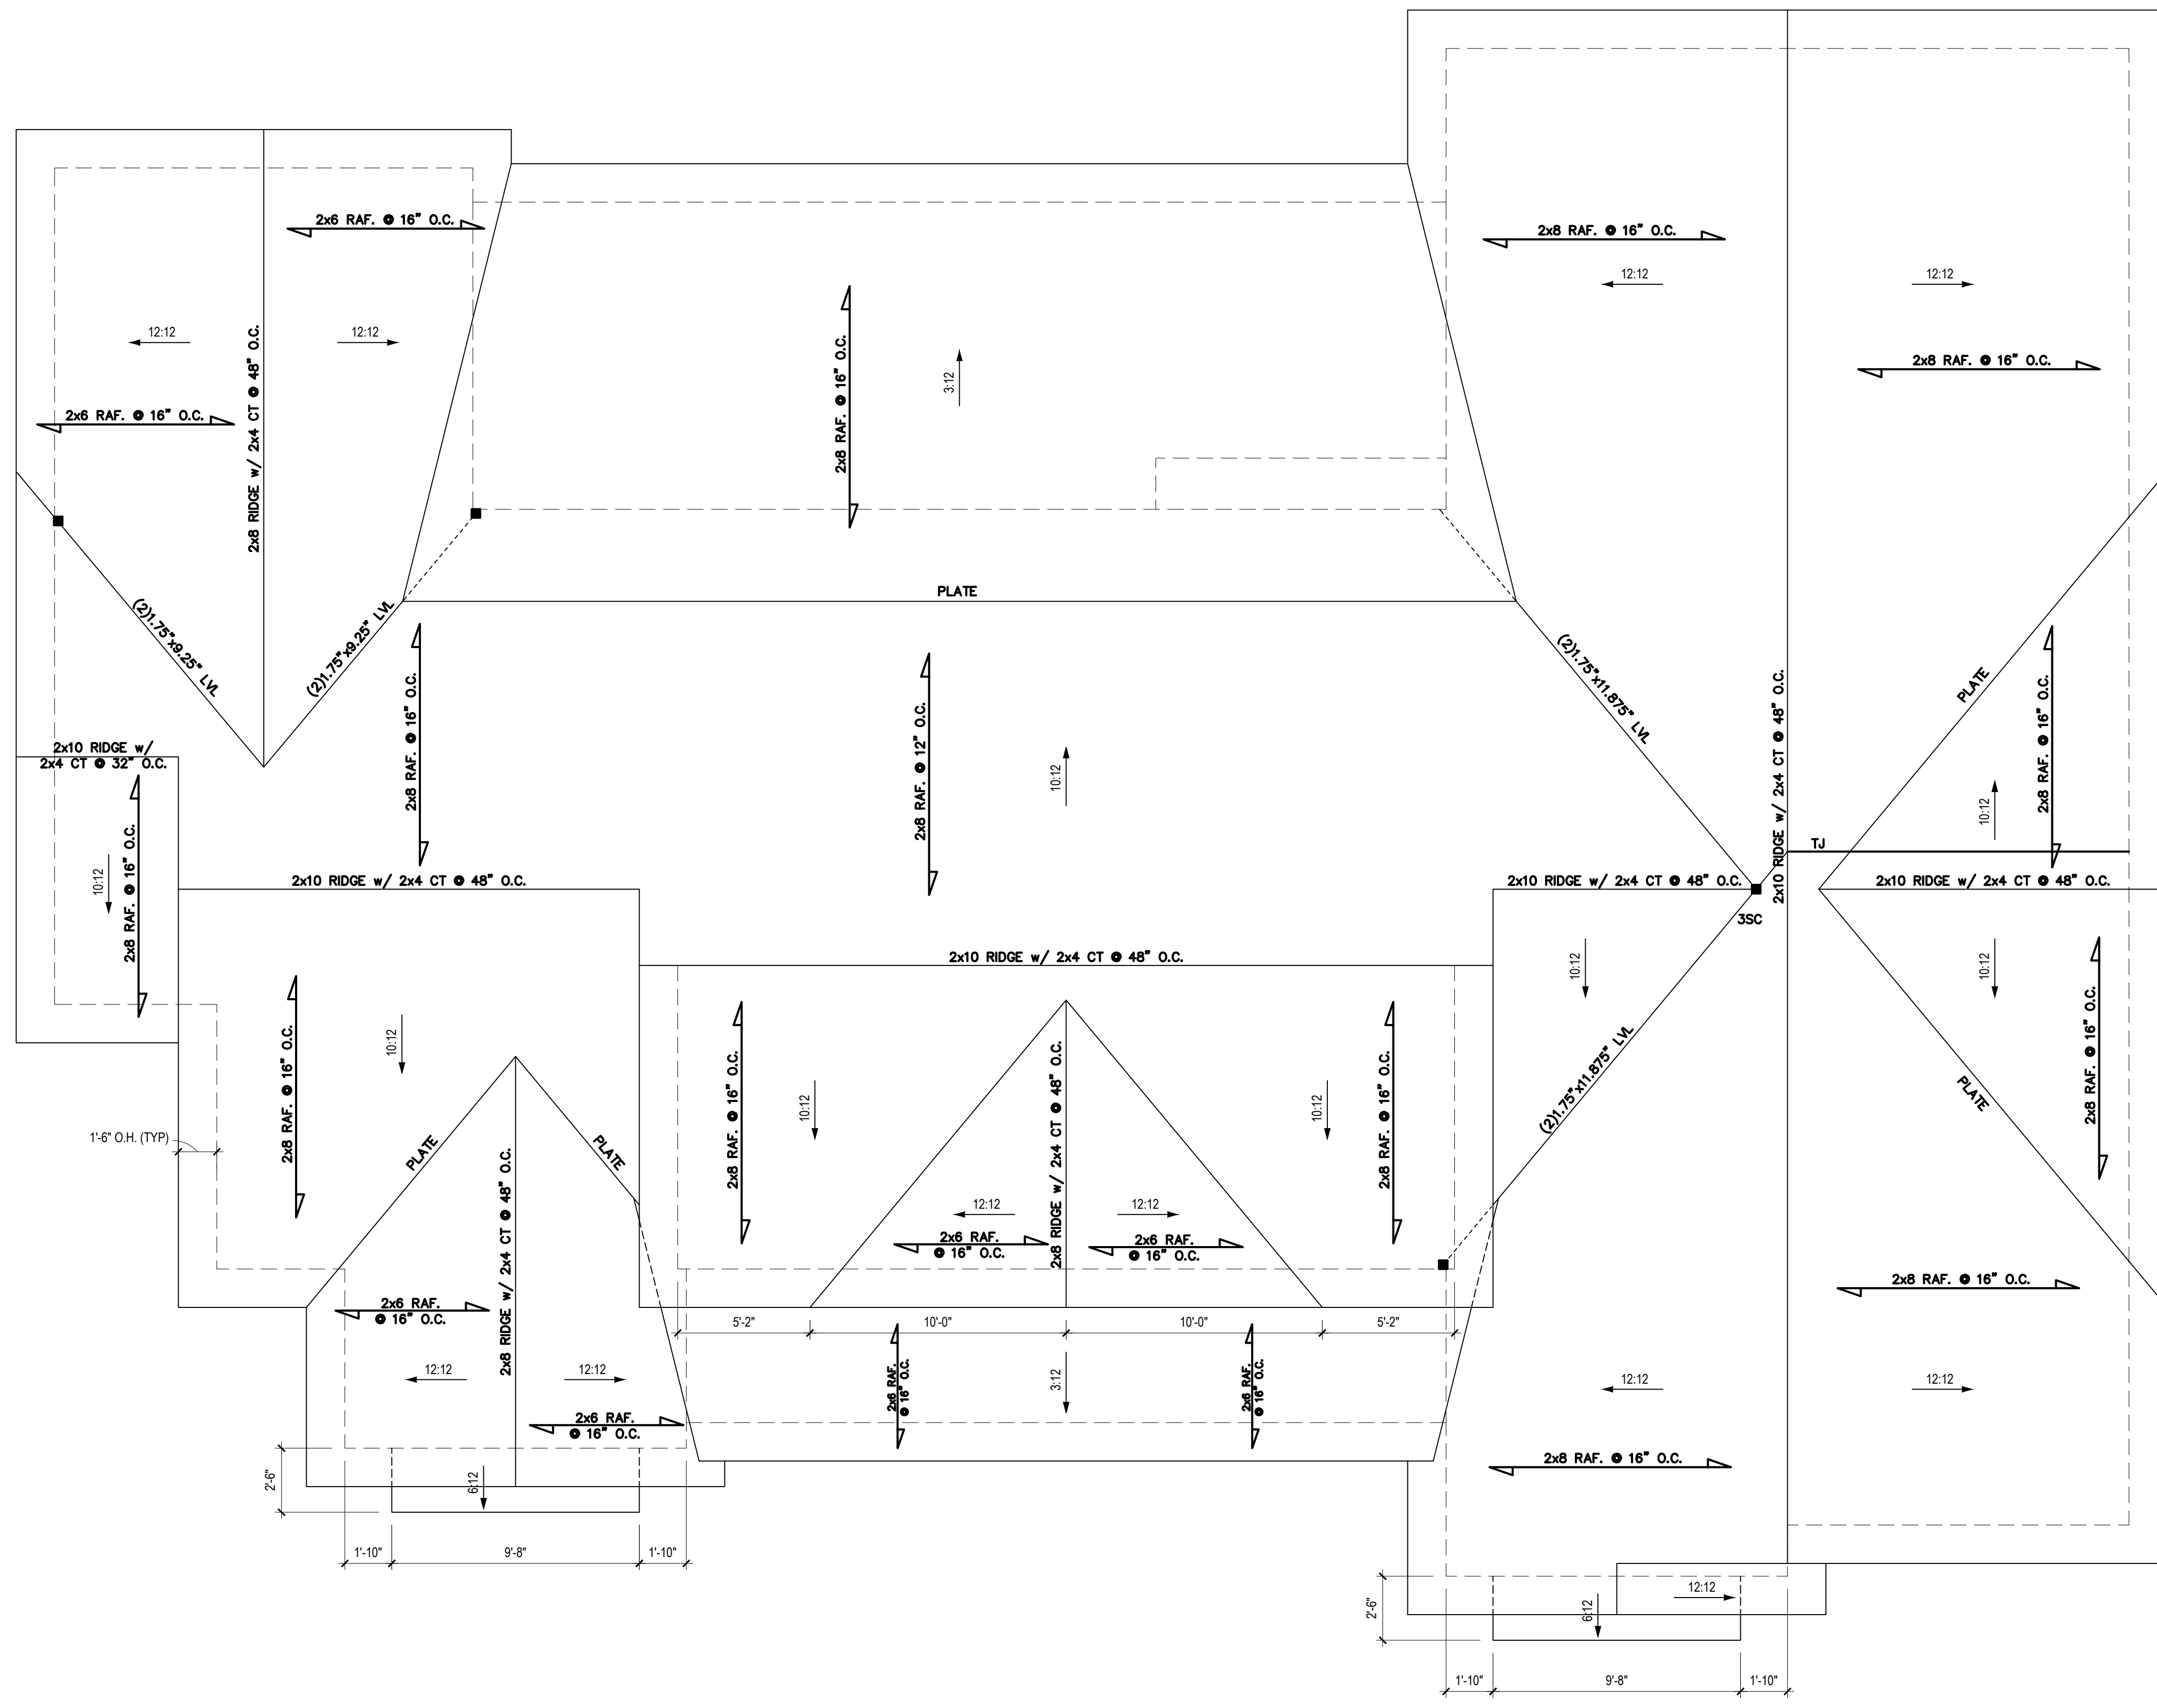

ROOF PLAN

1/4" = 1'-0"

*ALL LUMBER TO BE #2 SYP, UNO
 BUILDER MAY USE ROOF TRUSSES, TRUSS DESIGN, LAYOUT, AND
 ENGINEERING TO BE PROVIDED BY TRUSS MANUFACTURER

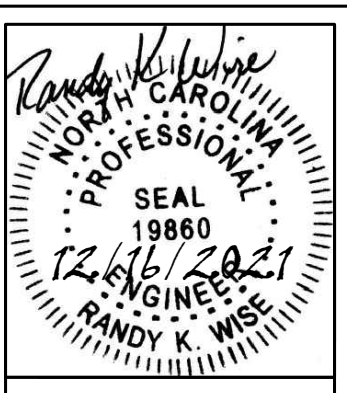

CLIENT: **Jon Taylor**
 PROJECT: **PERSONAL RESIDENCE**

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