




Kitchen Cabinets

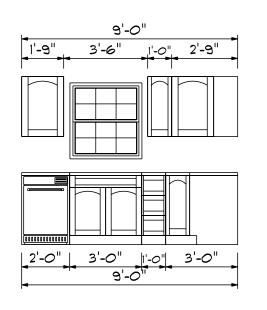

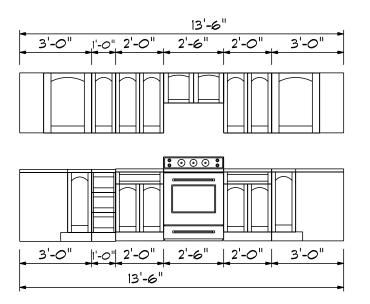

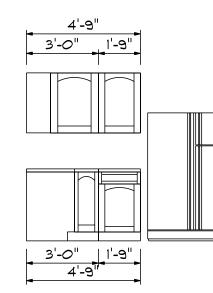

Bass Designs	2127 Chimney Pt. Linden N.C. 28356	910-864-9310
DATE:Tuesday, May 12, 2020	REVIGED	DRAWING*
SCALE: 1/4"	DRAWN BY	APPROVED


2'-0"	2'-0"
2-0	2-0
Ē .	1-
4'-	-0"
	-

FIRST FLOOR OPENING SCHEDULE					
PRODUCT CODE	SIZE	HINGE	COUNT		
36X80 COLONIAL A	3'-0"	R	1		
7X16 GARAGE DOOR	16'-0"	U	1		
72X80 SLIDING FRENCH 2	6'-0"	NL	1		
20 colonial	2'-0"	L	1		
20 colonial	2'-0"	R	1		
30 doublehung colonial	3'-0"	LR	1		
32X80 COLONIAL A 1	2'-8"	R	1		
24X24 CASEMENT 1	2'-0" x 2'-0"	N	2		
28x52 Twin	5'-4" x 5'-2"	NA	1		
28x52 twin	5'-4" x 5'-2"	NA	1		
30x32 single	3'-0" x 3'-2"	N	1		

BBH-2052

Areas


First Floor	942
Second Floor	1270
	======
Total Heated	2212
Garage	413
Porch	70

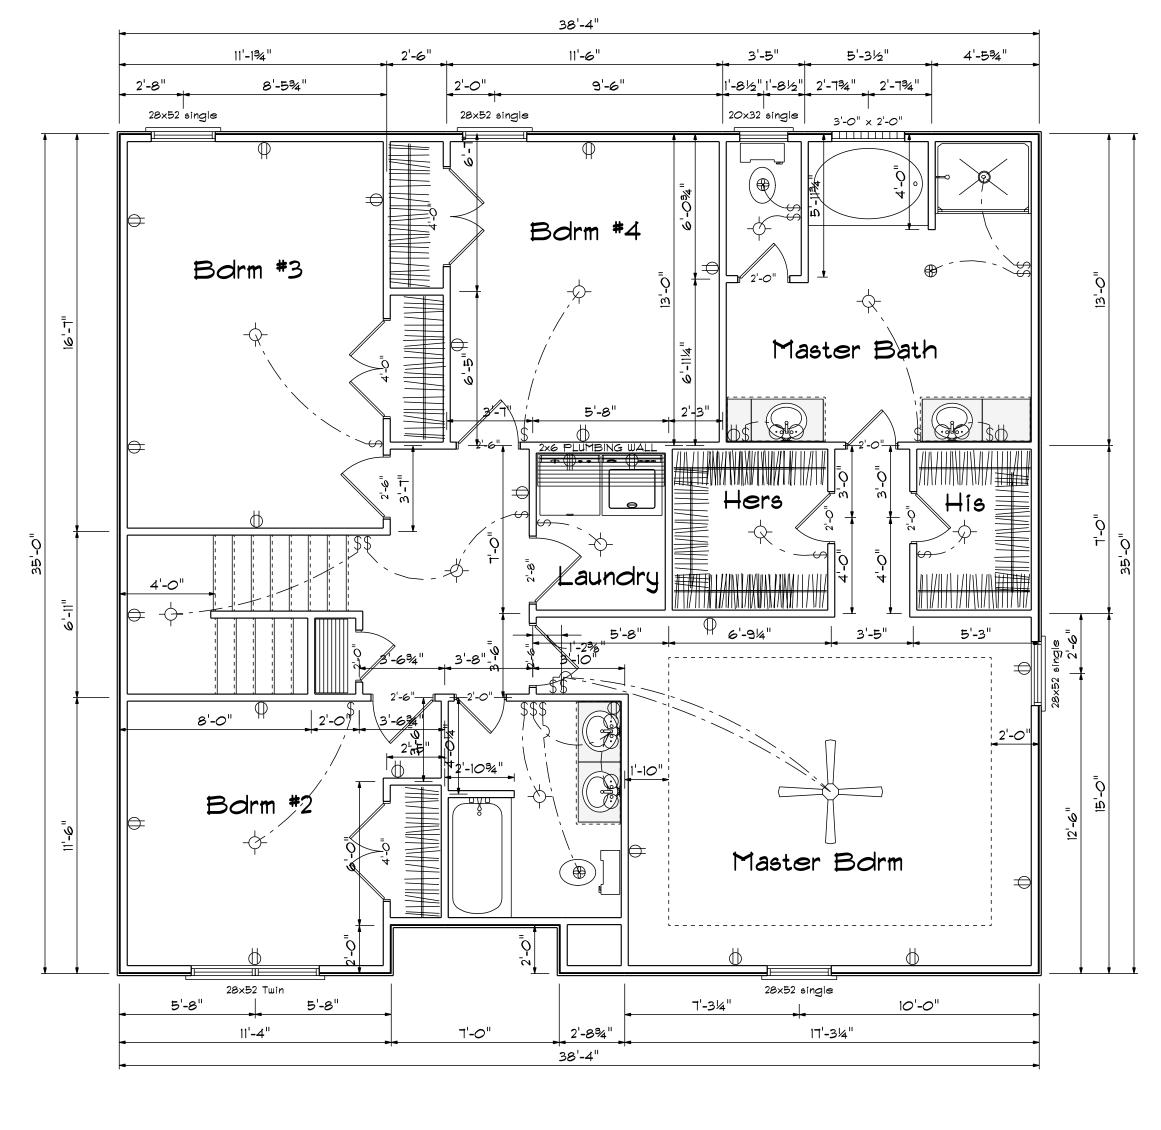

Second Floor Plan

Scale: 1/4"= 1'-0"



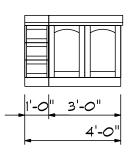

2'-0"	2'-6"
4	-6"


Hall Bath Cabinets


2'-6"	2'-6"
5'-	

SECOND FLOOR OPENING SCHEDULE					
PRODUCT CODE	SIZE	HINGE	COUNT		
2-0 Door Unit	2'-0"	R	1		
20 colonial	2'-0"	L	2		
20 colonial	2'-0"	R	3		
26 colonial	2'-6"	L	4		
4-0 Doublehung Door Unit	4'-0"	LR	1		
40 doublehung colonial	4'-0"	LR	2		
32X80 COLONIAL A 1	2'-8"	R	1		
20x32 single	2'-0" x 3'-2"	N	1		
28x52 Twin	5'-4" x 5'-2"	NA	1		
28x52 single	2'-8" x 5'-2"	N	4		
6X6 GLASS BLOCK	3'-0" x 2'-0"	N	1		


(SCALE: 1/4"	DATE:Tuesday, May 12, 2020	Base Designs
Ine Cubress	DRAWN BY	REVIGED	Linden, N.C. 28356
5	APPROVED	DRAWING#	910-864-9310

BBH-2052

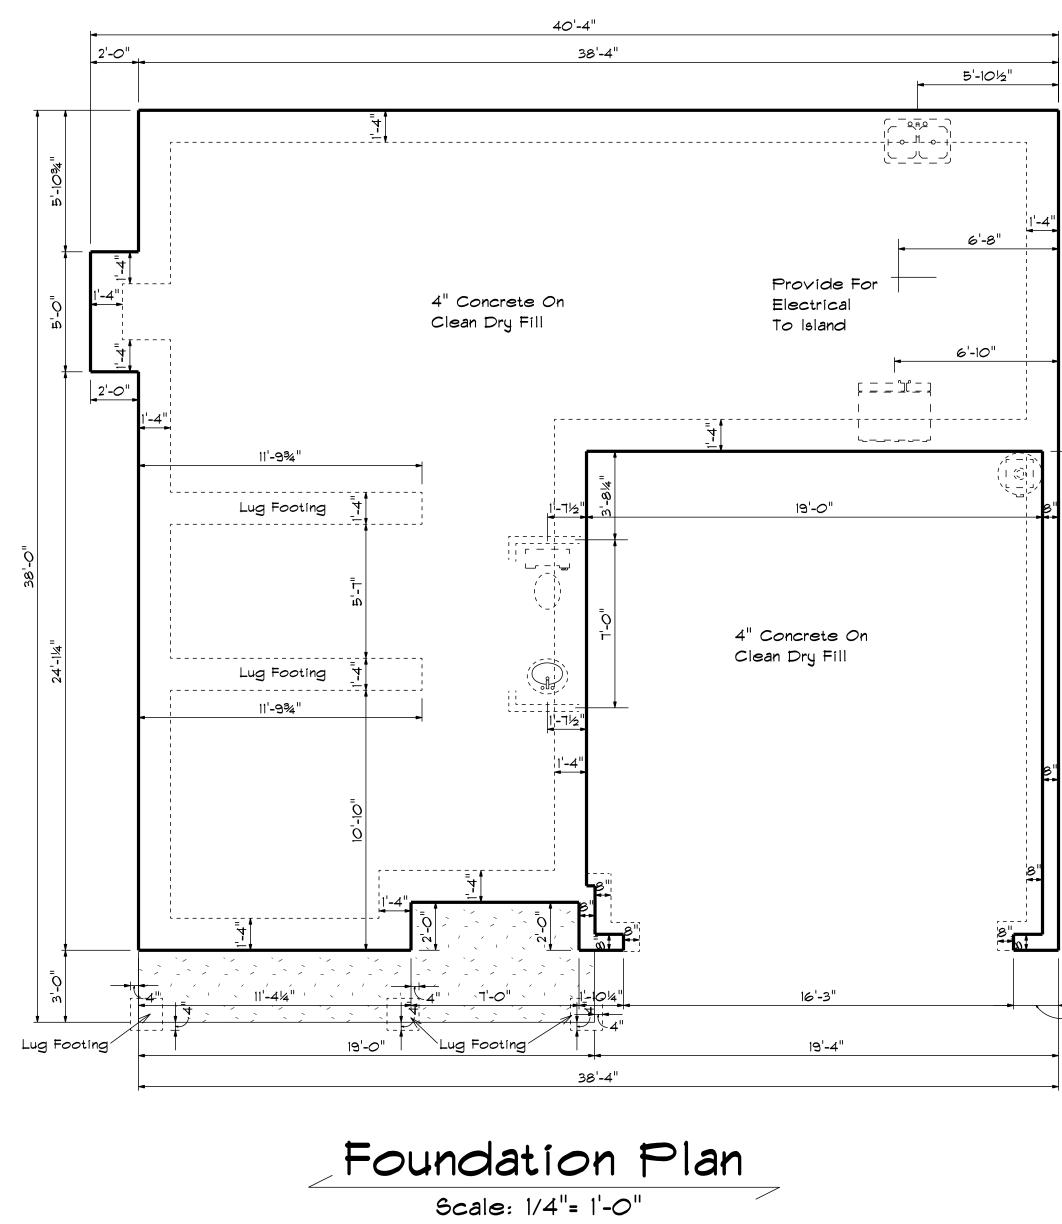

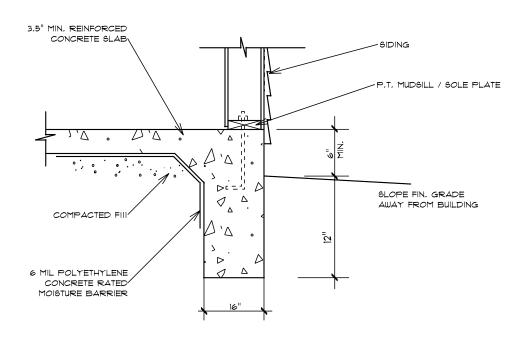



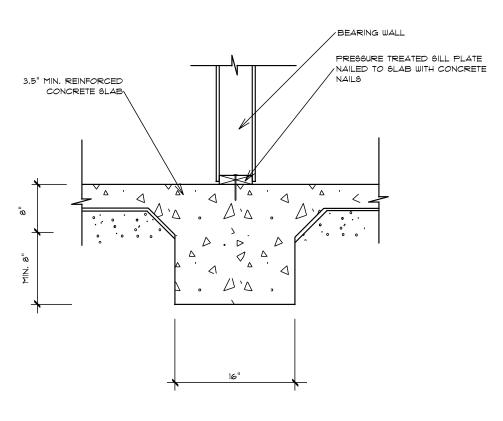



1'-101/2"

5

C

SCALE: 1/4"	DATE:Tuesday, May 12, 2020	Bass Designs
DRAWN BY	REVISED	2727 Chimney Pt. Linden N.C. 28356
APPROVED	DRAUING#	910-864-9310

Gypress 17 Ø

BBH-2052



Dimension Notes

All exterior wall to wall dimensions are to face of sheathing unless noted otherwise
 All interior wall dimensions are to face of frame wall unless noted otherwise
 All exterior wall to truss dimensions are to face of frame wall unless noted otherwise


	Conne	Nail Information				
Sym	Product	Manuf	Qty	Supported Member	Header	Truss
\bigcirc	MSH422	USP	4	Varies	10d/3"	10d/3"
\bigcirc	HUS410	USP	2	NA	16d/3-1/2"	16d/3-1/2"

	Plumbing Drop Notes
1.	Plumbing drop locations shown are NOT exact.
2.	Contractor to verify ALL plumbing drop
	locations prior to setting Floor Trusses.
3.	Adjust spacing as needed not to exceed 24"oc.


acing as needed not to exceed 24"oc.

	co	m	те	CH	
R	RUS eilly F Fayet Phon	SES load Ir teville e: (91)	& B		∕IS ™
deemed requirem attached requirem size and reactions 15000#. <i>A</i> retained reaction Tables. <i>A</i>	to compl nents. The Tables (nents) to number s greater A register to design that exce A register to design	y with the e contract derived f determin of wood s than 3000 red design the supp eeds thos red design	e prescrip tor shall r rom the p e the min studs requ D# but not n profess oort syste e specifie n professi port syste	to 3000# tive Code efer to the rescriptiv imum fou ired to si greater t ional shal m for any d in the a onal shal m for all	e ve Code indation upport han ll be / ttached
Signatur	.e[<mark>d L</mark> a	<mark>andr</mark> ndry	у
	(BASEI	ON TABL	63 R502.5(I	CK STU 0 & (b)) 0 0 EA END	
20 (5) (5) (4) (5) (4) (5) (5) (5) (5) (5) (5) (5) (5) (5) (5	800 SOLD FOR PLANDER 1 2 3 4	нелбез 2550 5100 7650	WGTROER 804 SUPLS 9, 044 1 1 2 3 0 4	NOLLY 4 0ND 340 680 1020	(0:40) 001 Squ15 (0.52) 001 1 002 3 000 3 000 4
8500 10200 11900 13600 15300	5 6 7 8 9	1275 1530		1700	00 5
CI TY / CO. Spring Lake / Cumberland	113 North Dakota Ct.	Roof	/. 01/07/21	DRAWN BY David Landry	SALES REP. Marshall Naylor
СІ ТҮ / СО	ADDRESS	MODEL	DATE REV.	DRAWN B	SALES RE
Benjamin Stout	JOB NAME Lot 6 Sierra Villas	Cypress	TE N/A	<pre># Quote #</pre>	J0121-0107
BUI LDER)	PLAN	SEAL DATE	QUOTE #	JOB #
These to comport design a See ind identified designe perman for the o support	russes ar hents to b at the spo ividual de ed on the er is respo ent braci overall st structure	e designo be incorpo ecification esign she placemen onsible fo ng of the ructure. 1 e includir	ed as indi prated into n of the be ets for ea nt drawing or tempora roof and The design og headers	GRAM ON vidual build the build uilding de ch truss of g. The build ary and floor syst n of the tr s, beams, f the build	ilding ding ssigner. design ilding em and russ walls,

Indicates Left End of Truss (Reference Engineered Truss Drawing)
Do NOT Frect Truss Backwards
for the overall structure. The design of the truss support structure including headers, beams, walls, and columns is the responsibility of the building designer. For general guidance regarding bracing, consult BCSI-B1 and BCSI-B3 provided with the truss delivery package or online @ sbcindustry.com

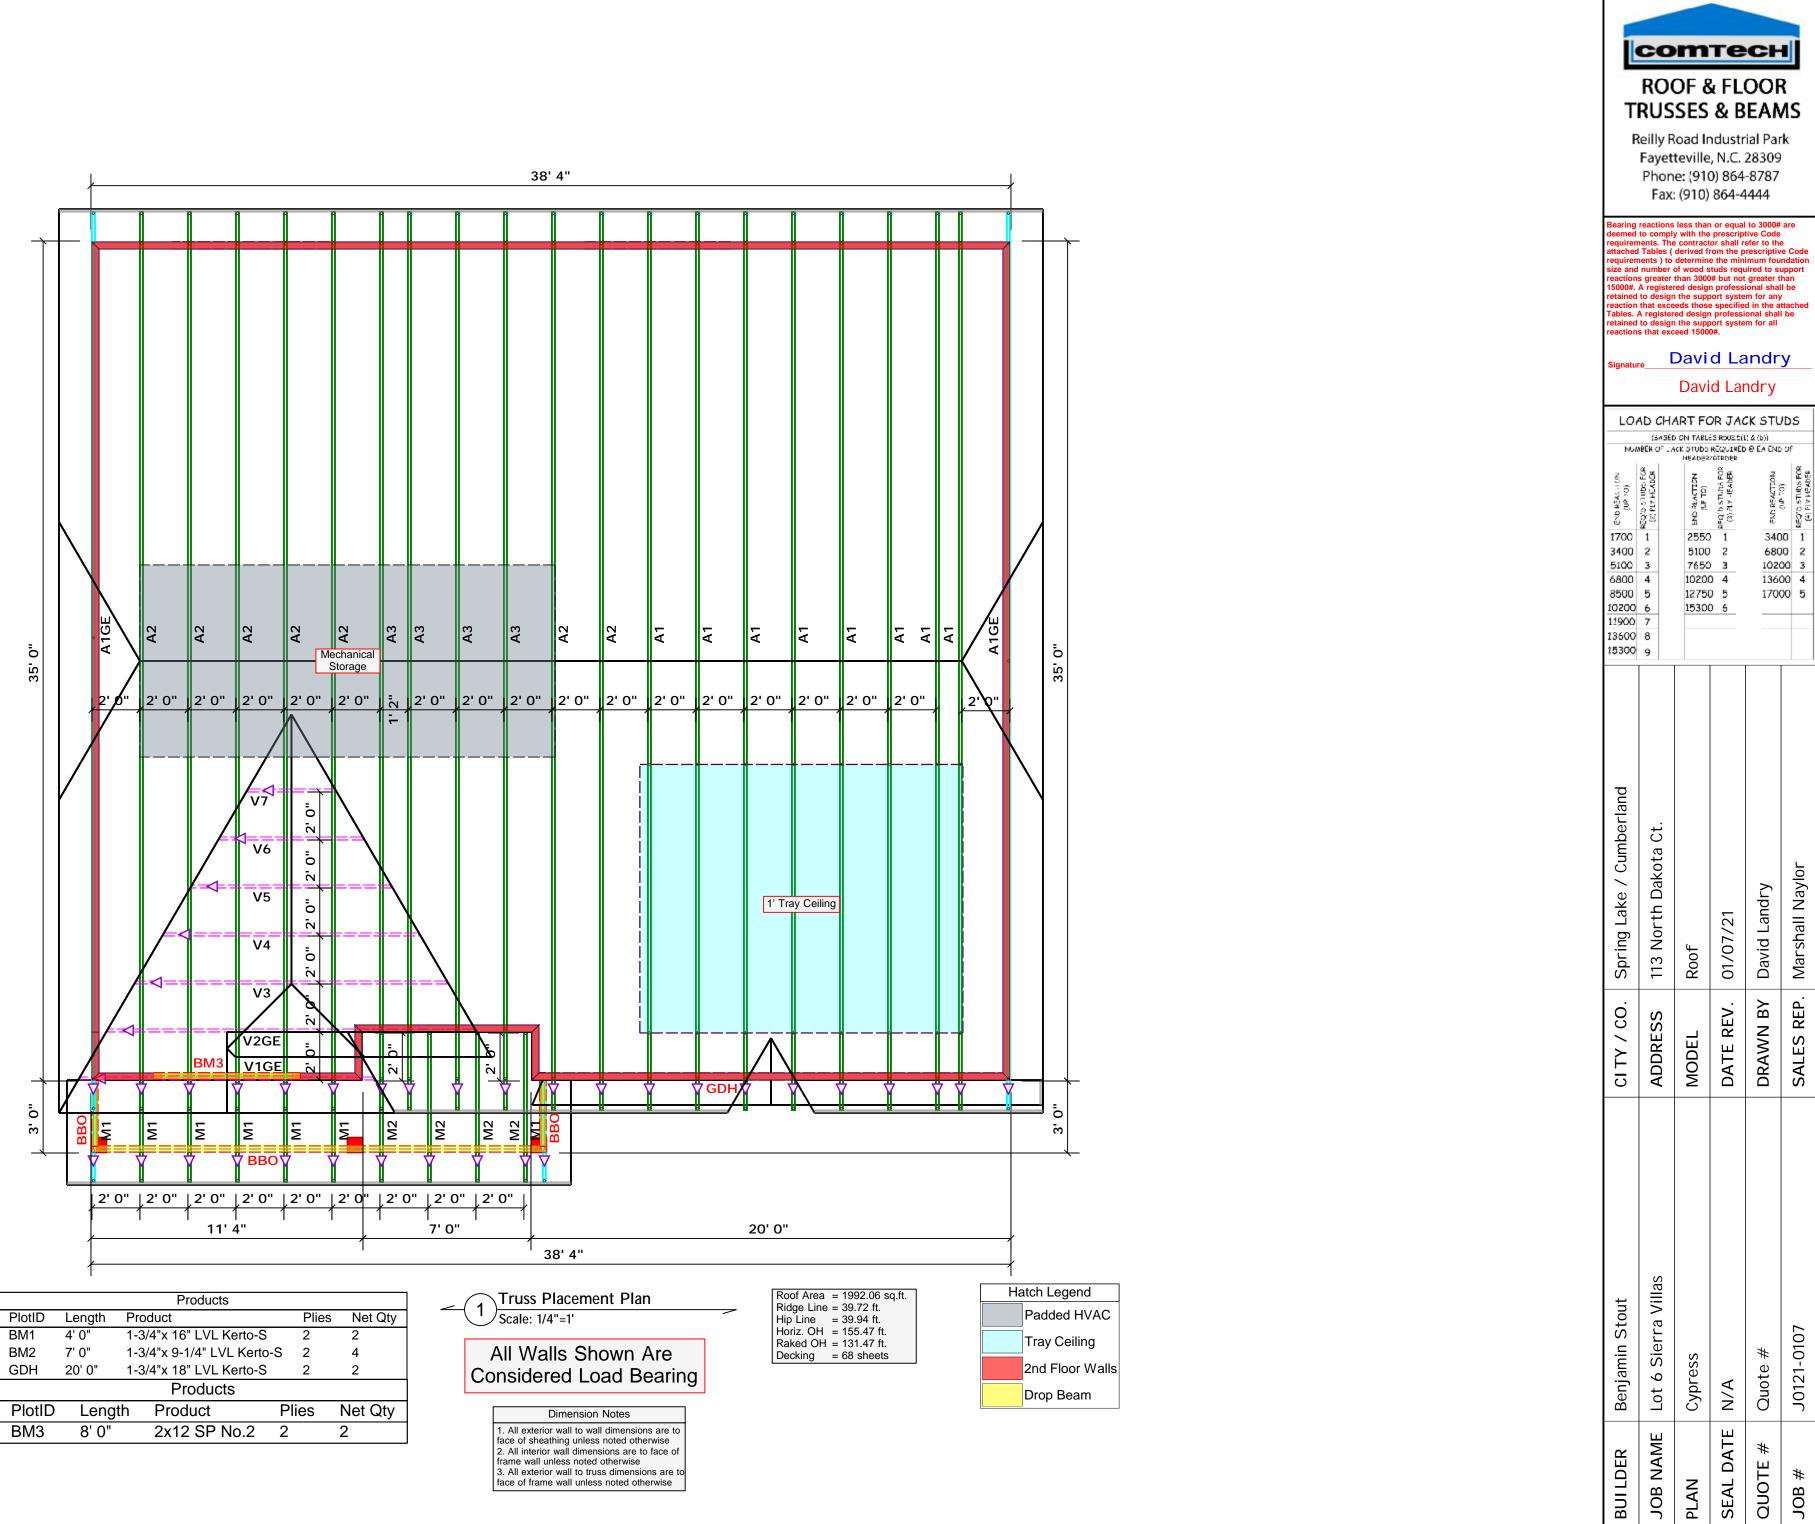

frame wall unless noted otherwise 3. All exterior wall to truss dimensions are to face of frame wall unless noted otherwise

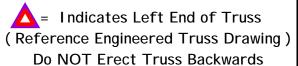

THIS IS A TRUSS PLACEMENT DIAGRAM ONLY. THIS IS A TRUSS PLACEMENT DIAGRAM ONLY. These trusses are designed as individual building components to be incorporated into the building design at the specification of the building designer. See individual design sheets for each truss design identified on the placement drawing. The building designer is responsible for temporary and permanent bracing of the roof and floor system and for the overall structure. The design of the truss support structure including headers, beams, walls, and columns is the responsibility of the building designer. For general guidance regarding bracing, consult BCSI-B1 and BCSI-B3 provided with the truss delivery package or online @ sbcindustry.com

PLAN

JOB

END REACTION (UP TO) REQ15 STUDS FOR (4) FLY HEADER

3400 1

6800 2

Marshall Naylor

J0121-0107

#

JOB