

NOTICE TO CONTRACTOR
All construction must comply with current NC Building Codes and is subject to field inspection and verification.


APPROVED
Limited building only review
Permit holder responsible for full compliance with the code

02/03/2021

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Harnett c o u N T Y NORTH CAROLINA

PLANS DESIGNED UNDER 2018 NORTH CAROLINA RESIDENTIAL CODE. SEE ROOF PLAN FOR KNEEWALL HEIGHTS AND LOCATIONS.

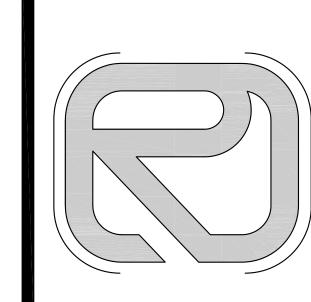

EATIVE RESIDENTIA DESIGNS, LLC

DESIGNS, LL 5000 NEIMAN COV RALEIGH, N.C. 27612 919.260.6393

PROJECT:

LOT 1 MORGAN FARM

PHENSON UILDERS

1187 NORTH RALEIGH STREET ANGIER, NC 27501

BCR


DATE:

01-12-21

REVISIONS:

SHEET NO.

1

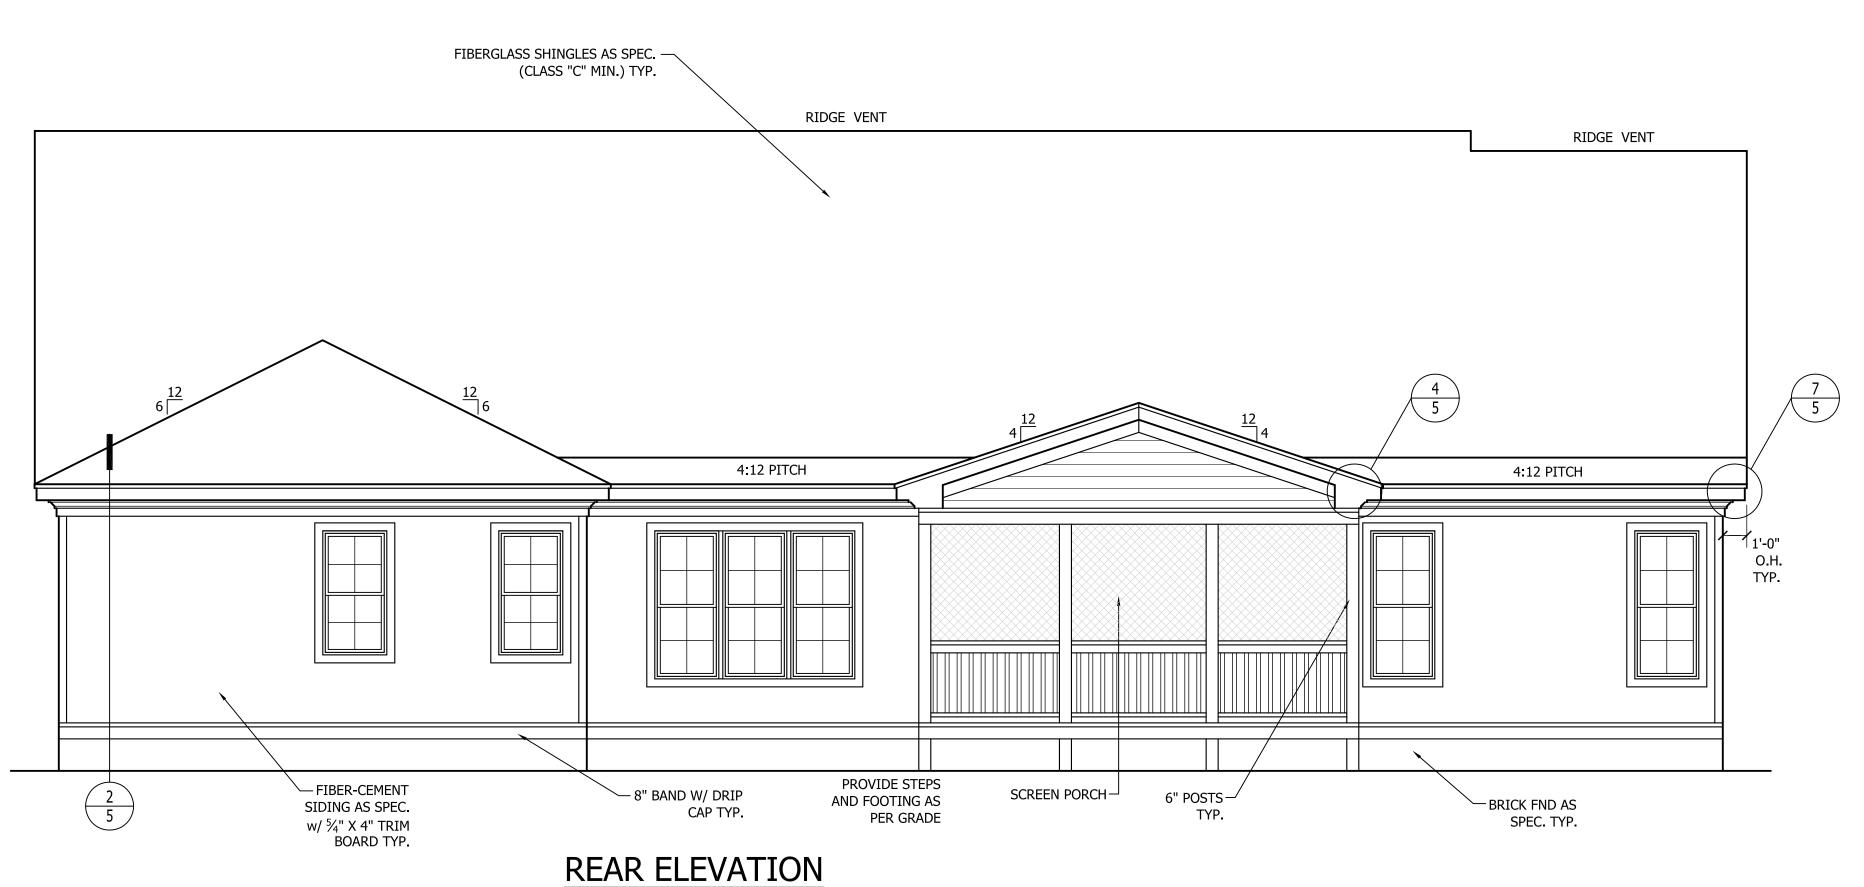


SCALE: 1/4"=1'-0"

RIDGE VENT FIBERGLASS SHINGLES AS SPEC.
(CLASS "C" MIN.) TYP. RIDGE VENT SCREEN PORCH — 6" POST AS SPEC. — TYP. PROVIDE STEPS AND FOOTING AS PER GRADE 8" POST AS SPEC. TYP. FIBER-CEMENT SIDING AS SPEC. w/ ½" X 4" TRIM BOARD TYP. 8" BAND W/
DRIP CAP TYP. — PARGED FND AS SPEC. TYP. BRICK FND. AS SPEC. TYP. LEFT-SIDE ELEVATION

SCALE: 1/4"=1'-0"

PLANS DESIGNED UNDER 2018 NORTH CAROLINA RESIDENTIAL CODE. SEE ROOF PLAN FOR KNEEWALL HEIGHTS AND LOCATIONS.

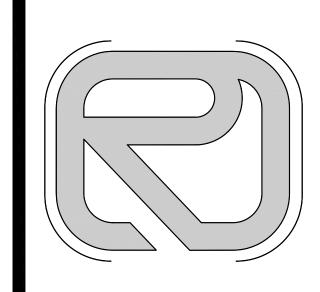

PROJECT:

LOT 1 MORGAN **FARM** 

DATE:

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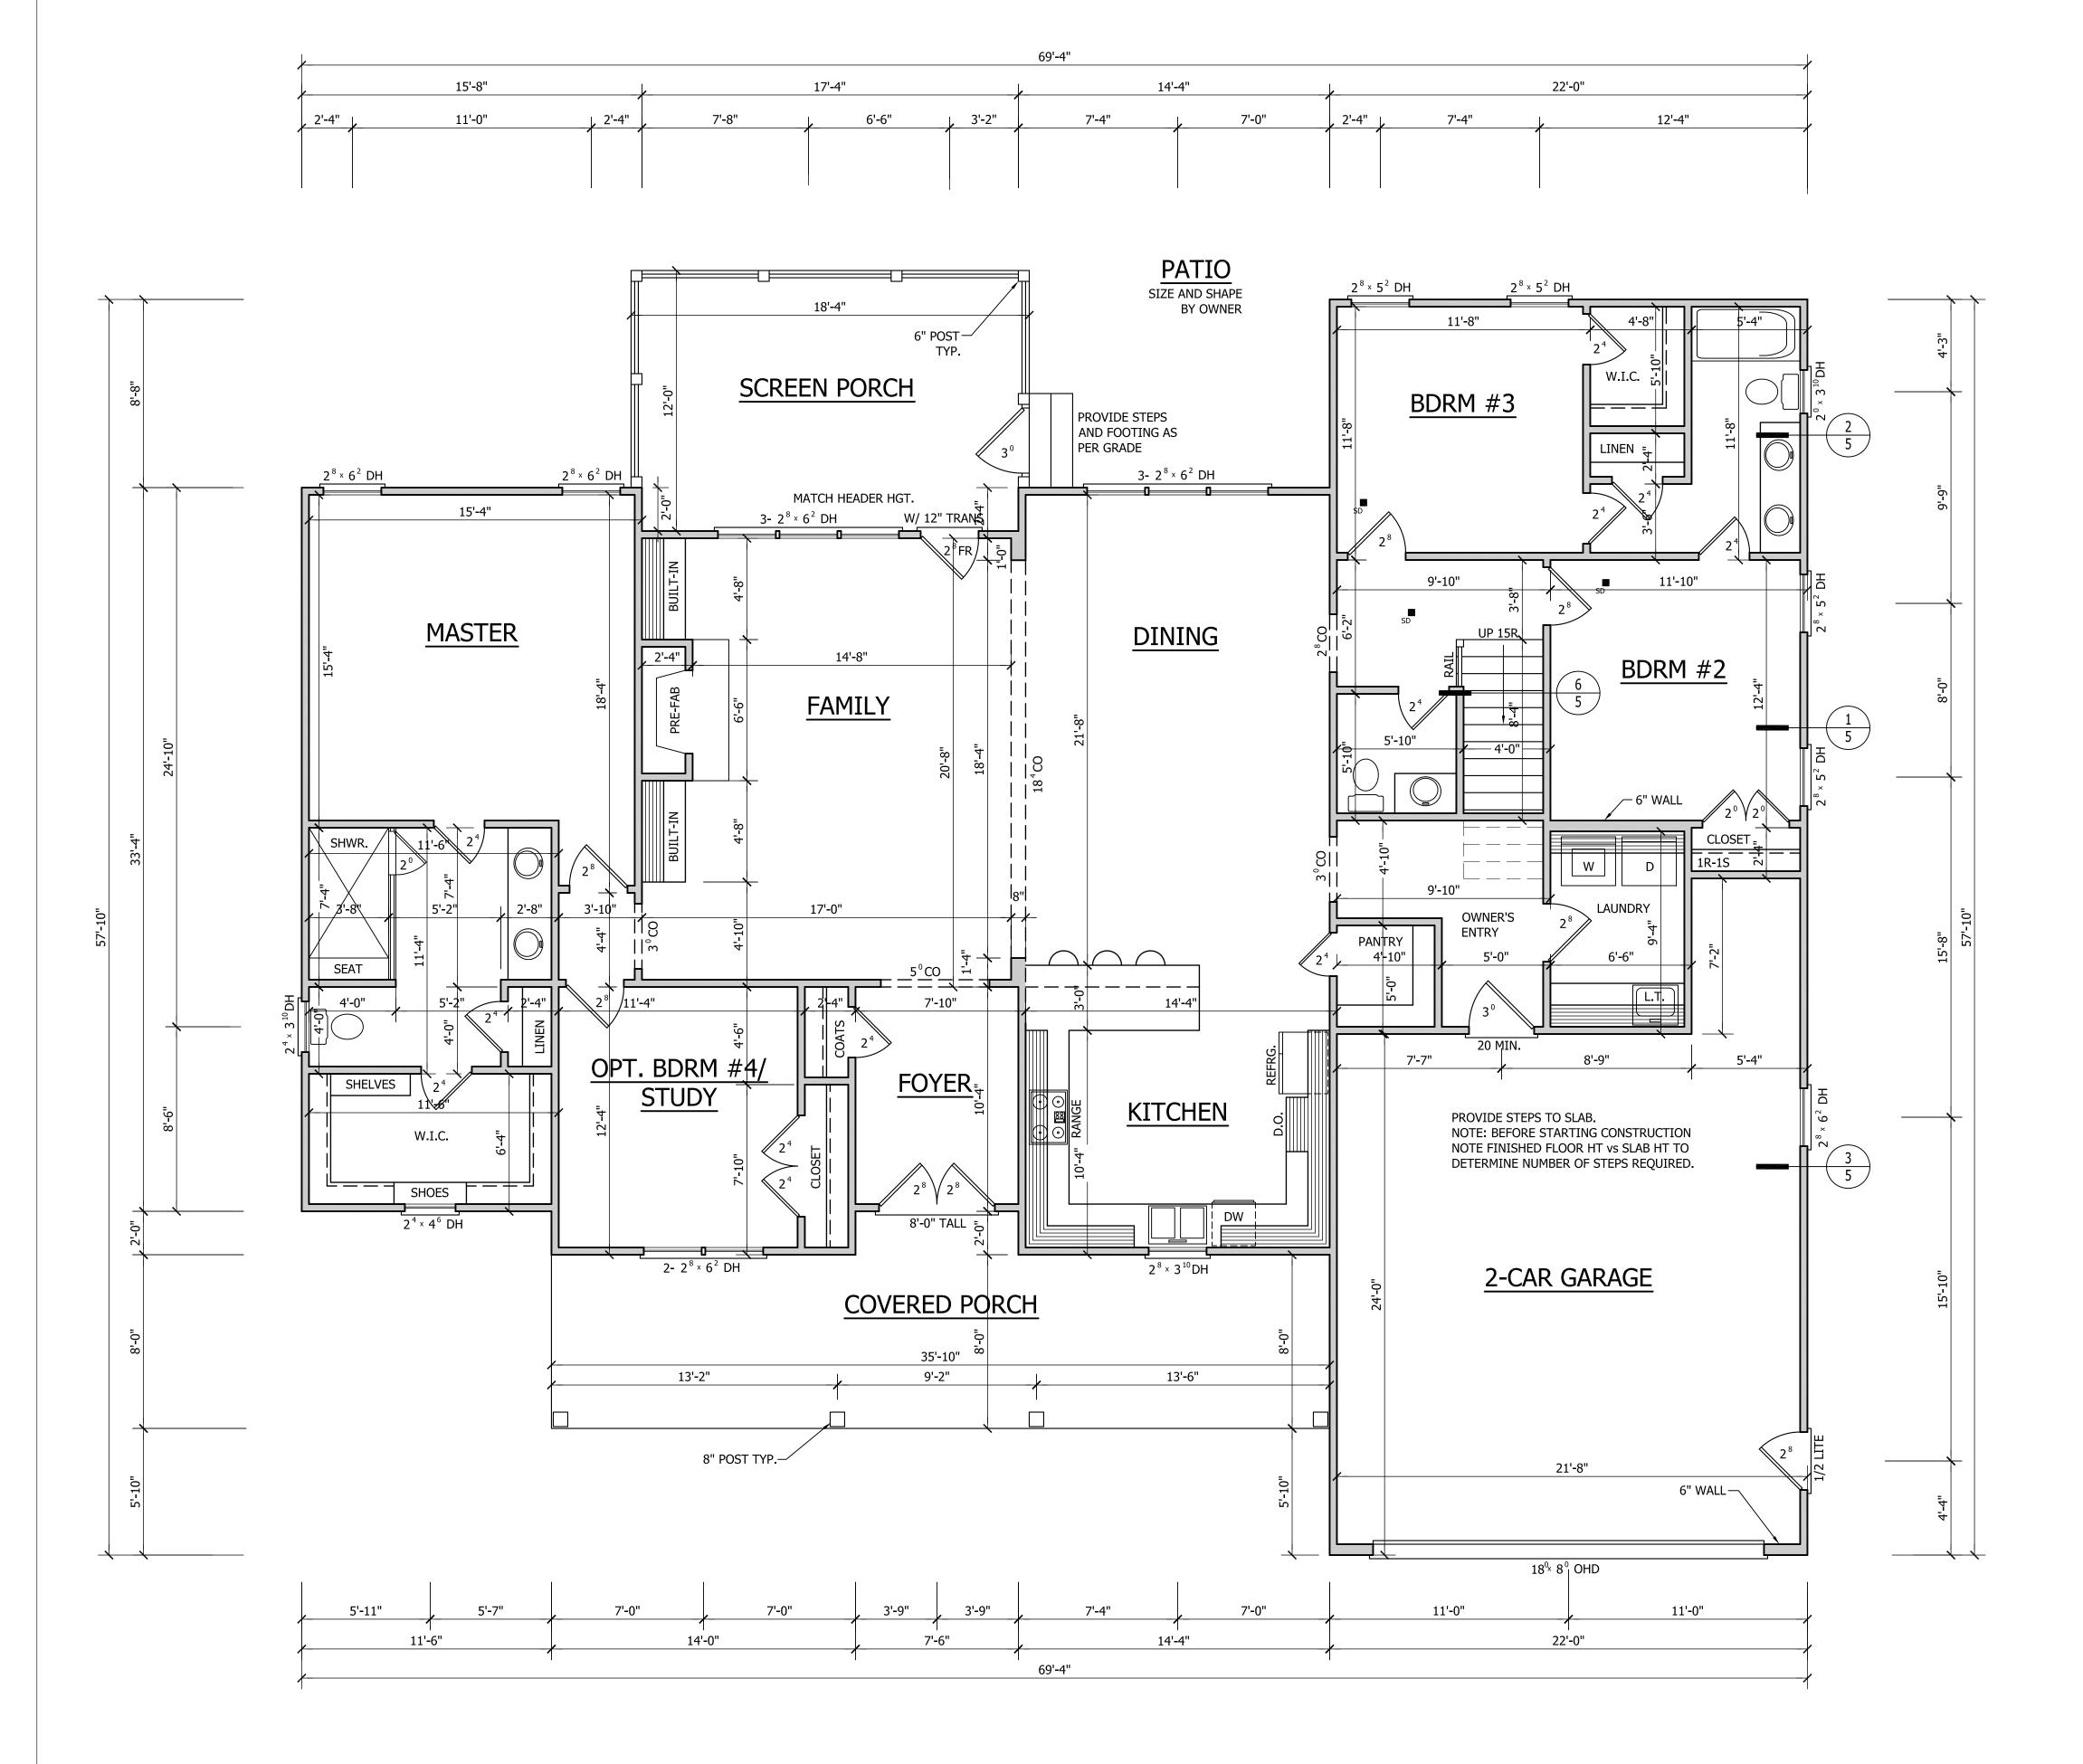
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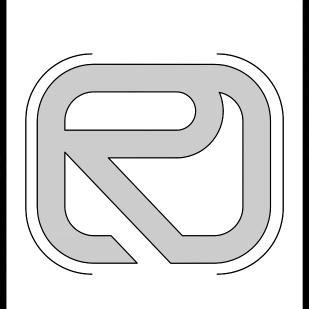
OF

FIBER-CEMENT SIDING AS SPEC. w/ ½" X 4" TRIM BOARD TYP. FIBERGLASS SHINGLES AS SPEC.
—(CLASS "C" MIN.) TYP. RIDGE VENT RIDGE VENT RIDGE VENT -SCREEN PORCH -6" POSTS 8" BAND W/ DRIP — CAP TYP. - PARGED FND AS SPEC. TYP.

RIGHT-SIDE ELEVATION

SCALE: 1/4"=1'-0"





ATIVE RESIDENTIA

5000 NEIN RALEI

PROJECT:

LOT 1 MORGAN FARM

TEPHENSON BUILDERS INC.

NORTH RALEIGH STREE ANGIER, NC 27501

BCR

DATE:

01-12-21

**REVISIONS:** 

SHEET NO.

3

FIRST FLOOR PLAN
9'-0" CEILING HGT.
SET WINDOWS @ 8'-0" A.F.F.

#### AREA CALCULATIONS

SCALE = 1/4" = 1'-0"

HEATED (SQ. FT.)		UNHEATED (SQ. FT.)		UNFINISHED (SQ. FT.)	
BASEMENT:	N/A	GARAGE:	563	BASEMENT:	N/A
1ST FLOOR:	2309	SCREEN:	218	REC ROOM:	N/A
2ND FLOOR:	512	PORCH:	302	ATTIC:	N/A
		STOOP:	N/A	STORAGE:	1131
_		BRICK:	N/A	OVERALL DIME	NSION
TOTAL:	2821	TOTAL:	1083	WIDTH:	69'-4"
(HEATED)		(UNHEATED)		DEPTH:	57'-10"

#### NOTES:

-PLANS DESIGNED UNDER 2018 NORTH CAROLINA RESIDENTIAL CODE.
-ALL ANGLED WALLS ARE 45 ° UNLESS NOTED OTHERWISE.
-FINISH DOOR AND WINDOW HEADS SHALL ALIGN EXCEPT AS NOTED.

-ALL MATERIALS AND COMPONENTS MUST BE INSTALLED PER MANUFACTURER'S RECOMMENDATIONS.

-GRADES SHOWN ARE ILLUSTRATIVE. NATURAL GRADE WILL DETERMINE FINISH GRADE.
-FLOOR PLAN NOTATIONS GOVERN OVER ELEVATION SCALE.

-VERIFY ALL WINDOW SIZES, RADIUS, AND DETAILS WITH CHOSEN MANUFACTURE.


-ALL HABITABLE ROOMS SHALL MEET LIGHT/VENTILATION & EGRESS REQUIRMENTS.


-TEMPERED GLASS TO BE USED AT ALL SAFETY REQUIRED LOCATIONS.
-ALL WINDOW GLAZING TO HAVE 0.35 U-FACTOR MIN.

-ALL CABINET DESIGNS/LAYOUTS TO BE VERIFIED WITH SHOP DRAWINGS FROM CABINET MANUFACTURER.
-PER 2018 N.C. RESIDENTIAL BUILDING CODE TABLE R302.6:

SHEETROCK ON GARAGE CEILING TO BE 5/8" TYPE "X".

OF

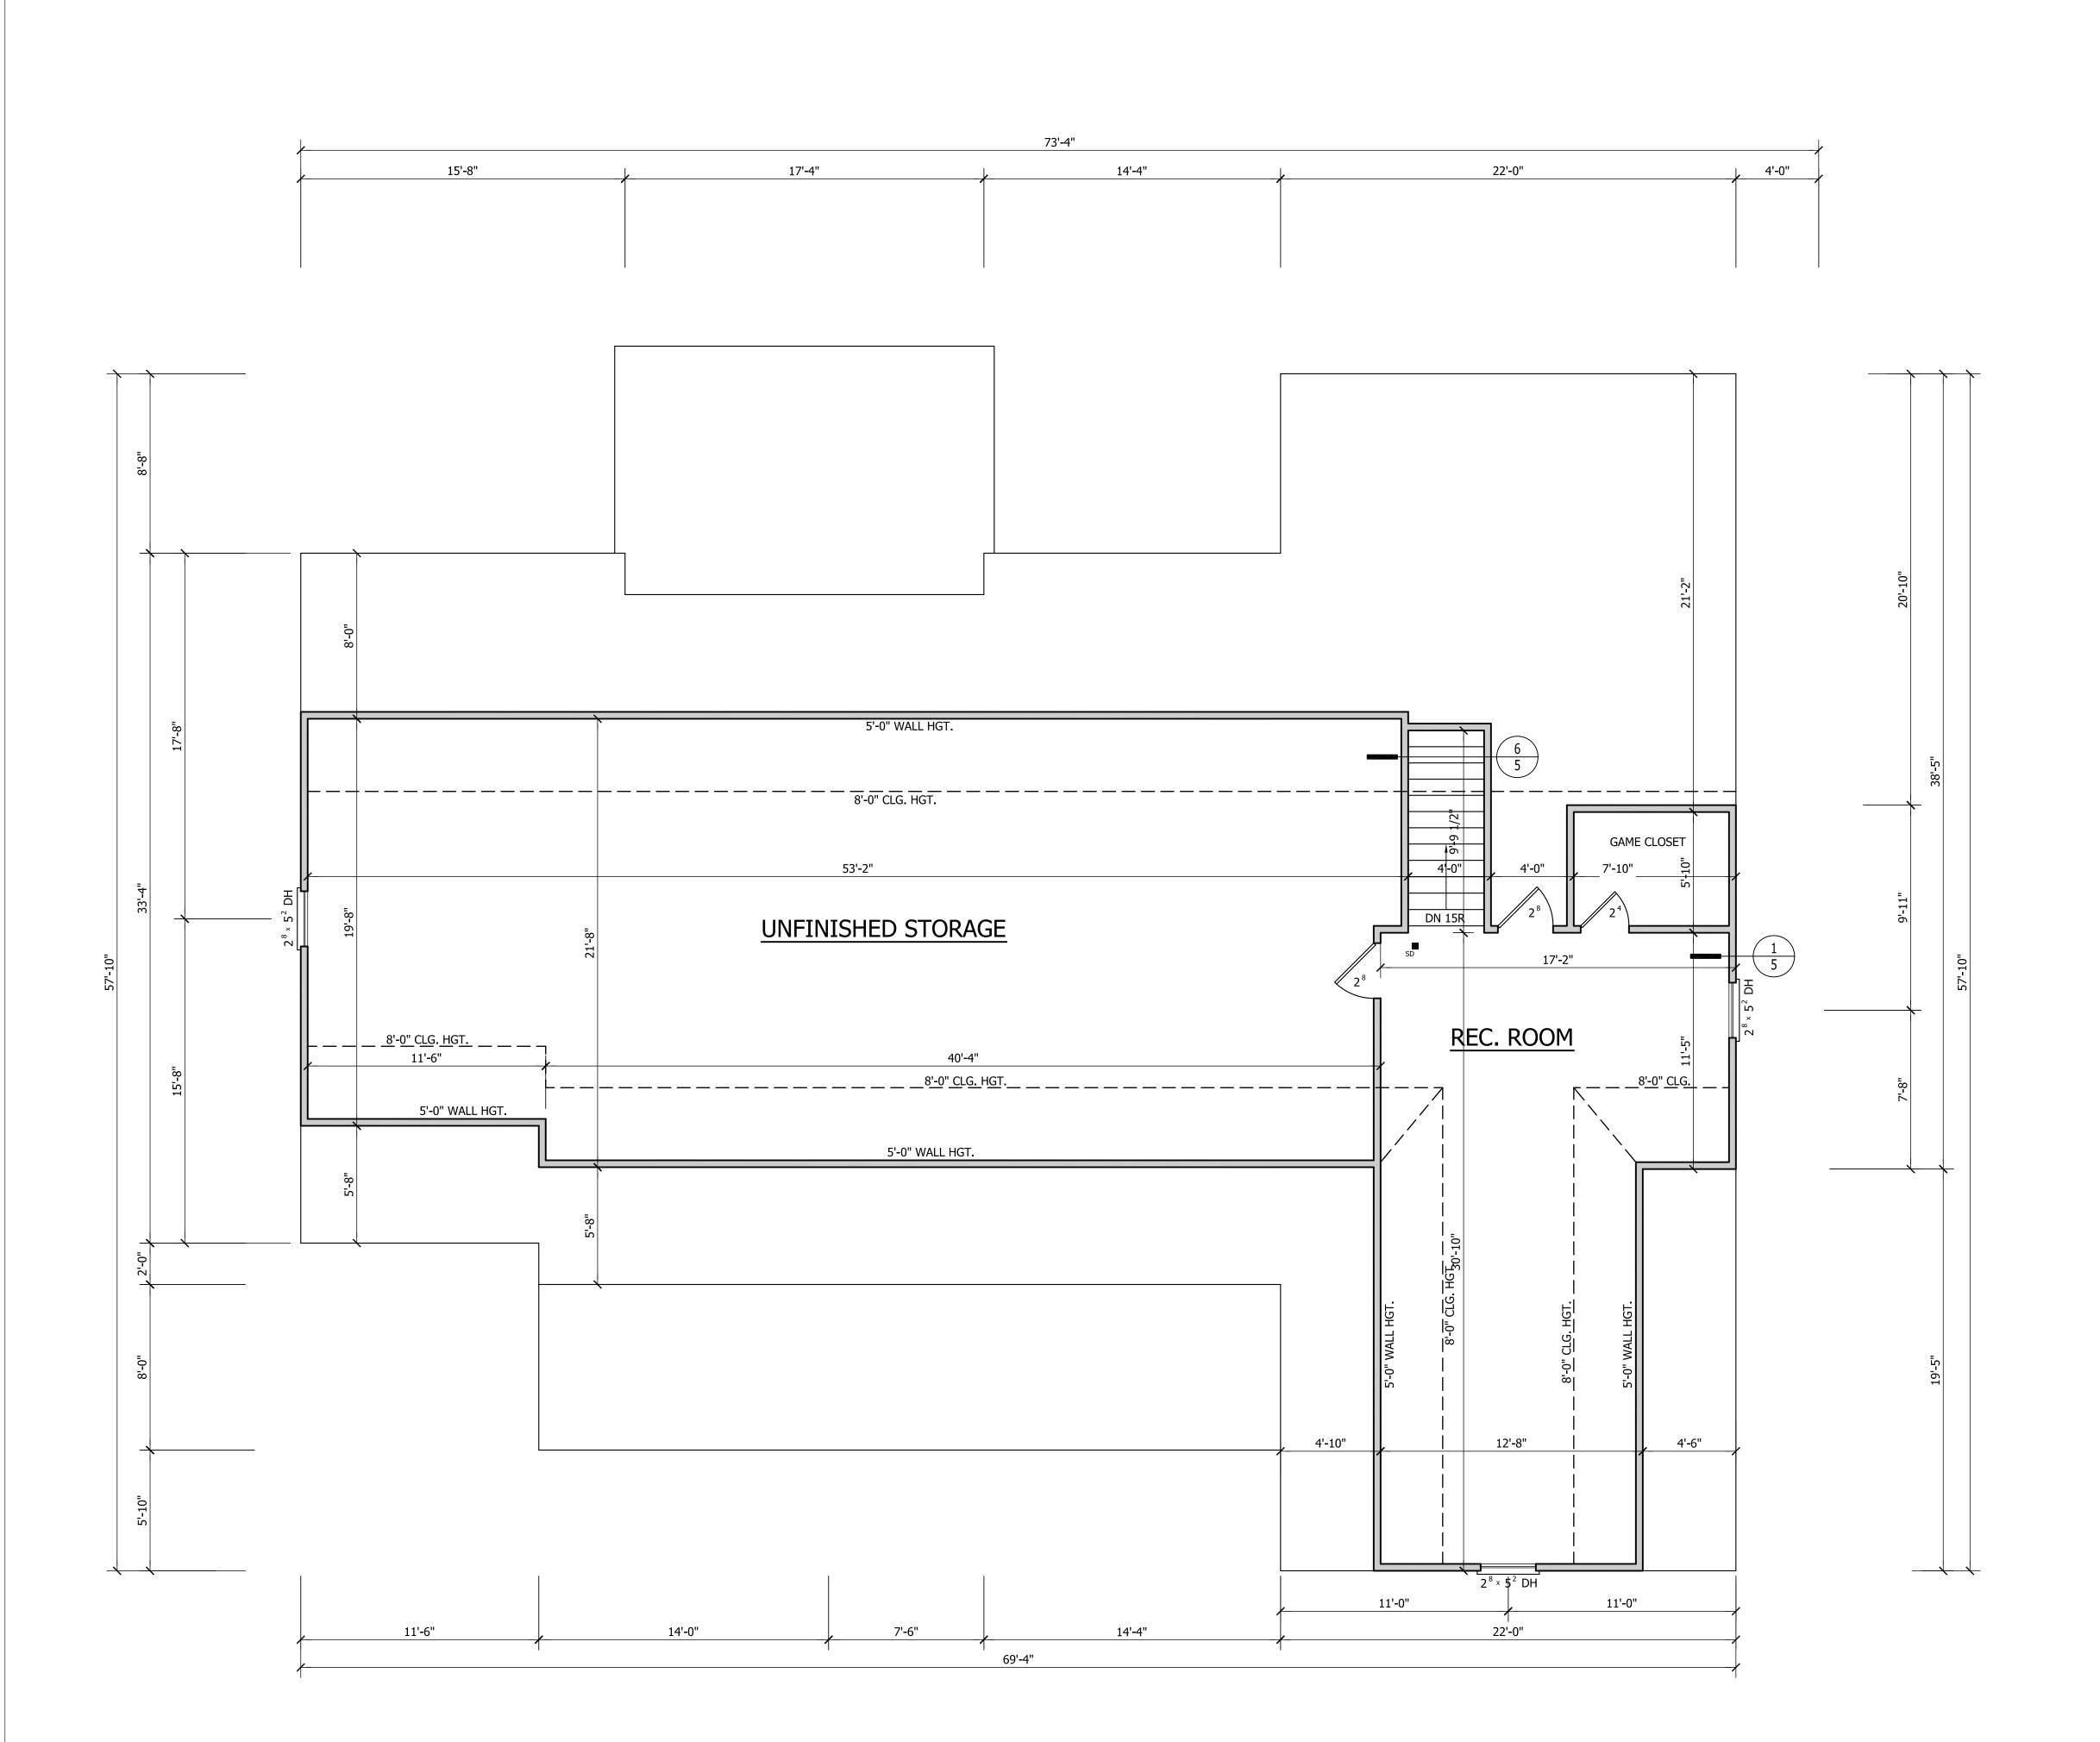

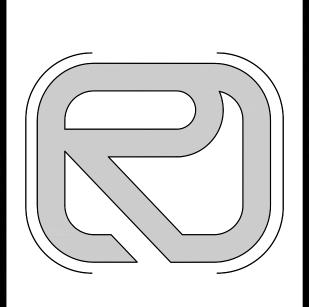

ATIVE RESIDENTIA

5

PROJECT:

LOT 1 MORGAN FARM

EPHENSON SUILDERS

NORTH RALEIGH STREE ANGIER, NC 27501

BCR

DATE:

01-12-21

**REVISIONS:** 

SHEET NO.

4

OF

5

SECOND FLOOR PLAN
8'-0" CEILING HGT.
SET WINDOWS @ 6'-8" A.F.F.
SCALE= 1/4" = 1'-0"

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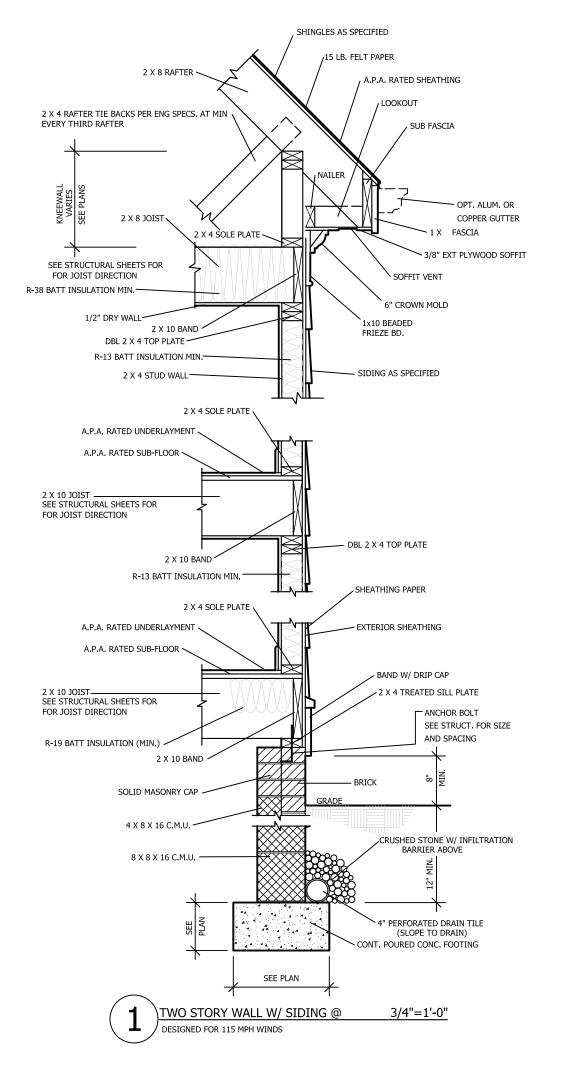
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-PER 2018 N.C. RESIDENTIAL BUILDING CODE TABLE R302.6: SHEETROCK ON GARAGE CEILING TO BE 5/8" TYPE "X".



OPTIONAL CAN LIGHTING

— OPTIONAL CROWN MOLDING

- ADJUSTABLE SHELVES

UNDERCABINET LIGHTING OPT.

SEE OWNER/BUILDER FOR

MODEL TO BE USED

— COUNTERTOP SEE OWNER

— ADJUSTABLE SHELVES

NOTE! SEE OWNER/BUILDER FOR

FOR 10' CLG HEIGHT USE 12" CABINETS SET ON TOP OF 42" UPPER

VERIFICATION OF CABINET

BACKSPLASH

1'-0"


2'-0"


TYP. KITCHEN CABINET SECTION @ 3/4"=1'-0"


TYP


TRIM WORK ON CABINETS AS SELECTED


OPTIONAL SOFFIT. ADJUST SOFFIT DIMENSIONS TO ACCEPT

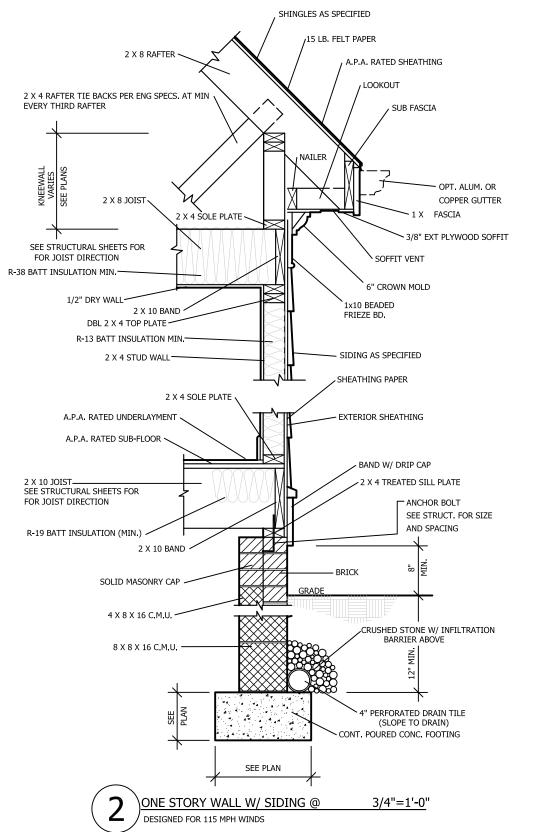

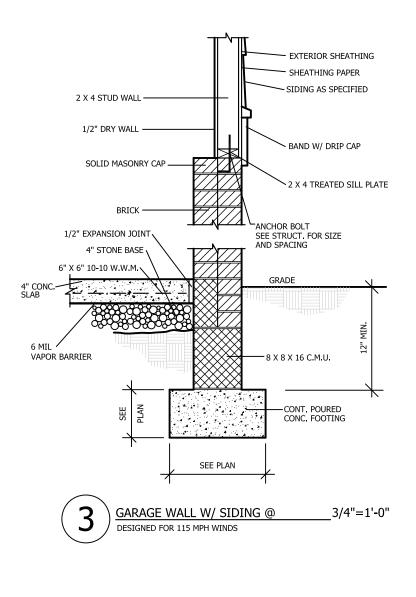


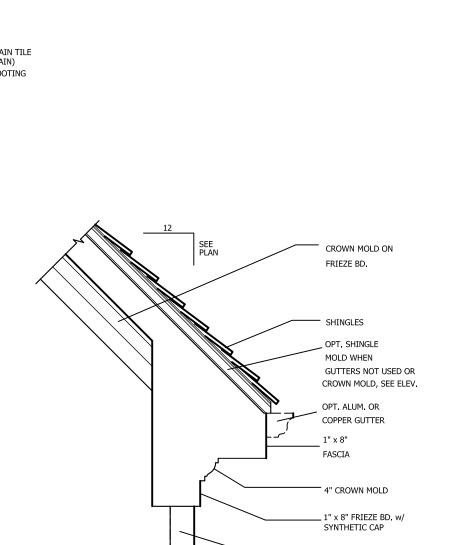

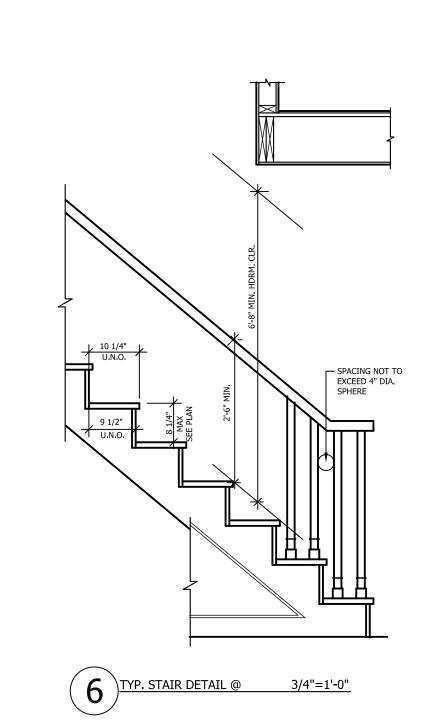

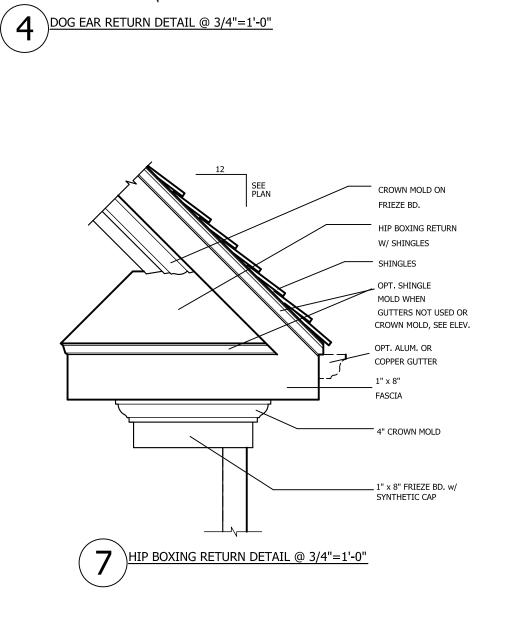

\_\_\_\_ 5/4" X 4" TRIM BOARD

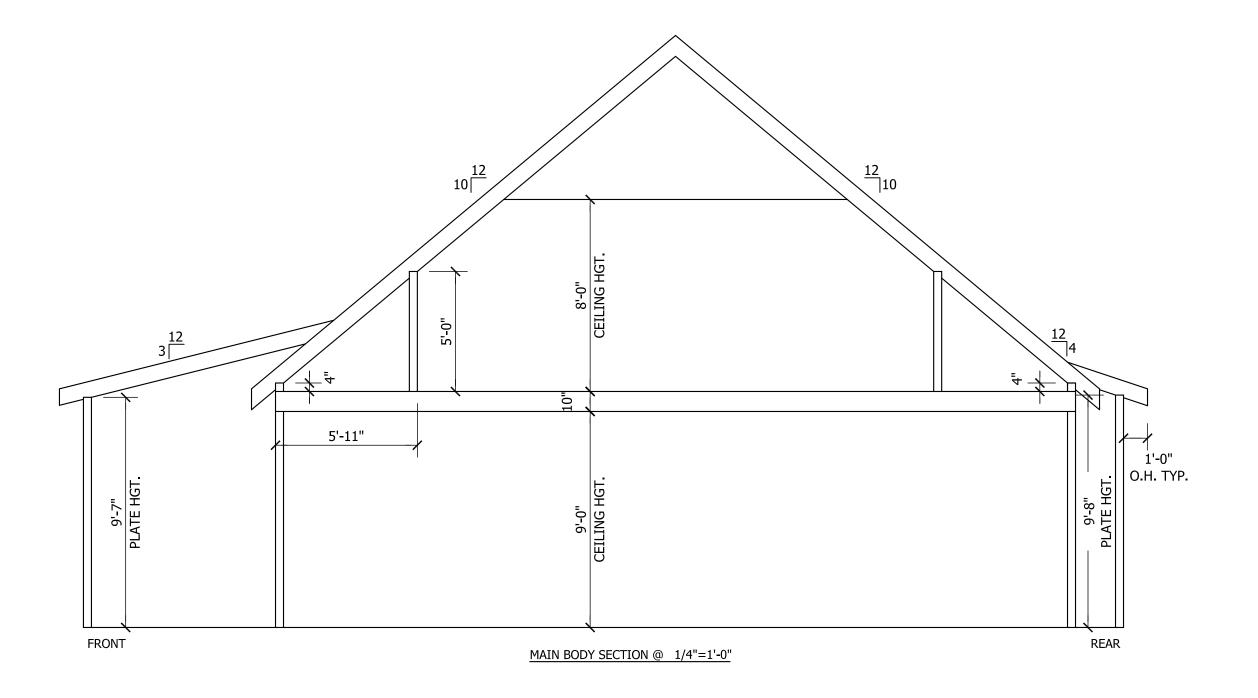


## **AREA CALCULATIONS**

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_		BRICK:	N/A	OVERALL DIMENSION			
TOTAL:	2821	TOTAL:	1083	WIDTH:	69'-4"		
(HEATED)		(UNHEATED)		DEPTH:	57'-10"		

COMPONENT & CLADDING DESIGNED FOR THE FOLLOWING LOADS

MEAN POOF HEIGHT - LIP TO 30' - 30'-1" - 35' - 35'-1" - 40' - 40'-1" -

	33 3.12.				
MEAI	N ROOF HEIGHT	UP TO 30'	30'-1" - 35'	35'-1" - 40'	40'-1" - 45'
	ZONE 1	16.5, -18.0	17.3, -18.9	18.0, -19.6	18.5, -20.2
	ZONE 2	16.5, -21.0	17.3, -22.1	18.0, -22.9	18.5, -23.5
	ZONE 3	16.5, -21.0	17.3, -22.1	18.0, -22.9	18.5, -23.5
	ZONE 4	18.0, -19.5	18.9, -20.5	19.6, -21.3	20.2, -21.8
	ZONE 5	18.0, -24.1	18.9, -25.3	19.6, -26.3	20.2, -27.0

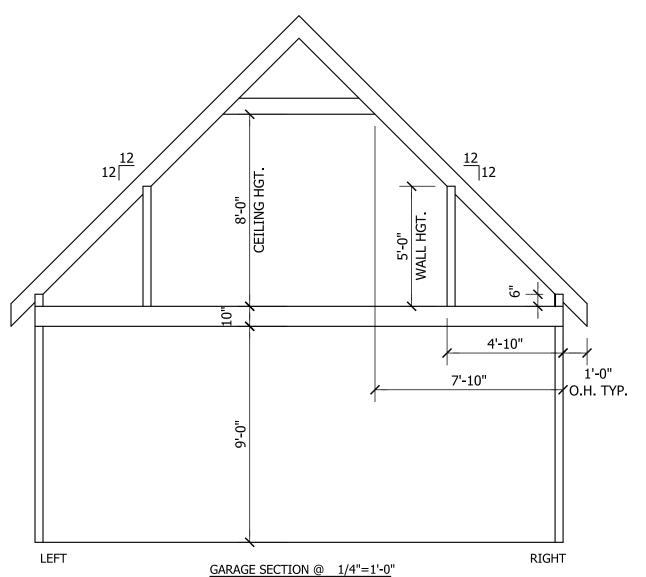

## FOUNDATION VENT CALCS.

2429 SQ.

2429 SQ. FT. 150 16.19 SQ. FT.

= 16.19 SQ. FT. VENT REQ'D.= 29 VENTS TO BE PROVIDED

NOTE: FIGURE BASED ON SECTION R-409 OF THE 2018 IRC. NOTE: FND VENT SPECS BASED ON PUSH/PULL POLYPROPYLENE FND. VENT THAT ALLOWS 72 SQ. IN. OF NET FREE AREA PER VENT.

- WHERE CONTINOUS OPERATED MECHANICAL VENTILATION IS PROVIDED AT A RATE OF 1.0 CFM FOR EACH 50 SQ. FT. OF CRAWL
- THE CRAWL SPACE IS SUPPLIED WITH CONDITIONED AIR AND THE PERIMETER WALLS ARE INSULATED IN ACCORDANCE WITH SECTION R409 OF THE 2018 IRC.
- BUILDER/OWNER TO VERIFY VENT SIZE AND REQUIREMENTS PRIOR TO CONSTRUCTION.
  SEE SECTION R409 OF THE 2018 IRC.

# ROOF VENTILATING REQUIREMENTS

 $\frac{3383}{150}$  SQ.FT. =  $\underline{22.55}$  SQ. FT. OF TOTAL ROOF VENTILATION REQ'D

280'-4" (LINEAR FT. OF SOFFIT) X = 9.81 SQ. FT. OF AVAILABLE SOFFIT VENT .035 (NET FREE AREA PER FT.)

22.55 -9.81 =  $\underline{12.74}$  SQ.FT. REMAINING REQ'D ROOF VENTILATION  $\underline{12.74}$  SQ.FT.  $\underline{125}$  (NET FREE AREA PER FT.) =  $\underline{101.92}$  LINEAR FT. OF RIDGE VENT REQ'D

NOTE: FIGURE BASED ON SECTION R-806 OF THE 2018 IRC.

NOTE: - SOFFIT VENT SPECS BASED ON HARDISOFFIT PANELS THAT ALLOWS
5 SQ. IN. OF NET FREE AREA PER LINEAR FT.

- RIDGE VENT SPECS BASED ON VENTURIVENT PLUS THAT ALLOWS
18 SQ. IN. OF NET FREE AREA PER LINEAR FT.

TOTAL NET FREE VENTILATING AREA IS PERMITTED TO BE REDUCED

- TO 1 TO 300:

  1 PROVIDED AT LEAST 50% AND NOT MORE THAN 80% OF THE REQ'D VENTILATING AREA IS PROVIDED BY VENTILATORS. REFERENCE R806.2 OF THE 2018 IRC. FOR PROPER LOCATION.
- WHEN AN APPROVED VAPOR BARRIER HAVING A TRANSMISSION RATE NOT EXCEDING 1 PERM IS INSTALLED ON THE WARM SIDE OF THE CEILING

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PROJECT:

LOT 1 MORGAN FARM

EPHENSON UILDERS INC.

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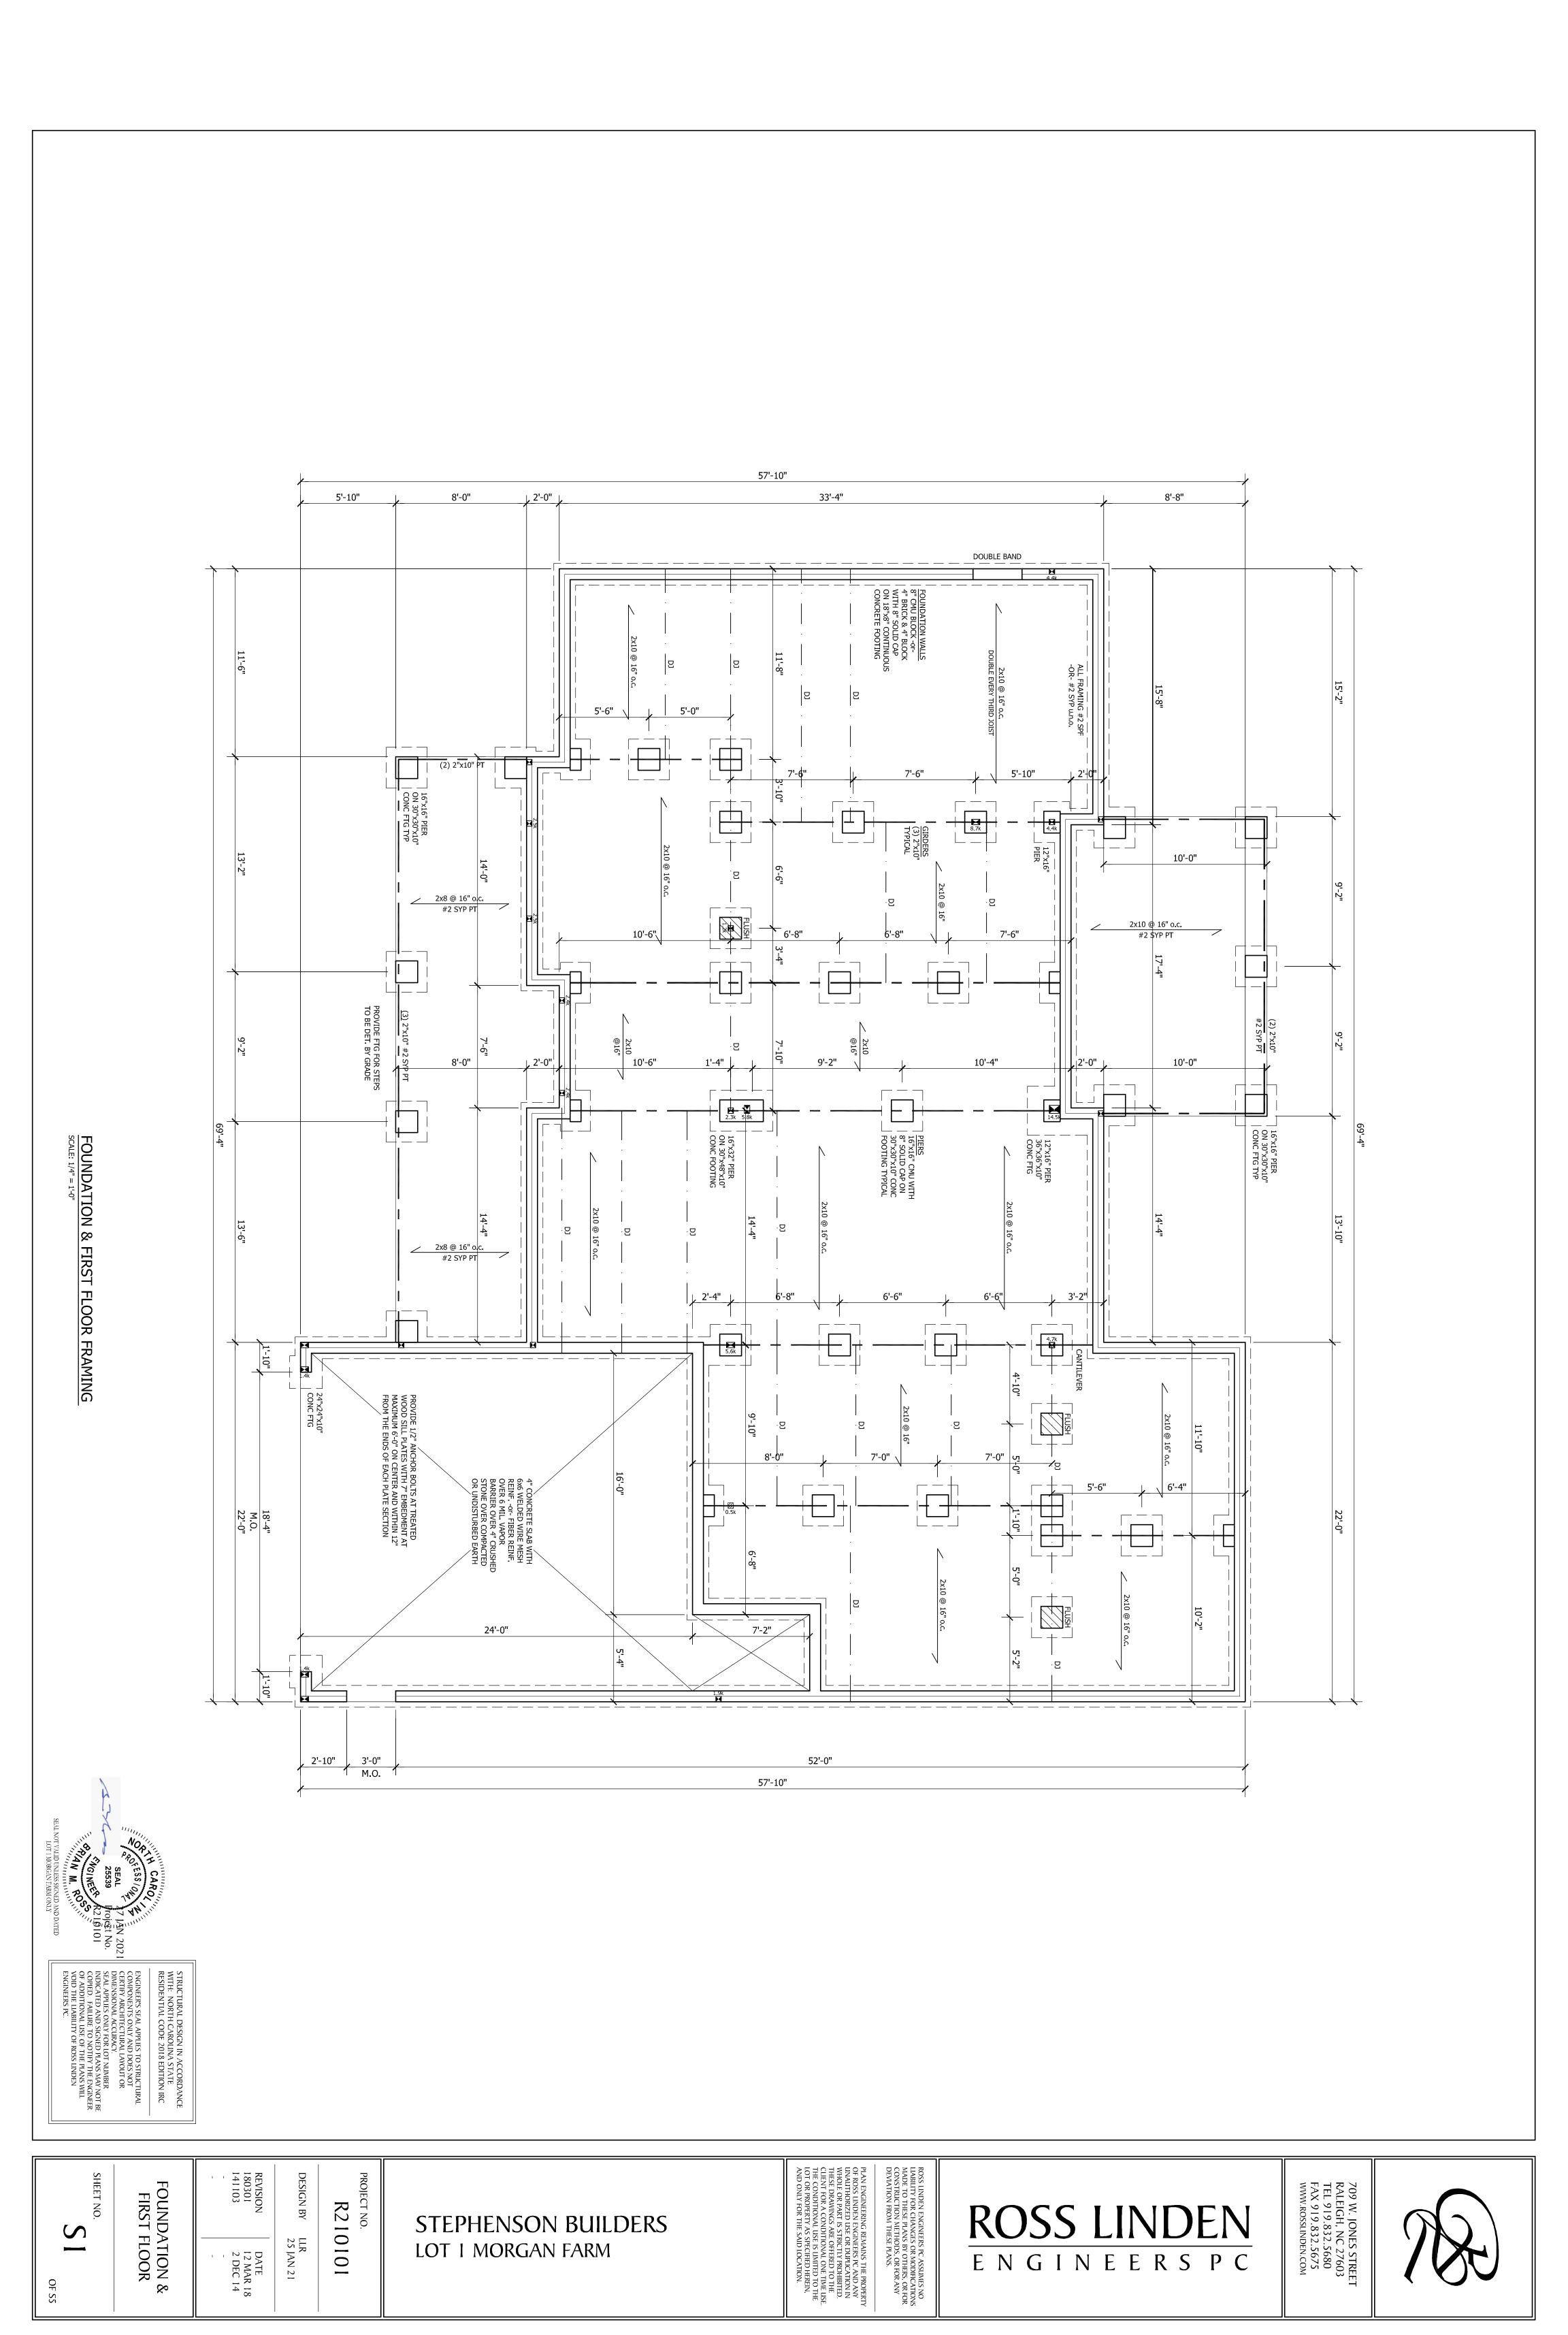
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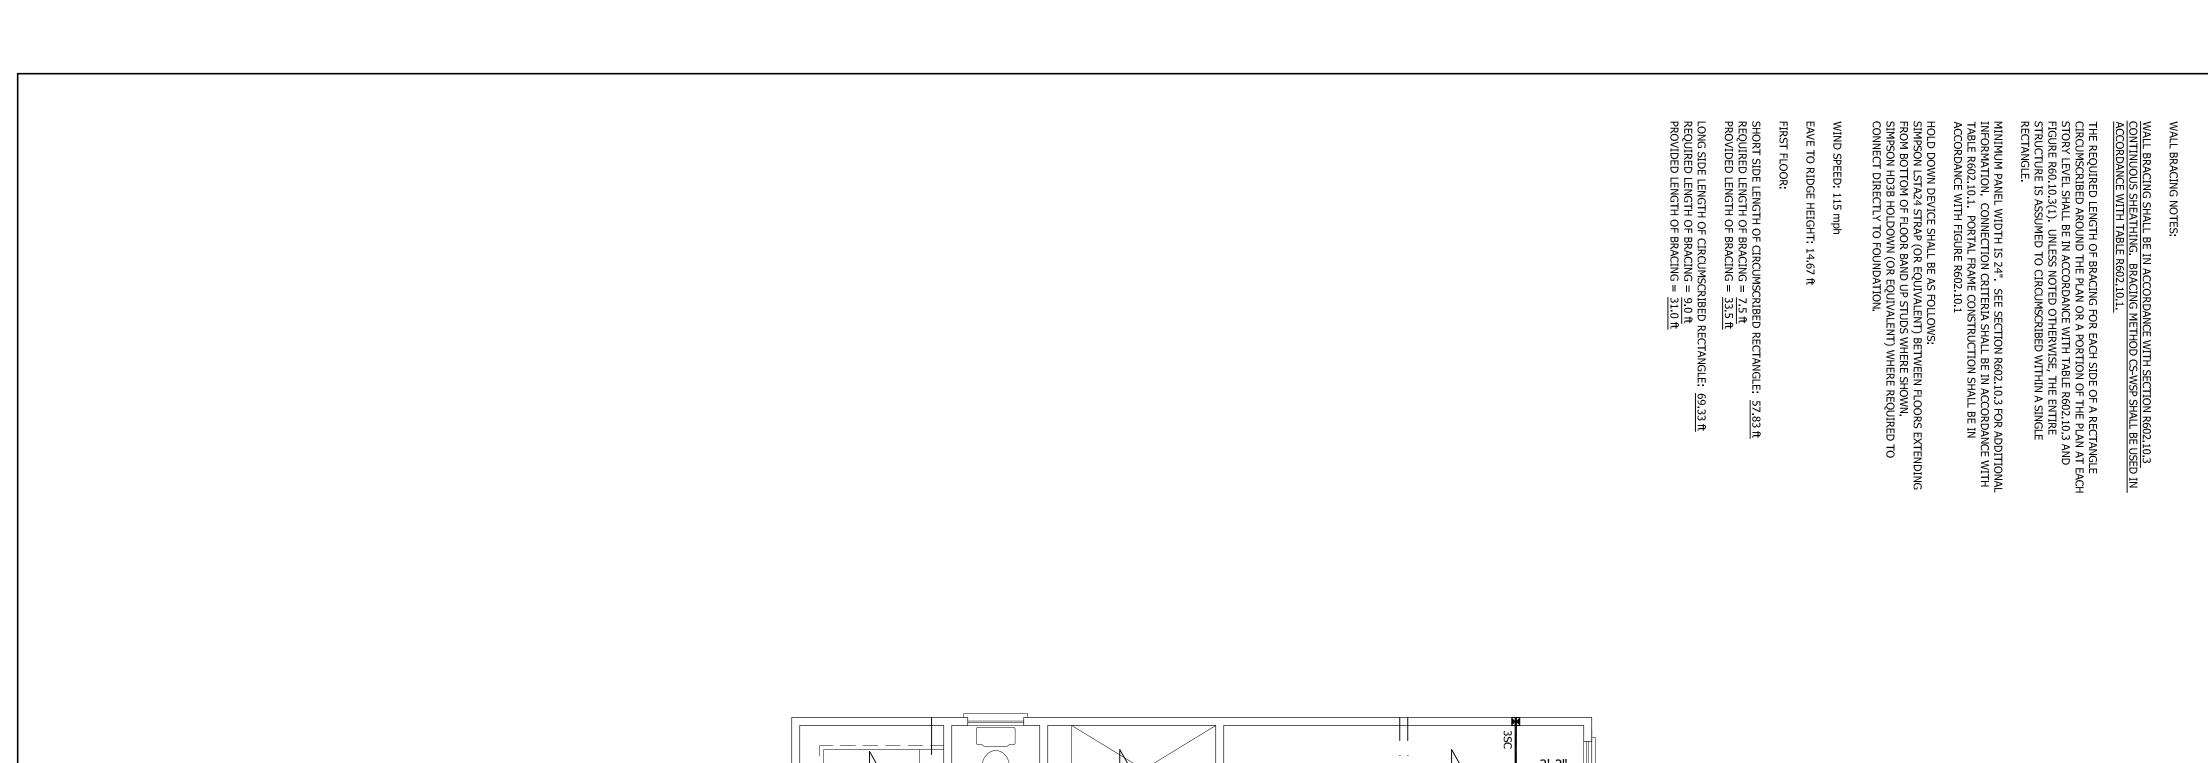
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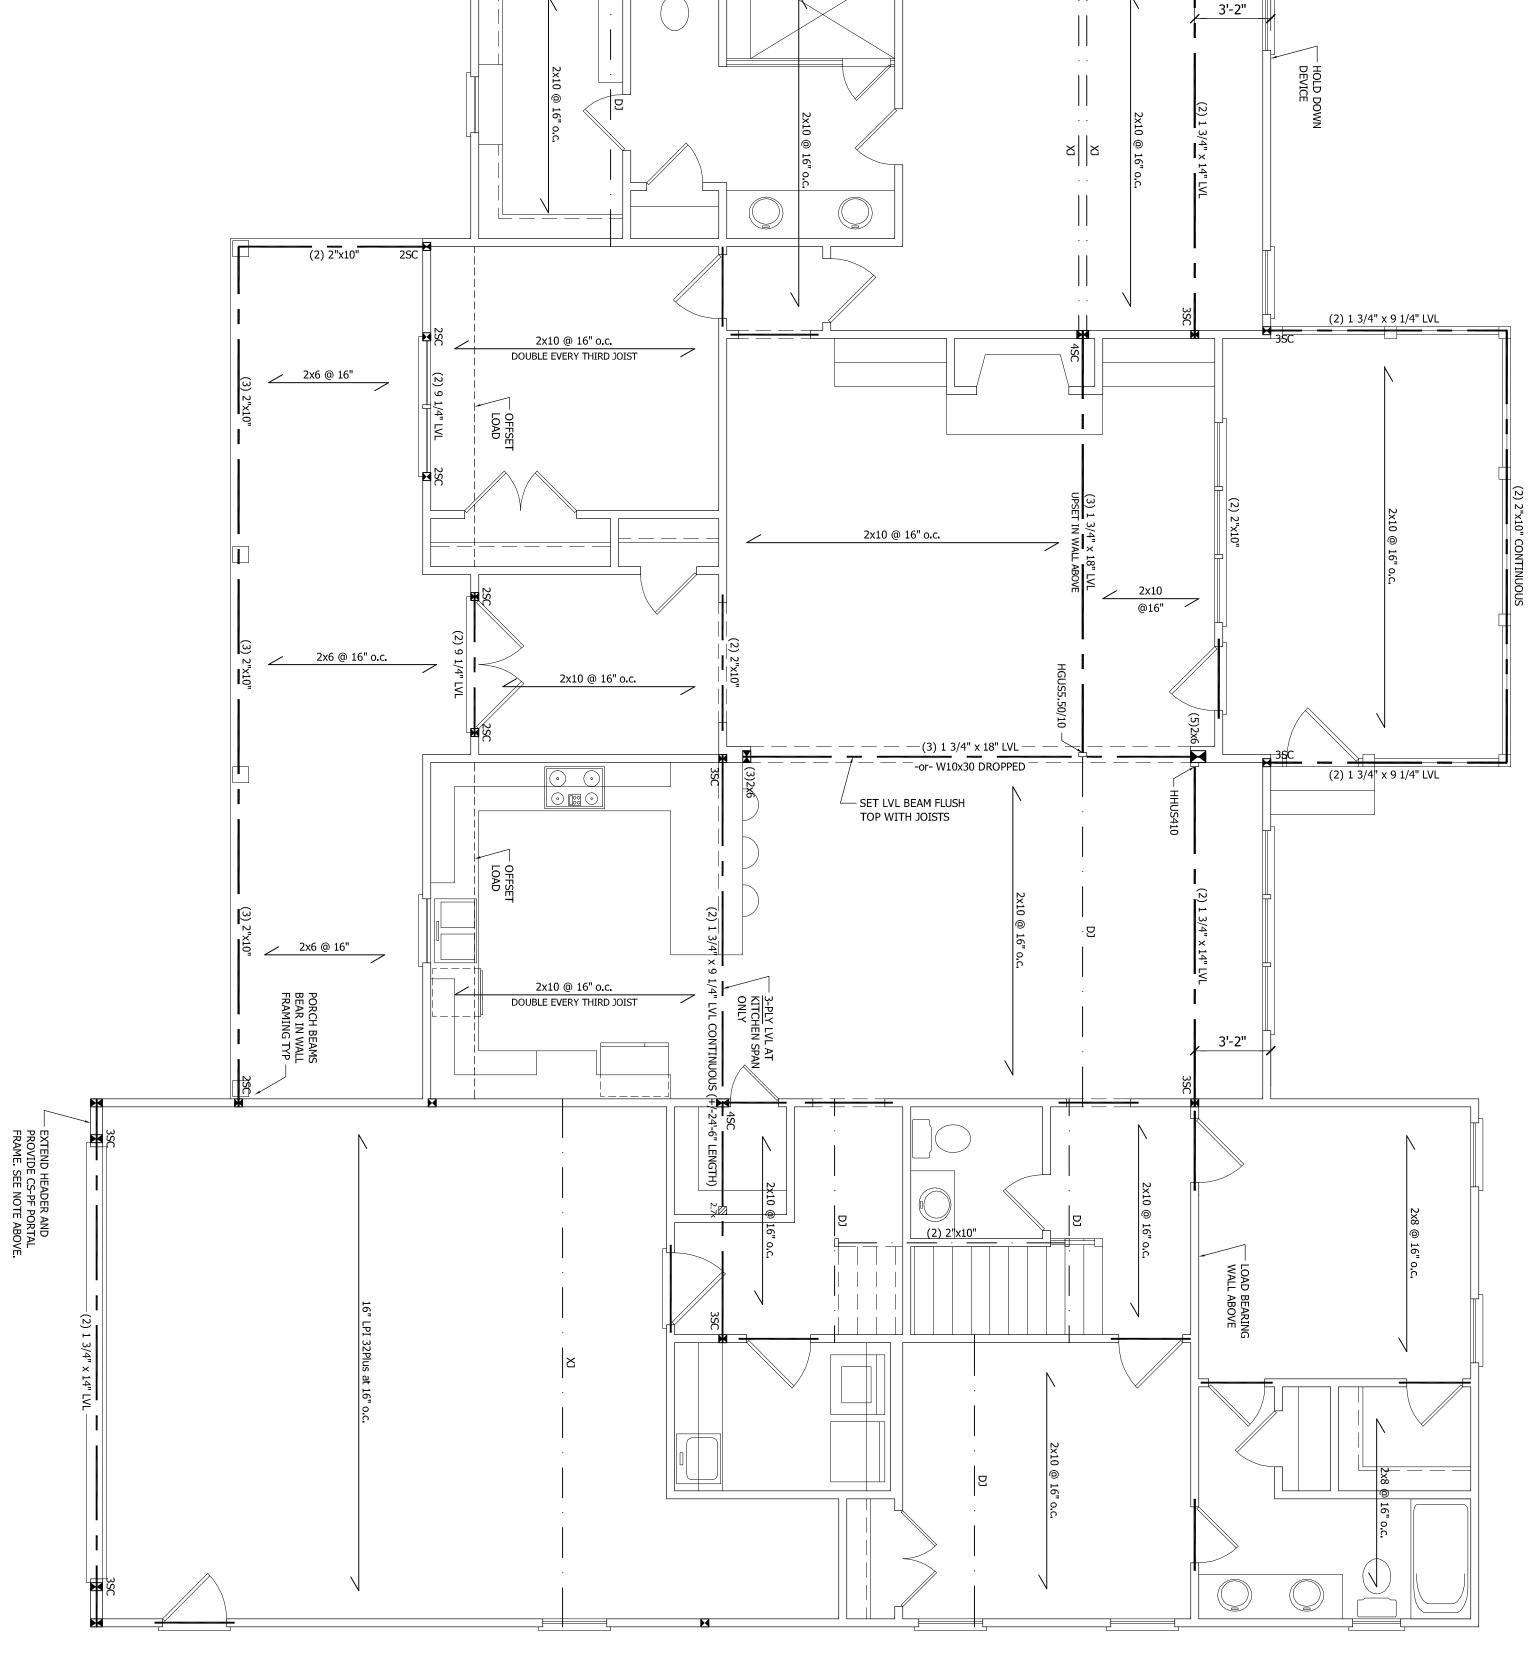
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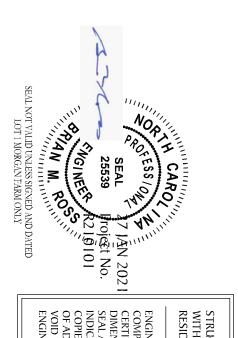
SHEET NO.

5









FIRST CEILING FRAMING
SCALE: 1/4" = 1'-0"

ENGINEER'S SEAL APPLIES TO STRUCTURAL COMPONENTS ONLY AND DOES NOT CERTIFY ARCHITECTURAL LAYOUT OR DIMENSIONAL ACCURACY.

SEAL APPLIES ONLY FOR LOT NUMBER INDICATED AND SIGNED PLANS MAY NOT BE COPIED. FAILURE TO NOTIFY THE ENGINEER OF ADDITIONAL USE OF THE PLANS WILL VOID THE LIABILITY OF ROSS LINDEN ENGINEERS PC.

STRUCTURAL DESIGN IN ACCORDANCE WITH: NORTH CAROLINA STATE RESIDENTIAL CODE 2018 EDITION IRC

FIRST CEILING FRAMING

OF S5

REVISION 180301 141103

DATE 12 MAR 18 2 DEC 14

DESIGN BY

LLR 25 JAN 21

R210101

PROJECT NO.

ROSS LINDEN ENGINEERS PC ASSUMES NO LIABILITY FOR CHANGES OR MODIFICATIONS MADE TO THESE PLANS BY OTHERS, OR FOR CONSTRUCTION METHODS, OR FOR ANY DEVIATION FROM THESE PLANS.

ROSS LINDEN ENGINEERSPC 709 W. JONES STREET RALEIGH, NC 27603 TEL 919.832.5680 FAX 919.832.5675 WWW.ROSSLINDEN.COM

FRAMING SYSTEM

JOIST LAYOUT AND PLACEMENT BY MANUFACTURER TO COINCIDE
WITH THE SUPPORT LOCATIONS SHOWN, JOISTS SHALL BE
DESIGNED FOR MAXIMUM L/480 LIVE LOAD DEFLECTION, JOIST
LAYOUT SHALL BE PROVIDED FOR REVIEW AND COORDINATED
WITH THE ENGINEER OF RECORD,
INSTALLATION SHALL BE IN ACCORDANCE WITH THE
MANUFACTURER'S INSTRUCTIONS.

EXTEND HEADER AND PROVIDE CS-PF PORTAL FRAME PANEL PER FIG. R602.10.1. PROVIDE LSTA24 STRAP (OR EQUIVALENT) EACH SIDE AS SHOWN. FASTEN SHEATHING TO HEADER AND WALL FRAMING (EACH STUD) WITH 8d NAILS AT 3" o.c. AS SHOWN. SEE FIG. R602.10.1 FOR ADDITIONAL REQUIREMENTS. SEE SHEET S5 FOR DETAIL.


2. FRAMING SHALL BE #2 SPF OR #2 SYP u.n.o.
3. EXTERIOR AND BEARING HEADERS (2) 2"x10" u.n.o.

4. ■ DENOTES POINT LOAD. SEE CONSTRUCTION NOTE #4 ON S5.

1. STRUCTURAL NOTES SHEET S5.

FRAMING NOTES

STEPHENSON BUILDERS

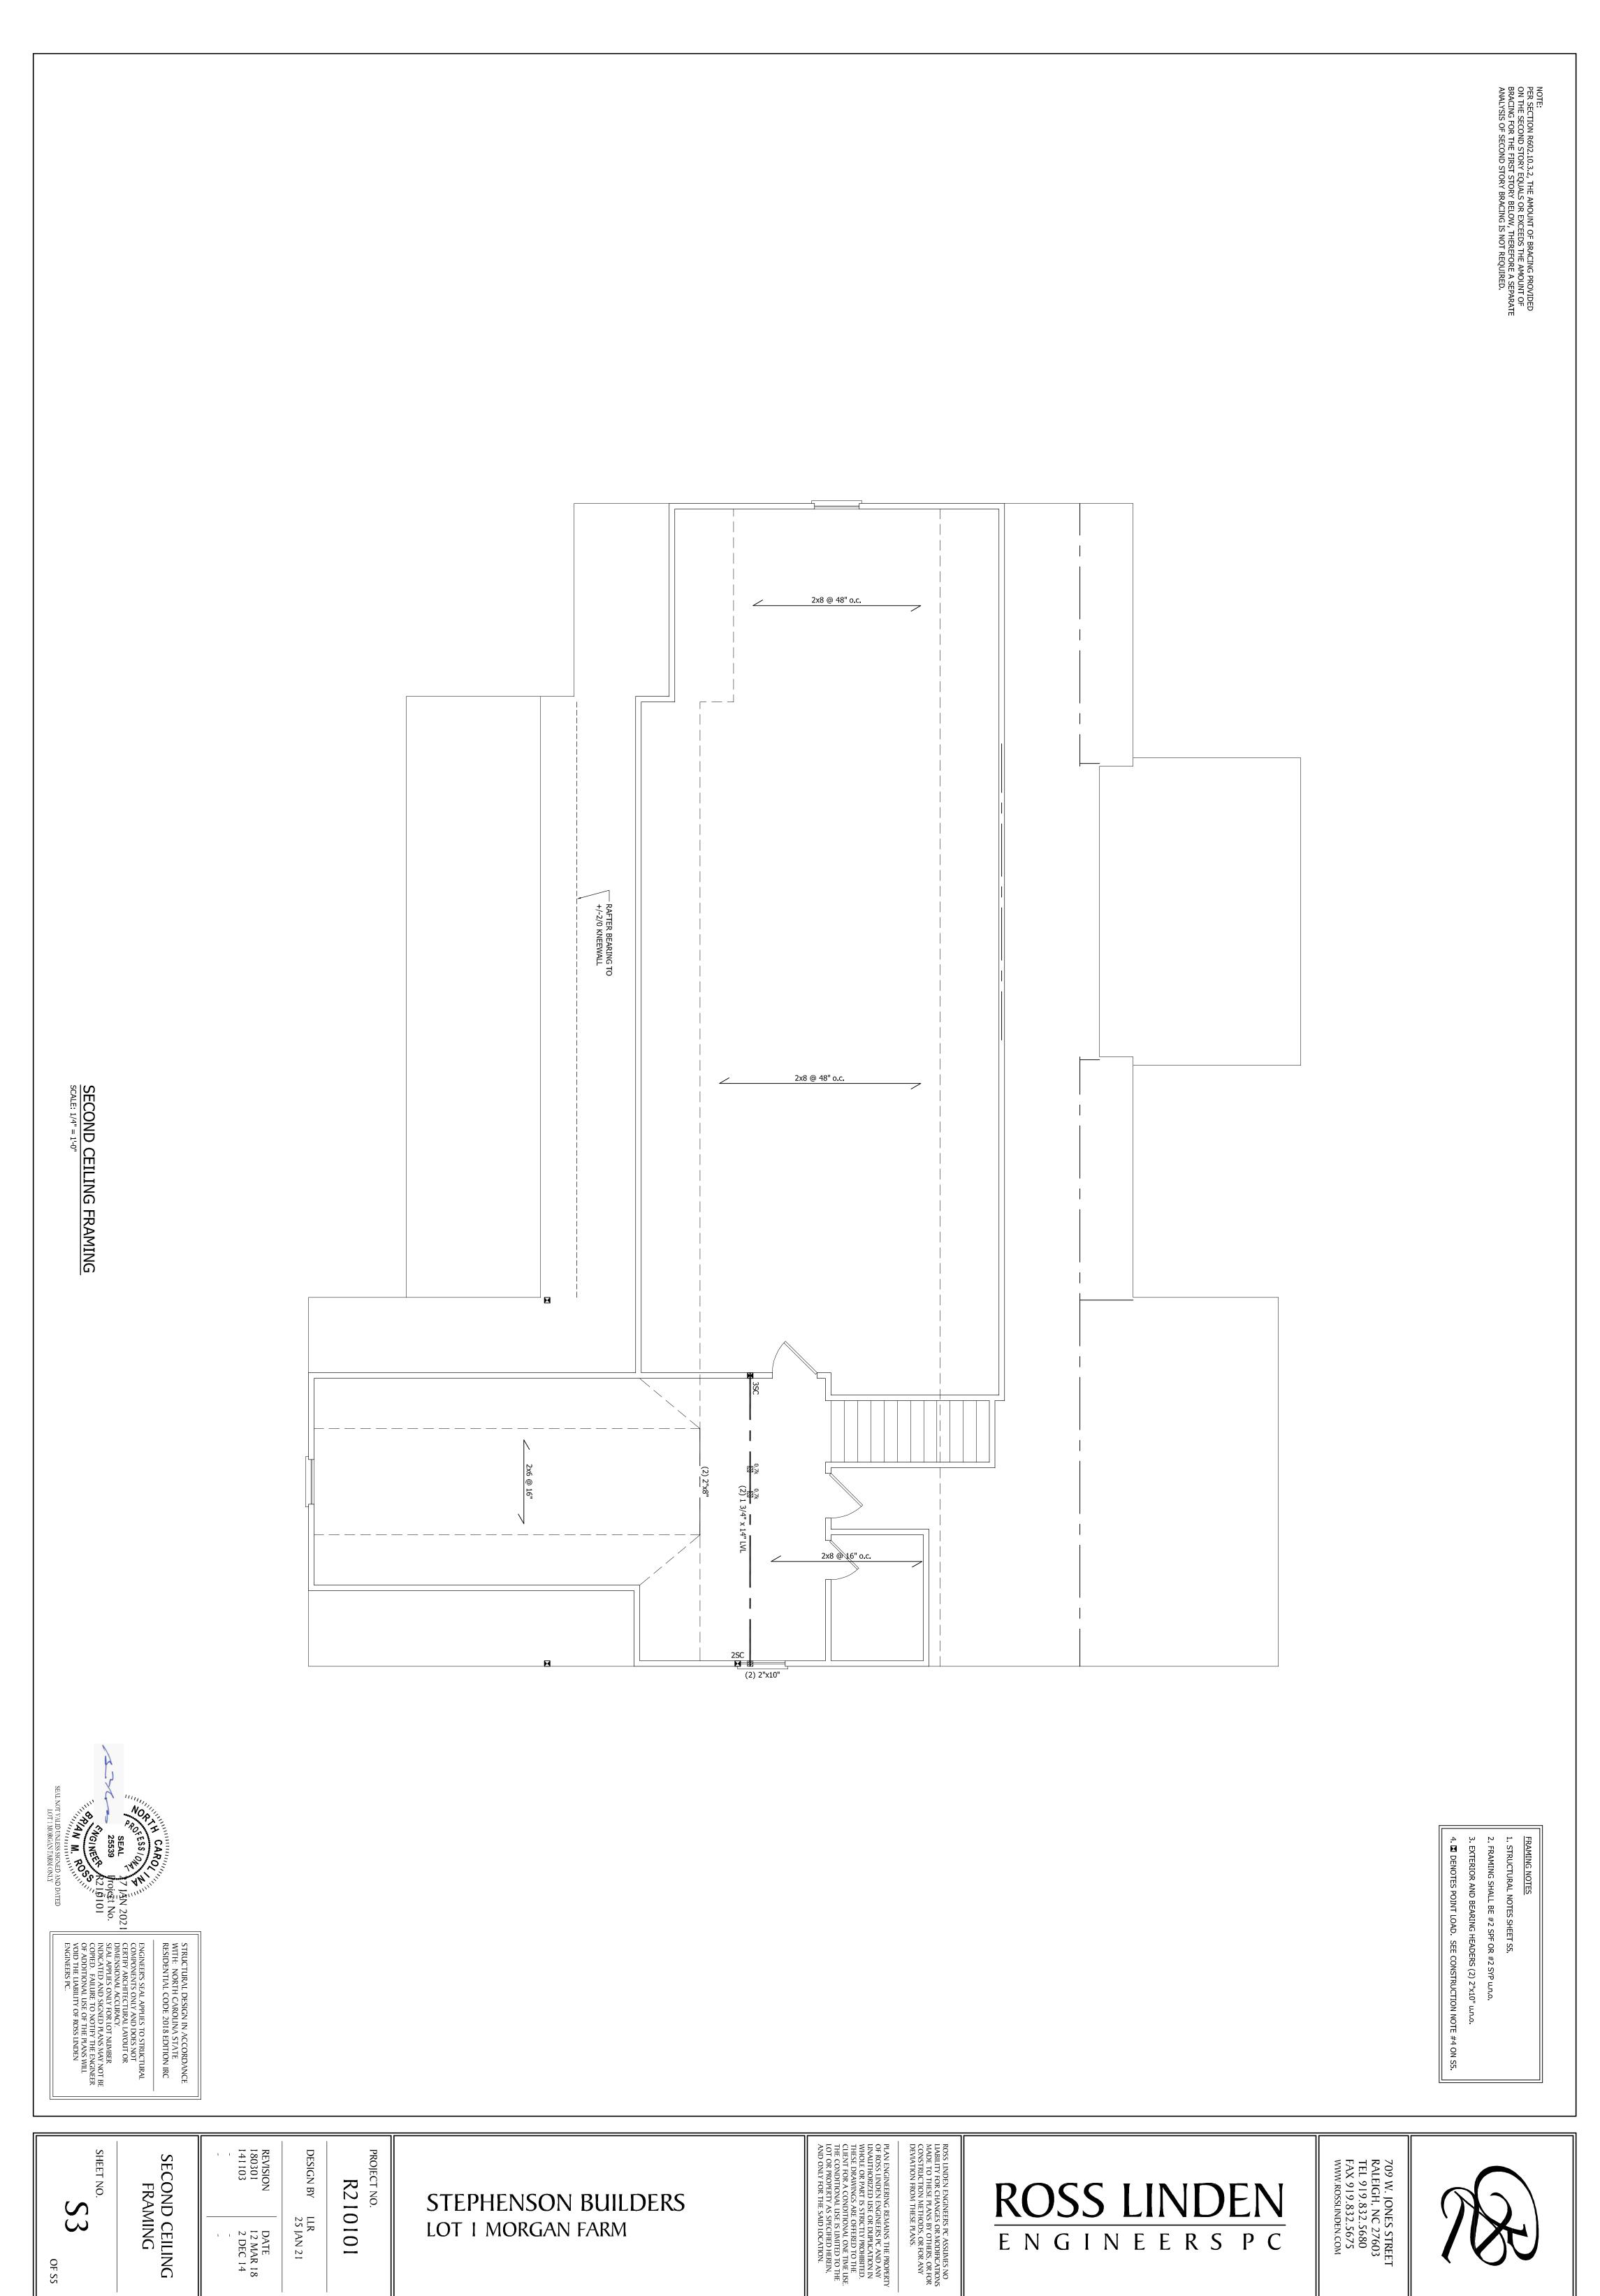


R210101

LLR 25 JAN 21

DATE 12 MAR 18 2 DEC 14

OF S5

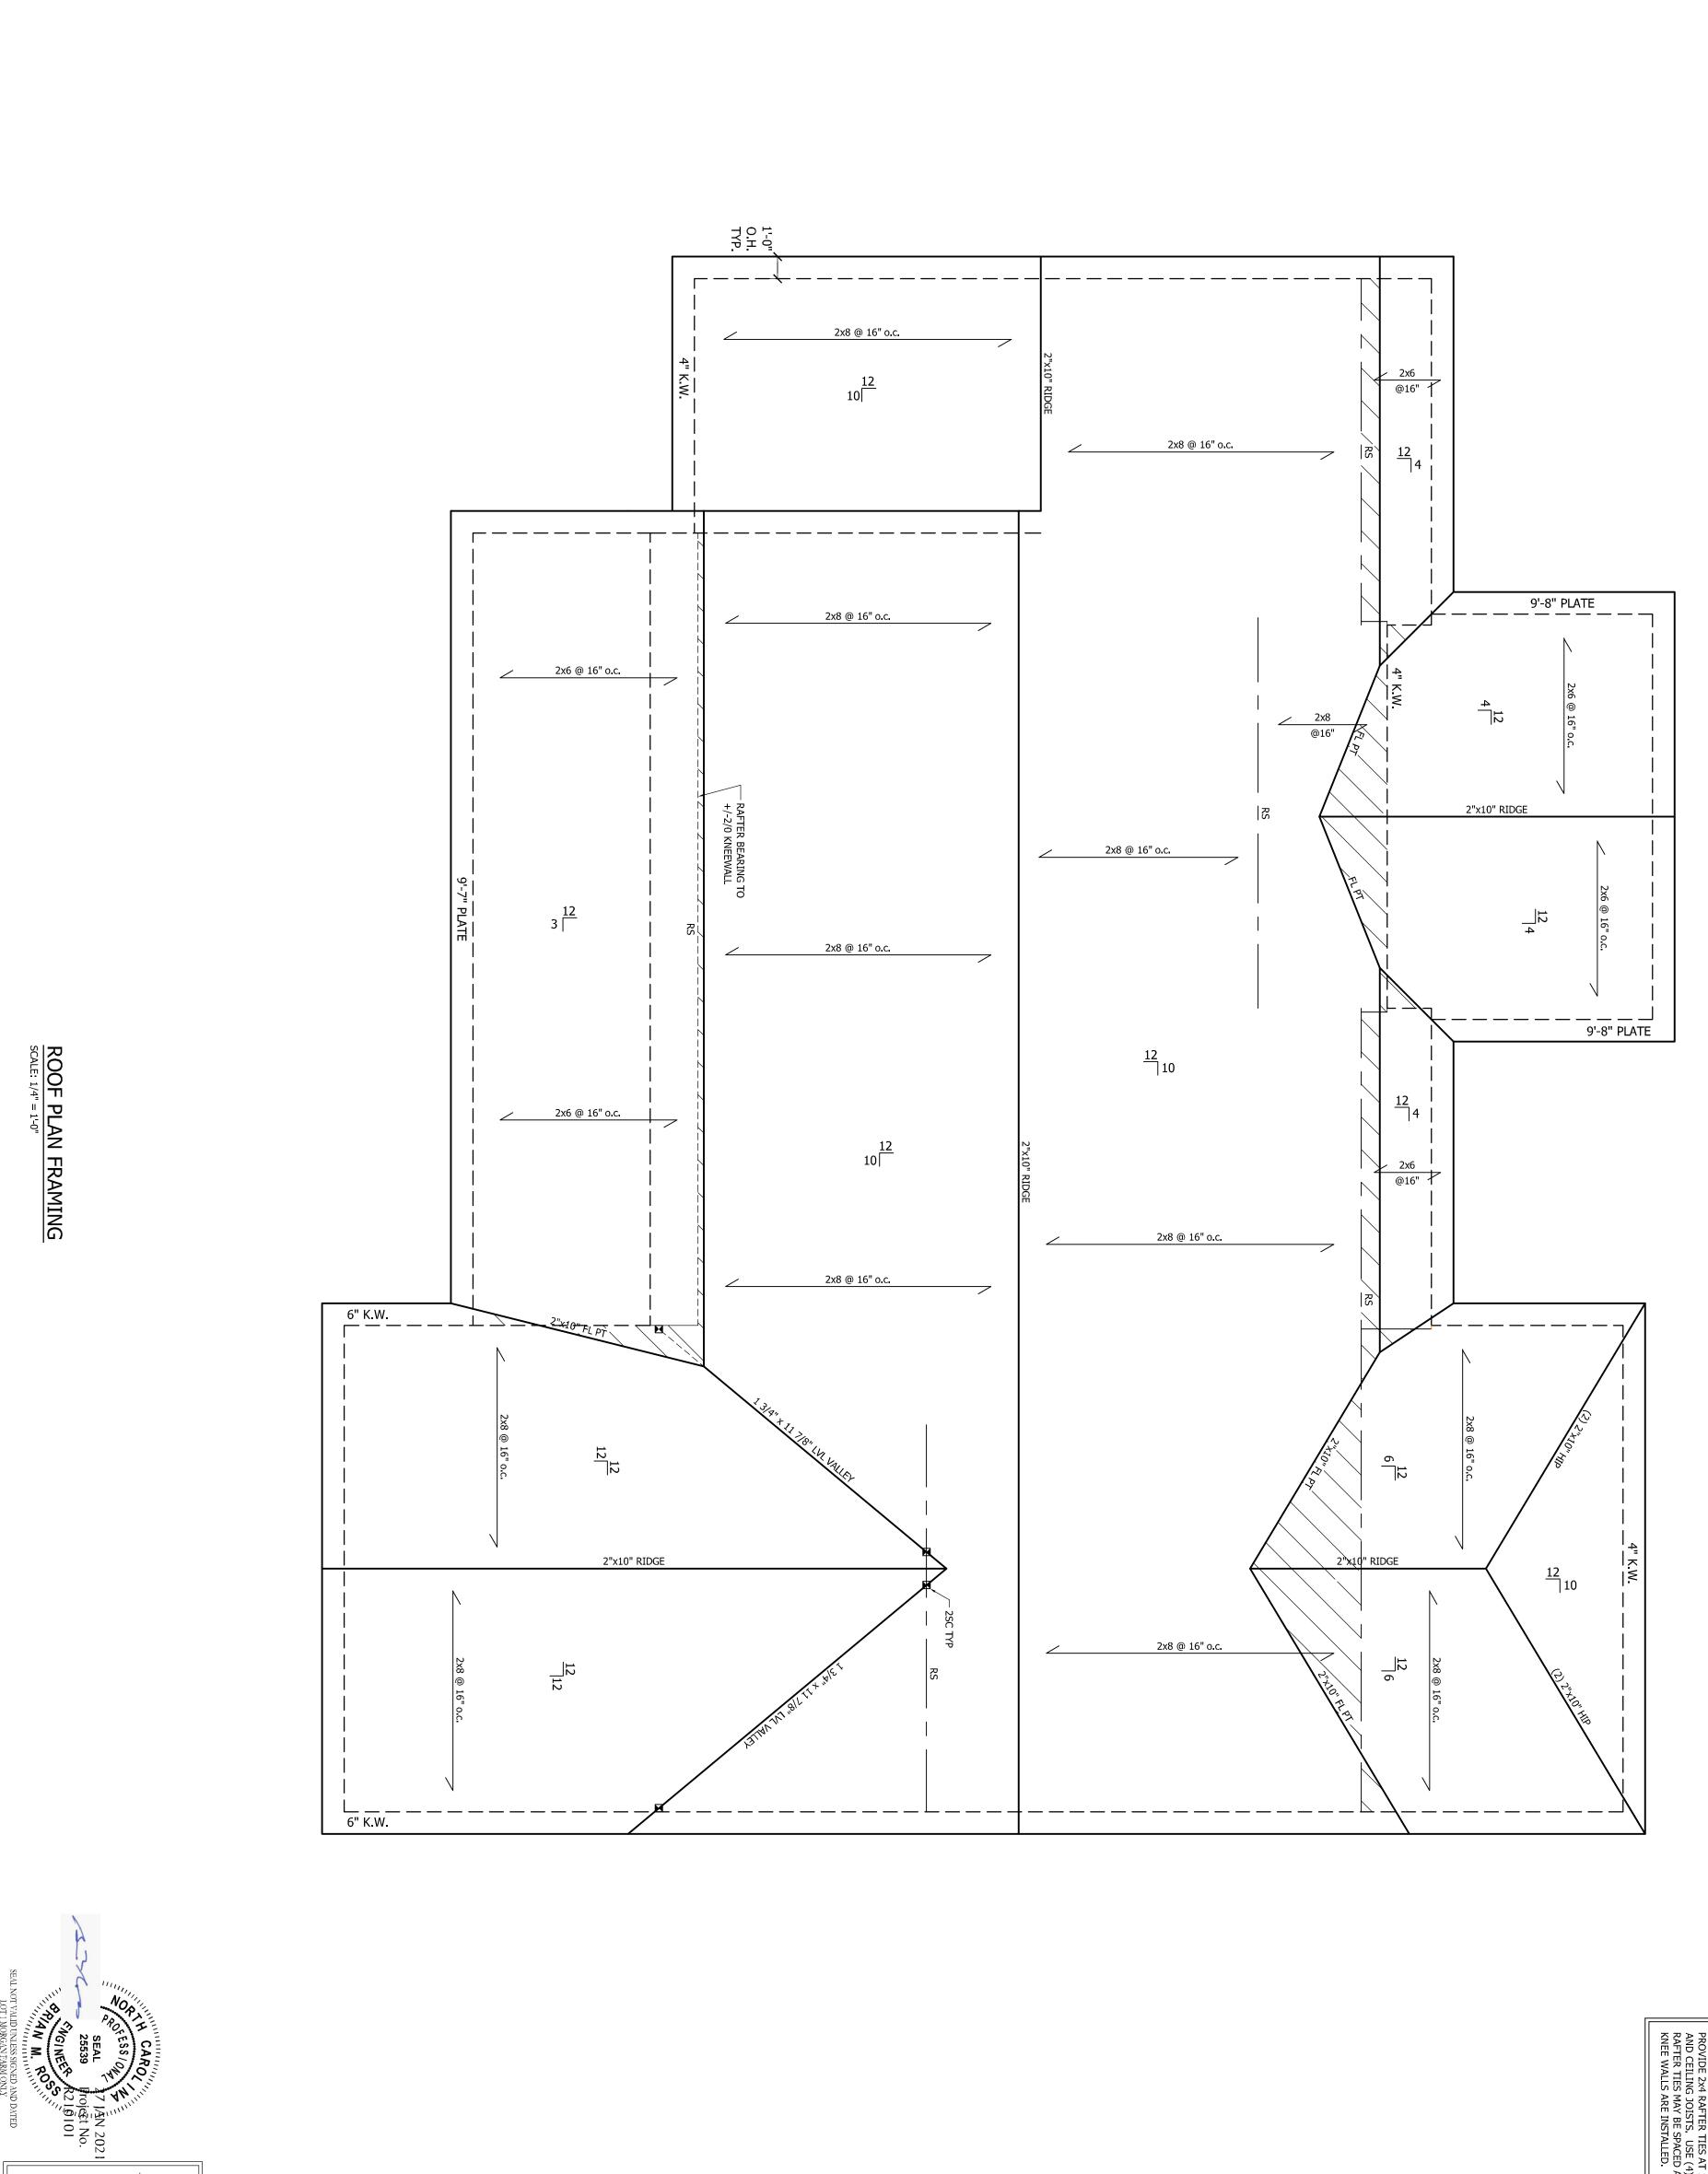

1. STRUCTURAL NOTES SHEET S5.

2. FRAMING SHALL BE #2 SPF OR #2 SYP u.n.o.

3. PROVIDE 2x4 COLLAR TIES AT 48" o.c. AT UPPER THIRD OF RAFTERS u.n.o. ON PLAN.

4. FUR RIDGES FOR FULL RAFTER CONTACT

5. DENOTES POINT LOAD. SEE CONSTRUCTION NOTE #4 ON S5.

6. DENOTES OVERFRAMED AREA

PROVIDE 2x4 RAFTER TIES AT 16" o.c. AT 45° BETWEEN RAFTERS AND CEILING JOISTS. USE (4) 16d NAILS AT EACH CONNECTION. RAFTER TIES MAY BE SPACED AT 48" o.c. AT LOCATIONS WHERE NO KNEE WALLS ARE INSTALLED.

PROJECT NO.

R210101

DESIGN BY LLR
25 JAN 21

REVISION
180301
141103

ROOF PLAN
FRAMING

SHEET NO.

SHEET NO.

CONTROL OF STORM OF STORM

SHEET NO.

ROOF PLAN
FRAMING

SHEET NO.

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STRUCTURAL DESIGN IN ACCORDANCE WITH: NORTH CAROLINA STATE RESIDENTIAL CODE 2018 EDITION IRC


STEPHENSON BUILDERS LOT I MORGAN FARM ROSS LINDEN ENGINEERS PC ASSUMES NO LIABILITY FOR CHANGES OR MODIFICATIONS MADE TO THESE PLANS BY OTHERS, OR FOR CONSTRUCTION METHODS, OR FOR ANY DEVIATION FROM THESE PLANS.


PLAN ENGINEERING REMAINS THE PROPERTY OF ROSS LINDEN ENGINEERS PC AND ANY UNAUTHORIZED USE OR DUPLICATION IN WHOLE OR PART IS STRICTLY PROHIBITED. THESE DRAWINGS ARE OFFERED TO THE CUIENT FOR A CONDITIONAL ONE TIME USE. THE CONDITIONAL USE IS LIMITED TO THE LOT OR PROPERTY AS SPECIFIED HEREIN,

ROSS LINDEN
ENGINEERS PC

709 W. JONES STREET RALEIGH, NC 27603 TEL 919.832.5680 FAX 919.832.5675 www.rosslinden.com



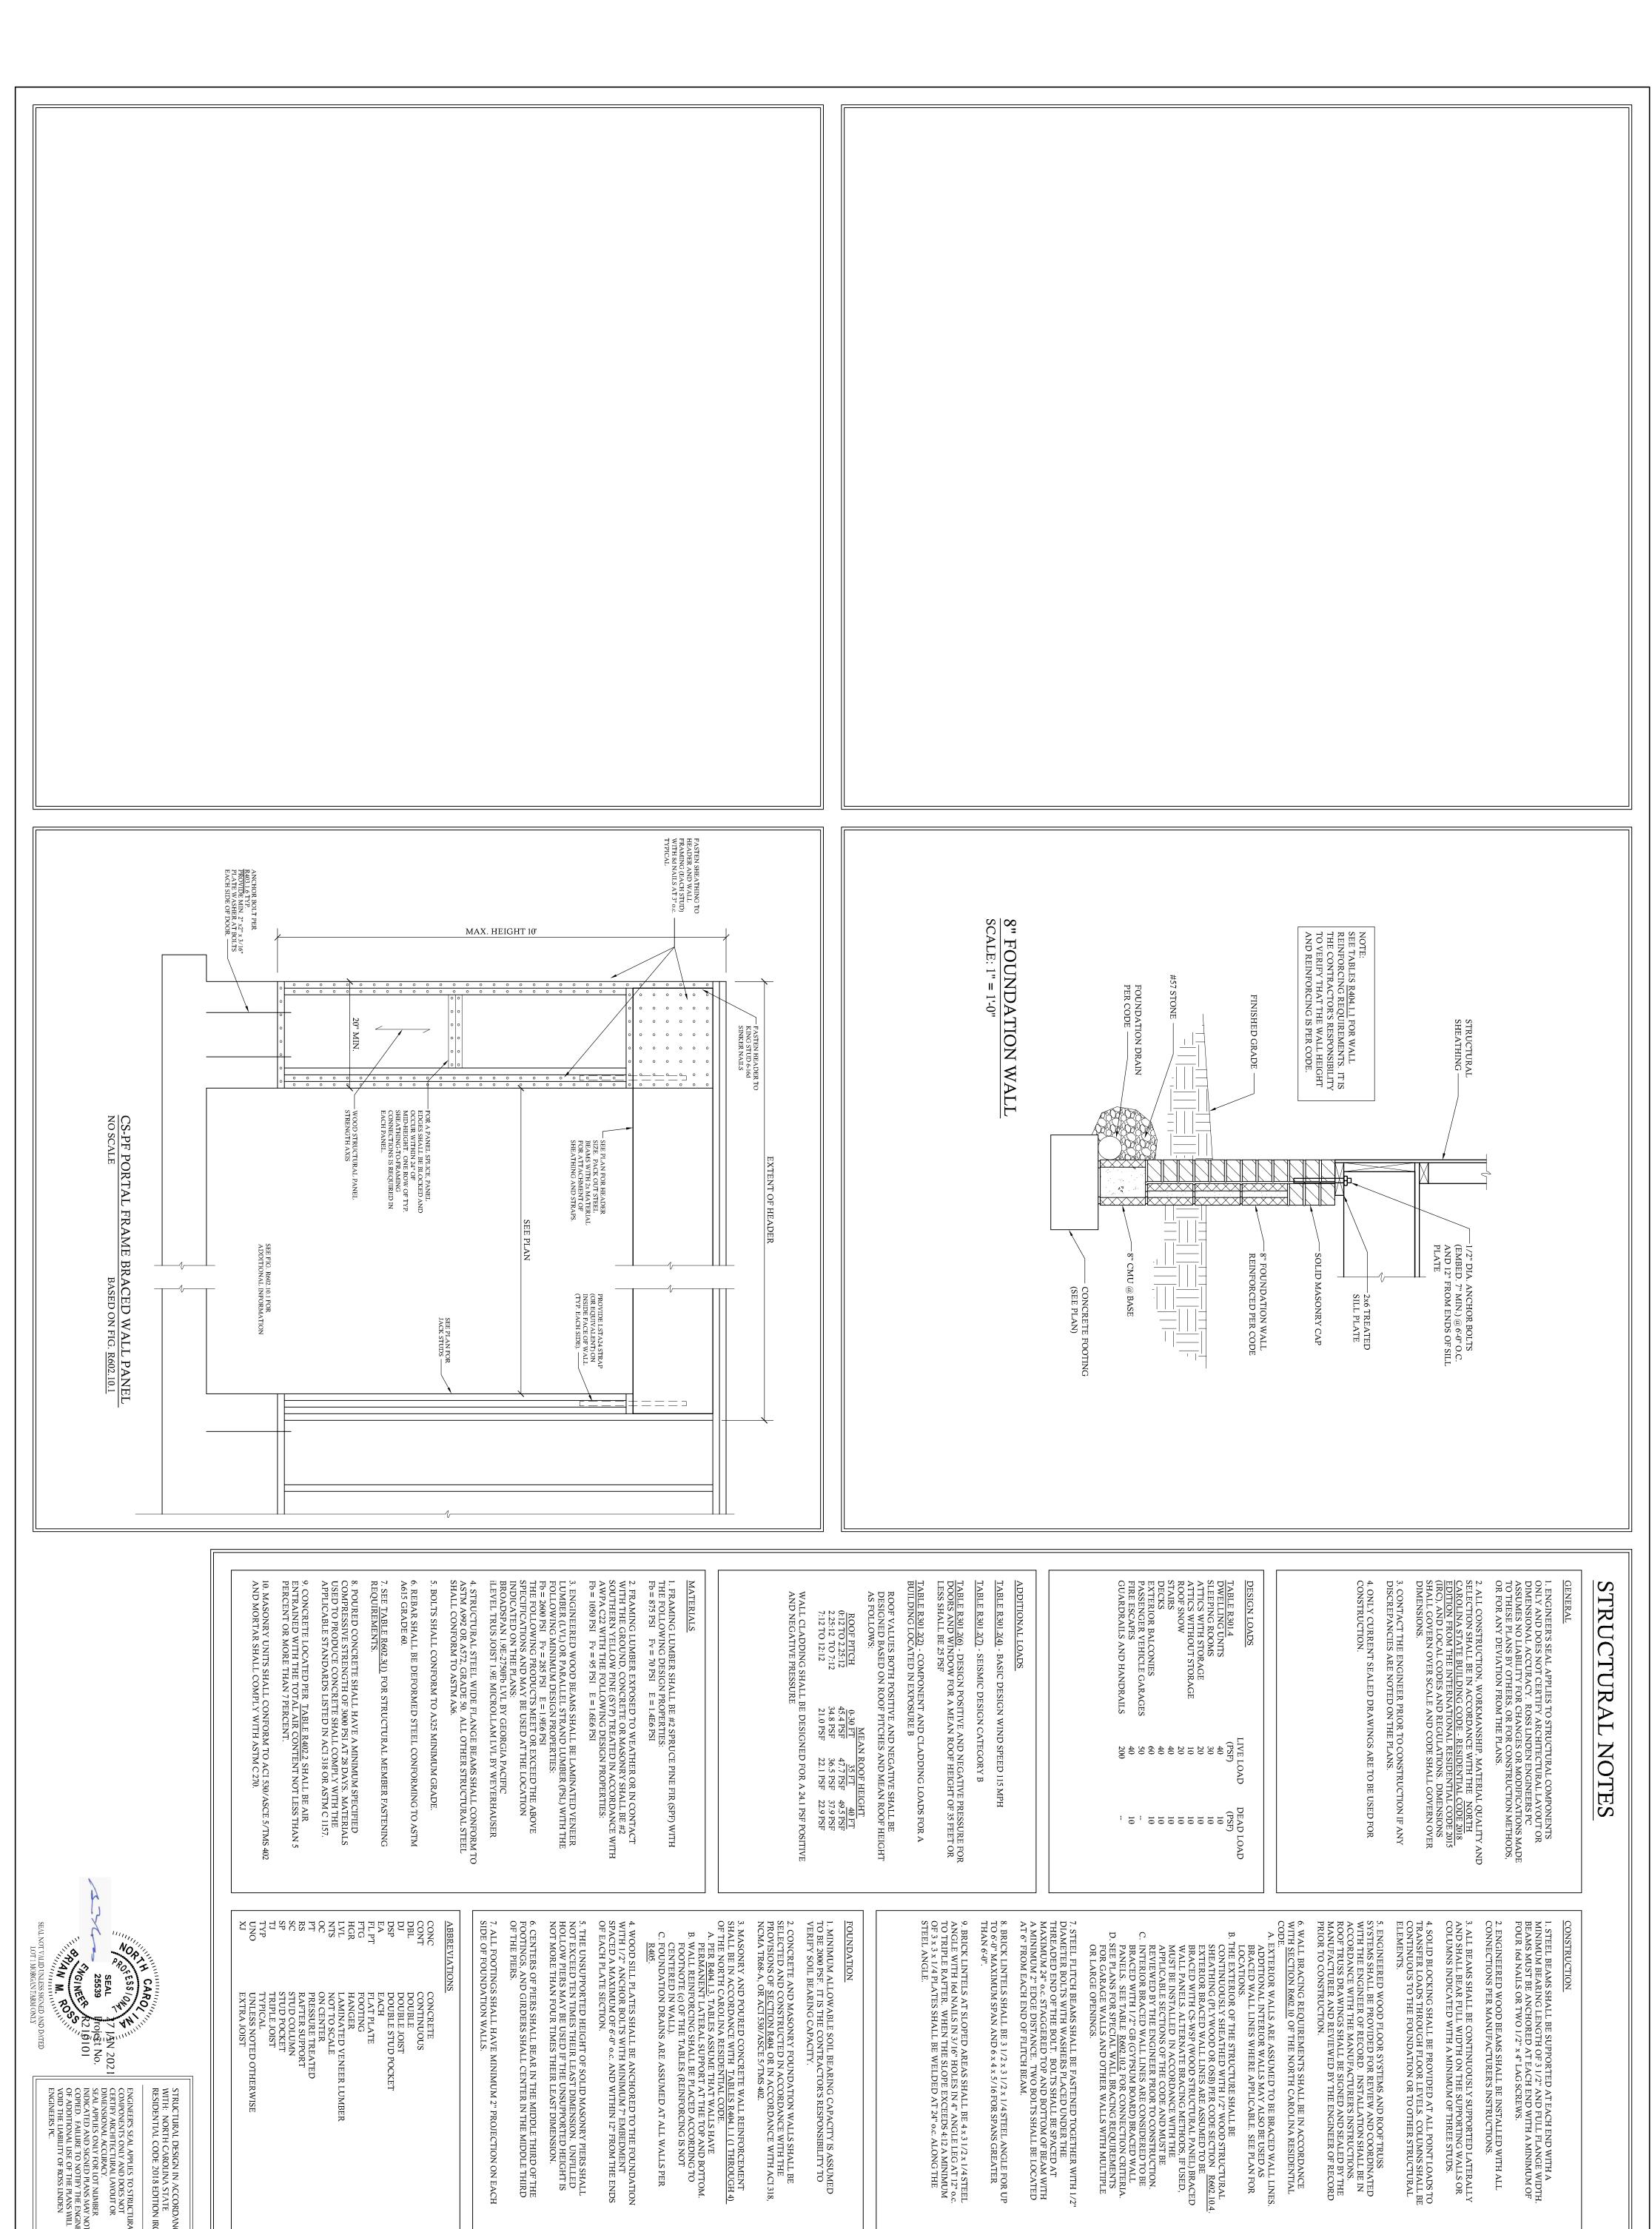

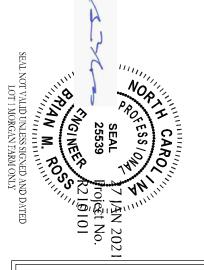

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> REVISION 180301 141103 DESIGN BY STRUCTURAL NOTES & DETAILS R2 10 10 1 LLR 25 JAN 21 DATE 12 MAR 18 2 DEC 14

PROJECT NO.

LOT I MORGAN FARM

ROSS LINDEN ENGINEERS PC ASSUMES NO LIABILITY FOR CHANGES OR MODIFICATIONS MADE TO THESE PLANS BY OTHERS, OR FOR CONSTRUCTION METHODS, OR FOR ANY DEVIATION FROM THESE PLANS.

ENGINEERS

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