Carriage Circle Lot 1162- 112 Spruce Hollow Circle, Spring Lake 28390 Harnett County Created: 12/7/2020

Elevation Euro Garage Left Fiber Cement Siding



2550 Capitol Drive Suite 105 Creedmoor, NC 27522 919-528-1347

# 2334 The Nicklaus II - LH

S	QUARE	FOOT	AGE		
	HERITAGE	EUROPEAN	HERITAGE FARMHOUSE		
	UNHEATED	HEATED	UNHEATED	HEATED	
FIRST FLOOR	0	971	0	971	
SECOND FLOOR	0	1363	0	1363	
REAR COVERED PORCH	50	0	50	0	
FRONT PORCH	120	0	120	0	
GARAGE	472	0	472	0	
SUBTOTALS	642	2334	642	2334	
			2976		
TOTAL UNDER ROOF	29	76	29	76	
TOTAL UNDER ROOF	29	76	29	76	
	29 PTIONS	76	29	76	
			29	76	
	PTIONS		29	76	
	PTIONS UNHEATED S.F.	HEATED S.F.	29	76	
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FRONT PORCH	120	0	120	0	
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TOTAL UNDER ROOF	29	76	2976		
0	PTIONS				
	UNHEATED S.F.	HEATED S.F.			
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Α	RCHITECTURAL DRAWINGS
Sheet No.	Sheet Description
0.0	Cover Sheet
2.1	First Floor Plan
2.2	Second Floor Plan
3.A.0	Heritage European Front & Right Elevations
3.A.1	Heritage European Left & Rear Elevations
3.A.2	Heritage European Roof Plan
3.B.O	Heritage Farmhouse Front & Right Elevations
3.B.1	Heritage Farmhouse Left & Rear Elevations
3.B.2	Heritage Farmhouse Roof Plan
S.1.1	Crawl Foundation
S.1.2	Slab Foundation
S.2.1	Second Floor Framing
S.3.1	Attic Floor Framing
S.4.1	Roof Plan - Heritage European
S.4.2	Roof Plan - Heritage Farmhouse

	REVISION LOC	G				
Rev	Description	Drawn By	Date	Sheets Affected	Brochure Required	Engineering Required
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	2334 - THE NICNLAUS II - LA					t	( Nver Sheet	
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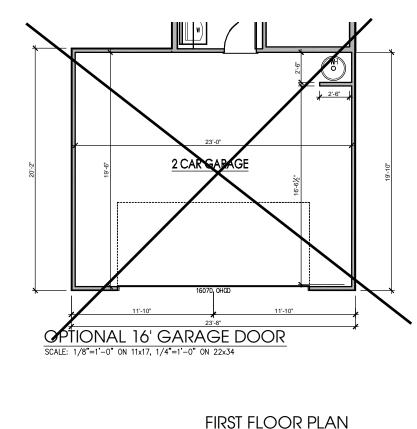
### **General Floor Plan Notes**


General Floor Plan Notes shall apply unless noted otherwise on plan.

- Wall Heights: Typically 10'-1-1/2' at first floor and second floor, and 9' 1-1/2' at attics U.N.O. All walls are constructed using a double top plate. Splices at Double Top Plate do not need to occur at Vertical Studs but must be at least 24' apart from Joint in other Top Plate layer. Special wall heights are noted on plans where they occur.
- 2. Wall Thickness is typically 4" at exterior walls, 3-1/2" at inherior. 2x6 frame shall be used at walls that back up to plumbing fixtures. Walls greater than 10" high shall be framed with 2x6 framing or greater and will be noted as a special condition where it occurs on plan.
- 3. Header height shall be 8'-0" AFF at First Floor, and 7'-6" AFF at Second Floor unless noted otherwise.
- Jacks: Openings up to 3'-4" wide shall have (1) 2x4 jack stud SPF on each side. Openings greater than 3'-4" wide shall have (2) 2x4 jack studs SPF on each side.
- Soffits, Coffered Ceilings, Trey Ceilings and other significant ceiling plan elements are shown on the floor plans and are denoted as single dashed lines. Unless specifically call out as included, Kitchens <u>de</u> <u>not</u> include soffits over wall cabinetry.
- 6. Door & Window Frames, where occurring near corners, shall be a minimum of 6' from corner. Except for walk-in closets with doors near a corner, doors at closets shall be centered on closet.
- Windows: Shall have at least (1) window in each sleeping room, that meets egress. Shall be provided with tempered glass th hazardous glazing areas. False windows shall be installed with obscure glazing.
- Closets for clothing or coat storage shall be equipped with 1 rod/shelf, open wire. Closets for linen shall have 5 open wire shelves. Closets for pantries shall have 5 wood shelves, painted.
- Stair treads shall be 10" deep, risers shall be a maximum of 7-3/4", unless noted otherwise.
- 10. Handrails and Guards at stairs shall be 34" above the linished surface of the ramp surface of the stair. Handrails at landings and overlooks of multilevel spaces shall be 36° above finished floor. Guards (pickets or balishers) shall be spaced with no more than 4" between guards.
- 11. Aftic Access shall be provided at all aftic area with a height greater than 30°. Minimum clear attic access shall be 20° x 30°. Puil down stairs and access dows in knew walls meeting minimum criteria are also acceptable.
- 12. Garage Door to Living Space shall be 2'-8" x 6'-8" minimum size and shall be 20 minute fire rated and weather sealed.
- 13. Garage Walls, as a minimum, shall be separated from living space and living space attic by installing 1/2" gypsum board on the garage side of the wall.

## SQUARE FOOTAGE HERITAGE EUROPEAN & FARMHOUSE


	UNHEATED S.F.	HEATED S.F.
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SECOND FLOOR	0	1363
FRONT PORCH	50	0
COVERED PORCH	120	0
GARAGE	472	0
TOTAL	642	2334
	OPTIONS	
	UNHEATED S.F.	HEATED S.F.



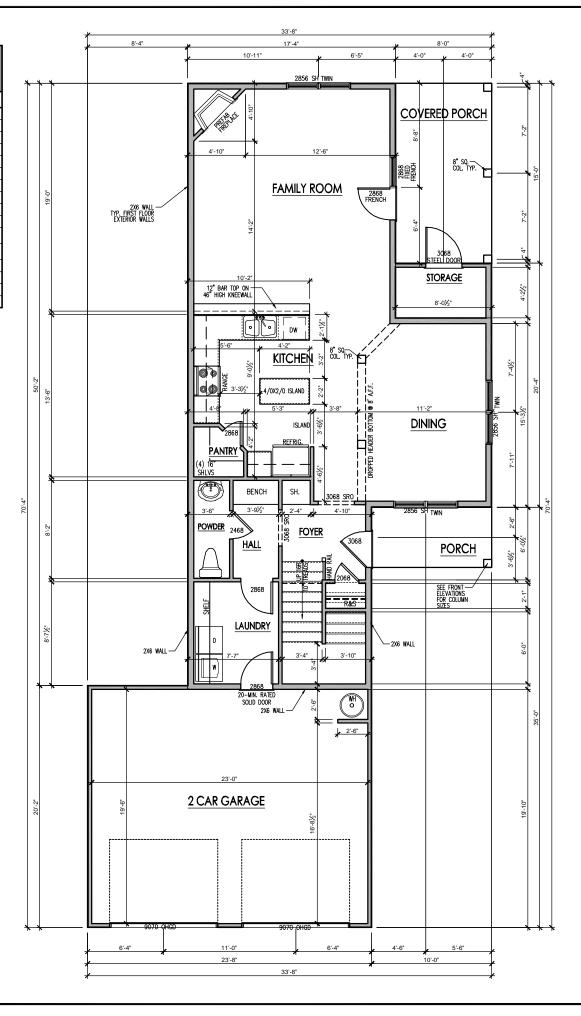

 FIRST FLOOR PLAIN


 SCALE:
 1/8"=1'-0"
 ON
 11x17,
 1/4"=1'-0"
 ON
 22x34

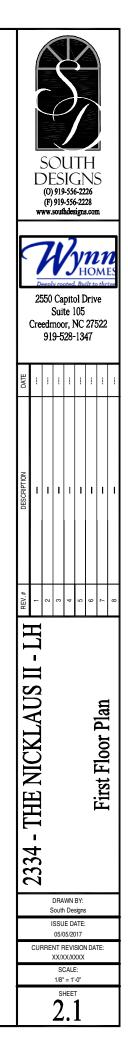

#### General Floor Plan Notes


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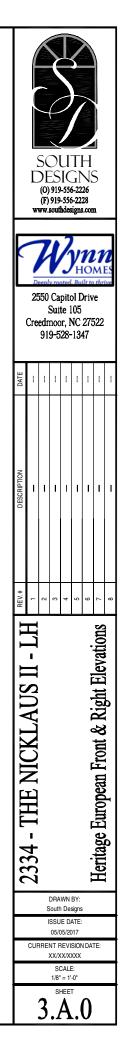
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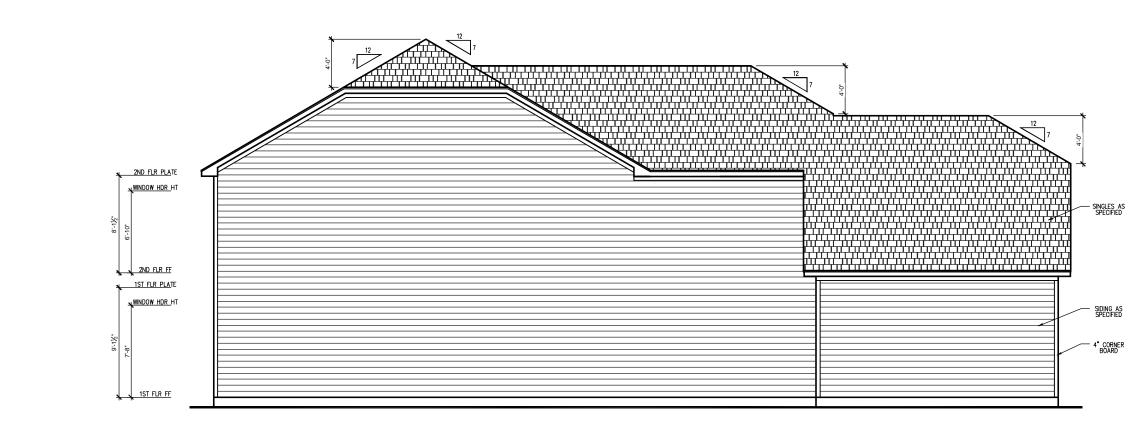


SECOND FLOOR PLAN

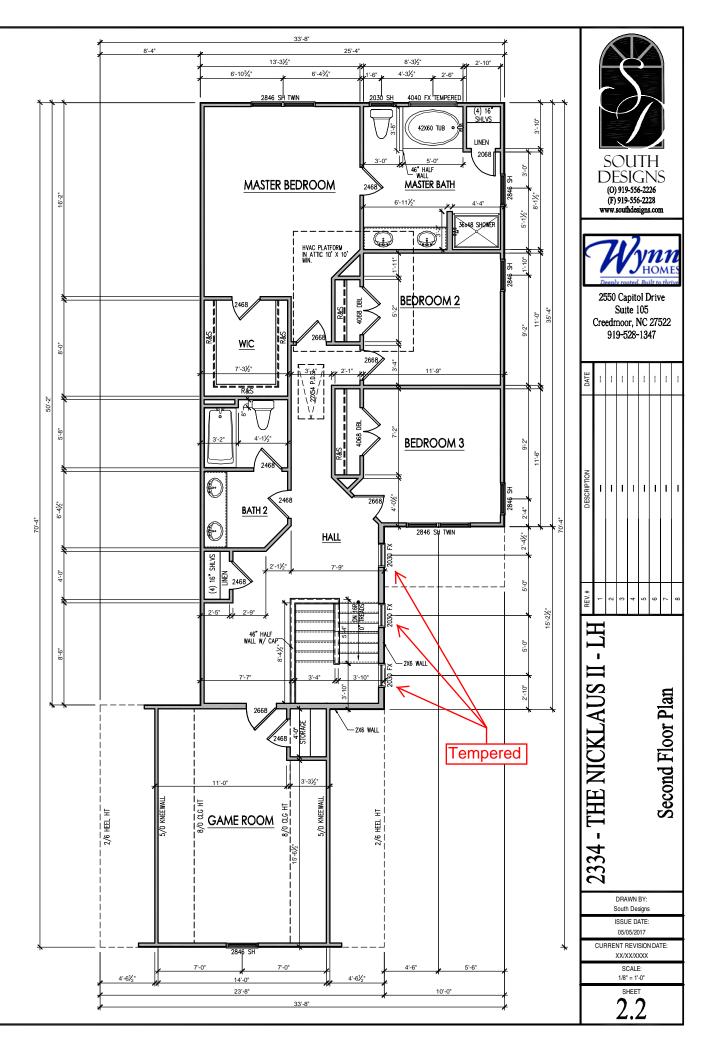SCALE: 1/8"=1'-0" ON 11x17, 1/4"=1'-0" ON 22x34






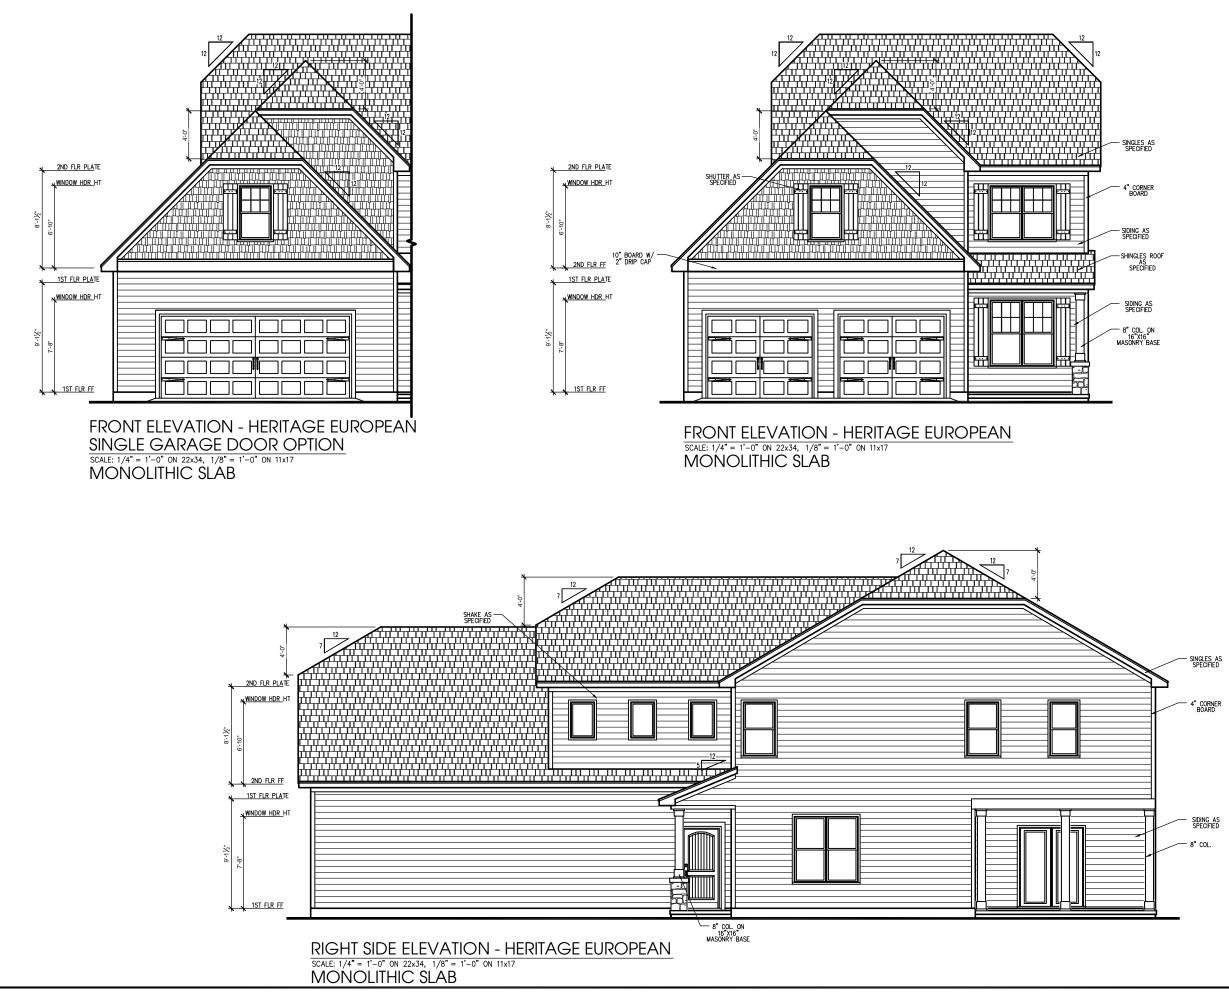



## LEFT SIDE ELEVATION - HERITAGE EUROPEAN SCALE: 1/4" = 1'-0" ON 22x34, 1/8" = 1'-0" ON 11x17 MONOLITHIC SLAB





REAR ELEVATION - HERITAGE EUROPEAN SCALE: 1/4" = 1'-0" ON 22x34, 1/8" = 1'-0" ON 11x17 MONOL ITHIC, SLAB

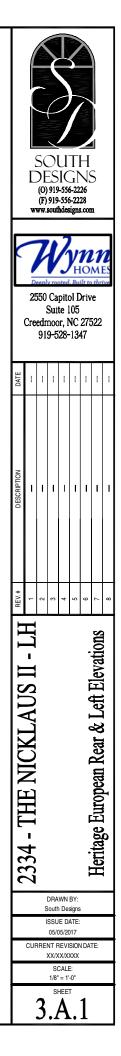


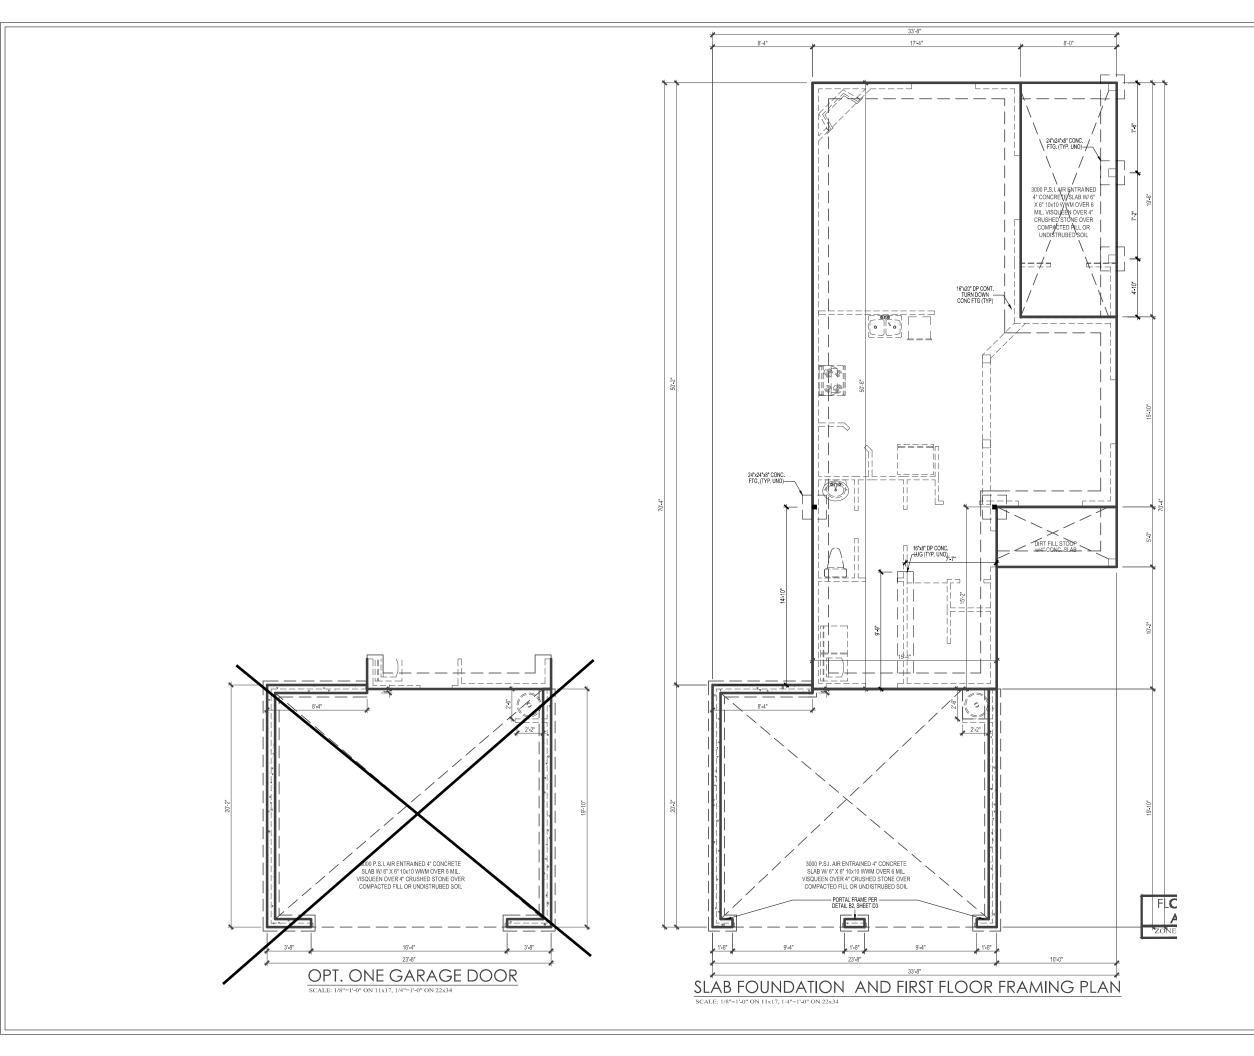

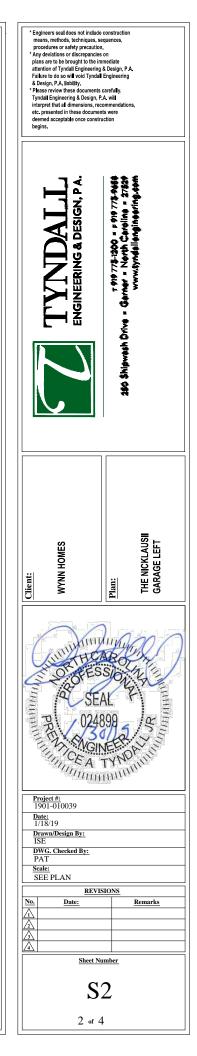

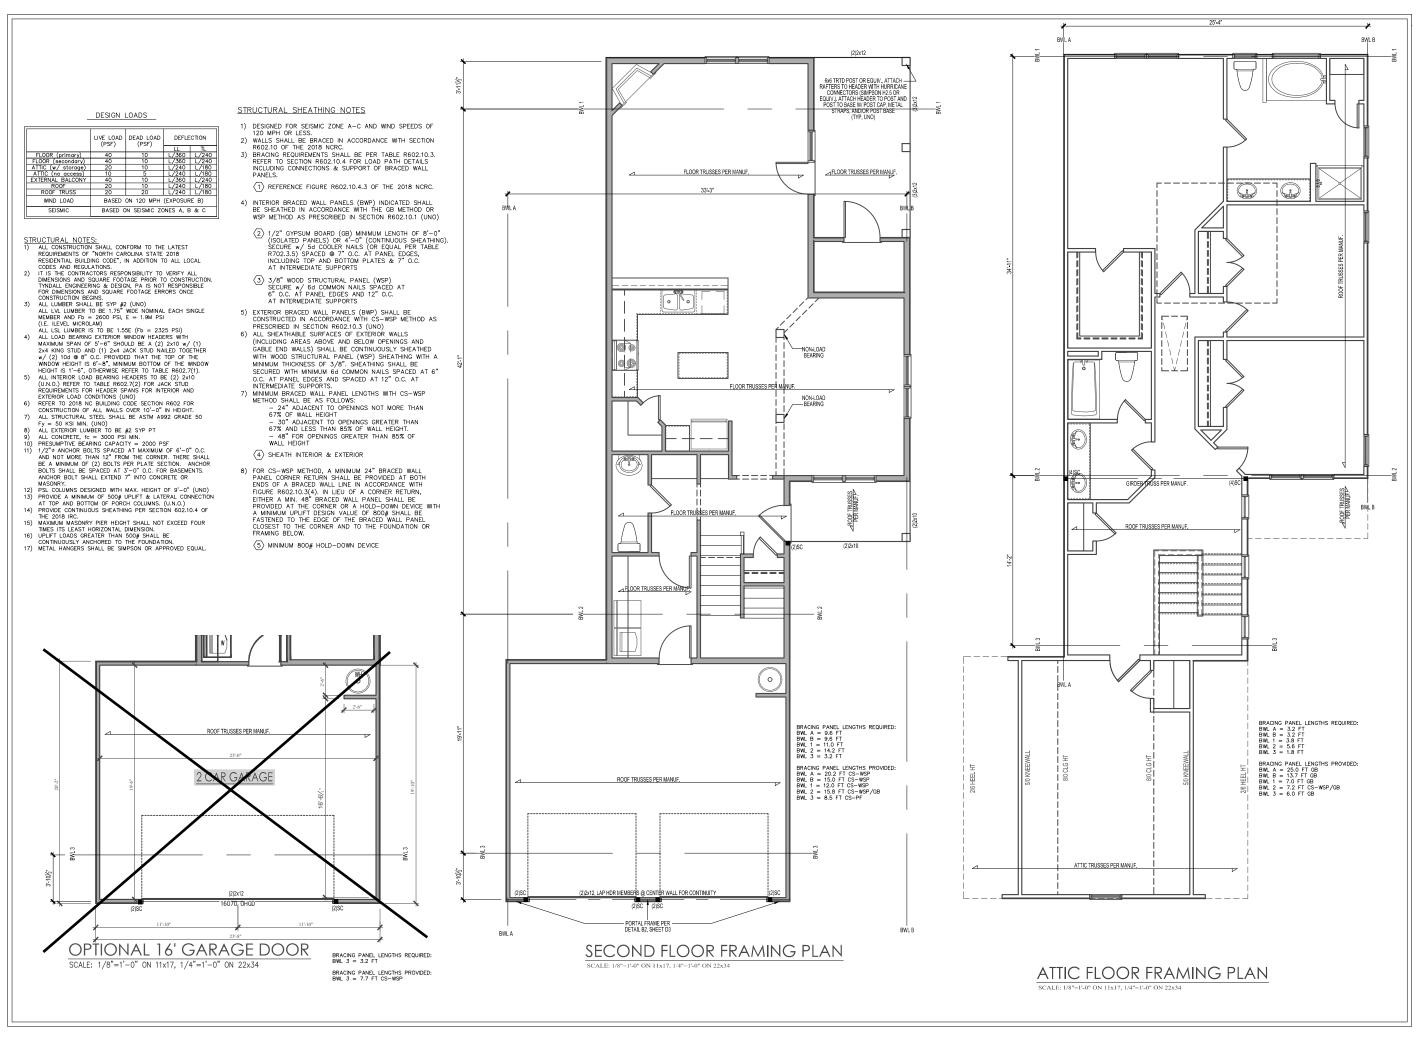

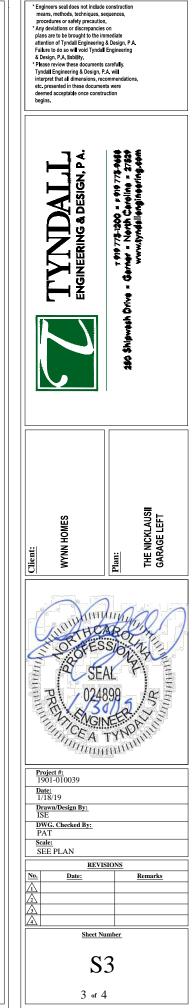

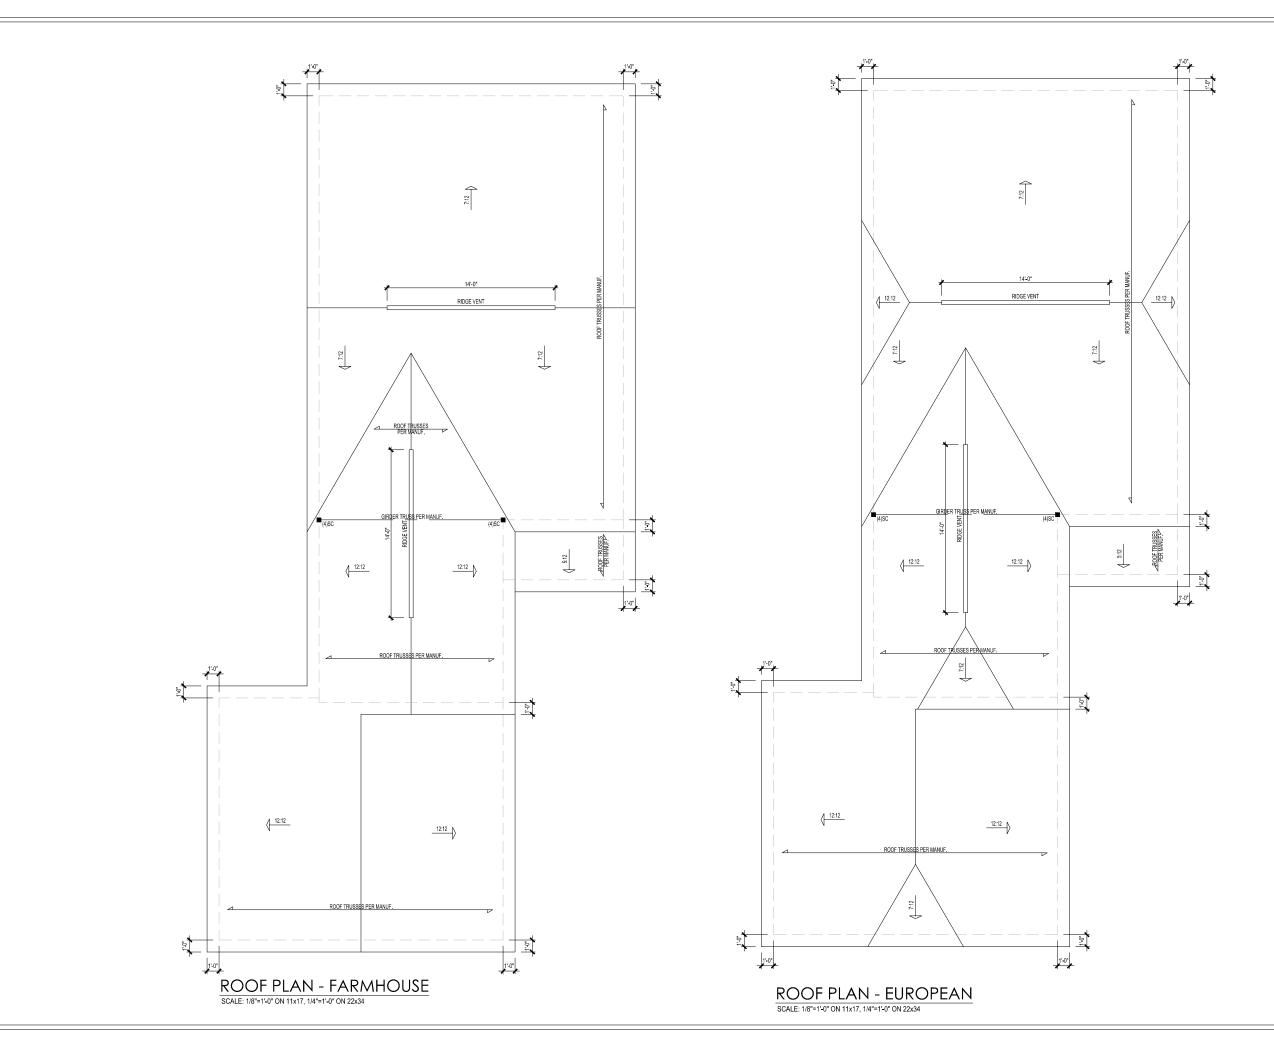

* Engineers seal does not include means, methods, techniques, s procedures or safety precaution * Any deviations or discrepancies plans are to be brought to the in attention of Tyndall Engineering Failure to do so will void Tyndal & Design, P.A. Ibability. * Please review these documents Tyndall Engineering & Design, P. interpret that all dimensions, ret etc. presented in these document decemed acceptable once constr begins.	quences, on mediate & Design, P.A. Engineering carefully. A. will ommendations, ts were
TYNDALL ENGINEERING & DESIGN, P.A.	7 919 773–1200 = 1 919 773–1200 = 1 919 773–9488 280 Shipwash Dríve = Gamar = Nenth Carolina = 27839 www.tyndallanginearing.com
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