



C. Uberst Made Dou ments Protects/Interton Internet/Propolationscolar St. 4-30-30 dec. 7/32/2030 6 47 57 AM

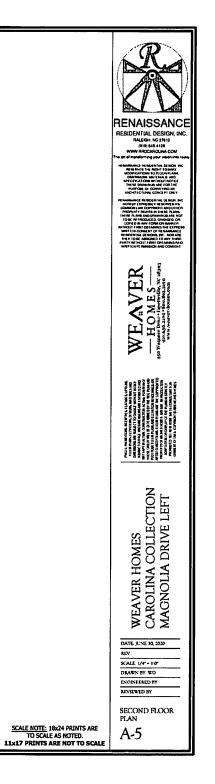

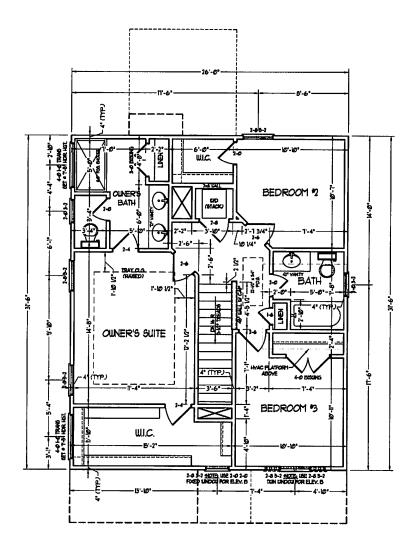


OPTIONAL FAMILY ROOM WITH ALTERNATE FIREPLACE LOCATION AND BUILT-INS


-RECEINED ENTERTAINMENT DO

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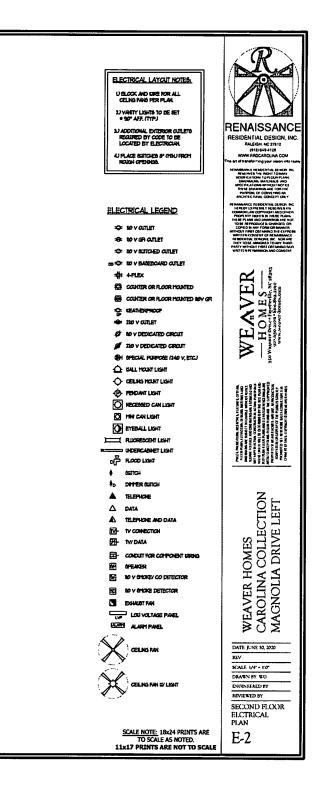
8

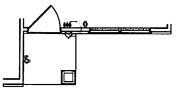



FRONT PORCH AND DINING ROOM WINDOW ELEVATION B

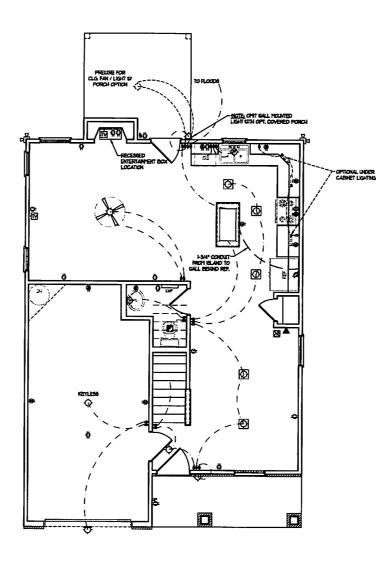


ELECTRICAL LAYOUT NOTES: U BLOCK AND GRE FOR ALL CELING FANG FER FLAN 2) VANTY LIGHTS TO BE GET • 30" AFF. (TYP) RENAISSANCE 3.) ADDITIONAL EXTENSION CATLETS REGISTED BY CODE TO BE LOCATED BY ELECTRICIAN RESIDENTIAL DESIGN, INC RALEICH, NC 27612 (919) 643 4128 WWW RROCAROLINA COM t of traditioning your vision visio 4) FLACE SUITCHES & MINU FROM ROUGH OPENNIGS LE HENDERTING DE SKA ELECTRICAL LEGEND OF SOY CITLET S LO Y GR OTLET - LO V SCITCAED CUTLET IN Y BASEDOARD GITLET VER MES---CoCgz 🖨 4REX CONTER OR FLOOR HOUNTED E COUNTER OR FLOOR MOUNTED NOV GR - UZATHERPROOF < 2 2 🗢 220 V CULET 0 WE. Ø 10 V DEDIGATED CIRCUIT # 70 Y DEDICATED CROIT tion Win H OFECIAL FURPOSE (740 V, ETC.) C GALL MOUNT LIGHT O CELING HONT LIGHT NAME OF A COLOR OF A C PENDANT LIGHT RECEIVED CAN LIGHT MINI CAN LIGHT EYEDALL LIGHT -----I AL JA PARON NATURA STATE UNDERCADNET LIGHT HOOD LIGHT \$ 800CH **\$**___ DIFFER & ITCH TELEPHONE WEAVER HOMES CAROLINA COLLECTION MAGNOLLA DRIVE LEFT ▲ TELEPHONE AND DATA **⊡** TY CONNECTION 圀 TV/ DATA 卧 CONDUCT FOR COMPONENT LIRING 8 OPEAKER M NO V SHOKE/ ON DETECTOR IS NO V CHORE DETECTOR DI EXHAUET FAN LOU VOLTAGE PANEL ALARM PANEL DATE JUNE 30, 2020 CELING FAN REV SCALE 1/4 - 10 DRAWN BY WO CEILING FAN BY LIGHT ENGINEERED BY REVIEWED BY FIRST FLOOR ELECTRICAL PLAN SCALE NOTE: 18x24 PRINTS ARE TO SCALE AS NOTED. E-1 11x17 PRINTS ARE NOT TO SCALE



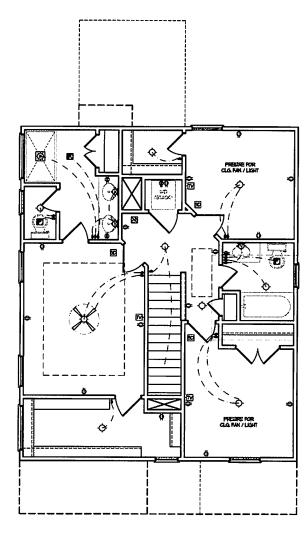

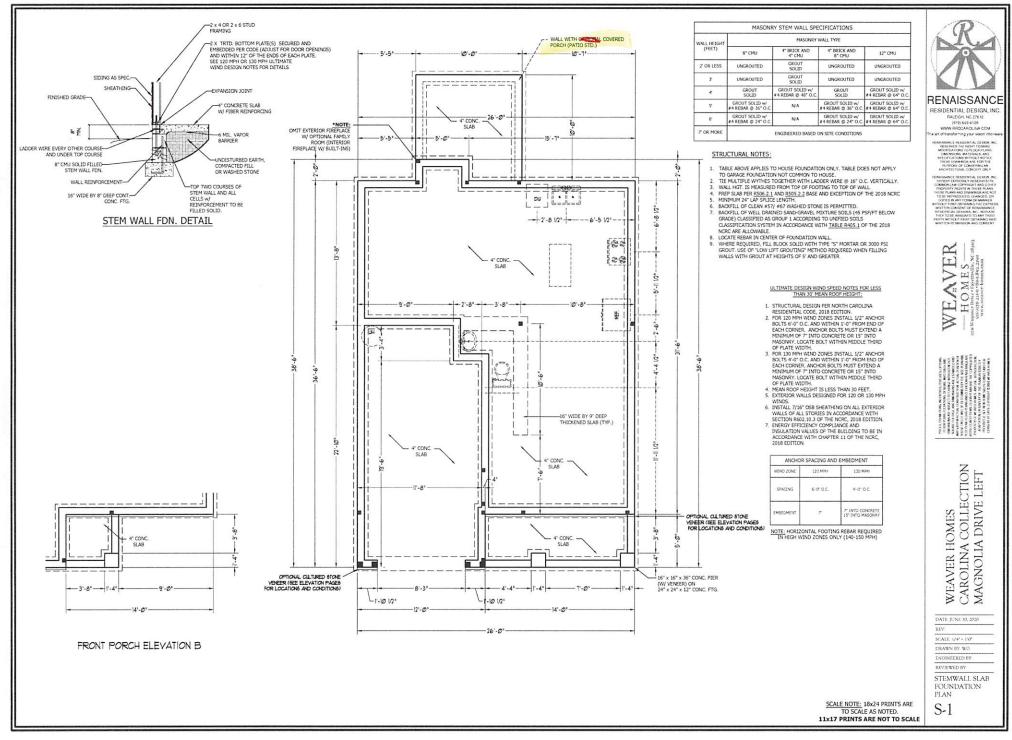

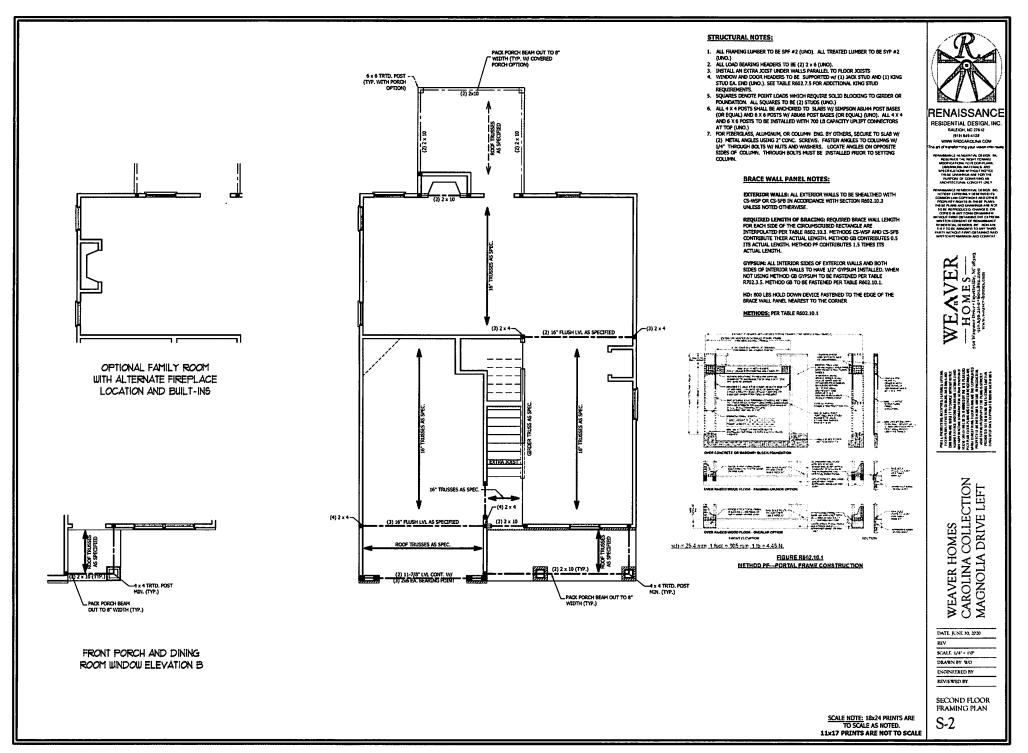

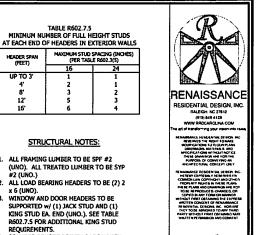


TABLE R602.7.5 MINIMUM NUMBER OF FULL HEIGHT STUDS

1

2

3

5

6

STRUCTURAL NOTES: 1. ALL FRAMING LUMBER TO BE SPF #2 (UNO). ALL TREATED LUMBER TO BE SYP

2. ALL LOAD BEARING HEADERS TO BE (2) 2 ALL LOAD BEAKING IFFALERS TO BE (2), x 6 (UND BEAKING IFFALERS TO BE SUPPORTED W/ (1) JACK STUD AND (1) INCK STUD AND (1) INCK STUD EA. END (UNO.), SEE TABLE R602.7.5 FOR ADDITIONAL KING STUD DEPUNDEMENTS.

4. SQUARES DENOTE POINT LOADS WHICH

DSP - DOUBLE STUD POCKET TSP - TRIPLE STUD POCKET

REQUIRE SOLID BLOCKING TO GIRDER OR FOUNDATION. ALL SQUARES TO BE (2) STUDS (UNO.)

HEADER SPAN (FEET)

UP TO 3

4'

8'

12'

16'

#2 (UNO.)

REQUIREMENTS.

MAXIMUM STUD SPACING (INCHES) (PER TASLE R502.3(5)

24

1

1

2

3

4







WEAVER HOMES CAROLINA COLLECTION MAGNOLLA DRIVE LEFT





ATTIC FLOOR FRAMING PLAN S-3

SCALE NOTE: 18x24 PRINTS ARE TO SCALE AS NOTED. 11x17 PRINTS ARE NOT TO SCALE

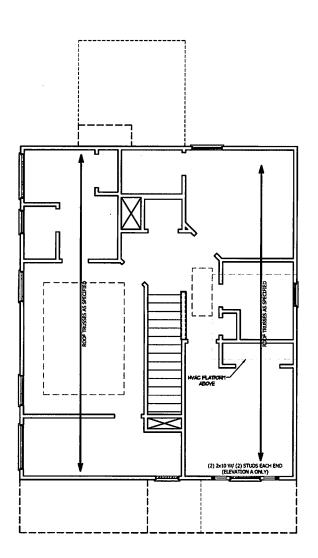

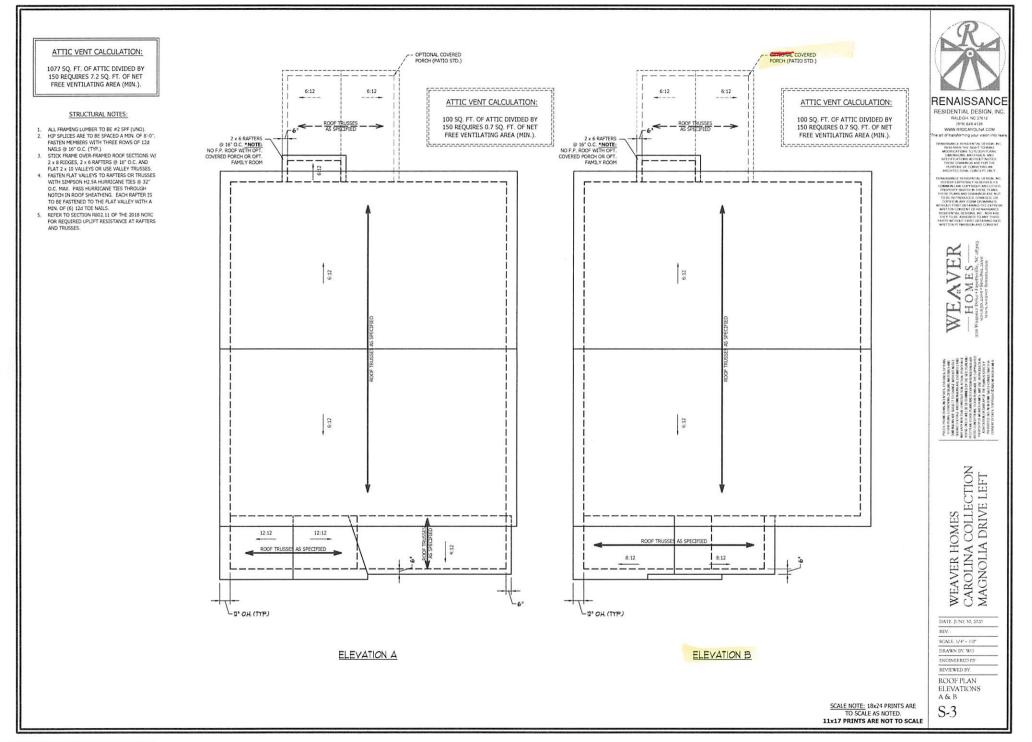

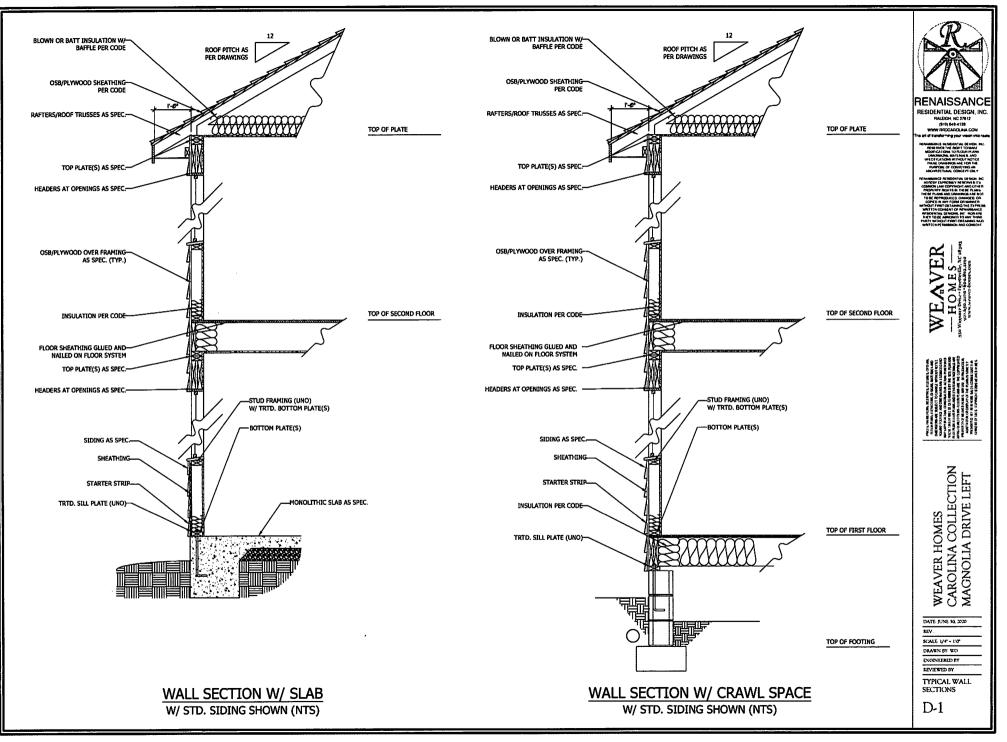

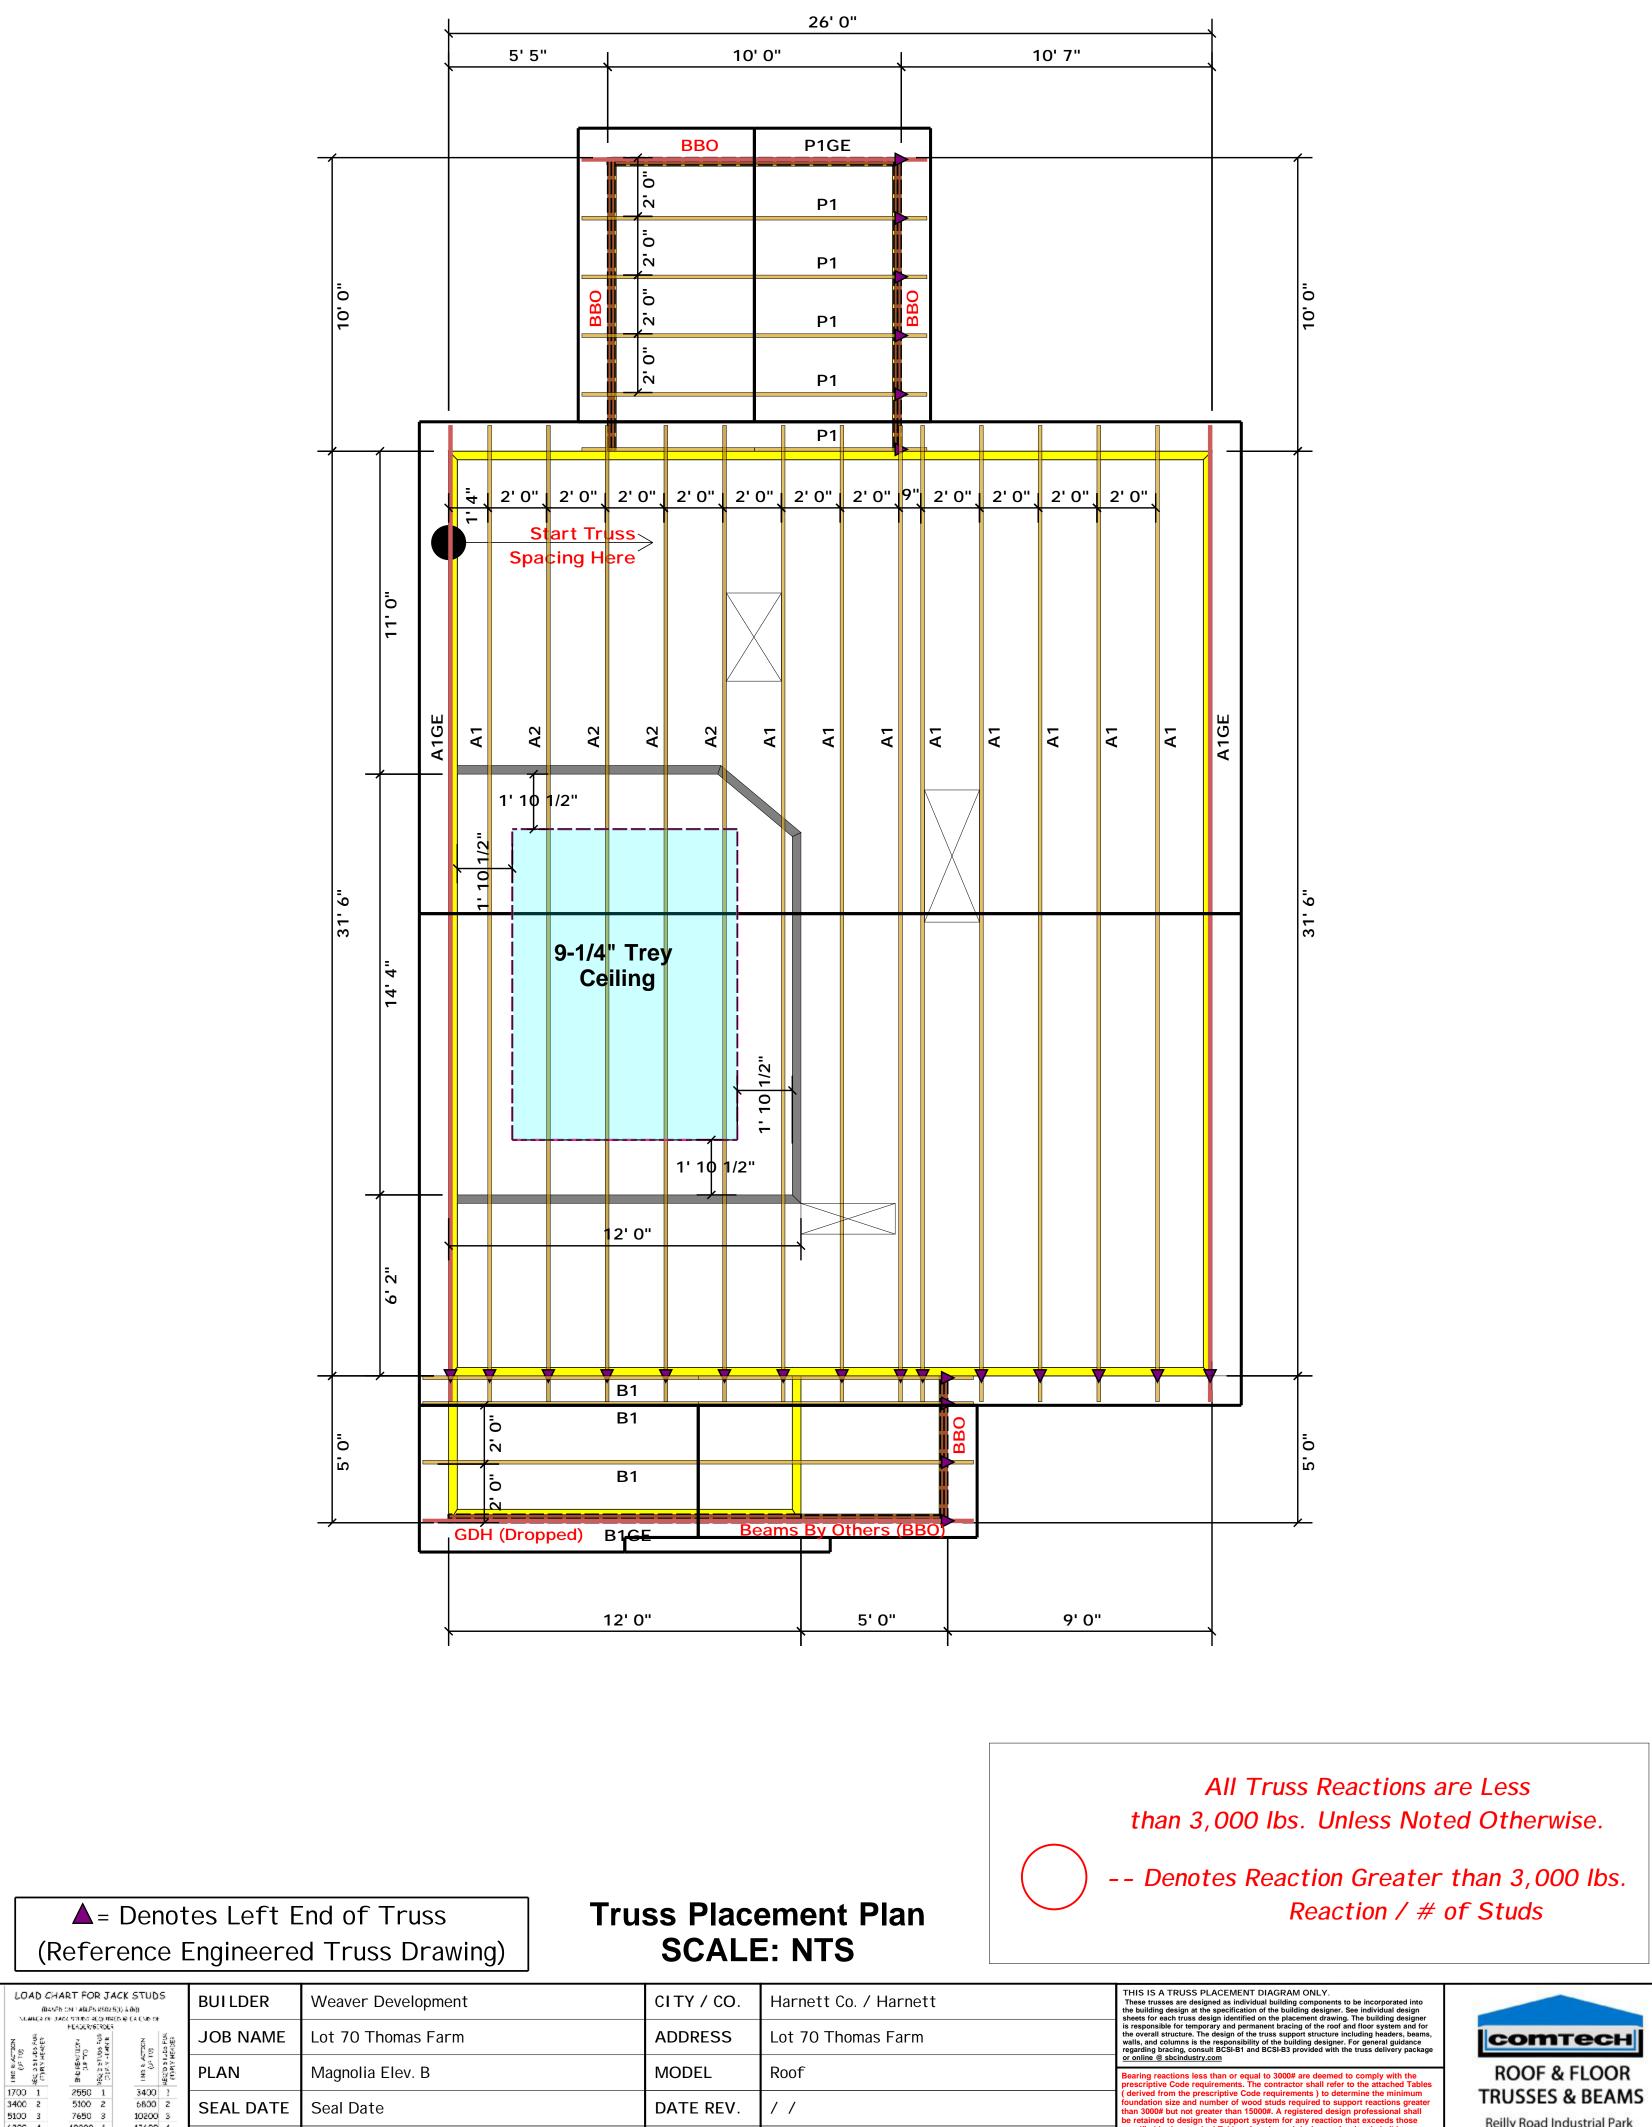

Christine Shivy

Lenny Norris

DRAWN BY

SALES REP.

10200 4 12750 5

15300 6

13600 4

17000 5

QUOTE #

JOB #

Quote #

J1220-5726

Reilly Road Industrial Park Fayetteville, N.C. 28309 Phone: (910) 864-8787 Fax: (910) 864-4444

onal shall be

ons that exceed 15000#


stered design pro

Christine Shivy

Christine Shivy

sign the support system for all reacting

Signatur

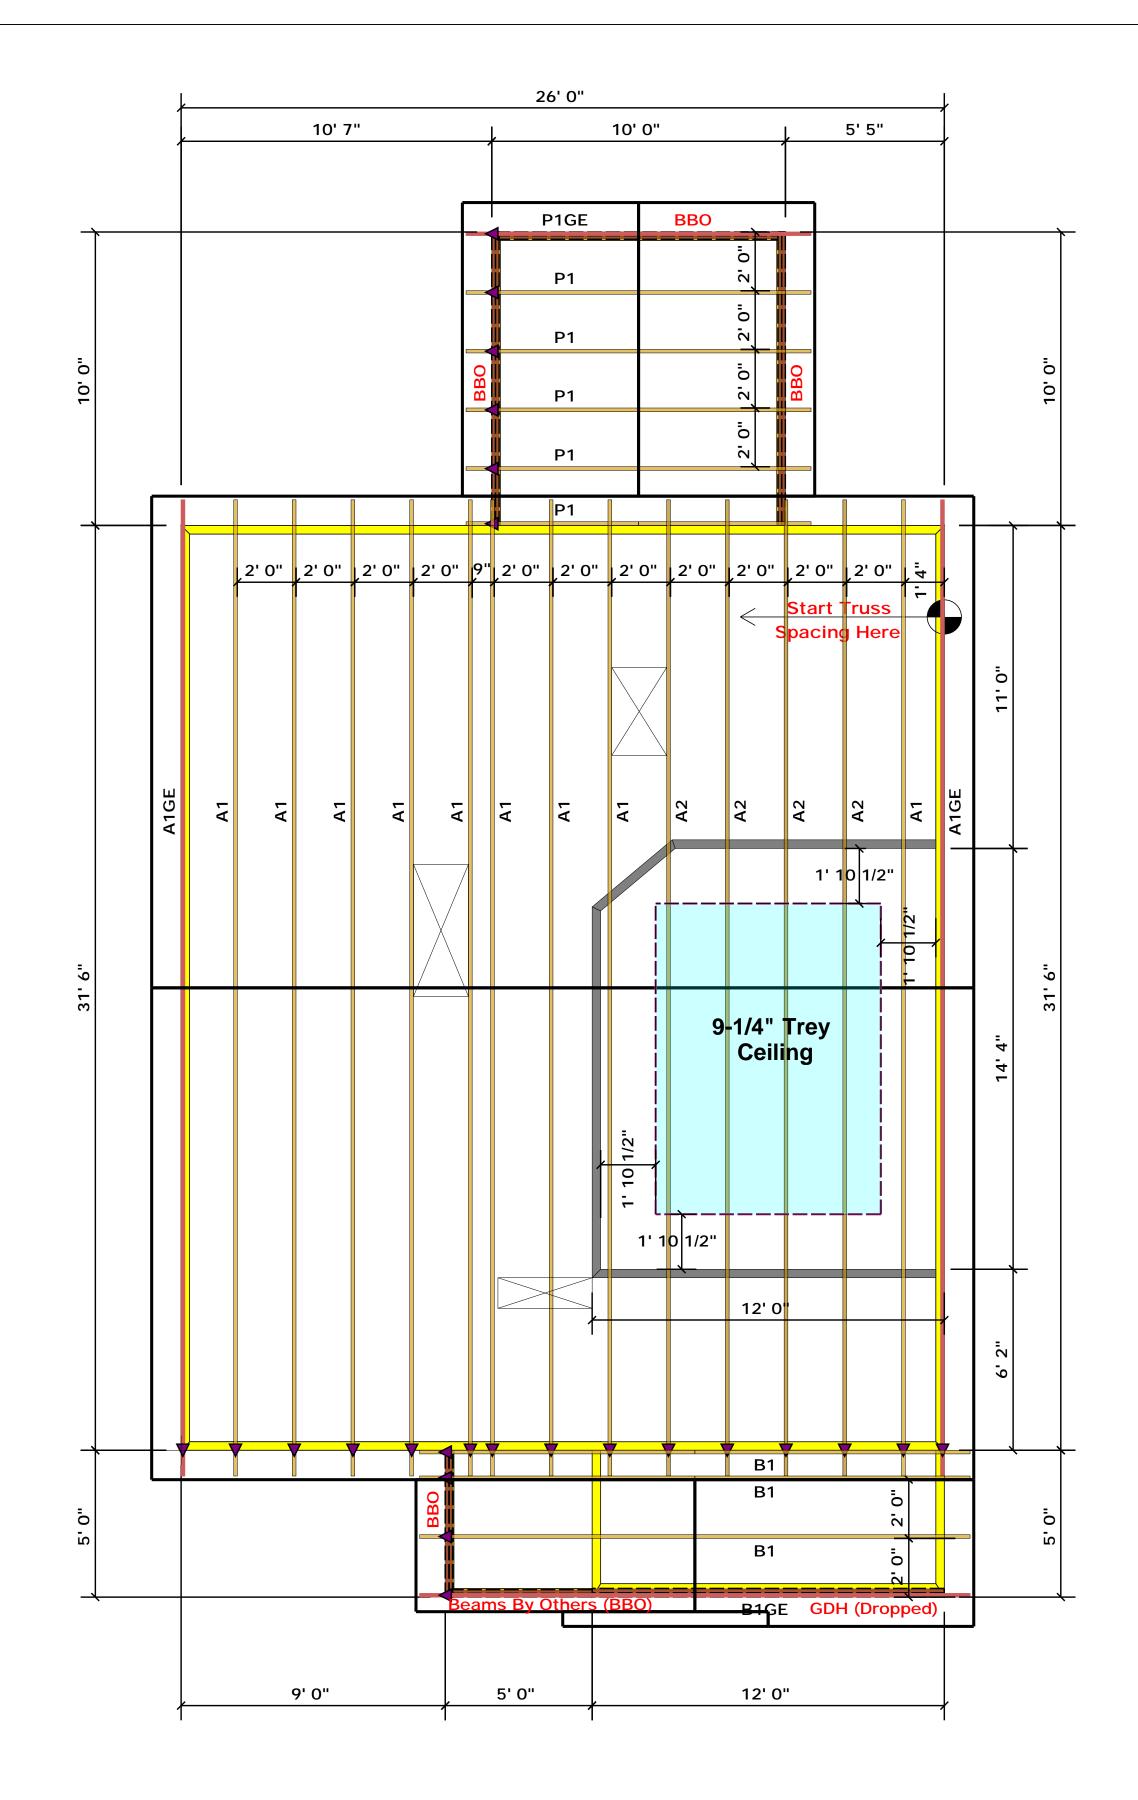

All Truss Reactions are Less than 3,000 lbs. Unless Noted Otherwise.


▲ = Denotes Left End of Truss (Reference Engineered Truss Drawing)

Truss Placement Plan SCALE: NTS

-- Denotes Reaction Greater than 3,000 lbs.

Reaction / # of Studs

LOAD CHART FOR JACK STUDS (04956 CN1 A0JEN 85025(1) 4.66) MARKER CN1 A02 STUDS (C) (C100 CF			BUILDER	Weaver Development	CITY/CO.	Harnett Co. / Harnett	THIS IS A TRUSS PLACEMENT DIAGRAM ONLY. These trusses are designed as individual building components to be incorporated into the building design at the specification of the building designer. See individual design sheets for each truss design identified on the placement drawing. The building designer	
NO NO<	FEADERVETROER	CTICKN 103 105 FUR 105 FUR	JOB NAME	Lot 70 Thomas Farm	ADDRESS	Lot 70 Thomas Farm	is responsible for temporary and permanent bracing of the roof and floor system and for the overall structure. The design of the truss support structure including headers, beams, walls, and columns is the responsibility of the building designer. For general guidance regarding bracing, consult BCSI-B1 and BCSI-B3 provided with the truss delivery package	COMTECH ROOF & FLOOR TRUSSES & BEAMS Reilly Road Industrial Park Fayetteville, N.C. 28309 Phone: (910) 864-8787 Fax: (910) 864-4444
	2 26	NN NN NN NN NN NN NN NN	PLAN	Magnolia Elev. B	MODEL	Roof	or online @ sbcindustry.com Bearing reactions less than or equal to 3000# are deemed to comply with the prescriptive Code requirements. The contractor shall refer to the attached Tables (derived from the prescriptive Code requirements) to determine the minimum foundation size and number of wood studs required to support reactions greater than 3000# but not greater than 15000#. A registered design professional shall be retained to design the support system for any reaction that exceeds those specified in the attached Tables. A registered design professional shall be retained to design the support system for all reactions that exceed 15000#. signature Christine Shivy Christine Shivy	
	2550 1 5100 2 7650 3	3400 1 6600 2 10200 3	SEAL DATE	Seal Date	DATE REV.			
	10200 4 12750 5 15300 6	13600 4 17000 5	QUOTE #	Quote #	DRAWN BY	Christine Shivy		
			JOB #	J1220-5726	SALES REP.	Lenny Norris		

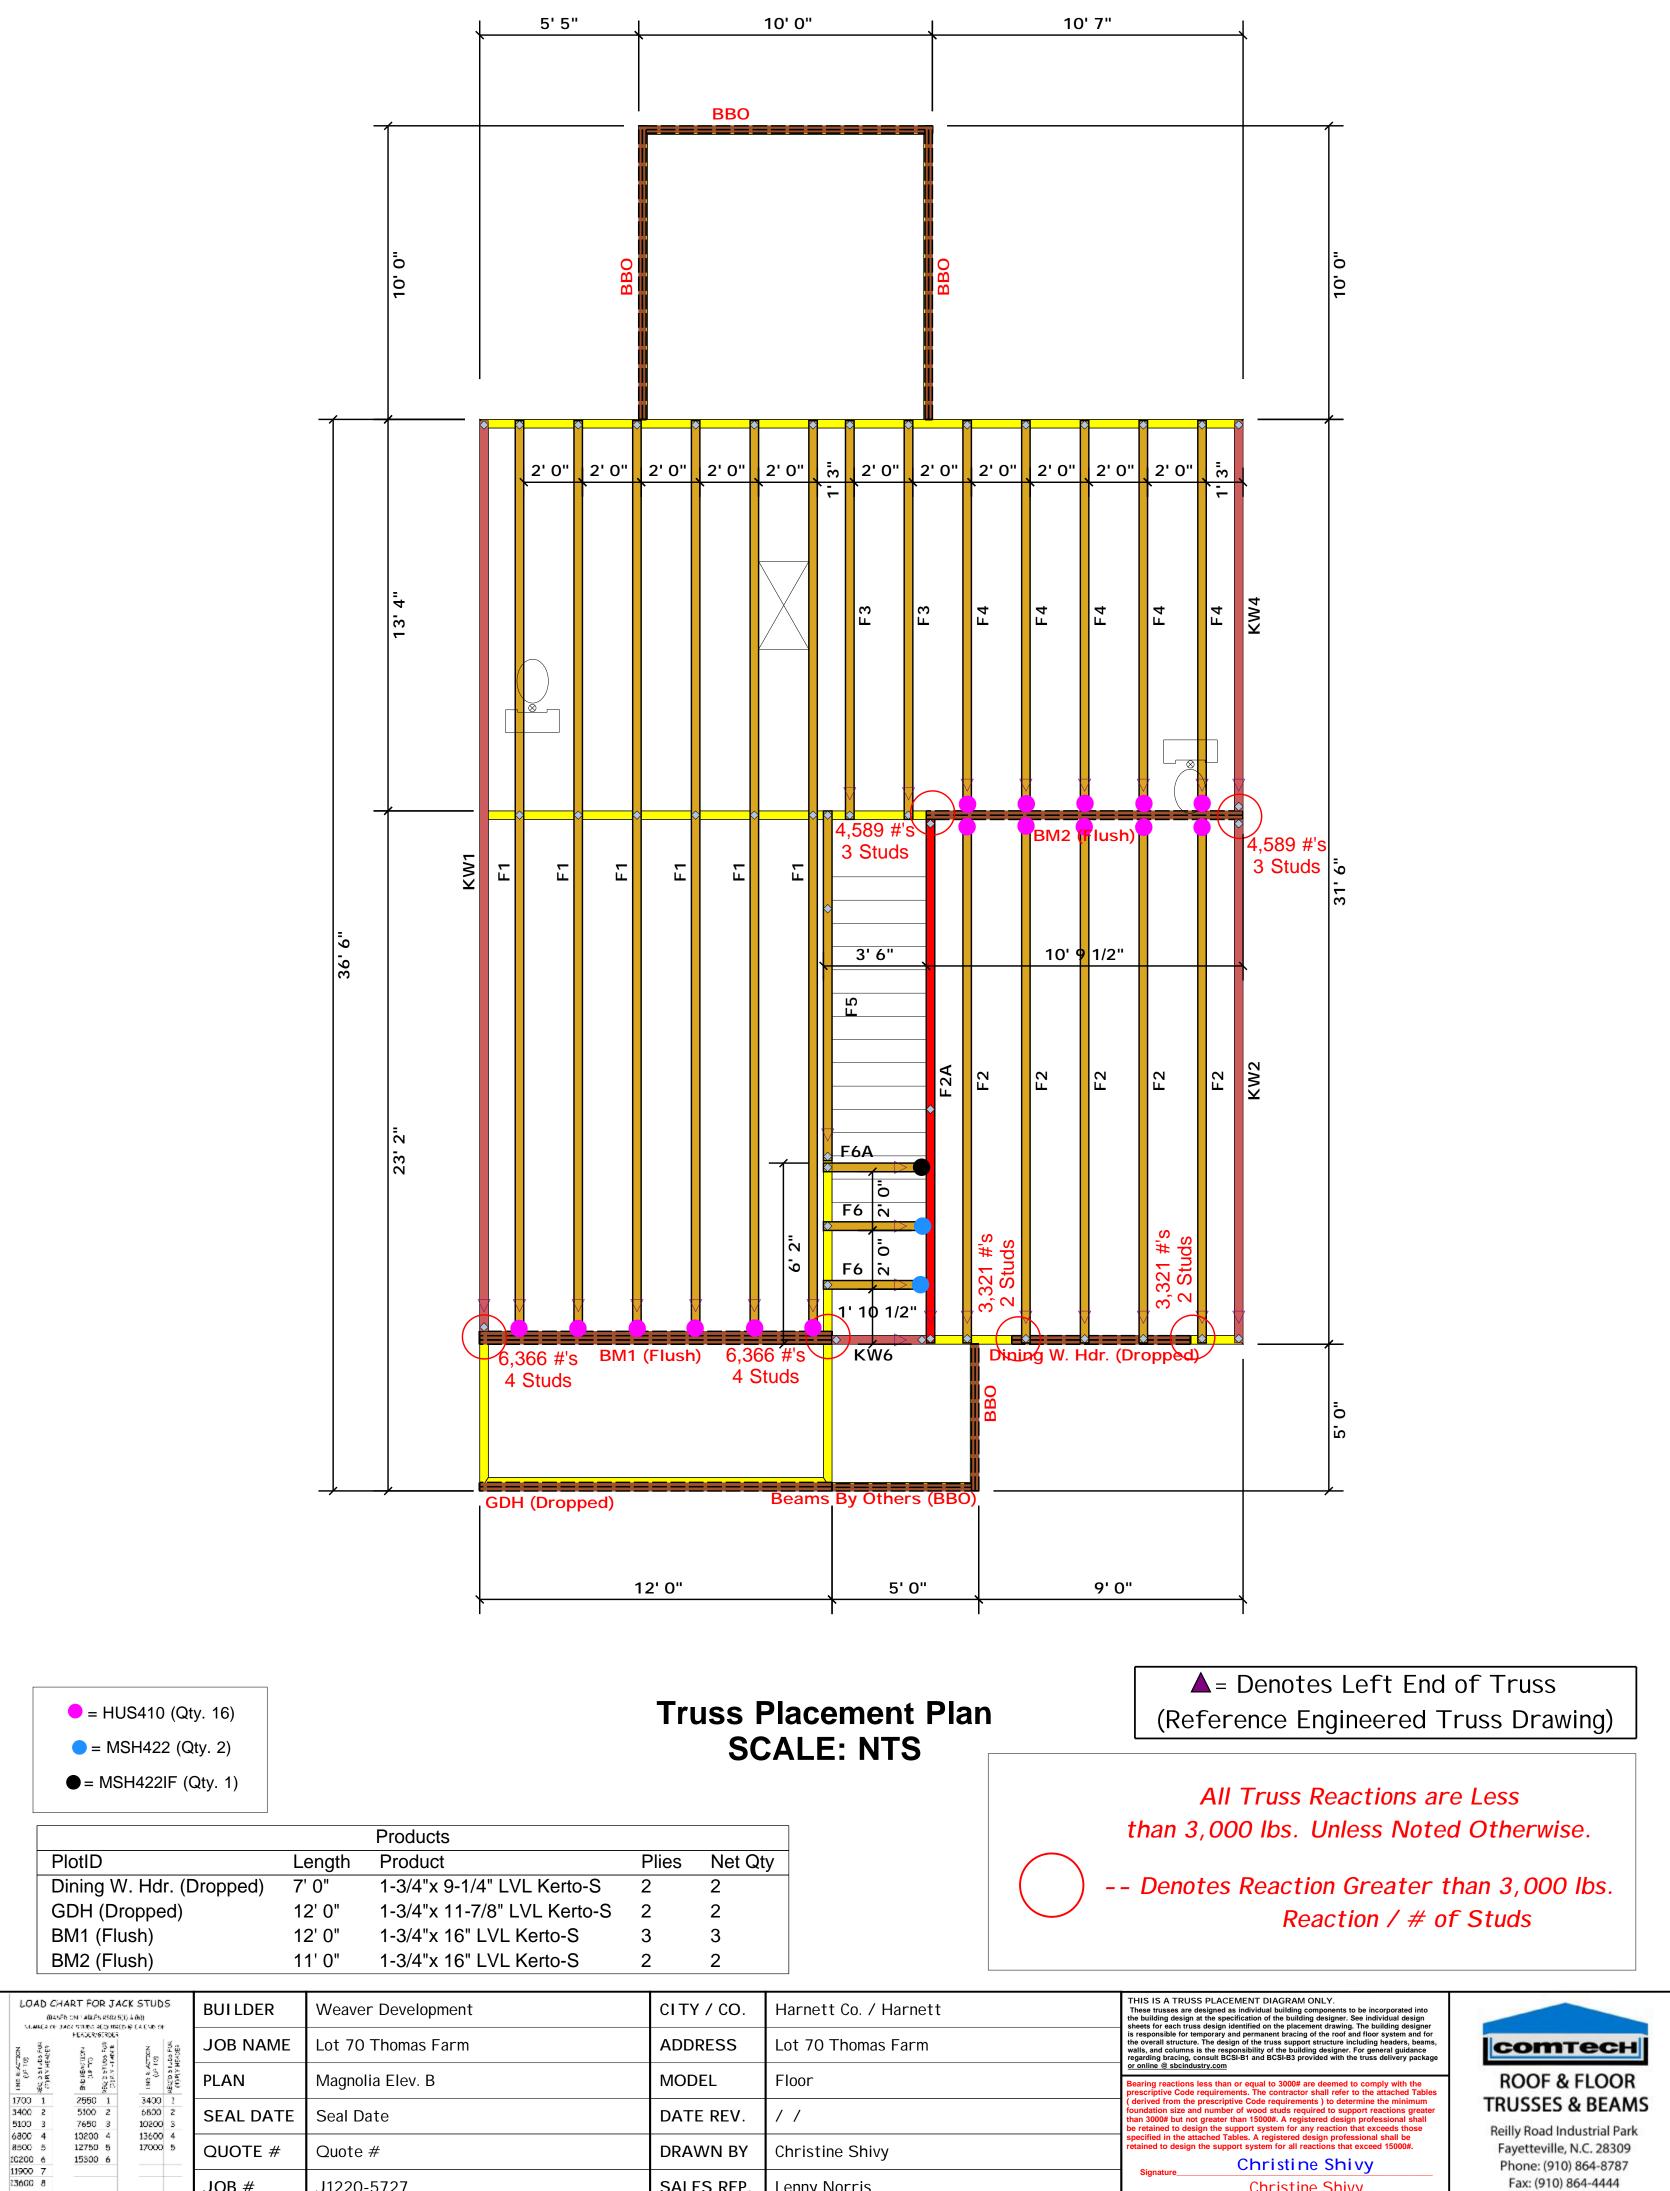

JOB #

15300 9


J1220-5727

SALES REP.

Lenny Norris

Fax: (910) 864-4444

Christine Shivy

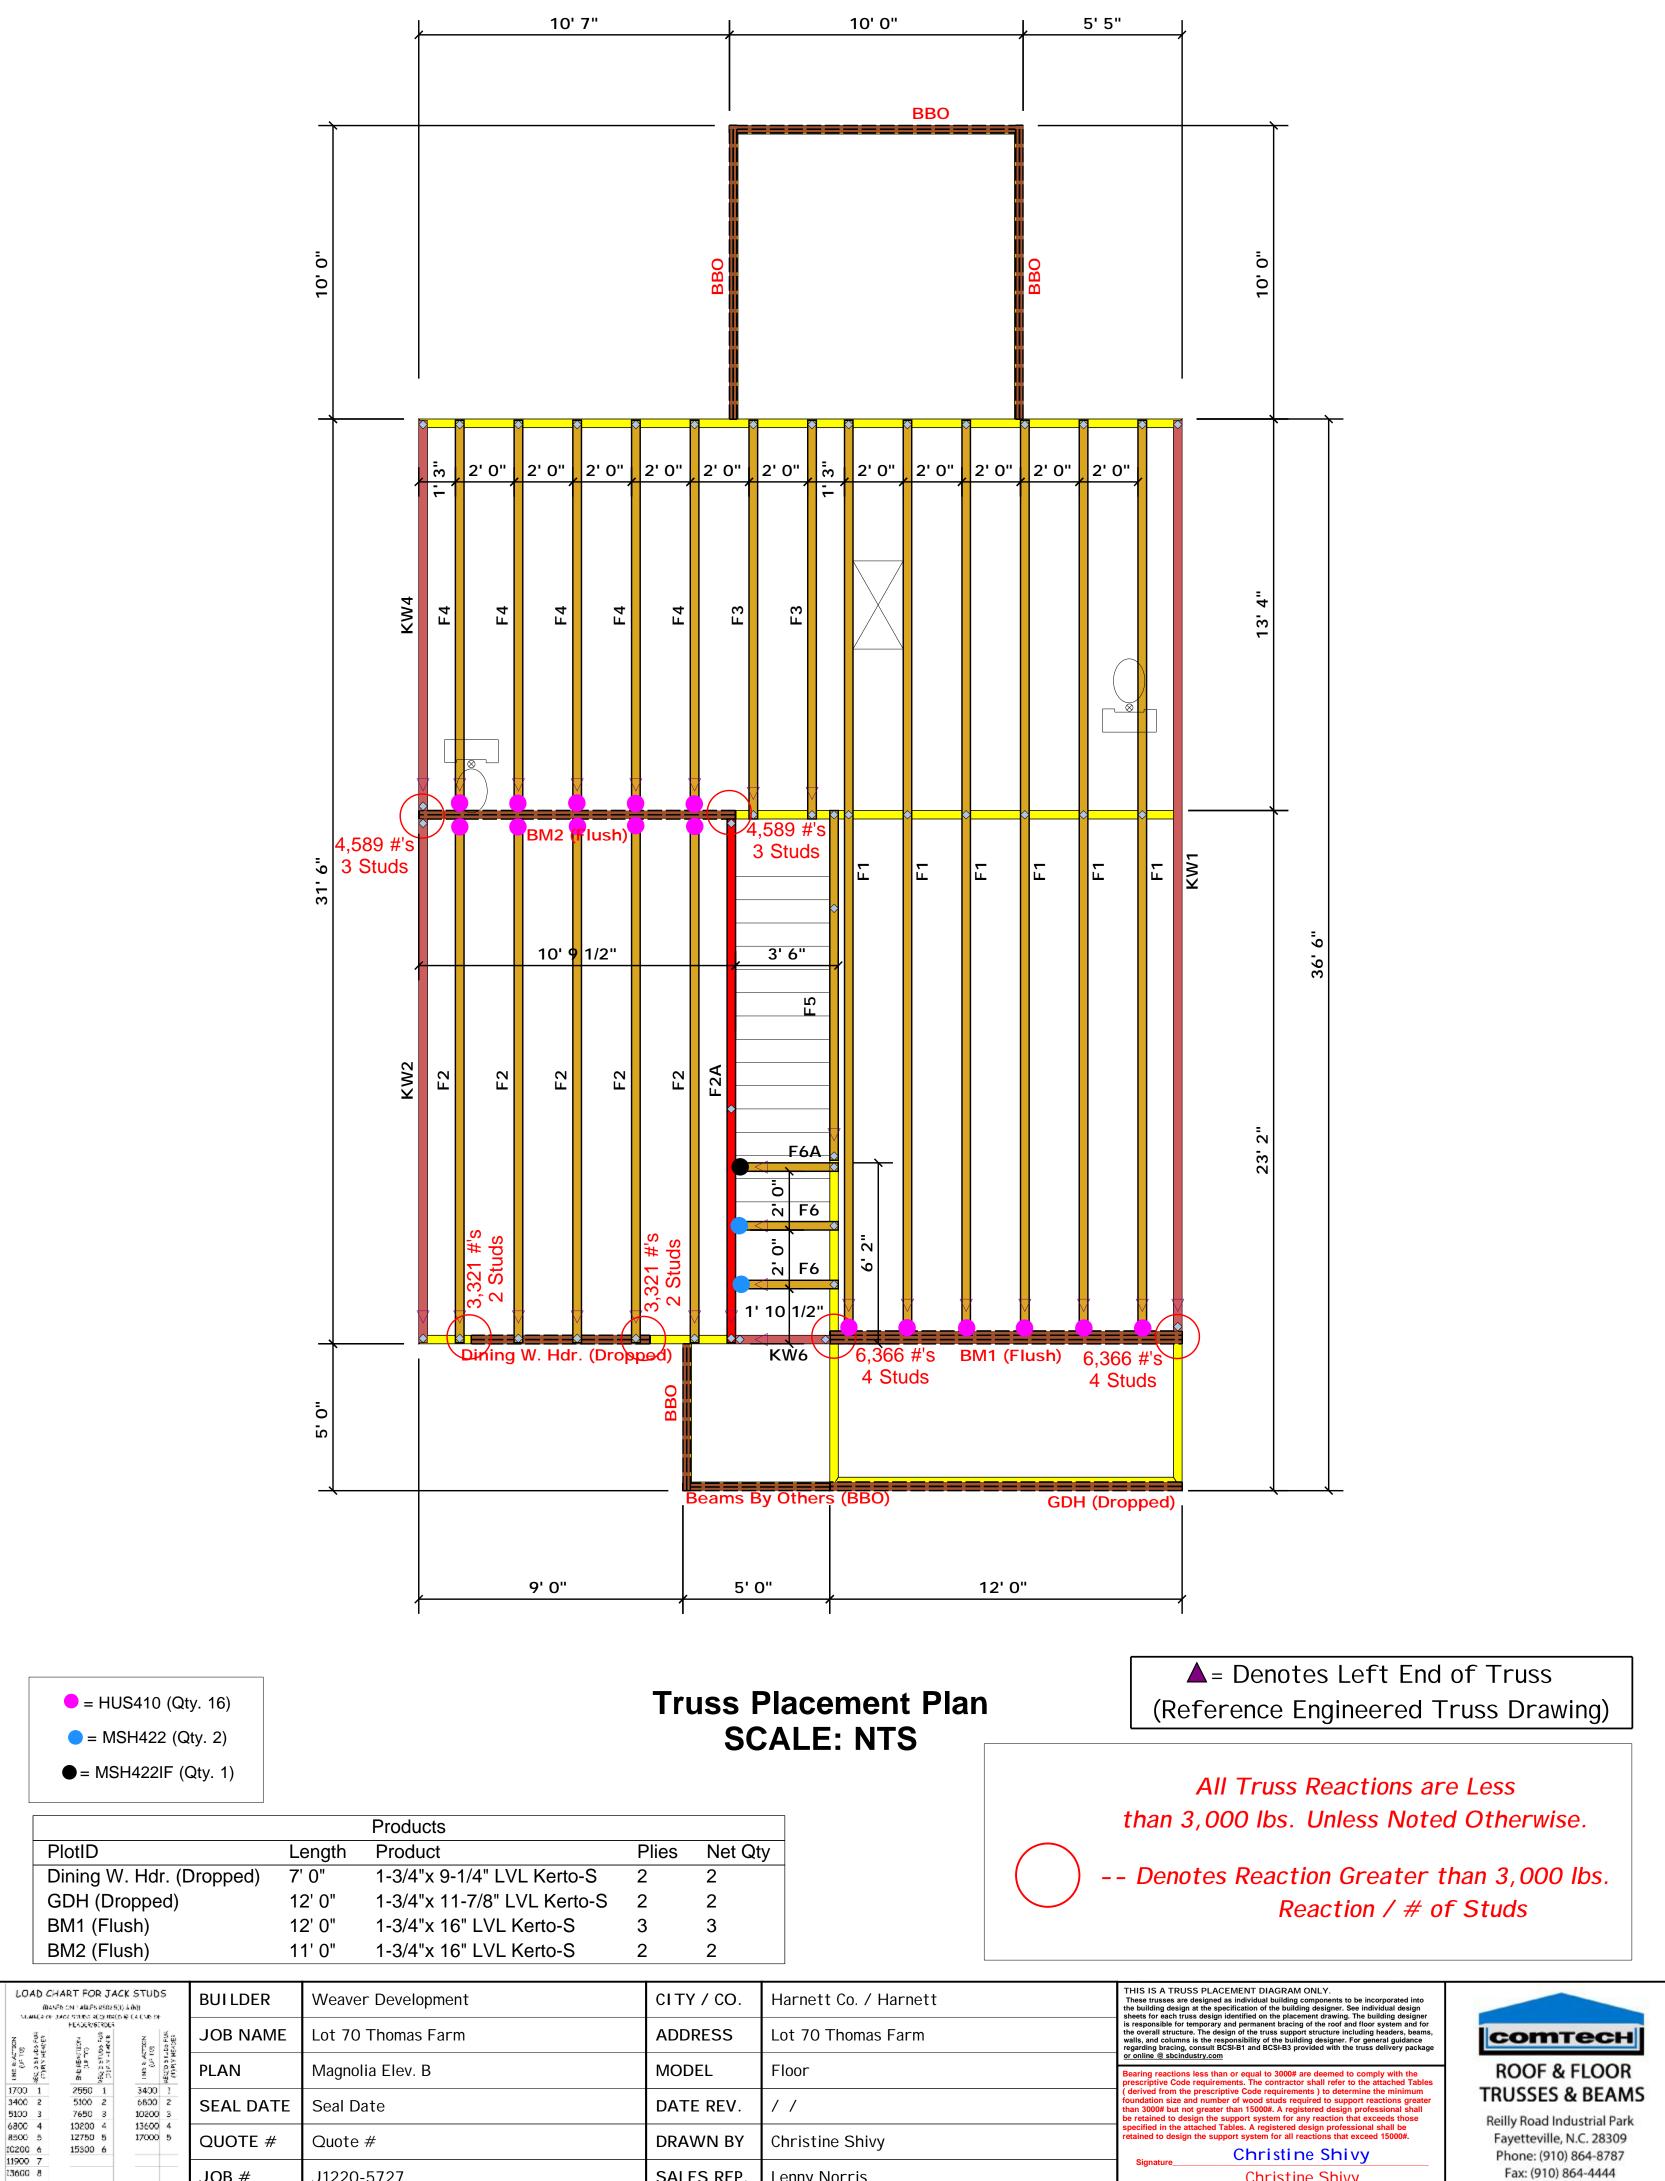

JOB #

15300 9

J1220-5727

SALES REP.

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Fax: (910) 864-4444

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