- GENERAL NOTES

 1. ALL WORK SHALL BE PERFORMED IN ACCORDANCE WITH ALL APPLICABLE NATIONAL, STATE, AND LOCAL CODES AND RESULATIONS.
- CONTRACTOR SHALL THOROUGHLY REVIEW ALL SHEETS IN PLAN SET AND VERIFY ALL DETAILS AND DIMENSIONS BEFORE BEGINNING CONSTRUCTION. ANY DISCREPANCIES SHALL BE REPORTED TO RENAISSANCE RESIDENTIAL DESIGN, INC. FOR JUSTIFICATION AND/OR CORRECTION BEFORE
 PROCEEDING WITH WORK. CONTRACTORS SHALL ASSUME RESPONSIBILITY
- FOR ERRORS THAT ARE NOT REPORTED PRIOR TO CONSTRUCTION.
 ALL DIMENSIONS SHOULD BE READ OR CALCULATED AND NEVER SCALED. CONTRACTOR SHALL ENSURE COMPATIBILITY OF THE BUILDING WITH ALL


LOT 68 THOMAS FARM 4179 OVERHILLS RD SPRING LAKE, NC 28390

PLANS DESIGNED TO THE 2018 NORTH CAROLINA STATE RESIDENTIAL BUILDING CODE.



FRONT ELEVATION-A SCALE: 1/4" = 1'-0"

STEPS PER GRADE AS REQ.

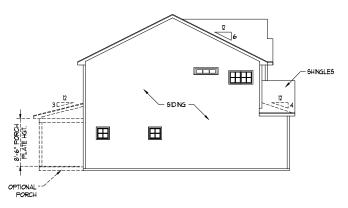


CORNER BOARD AS SPEC. (TYP.)


OPTIONAL CULTURED

STONE SKIRT (SHOWN)

HVAC: CAROLINA COMFORT LEFT ELEVATION CALE: I/8" = I'-0' PLUMBING: DOUBLE J **ELECTRIC: PIONEER**

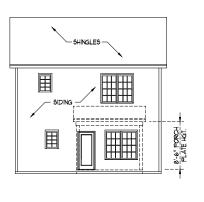

REAR ELEVATION SCALE: 1/8" = 1'-0"

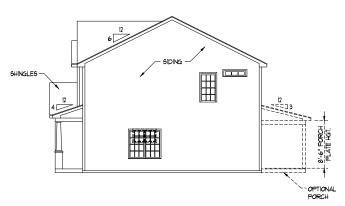

RIGHT ELEVATION SCALE: 1/8" = 1'-0'



RESIDENTIAL DESIGN, INC

RALEIGH, NC 27612 (919) 648-4128 WWW.RRDCAROLINA.COM




WEAVER HOMES CAROLINA COLLECTION HICKORY DRIVE LEFT

REV.: SCALE: AS NOTED

DRAWN BY: WG ENGINEERED BY REVIEWED BY:

A - ELEVATIONS

A-1

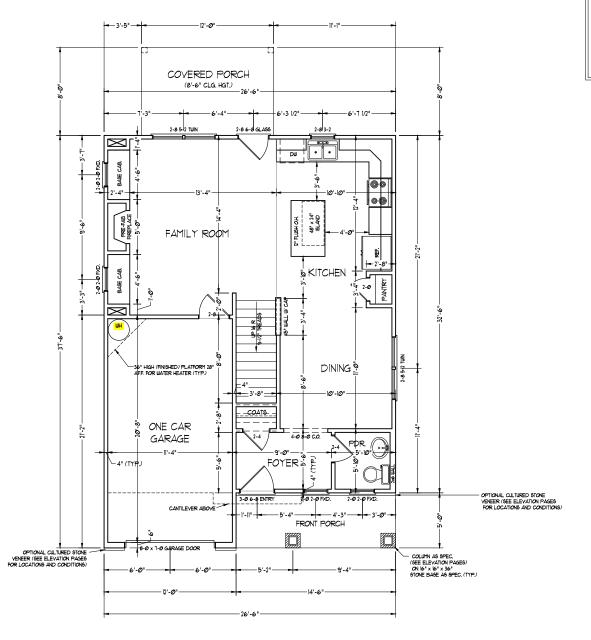

SQUARE FOOTAGE (IF.S.)

| Ist FLOOR: 639 SQ. FT. 2nd FLOOR: 195 SQ. FT. TOTAL: 1943 SQ. FT. GARAGE: 232 SQ. FT. FRONT PORCH: 15 SQ. FT. STD. REAR PATIO: 96 SQ. FT. OPT. REAR PORCH: 96 SQ. FT.



RESIDENTIAL DESIGN, INC.

RALEIGH, NC 27612 (919) 649-4128 WWW.RRDCAROLINA.COM

e art of transforming your vision into real

SSANCE RESIDENTIAL DESIGN, INC., ESERVES THE RIGHT TO MAKE DUFFICATIONS TO FLOOR PLANS, DIMENSIONS, MATERIALS, AND EGIFICATIONS WITHOUT NOTICE. HESE DRAWNOS ARE FOR THE PURPOSE OF CONNEYING AN DUFFICE THAT CANCERT ONLY.

INVESTIGATE PRESIDENT LESSON, INC.
HEREDY EMPRISS, I RESERVES ITS
COMMON LAW COMPRISON THAN OTHER
HERES PLANS NOT DRAWINGS ARE NOT
TO BE REPRODUCED, CHANGED, OR
COPIED IN ANY COMPRISON
HERES TO COME TO THE SEPTISS
HERES TO STANNING INTERPRESIDENT
HERES TO STANNING INTERPRESIDENT
HERES TO STANNING INTERPRESIDENT
HERES TO STANNING INTERPRESIDENT
HERES TO STANNING AND
ARTY WITHOUT PRIST OFFANING AND
ARTY WITHOUT PRIST OFFANING AND
MITTEN PERSISSION AND CONSENT.



PIETES PROUTING RATHERS RATHERS CPTNA.

THE STATE OF THE

WEAVER HOMES CAROLINA COLLECTION HICKORY DRIVE LEFT

DATE: AUGUST 25, 2020


REV.:

SCALE: 1/4" = 1'-0" DRAWN BY: WG

ENGINEERED BY: REVIEWED BY:

FIRST FLOOR PLAN

A-4

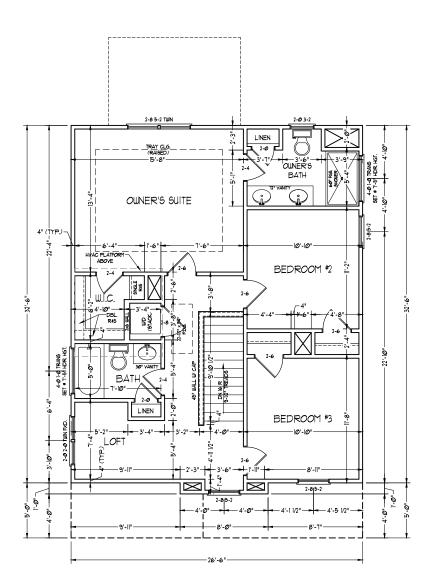



RESIDENTIAL DESIGN, INC.
RALEIGH, NC 27812
(919) 649-4128
WWW.RRDCAROLINA.COM
The art of transforming your vision into really



PATES PROMITING REATHER, COTHON, THE STATES COTHON, THE STATES COTHON, THE STATES COTHON TO THE STATES COTHON TO THE STATES COTHON TO THE STATES COTHON TO THE STATES OF T

WEAVER HOMES CAROLINA COLLECTION HICKORY DRIVE LEFT

DATE: AUGUST 25, 2020


REV.:

SCALE: 1/4" = 1'-0" DRAWN BY: WG

ENGINEERED BY: REVIEWED BY:

SECOND FLOOR PLAN

A-5

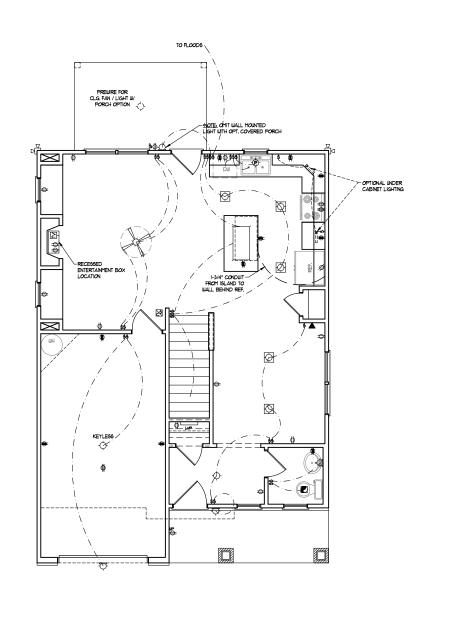

ELECTRICAL LAYOUT NOTES:

U BLOCK AND WIRE FOR ALL CELING FANS PER PLAN.

2.) VANITY LIGHTS TO BE SET • 90° AFF. (TYP.)

3.) ADDITIONAL EXTERIOR OUTLETS REQUIRED BY CODE TO BE LOCATED BY ELECTRICIAN.

4.) PLACE SWITCHES 8" (MIN.) FROM ROUGH OPENINGS.

ELECTRICAL LEGEND

- → NØ ∨ OUTLET
- ₩ 10 V GFI OUTLET
- IN A CALL ON ITE!
- ⊕ 10 ∨ SWITCHED OUTLET
- BB == 100 V BASEBOARD OUTLET
- 4-PLEX
- ⊕ COUNTER OR FLOOR MOUNTED
- COUNTER OR FLOOR MOUNTED 110V GF1
- # WEATHERPROOF
- ⇒ 22Ø ∨ OUTLET
- Ø 10 V DEDICATED CIRCUIT
- # 220 Y DEDICATED CIRCUIT
- SPECIAL PURPOSE (240 V, ETC.)
- ALL MOUNT LIGHT
- CEILING MOUNT LIGHT
- -PENDANT LIGHT
- RECESSED CAN LIGHT
- MINI CAN LIGHT
- EYEBALL LIGHT
- FLUORESCENT LIGHT
- undercabinet light
- FLOOD LIGHT
- \$ SWITCH
- \$D DIMMER SWITCH
- ▲ TELEPHONE
- △ DATA
- ▲ TELEPHONE AND DATA
- TV- TV CONNECTION
- TV/ DATA
- CD- CONDUIT FOR COMPONENT WIRING
- SP SPEAKER
- 10 V SMOKE/ CM DETECTOR
- BD 100 V SMOKE DETECTOR
 - EXHAUST FAN
 - LOW VOLTAGE PANEL
 - ALARM PANEL





SCALE NOTE: 18x24 PRINTS ARE TO SCALE AS NOTED. 11x17 PRINTS ARE NOT TO SCALE



REINAISSAINCE RESIDENTIAL DESIGN, INC.

RALEIGH, NC 27612 (919) 649-4128 WWW.RRDCAROLINA.COM e art of transforming your vision into rea

AUSSANCE RESIDENTIAL DESIGN, INC.
RESERVES THE RIGHT TO MAKE
MODIFICATIONS TO FLOOR PLANS,
DIMENSIONS, MATERIALS, AND
SPECIAL TIONS WITHOUT NOTICE.
THESE DRAWNIGS ARE FOR THE
PURPOSE OF CONNEYING AN
ARCHITECTURAL CONCEPT ONLY.

REMISSANCE RESIDENTIAL DESIGN, INN
HERBY EXPRESSLY RESERVES ITS
COMMON LAW COPPYBORT AND OTHER
PROPERTY RIGHTS IN THESE PLANS.
THESE PLANS AND DRAWINGS ARE NO'
TO BE REPRODUCED, CHANGED, OR
COPIED IN ANY FORM OR MANNER
MITTHOUT FIRST OBTAINING THE EXPRES
WRITTEN CONSENT OF REMISSANCE
RESIDENTIAL DESIGNS, INC. NOR ARE
RESIDENTIAL DESIGNS, INC. NOR ARE



TOOP TANK COMPANY EXPENSES STANSON OF TOO THE STANDON STANDON

WEAVER HOMES CAROLINA COLLECTION HICKORY DRIVE LEFT


DATE: AUGUST 25, 2020 REV.:

SCALE: 1/4" = 1'-0"

DRAWN BY: WG ENGINEERED BY: REVIEWED BY:

FIRST FLOOR ELECTRICAL PLAN

E-1

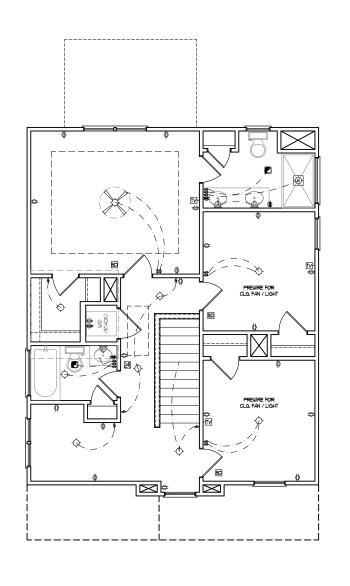

ELECTRICAL LAYOUT NOTES:

- U BLOCK AND WIRE FOR ALL CELING FANG PER PLAN.
- 2.) VANITY LIGHTS TO BE SET • 90° AFF. (TYP.)
- 3.) ADDITIONAL EXTERIOR OUTLETS REQUIRED BY CODE TO BE LOCATED BY ELECTRICIAN.
- 4.) PLACE SWITCHES 8" (MIN.) FROM ROUGH OPENINGS.

ELECTRICAL LEGEND

- □ IØ V OUTLET
- ₩ 10 V GFI OUTLET
- TO V SWITCHED OUTLET
- BB ⊕ 100 V BASEBOARD OUTLET
- 4-PLEX
- ⇔ counter or Floor Mounted
- S COUNTER OR FLOOR MOUNTED 110Y GFT
- # WEATHERPROOF
- 22Ø ∨ OUTLET
- Ø 10 V DEDICATED CIRCUIT
- # 220 Y DEDICATED CIRCUIT
- SPECIAL PURPOSE (24Ø V, ETC.)
- ALL MOUNT LIGHT
- CEILING MOUNT LIGHT
- -P-PENDANT LIGHT
- RECESSED CAN LIGHT
- MINI CAN LIGHT
- EYEBALL LIGHT
- FLUORESCENT LIGHT
- undercabinet light
- FLOOD LIGHT
- \$ SWITCH
- \$D DIMMER SWITCH
- ▲ TELEPHONE
- △ DATA
- ▲ TELEPHONE AND DATA
- TV- TV CONNECTION
- TV/ DATA
- CD- CONDUIT FOR COMPONENT WIRING
- SP SPEAKER
- ₩ v 9MOKE/ CO DETECTOR
- BD 100 V SMOKE DETECTOR
- EXHAUST FAN
- LVP LOW VOLTAGE PANEL

 ALARM PANEL





SCALE NOTE: 18x24 PRINTS ARE TO SCALE AS NOTED. 11x17 PRINTS ARE NOT TO SCALE



RENAISSANCE RESIDENTIAL DESIGN, INC. RALEIGH, NC 27612 (919) 649-4128 WWW.RRDCAROLINA.COM

art of transforming your vision into reals RENAISSANCE RESIDENTIAL DESIGN, INC., RESERVES THE RIGHT TO MAKE MODIFICATIONS TO FLOOR PLANS, DIMENSIONS, MATERIALS, AND

RESERVES THE RIGHT TO MAKE MODIFICATIONS TO FLOOR PLANS, DIMENSIONS, MATERIALS, AND PECIFICATIONS ARE FOR THE PURPOSE OF CONVEYING AN ARCHITECTURAL CONCEPT ONLY.

MISSANCE RESIDENTIAL DESIGN. INC.

HEREDY EXPRESSY RESERVES ITS COMMON LAW COPYRIGHT AND OTHER PROPERTY RIGHTS IN THESE FLANS. HESE PLANS AND DRAWINGS ARE NOT TO BE REPRODUCED, CHANGED, OR COPIED IN ANY FORM OR MANNER WITHOUT FIRST OBTAINING THE EXPRESS WITHOUT FIRST OBTAINING THE EXPRESS WITHOUT FIRST OBTAINING THE EXPRESS HOTE RESIDENTIAL DESIGNS, INC., NOR ARE THEY TO BE ASSIGNED TO ANY THAID PRITY WITHOUT FIRST ORTAINING SALE



WEAVER HOMES CAROLINA COLLECTION HICKORY DRIVE LEFT


DATE: AUGUST 25, 2020

REV.: SCALE: 1/4" = 1'-0"

DRAWN BY: WG ENGINEERED BY:

REVIEWED BY:
SECOND FLOOR
ELCTRICAL

PLAN E-2

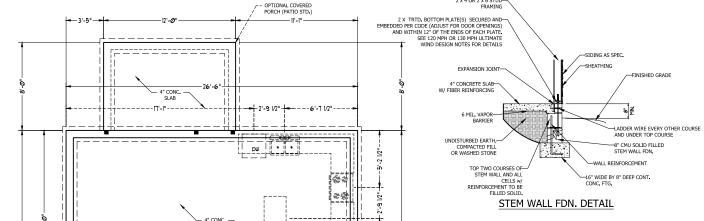

	MASONE	Y STEM WALL SPE	CIFICATIONS	
WALL HEIGHT (FEET)	MASONRY WALL TYPE			
	8" CMU	4" BRICK AND 4" CMU	4" BRICK AND 8" CMU	12" CMU
2' OR LESS	UNGROUTED	GROUT SOLID	UNGROUTED	UNGROUTED
3'	UNGROUTED	GROUT SOLID	UNGROUTED	UNGROUTED
4"	GROUT SOLID	GROUT SOLID w/ #4 REBAR @ 48" O.C.	GROUT SOLID	GROUT SOLID w/ #4 REBAR @ 64" O.0
5'	GROUT SOLID w/ #4 REBAR @ 36" O.C.	N/A	GROUT SOLID w/ #4 REBAR @ 36" O.C.	GROUT SOLID w/ #4 REBAR @ 64" O.0
6'	GROUT SOLID w/ #4 REBAR @ 24" O.C.	N/A	GROUT SOLID w/ #4 REBAR @ 24" O.C.	GROUT SOLID w/ #4 REBAR @ 64" O.0
7' OR MORE	ENGINEERED BASED ON SITE CONDITIONS			

STRUCTURAL NOTES:

- 1. TABLE ABOVE APPLIES TO HOUSE FOUNDATION ONLY, TABLE DOES NOT APPLY
- TO GARAGE FOUNDATION NOT COMMON TO HOUSE.

 2. TIE MULTIPLE WYTHES TOGETHER WITH LADDER WIRE @ 16" O.C. VERTICALLY.

 3. WALL HOT. IS MEASURED FROM TOP OF FOOTING TO TOP OF WALL.
- 3. WALL HGT. IS MEASURED FROM TOP OF FOOTING TO TOP OF WALL.

 PREP SLAB PER SSG6.21 AND ESSG5.22 BASE AND EXCEPTION OF THE 2018 NCRC

 5. MINIMUM 24* LAP SPLICE LENGTH.


 6. BACKFILL OF CLEAN #57/ #67 WASHED STONE IS PERMITTED.

 7. BACKFILL OF WELL DRAINED SAND-GRAVEL MIXTURE SOILS (45 PSF/FT BELOW)

- GRADE) CLASSIFIED AS GROUP 1 ACCORDING TO UNIFIED SOILS CLASSIFICATION SYSTEM IN ACCORDANCE WITH TABLE R405.1 OF THE 2018 NCRC ARE ALLOWABLE.
- LOCATE REBAR IN CENTER OF FOUNDATION WALL.
 WHERE REQUIRED, FILL BLOCK SOLID WITH TYPE "S" MORTAR OR 3000 PSI GROUT, USE OF "LOW LIFT GROUTING" METHOD REQUIRED WHEN FILLING

OPTIONAL CULTURED LA FONETH GROUT AT HEIGHTS OF 5' AND GREATER. VENEER (SEE ELEVATION PAGES FOR LOCATIONS AND CONDITIONS)

2 x 4 OR 2 x 6 STUD-

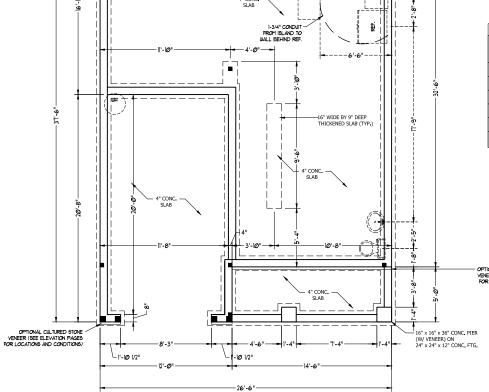

WEAVER HOMES CAROLINA COLLECTION CAROLINA COLL HICKORY DRIVE

RENAISSANCE

RESIDENTIAL DESIGN, INC.

RALEIGH, NC 27612 (919) 648-4128 WWW.RRDCAROLINA.COM

0

art of transforming your vision

DATE: AUGUST 25, 2020 REV -

SCALE: 1/4" = 1'-0"

DRAWN BY: WG

ENGINEERED BY-

REVIEWED BY:

STEMWALL SLAB FOUNDATION PLAN

SCALE NOTE: 18x24 PRINTS ARE TO SCALE AS NOTED. 11x17 PRINTS ARE NOT TO SCALE



ULTIMATE DESIGN WIND SPEED NOTES FOR LESS THAN 30' MEAN ROOF HEIGHT:

RESIDENTIAL CODE, 2018 EDITION.
2. FOR 120 MPH WIND ZONES INSTALL 1/2" ANCHOR BOLTS 6'-0" O.C. AND WITHIN 1'-0" FROM END OF

EACH CORNER. ANCHOR BOLTS MUST EXTEND A MINIMUM OF 7" INTO CONCRETE OR 15" INTO MASONRY, LOCATE BOLT WITHIN MIDDLE THIRD

3 FOR 130 MPH WIND ZONES INSTALL 1/2" ANCHOR BOLTS 4*-0" O.C. AND WITHIN 1*-0" FROM END OF EACH CORNER. ANCHOR BOLTS MUST EXTEND A

EACH CONNER, ANCHOR BOLLS MUST EXTEND A
MINIMUM OF 7" INTO CONCRETE OR 15" INTO
MASONRY, LOCATE BOLT WITHIN MIDDLE THIRD
OF PLATE WIDTH.
4. MEAN ROOF HEIGHT IS LESS THAN 30 FEET.

5. EXTERIOR WALLS DESIGNED FOR 120 OR 130 MPH WINDS.
6. INSTALL 7/16" OSB SHEATHING ON ALL EXTERIOR WALLS OF ALL STORIES IN ACCORDANCE WITH SECTION R602.10.3 OF THE NCRC, 2018 EDITION. 7. ENERGY EFFICIENCY COMPLIANCE AND

INSULATION VALUES OF THE BUILDING TO BE IN ACCORDANCE WITH CHAPTER 11 OF THE NCRC, 2018 EDITION. ANCHOR SPACING AND EMBEDMENT

120 MPH

6'-0" O C

NOTE: HORIZONTAL FOOTING REBAR REQUIRED IN HIGH WIND ZONES ONLY (140-150 MPH)

4'-0" O.C.

1. STRUCTURAL DESIGN PER NORTH CAROLINA

OF PLATE WIDTH

WIND ZONE

SPACING

-4 x 4 TRTD. POST \boxtimes 16" TRUSSES AS SPECIFIED 16" TRUSSES AS SPECIFIED ᆫ 16" TRUSSES AS SPECIFIED 16" TRUSSES AS SPECIFIED 16" TRUSSES AS SPECIFIED (2) 16" LVL AS SPECIFIED ROOF TRUSSES AS SPECIFIED -4 x 4 TRTD. POST MIN. (TYP.) PACK PORCH BEAM OUT TO 8" --WIDTH (TYP.)

STRUCTURAL NOTES:

- 1. ALL FRAMING LUMBER TO BE SPF #2 (UNO). ALL TREATED LUMBER TO BE SYP #2 (UNO.)

 2. ALL LOAD BEARING HEADERS TO BE (2) 2 x 4 (UNO).

 3. INSTALL AN EXTRA JOIST UNDER WALLS PARALLEL TO FLOOR JOISTS
- WINDOW AND DOOR HEADERS TO BE SUPPORTED w/ (1) JACK STUD AND (1) KING STUD EA. END (UNO.). SEE TABLE R602.7.5 FOR ADDITIONAL KING STUD
- STUD EN CITIED (UNIT). THE FRAME HAVE TO STUDY FOR THE STUDY FOR T
- ALL 4 X 4 POSTS SHALL BE ANCHORED TO SLABS W/ SIMPSON ABU44 POST BASES
 (OR EQUAL) AND 6 X 6 POSTS W/ ABU66 POST BASES (OR EQUAL) (UNO). ALL 4 X 4 AND 6 X 6 POSTS TO BE INSTALLED WITH 700 LB CAPACITY UPLIFT CONNECTORS AT TOP (UNO.)
- 7. FOR FIBERGLASS, ALUMINUM, OR COLUMN ENG. BY OTHERS, SECURE TO SLAB WA FOR FIBERGLASS, ALUMINUM, OR COLUMN ENG. BY OTHERS, SECURE ID SLAB W (2) METAL ANGLE USING 2" COMC. SCREWS, FASTEM ANGLES TO COLUMNS WITH 1/4" THROUGH BOLTS W, NUTS AND WASHERS, LOCATE ANGLES ON OPPOSITE SIDES OF COLUMN, THROUGH BOLTS MUST BE INSTALLED PRIOR TO SETTING COLUMN.

BRACE WALL PANEL NOTES:

EXTERIOR WALLS: ALL EXTERIOR WALLS TO BE SHEALTHED WITH CS-WSP OR CS-SFB IN ACCORDANCE WITH SECTION R602.10.3 UNLESS NOTED OTHERWISE.

REQUIRED LENGTH OF BRACING: REQUIRED BRACE WALL LENGTH FOR EACH SIDE OF THE CIRCUMSCRIBED RECTANGLE ARE
INTERPOLATED PER TABLE R602-10-3. METHODS CS-WSP AND CS-SFB CONTRIBUTE THIER ACTUAL LENGTH, METHOD GB CONTRIBUTES 0.5 ITS ACTUAL LENGTH. METHOD PF CONTRIBUTES 1.5 TIMES ITS ACTUAL LENGTH.

GYPSUM: ALL INTERIOR SIDES OF EXTERIOR WALLS AND BOTH SIDES OF INTERIOR WALLS TO HAVE 1/2" GYPSUM INSTALLED. WHEN NOT USING METHOD GB GYPSUM TO BE FASTENED PER TABLE R702.3.5. METHOD GB TO BE FASTENED PER TABLE R602.10.1.

HD: 800 LBS HOLD DOWN DEVICE FASTENED TO THE EDGE OF THE BRACE WALL PANEL NEAREST TO THE CORNER

METHODS: PER TABLE R602.10.1

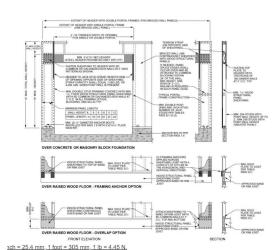


FIGURE R602.10.1

METHOD PF-PORTAL FRAME CONSTRUCTION

SCALE NOTE: 18x24 PRINTS ARE TO SCALE AS NOTED. 11x17 PRINTS ARE NOT TO SCALE



RENAISSANCE RESIDENTIAL DESIGN, INC.

RALEIGH, NC 27612 (919) 648-4128 WWW.RRDCAROLINA.COM

art of transforming your vision in



COLLECTION WEAVER HOMES CAROLINA COLLE HICKORY DRIVE L

REV -

SCALE: 1/4" = 1'-0" DRAWN BY: WG

ENGINEERED BY-

REVIEWED BY:

SECOND FLOOR FRAMING PLAN

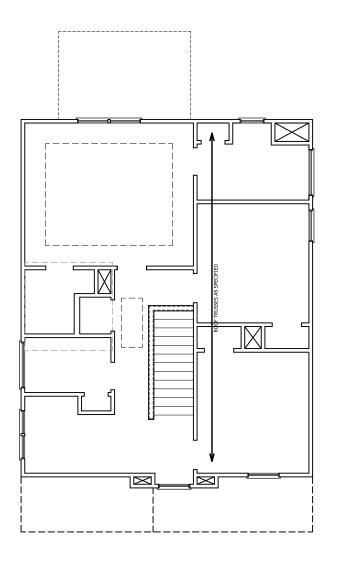


TABLE R602.7.5 MINIMUM NUMBER OF FULL HEIGHT STUDS AT EACH END OF HEADERS IN EXTERIOR WALLS

HEADER SPAN (FEET)	MAXIMUM STUD SPACING (INCHES) (PER TABLE R602.3(5)					
	16	24				
UP TO 3'	1	1				
4'	2	1				
8'	3	2				
12'	5	3				
16'	6	4				

STRUCTURAL NOTES:

- ALL FRAMING LUMBER TO BE SPF #2
 (UNO). ALL TREATED LUMBER TO BE SYP #2 (UNO.)
- 2. ALL LOAD BEARING HEADERS TO BE (2) 2 x 6 (UNO).
- 3. WINDOW AND DOOR HEADERS TO BE SUPPORTED w/ (1) JACK STUD AND (1) KING STUD EA. END (UNO.). SEE TABLE R602.7.5 FOR ADDITIONAL KING STUD REQUIREMENTS.
- SQUARES DENOTE POINT LOADS WHICH REQUIRE SOLID BLOCKING TO GIRDER OR FOUNDATION. ALL SQUARES TO BE (2) STUDS (UNO.)

DSP - DOUBLE STUD POCKET TSP - TRIPLE STUD POCKET



RESIDENTIAL DESIGN, INC.
RALEIGH, NC 27812
(919) 649-4128
WWW.RRDCAROLINA.COM
The art of transforming your vision into realty



WEAVER HOMES CAROLINA COLLECTION HICKORY DRIVE LEFT

DATE: AUGUST 25, 2020


REV.:

SCALE: 1/4" = 1'-0" DRAWN BY: WG

ENGINEERED BY: REVIEWED BY:

ATTIC FLOOR FRAMING PLAN

S-3

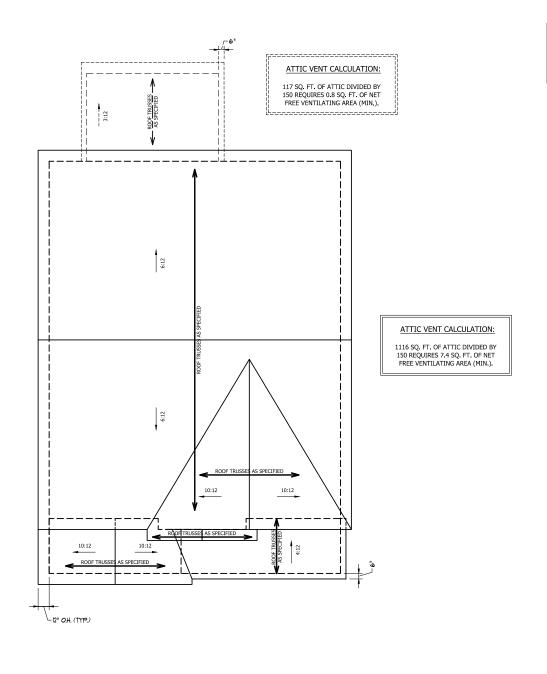

ATTIC VENT CALCULATION:

1040 SQ. FT. OF ATTIC DIVIDED BY 150 REQUIRES 6.9 SQ. FT. OF NET FREE VENTILATING AREA (MIN.).

STRUCTURAL NOTES:

- ALL FRAMING LUMBER TO BE #2 SPF (UNO).
 HIP SPLICES ARE TO BE SPACED A MIN. OF 8'-0".
 FASTEM MEMBERS WITH THREE ROWS OF 12d
 MAILS & 16" OC (TR).
- NAILS @ 16" O.C. (TYP.)

 3. STICK FRAME OVER-FRAMED ROOF SECTIONS W/
 2 x 8 RIDGES, 2 x 6 RAFTERS @ 16" O.C. AND
 FLAT 2 x 10 VALLEYS OR USE VALLEY TRUSSES.
- FASTEN FLAT VALLEYS TO RAFTERS OR TRUSSES WITH SIMPSON H.2.5A HURRICANE TIES ∰ 32° O.C. MAX. PASS HURRICANE TIES THROUGH NOTCH IN ROOF SHEATHING. EACH RAFTER IS TO BE FASTENED TO THE FLAT VALLEY WITH A MIN. OF (6) 12d TOE NAILS.
- REFER TO SECTION R802,11 OF THE 2018 NCRC FOR REQUIRED UPLIFT RESISTANCE AT RAFTERS AND TRUSSES.



RENAISSANCE RESIDENTIAL DESIGN, INC.

RALEIGH, NC 27612 (919) 648-4128 WWW.RRDCAROLINA.COM

e art of transforming your vision into reality: RENAISSANCE RESIDENTIAL DESIGN, INC. RESERVES THE RIGHT TO MAKE

RESERVES THE RIGHT TO MAKE CONFICATIONS TO FLOOR PLANS, DIMENSIONS, MATERIALS, AND ECIFICATIONS WITHOUT NOTICE, HESE DRAWINGS ARE FOR THE PURPOSE OF CONNEYING AN RCHITECTURAL CONCEPT ONLY.

EMASSANCE RESIDENTIAL DESIGN. INC.
HERBEY EXPRESS. Y RESERVES TIS
RESIDENCE AND STATE OF THE STA



AND THE SECOND CONTINUES OF TH

WEAVER HOMES CAROLINA COLLECTION HICKORY DRIVE LEFT


REV.:

SCALE: 1/4" = 1'-0" DRAWN BY: WG

ENGINEERED BY: REVIEWED BY:

ROOF PLAN

C 1

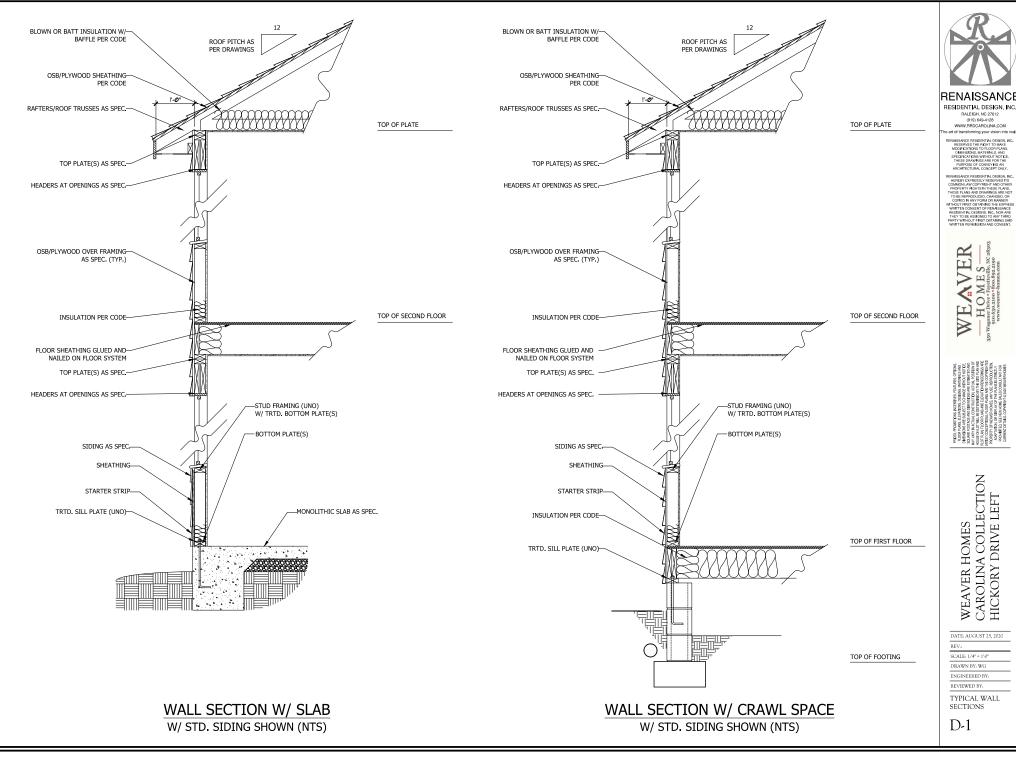

CAROLINA COLLECTION HICKORY DRIVE LEFT

TYPICAL WALL