

SCALE NOTE: 18x24 PRINTS ARE
TO SCALE AS NOTED.
11x17 PRINTS ARE NOT TO SCALE



RENAISSANCE

RESIDENTIAL DESIGN, INC. RALEIGH, NC 27612 (919) 649 4128 WWW RRDCAROLINA COM

WWW RRDCAROLINA COM The art of transforming your vision into real

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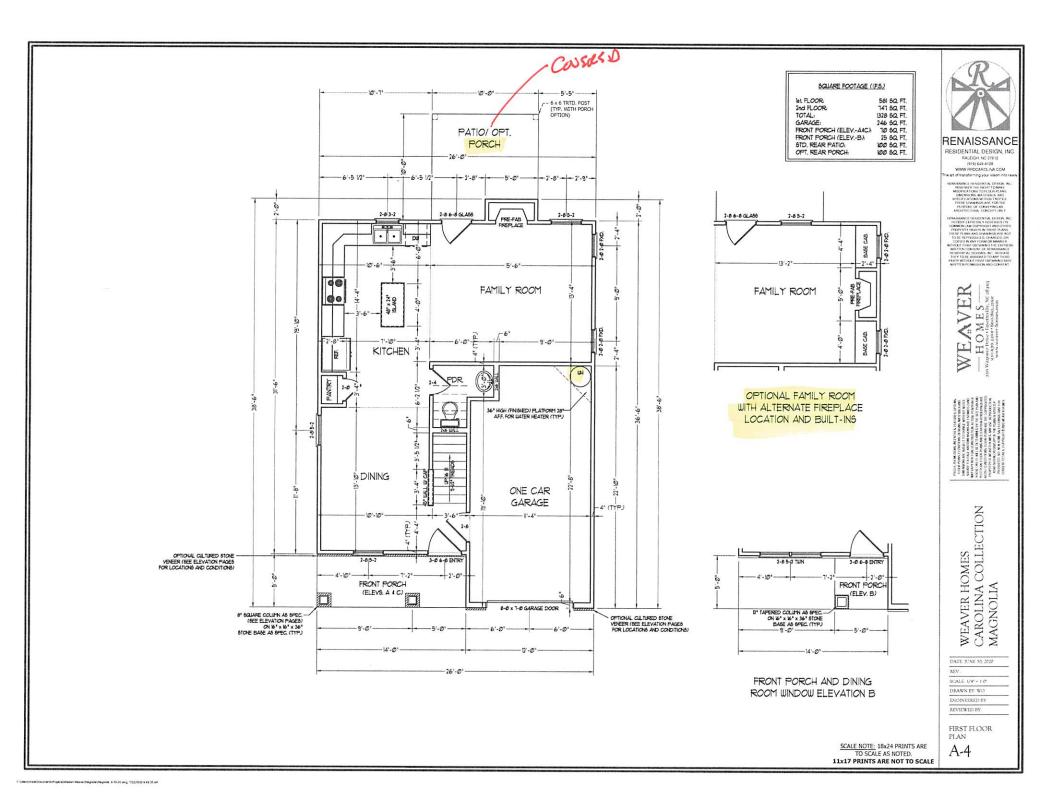
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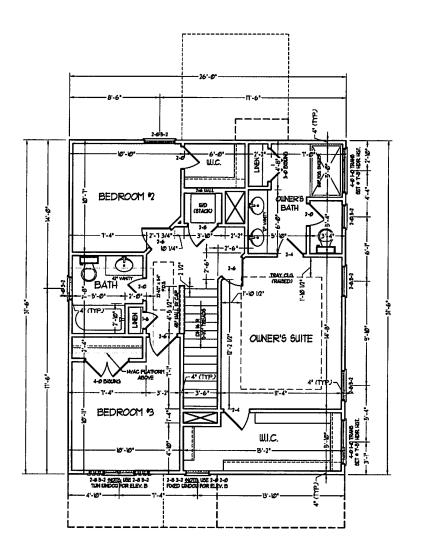
WEAVER HOMES CAROLINA COLLECTION MAGNOLIA

DATE JUNE 30, 2020
REV
SCALE 1/4" - 1/0"
DRAWN BY WO
ENGINEERED BY

REVIEWED BY

C-ELEVATIONS A-3





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WEAVER HOMES CAROLINA COLLECTION MAGNOLIA

DATE JUNE 30, 2020

SCALE 1/4° - 1'0"

DRAWN BY, WO ENGINEERED BY REVIEWED BY

SECOND FLOOR PLAN

A-5

SCALE NOTE: 18x24 PRINTS ARE TO SCALE AS NOTED. 11x17 PRINTS ARE NOT TO SCALE

ELECTRICAL LAYOUT NOTES:

- U BLOCK AND SINE FOR ALL CELNS HAND FER FLAN
- 2) VANTY LIGHTS TO BE SET # 30" AFF. (TYP)
- 3) ADDITIONAL EXTERIOR CUILETS RECURED BY CODE TO BE LOCATED BY ELECTRICIAN
- AJ PLACE BUTGLES S' CHINU FROM ROUSH OPENNIA.

ELECTRICAL LEGEND

- SO VOITLET
- # MO Y GET CUTLET
- CO CO V BASEBOARD OUTLET
- # 4FLEX
- COUNTER OR FLOOR HOUNTED
- ## COUNTER OR FLOOR HOUNTED NOV GA
- C LEATHERFROOF
- → 220 V CUILET
- IN NO V DEDICATED CIRCUIT
- # 220 V DEDIGATED CROUT
- THE SPECIAL PURPOSE (240 V, ETC.)
- THE BATT HONEL FROM
- CELING HOUNT LIGHT
- PRODUCT LIGHT
- RECESSED CAN LIGHT
- THE CAN LIGHT
- EMERATT FROM



- EB Kroop DRHI
- BUTCH
- D DIMER COTTON
- ▲ TELEPHONE
- △ DATA
- A TELEPHONE AND DATA
- M- TY CONSISTION
- E TV/ DATA
- ET- CONDUCT FOR COMPONENT LINOUS
- M SPEAKER
- NO V SHOKE/ OH DETECTOR
- NO V SMOKE DETECTOR
- EXHAUST FAN


LOS VOLTAGE PAREL


ALARM PAREL






CELING FAN EV LIGHT

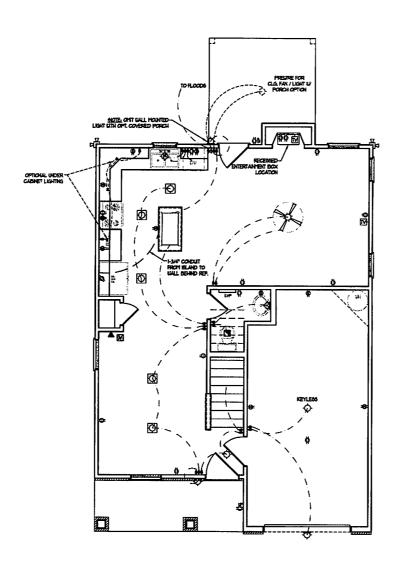

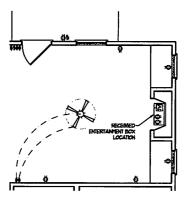

OPTIONAL FAMILY ROOM WITH ALTERNATE FIREPLACE LOCATION AND BUILT-INS

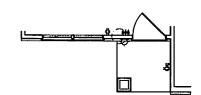

FRONT PORCH AND DINING ROOM WINDOW ELEVATION B

SCALE NOTE: 18x24 PRINTS ARE TO SCALE AS NOTED. 11x17 PRINTS ARE NOT TO SCALE



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WEAVER HOMES CAROLINA COLLECTION MAGNOLIA

DATE JUNE 10, 2020 REV.

SCALE I/4" - 1'0"

DRAWN BY WO ENGINEERED BY

REVIEWED BY FIRST FLOOR **ELECTRICAL** PLAN

E-1

ELECTRICAL LAYOUT NOTES.

- U BLOCK AND LIKE FOR ALL CELNG FAND PER FLAN
- 2) VANTY LIGHTS TO BE SET # 90° AFF, (TYP)
- 3) ADDITIONAL EXTERIOR CUILETS RECLINED BY CODE TO SE LOCATED BY ELECTRICAL
- 4) PLACE SUTGLES & CHINI FROM ROUGH OFFINISA

ELECTRICAL LEGEND

- ◆ 10 v cuttet
- S MO V GPI CUTLET
- TO Y SOUTCHED CATLET
- 10 Y DASEDOARD CUILLET
- 4 HEX
- COMMER OR FLOOR HOLNTED
- ## COUNTER OR FLOOR HOUNTED NOV GR
- CEATHERPROOF
- →
 220 V CUTLET
- # NO V DEDICATED CIRCUIT
- # 220 V DEDICATED CIRCUIT
- THE OFFICIAL PURPOSE (140 V, ETC.)
- THE BALL HOWIT LIGHT
- CELING HOURT LIGHT
- PENDANT LIGHT
- RECESSED CAN LIGHT
- MIN CAN LIGHT
- EMEDATT FIRM

FLUORESCENT LIGHT ----- UNDERCABNET LIGHT




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- TV/ DATA
- 22- CONDUIT FOR COMPONENT URBUS
- F SPEAKER
- BO V SMOKE/ CO DETECTOR
- 10 V CHOICE DETECTOR
- EXCLUSION FAN







CELNG FAN SY LIGHT

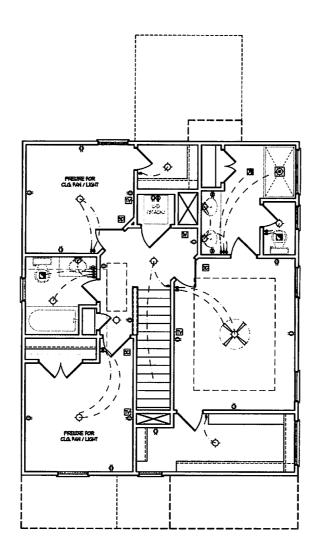



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WEAVER HOMES CAROLINA COLLECTION MAGNOLIA

DATE JUNE 30, 2020


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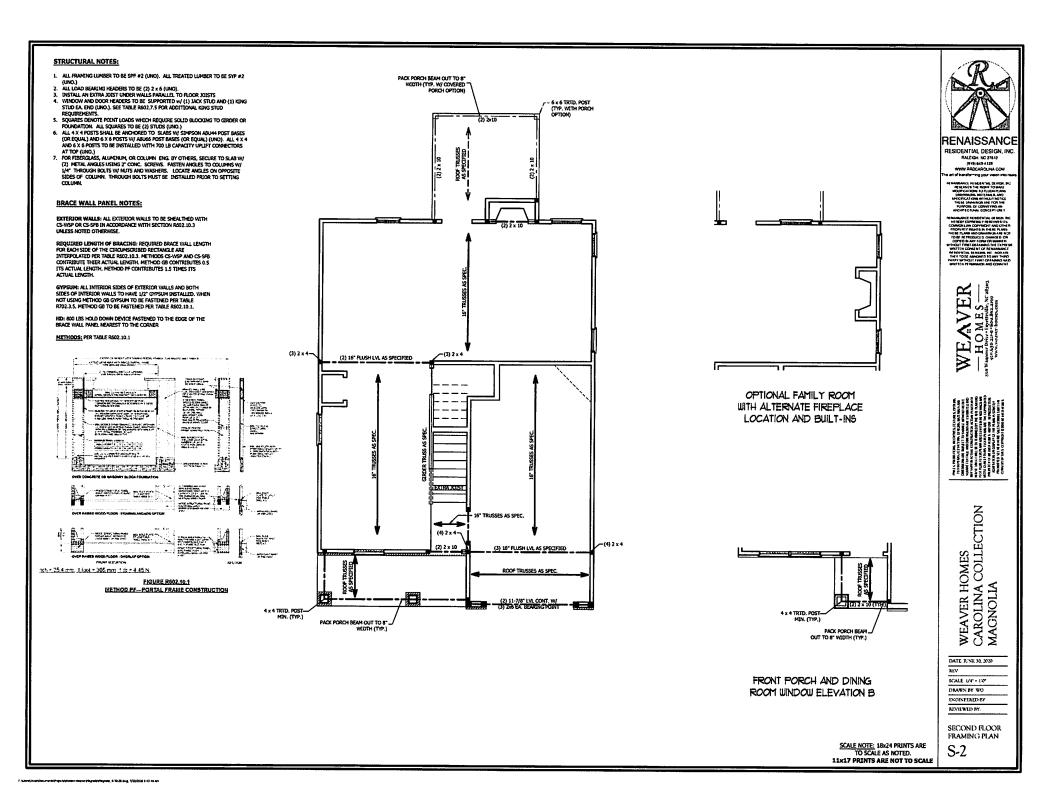
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PLAN E-2

SCALE NOTE: 18x24 PRINTS ARE TO SCALE AS NOTED. 11x17 PRINTS ARE NOT TO SCALE





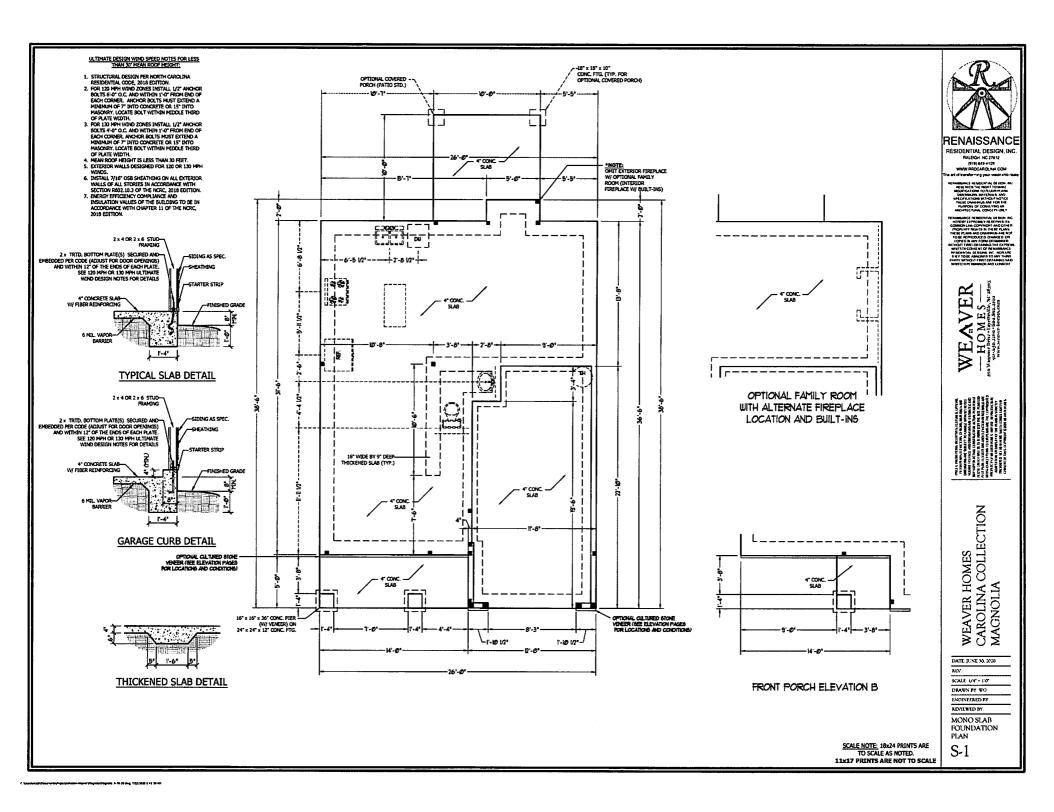


TABLE R602.7.5
MINIMUM NUMBER OF FULL HEIGHT STUDS

AT EACH END C	F HEADERS IN E	KIERIOR WALL	
HEADER SPAN (FEET)	MAXIMUM STUD SPACING (INCHES (PER TABLE R602.3(5)		
(,,,,	16	24	
UP TO 3"	1	1	
4"	2	1	
8'	3	2	
12'	5	3	
16'	6	4	

STRUCTURAL NOTES:

- 1. ALL FRAMING LUMBER TO BE SPF #2
 (UNO). ALL TREATED LUMBER TO BE SYP
 #2 (UNO.)
 2. ALL LOAD BEARING HEADERS TO BE (2) 2
- x 6 (UNO).
- x 6 (UNO).

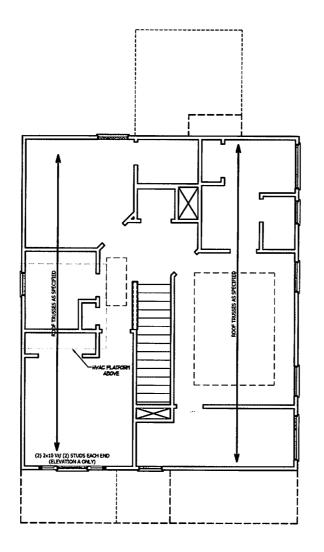 X G(UNO).

 WINDOW AND DOOR HEADERS TO BE SUPPORTED w/ (1) JACK STUD AND (1) KING STUD EA. END (UNO.). SEE TABLE REG2.7.5 FOR ADDITIONAL KING STUD REQUIREMENTS.

 SQUARES DENOTE POINT LOADS WHICH REQUIRE SOLID BLOCKING TO GIRDER OR FOUNDATION. ALL SQUARES TO BE (2) STUDS (UND.)
- STUDS (UNO.)

DSP - DOUBLE STUD POCKET TSP - TRIPLE STUD POCKET



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DATE JUNE 30, 2020


SCALE 1/4" - FOT DRAWN BY WO

ENGINEERED BY REVIEWED BY

ATTIC FLOOR FRAMING PLAN

S-3

SCALE NOTE: 18x24 PRINTS ARE TO SCALE AS NOTED. 11x17 PRINTS ARE NOT TO SCALE

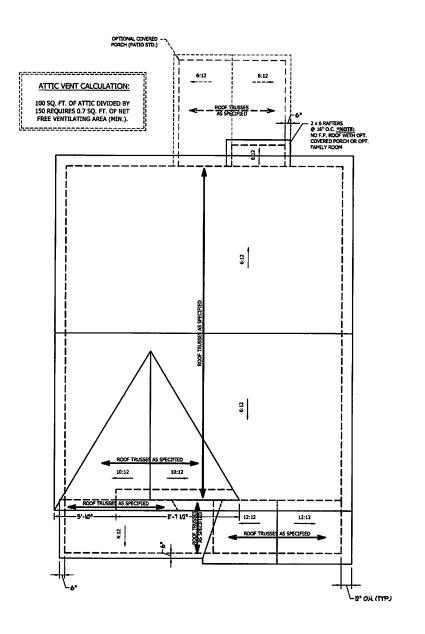

ELEVATION C

ATTIC VENT CALCULATION:

1040 SQ. FT. OF ATTIC DIVIDED BY 150 REQUIRES 6.9 SQ. FT. OF NET FREE VENTILATING AREA (MIN.).

STRUCTURAL NOTES:

- ALL FRANCING LUMBER TO BE #2 SPF (UNO).
 HIP SPLICES ARE TO BE SPACED A MIN. OF 8'-0'.
 FASTEN MEMBERS WITH THREE ROWS OF 12d NAILS @ 16" O.C. (TYP.)
- 3. STICK FRAME OVER-FRAMED ROOF SECTIONS W/ 2 x 8 RIDGES, 2 x 6 RAFTERS @ 16" O.C. AND PLAT 2 x 10 VALLEYS OR USE VALLEY TRUSSES. 4. FASTEN PLAT VALLEYS TO RAFTERS OR TRUSSES
- WITH SIMPSON H2.SA HURRICANE TIES Q 32"

 O.C. MAX. PASS HURRICANE TIES THROUGH

 NOTCH IN ROOF SHEATHING. EACH RAFTER IS MIN. OF (6) 12d TOE NAILS.
- REFER TO SECTION R802.11 OF THE 2018 NORC FOR REQUIRED UPLIFT RESISTANCE AT RAFTERS



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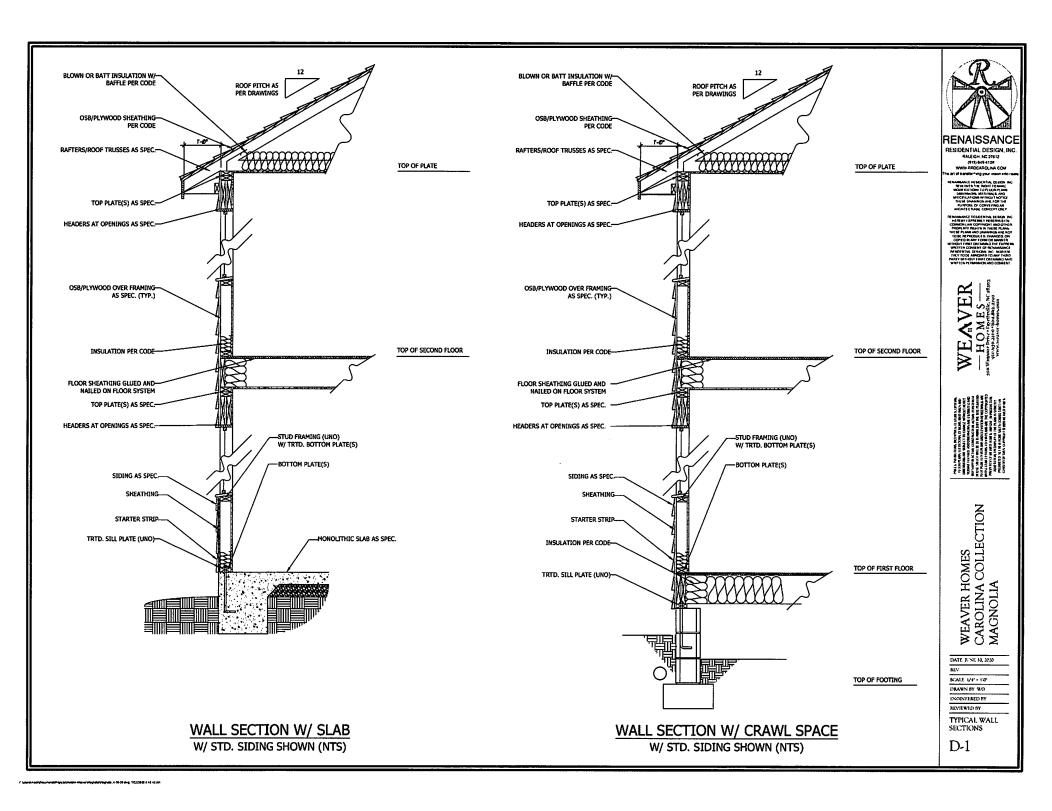
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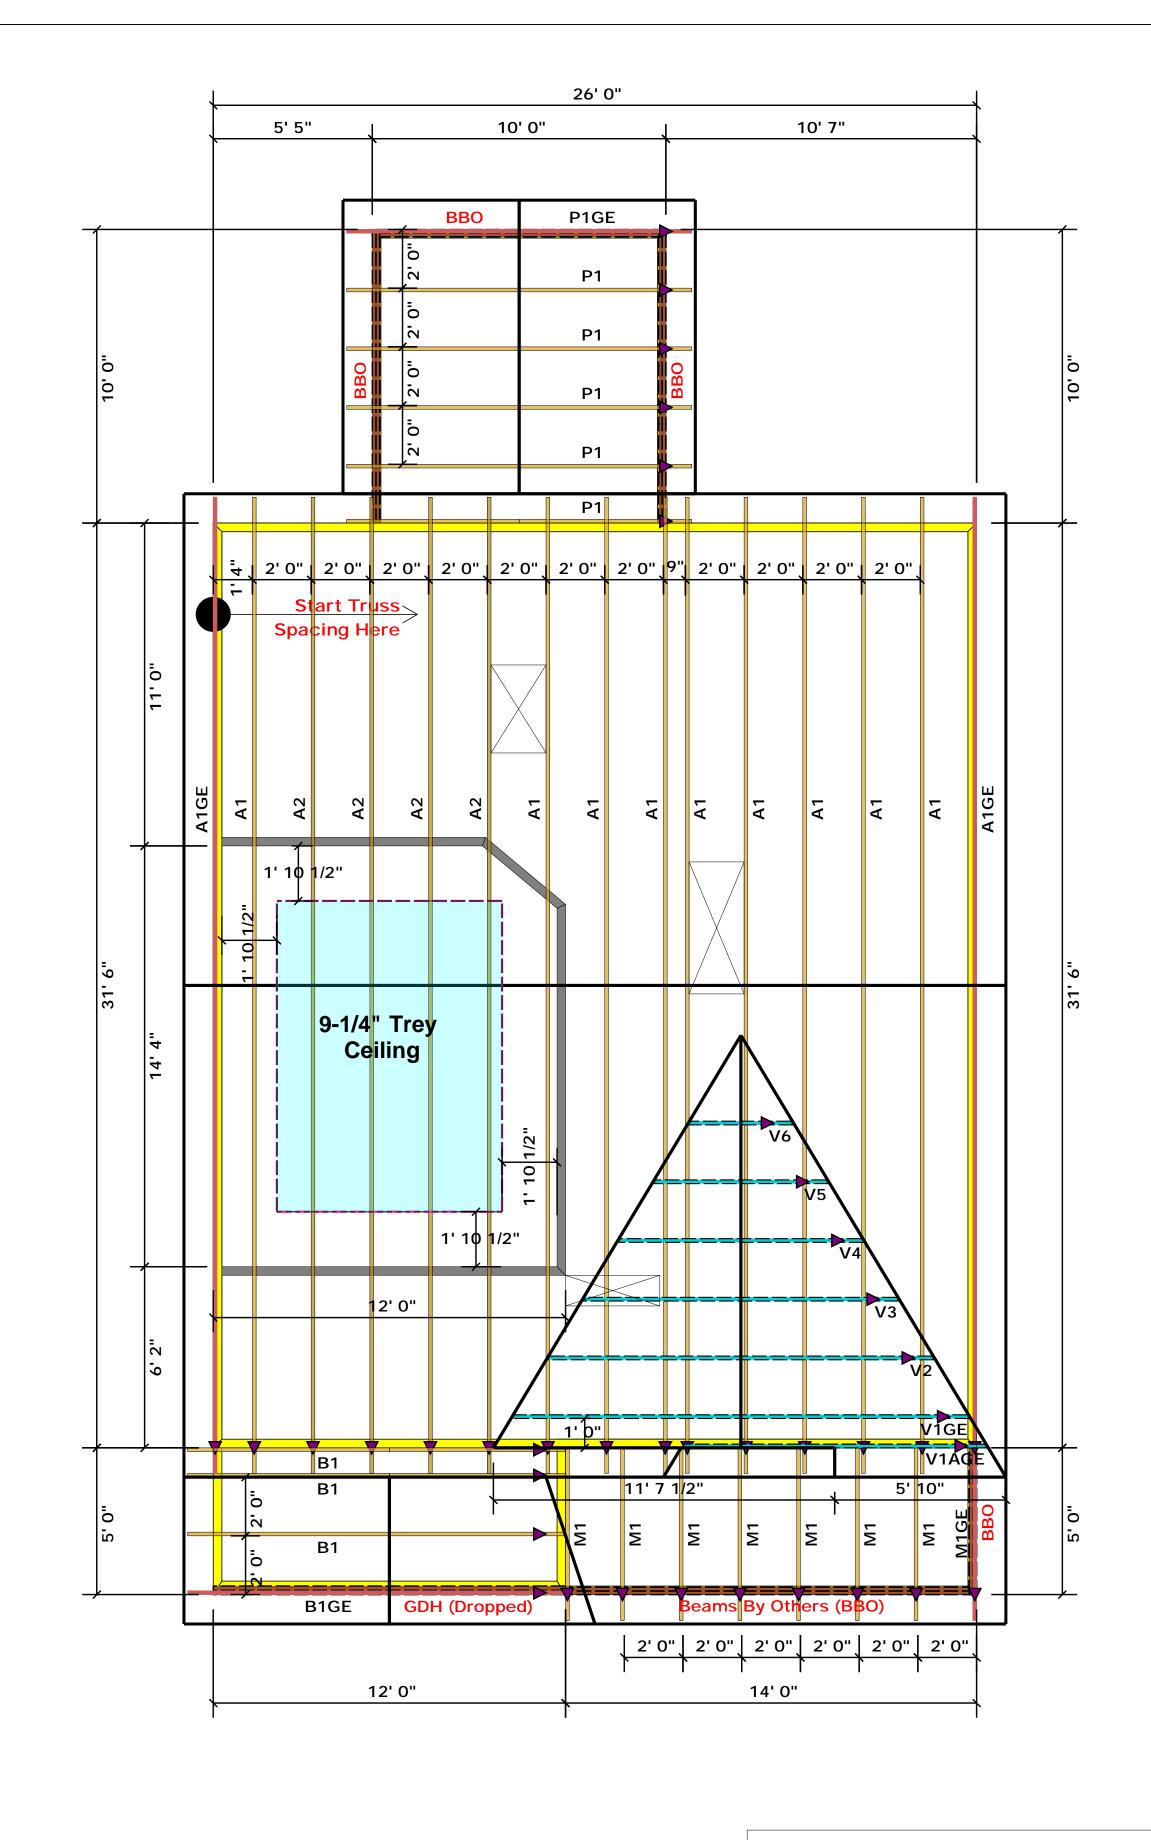
SCALE 1/4" - FO

DRAWN BY WO

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ROOF PLAN ELEVATION · C





All Truss Reactions are Less than 3,000 lbs. Unless Noted Otherwise.

) -

-- Denotes Reaction Greater than 3,000 lbs.
Reaction / # of Studs

▲ = Denotes Left End of Truss (Reference Engineered Truss Drawing)

J1220-5682

LOAD CHART FOR JACK STUDS
(BASED ON MALES 850/53) A 60)
MARKE OF JACK STUDO ACO 1980/6 (A COD OF FEADER/6000E)

2550 1 5100 2

7650 3

10200 4 12750 5

15300 6

3400

6600 2

10200 3

13600 4

17000 5

JOB#

1700 1 3400 2

5100 3

Truss Placement Plan SCALE: NTS

SALES REP. Lenny Norris

BUILDER	Weaver Development	CITY / CO.	Dunn / Harnett	THIS IS These true the building
JOB NAME	Lot 66 Thomas Farm	ADDRESS	Lot 66 Thomas Farm	is respons the overall walls, and regarding
PLAN	Magnolia Elev. C	MODEL	Roof	Bearing represcripti
SEAL DATE	Seal Date	DATE REV.	/ /	(derived foundation than 3000 be retained
QUOTE #	Quote #	DRAWN BY	Christine Shivy	specified retained t
				Ciano

THIS IS A TRUSS PLACEMENT DIAGRAM ONLY.

These trusses are designed as individual building components to be incorporated into the building design at the specification of the building designer. See individual design sheets for each truss design identified on the placement drawing. The building designer is responsible for temporary and permanent bracing of the roof and floor system and for the overall structure. The design of the truss support structure including headers, beams, walls, and columns is the responsibility of the building designer. For general guidance regarding bracing, consult BCSI-B1 and BCSI-B3 provided with the truss delivery package or online @ sbcindustry.com


Bearing reactions less than or equal to 3000# are deemed to comply with the prescriptive Code requirements. The contractor shall refer to the attached Tables (derived from the prescriptive Code requirements) to determine the minimum foundation size and number of wood studs required to support reactions greater than 3000# but not greater than 15000#. A registered design professional shall be retained to design the support system for any reaction that exceeds those specified in the attached Tables. A registered design professional shall be retained to design the support system for all reactions that exceed 15000#.

Christine Shivy

Fay: (910) 864-8787

Fax: (910) 864-4444



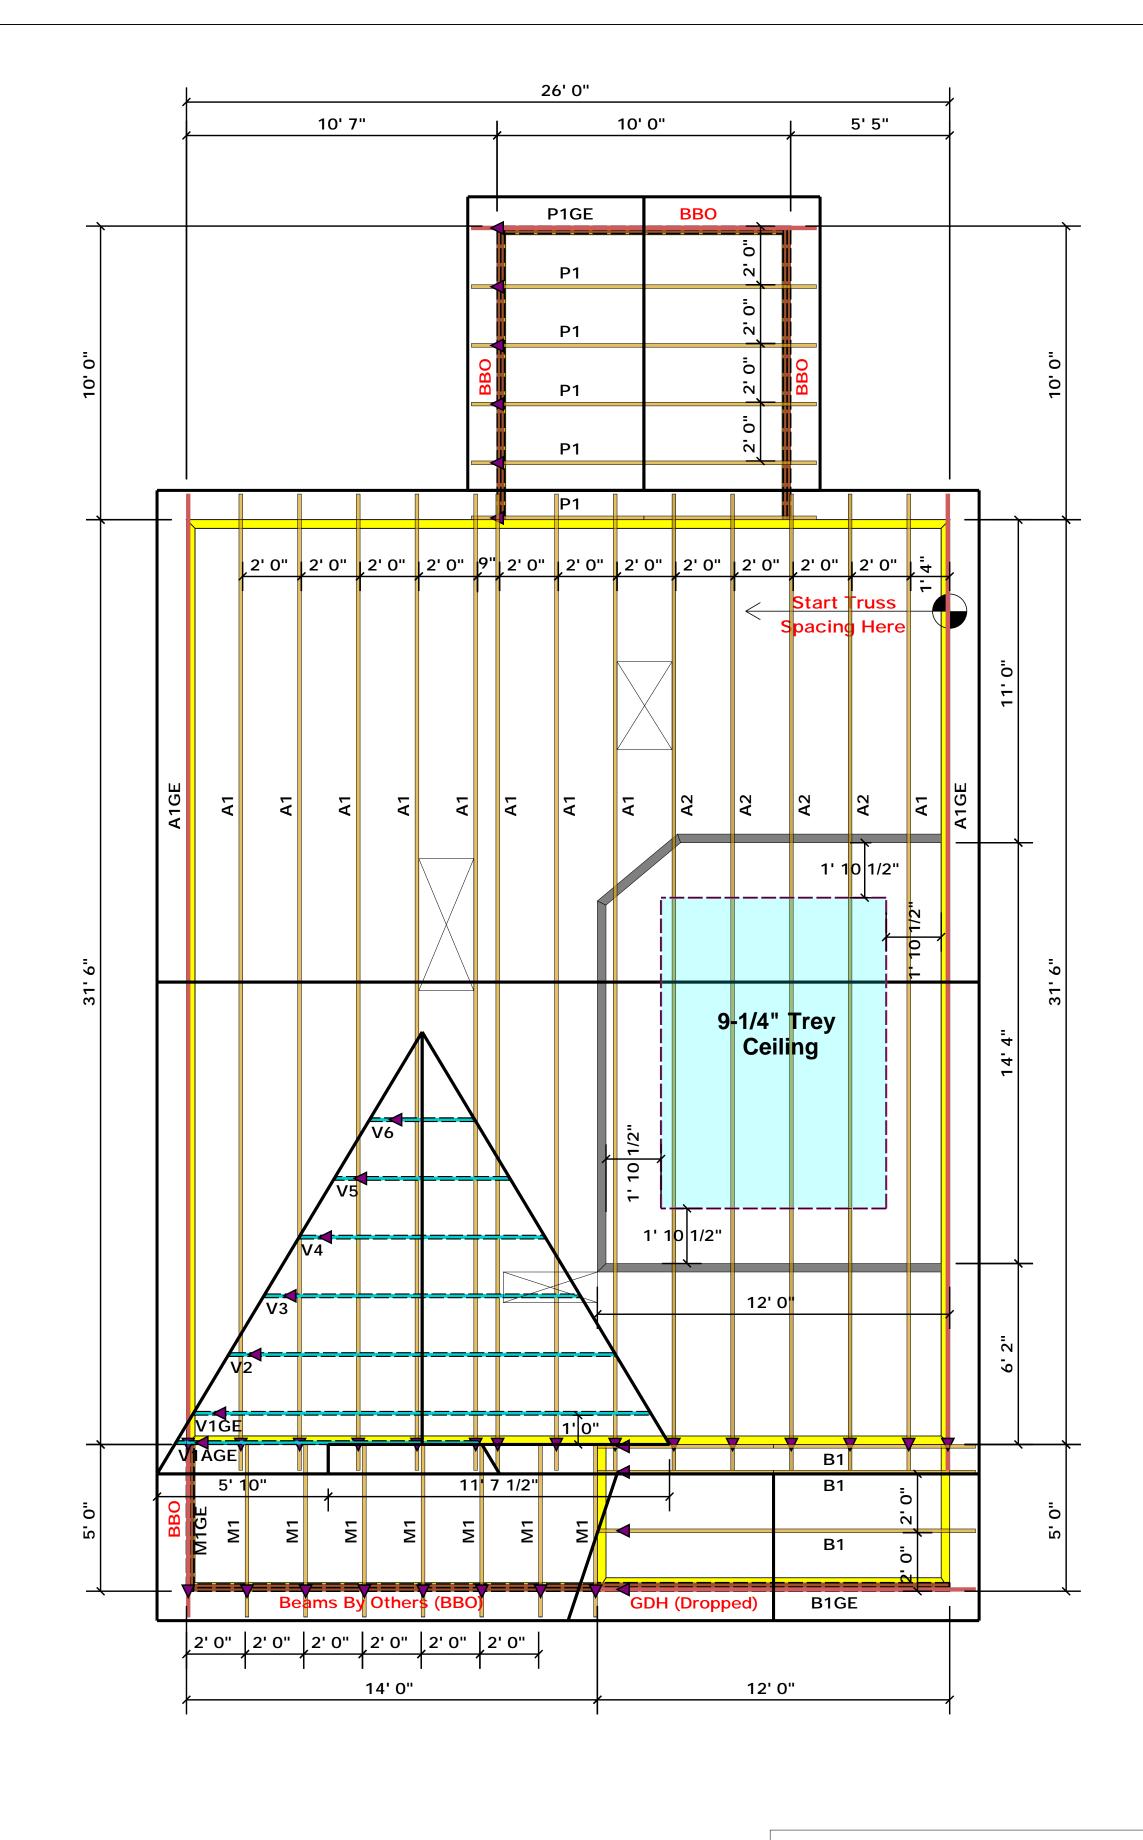

All Truss Reactions are Less than 3,000 lbs. Unless Noted Otherwise.

-- Denotes Reaction Greater than 3,000 lbs. Reaction / # of Studs

▲ = Denotes Left End of Truss (Reference Engineered Truss Drawing)

LOAD CHART FOR JACK STUDS (BANES ON FABLES (2002-51) A (6)) NUMBER OF THEIR STUDE REQUIRED (6) CA CAD OF FEADER/SECROES

2550 1 5100 2

7650 3

10200 4 12750 5

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6600 2

10200 3

13600 4

17000 5

1700 1 3400 2

5100 3

Truss Placement Plan SCALE: NTS


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BUILDER	Weaver Development	CITY / CO.	Dunn / Harnett	THIS IS A TRUSS PLACEMENT DIAGRAM ONLY. These trusses are designed as individual building components to be incorposed the building design at the specification of the building designer. See individual sheets for each truss design identified on the placement drawing. The build
JOB NAME	Lot 66 Thomas Farm	ADDRESS	Lot 66 Thomas Farm	is responsible for temporary and permanent bracing of the roof and floor sy the overall structure. The design of the truss support structure including he walls, and columns is the responsibility of the building designer. For genera regarding bracing, consult BCSI-B1 and BCSI-B3 provided with the truss de
PLAN	Magnolia Elev. C	MODEL	Roof	or online @ sbcindustry.com Bearing reactions less than or equal to 3000# are deemed to comply prescriptive Code requirements. The contractor shall refer to the attractor shall refer to the
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QUOTE #	Quote #	DRAWN BY	Christine Shivy	specified in the attached Tables. A registered design professional shretained to design the support system for all reactions that exceed 1
JOB#	J1220-5682	SALES REP.	Lenny Norris	Christine Shivy Christine Shivy

GRAM ONLY.

TRUSSES & BEAMS Reilly Road Industrial Park Fayetteville, N.C. 28309 Phone: (910) 864-8787 Fax: (910) 864-4444

соттесн

ROOF & FLOOR

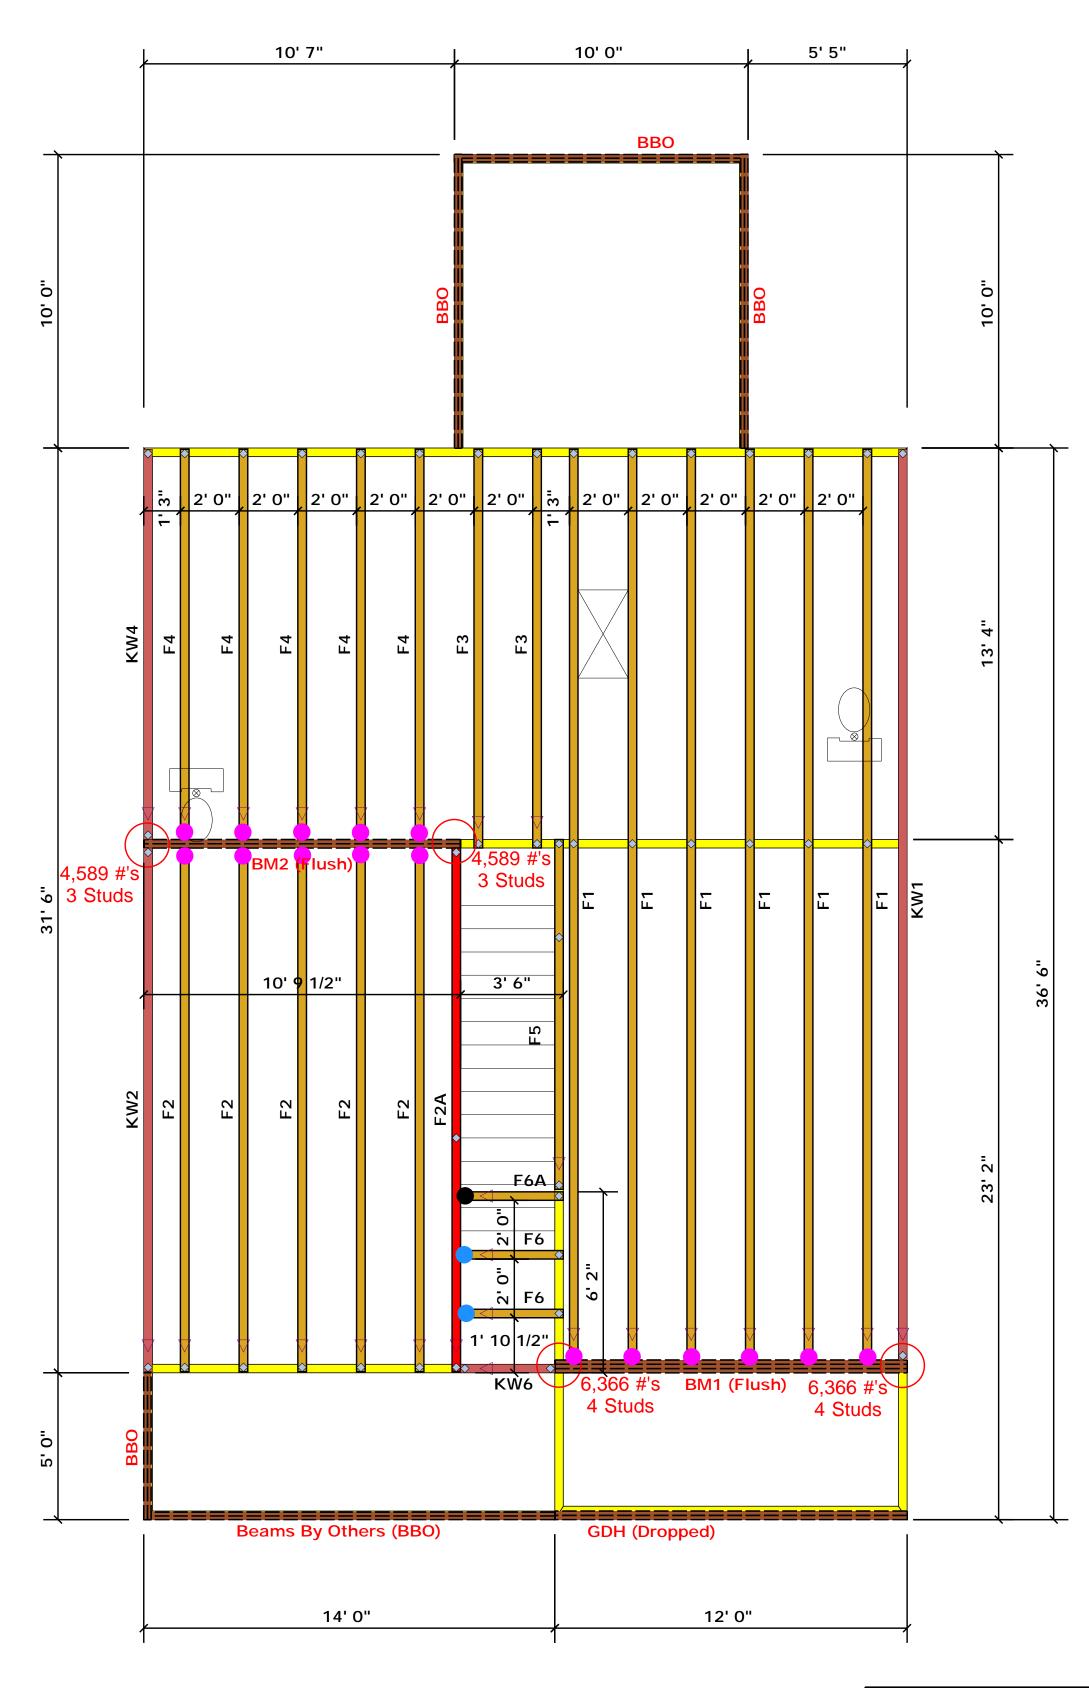

= HUS410 (Qty. 16)= MSH422 (Qty. 2)= MSH422IF (Qty. 1)

Truss Placement Plan SCALE: NTS

▲= Denotes Left End of Truss (Reference Engineered Truss Drawing)

Products						
PlotID	Length	Product	Plies	Net Qty		
GDH (Dropped)	12' 0"	1-3/4"x 11-7/8" LVL Kerto-S	2	2		
BM1 (Flush)	12' 0"	1-3/4"x 16" LVL Kerto-S	3	3		
BM2 (Flush)	11' 0"	1-3/4"x 16" LVL Kerto-S	2	2		

All Truss Reactions are Less than 3,000 lbs. Unless Noted Otherwise.

-- Denotes Reaction Greater than 3,000 lbs.

Reaction / # of Studs

L						_	_	
LOAD CHART FOR JACK STUDS MANFO ON TABLES RESOLUTE ON THE CHARLES OF LACK STUDY OF CALCUS OF		BUILDER	Weaver Development	CITY / CO.	Dunn / Harnett	THIS IS A TRUSS PL. These trusses are design the building design at the sheets for each truss desi		
	z Ž\$	PEADER/60RDER	to stude FOR	JOB NAME	Lot 66 Thomas Farm	ADDRESS	Lot 66 Thomas Farm	is responsible for tempora the overall structure. The walls, and columns is the regarding bracing, consul
	CONTRINCTO (0° TO) (0° TO) (0° TO) (0° TO)	BND PENCTION (ICP TO) PEG TS TUDS FOR	S S	PLAN	Magnolia Elev. C	MODEL	Floor	or online @ sbcindustry.co Bearing reactions less t prescriptive Code require
	3400 2 5100 3	2550 1 5100 2 7650 3	3400 ! 6600 2 10200 3	SEAL DATE	Seal Date	DATE REV.	/ /	(derived from the presonant foundation size and nurthan 3000# but not great be retained to design the
	8500 5 10200 6	10200 4 12750 5 15300 6	13600 4 17000 5	QUOTE #	Quote #	DRAWN BY	Christine Shivy	specified in the attacher retained to design the s
	11900 7 13600 8 15300 9			JOB#	J1220-5683	SALES REP.	Lenny Norris	Signature

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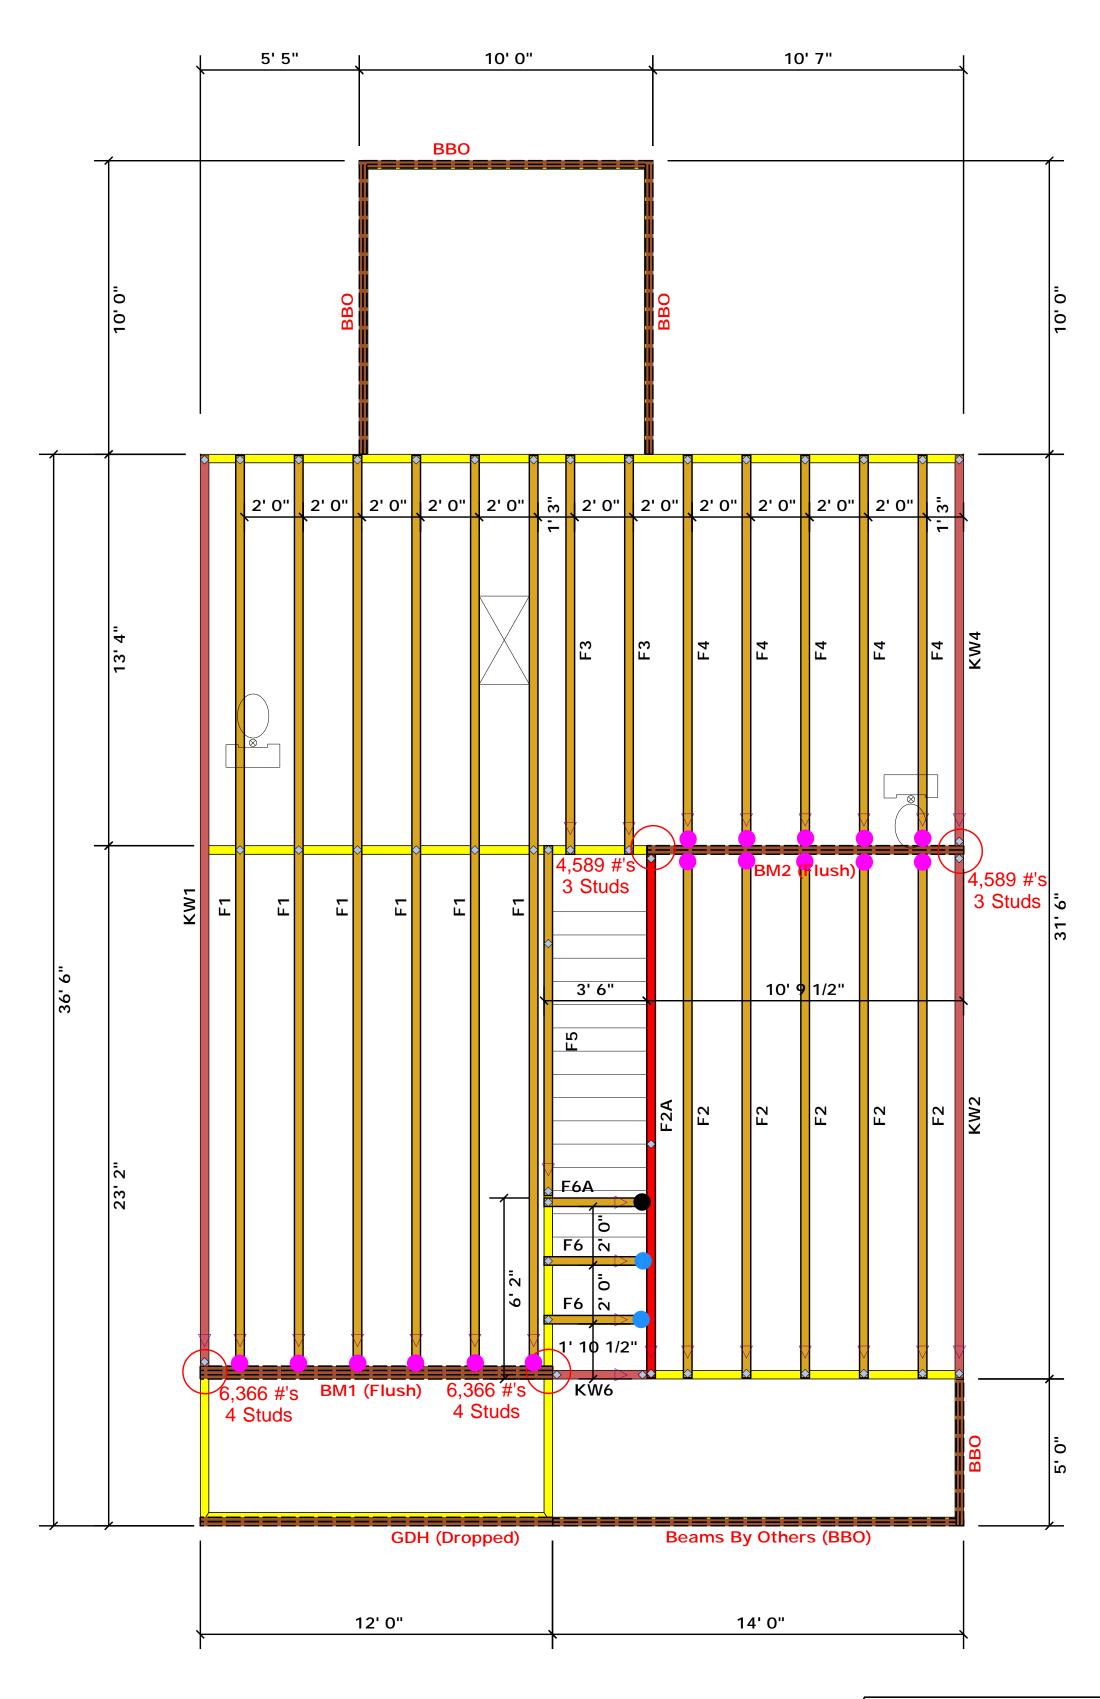
Christine Shivy

Christine Shivy

ROOF & FLOOR TRUSSES & BEAMS Reilly Road Industrial Park Fayetteville, N.C. 28309 Phone: (910) 864-8787

Fax: (910) 864-4444

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= HUS410 (Qty. 16) = MSH422 (Qty. 2) ●= MSH422IF (Qty. 1)

15300 g

Truss Placement Plan SCALE: NTS

▲ = Denotes Left End of Truss (Reference Engineered Truss Drawing)

Products						
PlotID	Length	Product	Plies	Net Qty		
GDH (Dropped)	12' 0"	1-3/4"x 11-7/8" LVL Kerto-S	2	2		
BM1 (Flush)	12' 0"	1-3/4"x 16" LVL Kerto-S	3	3		
BM2 (Flush)	11' 0"	1-3/4"x 16" LVL Kerto-S	2	2		

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-- Denotes Reaction Greater than 3,000 lbs. Reaction / # of Studs

All Truss Reactions are Less

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LOAD CHART FOR JACK STUDS (BASED ON TABLES \$503.5(1) J. (b)) (LANGE OF JACK STUDG SCOUNGER & CACUS OF		BUILDER	Weaver Development	CITY / CO.	Dunn / Harnett	THIS IS A TRUSS PLACI These trusses are designed a the building design at the spe sheets for each truss design i	
	HEADER/6TROER	Lat	JOB NAME	Lot 66 Thomas Farm	ADDRESS	Lot 66 Thomas Farm	is responsible for temporary a the overall structure. The desi walls, and columns is the res regarding bracing, consult BC
	OF 50 OF		PLAN	Magnolia Elev. C	MODEL	Floor	or online @ sbcindustry.com Bearing reactions less than prescriptive Code requirem
	1700 1 2550 1 3400 2 5100 2 5100 3 7650 3	3400 1 6600 2 10200 3	SEAL DATE	Seal Date	DATE REV.	/ /	(derived from the prescript foundation size and numbe than 3000# but not greater be retained to design the si
	6800 4 10200 4 8500 5 12750 5 10200 6 15300 6	13600 4 17000 5	QUOTE #	Quote #	DRAWN BY	Christine Shivy	specified in the attached Ta retained to design the supp
	11900 7 13600 8 15300 q		JOB #	J1220-5683	SALES REP.	Lenny Norris	Signature

LACEMENT DIAGRAM ONLY.

Ined as individual building components to be incorporated into be specification of the building designer. See individual design usign identified on the placement drawing. The building designer orary and permanent bracing of the roof and floor system and for the design of the truss support structure including headers, beams, the responsibility of the building designer. For general guidance

Christine Shivy

Christine Shivy



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