

FRONT ELEVATION

Scale: 1/4" = 1'0"

9'0" CEILING HEIGHT FIRST FLOOR (HEADER HEIGHT 7'6") 8'0" CEILING HEIGHT SECOND FLOOR (HEADER HEIGHT 7')

FRAME WINDOWS TO HEADER HEIGHT



LEFT ELEVATION

Scale: 1/8" = 1'0"



REAR ELEVATION

Scale: 1/8" = 1'0"



RIGHT ELEVATION

Scale: 1/8" = 1'0"

PLAN: Taggart

ELEVATIONS

SHEET TITLE:

PROJECT ADDRESS: 193 SUMMERLIN DR. (Summerlin Lot 56)

Precision Custom Homes
Raeford, NC
n@PrecisionCustomHomesNC.com


DATE:

DATE:

3/3/21

SCALE: 1/4" = 1'

SHEET:

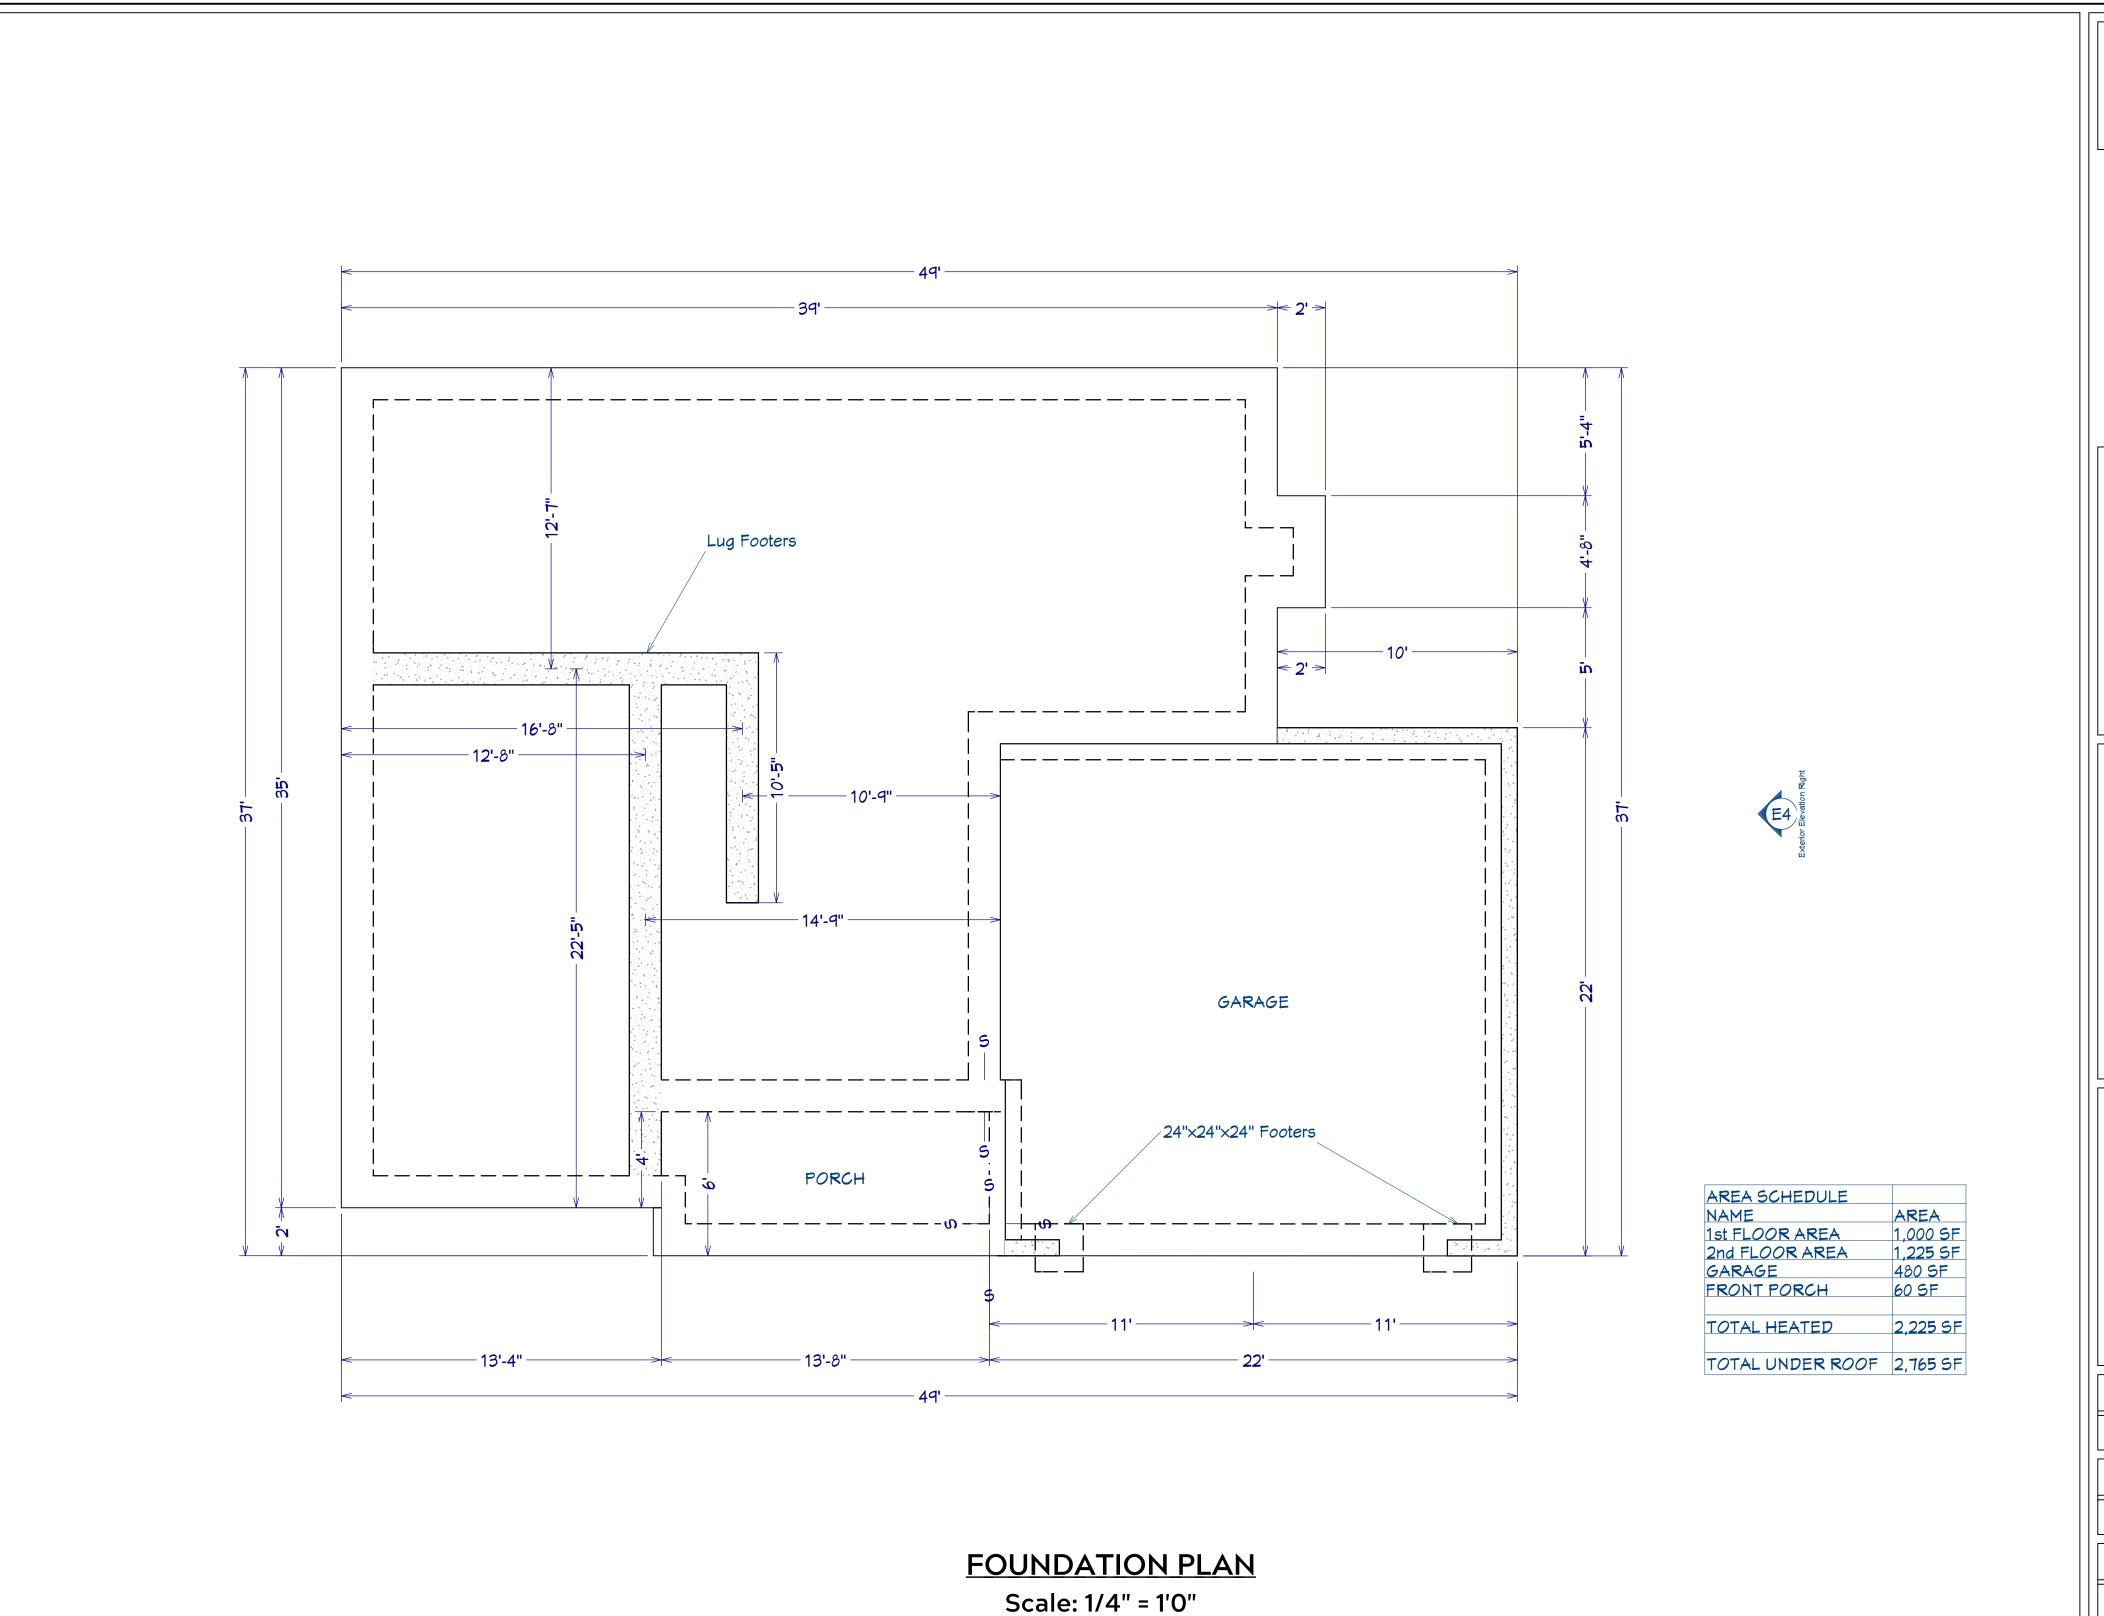

PLAN: Taggart

FOUNDATION

SHEET TITLE:

PROJECT ADDRESS: 193 SUMMERLIN DR. (Summerlin Lot 56)

> Precision Custom Homes Raeford, NC n@PrecisionCustomHomesNC.com


DATE:

3/3/21


SCALE:

1/4" = 1'


SHEET:

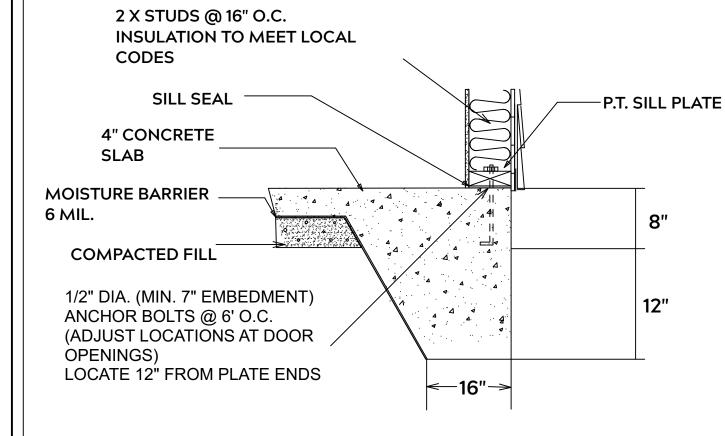

MONOLITHIC SLAB

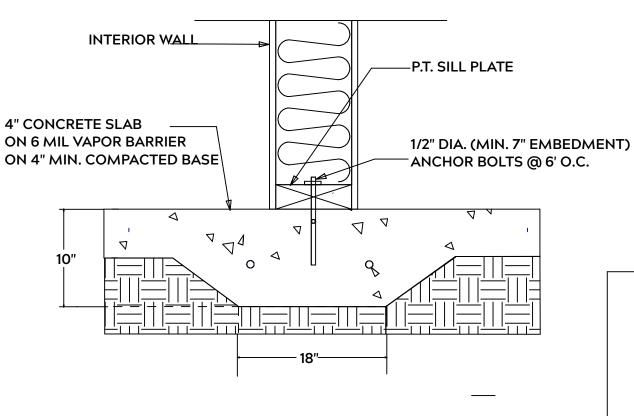

LUG FOOTING

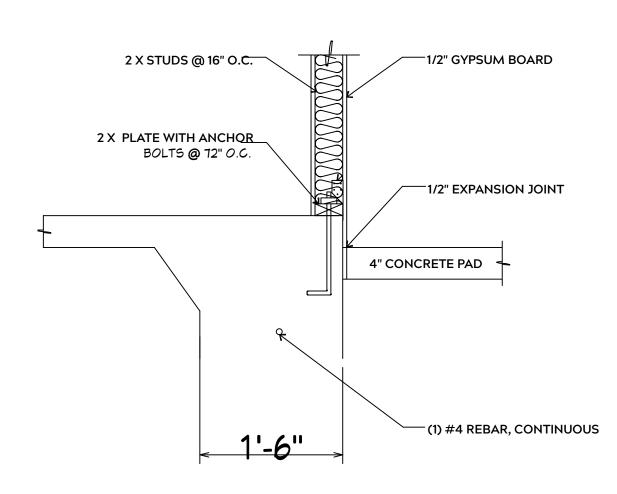

FOUNDATION NOTES:


ALL FOOTINGS SHALL BEAR ON ORIGINAL UNDISTURBED SOIL THE 28 DAY COMPRESSIVE STRENGTH OF ALL **FOOTINGS IS 3000 PSI**

PROVIDE WATER PROOFING AND PERIMTER **DRAINS AS REQUIRED**

FOOTING WIDTHS ARE BASED ON A LOAD **BEARING SOIL CAPACITY OF 2000 PSI**


PROVIDE 6 MIL POLY VAPOR BARRIER TO COVER GROUND IN CRAWL SPACE AND GROUND UNDER POURED CONCRETE

ALL ANCHOR BOLTS TO BE 1/2" X 12" LONG. ANCHOR BOLTS SHALL BE SPACED AT A MAXIMUM OF 6' ON CENTER AND NO MORE THEN 1' FROM EACH CORNER

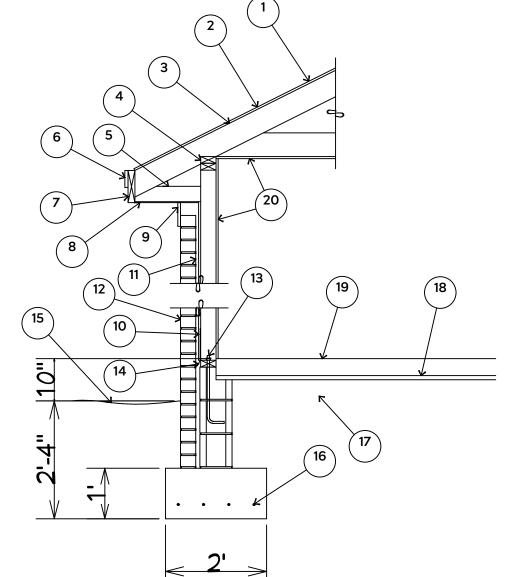

- 15# FELT UNDERLAYMENT UNDER COMPOSITION SHINGLES.
- ROOF DECKING.
- 3. 2 X RAFTERS / ENGINEERED TRUSSES
- DOUBLE TOP PLATE.
- 5. 2 X 4 RETURN. 6. 3/4" FASCIA OR PVC TRIM COIL
- 7. 2 X FASCIA
- 1/4" PLYWOOD OR VINYL SOFFIT
- 9. 1X FREIZE BOARD (TO BE USED WITH **BRICK VENEERS)**
- 10. INSULATION BOARD.
- 11. AIR SPACE.
- 12 BRICK WITH BRICK TIES PER MANUFACTURER'S SPECIFICATIONS.
- 13. 1/2" X 15" ANCHOR BOLTS, 6'-0" O.C., 12" FROM CORNERS.
- FLASHING WITH WEEP HOLES @ 48" O.C.
- 15. FINISHED GRADE.
- 16. (4) #4 REBARS ALL IN SOLID FOOTING 3" OFF BOTTOM.
- 17. COMPACTED EARTH FILL.
- 18. 1" STYROFOAM WITH 6 MIL
- VAPOR BARRIER. 19. 4" CONCRETE SLAB, 3,000 P.S.I. WITH 6" X 6" 10 GA. X 10 GA.
- WELDED WIRE FABRIC. 20. 1/2" GYPSUM BOARD.

EXTERIOR WALL SECTION

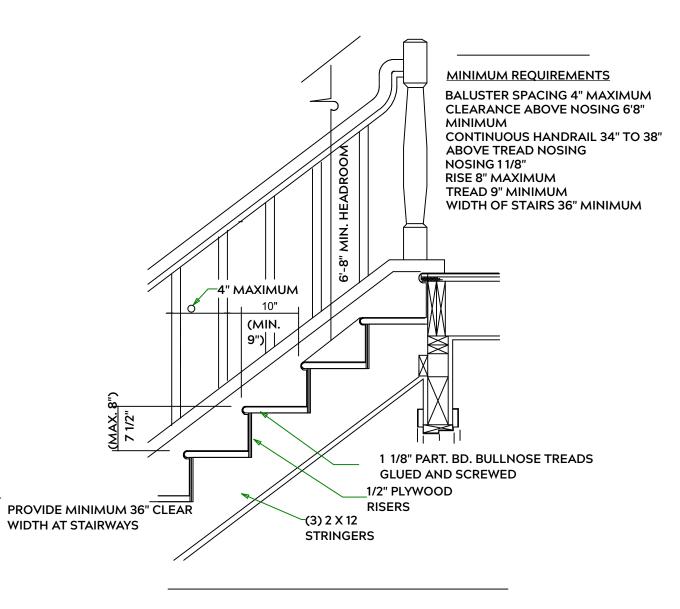

STAIR DETAIL

GENERAL FRAMING NOTES:

ALL LUMBER IN CONTACT WITH CONCRETE OR MASONRY SHALLE BE PRESSURE TREATED

FRAMING LUMBER SHALL BE SYP #2 GRADE AND / OR SPRUCE PINE FIR #1 AND / OR KILN DRIED

WHERE PRE-ENGINEERED JOISTS AND TRUSSES ARE USED, MANUFACTURER SHALL PROVIDE DRAWINGS / SCHEMATICS, WHICH SHALL BEAR OF A N.C. **ENGINEER**

STUDS AND JOISTS SHALL NOT BE CUT TO INSTALL PLUMBING OR WIRING WITHOUT ADDING METAL OR WOOD SIDE PANELS TO STRENGTHEN MEMBER TO ITS ORIGINAL CAPACITY

NAIL MULTIPLE MEMBERS WITH 2 ROWS OF 16d NAILS STAGGERED 32" O.C. AND USE 3 X 16d NAILS 2" IN AT EACH END.

NAIL FLOOR JOISTS TO SILL PLATE WITH WITH 8d TOE NAILS

ALL EXPOSED FRAMING ON PORCHES OR DECKS SHALL BE PRESSURE **TREATED**

PROVIDE WATERPROOFING AND DRAINS AS REQUIRED

ALL FRAMING TO BE 16" O.C. WALL FRAMING DIMENSIONS ARE BASED ON 2X4 OR 2X6 EXTERIOR WALLS AND 2X4 INTERIOR WALLS. DOULBE / TRIPLE JACK STUDS AS NECESSARY UNDER HEADERS AS REQUIRED

LVL'S TO BE SIZED BY OTHERS (TRUSS MANUFACTURER)

INTERIOR WALL @ GARAGE STEP DOWN

PLAN: Taggart

SHEETS AIL E

PROJECT ADDRESS: 193 SUMMERLIN DR. (Summerlin Lot 56)

Precision Custom Hor Raeford, NC @PrecisionCustomHor


DATE:

3/3/21

1/4" = 1'

SCALE:

SHEET:

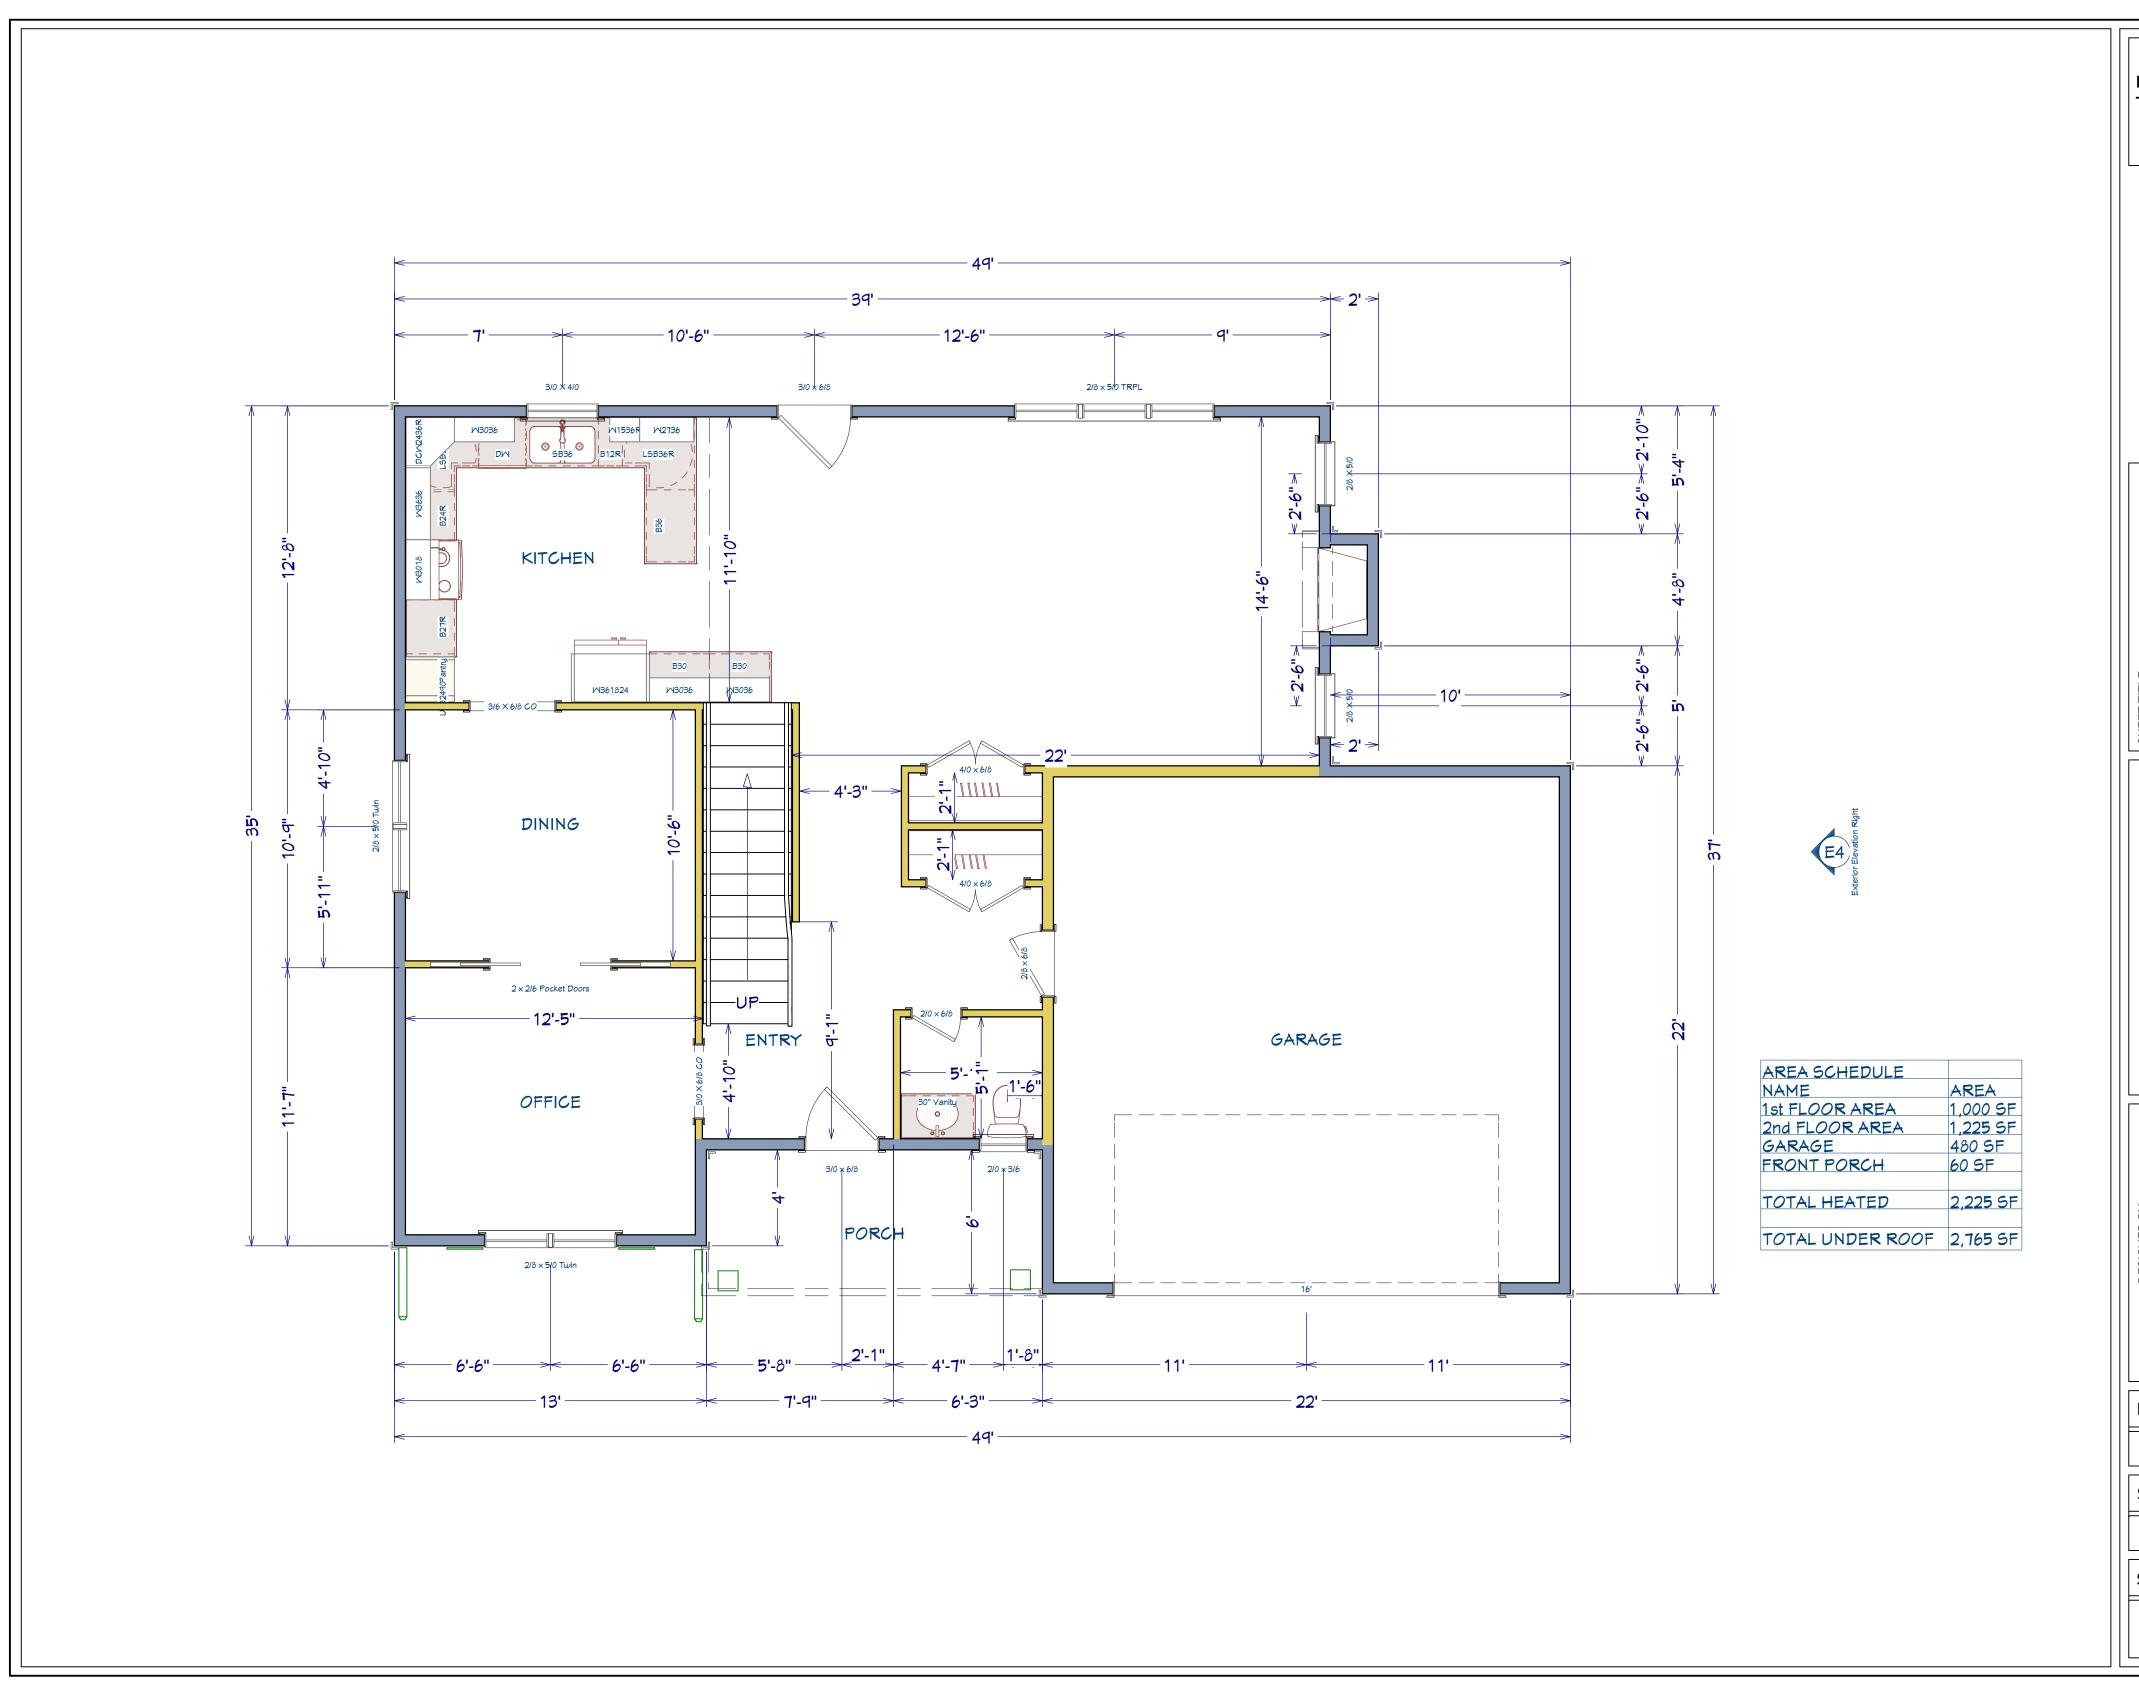

PLAN: Taggart

1st FLOOR

SHEET THE

PROJECT ADDRESS: 193 SUMMERLIN DR. (Summerlin Lot 56)

> Precision Custom Homes Raeford, NC naun@PrecisionCustomHomesNC.col


DATE:

3/3/21

SCALE: 1/4" = 1'

SHEET:



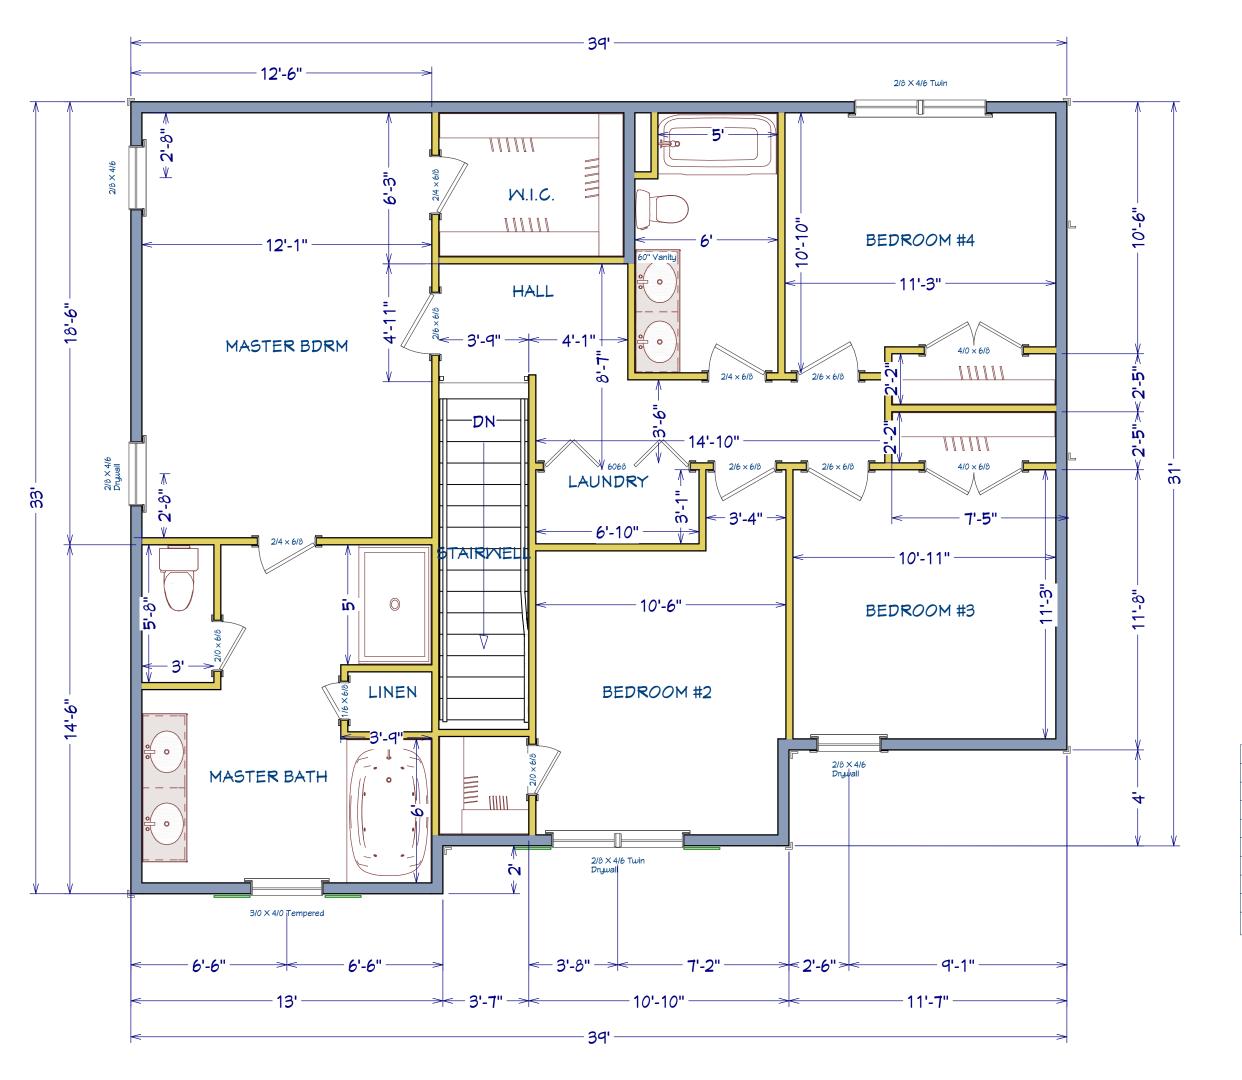

AREA
1,000 SF
1,225 SF
480 SF
60 SF
2,225 SF
-
2,765 SF

2nd FLOOR

SHEET TITLE:

PROJECT ADDRESS: 193 SUMMERLIN DR. (Summerlin Lot 56)

Precision Custom Homes
Raeford, NC

DATE:

3/3/21

SCALE: 1/4" = 1'

SHEET: