




FRONT ELEVATION

Scale: 1/4" = 1'0"

9'0" CEILING HEIGHT FIRST FLOOR
HEADER HEIGHT: 7'6"


8'0" CEILING HEIGHT SECOND FLOOR
HEADER HEIGHT: 7'

FRAME WINDOWS TO HEADER HEIGHT

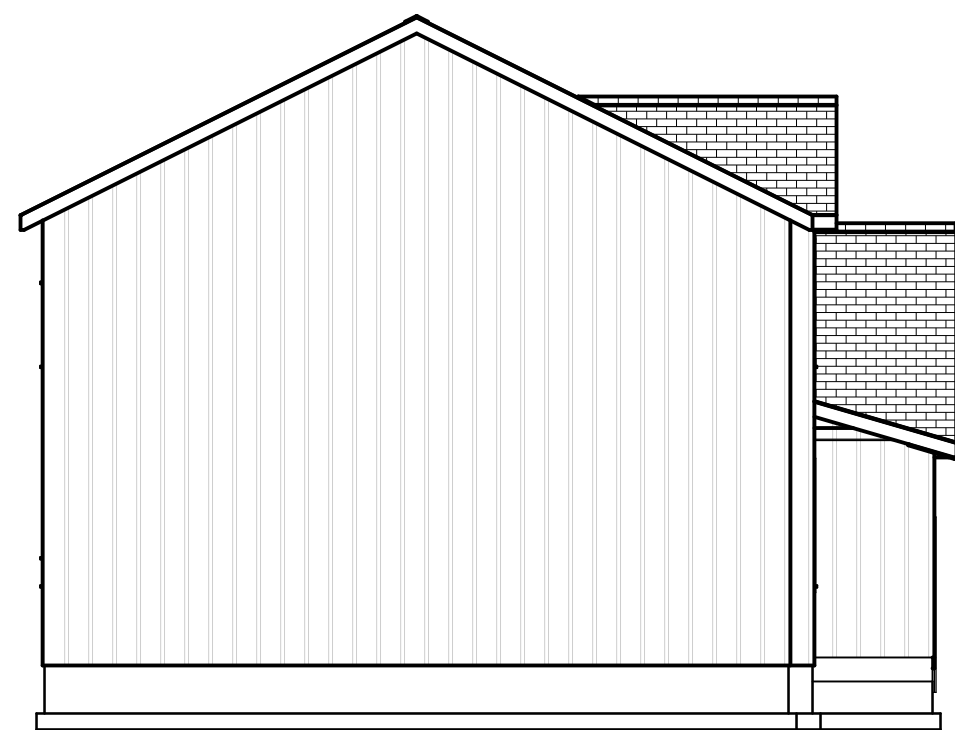

LEFT ELEVATION

Scale: 1/8" = 1'0"

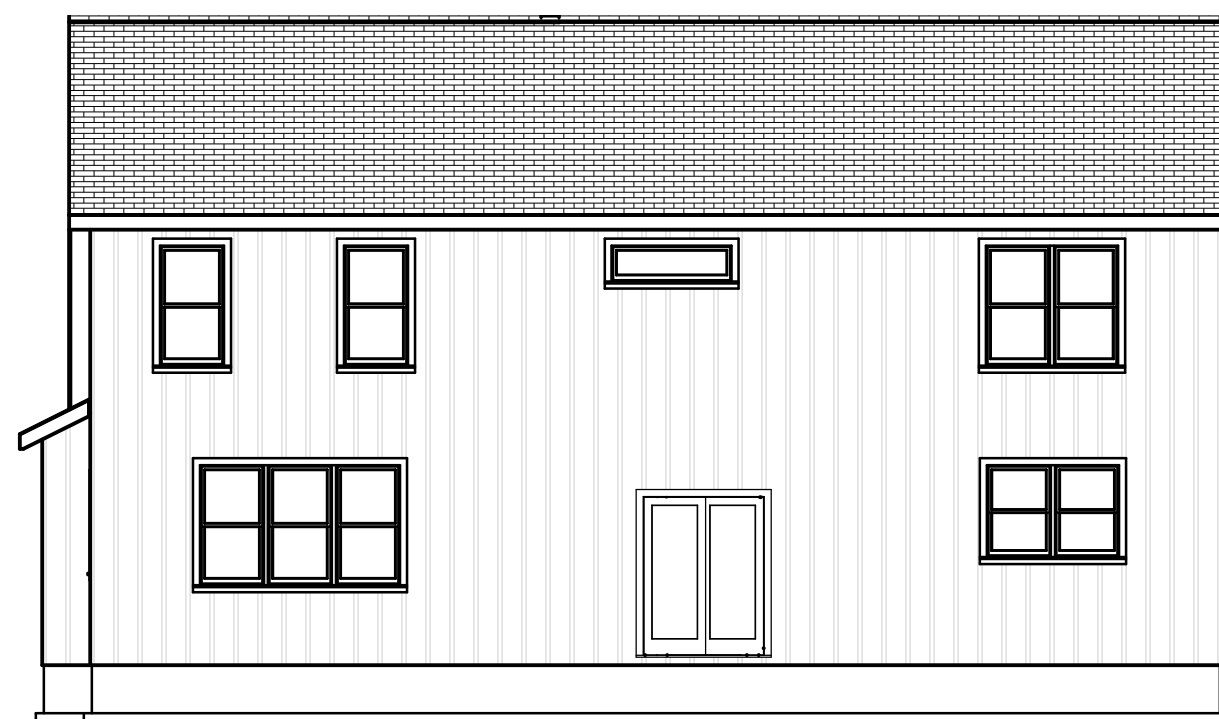


REAR ELEVATION

Scale: 1/8" = 1'0"




RIGHT ELEVATION

Scale: 1/8" = 1'0"

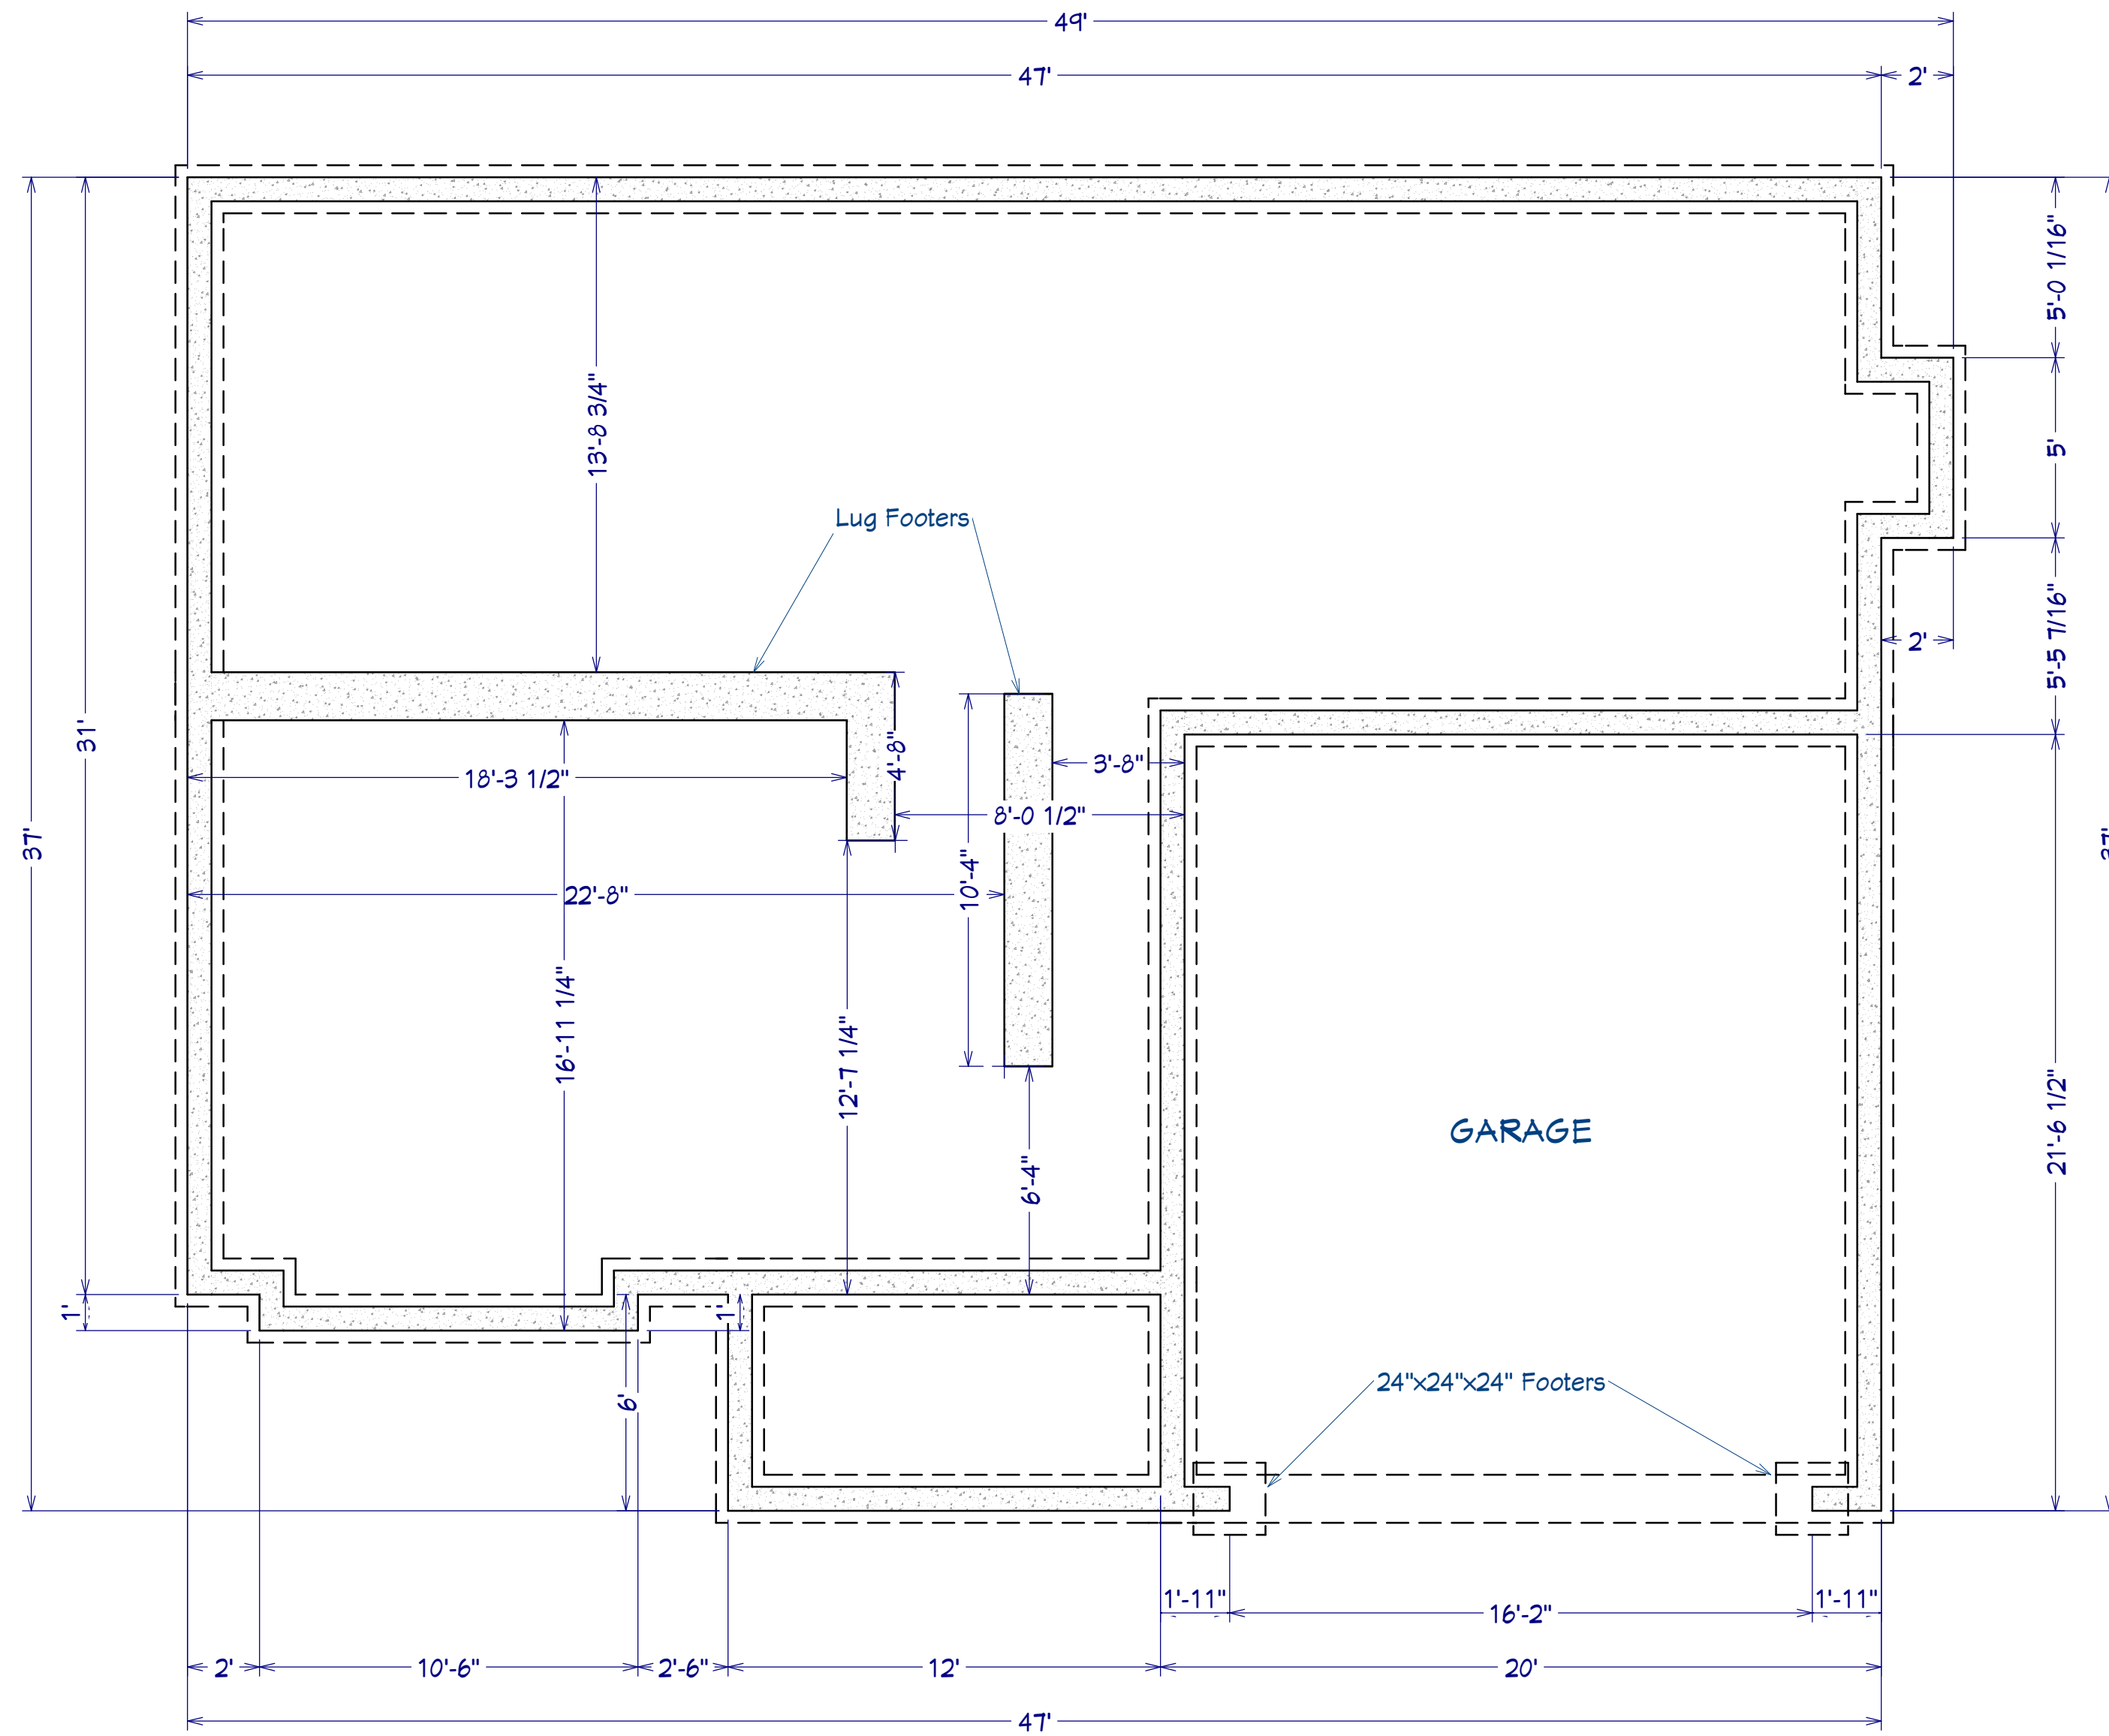

FOUNDATION PLAN

Scale: 1/4" = 1'0"

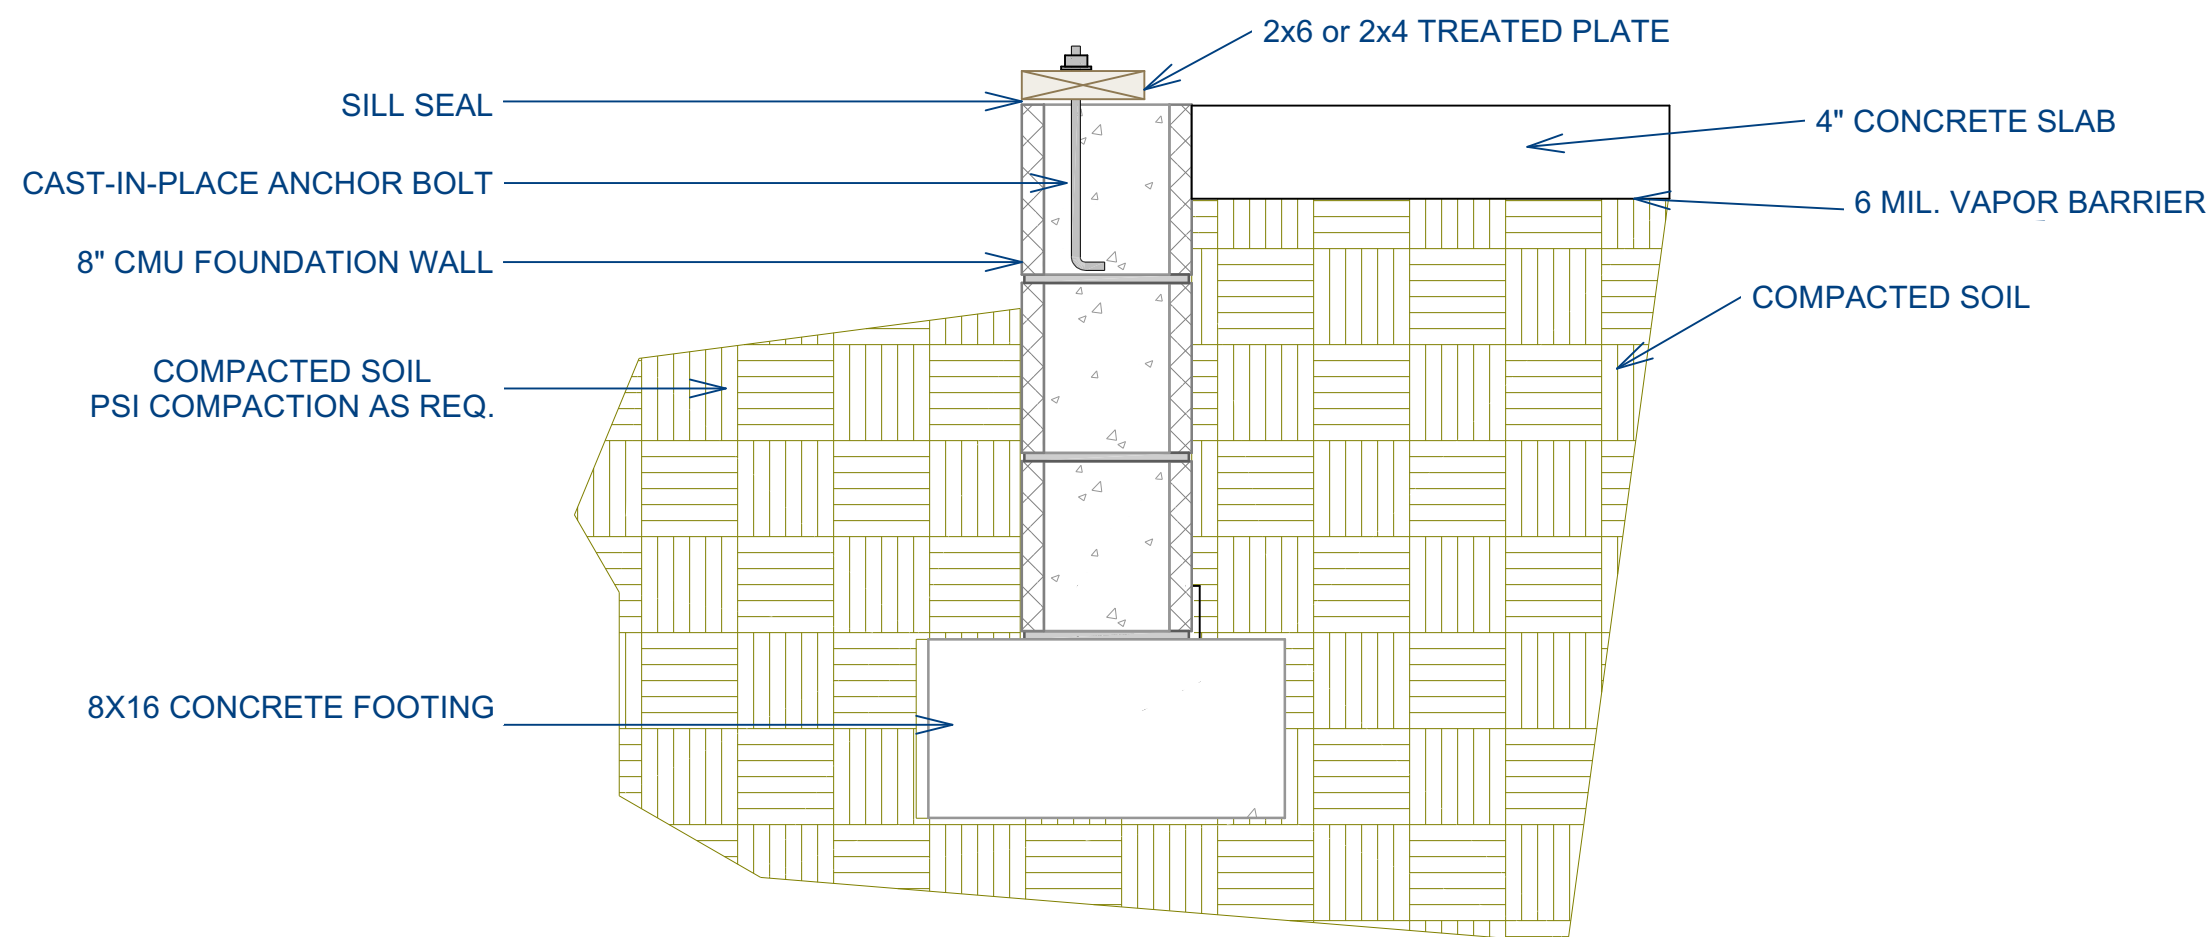

FOUNDATION NOTES:


ALL FOOTINGS SHALL BEAR ON ORIGINAL UNDISTURBED SOIL
 THE 28 DAY COMPRESSIVE STRENGTH OF ALL FOOTINGS IS 3000 PSI

PROVIDE WATER PROOFING AND PERIMTER DRAINS AS REQUIRED

FOOTING WIDTHS ARE BASED ON A LOAD BEARING SOIL CAPACITY OF 2000 PSI

PROVIDE 6 MIL POLY VAPOR BARRIER TO COVER GROUND IN CRAWL SPACE AND GROUND UNDER POURED CONCRETE

ALL ANCHOR BOLTS TO BE 1/2" X 12" LONG. ANCHOR BOLTS SHALL BE SPACED AT A MAXIMUM OF 6' ON CENTER AND NO MORE THEN 1' FROM EACH CORNER

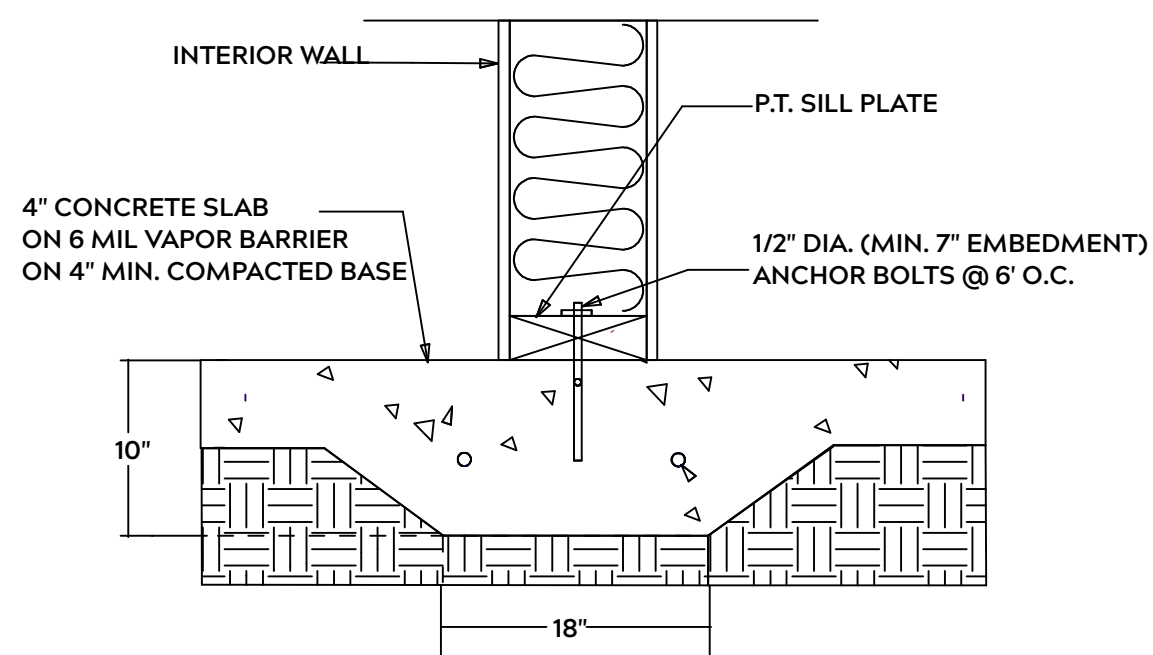

LUG FOOTING

GENERAL FRAMING NOTES:

ALL LUMBER IN CONTACT WITH CONCRETE OR MASONRY SHALL BE PRESSURE TREATED

FRAMING LUMBER SHALL BE SYP #2 GRADE AND / OR SPRUCE PINE FIR #1 AND / OR KILN DRIED

WHERE PRE-ENGINEERED JOISTS AND TRUSSES ARE USED, MANUFACTURER SHALL PROVIDE DRAWINGS / SCHEMATICS, WHICH SHALL BEAR OF A N.C. ENGINEER

STUDS AND JOISTS SHALL NOT BE CUT TO INSTALL PLUMBING OR WIRING WITHOUT ADDING METAL OR WOOD SIDE PANELS TO STRENGTHEN MEMBER TO ITS ORIGINAL CAPACITY

NAIL MULTIPLE MEMBERS WITH 2 ROWS OF 16d NAILS STAGGERED 32" O.C. AND USE 3 X 16d NAILS 2" IN AT EACH END.


NAIL FLOOR JOISTS TO SILL PLATE WITH WITH 8d TOE NAILS

ALL EXPOSED FRAMING ON PORCHES OR DECKS SHALL BE PRESSURE TREATED


PROVIDE WATERPROOFING AND DRAINS AS REQUIRED

ALL FRAMING TO BE 16" O.C. WALL FRAMING DIMENSIONS ARE BASED ON 2X4 OR 2X6 EXTERIOR WALLS AND 2X4 INTERIOR WALLS. DOULBE / TRIPLE JACK STUDS AS NECESSARY UNDER HEADERS AS REQUIRED

LVLS TO BE SIZED BY OTHERS (TRUSS MANUFACTURER)

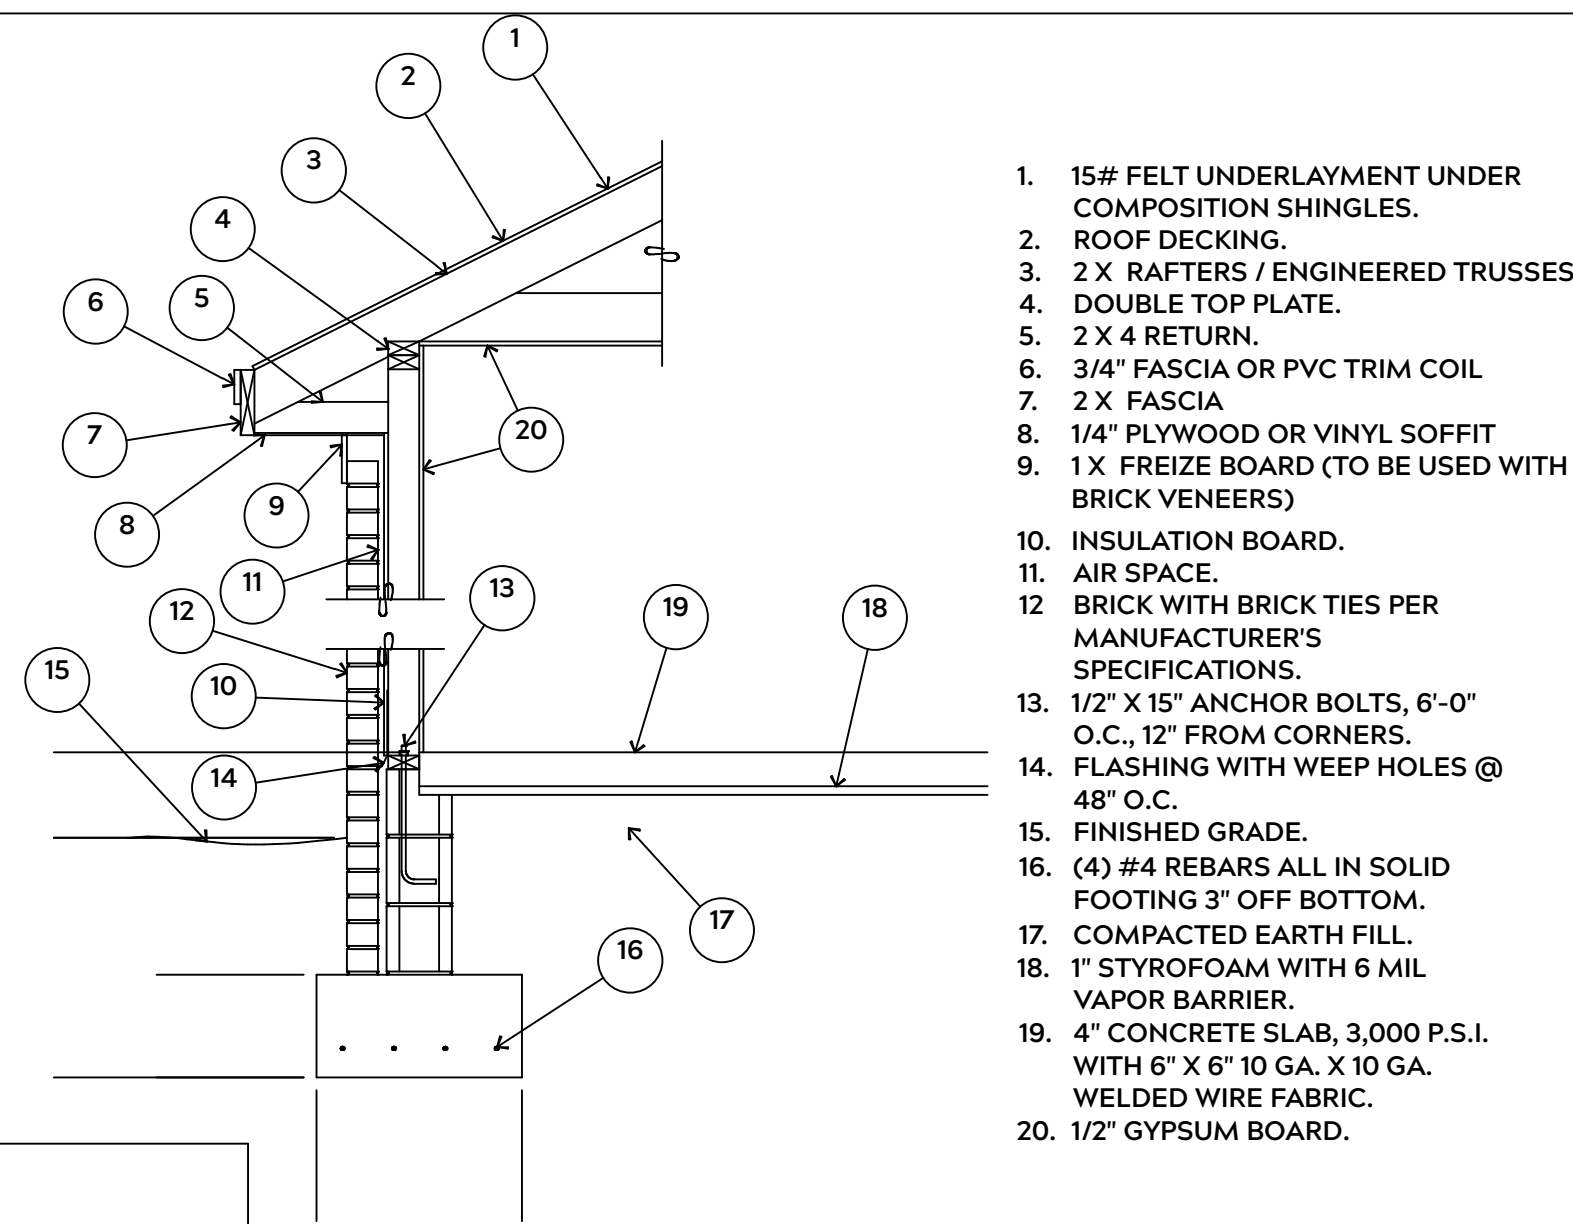

EXTERIOR WALL SECTION

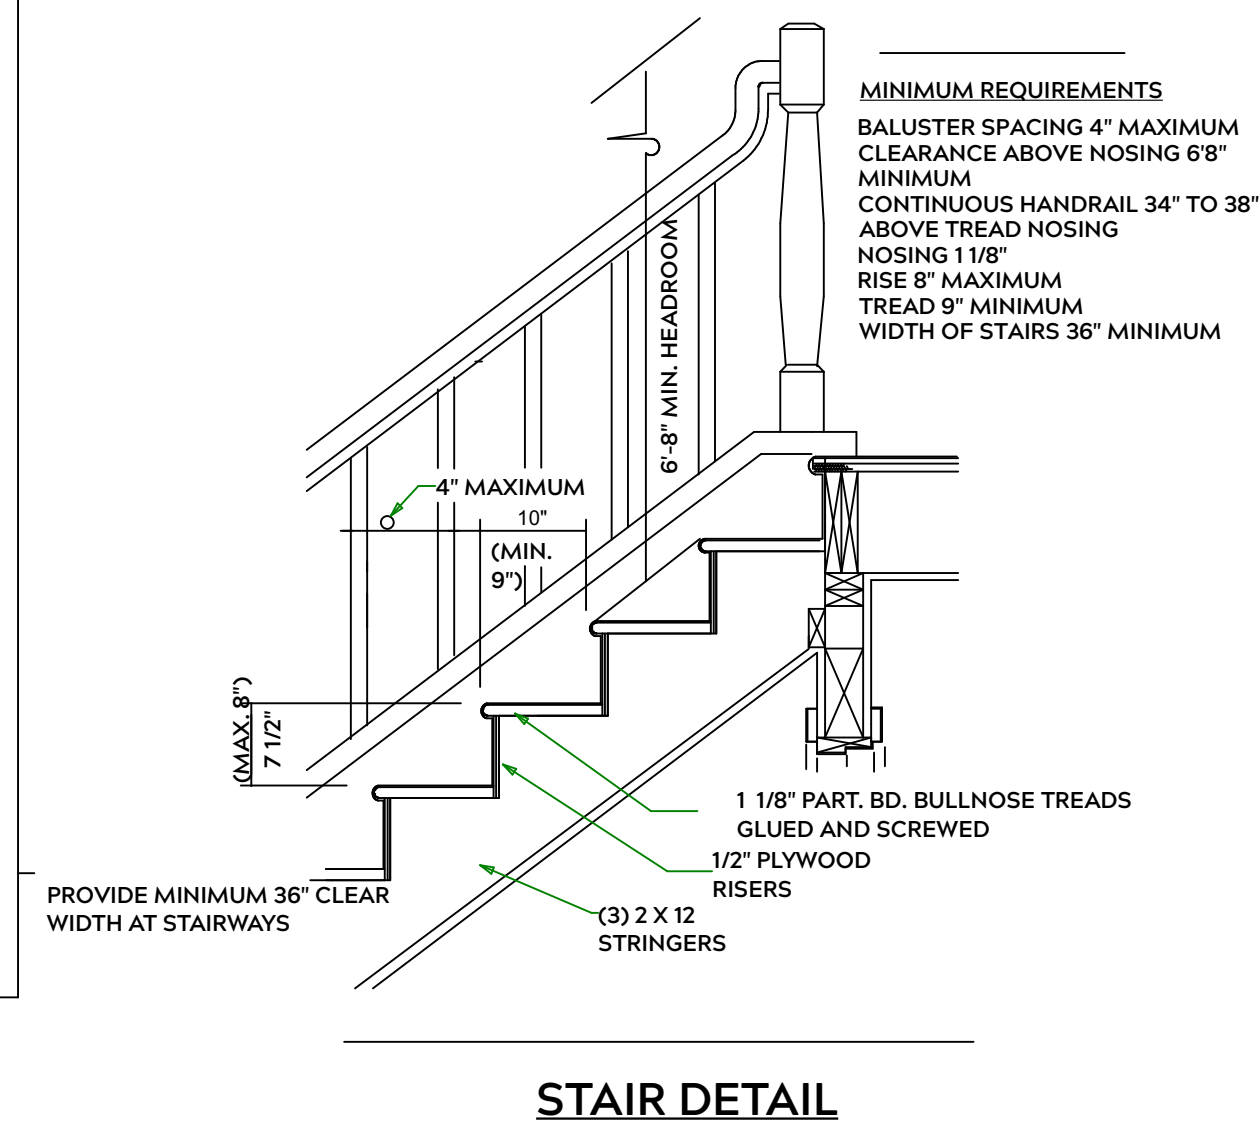

STAIR DETAIL

PLAN:
Roark 2.0

SHEET TITLE:
DETAIL SHEETS

PROJECT ADDRESS:
111 SUMMERLIN DR.
SUMMERLIN 58

DESIGNED BY:
Precision Custom Homes
Raeferd, NC
Shaun@PrecisionCustomHomesNC.com

DATE:


1/14/21

SCALE:

1/4" = 1'


SHEET:

A-3

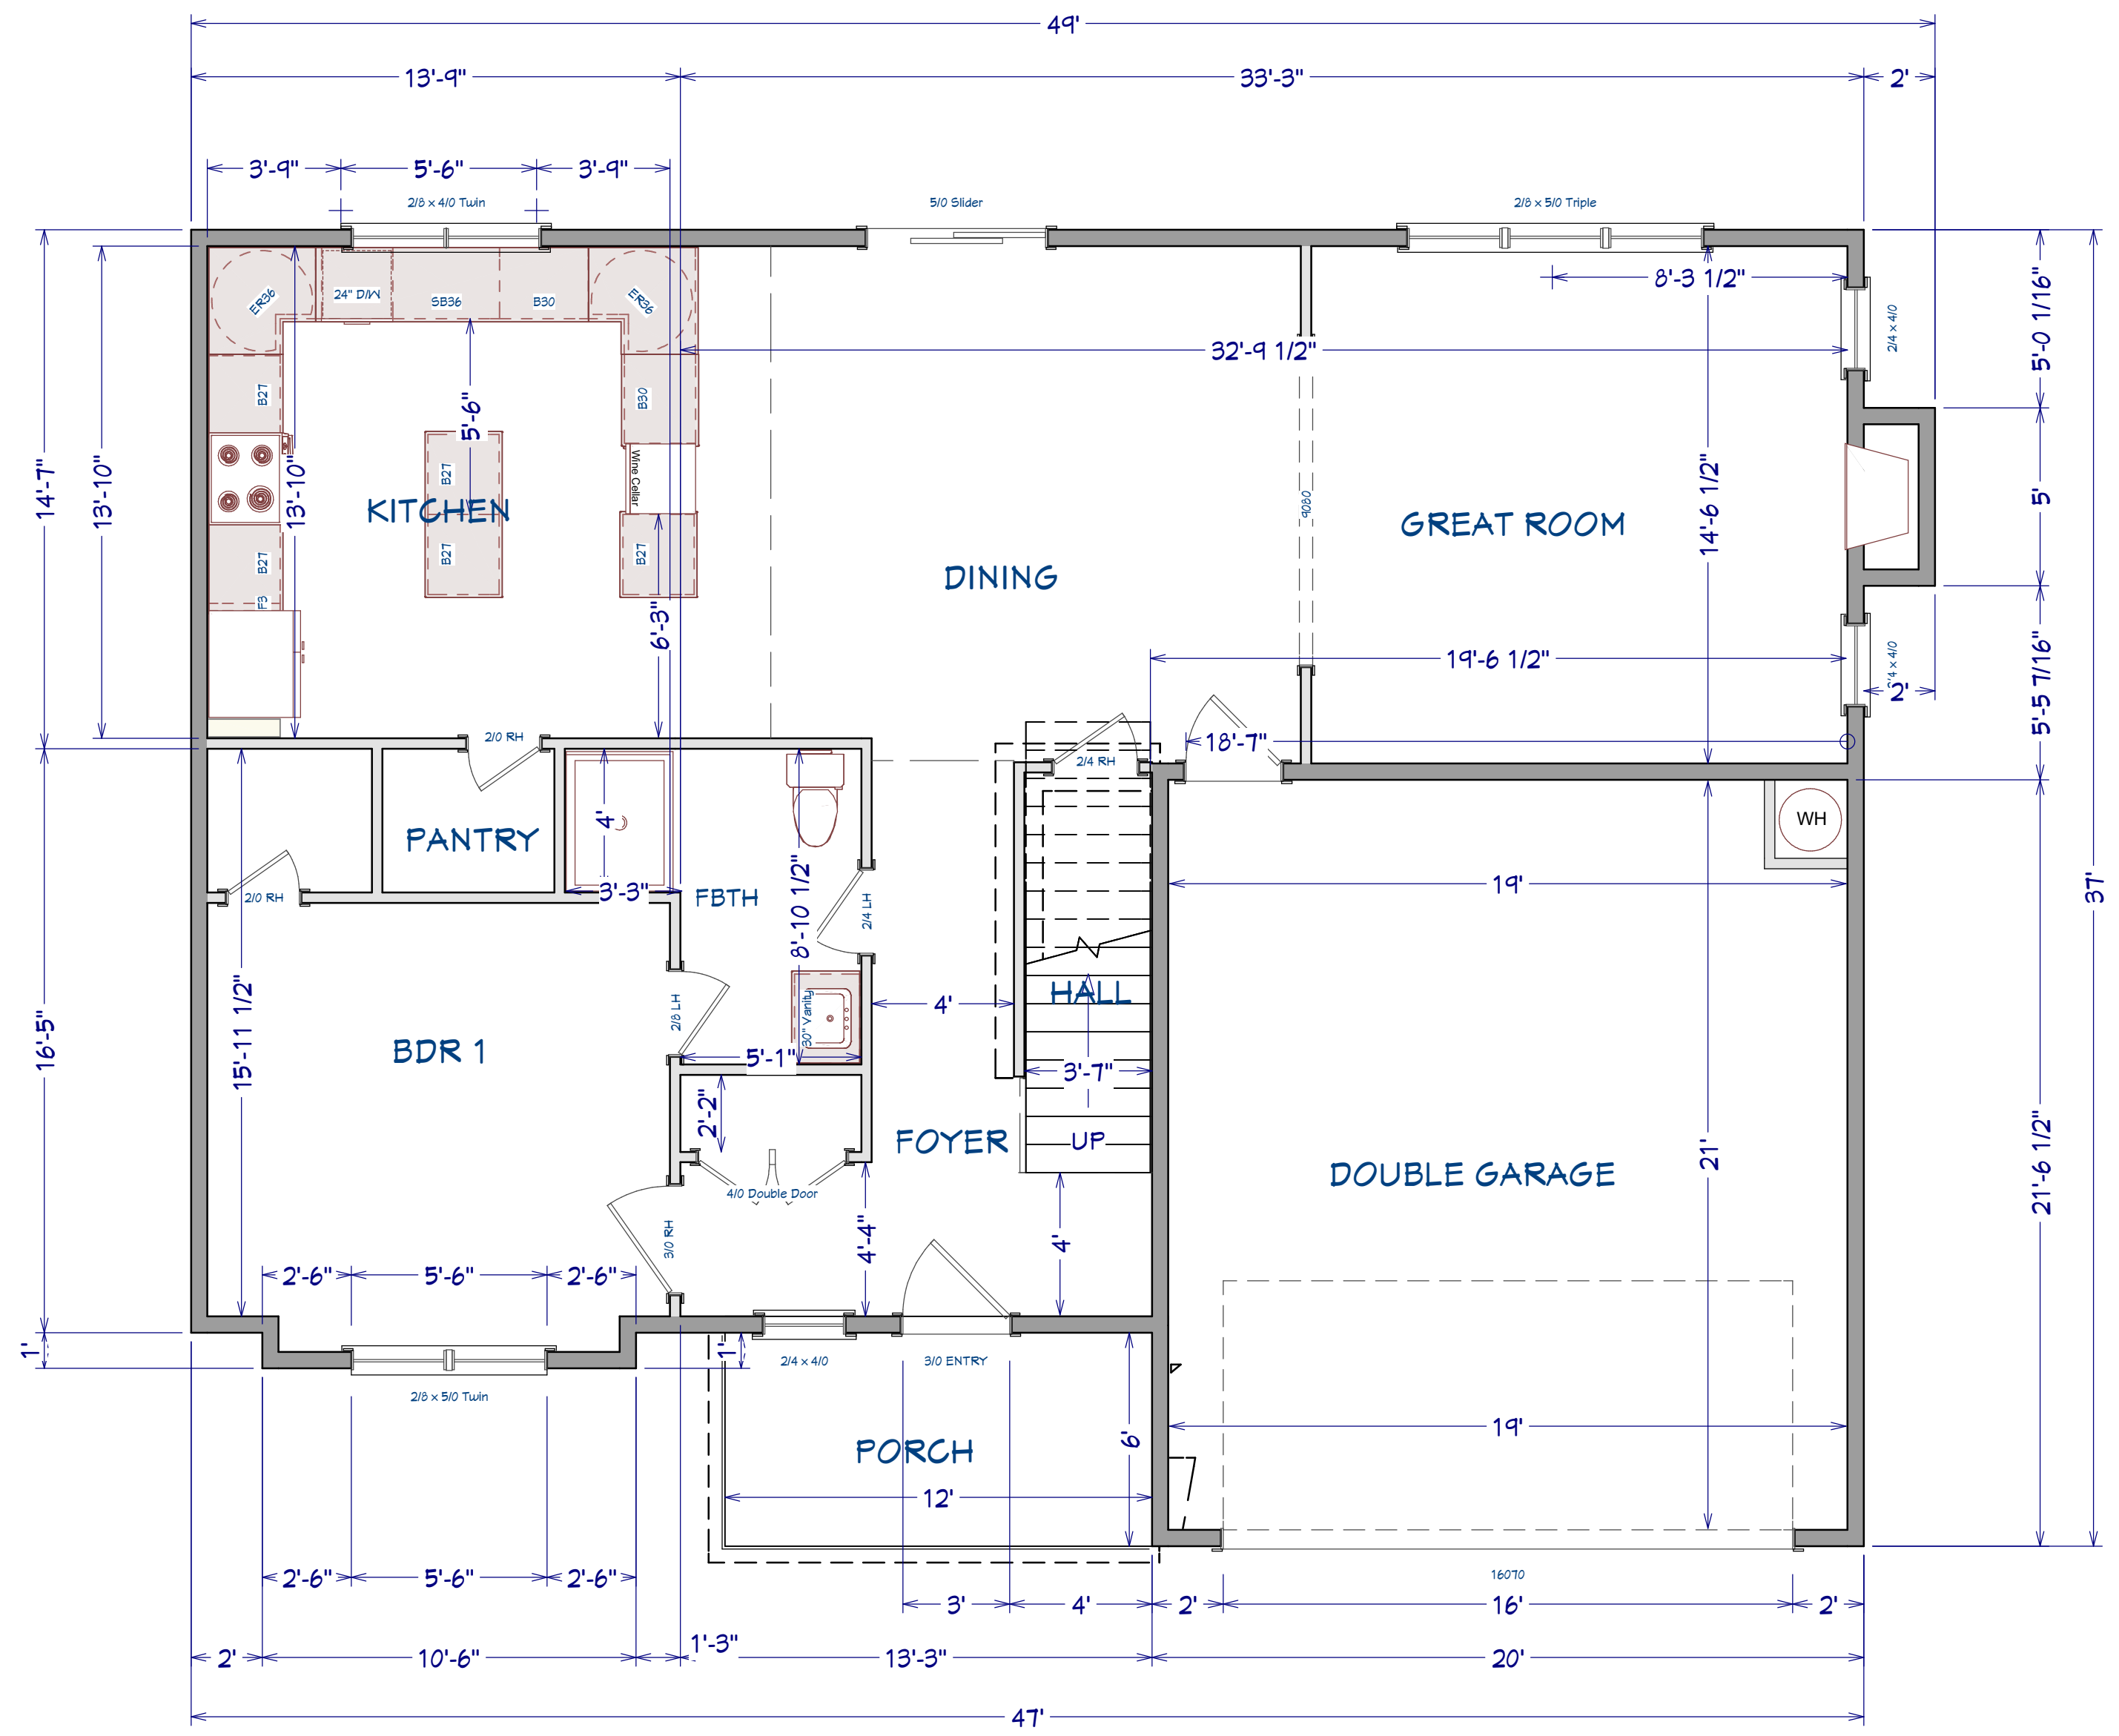

AREA SCHEDULE	
NAME	AREA
1st FLOOR AREA	1,185 SF
2nd FLOOR AREA	1305 SF
GARAGE	418 SF
FRONT PORCH	75 SF
TOTAL HEATED	2490 SF
TOTAL UNDER ROOF	2483 SF

1st Floor
Scale: 1/4" = 1'0"

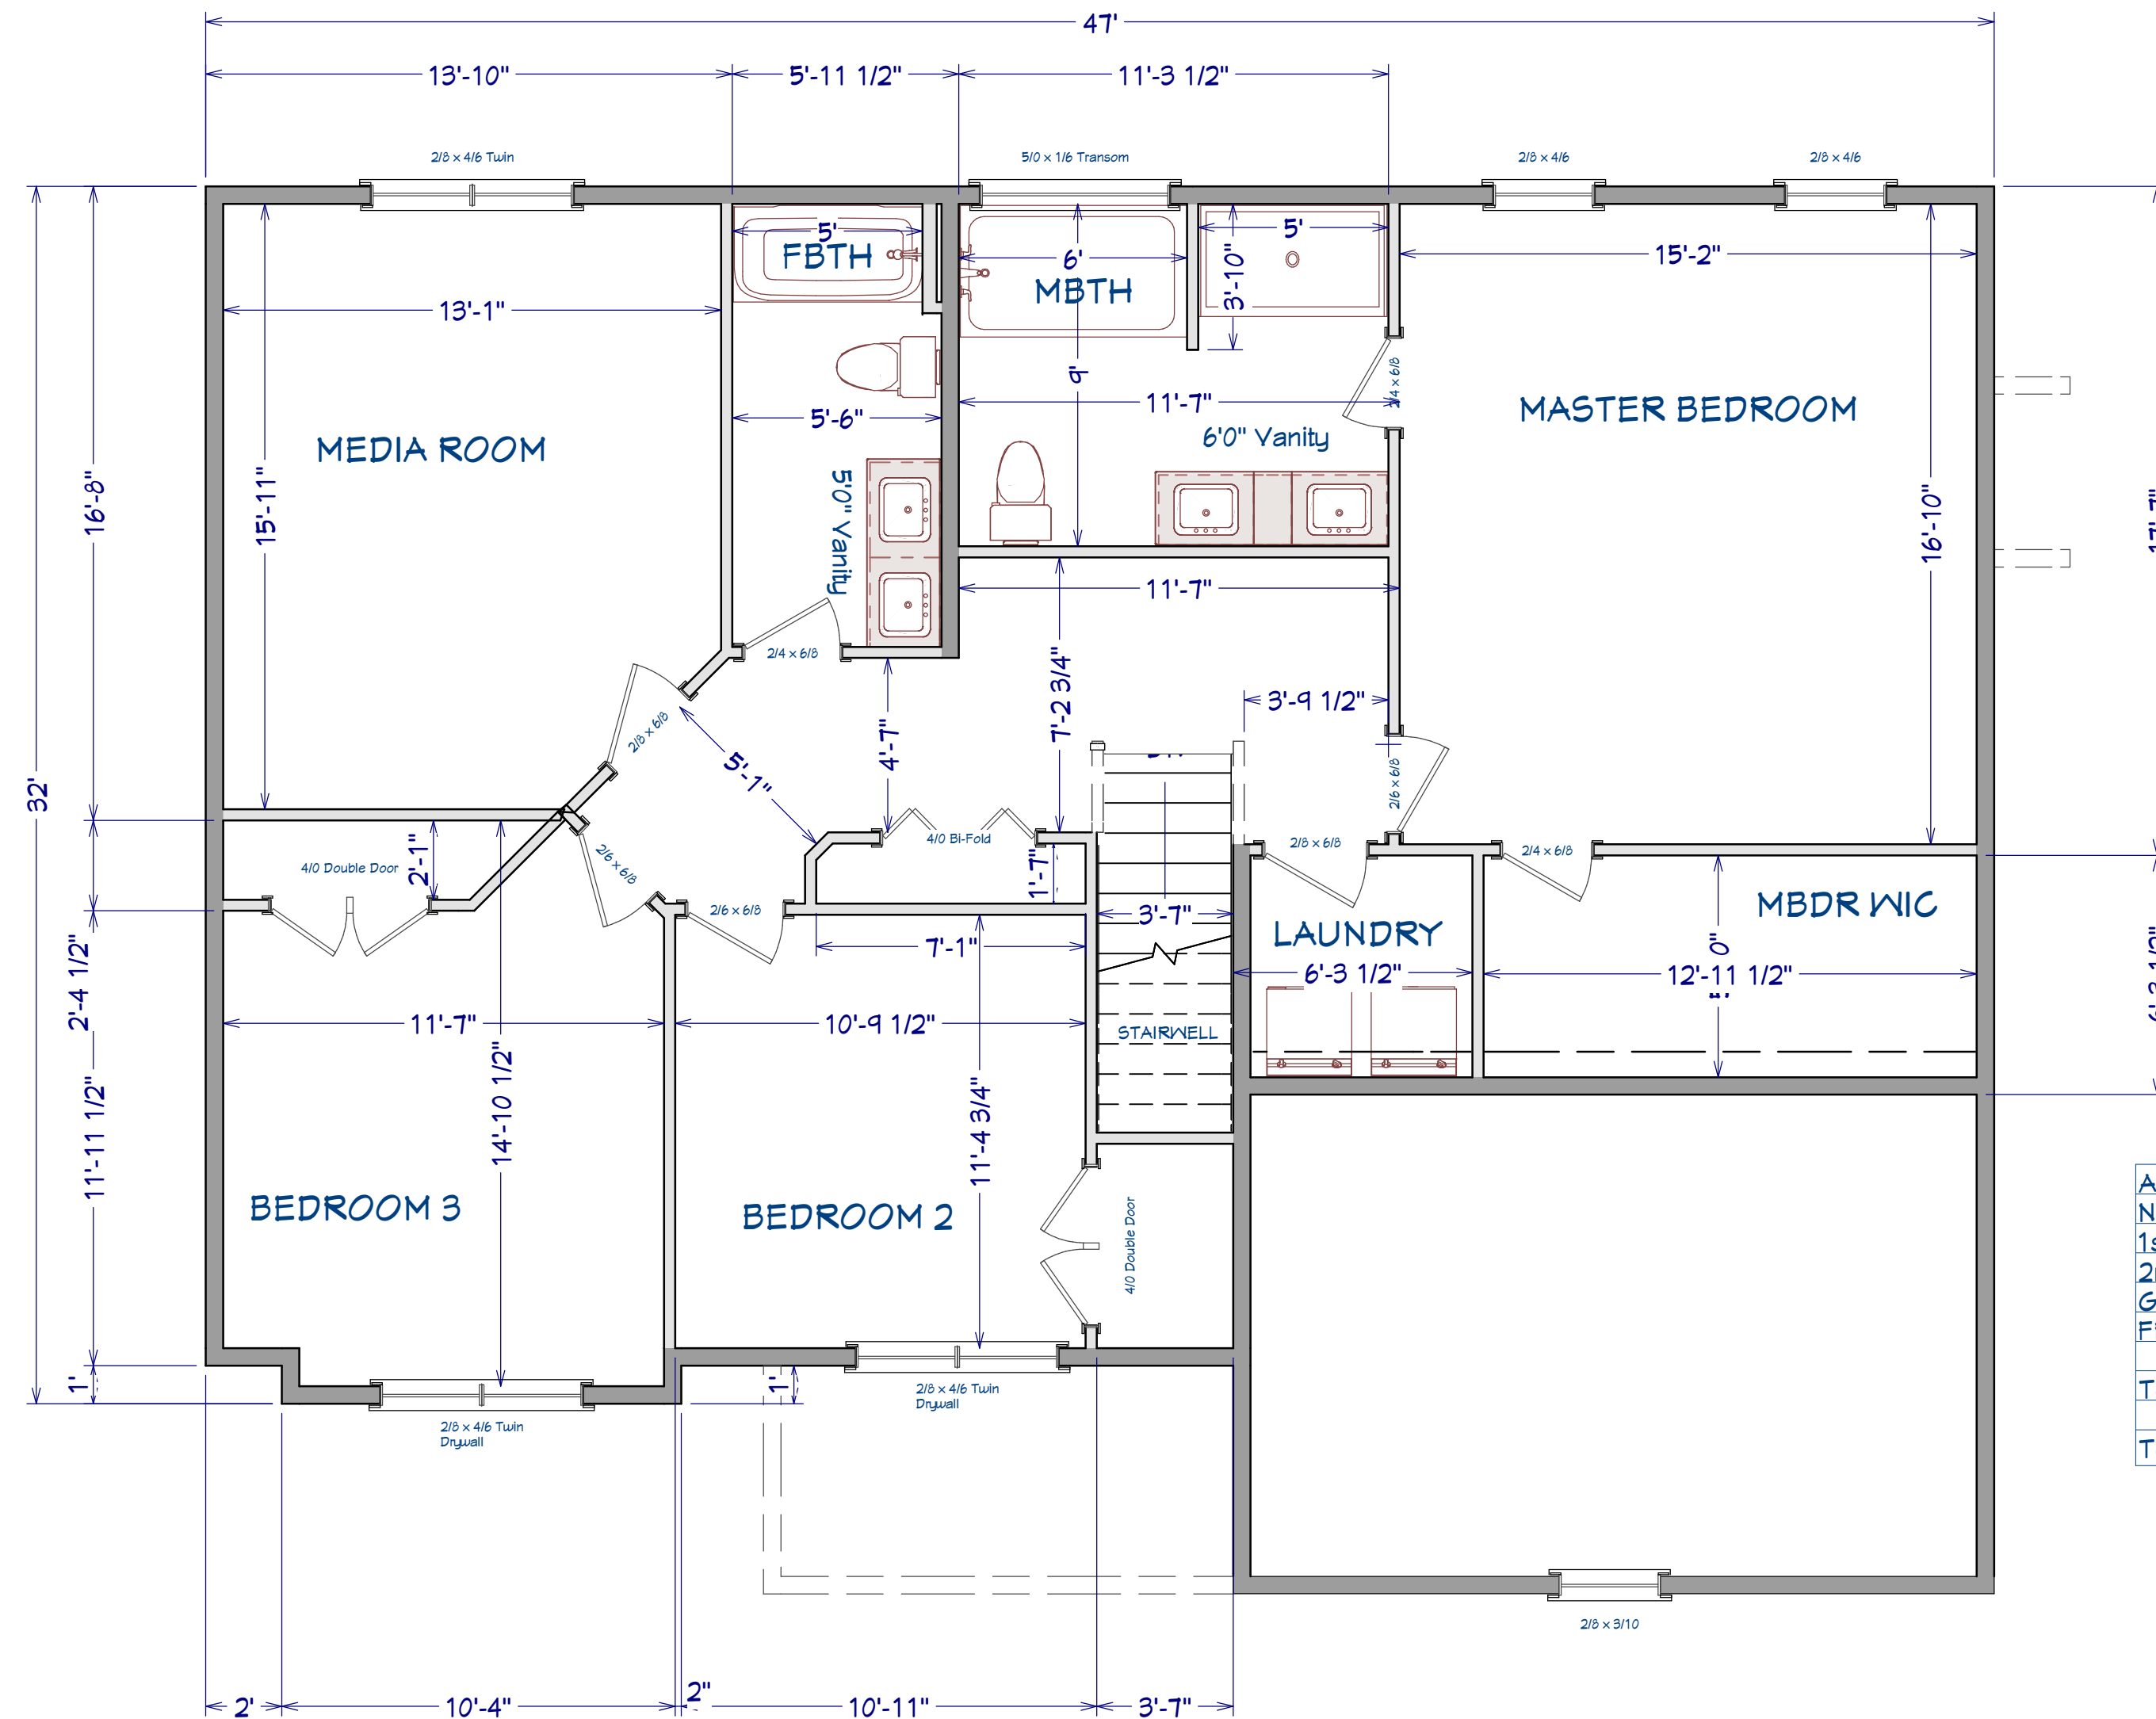

AREA SCHEDULE	
NAME	AREA
1st FLOOR AREA	1,185 SF
2nd FLOOR AREA	1,305 SF
GARAGE	418 SF
FRONT PORCH	75 SF
TOTAL HEATED	2490 SF
TOTAL UNDER ROOF	2983 SF

2nd Floor
Scale: 1/4" = 1'0"