
KLF-000-054



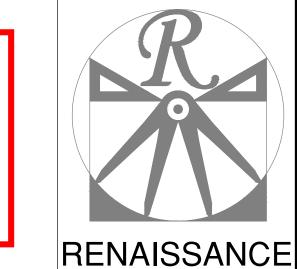


RESIDENTIAL DESIGN, INC. RALEIGH, NC (919) 649-4128 WWW.RRDCAROLINA.COM

RENAISSANCE RESIDENTIAL DESIGN, INC.
RESERVES THE RIGHT TO MAKE
MODIFICATIONS TO FLOOR PLANS,
DIMENSIONS, MATERIALS, AND
SPECIFICATIONS WITHOUT NOTICE.
THESE DRAWINGS ARE FOR THE PURPOSE OF CONVEYING AN ARCHITECTURAL CONCEPT ONLY.

"The art of transforming your vision into reality.'

COMMON LAW COPYRIGHT AND OTHER PROPERTY RIGHTS IN THESE PLANS. THESE PLANS AND DRAWINGS ARE NOT TO BE REPRODUCED, CHANGED, OR COPIED IN ANY FORM OR MANNER WITHOUT FIRST OBTAINING THE EXPRESS WRITTEN CONSENT OF RENAISSANCE RESIDENTIAL DESIGN, INC. NOR ARE THEY TO BE ASSIGNED TO ANY THIRD PARTY WITHOUT FIRST OBTAINING SAID WRITTEN PERMISSION AND CONSENT.

RENAISSANCE RESIDENTIAL DESIGN, INC. HEREBY EXPRESSLY RESERVES ITS

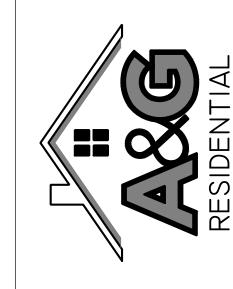

A&G RESIDENTIAL GREENVILLE DRIVE LEFT

DATE: MAY 21, 2020


REV.: 9-22-20 SCALE: AS NOTED


DRAWN BY: WG

ENGINEERED BY: REVIEWED BY:


B - ELEVATIONS


A-2

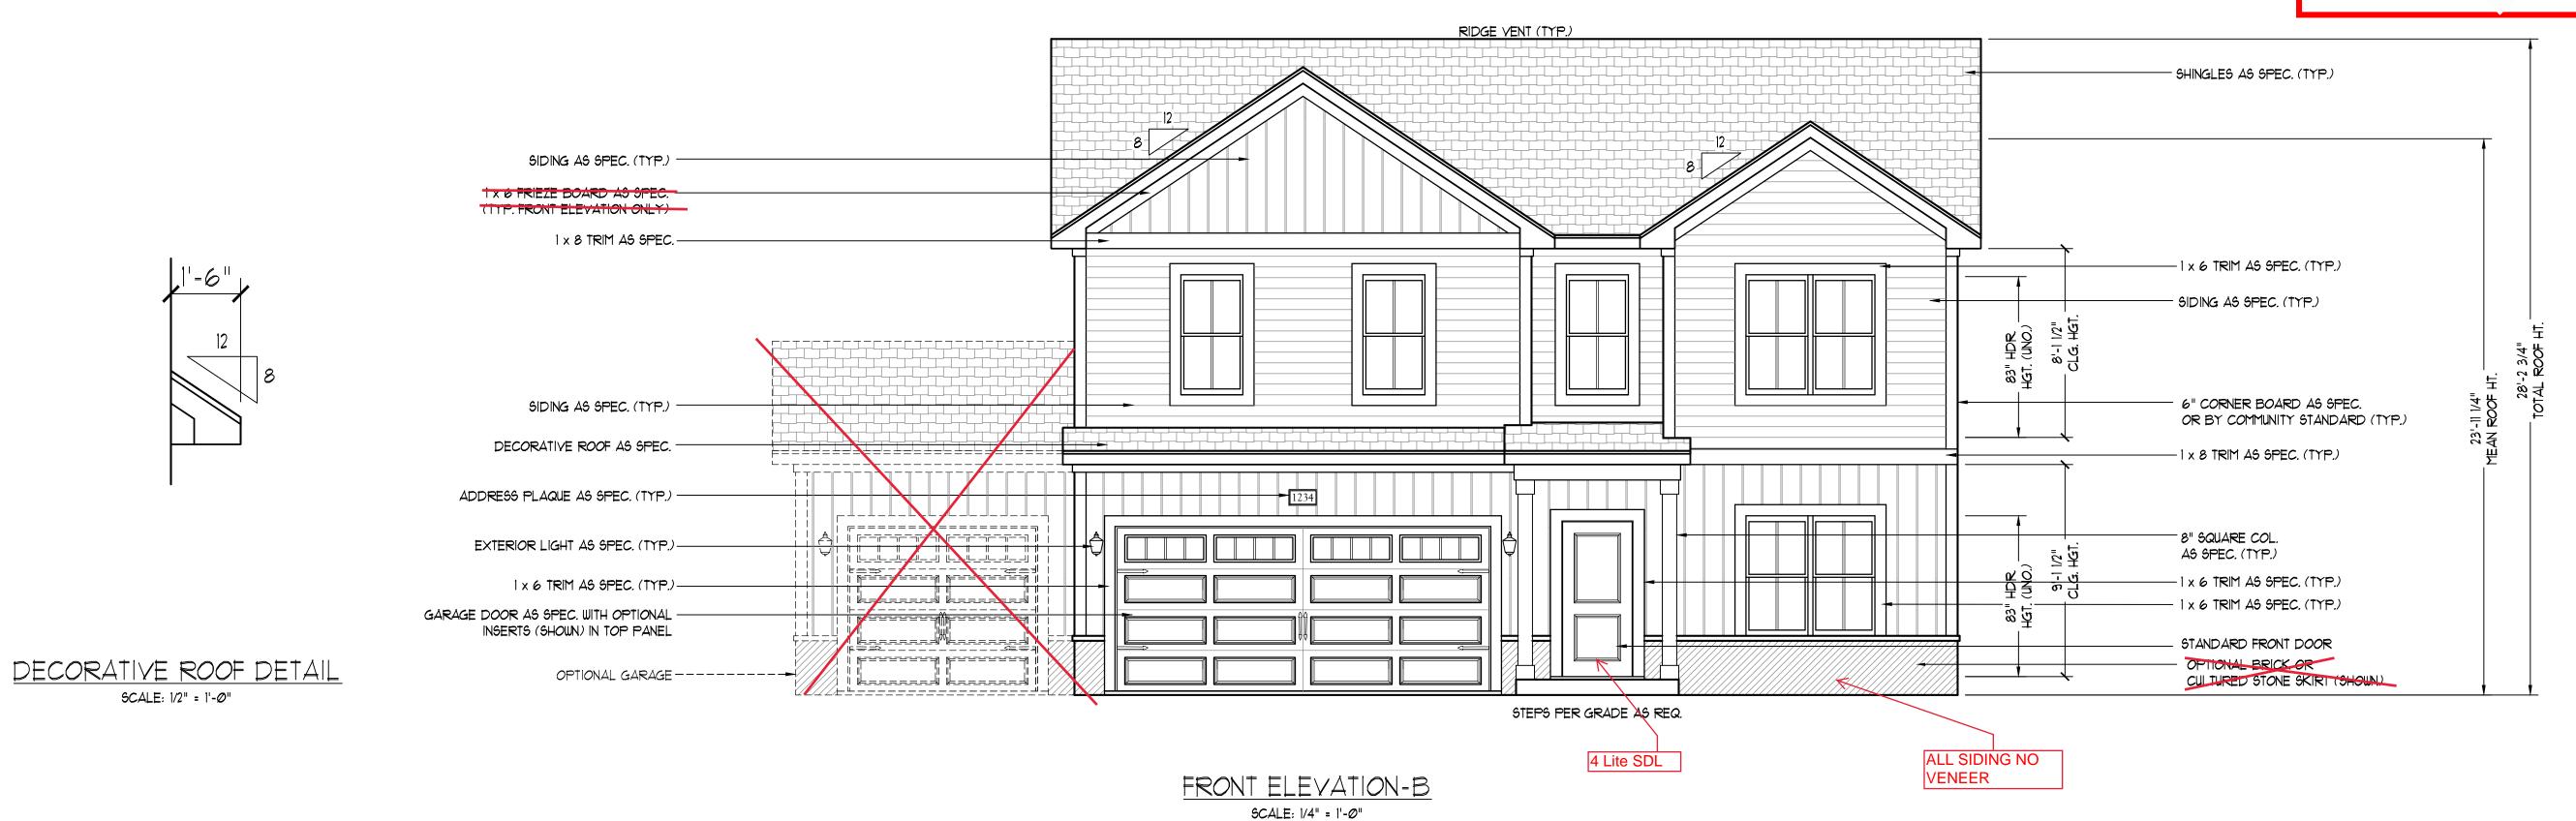

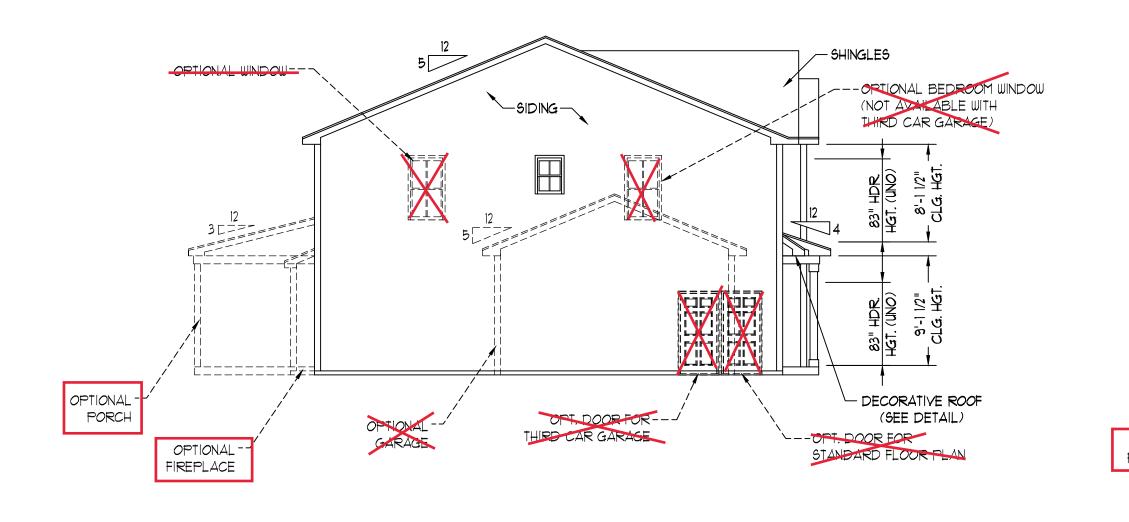


<u>LEFT ELEVATION</u> SCALE: 1/8" = 1'-0"

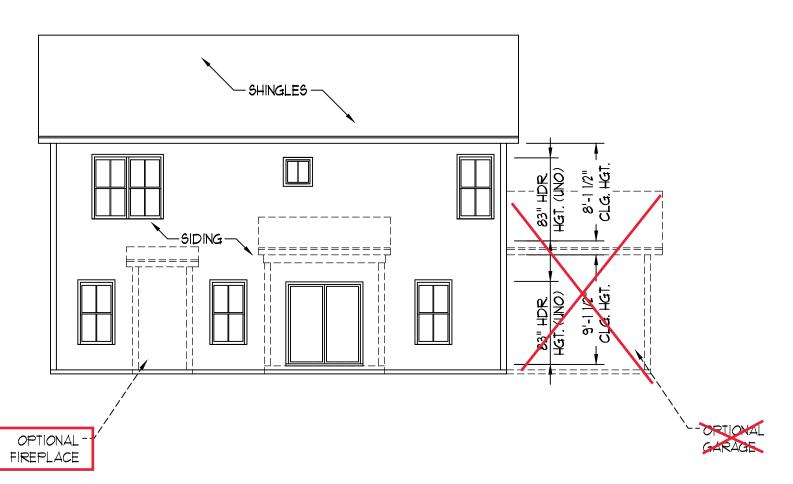

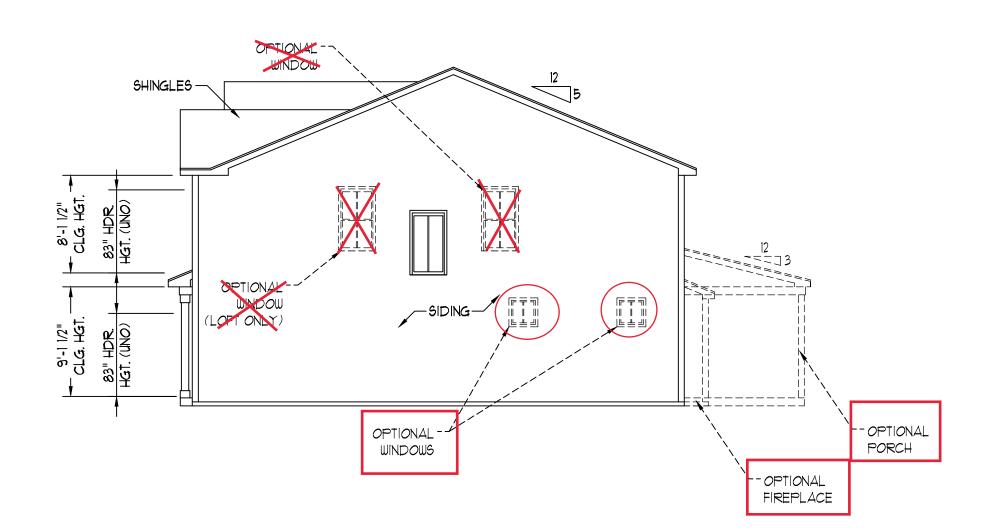

RIGHT ELEVATION SCALE: 1/8" = 1'-0"

REAR ELEVATION SCALE: 1/8" = 1'-0"

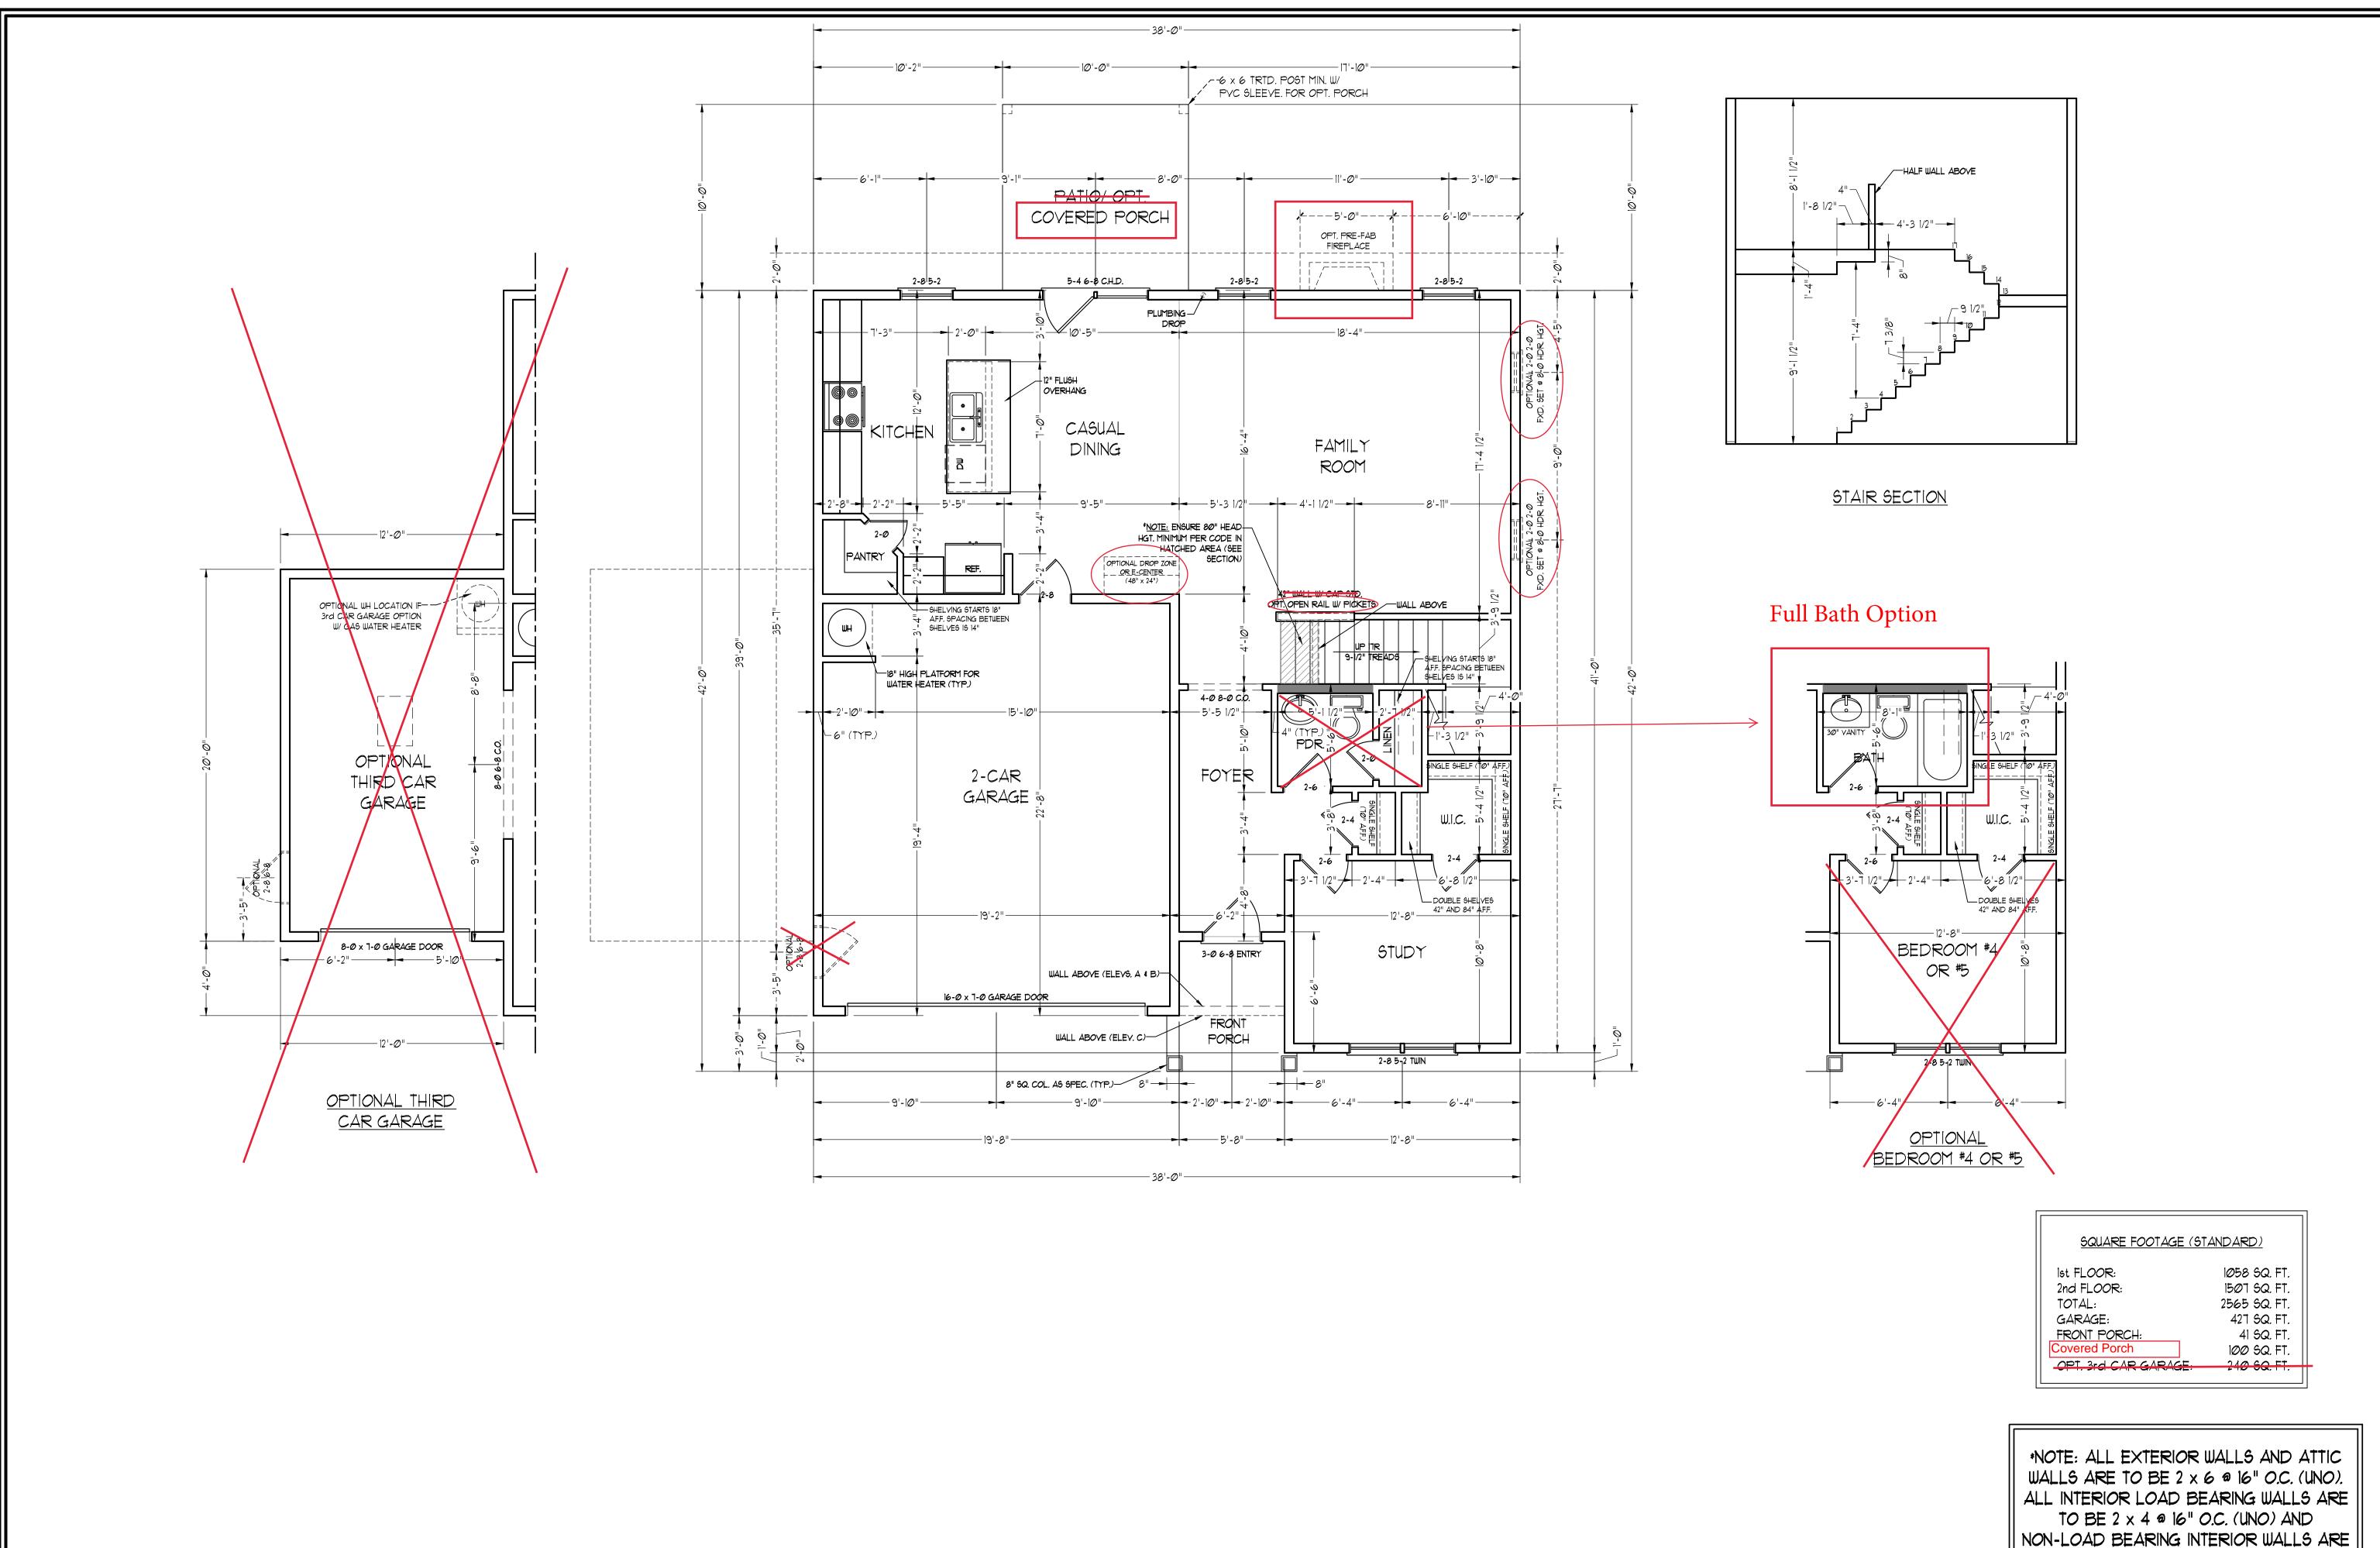


RENAISSANCE RESIDENTIAL DESIGN, INC. RALEIGH, NC (919) 649-4128

WWW.RRDCAROLINA.COM
"The art of transforming your vision into reality."

RENAISSANCE RESIDENTIAL DESIGN, INC.
RESERVES THE RIGHT TO MAKE
MODIFICATIONS TO FLOOR PLANS,
DIMENSIONS, MATERIALS, AND
SPECIFICATIONS WITHOUT NOTICE.
THESE DRAWINGS ARE FOR THE
PURPOSE OF CONVEYING AN
ARCHITECTURAL CONCEPT ONLY.

RENAISSANCE RESIDENTIAL DESIGN, INC.
HEREBY EXPRESSLY RESERVES ITS
COMMON LAW COPYRIGHT AND OTHER
PROPERTY RIGHTS IN THESE PLANS.
THESE PLANS AND DRAWINGS ARE NOT
TO BE REPRODUCED, CHANGED, OR
COPIED IN ANY FORM OR MANNER
WITHOUT FIRST OBTAINING THE EXPRESS
WRITTEN CONSENT OF RENAISSANCE
RESIDENTIAL DESIGN, INC. NOR ARE
THEY TO BE ASSIGNED TO ANY THIRD
PARTY WITHOUT FIRST OBTAINING SAID
WRITTEN PERMISSION AND CONSENT.

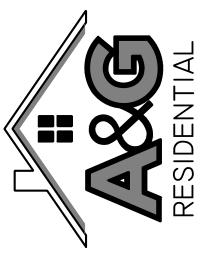

IENSIONS ARE SUBJECT TO CHANGE WITHOUT NOTICE.

RE FOOTAGE AND DIMENSIONS ARE ESTIMATED AND MAY
IN ACTUAL CONSTRUCTION. ACTUAL POSITION OF HOUSE
LOT WILL BE DETERMINED BY THE SITE PLAN AND PLOT
FLOOR PLANS AND ELEVATION RENDERINGS ARE ARTIST
ONCEPTIONS. FLOOR PLANS ARE THE COPYRIGHTED
PERTY OF A&G RESIDENTIAL. ANY USE, REPRODUCTION,
ADAPTATION, OR DISPLAY OF THE PLANS IS STRICTLY
ROHIBITED. SEE NEW HOME SALES CONSULTANT FOR

A&G RESIDENTIAL GREENVILLE DRIVE LEFT

DATE: MAY 21, 2020

REV.: 9-22-20

SCALE: 1/4"=1'-0"

DRAWN BY: WG

ENGINEERED BY:

FIRST FLOOR PLAN


A-4


TO BE 2 x 4 @ 24" O.C. (UNO).

\* SHADED INTERIOR WALLS ARE TO BE

2 x 6 @ 16" O.C. (LOAD BEARING) OR

2 x 6 @ 24" O.C. (NON-LOAD BEARING)

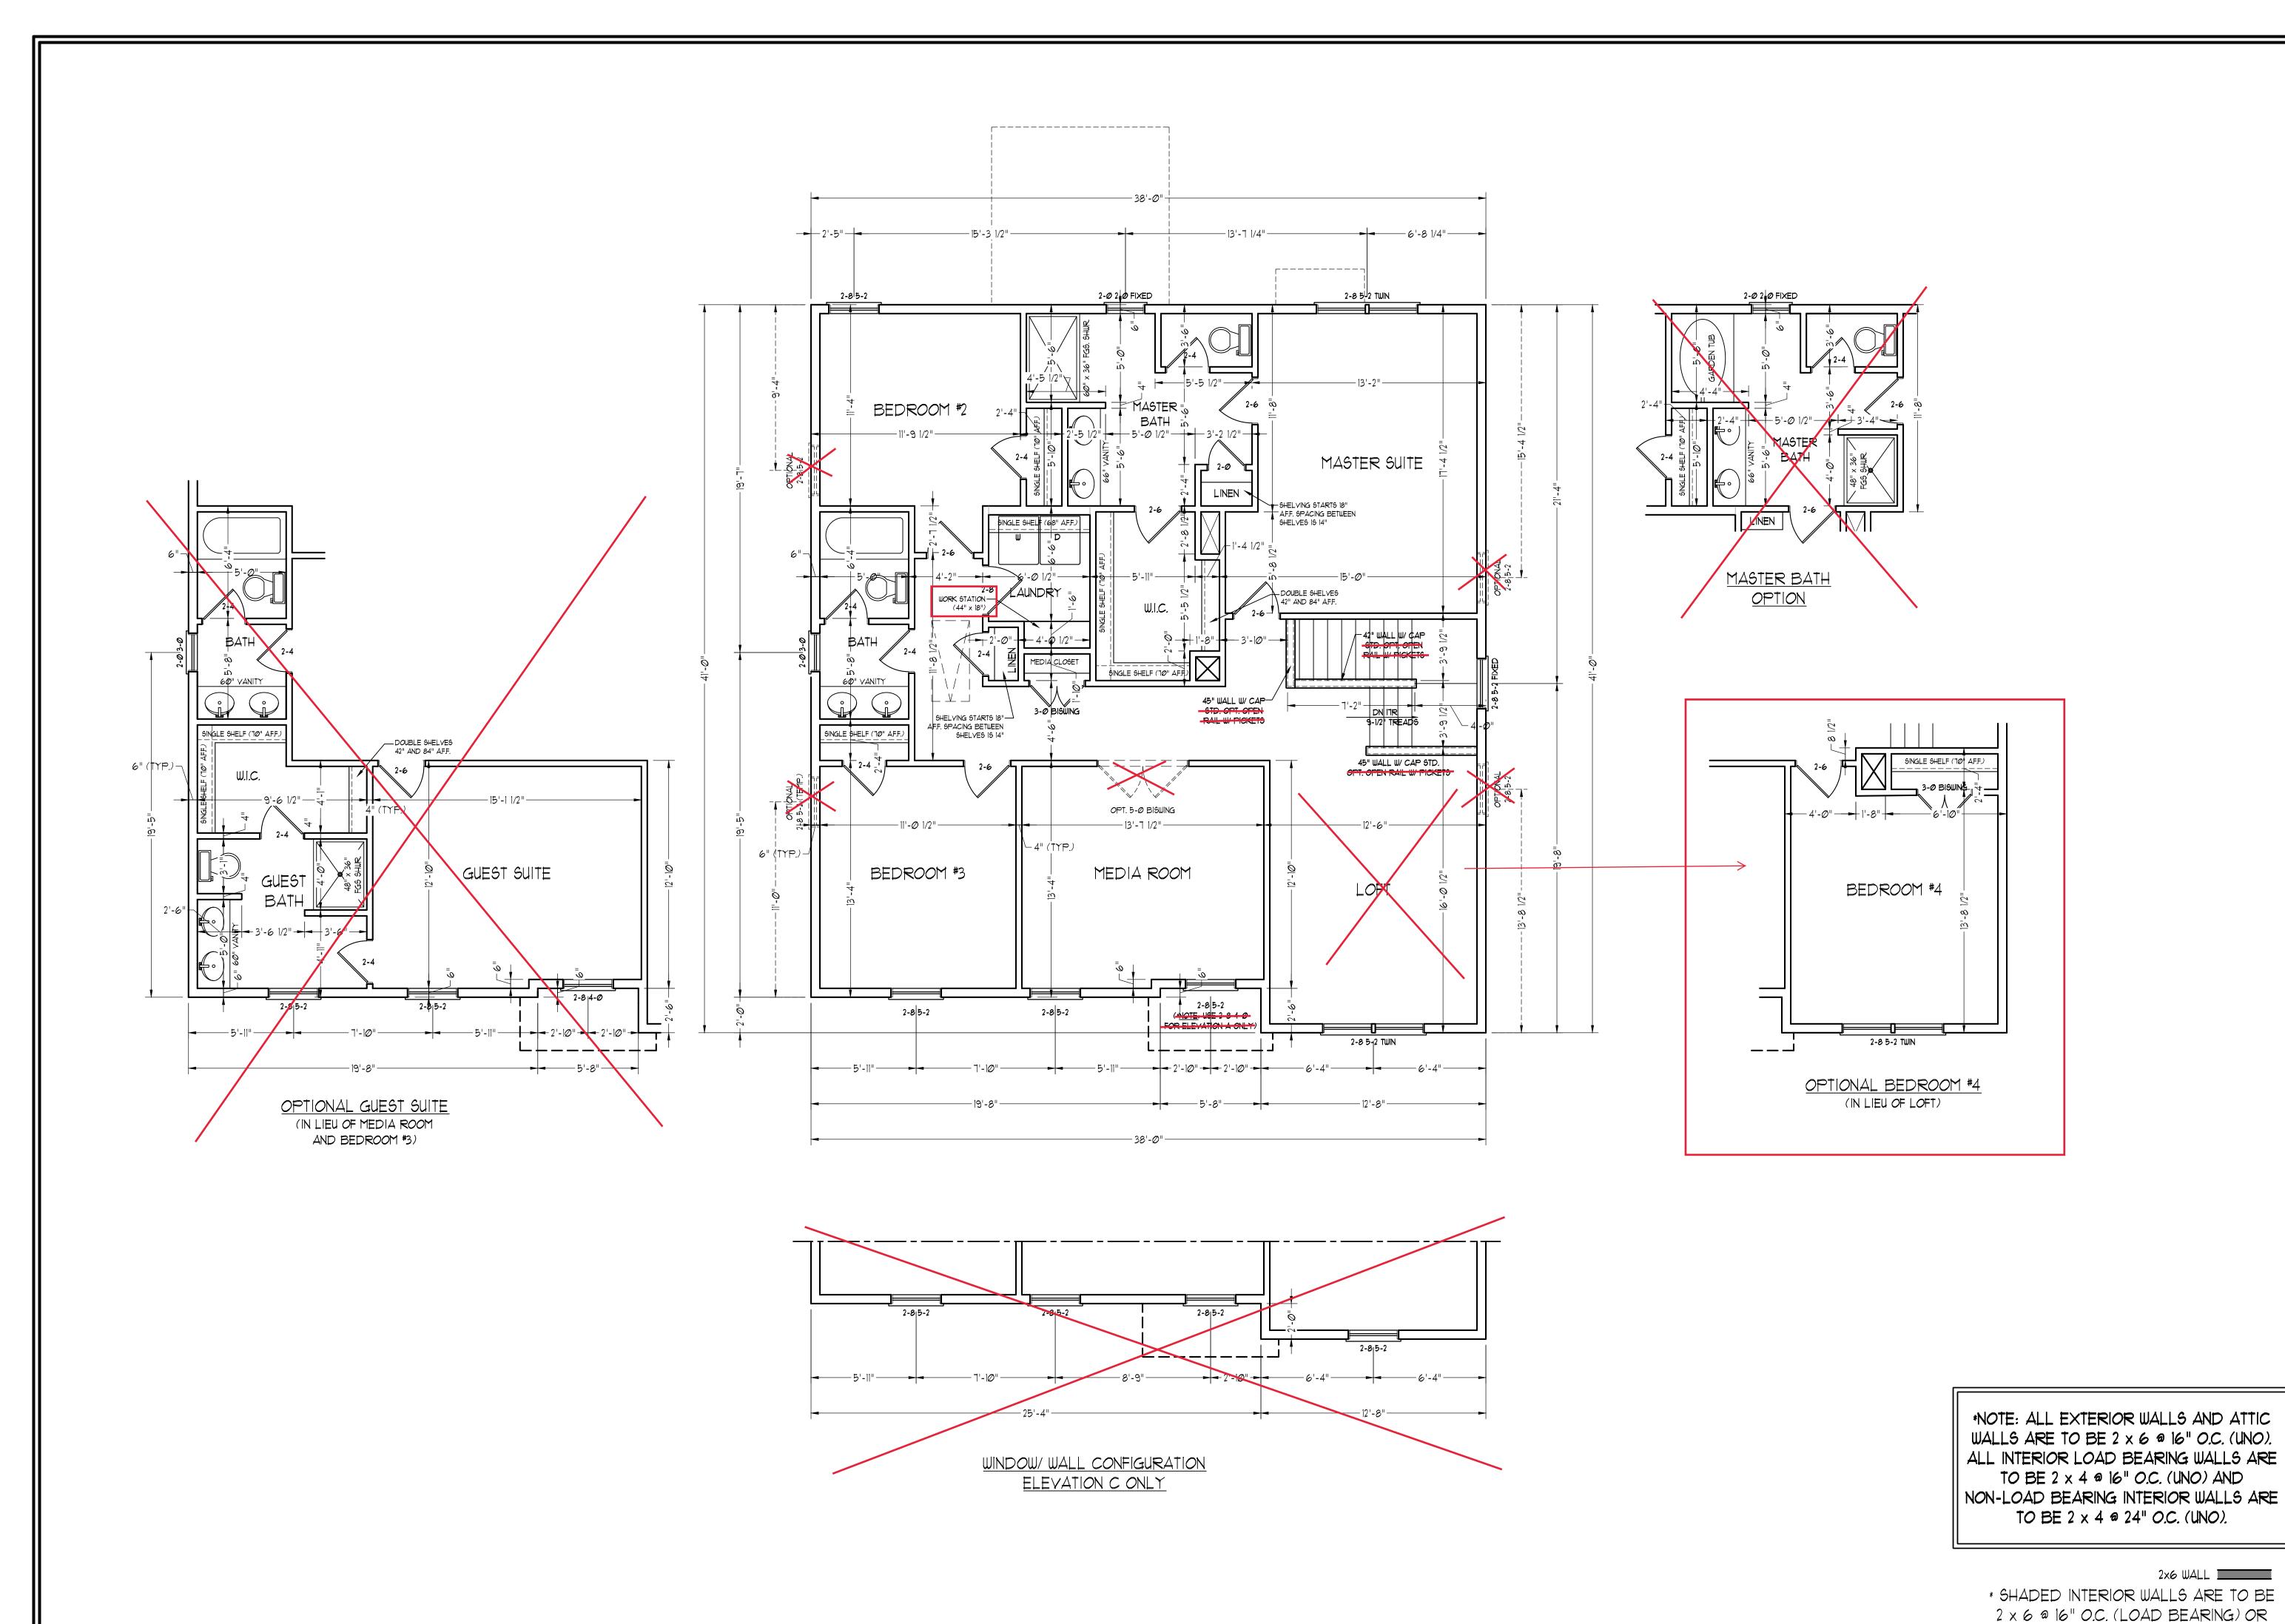

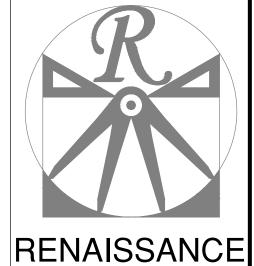


RESIDENTIAL DESIGN, INC.
RALEIGH, NC (919) 649-4128

WWW.RRDCAROLINA.COM
"The art of transforming your vision into reality."

RENAISSANCE RESIDENTIAL DESIGN, INC.
RESERVES THE RIGHT TO MAKE
MODIFICATIONS TO FLOOR PLANS,
DIMENSIONS, MATERIALS, AND
SPECIFICATIONS WITHOUT NOTICE.
THESE DRAWINGS ARE FOR THE
PURPOSE OF CONVEYING AN
ARCHITECTURAL CONCEPT ONLY.

RENAISSANCE RESIDENTIAL DESIGN, INC. HEREBY EXPRESSLY RESERVES ITS COMMON LAW COPYRIGHT AND OTHER PROPERTY RIGHTS IN THESE PLANS. THESE PLANS AND DRAWINGS ARE NOT TO BE REPRODUCED, CHANGED, OR COPIED IN ANY FORM OR MANNER WITHOUT FIRST OBTAINING THE EXPRESS WRITTEN CONSENT OF RENAISSANCE RESIDENTIAL DESIGN, INC. NOR ARE THEY TO BE ASSIGNED TO ANY THIRD PARTY WITHOUT FIRST OBTAINING SAID WRITTEN PERMISSION AND CONSENT.

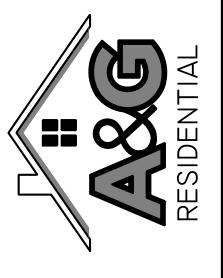

ENGLARIA SELEVATIONS, DESIGNA, MATERIALS AND SINSIONS ARE SUBJECT TO CHANGE WITHOUT NOTICE.

E FOOTAGE AND DIMENSIONS ARE ESTIMATED AND MAY A ACTUAL CONSTRUCTION. ACTUAL POSITION OF HOUSE OT WILL BE DETERMINED BY THE SITE PLAN AND PLOT SLOOR PLANS AND ELEVATION RENDERINGS ARE ARTIST INCEPTIONS. FLOOR PLANS ARE THE COPYRIGHTED ERTY OF A&G RESIDENTIAL. ANY USE, REPRODUCTION, AAPTATION, OR DISPLAY OF THE PLANS IS STRICTLY OHIBITED. SEE NEW HOME SALES CONSULTANT FOR BENT DEFAILS.

A&G RESIDENTIAL GREENVILLE DRIVE LEFT

DATE: MAY 21, 2020

REV.: 9-22-20

SCALE: 1/4"=1'-0"

DRAWN BY: WG
ENGINEERED BY:


REVIEWED BY:


SECOND FLOOR

PLAN

A-5

2 x 6 @ 24" O.C. (NON-LOAD BEARING)

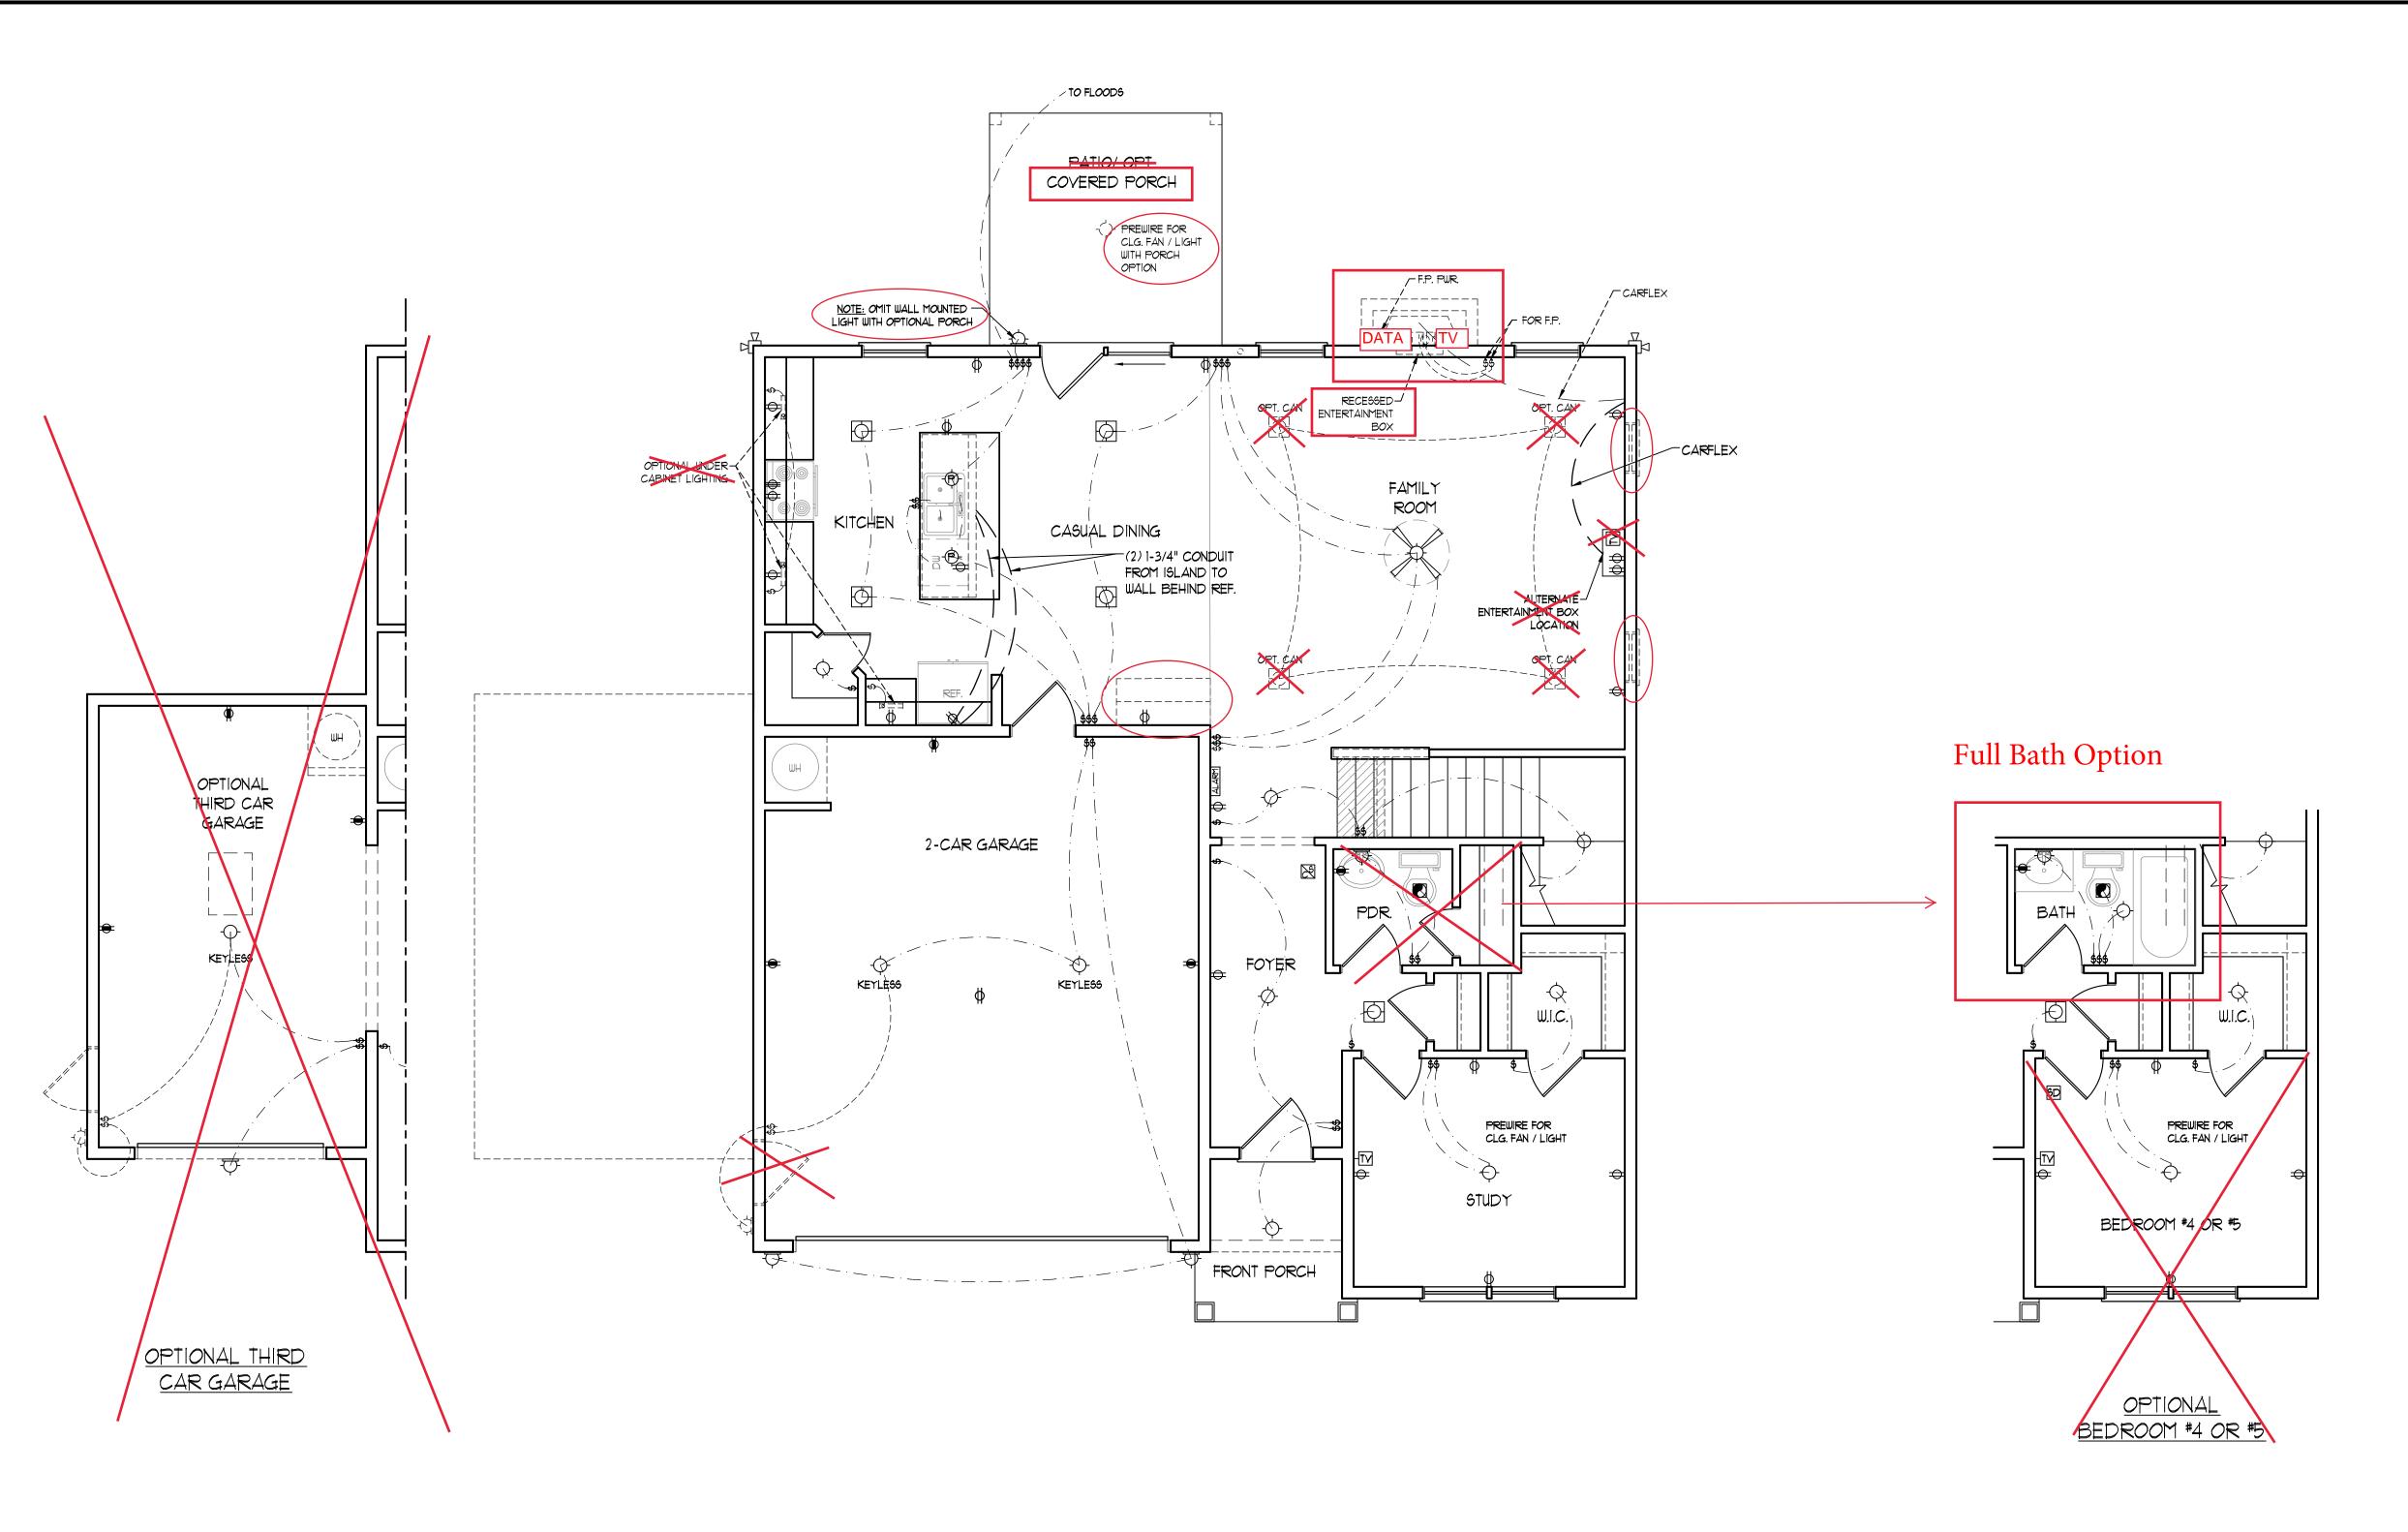

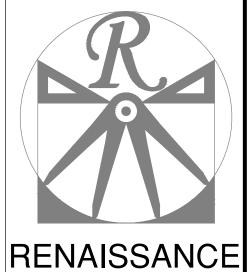

# RESIDENTIAL DESIGN, INC. RALEIGH, NC (919) 649-4128

WWW.RRDCAROLINA.COM
"The art of transforming your vision into reality."

RENAISSANCE RESIDENTIAL DESIGN, INC.
RESERVES THE RIGHT TO MAKE
MODIFICATIONS TO FLOOR PLANS,
DIMENSIONS, MATERIALS, AND
SPECIFICATIONS WITHOUT NOTICE.
THESE DRAWINGS ARE FOR THE
PURPOSE OF CONVEYING AN

ARCHITECTURAL CONCEPT ONLY.

RENAISSANCE RESIDENTIAL DESIGN, INC.

HEREBY EXPRESSLY RESERVES ITS

COMMON LAW COPYRIGHT AND OTHER PROPERTY RIGHTS IN THESE PLANS.

THESE PLANS AND DRAWINGS ARE NOT TO BE REPRODUCED, CHANGED, OR COPIED IN ANY FORM OR MANNER WITHOUT FIRST OBTAINING THE EXPRESS

WITHOUT FIRST OBTAINING THE EXPRESS
WRITTEN CONSENT OF RENAISSANCE
RESIDENTIAL DESIGN, INC. NOR ARE
THEY TO BE ASSIGNED TO ANY THIRD
PARTY WITHOUT FIRST OBTAINING SAID
WRITTEN PERMISSION AND CONSENT.

ELECTRICAL LAYOUT NOTES:

1.) BLOCK AND WIRE FOR ALL CELING FANS PER PLAN.

2.) VANITY LIGHTS TO BE SET 90" AFF. (TYP.)

3.) ADDITIONAL EXTERIOR OUTLETS REQUIRED BY CODE TO BE LOCATED BY ELECTRICIAN.

4.) PLACE SWITCHES 8" (MIN.) FROM ROUGH OPENINGS.

# ELECTRICAL LEGEND

→ IIØ ∨ OUTLET

IIØ ∨ GFI OUTLET

■

□ ✓ SWITCHED OUTLET

BB = 110 V BASEBOARD OUTLET

4-PLEX

COUNTER OR FLOOR MOUNTED

COUNTER OR FLOOR MOUNTED 110V GF1

₩EATHERPROOF

**⊕** 22Ø ∨ OUTLET

Ø 110 V DEDICATED CIRCUIT

# 220 Y DEDICATED CIRCUIT

● SPECIAL PURPOSE (240 V, ETC.)

- WALL MOUNT LIGHT

CEILING MOUNT LIGHT

PENDANT LIGHT

RECESSED CAN LIGHT

MINI CAN LIGHT

EYEBALL LIGHT

FLUORESCENT LIGHT

undercabinet light

FLOOD LIGHT

\$ SWITCH

\$D DIMMER SWITCH

TELEPHONE

DATA

TELEPHONE AND DATA

TV- TV CONNECTION
TV/ DATA

CD- CONDUIT FOR COMPONENT WIRING

SP SPEAKER

IIØ V SMOKE/ CM DETECTOR

IIØ V SMOKE DETECTOR

EXHAUST FAN

LOW VOLTAGE PANEL

[ALARM] ALARM PANEL





A&G RESIDENTIAL GREENVILLE DRIVE LEFT

DATE: MAY 21, 2020

REV.: 9-22-20 SCALE: 1/4"=1'-0"


DRAWN BY: WG

ENGINEERED BY:

REVIEWED BY:

FIRST FLOOR ELECTRICAL PLAN

E-1

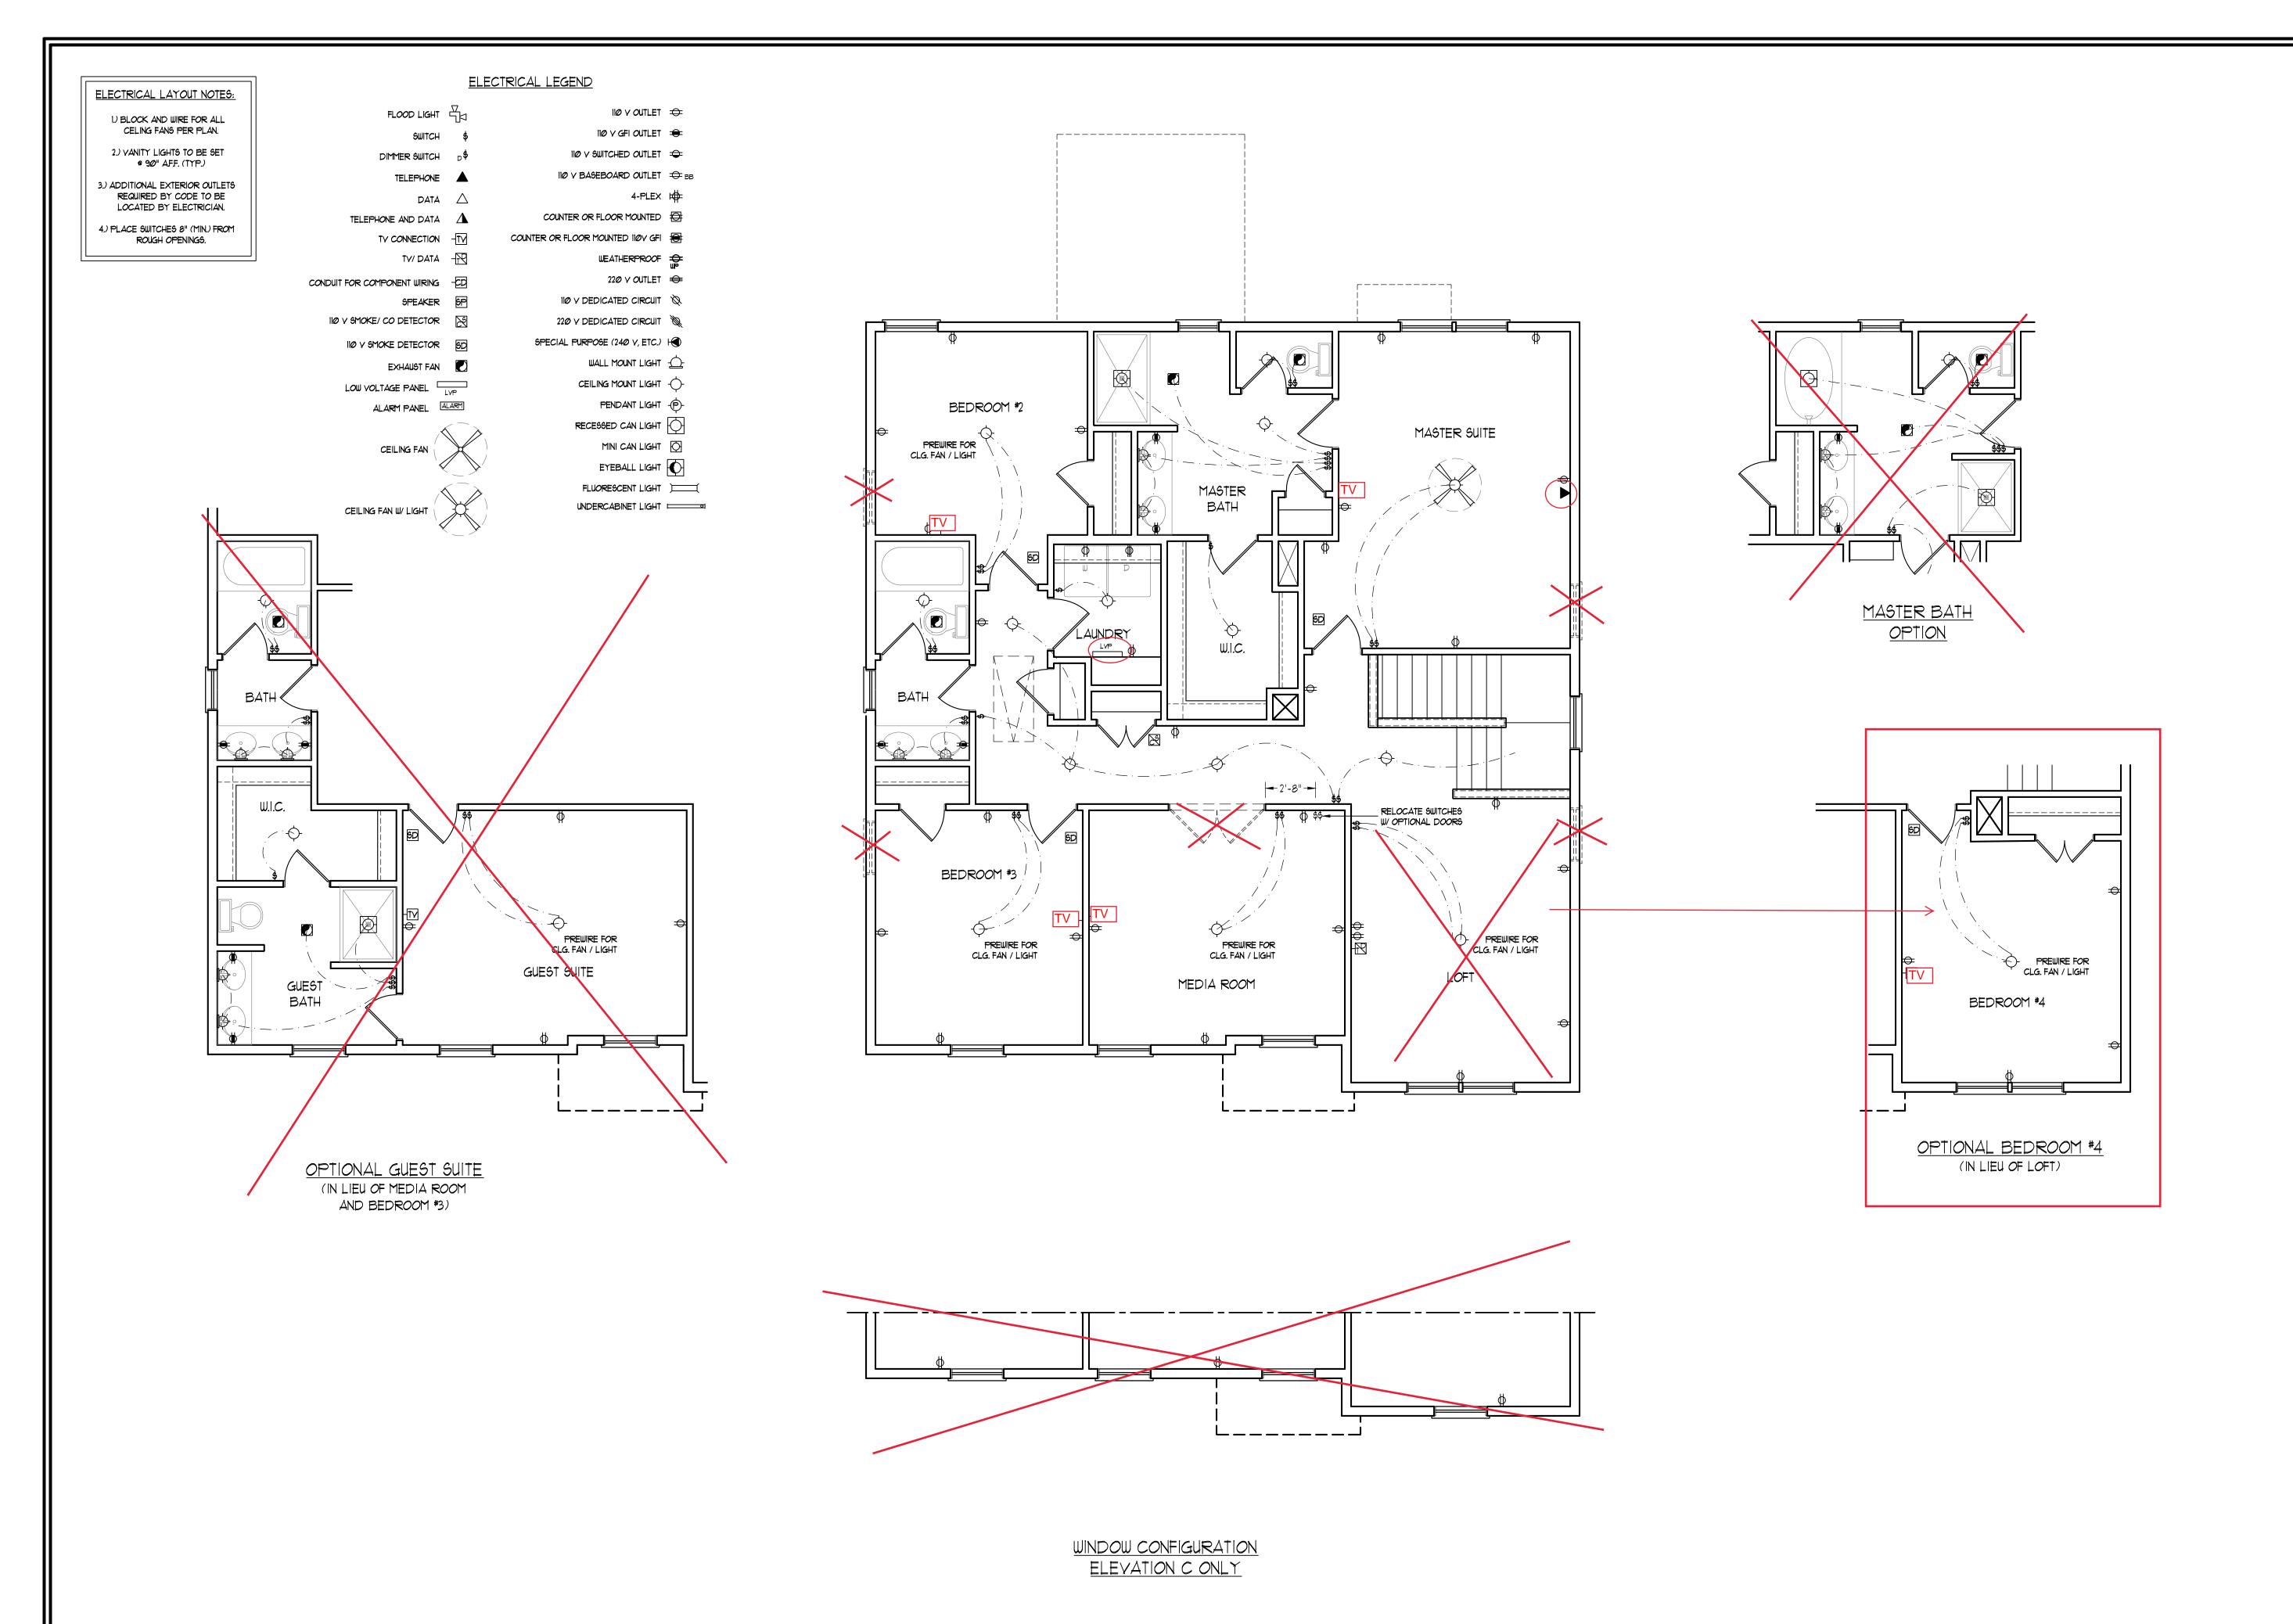

RENAISSANCE
RESIDENTIAL DESIGN, INC.
RALEIGH, NC (919) 649-4128

WWW.RRDCAROLINA.COM
"The art of transforming your vision into reality."

RENAISSANCE RESIDENTIAL DESIGN, INC.
RESERVES THE RIGHT TO MAKE
MODIFICATIONS TO FLOOR PLANS,
DIMENSIONS, MATERIALS, AND
SPECIFICATIONS WITHOUT NOTICE.
THESE DRAWINGS ARE FOR THE
PURPOSE OF CONVEYING AN
ARCHITECTURAL CONCEPT ONLY.

HEREBY EXPRESSLY RESERVES ITS
COMMON LAW COPYRIGHT AND OTHER
PROPERTY RIGHTS IN THESE PLANS.
THESE PLANS AND DRAWINGS ARE NOT
TO BE REPRODUCED, CHANGED, OR
COPIED IN ANY FORM OR MANNER
WITHOUT FIRST OBTAINING THE EXPRESS
WRITTEN CONSENT OF RENAISSANCE
RESIDENTIAL DESIGN, INC. NOR ARE
THEY TO BE ASSIGNED TO ANY THIRD
PARTY WITHOUT FIRST OBTAINING SAID
WRITTEN PERMISSION AND CONSENT.

RENAISSANCE RESIDENTIAL DESIGN, INC.



FLOOR PLANS, ELEVATIONS, DESIGNS, MATERIALS AND DIMENSIONS ARE SUBJECT TO CHANGE WITHOUT NOTICE. QUARE FOOTAGE AND DIMENSIONS ARE ESTIMATED AND MAY ARY IN ACTUAL CONSTRUCTION. ACTUAL POSITION OF HOUSE ON LOT WILL BE DETERMINED BY THE SITE PLAN AND PLOT LAN. FLOOR PLANS AND ELEVATION RENDERINGS ARE ARTIST CONCEPTIONS. FLOOR PLANS ARE THE COPYRIGHTED PROPERTY OF A&G RESIDENTIAL. ANY USE, REPRODUCTION, ADAPTATION, OR DISPLAY OF THE PLANS IS STRICTLY PROHIBITED. SEE NEW HOME SALES CONSULTANT FOR CURRENT DETAILS. COPYRIGHT © 2020 A&G RESIDENTIAL

A&G RESIDENTIAL GREENVILLE DRIVE LEFT

DATE: MAY 21, 2020

REV.: 9-22-20

SCALE: 1/4"=1'-0"


DRAWN BY: WG


ENGINEERED BY:

REVIEWED BY:

SECOND FLOOR ELECTRICAL PLAN

E-2

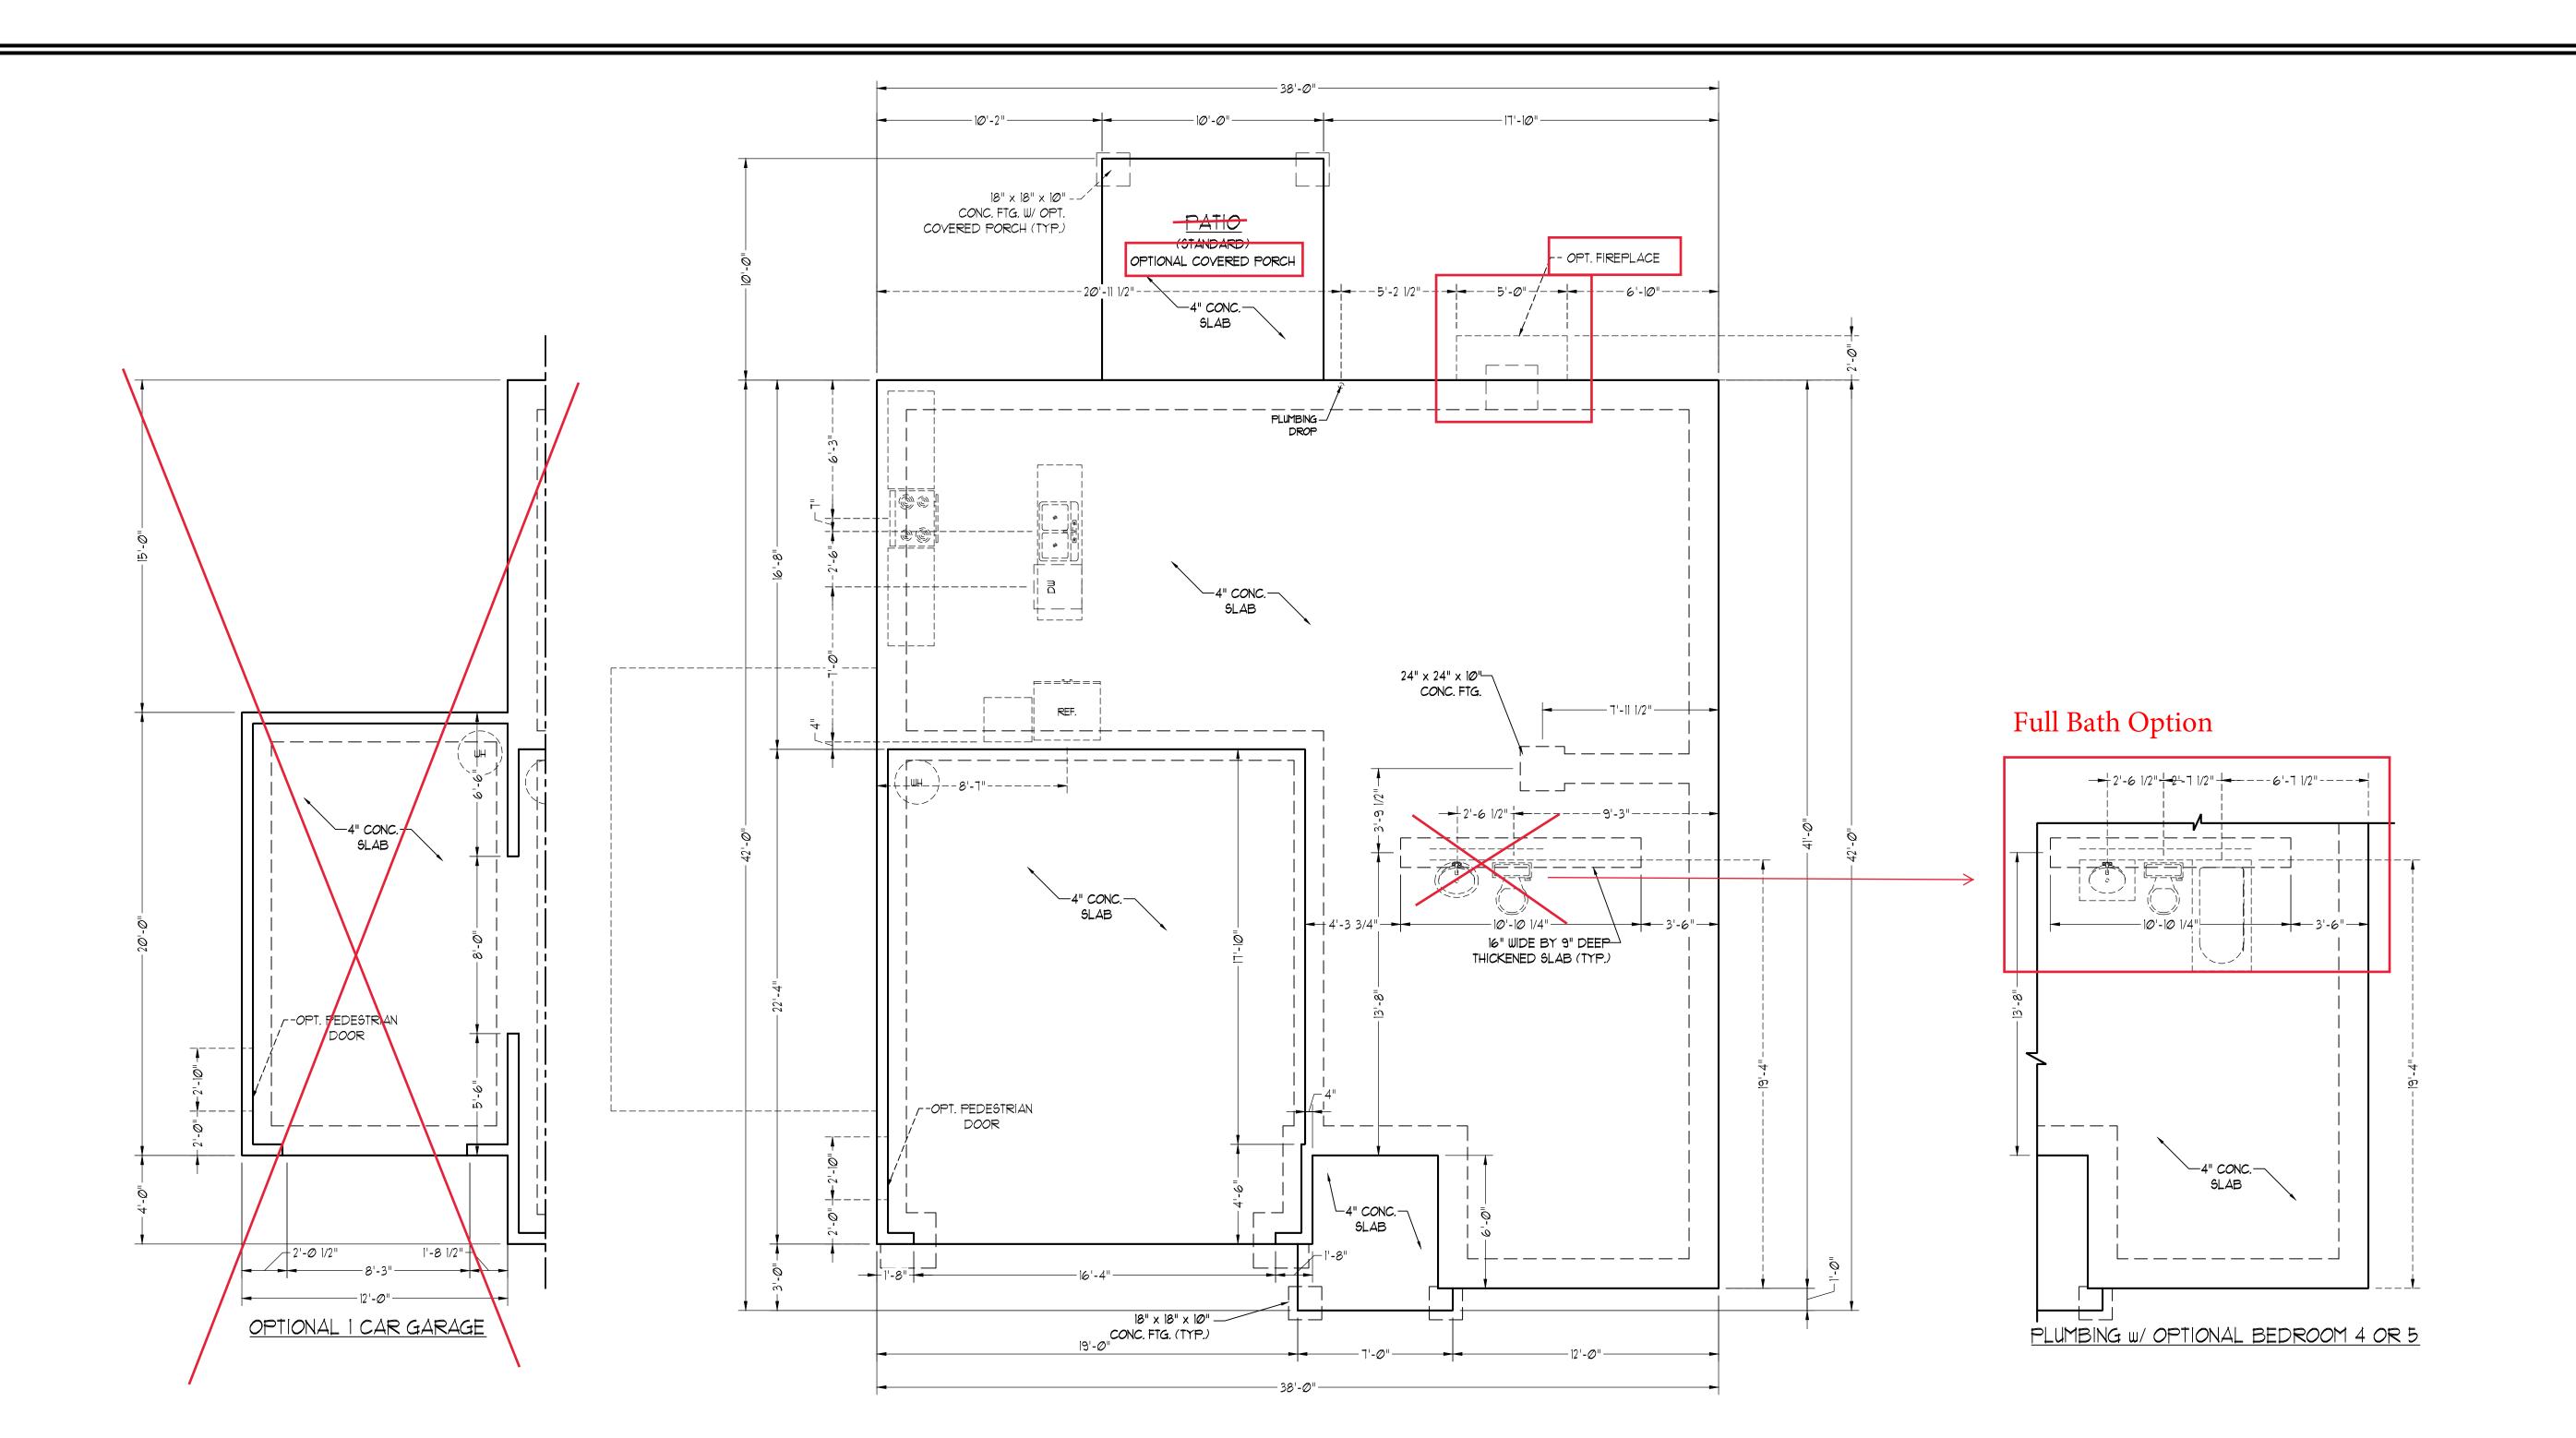

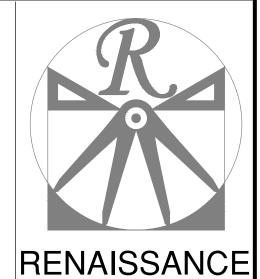


RESIDENTIAL DESIGN, INC.
RALEIGH, NC (919) 649-4128
WWW.RRDCAROLINA.COM

"The art of transforming your vision into reality."

RENAISSANCE RESIDENTIAL DESIGN, INC.
RESERVES THE RIGHT TO MAKE
MODIFICATIONS TO FLOOR PLANS,
DIMENSIONS, MATERIALS, AND
SPECIFICATIONS WITHOUT NOTICE.
THESE DRAWINGS ARE FOR THE
PURPOSE OF CONVEYING AN
ARCHITECTURAL CONCEPT ONLY.

RENAISSANCE RESIDENTIAL DESIGN, INC.
HEREBY EXPRESSLY RESERVES ITS
COMMON LAW COPYRIGHT AND OTHER
PROPERTY RIGHTS IN THESE PLANS.
THESE PLANS AND DRAWINGS ARE NOT
TO BE REPRODUCED, CHANGED, OR
COPIED IN ANY FORM OR MANNER
WITHOUT FIRST OBTAINING THE EXPRESS
WRITTEN CONSENT OF RENAISSANCE
RESIDENTIAL DESIGN, INC. NOR ARE
THEY TO BE ASSIGNED TO ANY THIRD
PARTY WITHOUT FIRST OBTAINING SAID
WRITTEN PERMISSION AND CONSENT.

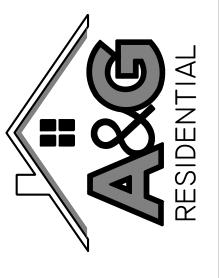

MENSIONS ARE SUBJECT TO CHANGE WITHOUT NOTICE.
ARE FOOTAGE AND DIMENSIONS ARE ESTIMATED AND MAY
AND MENSIONS ARE SUBJECT TO CHANGE WITHOUT NOTICE.
AND MILL BE DETERMINED BY THE SITE PLAN AND PLOT
A. FLOOR PLANS AND ELEVATION RENDERINGS ARE ARTIST
CONCEPTIONS. FLOOR PLANS ARE THE COPYRIGHTED
OPERTY OF A&G RESIDENTIAL. ANY USE, REPRODUCTION,
ADAPTATION, OR DISPLAY OF THE PLANS IS STRICTLY
PROHIBITED. SEE NEW HOME SALES CONSULTANT FOR
INBRENT DETAILS. COPYRIGHT © 2020 A&G RESIDENTIAL

A&G RESIDENTIAL GREENVILLE DRIVE I FFT

DATE: MAY 21, 2020

REV.: 9-22-20

SCALE: 1/4"=1'-0"


DRAWN BY: WG


ENGINEERED BY:

REVIEWED BY:

MONO SLAB FOUNDATION PLAN

S-1

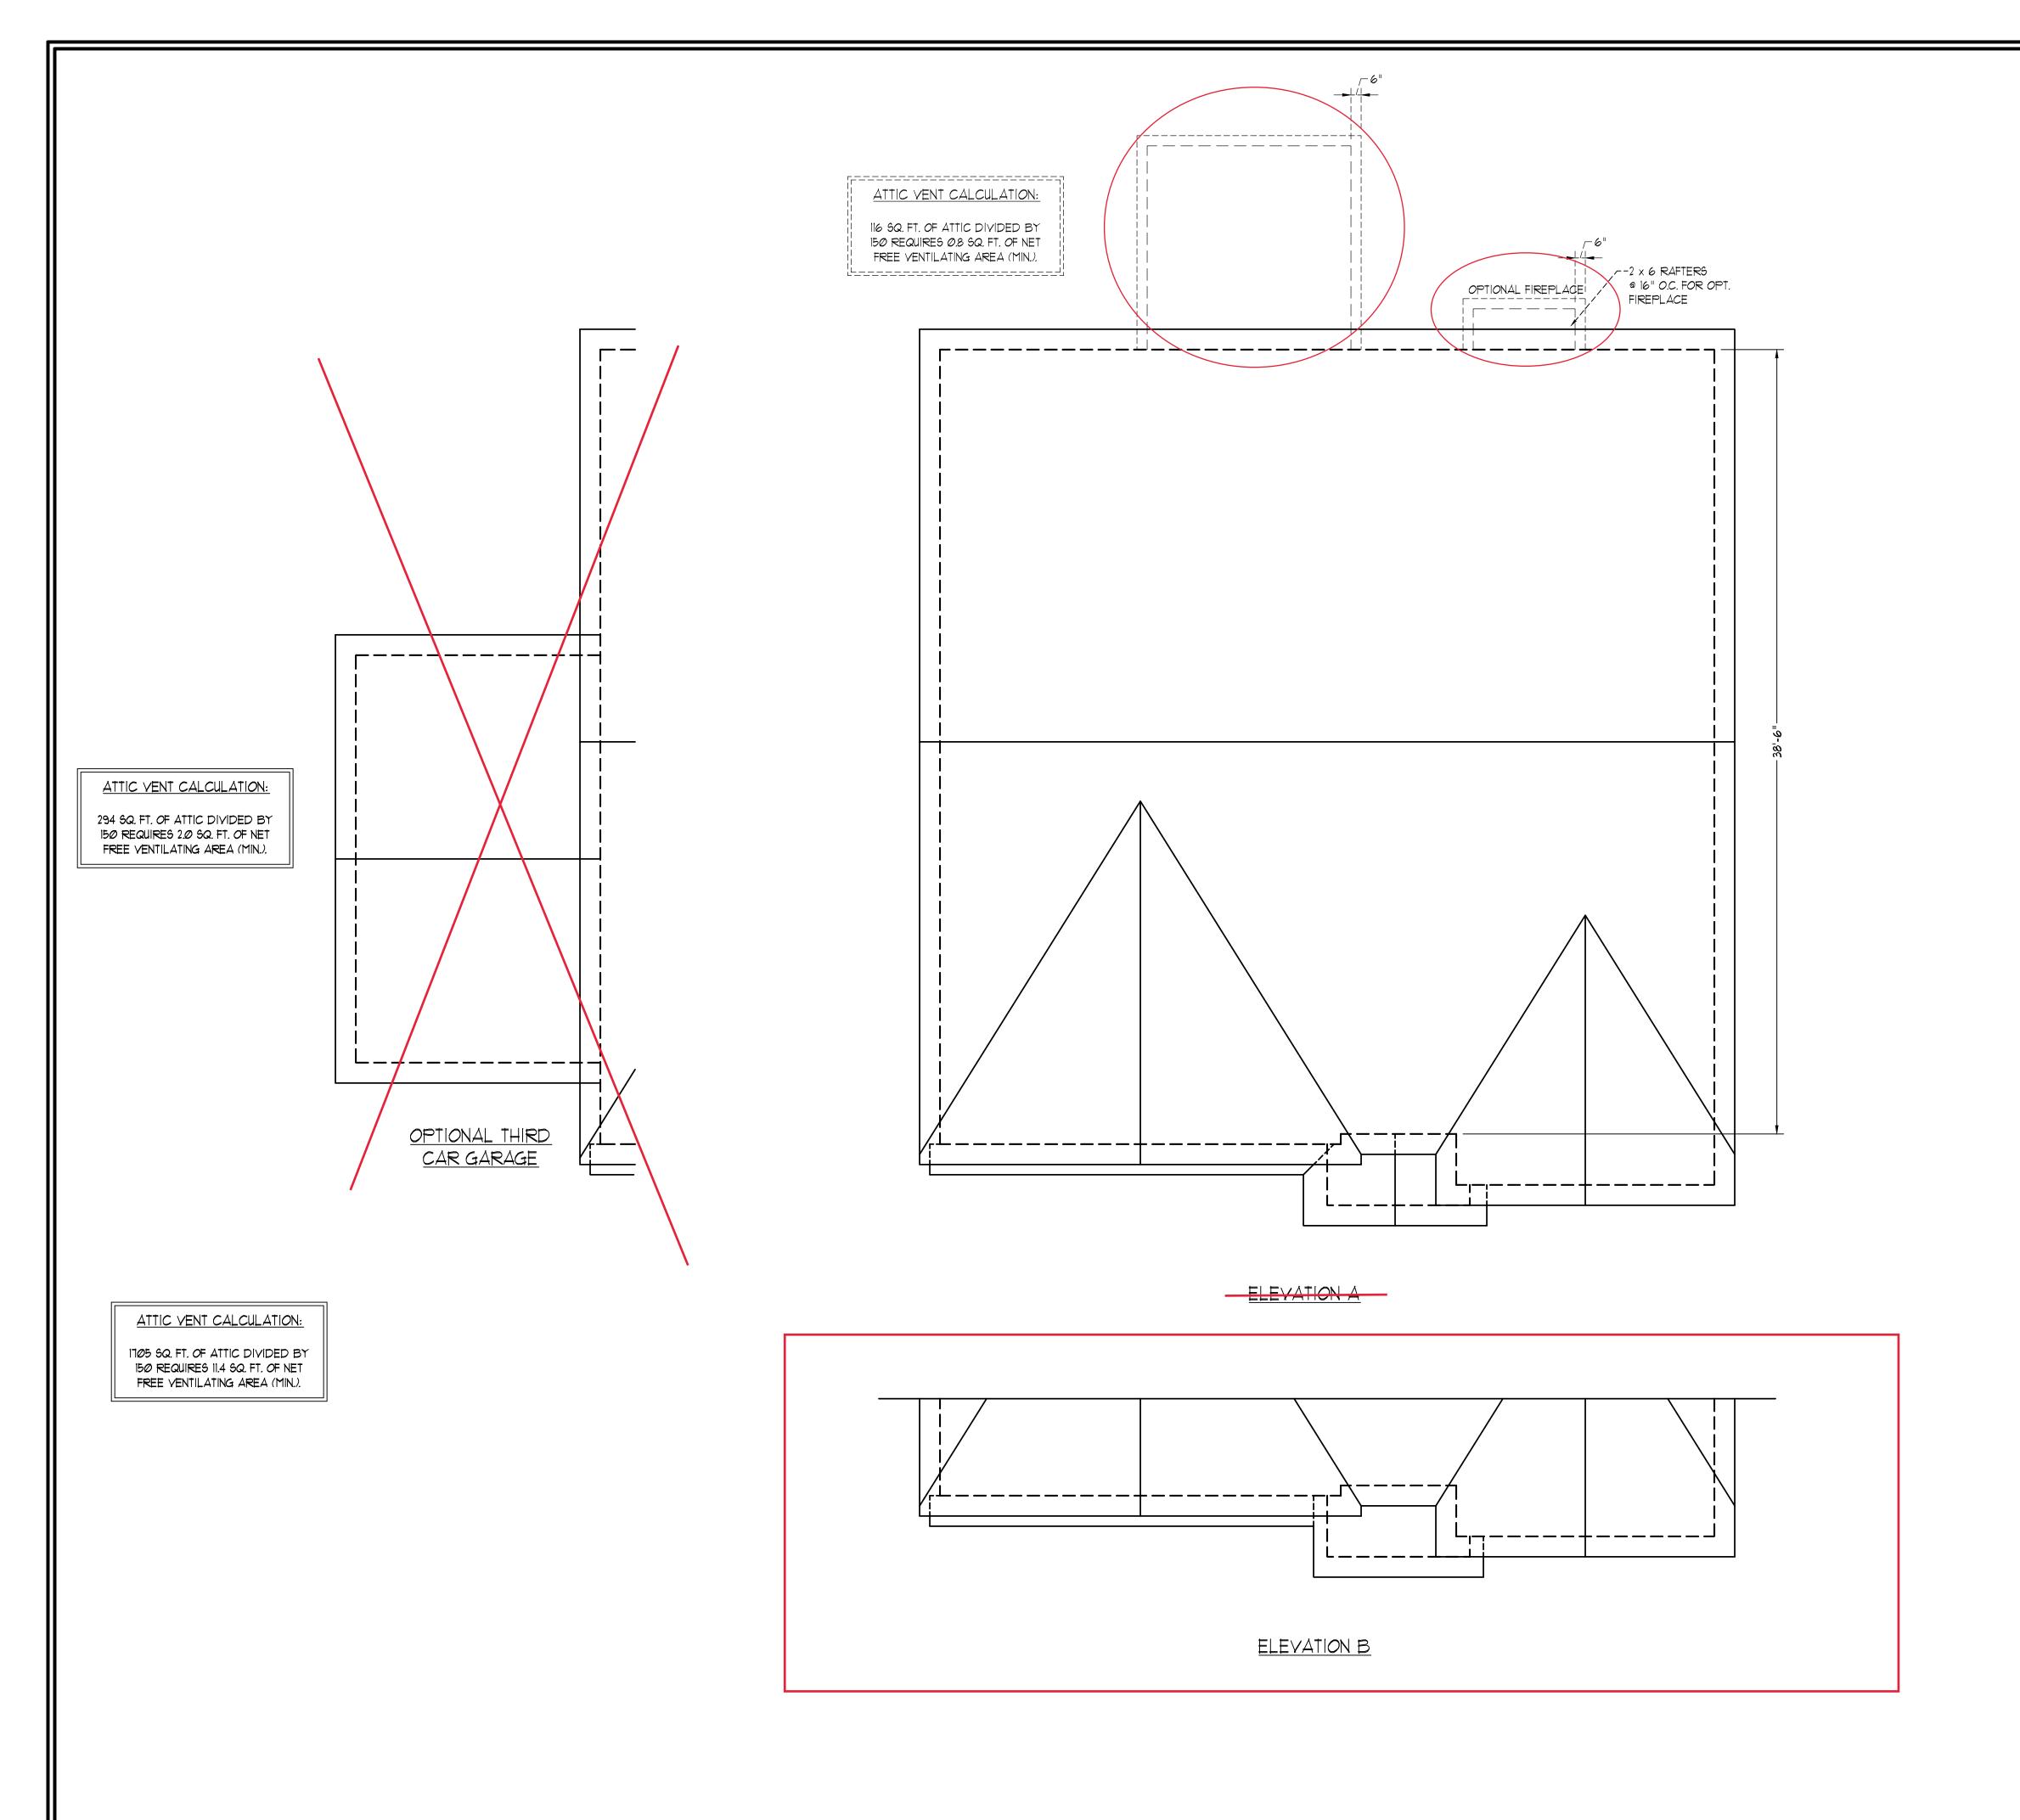

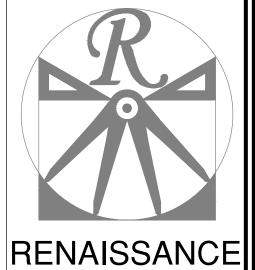


RESIDENTIAL DESIGN, INC.
RALEIGH, NC (919) 649-4128

WWW.RRDCAROLINA.COM
"The art of transforming your vision into reality."

RENAISSANCE RESIDENTIAL DESIGN, INC.
RESERVES THE RIGHT TO MAKE
MODIFICATIONS TO FLOOR PLANS,
DIMENSIONS, MATERIALS, AND
SPECIFICATIONS WITHOUT NOTICE.
THESE DRAWINGS ARE FOR THE
PURPOSE OF CONVEYING AN
ARCHITECTURAL CONCEPT ONLY.

HEREBY EXPRESSLY RESERVES ITS
COMMON LAW COPYRIGHT AND OTHER
PROPERTY RIGHTS IN THESE PLANS.
THESE PLANS AND DRAWINGS ARE NOT
TO BE REPRODUCED, CHANGED, OR
COPIED IN ANY FORM OR MANNER
WITHOUT FIRST OBTAINING THE EXPRESS
WRITTEN CONSENT OF RENAISSANCE
RESIDENTIAL DESIGN, INC. NOR ARE
THEY TO BE ASSIGNED TO ANY THIRD
PARTY WITHOUT FIRST OBTAINING SAID
WRITTEN PERMISSION AND CONSENT.

RENAISSANCE RESIDENTIAL DESIGN, INC.

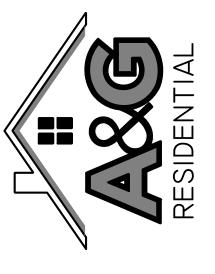

PRICES, PROMOTIONS, INCENTIVES, FEATURES, OPTIONS, FLOOR PLANS, ELEVATIONS, DESIGNS, MATERIALS AND DIMENSIONS ARE STIMATED AND DIMENSIONS ARE ESTIMATED AND MAY BY IN ACTUAL CONSTRUCTION. ACTUAL POSITION OF HOUSE IN LOT WILL BE DETERMINED BY THE SITE PLAN AND PLOT AN FLOOR PLANS ARE THE COPYRIGHTED CONCEPTIONS. FLOOR PLANS ARE THE COPYRIGHTED APPENTION. A AGG RESIDENTIAL. ANY USE, REPRODUCTION, ADAPTATION, OR DISPLAY OF THE PLANS IS STRICTLY PROHIBITED. SEE NEW HOME SALES CONSULTANT FOR

A&G RESIDENTIAL GREENVILLE DRIVE I FFT

DATE: MAY 21, 2020

REV.: 9-22-20

SCALE: 1/4"=1'-0"


DRAWN BY: WG

ENGINEERED BY:


REVIEWED BY:


ROOF PLAN ELEVATIONS A & B

S-4

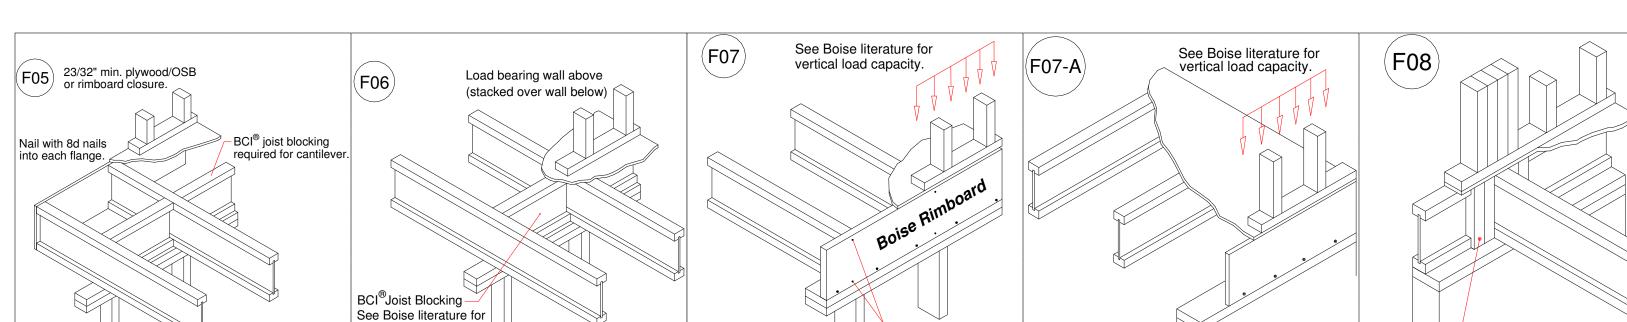



vertical load capacity.

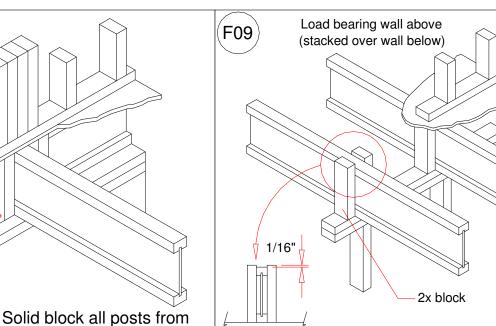

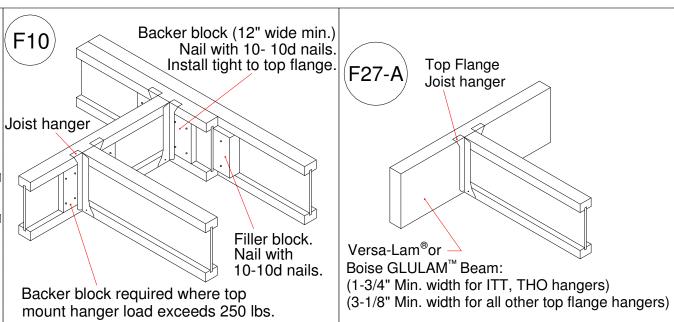

Install tight to top flange.

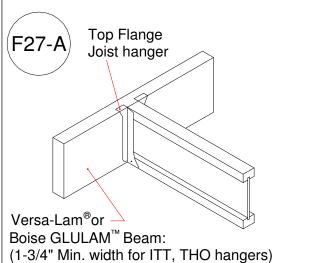

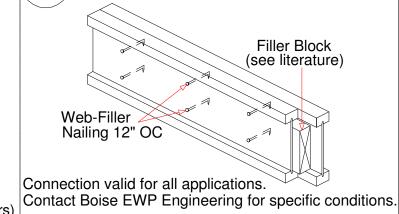

Double BCI® Joist

Connection



**Boise Cascade** www.bldr.com

1135 ROBESON STREET FAYETTEVILLE, NC 28305 V (910) 485-1111

7601 BOEING DRIVE GREENSBORO, NC 27409 V (336) 884-5454

3189 NC HIGHWAY5 ABERDEEN NC 28315 V (910) 944-2516

This layout and associated materials list has been prepared based on project plans and/or information provided to Builders FirstSource (BFS). It remains the responsibility of the review this information to assure complete and complies with

builder, architect, designer, or other responsible persons to that it is appropriate, accurate, applicable building codes.

1.) READ THE INSTALLATION GUIDE BEFORE FRAMING.
2.) ALL WALLS SHOWN ARE LOAD BEARING UNLESS NOTED OTHERWISE. WALLS NOT SHOWN ARE CONSIDERED NON-LOAD BEARING.
3.) UNLESS STATED OTHERWISE ALL CEILING & ROOF LOADS BRACE DIRECTLY TO LOAD BEARING WALLS SUPPORTED BY FOUNDATION.
4.) CONTACT BUILDERS FIRSTSOURCE BEFORE MAKING ANY ALTERATIONS OR ADJUSTMENTS...FAILURE TO DO SO MAY RESULT IN COSTLY REPAIRS.

A&G Residential

KLF054 GREENVILLE

EWP PLACEMENT PLAN

Builders FirstSource, Central Carolina Markets AJ Nap DRAWN BY:

MINIMUM DESIGN DATA

LIVE LOAD 40 PSF DEAD LOAD 10 PSF


TOTAL LOAD 50 PSF

DOL = 100% DEFLECTION CRITERIA

L/480 (MINIMUM)

ARCHITECTUAL PLAN DATE XX-XX-XX REVISED ARCH. PLAN DATE XX-XX-XX


> XXXXXXX Sheet 1 OF 1

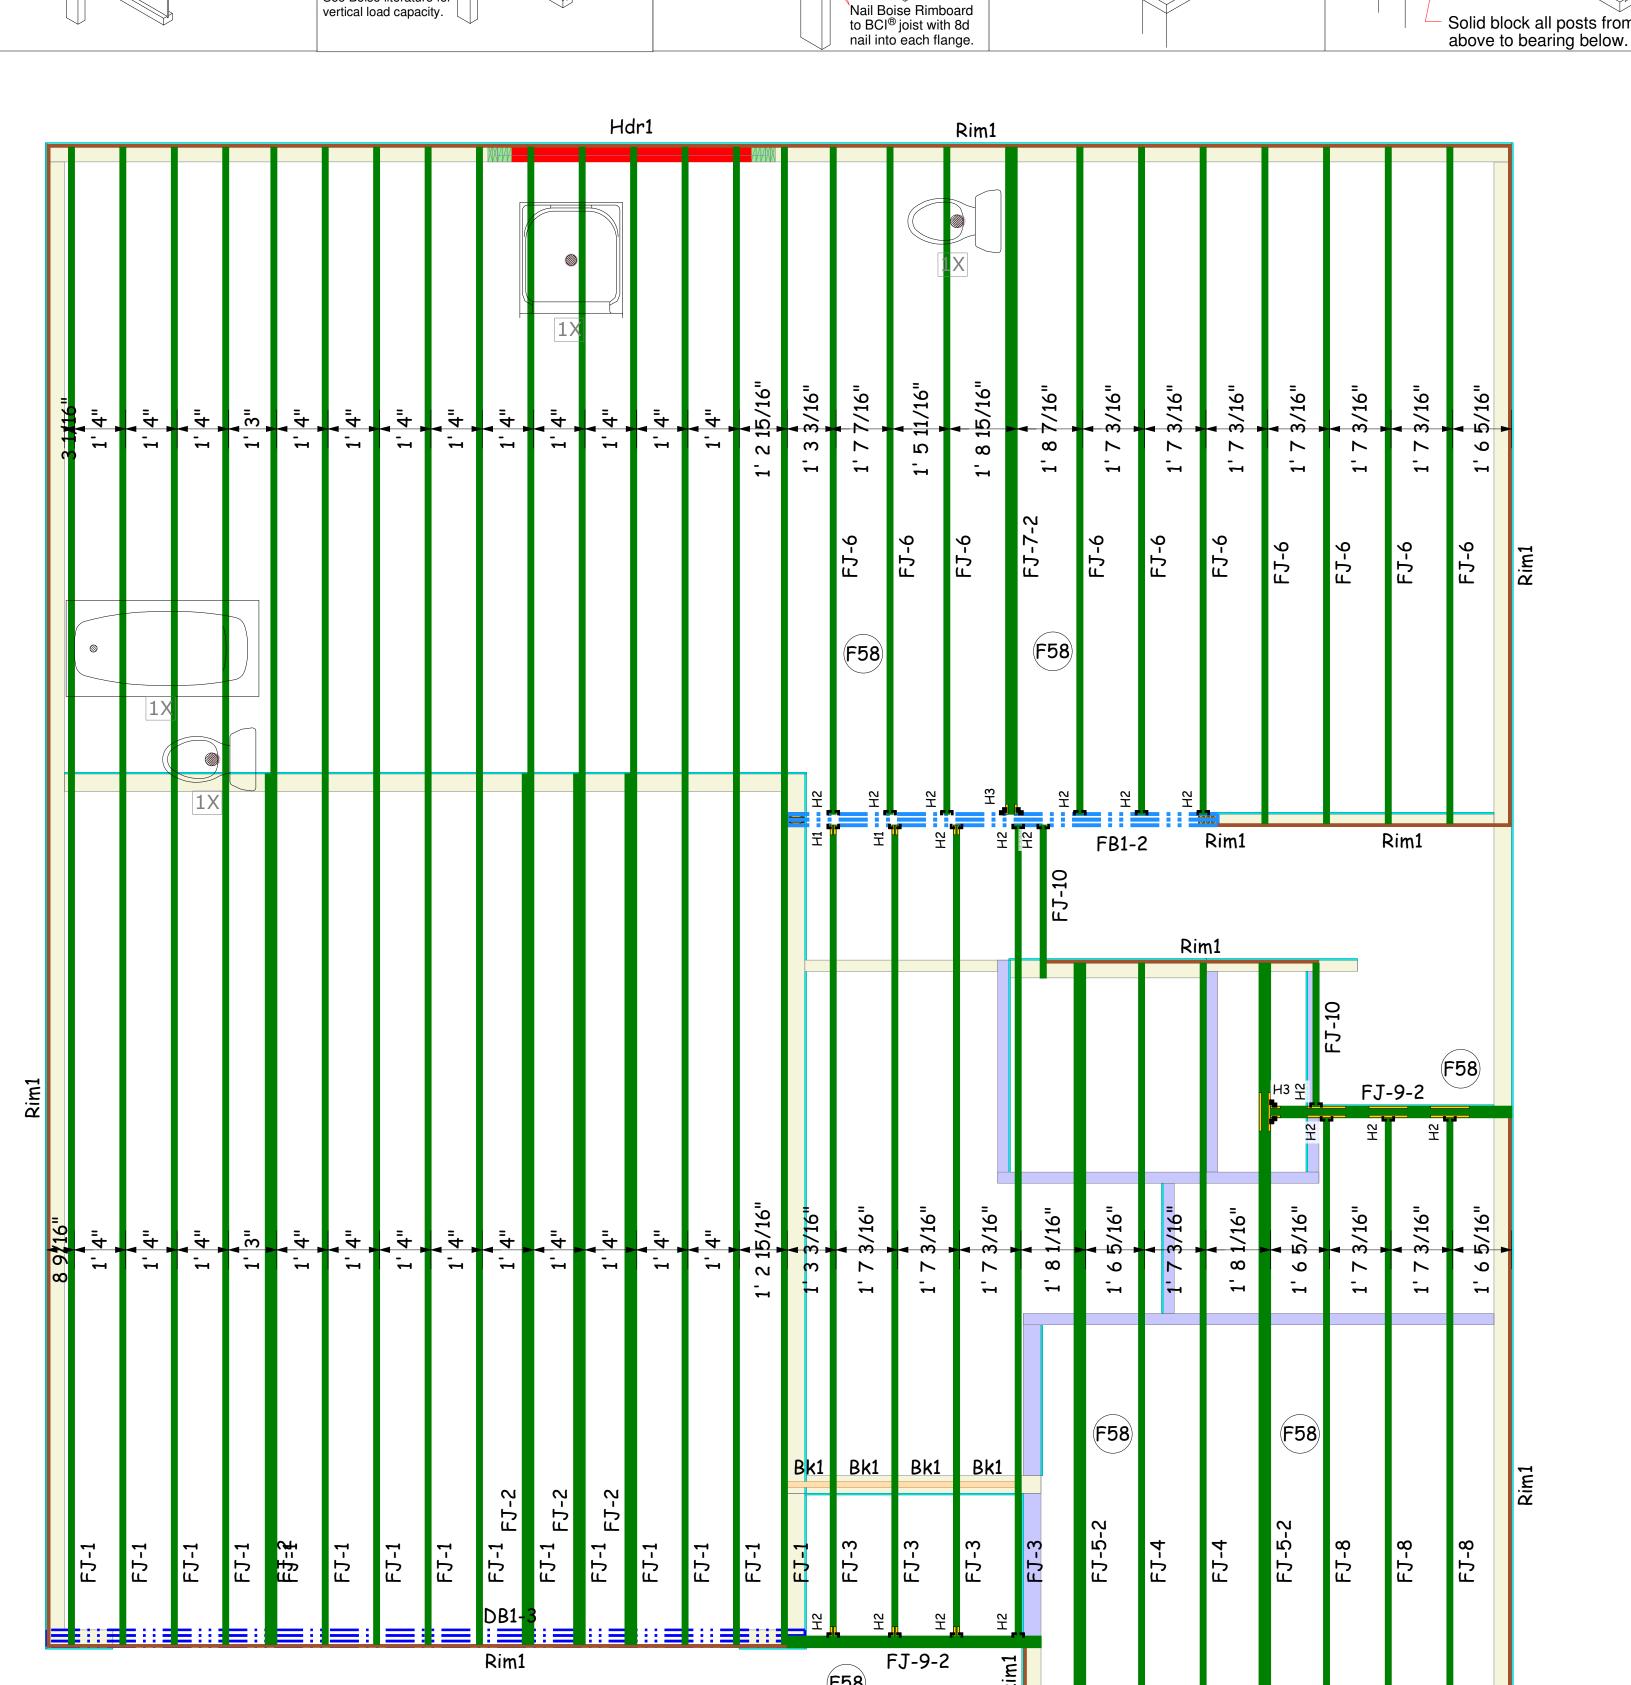

		Products			
PlotID	Length	Product	Plies	Net Qty	Fab Type
FJ-1	40' 0"	16" BCI® 4500s-1.8	1	15	MFD
FJ-2	24' 0"	16" BCI® 4500s-1.8	1	4	MFD
FJ-3	22' 0"	16" BCI® 4500s-1.8	1	4	MFD
FJ-4	20' 0"	16" BCI® 4500s-1.8	1	2	MFD
FJ-5-2	20' 0"	16" BCI® 4500s-1.8	2	4	MFD
FJ-6	18' 0"	16" BCI® 4500s-1.8	1	10	MFD
FJ-7-2	18' 0"	16" BCI® 4500s-1.8	2	2	MFD
FJ-8	16' 0"	16" BCI® 4500s-1.8	1	3	MFD
FJ-9-2	8' 0"	16" BCI® 4500s-1.8	2	4	FF
FJ-10	4' 0"	16" BCI® 4500s-1.8	1	2	FF
DB1-3	20' 0"	1-3/4" x 16" VERSA-LAM® 2.0 3100 SP	3	3	FF
FB1-2	12' 0"	1-3/4" x 16" VERSA-LAM® 2.0 3100 SP	2	2	FF
Rim1	12' 0"	1" × 16" BC RIM BOARD OSB	1	14	FF
Bk1	6' 0"	14" BCI® 4500s-1.8	1	1	FF

		Hangers	
PlotID	Qty	Manuf	Product
H1	2	Simpson	HU14
H2	17	Simpson	IUS1.81/16
H3	2	Simpson	IUS3.56/16

		Wall Framing			
PlotID	Length	Product	Plies	Net Qty	Fab Type
Hdr1	8' 0"	3-1/2" x 9-1/4" VERSA-LAM® 1.7 2650 SP	1	2	MFD

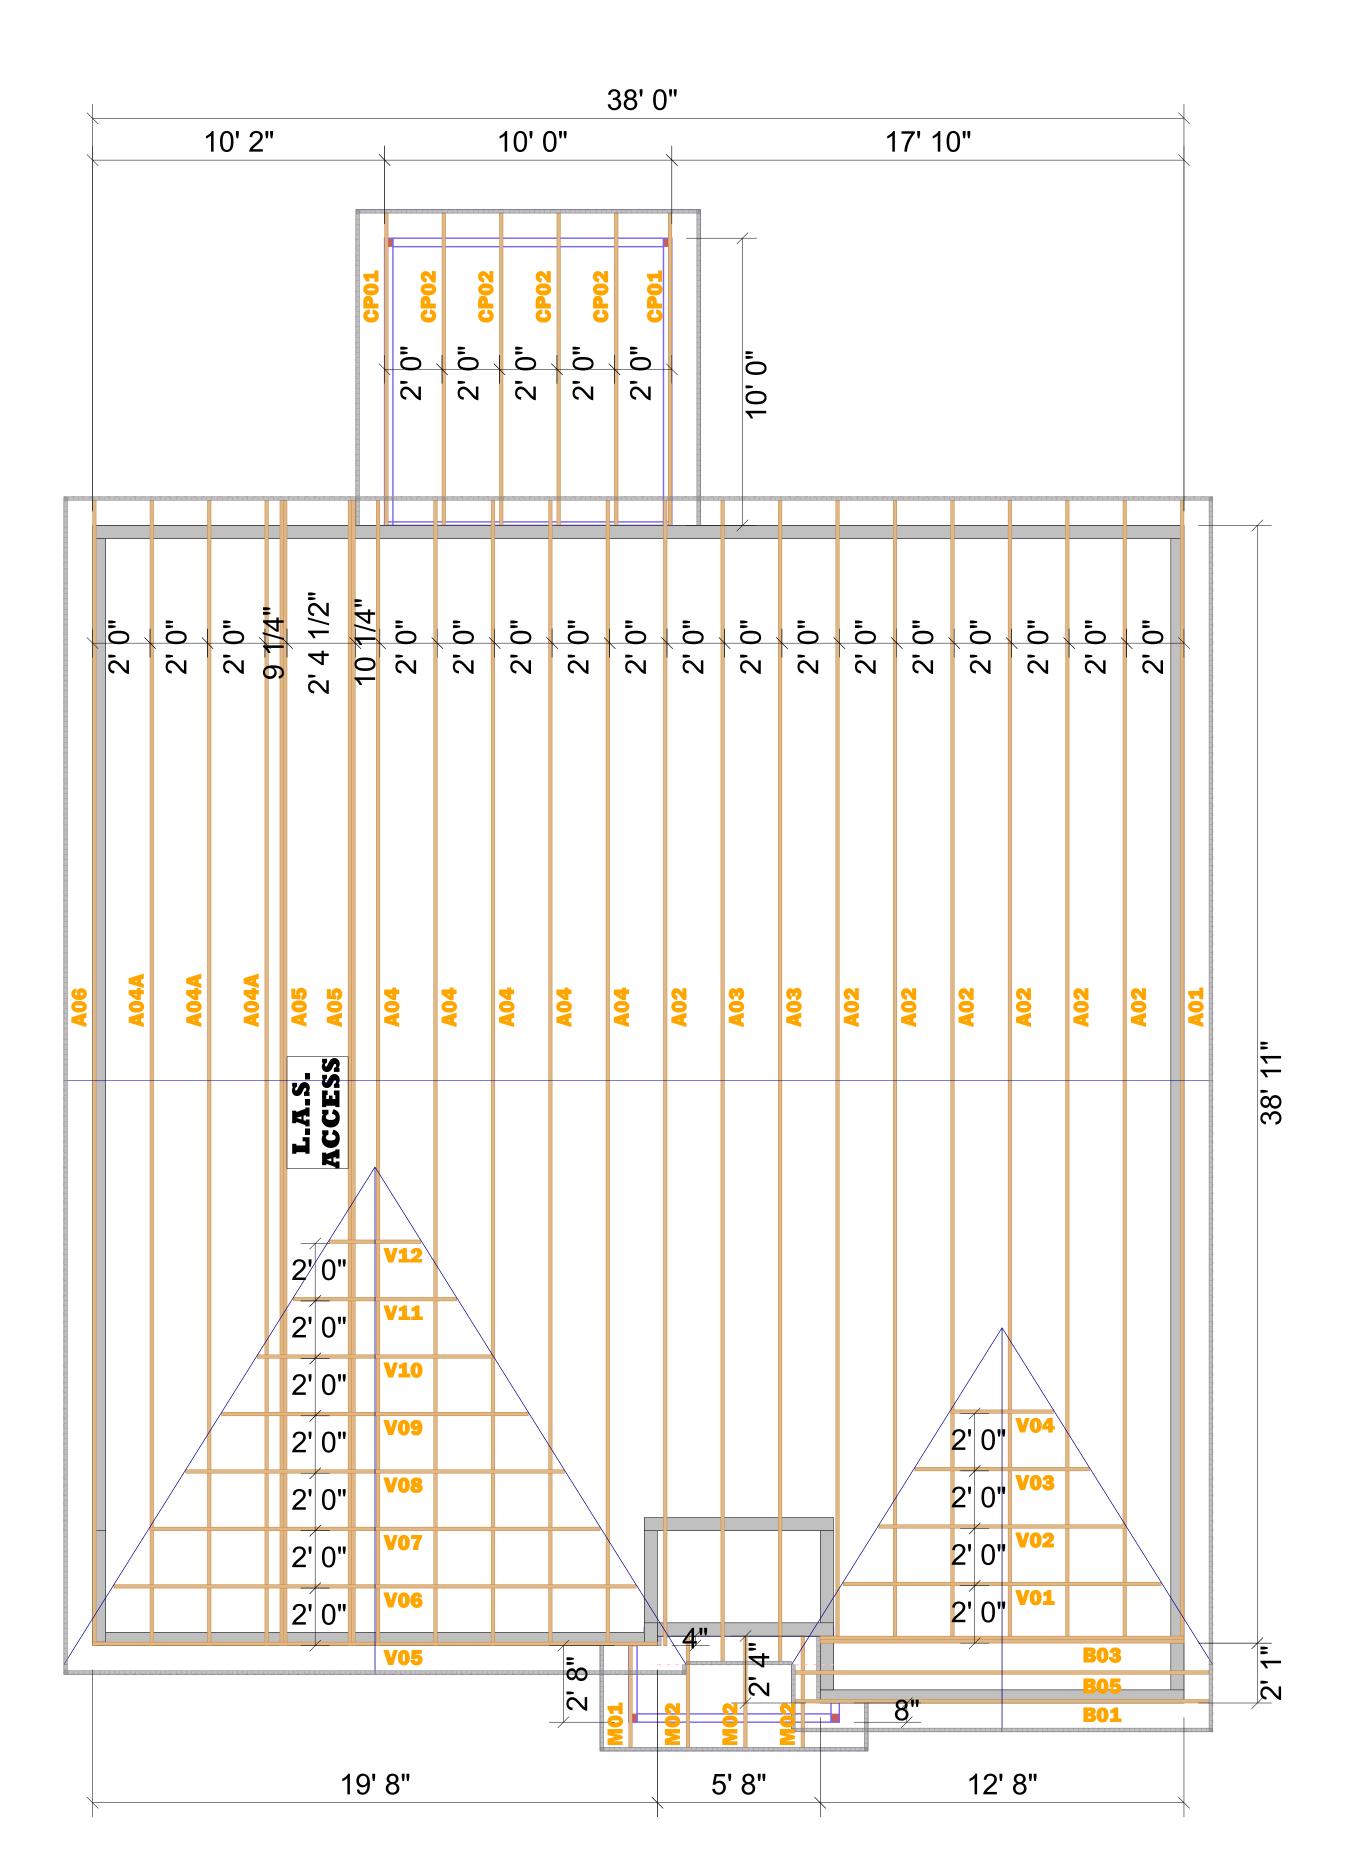

SIMPSON CONNECTOR SCHEDULE									
HANGER TYPE	Qty	FASTE CARRYING MEMBER			CARRIED MEMBER				
HTU-26	6	20-16d	20-10d x 1½	B03	A02				

THE SUGGESTED TRUSS HANGERS, CONNECTIONS AND TIE-DOWNS FOR GRAVITY, UPLIFT AND LATERAL LOADS, MUST BE REVIEWED BY THE BUILDING DESIGNER OR ENGINEER OF RECORD. PER ANSI/TPI 1-2002, ALL "TRUSS TO WALL" AND "TRUSS TO BEAM" CONNECTIONS ARE THE RESPONSIBILITY OF THE BUILDING DESIGNER. ALL "TRUSS TO TRUSS" CONNECTIONS ARE THE RESPONSIBILTY OF THE TRUSS DESIGNER/ MANUFACTURER

$\bigcirc$	H2.5A	-
$\Rightarrow$	H10A	-
$\triangle$	HTS20	-
$\bigcirc$	H14	-
	TBE4	-
	LGT2	-
	LGT3	-

# **ROOF TRUSS**

# NOTES:

DO NOT CUT, DRILL, NOTCH, OR OTHERWISE DAMAGE TRUSSES. Contact your BFS Representative for assistance PRIOR TO modifying any truss. **Espanol** - (NO CORTE, PERFORE, HAGA MUESCAS O DANE DE CUALQUIER OTRA MANERA LAS TRUSSES (CERCHAS DE MADERA). Contacte a su representante de BFS para asistencia ANTES de realizar cualquier modification.)

- 1. This Truss Placement Diagram is intended to serve as a guide for truss installation. This Diagram has been prepared by a Truss Technician and is not an engineered drawing. 2. The responsibilities of the Owner, Building Designer, Contractor, Truss Designer, and Truss Manufacturer shall be as defined by the
- TPI 1 National Standard. 3. The wood components shown on this diagram are to be used in dry service (moisture content<19%) and non-toxic environmental applications. The metal plates and hangers are galvanized to the G60 Standard unless noted otherwise.
- 4. Refer to the Truss Design Drawings for specific information about each individual truss
- 5. The Truss Technician shall provide Truss-to-Truss Connection Requirements. Any special or other connection shall be the responsibility of the Building Designer.
- 6. The Truss Placement Diagram and Truss Design Drawings are the property of Builders FirstSource and may not be reused or reproduced in part or in total under any circumstances without prior written authorization.
- 7. In some cases, field framing may be required to achieve the final appearance shown on the Construction Documents.
- 8. Field framing, including valley rafters, installed over roof trusses shall have a knee brace from the rafter to the truss top chord at intervals of 48" on center (O.C.) or less. Stagger knee braces from adjacent rafters such that the load is distributed uniformly over multiple truss locations and not concentrated at one location or along one truss.
- 9. Truss Top Chords shall be fully sheathed or have lateral bracing (purlins) spaced at 24" O.C. or less. Truss Bottom Chord Bracing shall not exceed the maximum shown on the Truss Design Drawing. Field framed bottom chord floor or ceiling attachments shall be spaced at 24" O.C. or less. Proper Bracing prevents buckling of individual truss members due to design loads.
- 10. This Placement Diagram is based upon the supporting structure being structurally adequate, dimensionally correct, square, plumb, and level to adequately support the trusses. The foundation design, structural member sizing, load transfer, bearing conditions, and the structure's compliance with the applicable building code are the responsibility of the Owner, Building Designer,
- and Contractor. 11. If Piggyback Trusses are included in this project, refer to the Mitek Piggyback Connection Detail applicable for the project details and wind load category. 12. The Contractor shall follow the SBCA TTB Partition Separation Prevention and Solutions for truss attachment to non-load bearing walls and carefully complete these details to avoid

# gypsum wall board related issues.

TRUSSES MUST BE BRACED DURING INSTALLATION. FAILURE TO DO SO MAY RESULT IN INJURY OR DEATH. Espanol -(TRUSSES (CERCHAS) DEBERAN TENER UN SOPORTE DURANTE LA INSTALACION. NO HACERLO PODRIA RESULTAR EN LESIONES O MUERTE.) 1. Trusses shall be installed in a safe manner

- meeting all code, local, OSHA, TPI, and BCSI Specifications. Failure to follow these specifications may result in injury or death. 2. Buildings under construction are vulnerable
- to high winds and present a possible safety hazard. The Contractor is responsible for recognizing adverse weather conditions and shall take appropriate action to prevent injury
- 3. BCSI INSTRUCTIONS SHALL BE FOLLOWED:

BCSI-B1 = Safe Truss Handling and Installation BCSI-B2 = Installation and Temporary

Restraint BCSI-B3 = Permanent Restraint BCSI-B4 = Safe Construction Loading BCSI-B5 = Truss Damage and Modification

Guidelines BCSI-B7 = Floor Truss Installation BCSI-B8 = Toe-Nailed Connections BCSI-B9 = Multi-Ply Girders BCSI-B10 = Post Frame Truss Installation BCSI-B11 = Fall Protection 4. Follow TPI Requirements for Long Span

Trusses (>60').

SHEET NUMBER OF

# **ROOF TRUSS LAYOUT**

SCALE: N.T.S.

# **REVISIONS**

+C0P enville "B" BASE+COF t 54 - Kenlan Farms Lillington, NC A&G Residential Greenville Lot 54 - P Lot

Truss Plant
Box 1546
, S.C. 29151
03-778-1921
3-773-4731 51 92 31 Box 1 , S.C. 303-7 umter, Sone: 803-Sumter P.O. E 0 0 S Ph





DRAWN BY


MGM

DATE

10/26/2020

JOB NUMBER

2519559

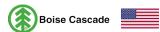

## Triple 1-3/4" x 16" VERSA-LAM® 2.0 3100 SP

#### 2nd Floor\Dropped Beams\DB1-3(i3172) (Dropped Beam)



**BC CALC® Member Report** 

Dry | 1 span | No cant.

January 6, 2021 15:52:09

**Build 7493** 


Job name: File name:

Description: 2nd Floor\Dropped Beams\DB1-3(i3172) Address:

City, State, Zip: Customer:

Specifier: Designer: Greenville KLF054.mmdl

ESR-1040 Company: Code reports:

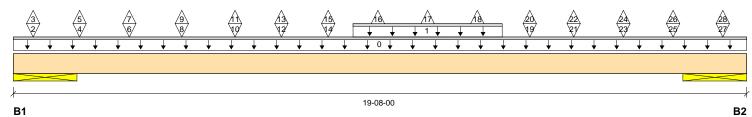

#### **Total Horizontal Product Length = 19-08-00**

Reaction Summary (Down / Uplift) (lbs)

Bearing	Live	` Dead	Snow	Wind	Roof Live	
B1, 20-1/2"	4003 / 247	5932 / 0	3785 / 0			
B2 20-1/2"	3809 / 237	6182 / 0	3937 / 0			

Loa	ad Summary						Live	Dead	Snow	Wind	Roof Live	Tributary
Tag	Description	Load Type	Ref.	Start	End	Loc.	100%	90%	115%	160%	125%	
0	Self-Weight	Unf. Lin. (lb/ft)	L	00-00-00	19-08-00	Top		24				00-00-00
1	Smoothed Load	Unf. Lin. (lb/ft)	L	09-01-05	13-01-05	Top	393	623	427			n∖a
2	FJ-1(i3168)	Conc. Pt. (lbs)	L	00-06-06	00-06-06	Top	493	494	297			n∖a
3	FJ-1(i3168)	Conc. Pt. (lbs)	L	00-06-06	00-06-06	Top	-32					n∖a
4	FJ-1(i3144)	Conc. Pt. (lbs)	L	01-09-05	01-09-05	Top	507	807	551			n∖a
5	FJ-1(i3144)	Conc. Pt. (lbs)	L	01-09-05	01-09-05	Top	-32					n∖a
6	FJ-1(i3122)	Conc. Pt. (lbs)	L	03-01-05	03-01-05	Top	524	835	570			n∖a
7	FJ-1(i3122)	Conc. Pt. (lbs)	L	03-01-05	03-01-05	Top	-33					n∖a
8	-	Conc. Pt. (lbs)	L	04-06-04	04-06-04	Top	625	901	600			n∖a
9	-	Conc. Pt. (lbs)	L	04-06-04	04-06-04	Top	-37					n∖a
10	-	Conc. Pt. (lbs)	L	05-11-06	05-11-06	Top	568	449	284			n∖a
11	-	Conc. Pt. (lbs)	L	05-11-06	05-11-06	Top	-33					n∖a
12	-	Conc. Pt. (lbs)	L	07-02-04	07-02-04	Top	535	839	569			n∖a
13	-	Conc. Pt. (lbs)	L	07-02-04	07-02-04	Top	-30					n∖a
14	FJ-1(i3176)	Conc. Pt. (lbs)	L	08-05-05	08-05-05	Top	495	781	538			n∖a
15	FJ-1(i3176)	Conc. Pt. (lbs)	L	08-05-05	08-05-05	Top	-33					n∖a
16	FJ-1(i3135)	Conc. Pt. (lbs)	L	09-09-05	09-09-05	Top	-33					n∖a
17	FJ-1(i3139)	Conc. Pt. (lbs)	L	11-01-05	11-01-05	Top	-33					n∖a
18	FJ-1(i3126)	Conc. Pt. (lbs)	L	12-05-05	12-05-05	Top	-33					n∖a
19	-	Conc. Pt. (lbs)	L	13-10-03	13-10-03	Top	573	927	581			n∖a
20	-	Conc. Pt. (lbs)	L	13-10-03	13-10-03	Top	-32					n∖a
21	FJ-1(i3124)	Conc. Pt. (lbs)	L	15-00-05	15-00-05	Top	479	768	521			n∖a
22	FJ-1(i3124)	Conc. Pt. (lbs)	L	15-00-05	15-00-05	Top	-32					n∖a
23	FJ-1(i3123)	Conc. Pt. (lbs)	L	16-04-05	16-04-05	Top	524	839	570			n∖a
24	FJ-1(i3123)	Conc. Pt. (lbs)	L	16-04-05	16-04-05	Top	-33					n∖a
25	FJ-1(i3177)	Conc. Pt. (lbs)	L	17-08-05	17-08-05	Top	524	839	570			n∖a
26	FJ-1(i3177)	Conc. Pt. (lbs)	L	17-08-05	17-08-05	Top	-33					n∖a
27	FJ-1(i3153)	Conc. Pt. (lbs)	L	19-00-05	19-00-05	Top	387	553	356			n∖a
28	FJ-1(i3153)	Conc. Pt. (lbs)	L	19-00-05	19-00-05	Top	-25					n∖a

<b>Controls Summary</b>	Value	% Allowable	Duration	Case	Location
Pos. Moment	41438 ft-lbs	65.6%	115%	8	09-09-05
End Shear	9072 lbs	49.4%	115%	8	16-07-08
Total Load Deflection	L/355 (0.554")	67.6%	n\a	8	09-09-06
Live Load Deflection	L/723 (0.272")	49.8%	n∖a	25	09-09-06
Max Defl.	0.554"	36.9%	n∖a	8	09-09-06



## Triple 1-3/4" x 16" VERSA-LAM® 2.0 3100 SP

#### 2nd Floor\Dropped Beams\DB1-3(i3172) (Dropped Beam)



BC CALC® Member Report

Dry | 1 span | No cant.

January 6, 2021 15:52:09

Build 7493

Job name: File name: Greenville KLF054.mmdl

Address: Description: 2nd Floor\Dropped Beams\DB1-3(i3172)

City, State, Zip: Customer:

Specifier: Designer: Company:

Code reports: ESR-1040

<b>Controls Summary</b>	Value	% Allowable	Duration	Case	Location
Span / Depth	12.3	,			
Conc. Load (B1)	1087 lbs	7.9%	100%		
Conc. Load (B2)	1110 lbs	8.1%	100%		

_				% Allow	% Allow	
Bear	ing Supports	Dim. (LxW)	Value	Support	Member	Material
B1	Wall/Plate	20-1/2" x 5-1/4"	11772 lbs	15.1%	14.6%	Unspecified
B2	Wall/Plate	20-1/2" x 5-1/4"	11991 lbs	15.3%	14.8%	Unspecified

#### **Notes**

Design meets Code minimum (L/240) Total load deflection criteria.

Design meets Code minimum (L/360) Live load deflection criteria.

Design meets arbitrary (1.5") Maximum Total load deflection criteria.

Design meets arbitrary (1") Maximum live load deflection criteria.


Calculations assume unbraced length of Top: 01-02-08, Bottom: 01-02-08.

BC CALC® analysis is based on IBC 2015.

Unbalanced snow loads determined from building geometry were used in selected product's verification.

Design based on Dry Service Condition.

#### Connection Diagram: Full Length of Member

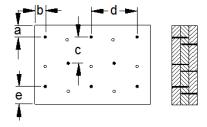

Nailing applies to both sides of the member Connectors are: 3-1/4 in. Pneumatic Gun Nails

#### **Disclosure**

Use of the Boise Cascade Software is subject to the terms of the End User License Agreement (EULA). Completeness and accuracy of input must be reviewed and verified by a qualified engineer or other appropriate expert to assure its adequacy, prior to anyone relying on such output as evidence of suitability for a particular application. The output here is based on building code-accepted design properties and analysis methods. Installation of Boise Cascade engineered wood products must be in accordance with current Installation Guide and applicable building codes. To obtain Installation Guide or ask questions, please call (800)232-0788 before installation.

BC CALC®, BC FRAMER®, AJS<sup>TM</sup>,
ALLJOIST®, BC RIM BOARD<sup>TM</sup>, BCI®,
BOISE GLULAM<sup>TM</sup>, BC FloorValue®,
VERSA-LAM®, VERSA-RIM PLUS®,

## North Carolina 2018 - R402.1.5 Total UA

Property , NC 27546 Model: Greenville Organization
Southern Energy Manager
Justin Smith

Inspection Status
Results are projected



Template - A & G - Greenville plan slab CZ 4 - ecoSelect Greenville plan slab Builder A & G

This report is based on a proposed design and does not confirm field enforcement of design elements.

#### **Building UA**

Elements	NC Reference	As Designed
Ceilings	45.2	40.5
Above-Grade Walls	181.0	140.7
Windows, Doors and Skylights	120.4	114.7
Slab Floor:	74.7	96.7
Framed Floors	21.1	20.6
Foundation Walls	0.0	0.0
Rim Joists	8.8	7.1
Overall UA (Design must be equal or lower):	451.2	420.3

#### Requirements

402.1.5	Total UA alternative compliance passes by 6.8%.	
402.3.2 Glazed Fenestration SHGC	Average SHGC: 0.27 Max SHGC: 0.30	
R402.4.2.2	Air Leakage Testing	Air sealing is 4.80 ACH at 50 Pa. It must not exceed 5.00 ACH at 50 Pa.
R402.5	Area-weighted average fenestration SHGC	
R402.5	Area-weighted average fenestration U-Factor	
R404.1	Lighting Equipment Efficiency	
Mandatory Checklist	Mandatory code requirements that are not checked by Ekotrope must be met.	
R403.3	Duct Insulation	
403.3.3	Duct Testing	

## Design exceeds requirements for North Carolina 2018 Prescriptive compliance by 6.8%.

Name:	Justin Smith	Signature:	Justin Smith
Organization:	Southern Energy Management	Digitally signed:	6/1/20 at 11:08 AM

Property , NC 27546 Model: Greenville

Template - A & G - Greenville plan slab CZ 4 -

ecoSelect Greenville plan slab Organization

Southern Energy Management Justin Smith

Builder A & G

Inspection Status Results are projected



General Building Informat	tion
Number Of Bedrooms	4
Number Of Floors	2
Conditioned Floor Area [sq. ft.]	2,565
Has Electric Vehicle Ready Space	No
Unconditioned, attached garage?	Yes
Conditioned Volume [cu. ft.]	22,636
Total Units in Building	1
Residence Type	Single family detached
Floor Number	- 1
Model	Greenville
Community	
Climate Zone	4A

г.		-1 - 43		1A/-	ш
-c	บบ	dati	on	vva	ш

None Present

# Foundation Wall Library List

	Slab								
ľ	Name	Library Type	Perimeter	Floor Grade	Carpet R	Exposed Masonry Area	Surface Area	Location	Enclosing
	slab	Uninsulated	158	On Grade	1	0	1,058.0 ft²	Exposed Exterior	Conditioned Space

Slab Library I	List						
Name	Wall Construction Type	Slab Completely Insulated?	Underslab Insulation Width [ft]		Perimeter Insulation R Value		Effective R-value
Uninsulated	Wood Frame / Other	No	0	0	0	No	0.00

Property , NC 27546 Model: Greenville

Template - A & G - Greenville plan slab CZ 4 -

**Organization** Southern Energy Management Justin Smith

Builder

A & G

Inspection Status Results are projected



Template - A & G - Greenville plan slab CZ 4 - ecoSelect
Greenville plan slab

Framed Floo	r				
Name	Library Type	Carpet R	Floor Grade	Surface Area	Location
over ambient	R-19, 16"OC G1 Carpet	0	Above Grade	20.0 ft²	Exposed Exterior
over garage	R-19, 16"OC G1 Carpet	0	Above Grade	429.0 ft²	Unconditioned, attached garage

# Framed Floor Library List

Name Effective R-value

R-19, 16"OC G1 Carpet

21.798

Rim Joist			
Name	Library Type	Surface Area	Location
1st floor ambient	R 19 G1, 16"OC	121.0 ft²	Exposed Exterior
1st floor garage	R 19 G1, 16"OC	37.0 ft²	Unconditioned, attached garage

# Rim Joist Library List

Name Effective Insulation R-value

R 19 G1, 16"OC

17.30

Wall				
Name	Library Type	Surface Color	Surface Area	Location
1st floor ambient	R 19 Adv. Framing G2 16" O.C	Medium	1,087.0 ft²	Exposed Exterior
1st floor garage	R 19 Adv. Framing G2 16" O.C	Medium	335.0 ft²	Unconditioned, attached garage
2nd floor ambient	R 19 Adv. Framing G2 16" O.C	Medium	1,272.0 ft²	Exposed Exterior

Property , NC 27546 Model: Greenville

Template - A & G - Greenville plan slab CZ 4 -

Organization Southern Energy Management Justin Smith

Builder A & G

Inspection Status Results are projected



Greenville plan slab

Wall Library List	
Name	Effective R-value
R 19 Adv. Framing G2 16" O.C	16.703

Glazing								
Name	Library Type	Wall Assignment	Foundation Wall Assignment	Overhang Depth	Overhang Ft To Top	Overhang Ft To Bottom	Orientation	Surface Area
front 2nd unshaded	35/27	2nd floor ambient		0	0	0	West	68.9 ft²
front unshaded	35/27	1st floor ambient		0	0	0	West	27.5 ft²
left 2nd unshaded	35/27	2nd floor ambient		0	0	0	North	41.3 ft²
left unshaded	35/27	1st floor ambient		0	0	0	North	8.0 ft²
rear 2nd unshaded	35/27	2nd floor ambient		0	0	0	East	45.3 ft²
rear unshaded	35/27	1st floor ambient		0	0	0	East	81.5 ft²
right 2nd unshaded	35/27	2nd floor ambient		0	0	0	South	33.5 ft²

Glazing Libra	ry List	
Name	Shgc	U-factor
35/27	0.27	0.350

Skylight			
	None Present		

# **Skylight Library List**

Property , NC 27546 Model: Greenville

Template - A & G - Greenville plan slab CZ 4 ecoSelect

Organization Southern Energy Management Justin Smith

Results are projected

Inspection Status



Builder A & G Greenville plan slab

<b>Opaque Door</b>								
Name	Library Type	Wall Assignment	Foundation Wall Assignment		Solar Absorptance		Surface Area	Location
front door	Fiberglass R-5	1st floor ambient		0.9	0.75	Medium	20.0 ft²	Exposed Exterior
garage door	Fiberglass R-5	1st floor garage		0.9	0.75	Medium	18.0 ft²	Exposed Exterior

Opaque Door L	brary List
	lame Effective U-fact
Fiberglas	R-5 0.20

	Roof Insulation	on					
ĺ	Name	Library Type	Attic Exterior Area [s.f.]	Clay or Concrete Roof Tiles	Surface Color	Surface Area	Location
	Attic	R-38 Attic BLOWN FG G1 2x10 24"OC w/	2,215.29	No	Dark	1,507.0 ft²	Attic

Roof Insulation L	ibrary List	
Name	Has Radiant Barrier	Effective R-value
R-38 Attic BLOWN FG G1 2x10 24"OC w/	Yes	37.246

Whole House	Infiltration	
Infiltration	Measurement Type	Shelter Class
1810 CFM at 50 Pa	Blower-door tested	4

## **Mechanical Ventilation**

Property , NC 27546 Model: Greenville

Template - A & G - Greenville plan slab CZ 4 -

Template - A & G - Greenville plan slab CZ 4 - ecoSelect Greenville plan slab **Organization** Southern Energy Management Justin Smith

Builder A & G





Lighting					
% Interior Fluorescent Lighting	% Interior LED Lighting	% Exterior Fluorescent Lighting	% Exterior LED Lighting	% Garage Fluorescent Lighting	% Garage LED Lighting
0	75	0	0	0	0

	- 4		$\overline{}$				4.		
On	I C I I	Δ.	$\sim$		ne	ro	ш	0	n
$\mathbf{c}$	ы		u	•	ııc		ш	v	

None Present

## **Onsite Generation Library List**

None Present

#### **Solar Generation**

None Present

## **Solar Generation Library List**

Conditioning Equipment						
Library Type	Heating Percent Load	Cooling Percent Load	Hot Water Percent Load	Location		
Z 50 gal. 0.91EF elec	0%	0%	100%	Unspecified		
z 36k 14 seer 8.2hspf	100%	100%	0%	Unspecified		
	Library Type Z 50 gal. 0.91EF elec	Library Type Heating Percent Load Z 50 gal. 0.91EF elec 0%	Library Type Heating Percent Load Cooling Percent Load  Z 50 gal. 0.91EF elec 0% 0%	Library Type Heating Percent Load Cooling Percent Load Hot Water Percent Load  Z 50 gal. 0.91EF elec 0% 0% 100%		

Property , NC 27546 Model: Greenville

**Organization**Southern Energy Management
Justin Smith

Inspection Status Results are projected



Template - A & G - Greenville plan slab CZ 4 - ecoSelect

Greenville plan slab

Builder A & G

Equipment Type: Z 50 gal. 0.91EF elec				
Fuel Type	Electric			
Distribution Type	Hydronic Delivery (Radiant)			
Hot Water Efficiency	0.91 Energy Factor			
Tank Capacity (gal.)	50			
Hot Water Capacity [kBtu/h]	40			
Recovery Efficiency	0.98			

Equipment Type: z 36k 14 seer 8.2hspf				
Fuel Type	Electric			
Distribution Type	Forced Air			
Motor Type	PSC (Single Speed)			
Heating Efficiency	8.2 HSPF			
Heating Capacity [kBtu/h]	36			
Use default Supplemental Heat	Yes			
Cooling Efficiency	14 SEER			
Cooling Capacity [kBtu/h]	36			

Property , NC 27546 Model: Greenville

Template - A & G - Greenville plan slab CZ 4 - ecoSelect

Greenville plan slab

Organization Southern Energy Management Justin Smith

Builder A & G

Inspection Status Results are projected



Distribution System	
	E 14:
Distribution Type	Forced Air
Heating Equipment	whole house heat pump
Cooling Equipment	whole house heat pump
Sq. Feet Served	2565
# Return Grilles	3
Supply Duct R Value	8
Return Duct R Value	8
Supply Duct Area [ft²]	692.55
Return Duct Area [ft²]	384.75
Leakage to Outdoors	102 CFM @ 25Pa (3.98 / 100 s.f.)
Total Leakage	102 CFM25
Total Leakage Duct Test Conditions	Post-Construction
Use Default Flow Rate	Yes
Duct 1	
Duct Location	Attic (well vented, radiant barrier)
Percent Supply Area	100
Percent Return Area	100
Duct 2	
Duct Location	Conditioned Space
Percent Supply Area	0
Percent Return Area	0
Duct 3	
Duct Location	Conditioned Space
Percent Supply Area	0
Percent Return Area	0
Duct 4	
Duct Location	Conditioned Space
Percent Supply Area	0
Percent Return Area	0
Duct 5	
Duct Location	Conditioned Space
Percent Supply Area	0
Percent Return Area	0
Duct 6	
Duct Location	Conditioned Space
Percent Supply Area	0
Percent Return Area	0

Ceiling Fan		
Has Ceiling Fan	Yes	
Cfm Per Watt	100	

Standard
No
72
No
No
10
No

Property , NC 27546 Model: Greenville

Template - A & G - Greenville plan slab CZ 4 -

ecoSelect Greenville plan slab Organization

Southern Energy Management Justin Smith

Builder A & G





Clothes Dryer	
Fuel Type	Electric
Cef	2.617
Field Utilization	Timer Controls
Is Outside Conditioned Space	No

Clothes Washer		
Label Energy Rating	151 kWh/Year	
Electric Rate	\$0.11/kWh	
Annual Gas Cost	\$12.00	
Gas Rate	\$1.22/Therm	
Capacity	3.31	
Imef	2.15474	
Is Outside Conditioned Space	No	

Appliances and Controls	
Programmable thermostat?	Yes
Dishwasher Size	Standard
Dishwasher Efficiency	0.65 EF
Dishwasher Outside Conditioned Space?	No
Range/Oven Fuel	Electric
Convection Oven?	No
Induction Range?	No
Range/Oven Outside Conditioned Space?	No
Refrigerator Consumption	538 kWh/Year
Refrigerator Outside Conditioned Space?	No

#### **Notes**

-updated JS 06/01/20

- -uninsulated slab modeled
- -wall insulation modeled to Grade 2
- -confirm attic insulation and hvac specs
- -ventilation modeled as none
- -confirm cfl lighting %
- -modeled to worst case orientation