### GENERAL NOTES:

1. ALL WORK SHALL BE PERFORMED IN ACCORDANCE WITH ALL APPLICABLE NATIONAL, STATE, AND LOCAL CODES, REGULATIONS,

AT SITE BEFORE BEGINNING CONSTRUCTION. ANY DESCREPANCES SHALL BE REPORTED TO ARCHIVAL DESIGNS, INC. FOR JUSTIFICATION AND/OR CORRECTION BEFORE PROCEEDING WITH WORK. CONTRACTORS SHALL ASSUME RESPONSIBILITY FOR ERRORS THAT ARE NOT REPORTED. 3. ALL DIMENSIONS SHALL BE READ OR CALCULATED AND NEVER

4. ALL FOOTINGS TO BE BELOW FROST LINE (SEE LOCAL CODE) AND MUST REST ON UNDISTIRBED SOIL CAPABLE OF HANDLING THE BUILDING. CONSULT LOCAL ENGINEER FOR PROPER FOOTING AND REINFORCING SIZES

5. CONTRACTOR SHALL INSURE COMPATIABLILTY OF THE BUILDING WITH ALL SITE REQUIREMENTS. 6. IF BACKFILL EXCEEDS 4' AGAINST ANY FOUNDATION WALL,

REINFORCE AS PER CODE 7. ALL FOUNDATION AND STRUCTURAL MEMBERS SHOULD BE VERIFIED AND STAMPED BY AN ENGINEER IN THE STATE WHERE CONSTRUCTION IS OCCURING DUE TO WIDE VARIANCE IN LOCAL CODES, SOIL BEARING CONDITIONS, FOREST LINE DEPTH, GEOLOGICAL AND WEATHER CONDITIONS, ETC. THE CONTRACTOR IS RESPONSIBLE FOR ADJUSTING AND VERIFYING ALL STRUCTURAL DETAILS AND CONDITIONS TO MEET ALL LOCAL CODES AND TO INSURE A QUALITY A SAFE STRUCTURE

8. ALL WOOD, CONCRETE, AND STEEL STRUCTURAL MEMBERS SHAL BE OF A GOOD GRADE AND QUALITY AND MEET ALL NATIONAL, STATE ANDLOCAL BUILDING CODES WHERE APPLICABLE. 9.ALL COLUMNS OR SOLID FRAMING SHOULD BE DESIGNED TO CARRY LOADS AND SHOULD EXTEND DOWN THRU THE LEVELS BELOW AND TERMINATE AT THE BASEMENT FLOOR OR AT OTHER BEARING POINTS DESIGNED TO CARRY THE LOAD. 10. THIS DESIGN LICENSE IS RELEASED FOR ONE (1) BUILT STRUCTURE ONLY AND IS NOT TRANSFERABLE TO ANOTHER INDIVIDUAL OR COMPANY

11. DONALDSON DESIGNS, INC. IS THE SOLE OWNER OF THIS AND ANY DERIVATIVE ODIFICATION OF THIS COPYRIGHT PROTECTED

IS NOT TO EXCEED 14" IN DEPTH. ENGINEER SHALL RELATE FLOOR DEPTH TO STAIR DESIGN AND MODIFY ACCORDINGLY. NOTE: FLOOR SYSTEMS DEEPER THAN 14" CAN ADVERSLY IMPACT FLOOR PLAN

13.THE DRAWINGS PREPARED BY ARCHIVAL DESIGNS, INC. ARE ARCHITECTURAL IN NATURE. STRUCTURAL DRAWINGS SHALL BE PREPARED BY A LOCAL ENGINEER PER LOCAL CODES.

### GENERAL NOTES

ALL WALLS ARE DRAWN AT 4" UNLESS OTHERWISE NOTED ON PLANS ALL ANGLED WALLS ARE 45 UNLESS OTHERWISE NOTED ON PLANS

### ||SMOKE DETECTORS: LOCATION AND NUMBER OF SMOKE DETECTORS SHALL

CONFORM TO NEC. ||EGRESS:

ALL BEDROOMS MUST AT LEAST ONE WINDOW WHICH CONFORMS TO R-310 OF THE NORTH CAROLINA RESIDENTIAL BUILDING CODE. IT IS THE GENERAL CONTRACTORS RESPOSIBILITY TO VERITY CHOSEN WINDOWS THAT MEET EGRESS AS MANUFACTURERS

### ATTIC ACCESS:

MINIMUM ATTIC ACCESS SHALL BE PROVIDED BY GENERAL CONTRACTOR AND LOCATED ON SITE.

### WALL / CEILING HGT.

WALL AND CEILING HEIGHT NOTES ARE BASED ON NOMINAL WALL SIZE. KNEE WALL HEIGHT LABELS FOR WALLS UNDER RAFTERS ASSUME AN EXTRA 2" FOR FURRING (IN HEATED SPACES) FOR INSULATION. THE WALL HEIGHT REFERS TO THE HEIGHT FROM THE FLOOR DECKING TO THE BOTTOM OF THE FURRING.

### PLAN NOTES:

1.ALL WORK SHAL LBE PERFORMED IN ACCORDANCE WITH ALL APPLICABLE NATIONAL, STATE, AND LCOAL CODES, REGULATIONS AND FHA / VA MPS.

2.CONTRACTORS SHALL VERIFY ALL CONDITIONS AND DIMENSIONS AT THE SITE BEFORE BEGINNING ANY CONSTRUCTION. ANY DESCREPANCES SHALL BE REPORTED TO DONALDSONDESIGNS, INC. FOR JUSTIFICATION AND / OR CORRECTION BEFORE PROCEEDING WITH WORK. CONTRACTORS SHALL ASSUME RESPONSIBILITY FOR ERRORS THAT ARE NOT REPORTED.

3.ALL DIMENSIONS SHALL BE READ OR CALCULATED NEVER SCALED 4.ALL FOOTINGS TO BE BELOW FRONT LINE (SEE LOCALCODE) AND MUST REST ON UNDISTRIRBED SOIL CAPABLE OF HANDLING THE BUILDING. CONSULT LOCAL ENGINEER FOR PROPER FOOTING AND REINFORCEMENT SIZES. 5.CONTRACTOR SHALL INSURE COMPATIBILITY OF THE BUILDING WITH

ALL SITE REQUIREMENTS. 6.IF BACKFILL EXCEEDS 4' AGAINST ANY FOUNDATION WALL

REINFORCE PER CODE REQUIREMENTS. 7.ALL FOUNDATION AND STRUCTURAL MEMBERES SHOULD BE VERIFIED AND STAMPED BY AN ENGINEER IN THE STATE WHERE CONSTRUCTION IS OCCURING DUE TO VARIANCE IN LOCAL CODES, SOIL BEARING CONDITIONS, FOREST LINE DEPTH, GEOLOGICAL AND WEATHER CONDITIONS, ECT. THE CONTRACTOR IS RESPONSIBLE FOR ADJUSTING AND VERIFYING ALL STRUCTURAL DETAILS AND CONDITIONS TO MEET ALL LOCAL CODES AND TO INSURE A QUALITY

8.ALL WOOD, CONCRETE, AND STEEL STRUCTURAL MEMBERS SHALL BE OF A GOOD GRADE AND QAULITY TO MEET ALL NATIONAL, STATE AND LOCAL CODES WHERE APPLICABLE.

9.ALL COLUMNS OR SOLID FRAMING SHOULD BE DEISGNED TO CARRY LOADS AND SHOULD EXTEND DOWN THROUGH ALL LEVELS BELOW AND TERMINATE AT LOAD BEARING POINTS DESIGNED TO CARRY THE

10.ARCHITECTURAL DESIGN ASSUMES ENGINEERED FLOOR SYSTEM IS NOT TO EXCEED 14" IN DEPTH ENGINEER SHALL RELATE FLOOR DEPTH TO STAIR DESIGN AND MODIFY ACCORDINGLY. (NOTE: FLOOR SYSTEMS DEEPER THAN 14" CAN ADVERSELY IMPACT FLOOR PLAN LAYOUT AND DESIGN

11.THE DRAWINGS ARE PREPARED BY DONALDSONDESIGNS, INC. ANY STRUCTURAL DRAWINGS AR TO BE PREPARED BY LOCAL

### THE SWINSON RESIDENCE

HOLLY SPRINGS, NORTH CAROLINA

All construction must comply with current NC Building Codes and is subject to field inspection and verification. APPROVED Limited building only review Permit holder responsible for full compliance with the code

12/08/2020

COUNTYNORTH CAROLINA

### CONSTRUCTION NOTES:

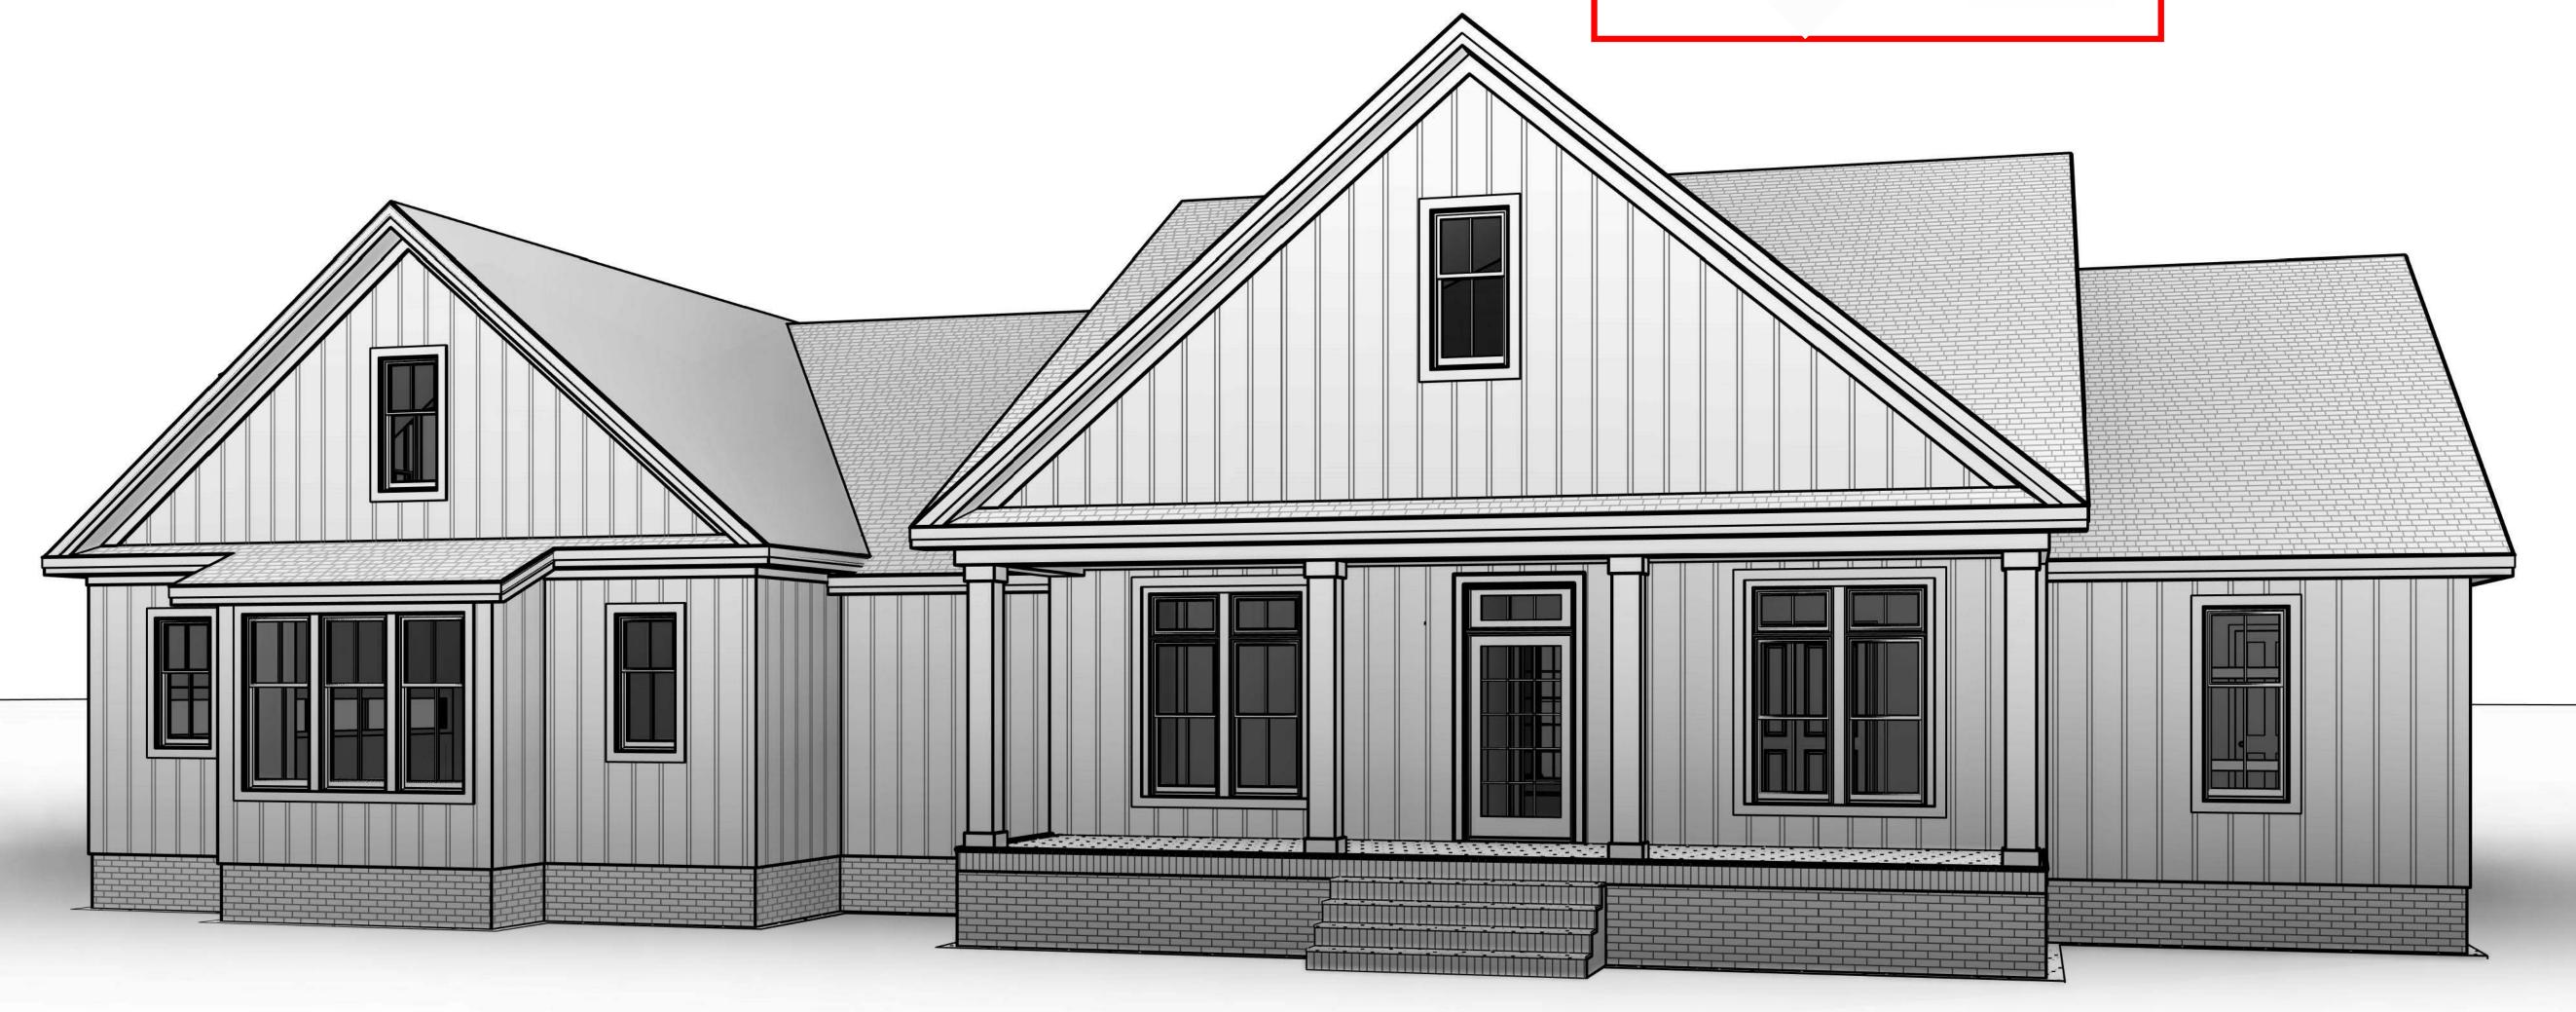
1. STEFL FLITCH BEAMS SHALL BE FASTENED TOGETHER WITH 1/2" DIAMETER BOLTS WITH WASHERS PLACED UNDER THE THREADED END OF THE BOLT. BOLTS SHALL BE SPACED AT MAXIMUM 24" o.c. STAGGERED TOP AND BOTTOM OF BEAM WITH A MINIMUM 2" EDGE DISTANCE. TWO BOLTS SHALL BE LOCATED AT 6" FROM EACH END O

2. STEEL BEAMS SHALL BE SUPPORTED AT EACH END WITH A MINIMUM BEARING LENGTH OF 3 1/2" AND FULL FLANGE WIDTH. BEAMS MUST BE ANCHORED AT EACH END WITH A MINIMUM OF FOUR 16d NAILS OR TWO 1/2" x 4" LAG SCREWS.

3. ENGINEERED WOOD BEAMS SHALL BE INSTALLED WITH ALL CONNECTIONS PER MANUFACTURER'S INSTRUCTIONS. 4. ALL BEAMS SHALL BE CONTINUOUSLY SUPPORTED LATERALLY AND SHALL BEAR FULL WIDTH ON THE SUPPORTING WALLS OR COLUMNS INDICATED WITH A MINIMUM OF THREE STUDS. 5. SOLID BLOCKING SHALL BE PROVIDED AT ALL POINT LOADS TO TRANSFER LOADS THROUGH FLOOR LEVELS. COLUMNS SHALL BE CONTINUOUS TO THE FOUNDATION OR TO OTHER STRUCTURAL

6. ENGINEERED WOOD FLOOR SYSTEMS AND ROOF TRUSS SYSTEMS SHALL BE PROVIDED FOR REVIEW AND COORDINATED WITH THE ENGINEER OF RECORD. INSTALLATION SHALL BE IN ACCORDANCE WITH THE MANUFACTURER'S INSTRUCTIONS.

7. WALL BRACING REQUIREMENTS SHALL BE IN ACCORDANCE WITH SECTION R602.10 OF THE NORTH CAROLINA RESIDENTIAL CODE. 8. BRICK LINTELS SHALL BE 3 1/2 x 3 1/2 x 1/4 STEEL ANGLE FOR UP TO 6'0" MAXIMUM SPAN AND 6 x 4 x 5/16 FOR SPANS GREATER THAN 6'0". 9. BRICK LINTELS AT SLOPED AREAS SHALL BE 4 x 3 1/2 x 1/4 STEEL ANGLE WITH 16d NAILS IN 3/16" HOLES IN 4" ANGLE LEG AT 12" o.c. TO DOUBLE RAFTER. WHEN THE SLOPE EXCEEDS 4:12 A MINIMUM OF 3 x 3 x 1/4 PLATES SHALL BE WELDED AT 24" o.c. ALONG THE STEEL



WINDOW SCHEDULE					
PLAN MARK	QUANTITY	WINDOW SIZE	WIDTH	HEIGHT	HEAD HGT.
W1	6	2/4 X 5/8 SINGLE	2' - 4"	5' - 8"	7' - 6"
W2	2	2/6 X 6/0 SINGLE	2' - 6"	6' - 0"	7' - 6"
W5	3	7/6 X 6/0 TRIPLE	8' - 8"	6' - 0"	7' - 6"
W6	1	4/0 X 4/0 GLASS BLOCK	4' - 0"	4' - 0"	7' - 6"
W8	1	7/6 X 5/8 TRIPLE	8' - 2"	5' - 8"	7' - 6"
W9	4	2/4 X 4/8 SINGLE	2' - 4"	4' - 8"	
W14	2	5/4 X 6/10 TWIN W/ TRANSOM	5' - 4"	6' - 10"	8' - 2"
W18	3	4/0 X 1/0	4' - 0"	1' - 0"	7' - 6"
22		•	•	•	•

ROOM FINISH SCHEDULE						
NAME	WALL FINISH	FLOOR FINISH	CEILING FINISH	PERIMETER	AREA	
BEDROOM 4	PAINTED GYPSUM	PAINTED GYPSUM	PAINTED GYPSUM	49' - 4"	152 SF	
BEDROOM 3	PAINTED GYPSUM	PAINTED GYPSUM	PAINTED GYPSUM	47' - 8"	142 SF	
BEDROOM 2	PAINTED GYPSUM	PAINTED GYPSUM	PAINTED GYPSUM	52' - 8"	151 SF	
STUDY	PAINTED GYPSUM	PAINTED GYPSUM	PAINTED GYPSUM	47' - 4"	140 SF	
GARAGE	PAINTED GYPSUM	CONC. SLAB	PAINTED GYPSUM	116' - 0"	749 SF	
M. BEDROOM	PAINTED GYPSUM	PAINTED GYPSUM	PAINTED GYPSUM	65' - 8"	269 SF	
GREAT ROOM	PAINTED GYPSUM	PAINTED GYPSUM	PAINTED GYPSUM	94' - 5"	413 SF	
FOYER	PAINTED GYPSUM	PAINTED GYPSUM	PAINTED GYPSUM	40' - 4"	88 SF	
DINING	PAINTED GYPSUM	PAINTED GYPSUM	PAINTED GYPSUM	54' - 8"	178 SF	
MUDROOM	PAINTED GYPSUM	PAINTED GYPSUM	PAINTED GYPSUM	37' - 8"	88 SI	
KITCHEN	PAINTED GYPSUM	PAINTED GYPSUM	PAINTED GYPSUM	65' - 8"	250 SI	

DOOR SIZE	QUANTITY	HEAD HGT.
2/0 X 6/8	1	6' - 8"
2/4 X 7/0	9	7' - 0"
2/8 X 7/0	3	7' - 0"
3/0 X 7/0	12	7' - 0"
3/0 X 7/6	1	7' - 5 1/2"
5/0 X 7/0	1	7' - 0"
6/0 X 7/0 DBL BARN DOOR	1	7' - 0"
18/0 X 8/0 OVERHEAD DOOR	1	8' - 0"
Barn Door (Interior)	1	7' - 0"
UIFD3690	1	8' - 4"
Grand total: 31	•	•

SQUARE FOOTAGES	}	
FIRST FLOOR HEATED S.F.	2827	2821.15
SECOND FLOOR HEATED S.F.	570	_N/A
TOTAL HEATED S.F.	3397	2821.15
GARAGE UNHEATED S.F.	805	7 <del>72.10</del>
PORCHES UNHEATED S.F.		588.23
TOTAL UN-HEATED S.F.		984.17

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field changes marked for "as built" plans.

DESIGN COMPANY:

S

BRYON A. DONALDSON DONALDSONDESIGNS 252-902-7402

CLIENT / OWNER:

PROJECT INFORMATION: THE SWINSON Owner ENCE THE SWINSON HOLLY SPRINGS, NORTH

PRIN

12" = 1'-0"

SHEET INFORMATION:

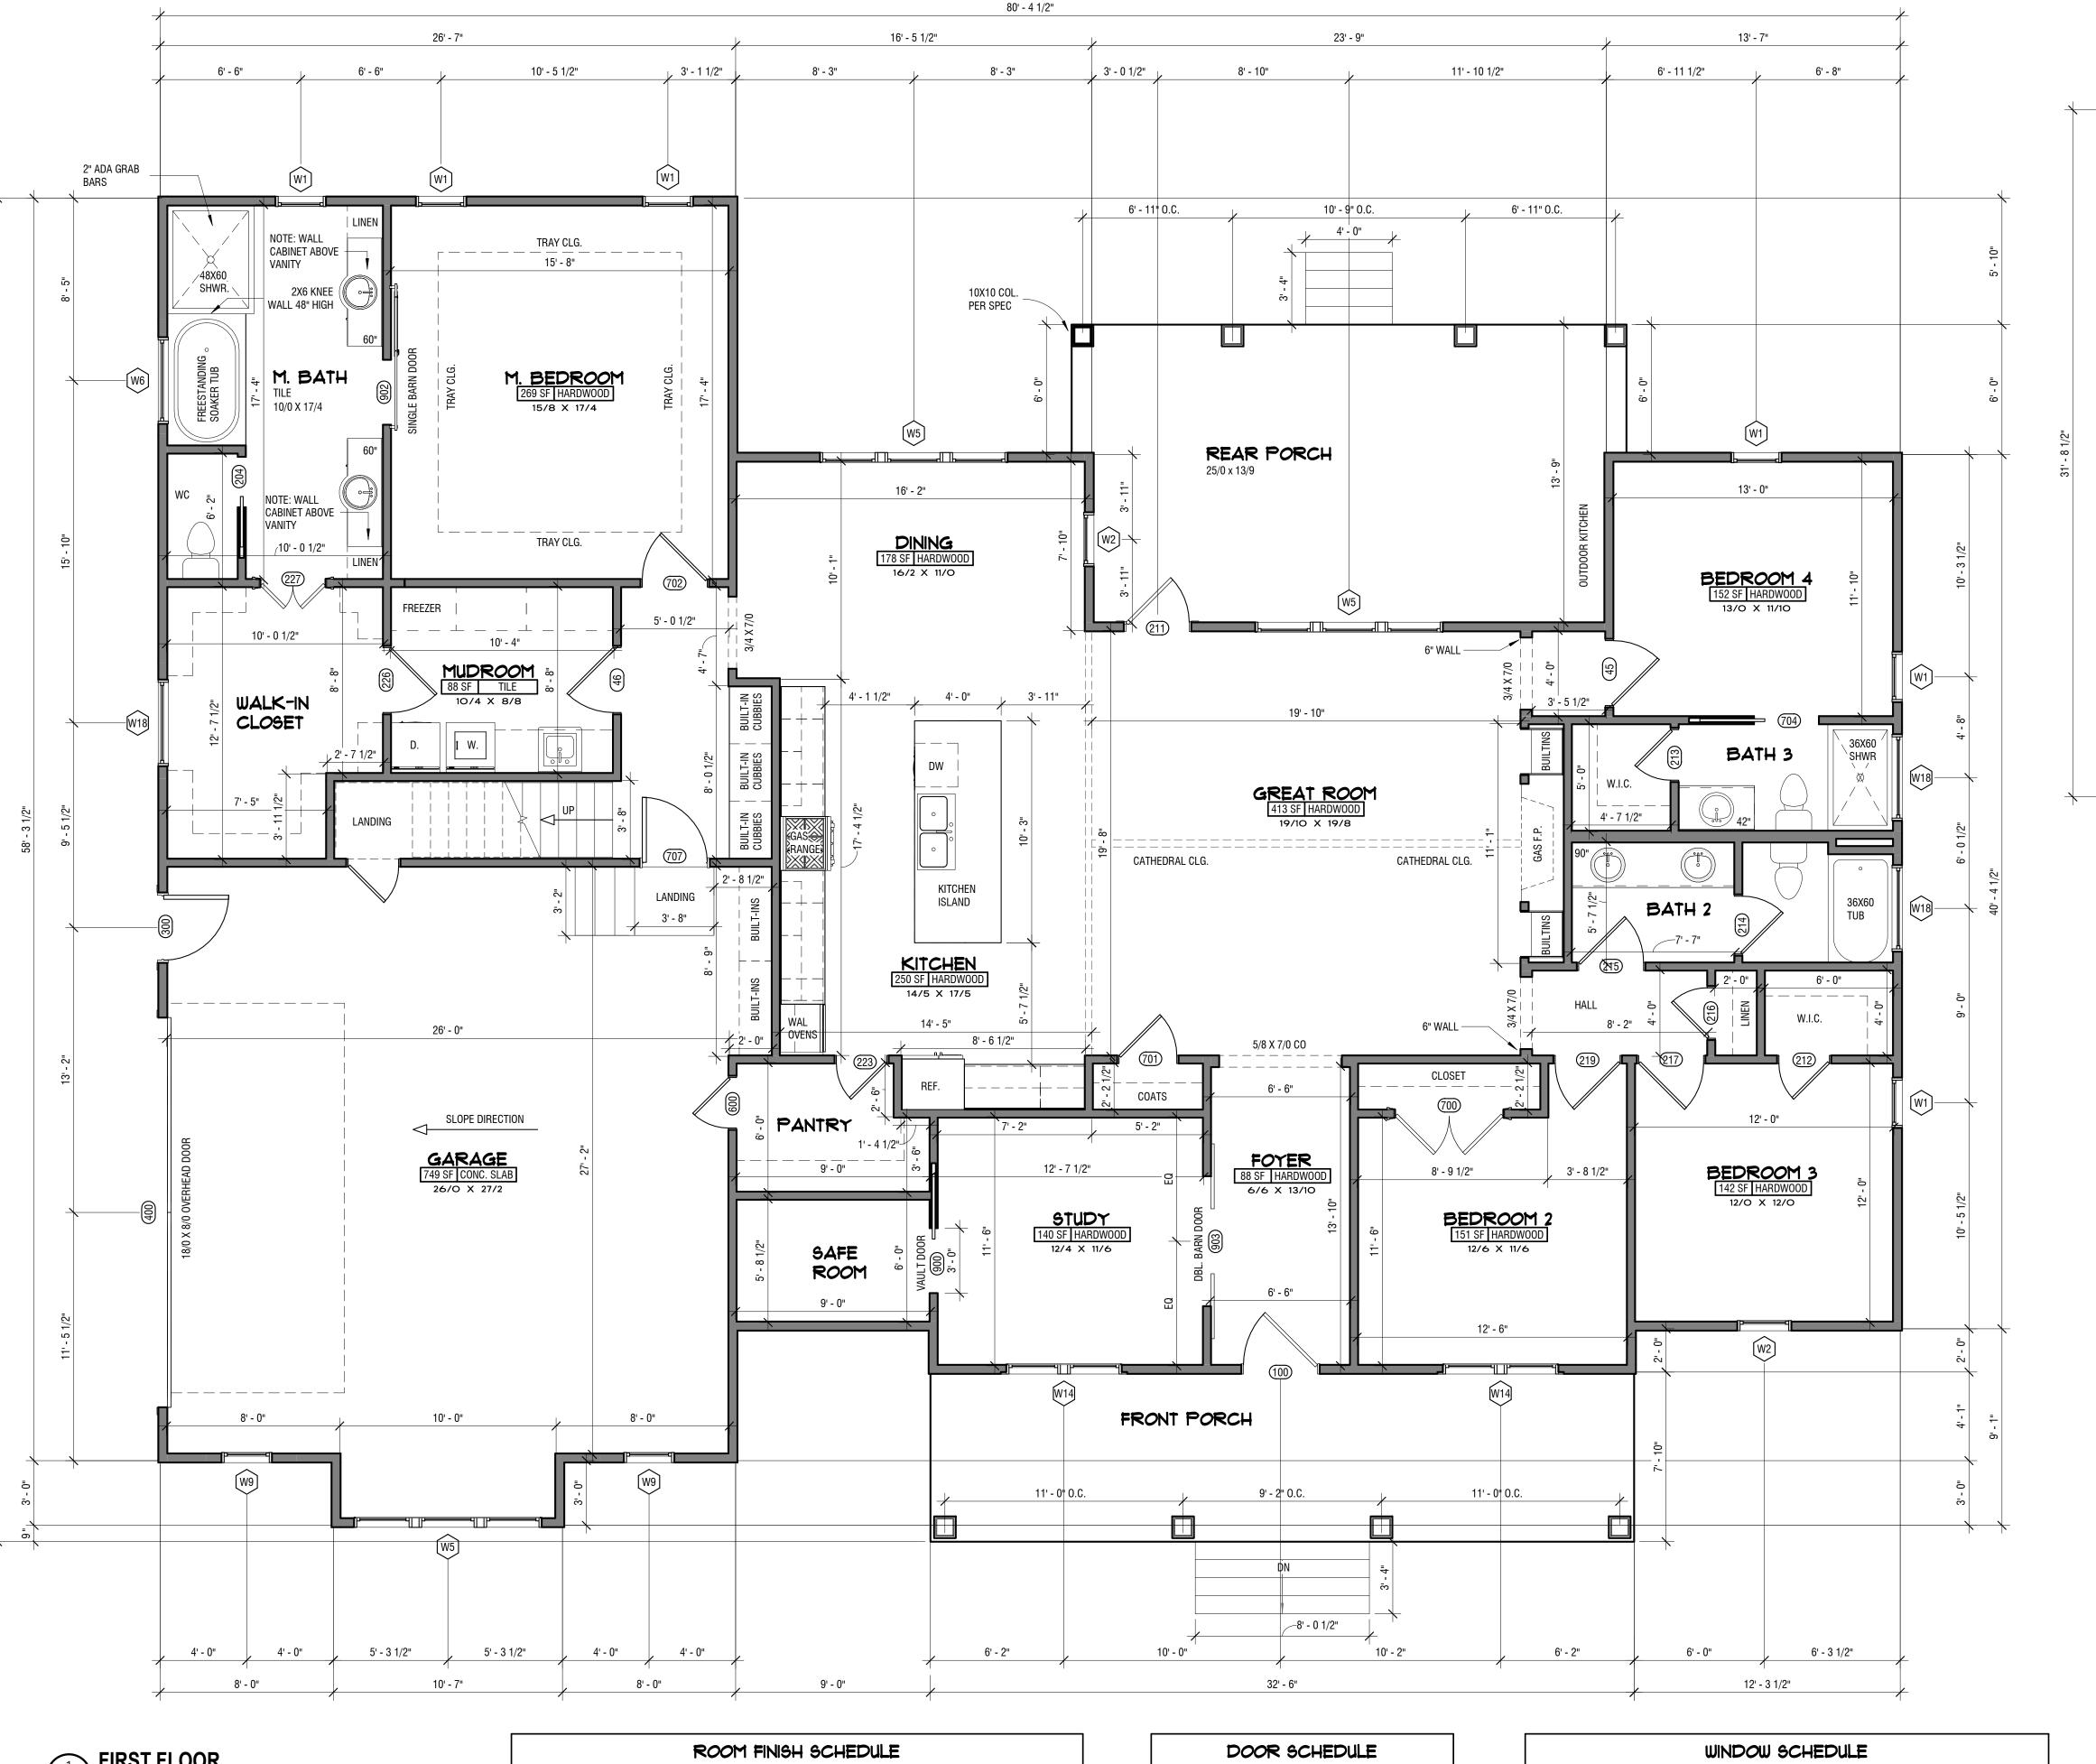
CAROLINA T

Designer

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SHEET NUMBER



14' - 1" L 2' - 11 1/2" 4' - 9" 6' - 11 1/2" 2' - 9 1/2' 21' - 2 1/2" BONUS ROOM 16/4 X 18/3 16' - 4" 8' - 6" 4' - 9 1/2" 8' - 6" 21' - 9 1/2"

21' - 9 1/2"

### CONSTRUCTION NOTES:

1. STEEL FLITCH BEAMS SHALL BE FASTENED TOGETHER WITH 1/2" DIAMETER BOLTS WITH WASHERS PLACED UNDER THE THREADED END OF THE BOLT. BOLTS SHALL BE SPACED AT MAXIMUM 24" o.c. STAGGERED TOP AND BOTTOM OF BEAM WITH A MINIMUM 2" EDGE DISTANCE. TWO BOLTS SHALL BE LOCATED AT 6" FROM EACH END OF FLITCH BEAM.

2. STEEL BEAMS SHALL BE SUPPORTED AT EACH END WITH A MINIMUM BEARING LENGTH OF 3 1/2" AND FULL FLANGE WIDTH. BEAMS MUST BE ANCHORED AT EACH END WITH A MINIMUM OF FOUR

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1 FIRST FLOOR
B1 1/4" = 1'-0"

ROOM FINISH SCHEDULE						
NAME	WALL FINISH	FLOOR FINISH	CEILING FINISH	PERIMETER	AREA	
BEDROOM 4	PAINTED GYPSUM	PAINTED GYPSUM	PAINTED GYPSUM	49' - 4"	152 SF	
BEDROOM 3	PAINTED GYPSUM	PAINTED GYPSUM	PAINTED GYPSUM	47' - 8"	142 SF	
BEDROOM 2	PAINTED GYPSUM	PAINTED GYPSUM	PAINTED GYPSUM	52' - 8"	151 SF	
STUDY	PAINTED GYPSUM	PAINTED GYPSUM	PAINTED GYPSUM	47' - 4"	140 SF	
GARAGE	PAINTED GYPSUM	CONC. SLAB	PAINTED GYPSUM	116' - 0"	749 SF	
M. BEDROOM	PAINTED GYPSUM	PAINTED GYPSUM	PAINTED GYPSUM	65' - 8"	269 SF	
GREAT ROOM	PAINTED GYPSUM	PAINTED GYPSUM	PAINTED GYPSUM	94' - 5"	413 SF	
FOYER	PAINTED GYPSUM	PAINTED GYPSUM	PAINTED GYPSUM	40' - 4"	88 SF	
DINING	PAINTED GYPSUM	PAINTED GYPSUM	PAINTED GYPSUM	54' - 8"	178 SF	
MUDROOM	PAINTED GYPSUM	PAINTED GYPSUM	PAINTED GYPSUM	37' - 8"	88 SF	
KITCHEN	PAINTED GYPSUM	PAINTED GYPSUM	PAINTED GYPSUM	65' - 8"	250 SF	

DOOR !	SCHEDULE	
DOOR SIZE	QUANTITY	HEAD HGT.
2/0 X 6/8	1	6' - 8"
2/4 X 7/0	9	7' - 0"
2/8 X 7/0	3	7' - 0"
3/0 X 7/0	12	7' - 0"
3/0 X 7/6	1	7' - 5 1/2"
5/0 X 7/0	1	7' - 0"
6/0 X 7/0 DBL BARN DOOR	1	7' - 0"
18/0 X 8/0 OVERHEAD DOOR	1	8' - 0"
Barn Door (Interior)	1	7' - 0"
UIFD3690	1	8' - 4"
Grand total: 31		

PLAN MARK	QUANTITY	WINDOW SIZE	WIDTH	HEIGHT	HEAD HGT.
W1	6	2/4 X 5/8 SINGLE	2' - 4"	5' - 8"	7' - 6"
W2	2	2/6 X 6/0 SINGLE	2' - 6"	6' - 0"	7' - 6"
W5	3	7/6 X 6/0 TRIPLE	8' - 8"	6' - 0"	7' - 6"
W6	1	4/0 X 4/0 GLASS BLOCK	4' - 0"	4' - 0"	7' - 6"
W8	1	7/6 X 5/8 TRIPLE	8' - 2"	5' - 8"	7' - 6"
W9	4	2/4 X 4/8 SINGLE	2' - 4"	4' - 8"	
W14	2	5/4 X 6/10 TWIN W/ TRANSOM	5' - 4"	6' - 10"	8' - 2"
W18	3	4/0 X 1/0	4' - 0"	1' - 0"	7' - 6"

As indicated SHEET INFORMATION:

FIRST FLOOR PLAN

PROJECT INFORMATION:

HOLLY SPRINGS, NORTH

THE SWINSON

THE SWINSON

OwnerENCE

CAROLINA

Designer

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project of which they are designed.

field changes marked for "as built" plans.

DESIGN COMPANY:

BRYON A. DONALDSON

DONALDSONDESIGNS

252-902-7402

DONALDSONDESIGNS@GMAIL.COM

CLIENT / OWNER:

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SWIN

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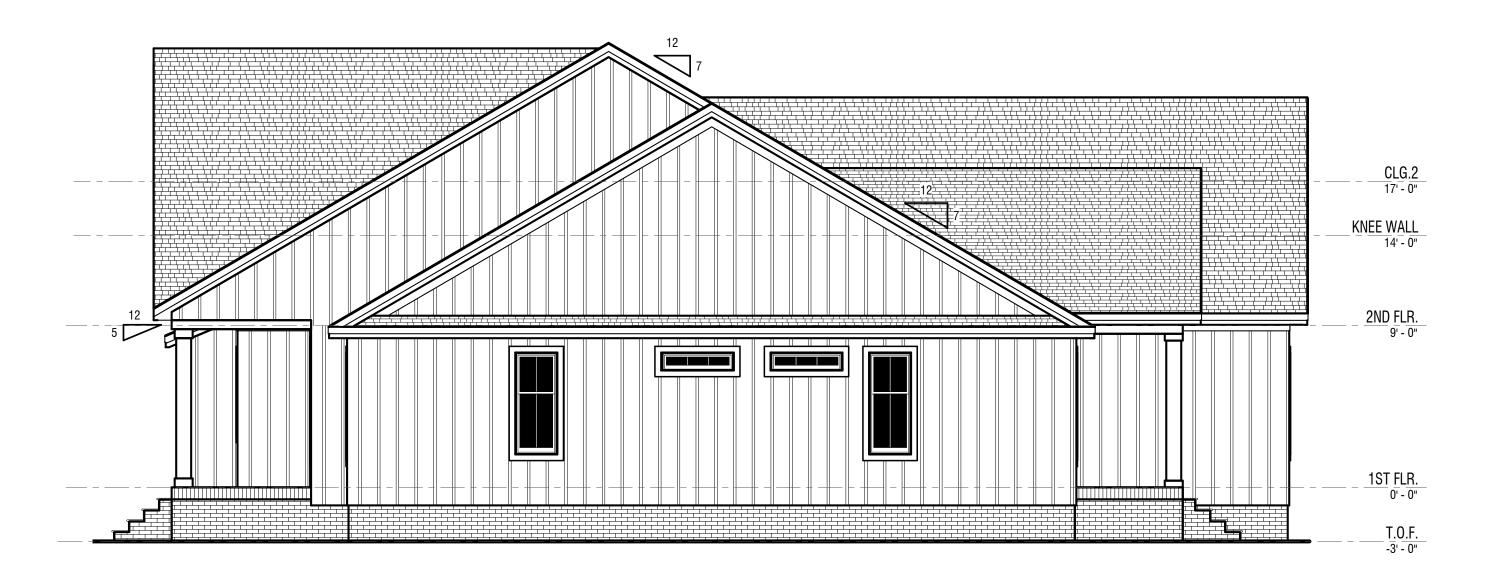
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SHEET NUMBER

SQUARE FOOTAGES: FIRST FLOOR HEATED S.F. 2821.15 SECOND FLOOR HEATED S.F. TOTAL HEATED S.F. 2821.15 772.10 GARAGE UNHEATED S.F. 588.23 PORCHES UNHEATED S.F. TOTAL UN-HEATED S.F. 984.17



	•	ROOM FINISH	SCHEDULE		
NAME	WALL FINISH	FLOOR FINISH	CEILING FINISH	PERIMETER	AREA
BEDROOM 4	PAINTED GYPSUM	PAINTED GYPSUM	PAINTED GYPSUM	49' - 4"	152 S
BEDROOM 3	PAINTED GYPSUM	PAINTED GYPSUM	PAINTED GYPSUM	47' - 8"	142 S
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PLAN MARK	QUANTITY	WINDOW SIZE	WIDTH	HEIGHT	HEAD HGT
			•		•
W1	6	2/4 X 5/8 SINGLE	2' - 4"	5' - 8"	7' - 6"
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W9	4	2/4 X 4/8 SINGLE	2' - 4"	4' - 8"	
W14	2	5/4 X 6/10 TWIN W/ TRANSOM	5' - 4"	6' - 10"	8' - 2"
W18	3	4/0 X 1/0	4' - 0"	1' - 0"	7' - 6"

DOOR SCHEDULE					
DOOR SIZE	QUANTITY	HEAD HGT.			
2/0 X 6/8	1	6' - 8"			
2/4 X 7/0	9	7' - 0"			
2/8 X 7/0	3	7' - 0"			
3/0 X 7/0	12	7' - 0"			
3/0 X 7/6	1	7' - 5 1/2"			
5/0 X 7/0	1	7' - 0"			
6/0 X 7/0 DBL BARN DOOR	1	7' - 0"			
18/0 X 8/0 OVERHEAD DOOR	1	8' - 0"			
Barn Door (Interior)	1	7' - 0"			
UIFD3690	1	8' - 4"			
Grand total: 31					

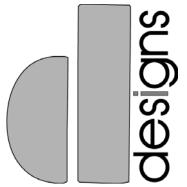


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Upon completion of project all copies must be returned to DT&A with field changes marked for "as built" plans.

DESIGN COMPANY:



BRYON A. DONALDSON DONALDSONDESIGNS 252-902-7402 DONALDSONDESIGNS@GMAIL.COM

CLIENT / OWNER:

RESIDENCE

CAROLINA

SPRINGS, NOR

# SWINSON 里

PROJECT INFORMATION:
THE SWINSON
Owner ENCE

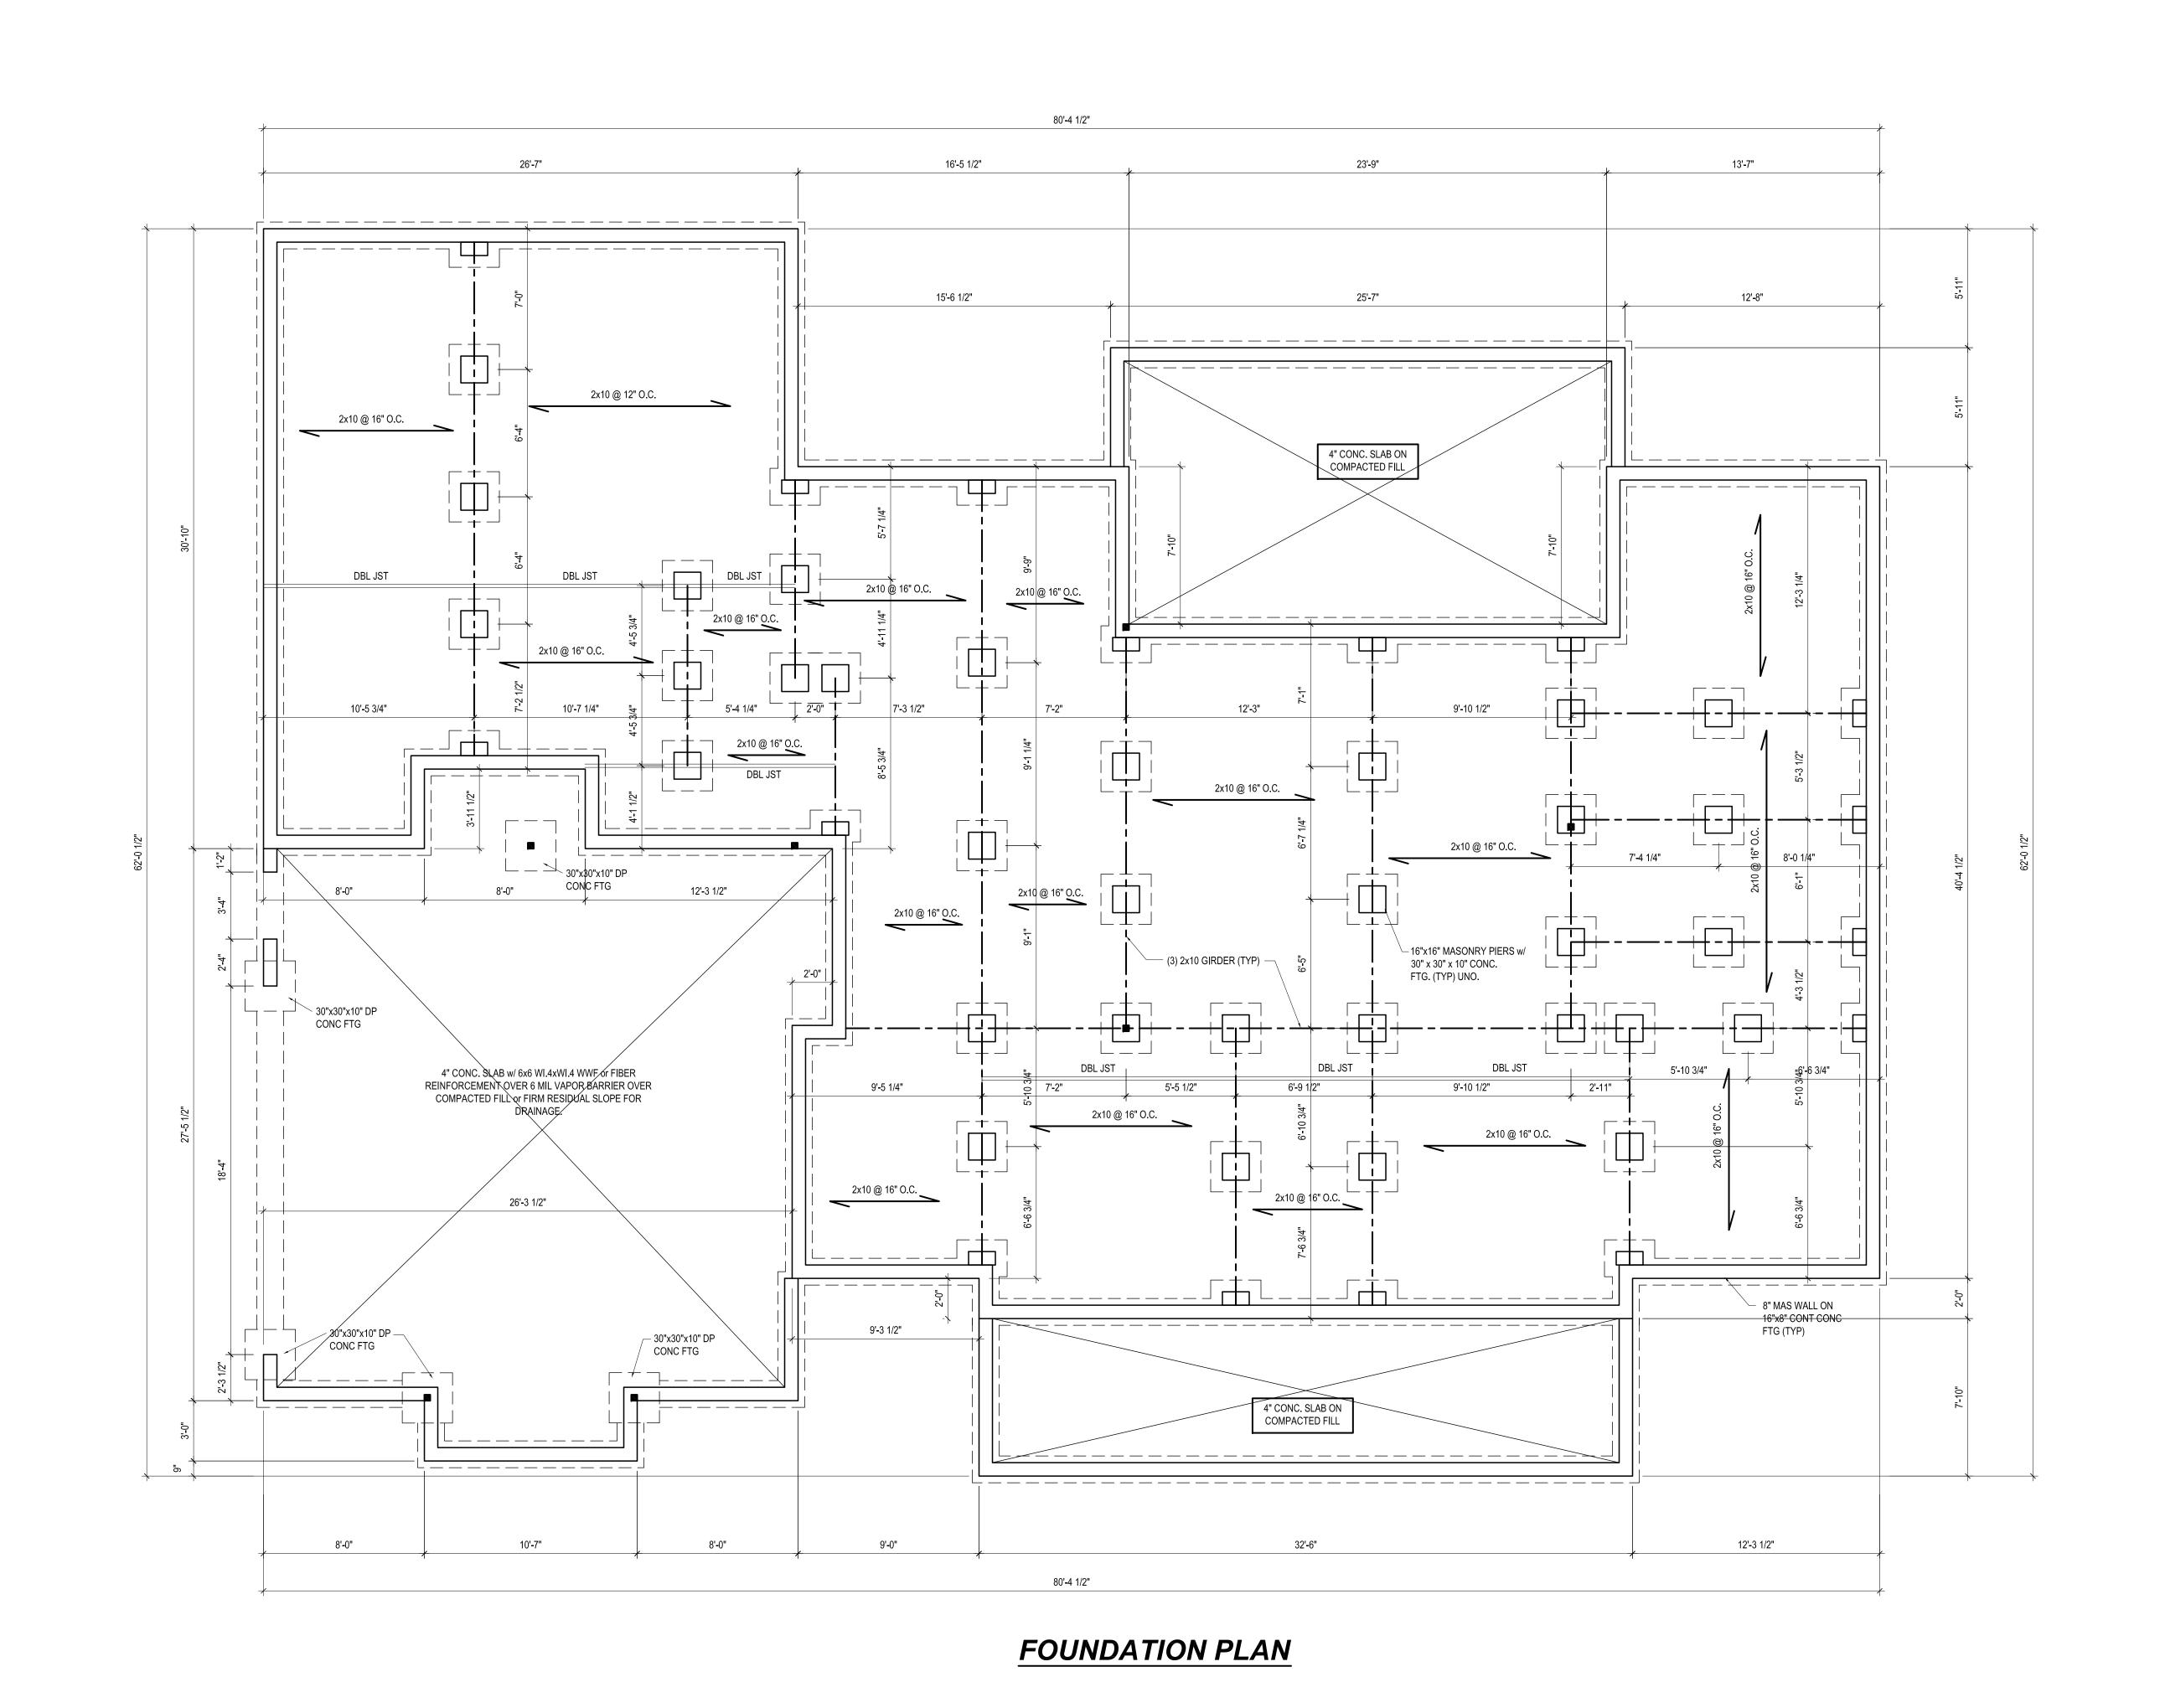
THE SWINSON
HOLLY SPRINGS, NORTH
CAROLINA

Designer As indicated

SHEET INFORMATION:

EXTERIOR ELEVATIONS

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NC

Angel Structures, I P.O. Box 982 Fuquay-Varina, N

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\* Please review these documents carefully.
Mark E. Jones, PE will interpret
that all dimensions, recommendations,
etc. presented in these documents were
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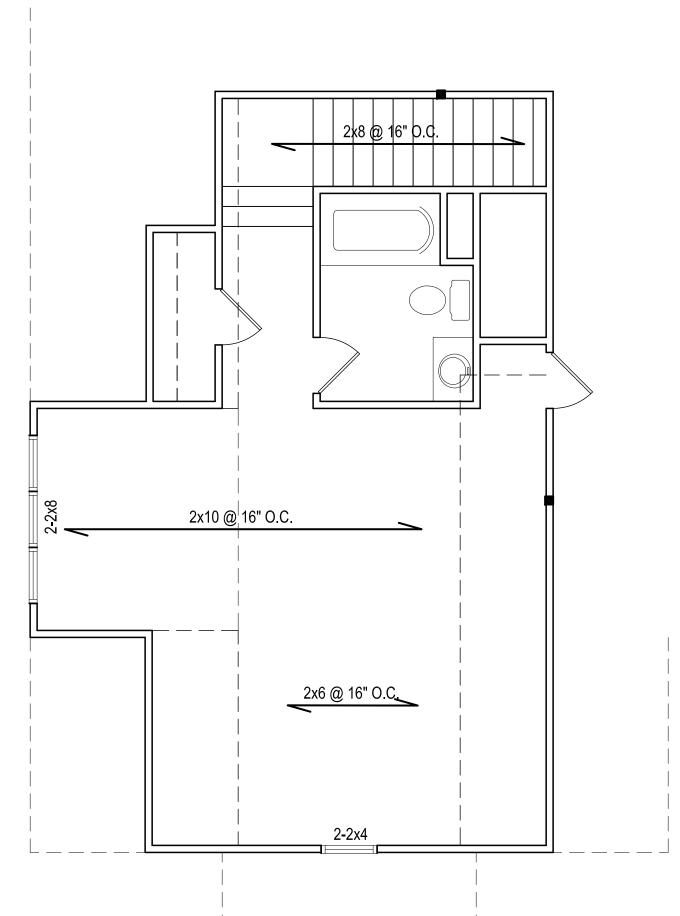
11/16/2020 Drawn/Design By: DWG. Checked By: MEJ Scale: 1/4"=1'-0"

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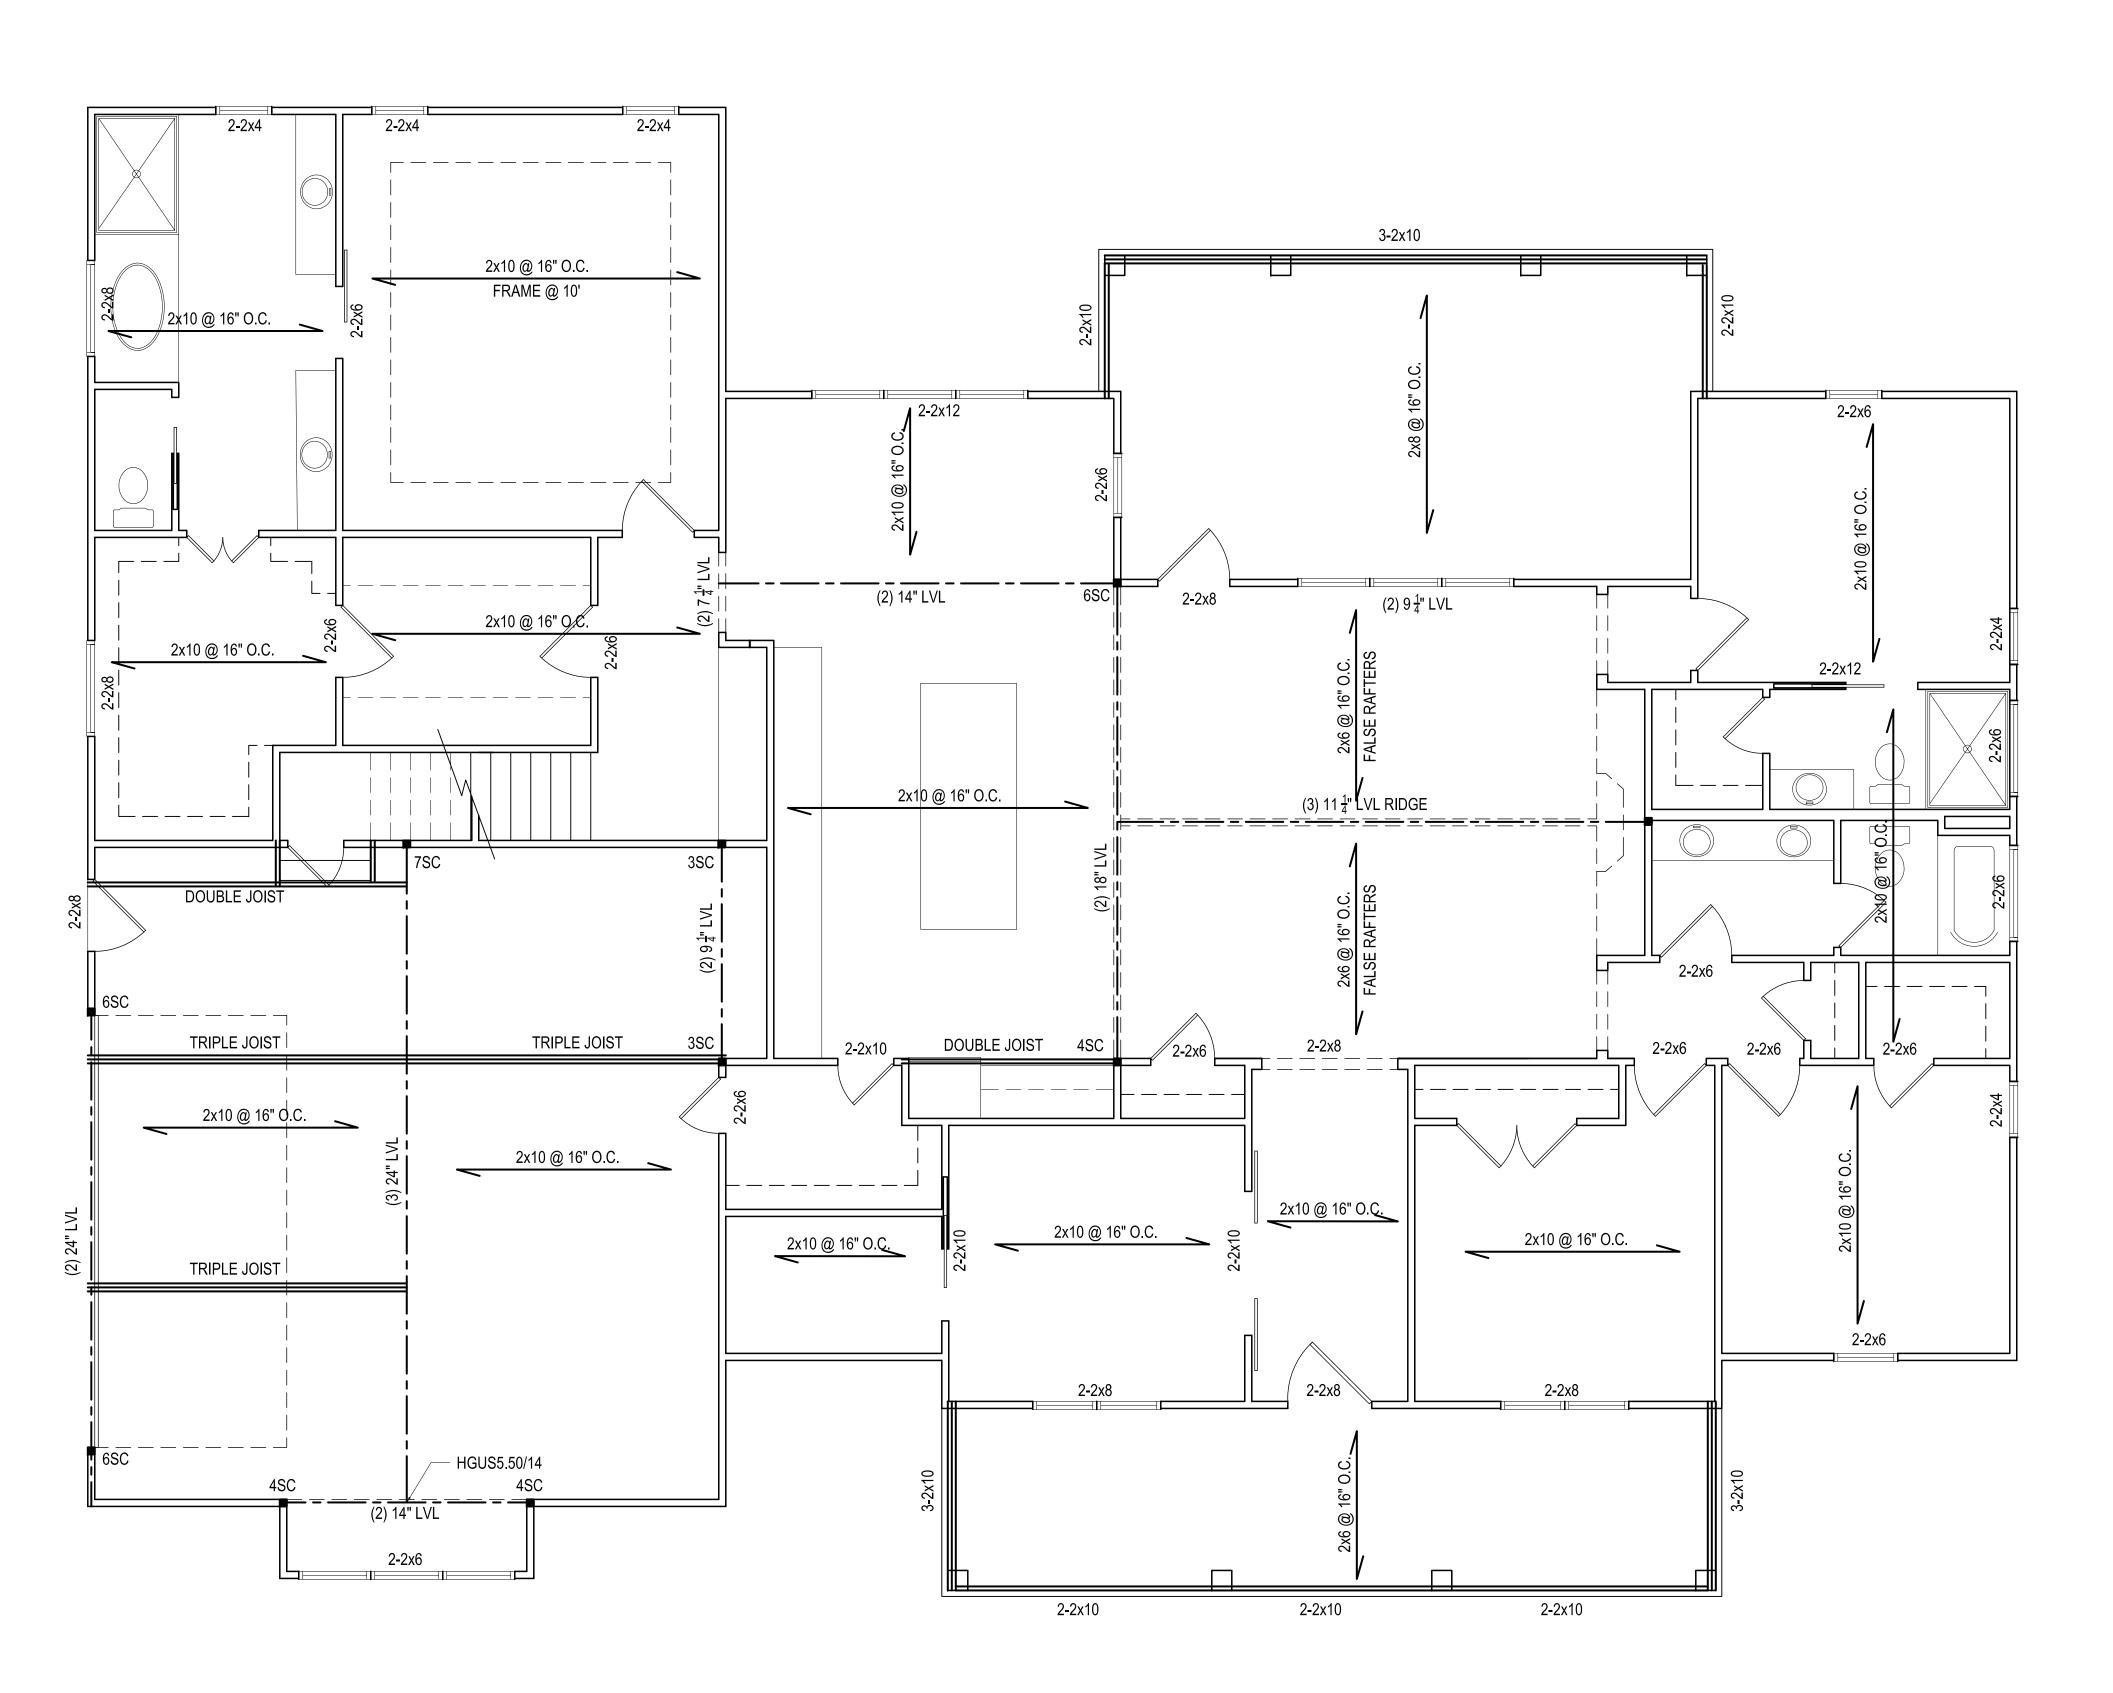
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## BRACED WALL NOTES THIS PLAN SHALL BE CONTINUOUSLY BRACED WITH WOOD STRUCTURAL PANELS PER SECTION R602.10.3 OF THE NC RESIDENTIAL BUILDING CODE. NOTE ALL WALL BRACING LINES SATISFY THE MINIMUM AMOUNTS OF WALL BRACING PER CODE. GARAGE DOOR HEADER SHALL BE CONSTRUCTED PER FIGURE R602.10.1, METHOD PF.



### SECOND FLOOR STRUCTURAL PLAN

1/4" = 1'-0"



### FIRST FLOOR STRUCTURAL PLAN

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Mark E. Jones, PE 6425 Glen Dean Court Raleigh, NC 27603 (919) 395-5618

Angel Structures, Inc P.O. Box 982 Fuquay-Varina, NC

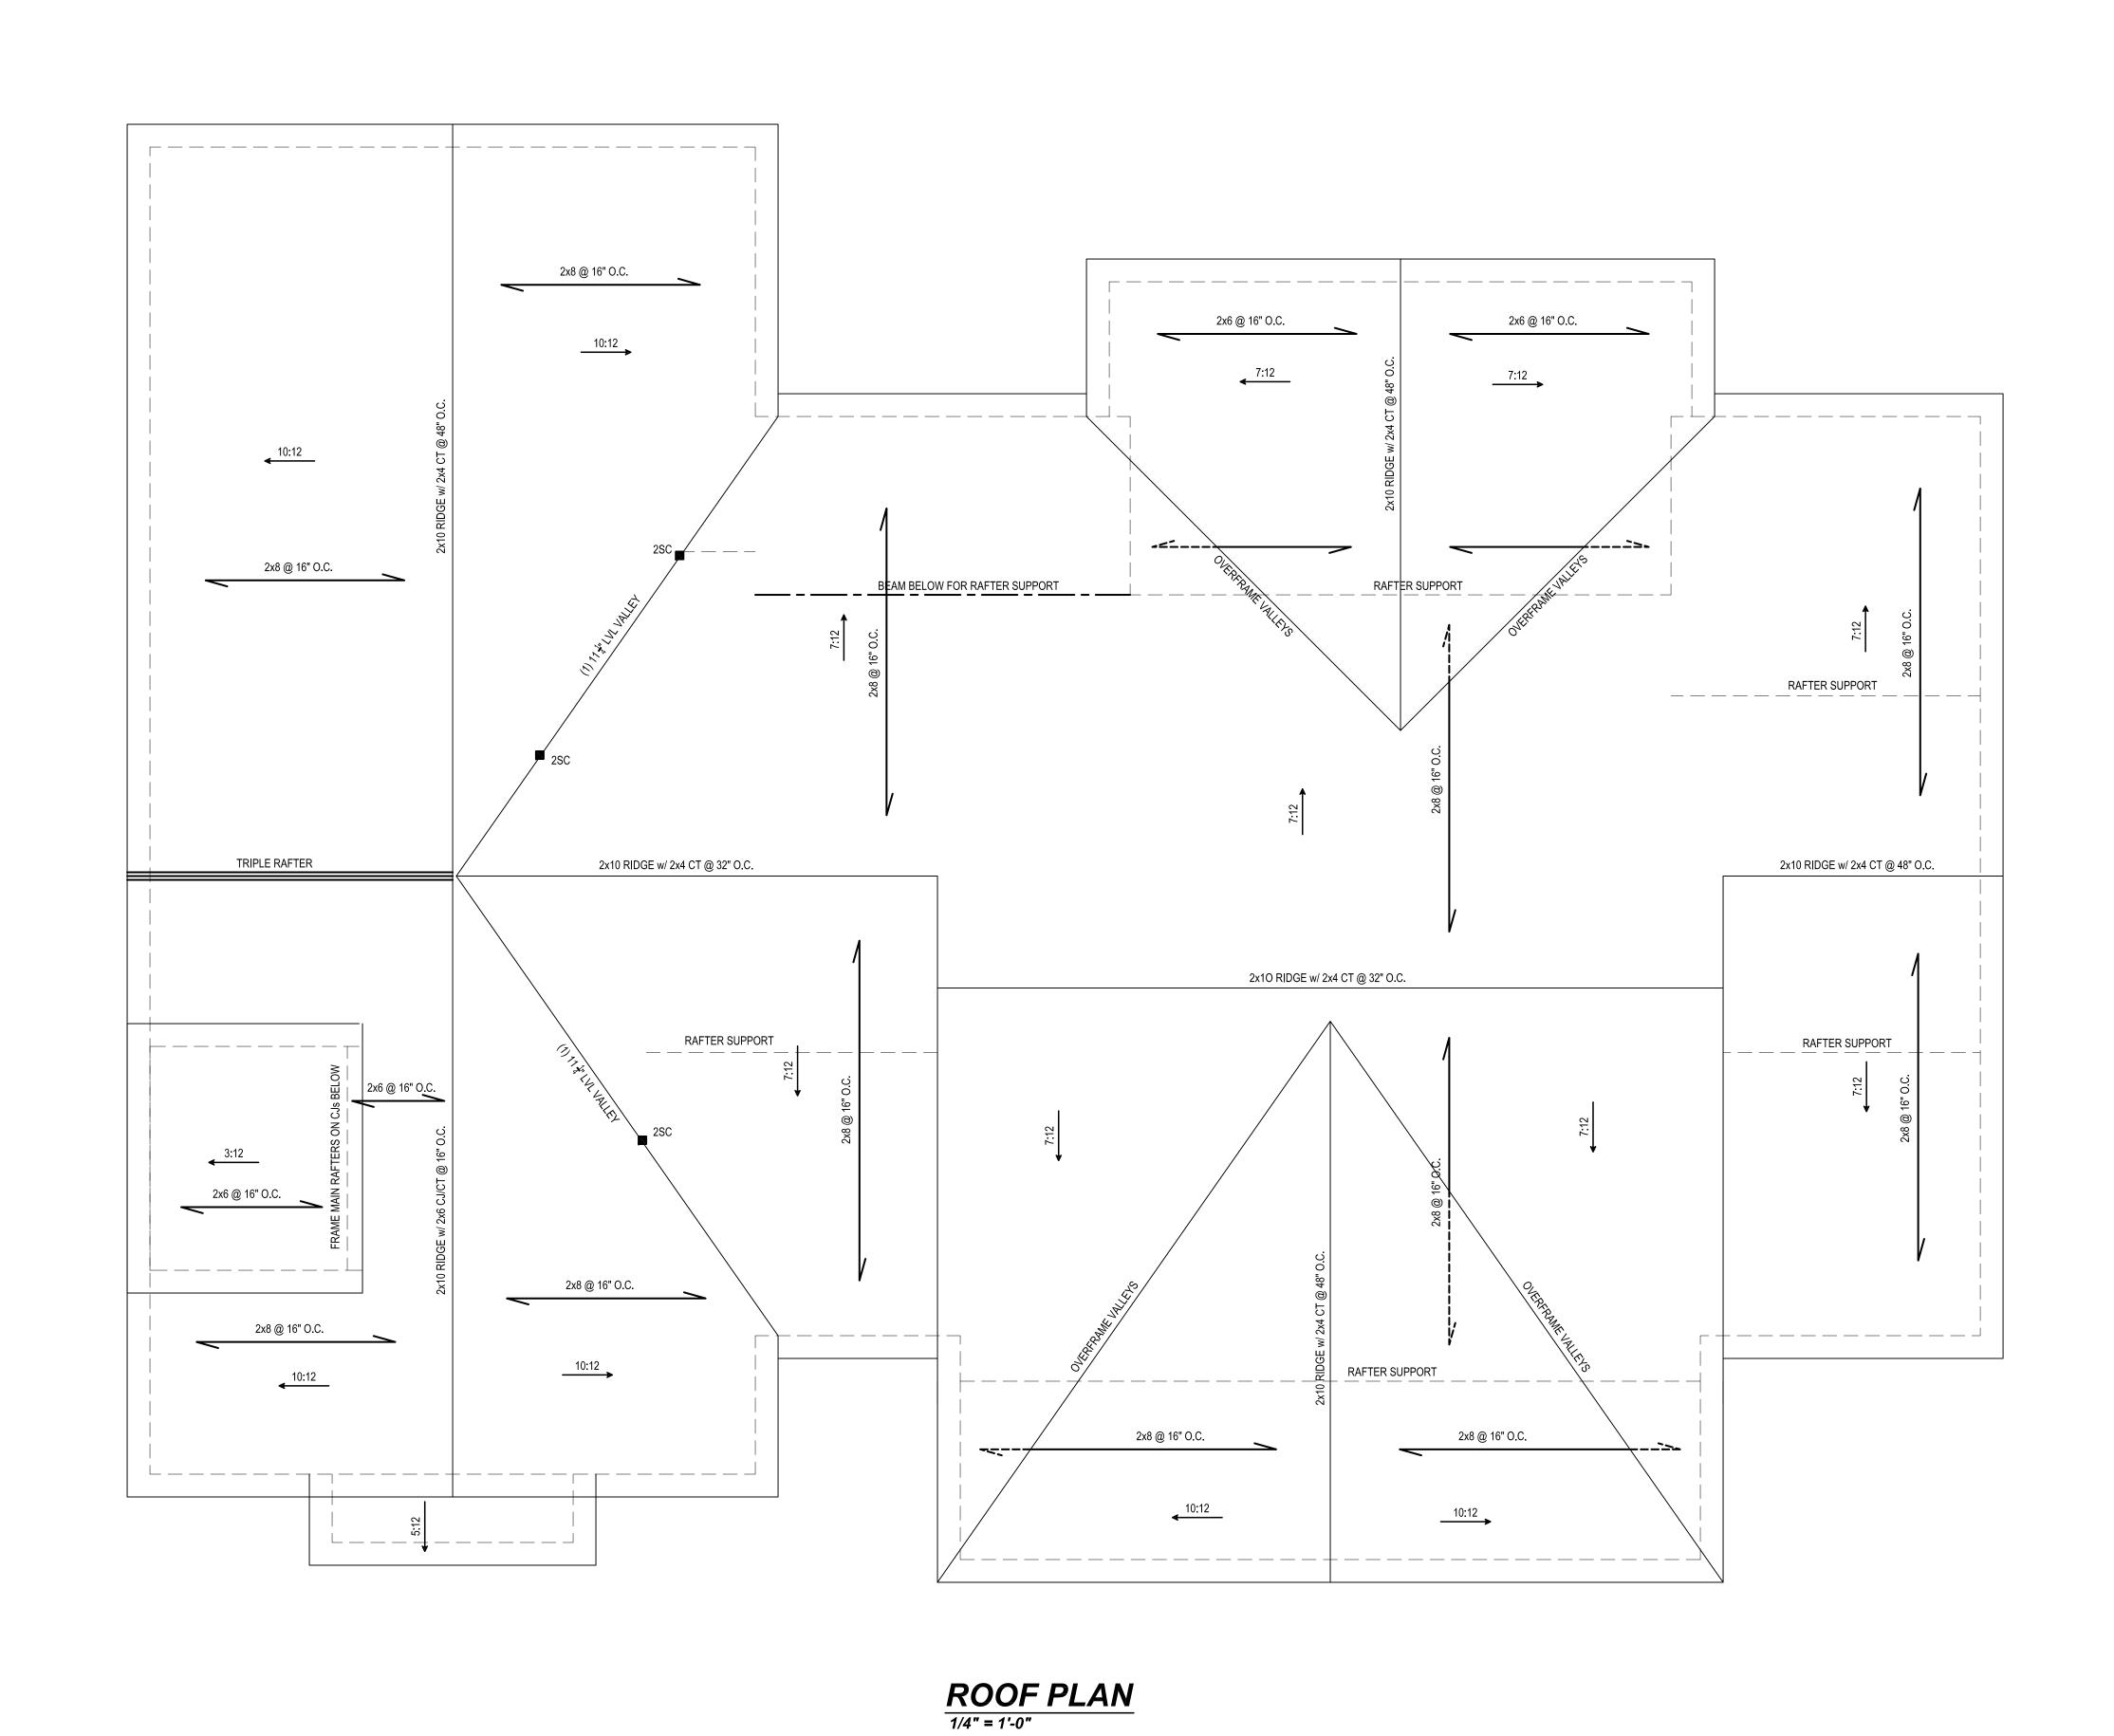
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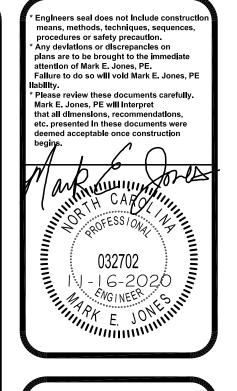
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### STRUCTURAL NOTES

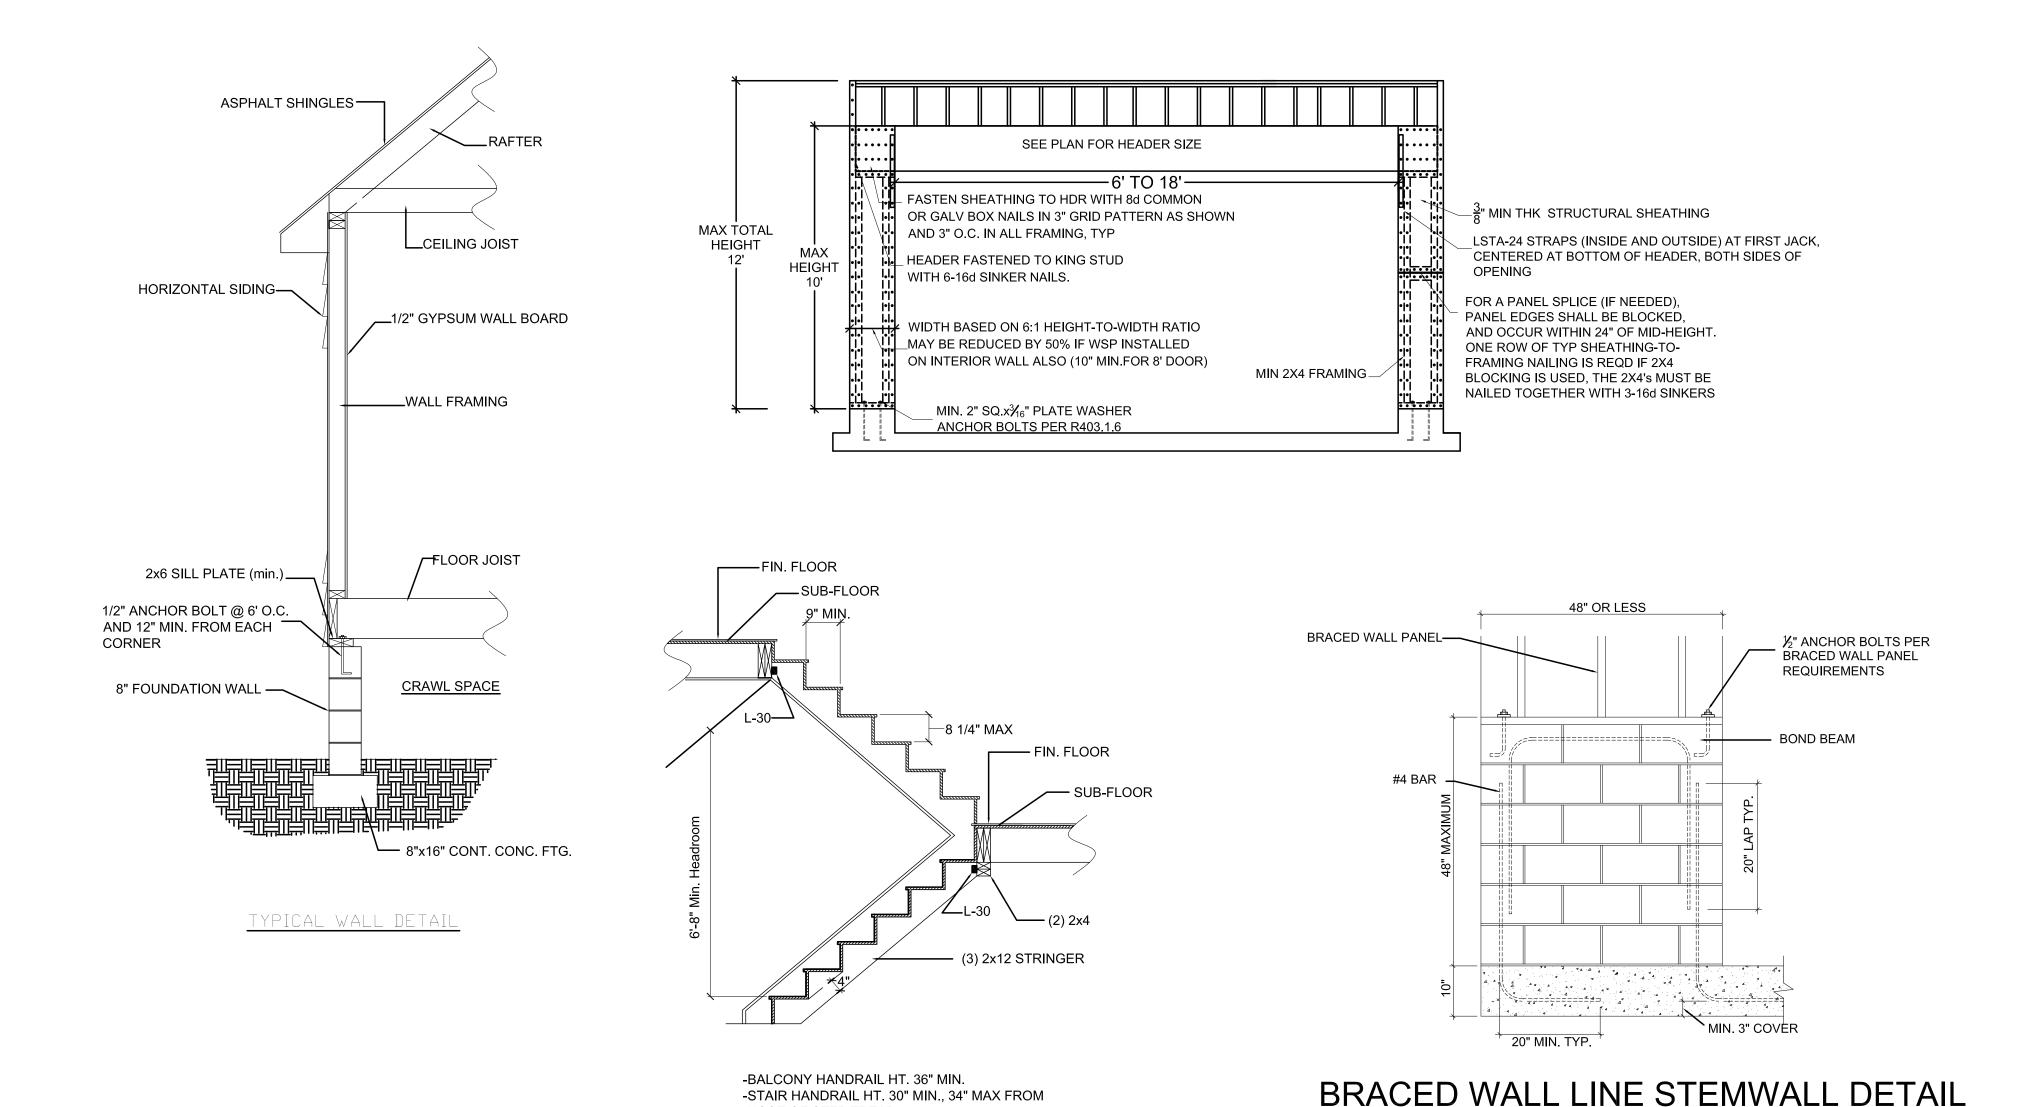
1) ALL CONSTRUCTION SHALL CONFORM TO THE LATEST REQUIREMENTS OF "NORTH CAROLINA STATE 2018 RESIDENTIAL BUILDING CODE", IN ADDITION TO ALL LOCAL CODES AND REGULATIONS. 2) DESIGN LOADS:

	LIVE LOAD (PSF)	DEAD LOAD (PSF)	DEFLECTION (DL & LL)
ALL FLOORS	40	10	L/360
ATTIC (pull down access)	20	10	L/240
ATTIC (no access)	10	5	L/240
EXTERNAL BALCONY	60	10	L/360
ROOF	20	10	L/180
ROOF TRUSS	20	20	L/240
WIND LOAD	[BASE	D ON 115 MPH	(3-second gusts)]

### B) MINIMUM ALLOWABLE SOIL BEARING PRESSURE = 2000 PSF

- 4) CONCRETE SHALL HAVE A MINIMUM 28 DAY STRENGTH OF 3000 PSI AND A MAXIMUM SLUMP OF FIVE INCHES UNLESS NOTED OTHERWISE (UNO).
- 5) MAXIMUM DEPTH OF UNBALANCED FILL AGAINST FOUNDATION WALLS TO BE LESS THAN 4'-0" WITHOUT USING SUFFICIENT WALL BRACING. REFER TO SECTION R404 OF 2018 NC BUILDING CODE FOR BACKFILL LIMITATIONS BASED ON WALL HEIGHT, WALL THICKNESS, SOIL TYPE, AND UNBALANCED BACKFILL HEIGHT
- 6) ALL FRAMING LUMBER SHALL BE SYP #2 (Fb = 800 PSI) UNO.
- ALL FRAMING LUMBER EXPOSED TO THE ELEMENTS SHALL BE TREATED MATERIAL.
- 7) ALL LOAD BEARING HEADERS SHALL BE (2)2x10 (UNO). ALL WINDOW AND DOOR HEADERS SHALL BE SUPPORTED BY (1) JACK STUD AND (1) KING STUD AT EACH END UNLESS NOTED. ALL OTHER BEAMS SHALL BE SUPPORTED BY 2 STUDS OR THE AMOUNT OF STUDS REQUIRED FOR FULL BEARING AT EACH END UNLESS NOTED. POINT LOADS (STIFF KNEES, ETC.) SHALL CONSIST OF 2 STUDS UNLESS NOTED. ALL SUPPORTS OF 2 STUDS OR MORE SHALL BE TRANSFERRED THROUGH EACH FLOOR TO THE FOUNDATION.
- 8) ALL EXTERIOR WALLS TO BE SHEATHED WITH MIN. 7/16" WOOD STRUCTURAL PANELS FASTNED WITH 8D NAILS 6" O.C. AT EDGES AND 12" O.C. AT INT. SUPPORTS. BLOCKING SHALL BE INSTALLED IF LESS THAN 50 PERCENT OF THE WALL LENGTH IS SHEATHED. WHERE BLOCKING IS REQ'D, ALL PANELS SHALL BE FASTENED AT 3" O.C AT EDGES AND 6" O.C. AT
- 9) ALL STRUCTURAL STEEL SHALL ASTM A-36. STEEL BEAMS SHALL BE SUPPORTED AT EACH END WITH A MINIMUM BEARING LENGTH OF 3-1\2" INCHES AND FULL FLANGE WIDTH. PROVIDE SOLID BEARING FROM BEAM SUPPORT TO FOUNDATION. BEAMS SHALL BE ATTACHED TO EACH SUPPORT WITH TWO LAG SCREWS (1/2 DIAMETER AND 4" LONG). LATERAL SUPPORT IS CONSIDERED ADEQUATE PROVIDING THE JOISTS ARE TOE NAILED TO THE SOLE PLATES, AND THE SOLE PLATES ARE NAILED OR BOLTED TO THE BEAM FLANGES @ 48" O.C.
- 10) ANCHOR BOLT PLACEMENT PER SECTION R403.1.6. 1/2" DIAMETER ANCHOR BOLTS SPACED AT 6'-0" O/C AND PLACED 12" FROM THE END OF EACH PLATE SECTION
- 11) FOUNDATION DRAINAGE-DAMP PROOFING OR WATERPROOFING PER SECTION 405 AND 406 OF 2018 NC BUILDING CODE
- 2) WALL AND ROOF CLADDING VALUES:
- WALL CLADDING SHALL BE DESIGNED FOR A 24.1 SQ.FT. OR GREATER POSITIVE AND NEGATIVE PRESSURE ROOF VALUES BOTH POSITIVE AND NEGATIVE SHALL BE AS FOLLOWS:
- 45.5 LBS/SQFT FOR ROOF PITCHES OF 0/12 TO 2.25/12
- 34.8 LBS/SQFT FOR ROOF PITCHES OF 2.25/12 TO 7/12 21.0 LBS/SQFT FOR ROOF PITCHES OF 7/12 TO 12/12
- \*\* MEAN ROOF HEIGHT 30' OR LESS
- 13) FOR ROOF SLOPES FROM 2:12 THROUGH 4:12, BUILDER TO INSTALL 2 LAYERS OF 15# FELT PAPER
- 14) IT IS THE CONTRACTOR'S RESPONSIBLITY TO VERIFY ALL DIMENSIONS AND SQ. FTG. ARE CORRECT PRIOR TO CONSTRUCTION. DESIGNER IS NOT RESPONSIBLE FOR DIMENSIONING OR SQ. FTG. ERRORS ONCE CONSTRUCTION BEGINS

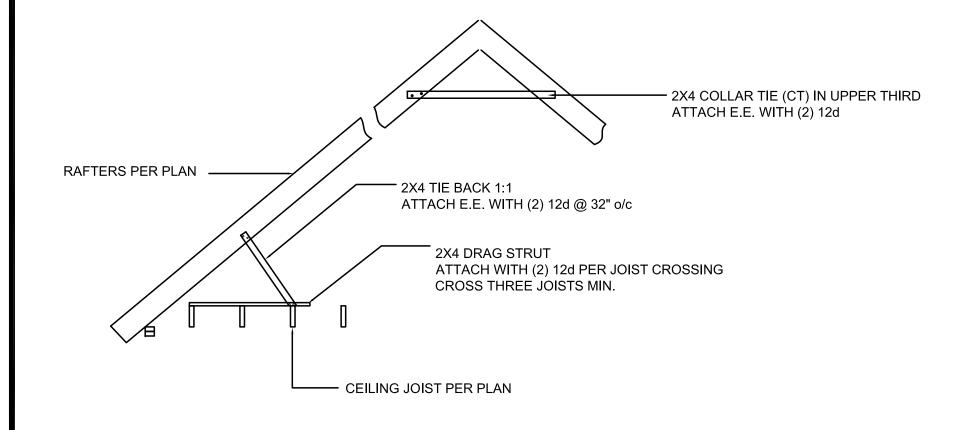
CLIMATE ZONE	MAXIMUM	MINIMUM INSULATION R-VALUE					
	GLAZING U-FACTOR	CEILINGS	WALLS	FLOORS	BASEMENT WALLS	SLAB PERIMETER	CRAWL SPACE WALLS
3	.35	R-38 or R-30	R-15	R-19	R-5/13	R-0	R-5/13
4	.35	R-38 or R-30	R-15	R-19	R-10/15	R-10	R-10/15

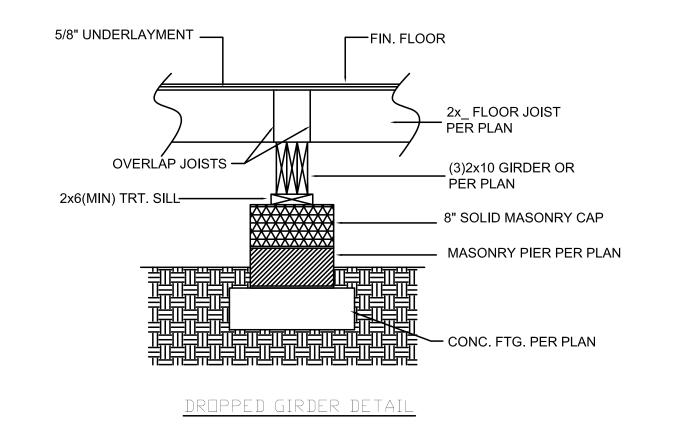


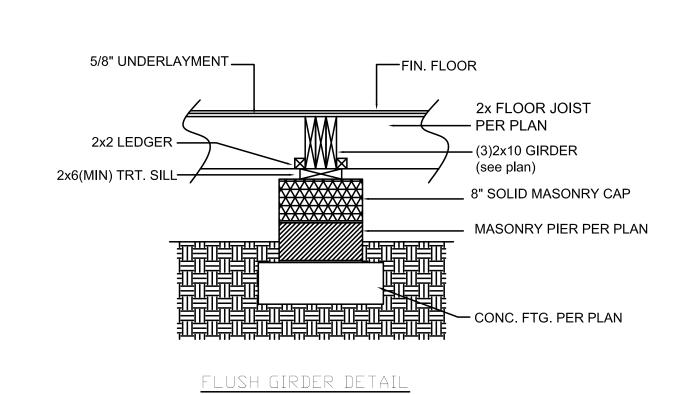
TYPICAL STAIRWAY DETAIL

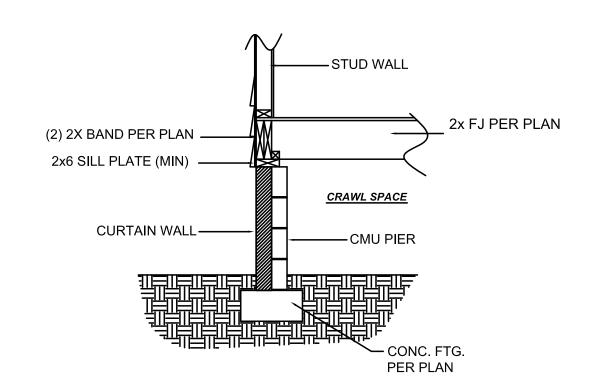
-STAIR HANDRAIL HT. 30" MIN., 34" MAX FROM

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**DETAILS** 

Sheet Number **S4**