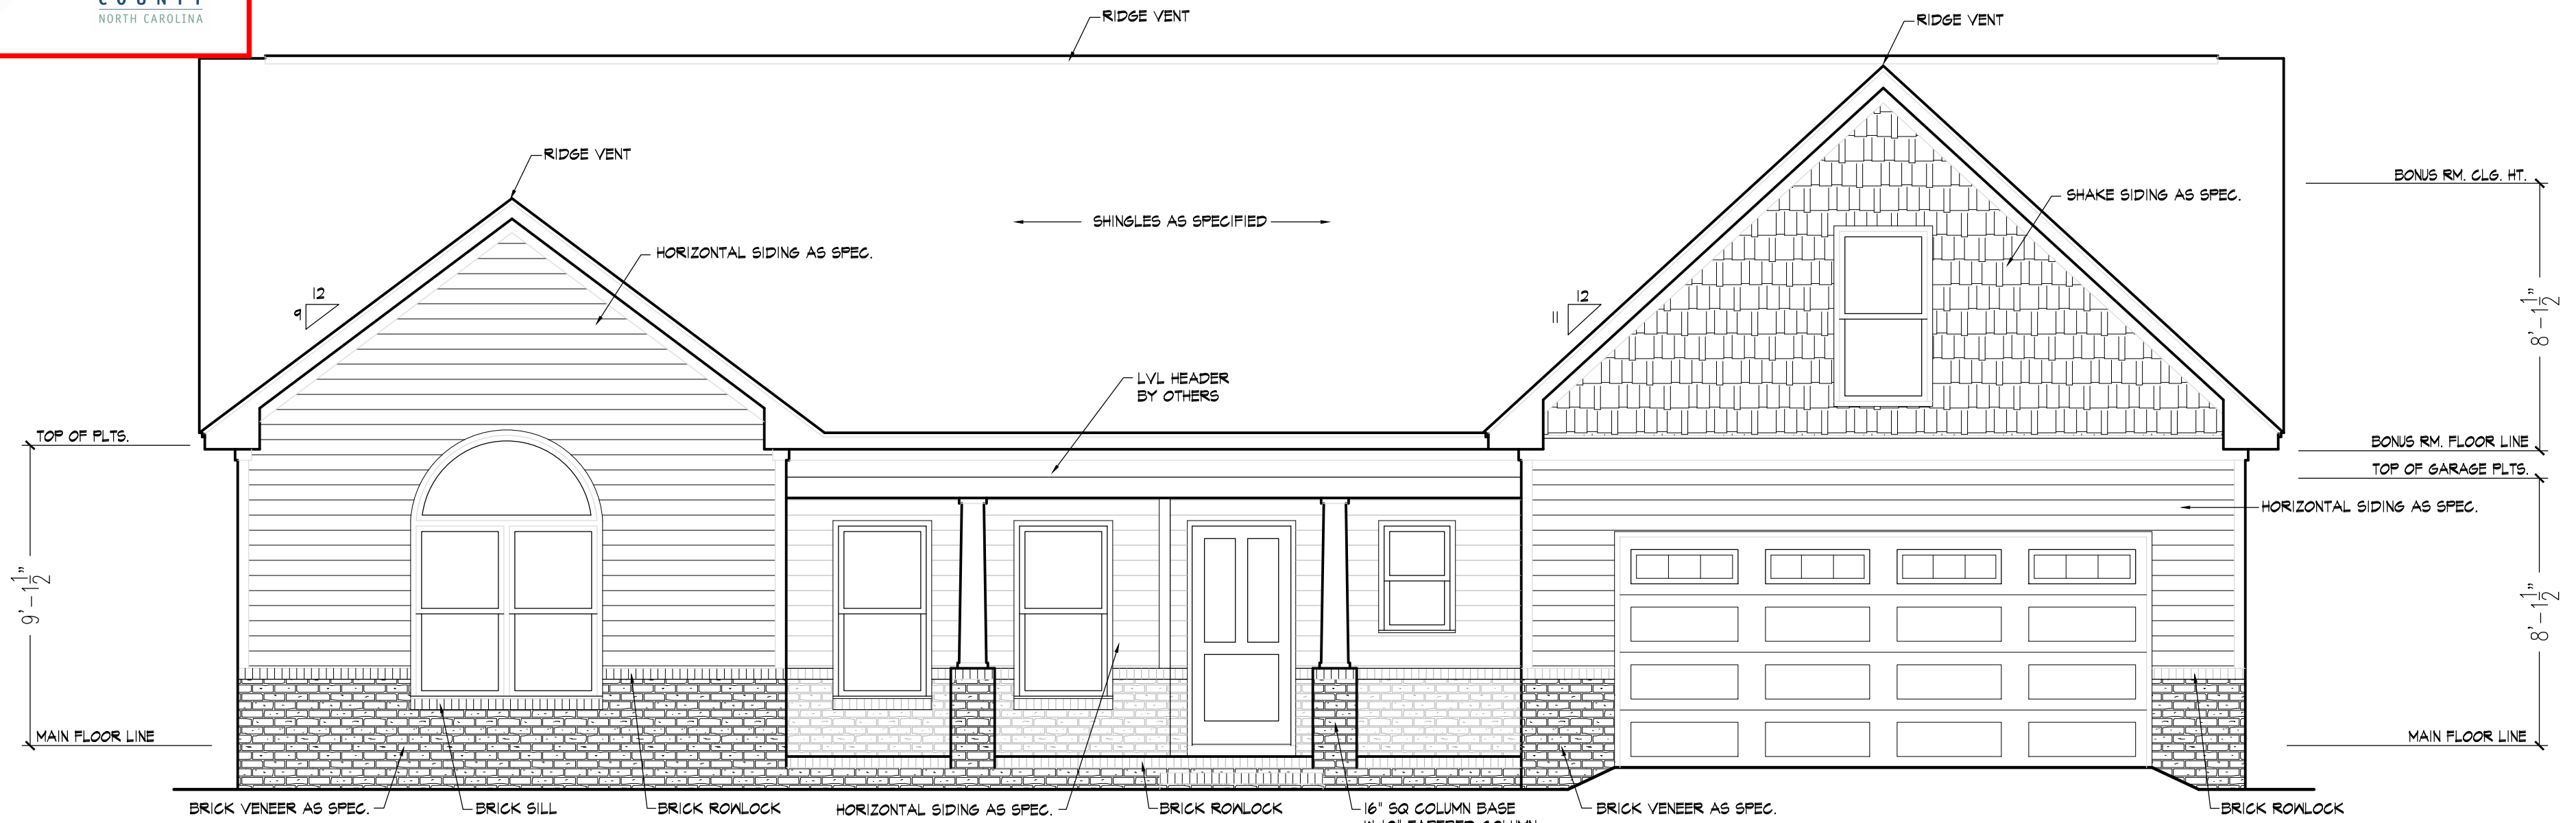


NOTICE TO CONTRACTOR
All construction must comply with current NC Building Codes and is subject to field inspection and verification.


APPROVED
Limited building only review
Permit holder responsible for full compliance with the code

10/12/2020


101 Front Elevation

Scale: 1/4" = 1'-0"

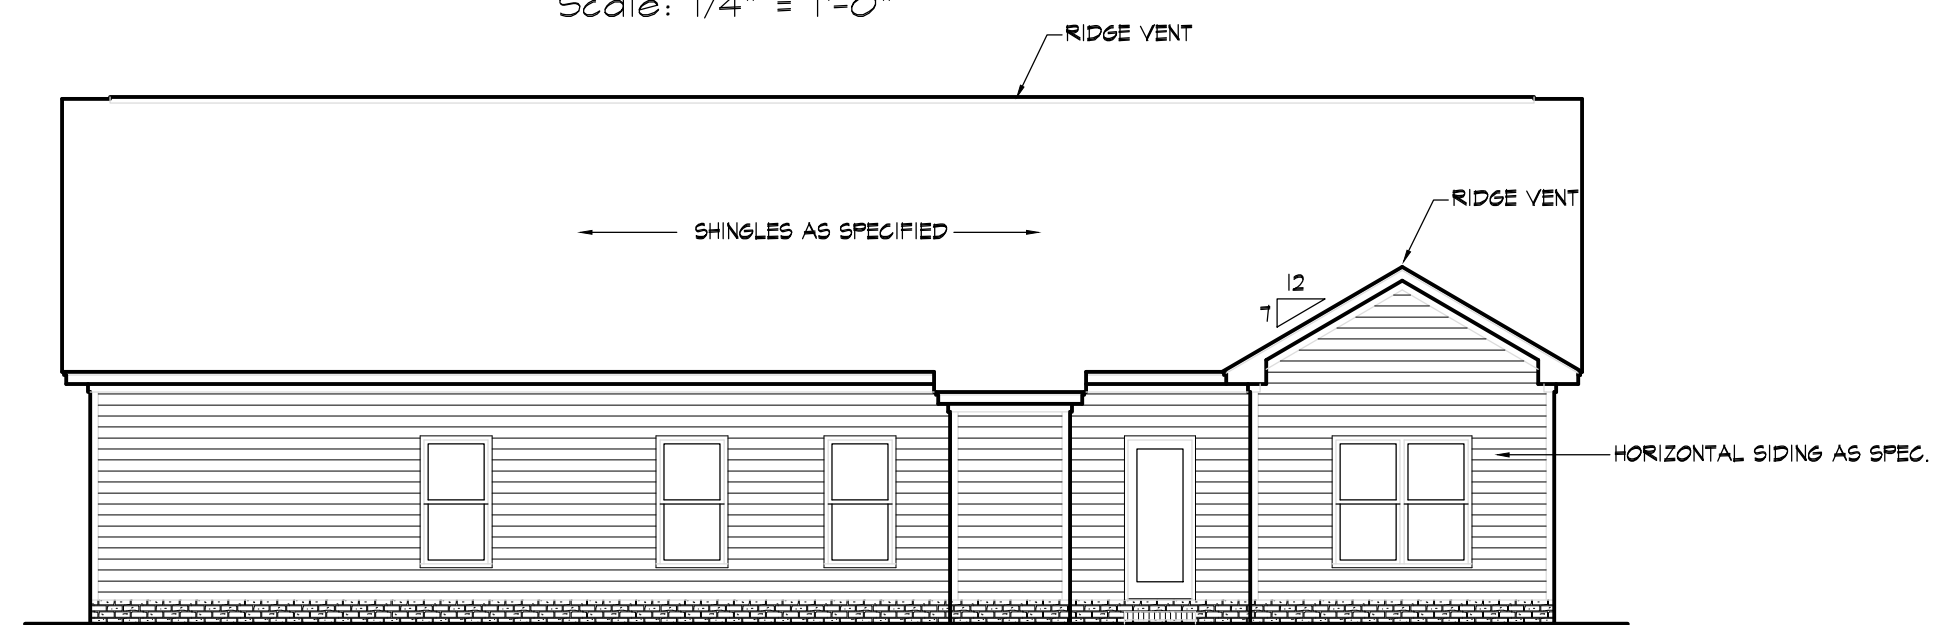


102 Rear Elevation

Scale: 1/8" = 1'-0"

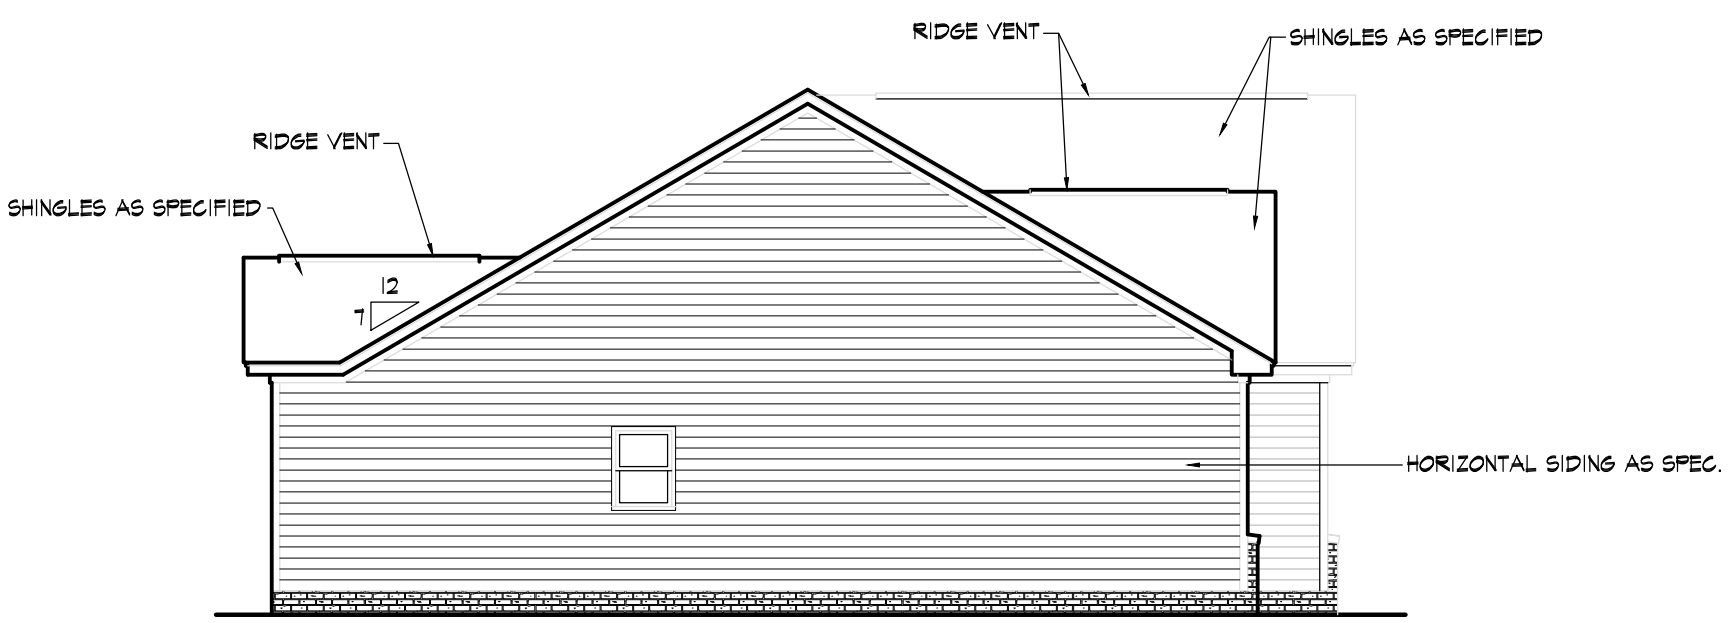

103 Left Elevation

Scale: 1/8" = 1'-0"

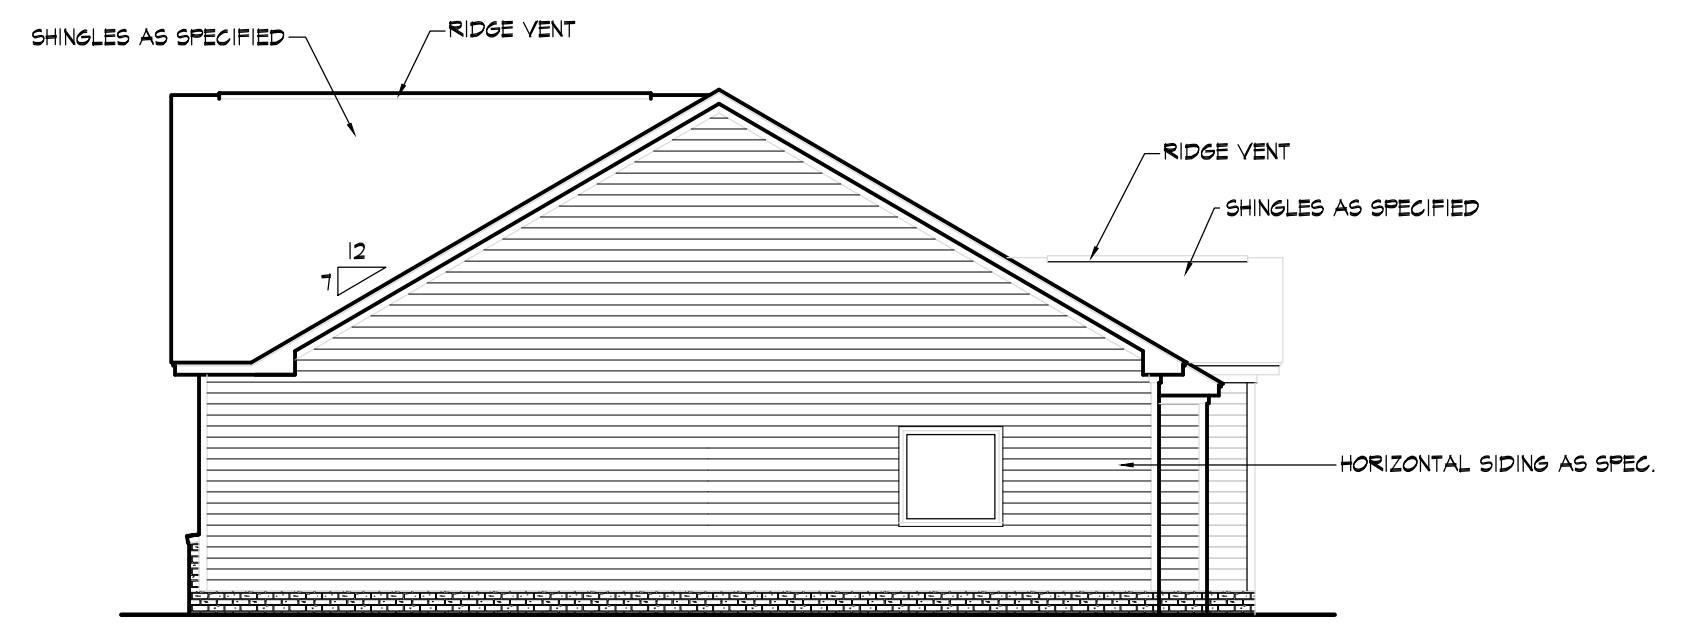

104 Right Elevation

Scale: 1/8" = 1'-0"

| Area Tabulations | |
|------------------|--------------|
| Main Floor Htd. | 1723 SQ. FT. |
| Bonus Room Htd. | 264 SQ. FT. |
| Total Htd. | 1987 SQ. FT. |
| Garage | 495 SQ. FT. |
| Front Porch | 143 SQ. FT. |
| Total Unhtd. | 638 SQ. FT. |
| Total Area | 2625 SQ. FT. |

Project Title
The Lindsay


Sheet Title

Exterior Elevations

Revisions


Scale:
as shown
Date:
November 2019

Sheet No.
|

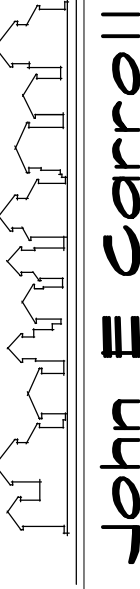

John E Carroll
Residential Design

844 montclair road, fayetteville, nc 28314
johnecarroll.design@gmail.com
910.850.9408

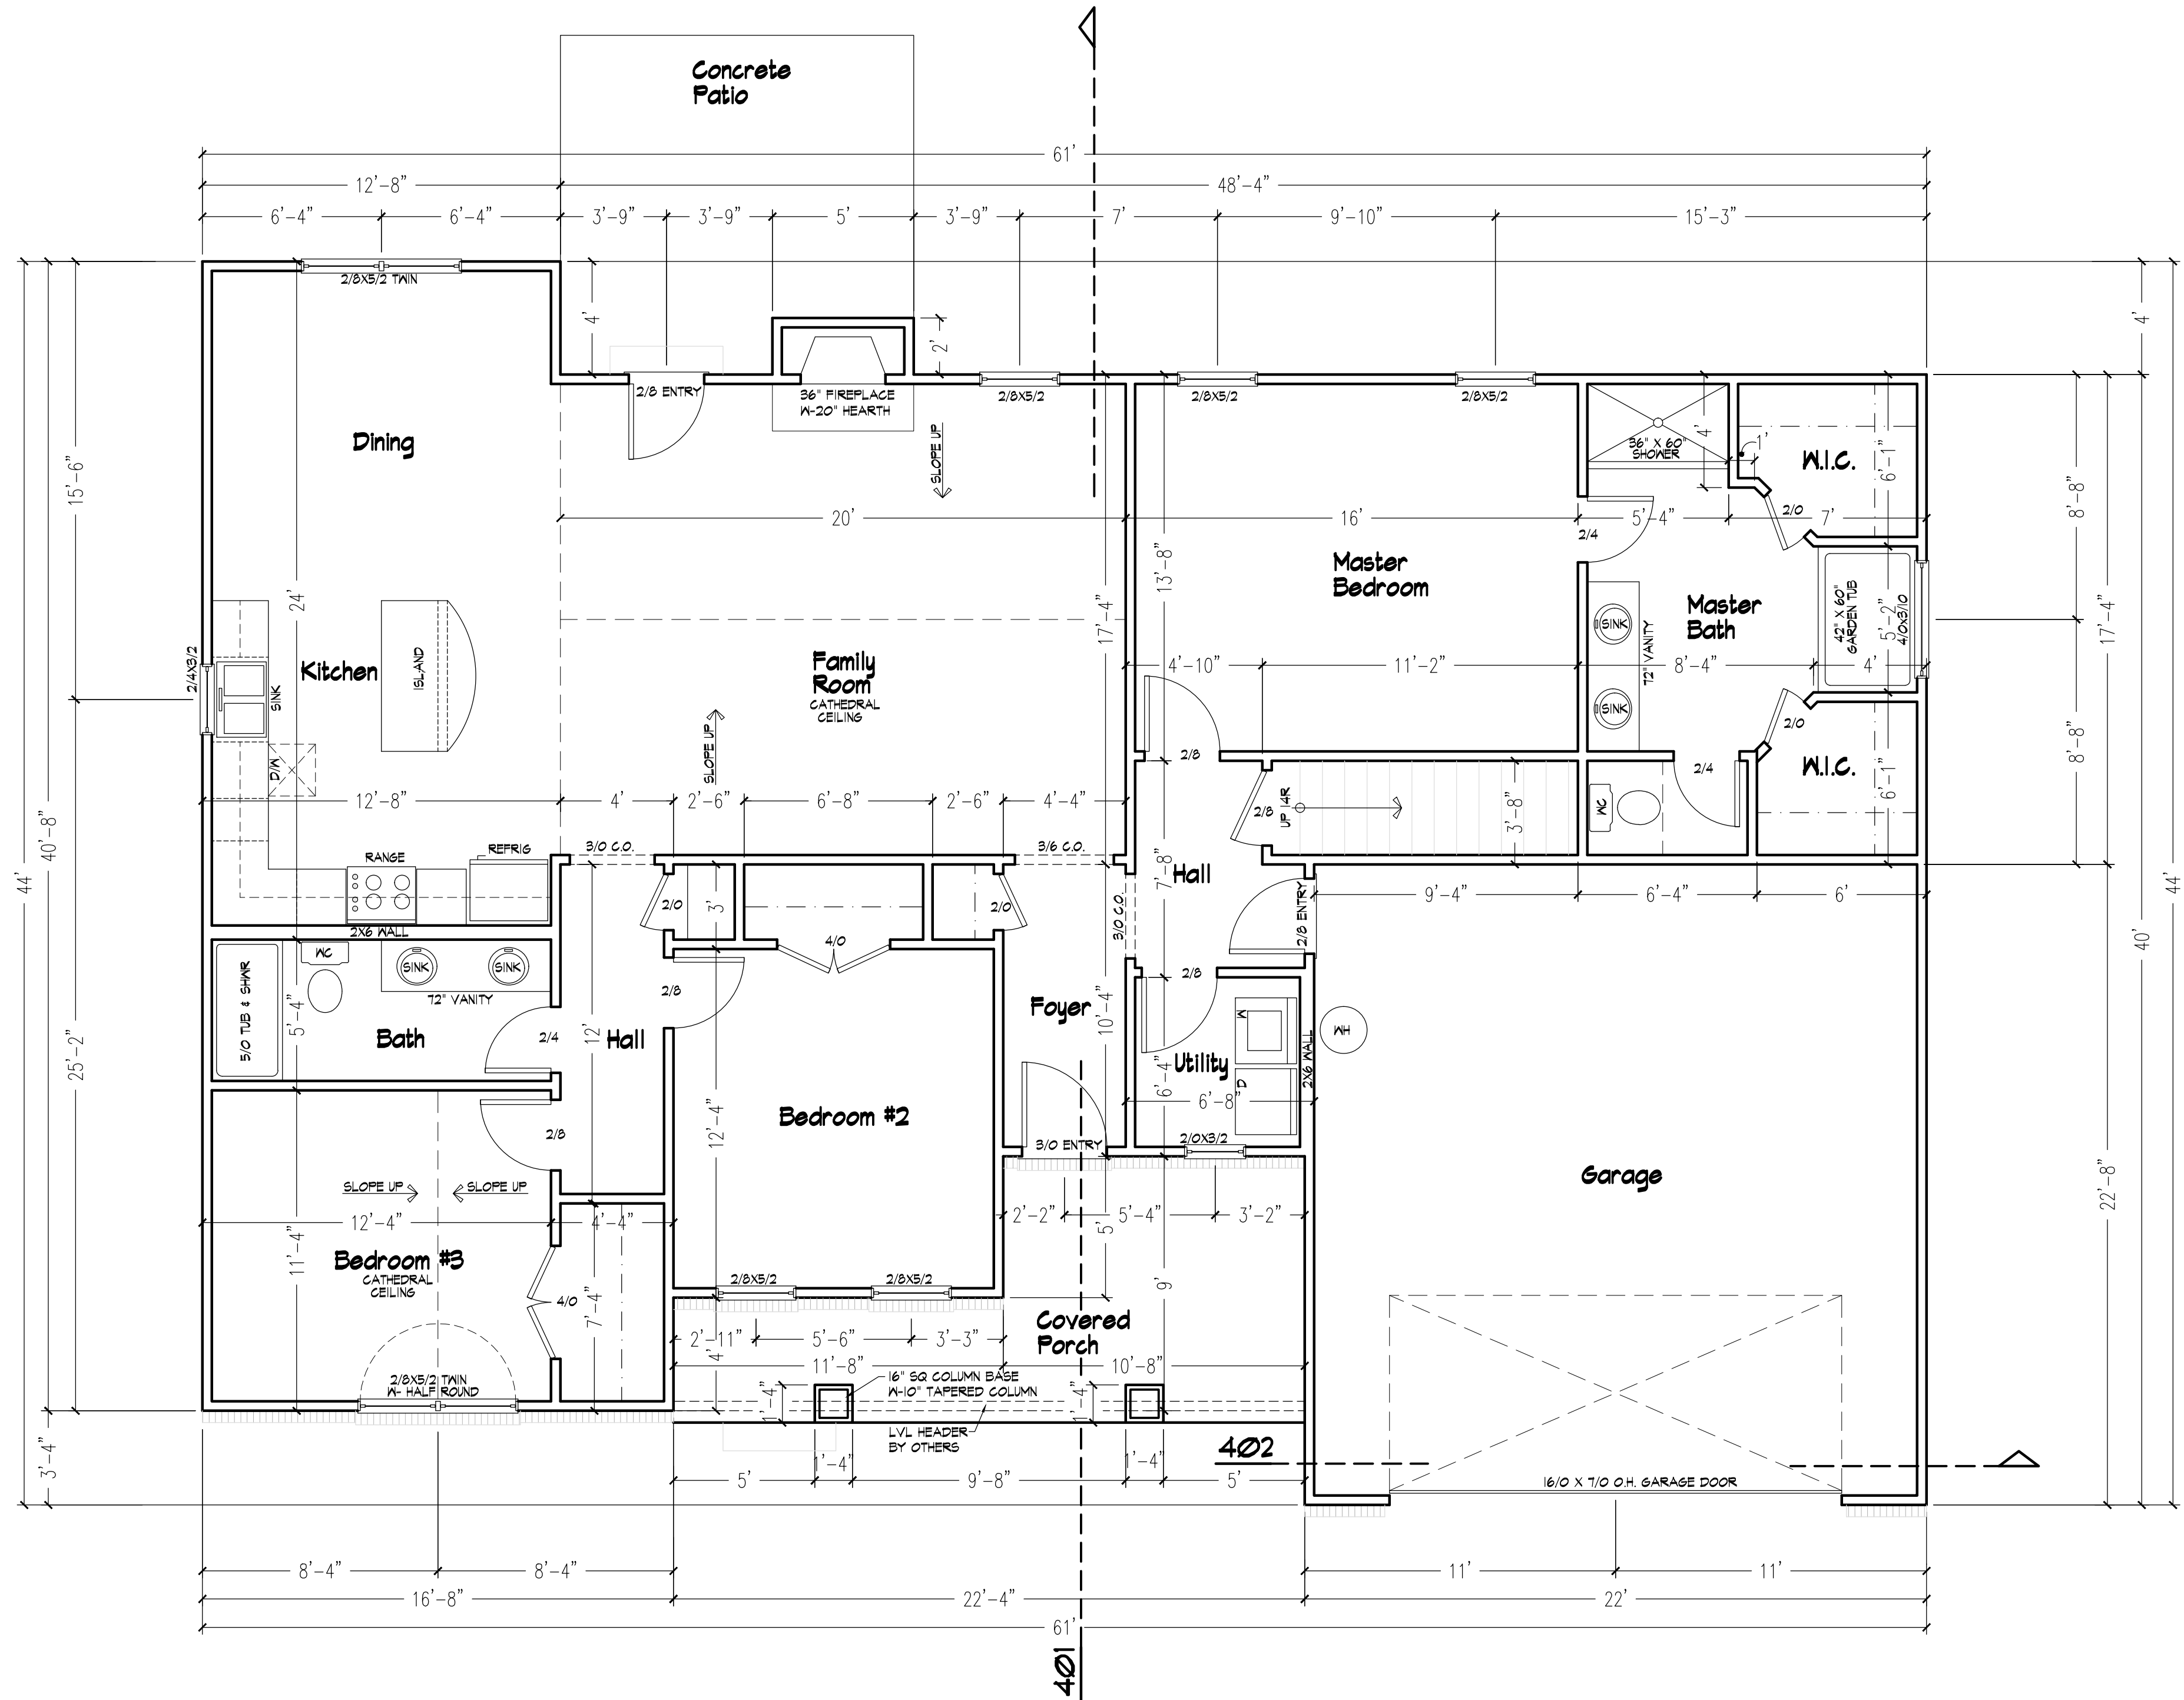


201 Main Floor Plan
 Scale: 1/4" = 1'-0"


Revisions

Scale:
 as shown
 Date:
 November 2019

Sheet No.
2

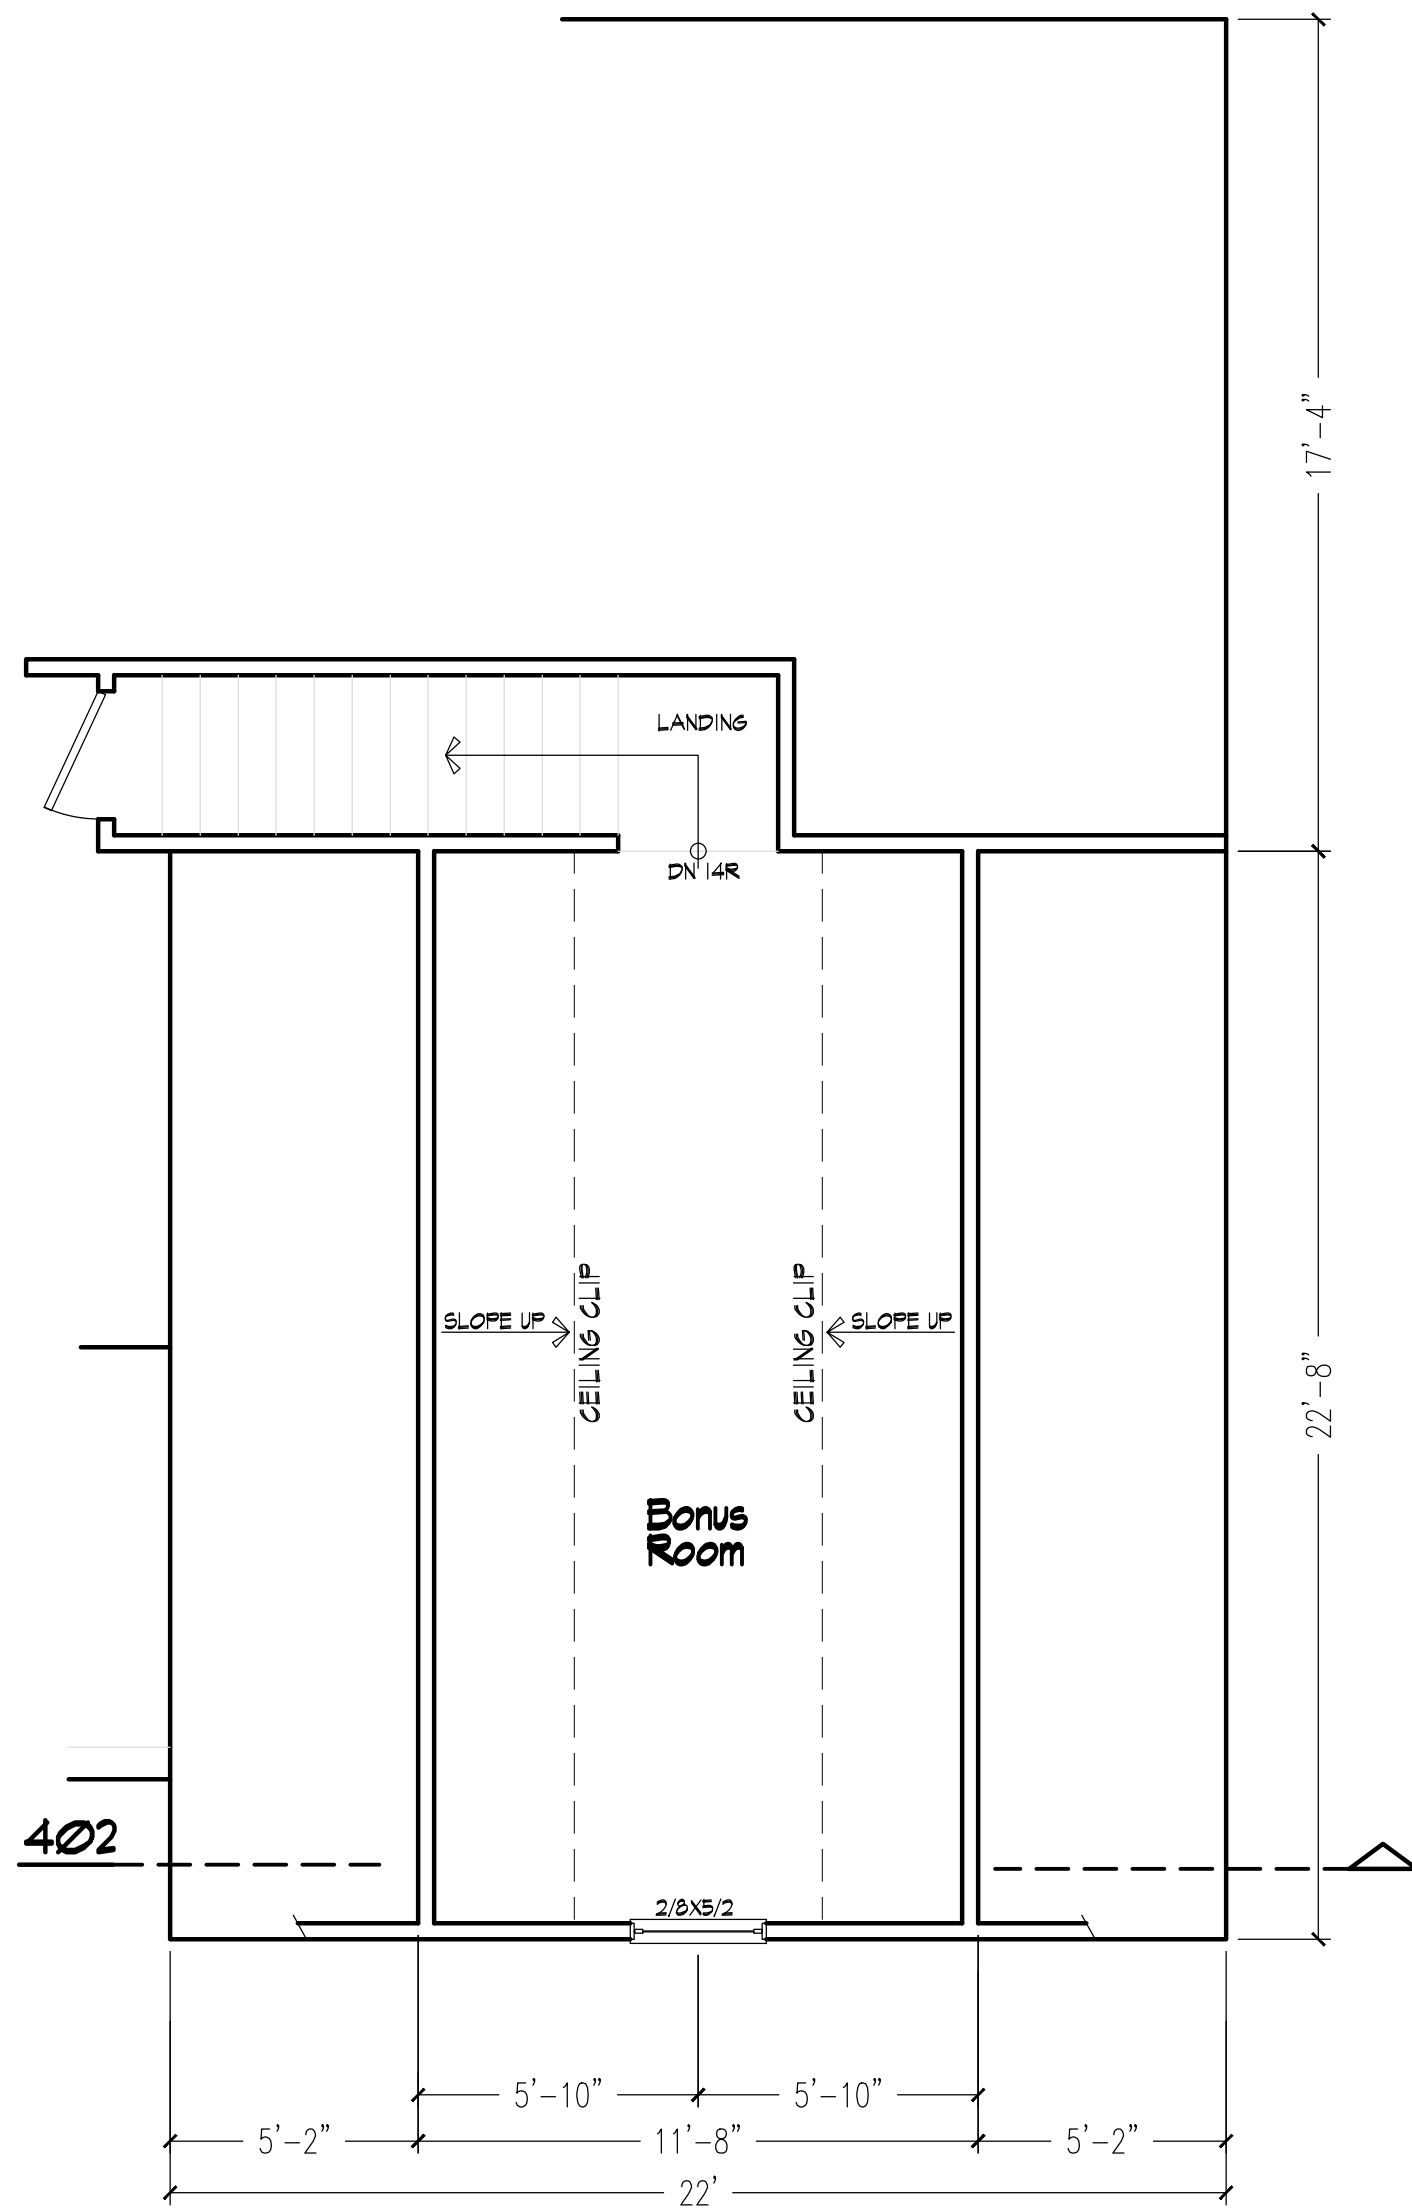

301 Bonus Room Floor Plan
Scale: 1/4" = 1'-0"

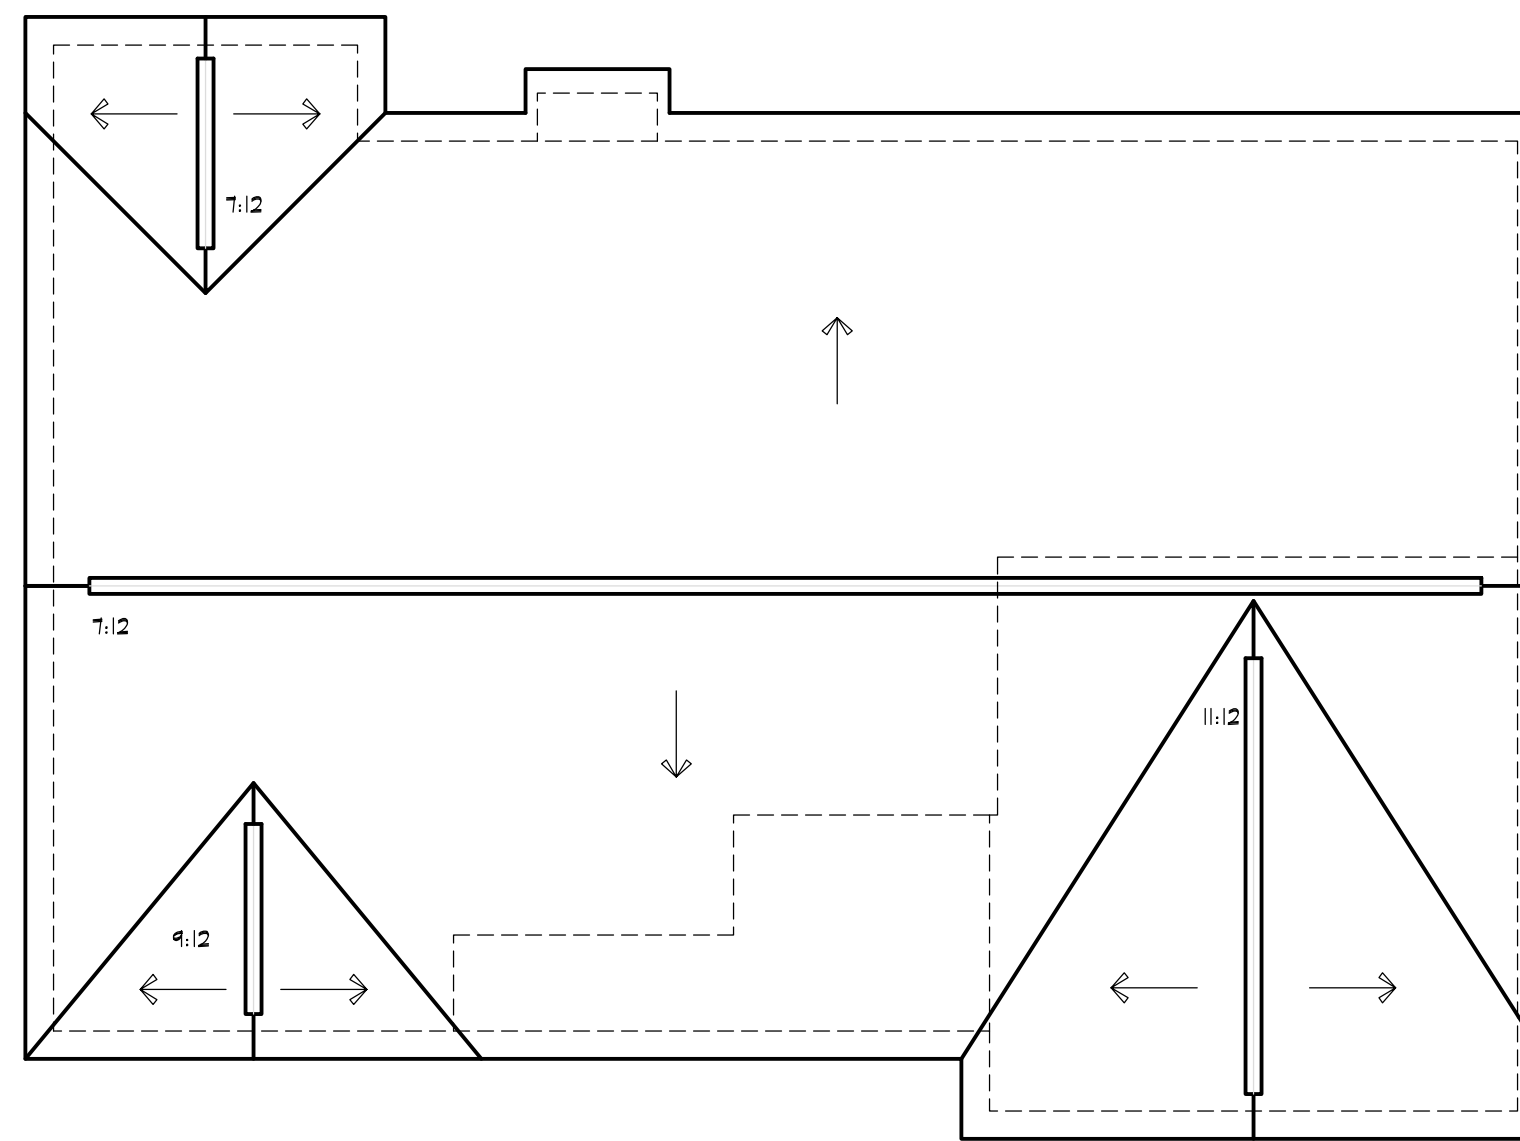


302 Roof Plan
Scale: 1/8" = 1'-0"


Revisions

Scale:
 as shown
 Date:
 November 2019


Sheet No.
3

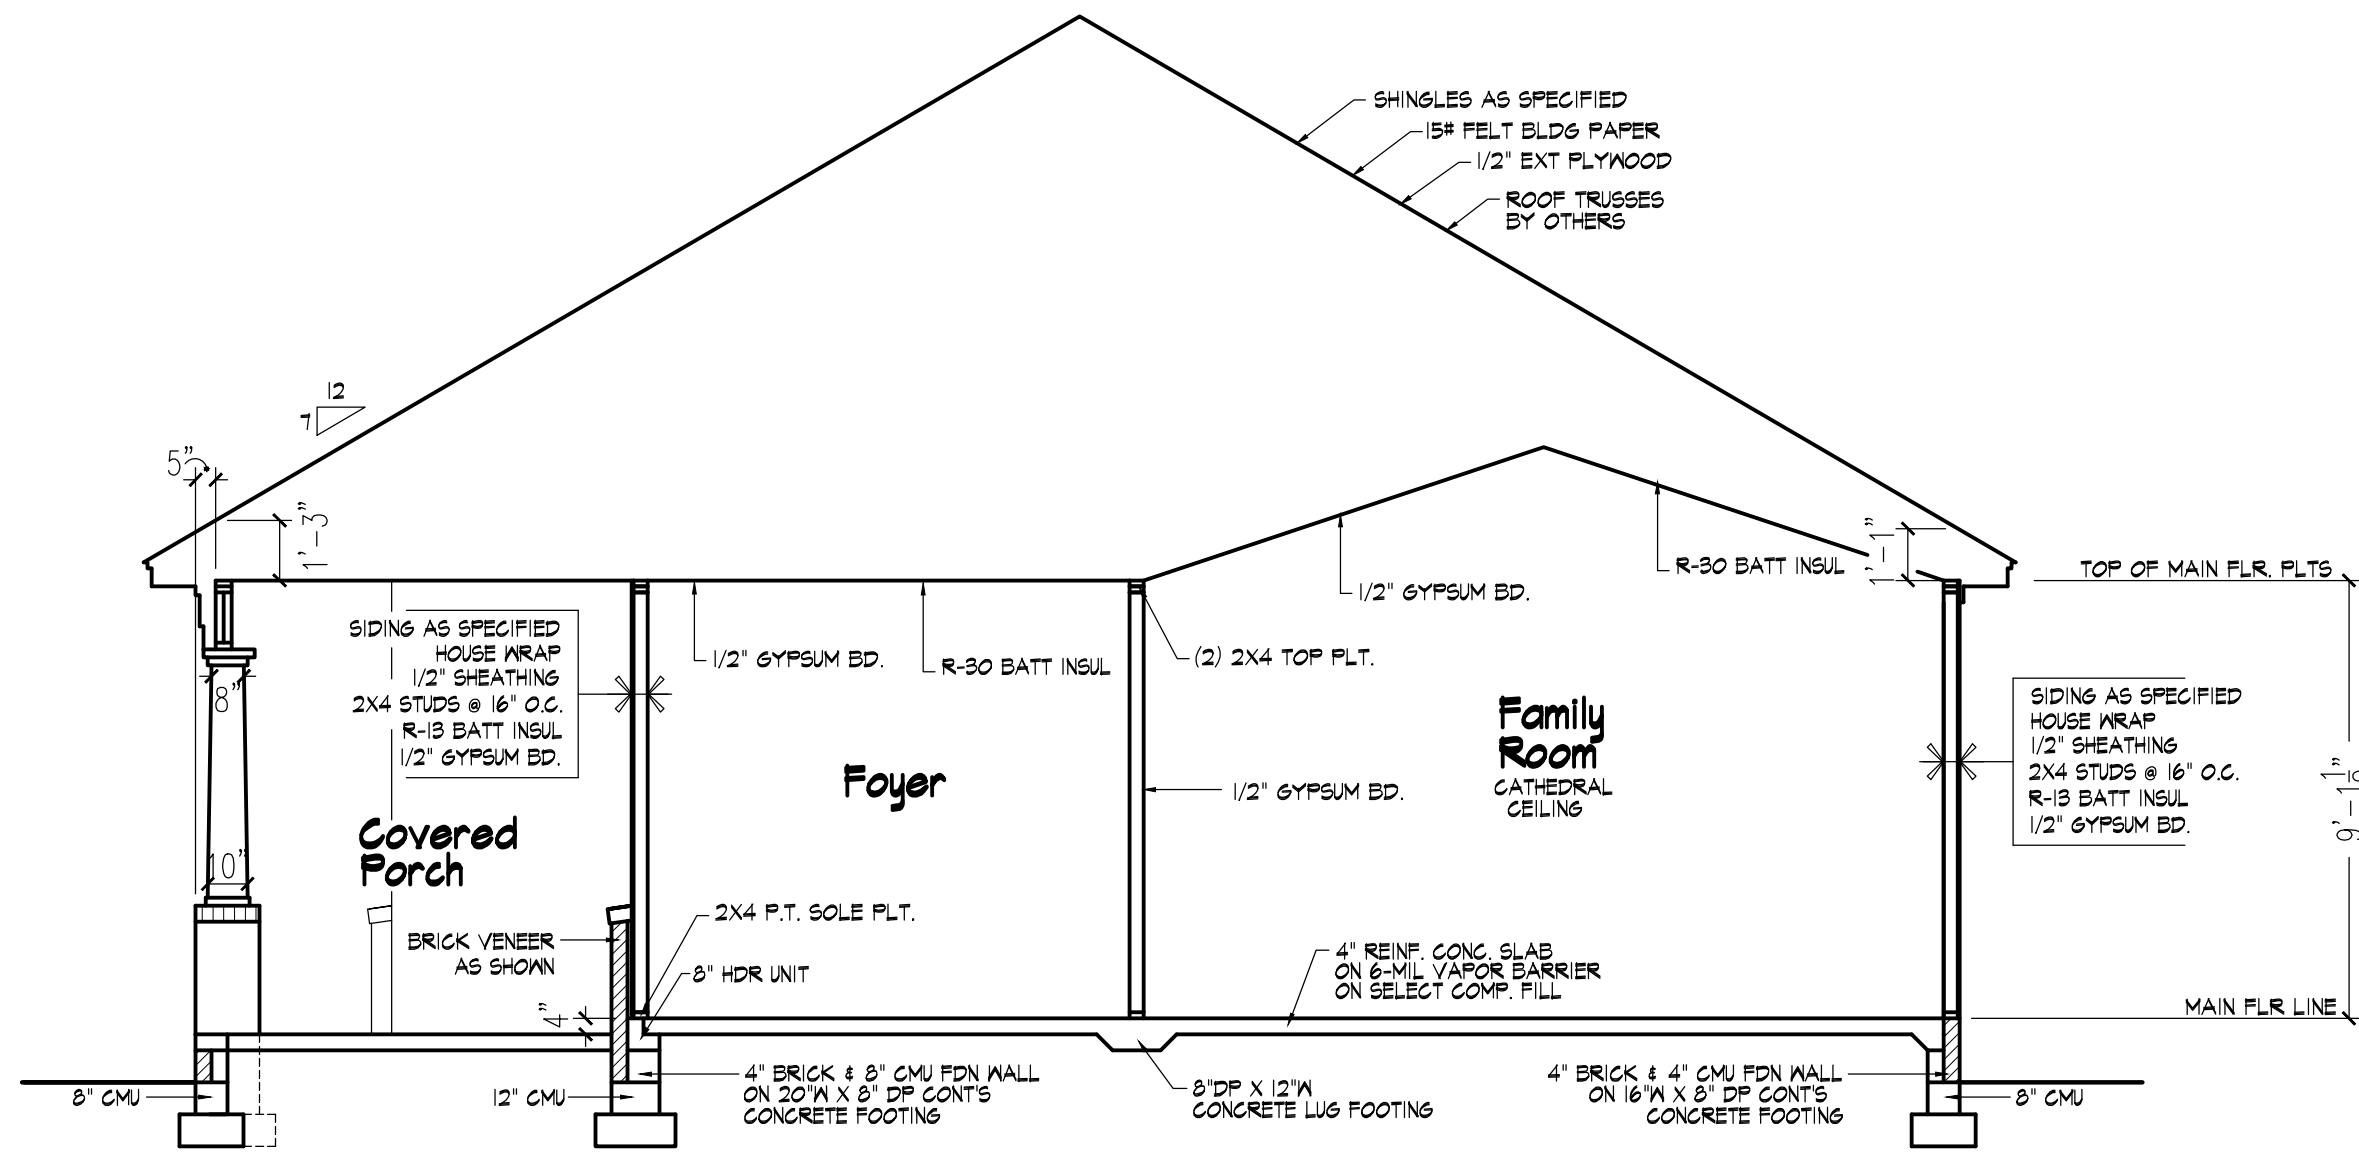

401 Building Section
Scale 1/4" = 1'-0"

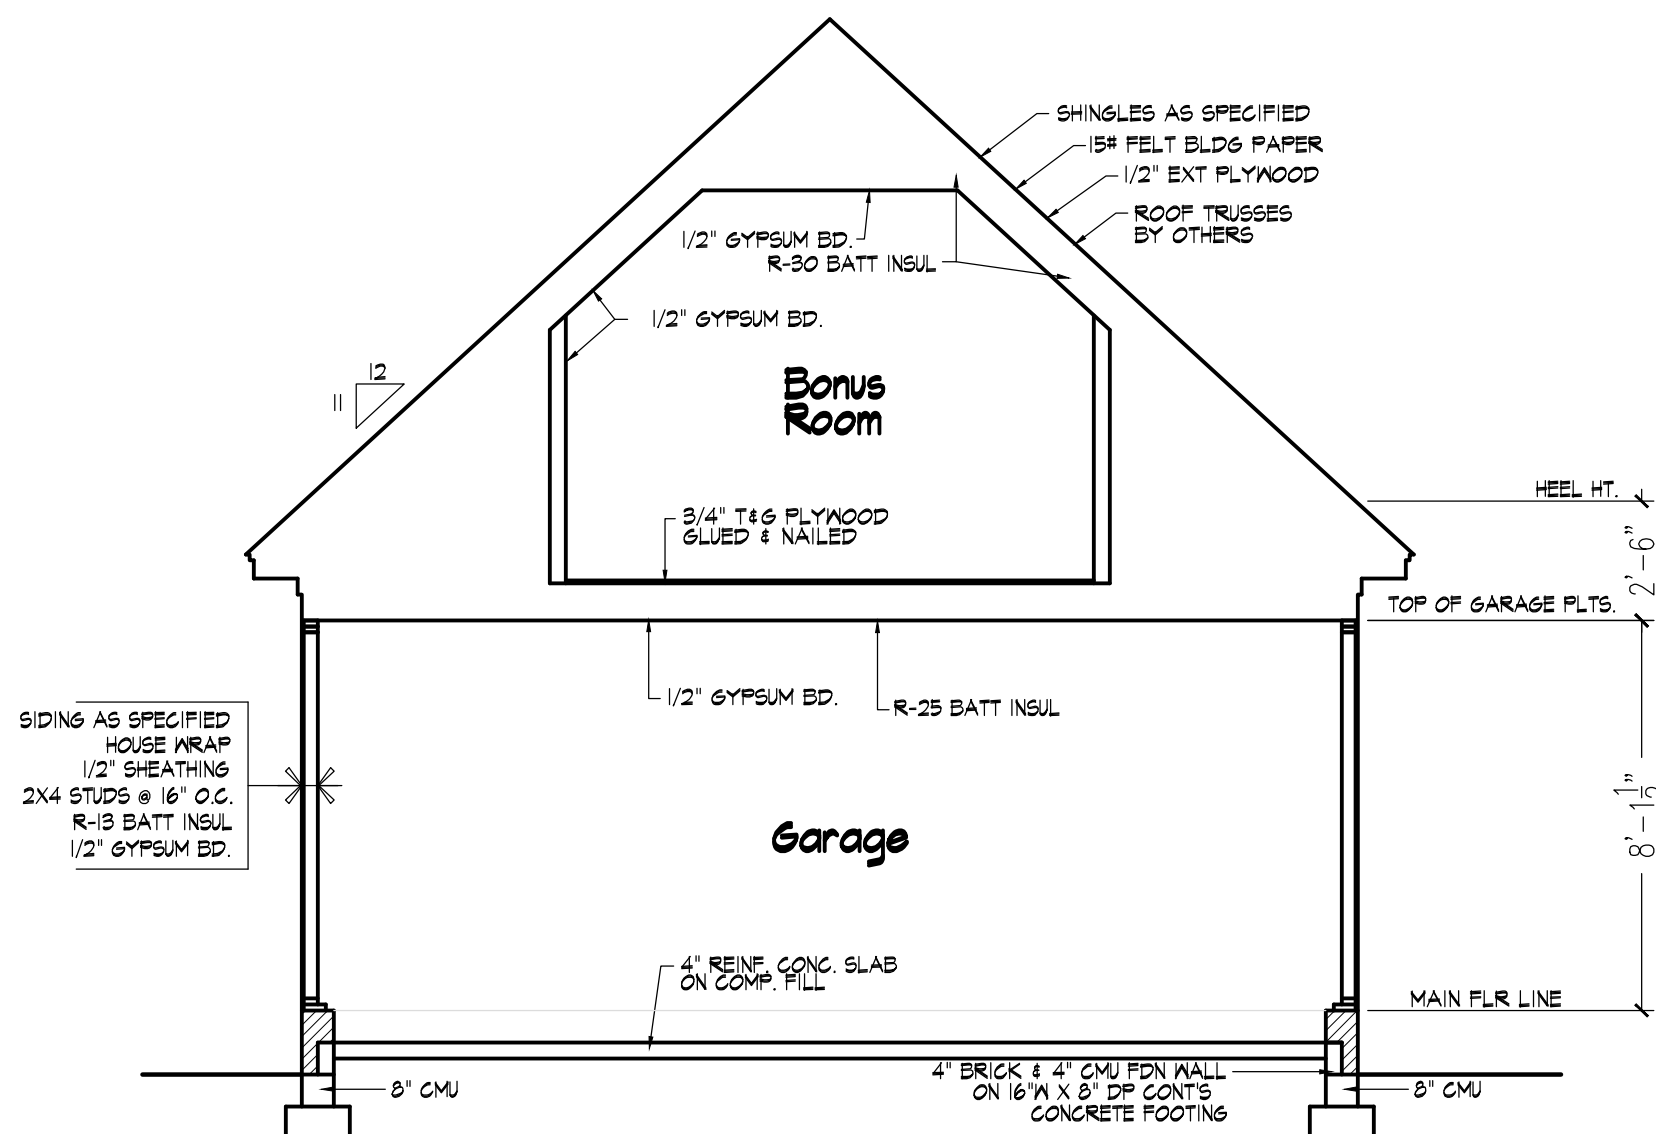

402 Building Section
Scale 1/4" = 1'-0"

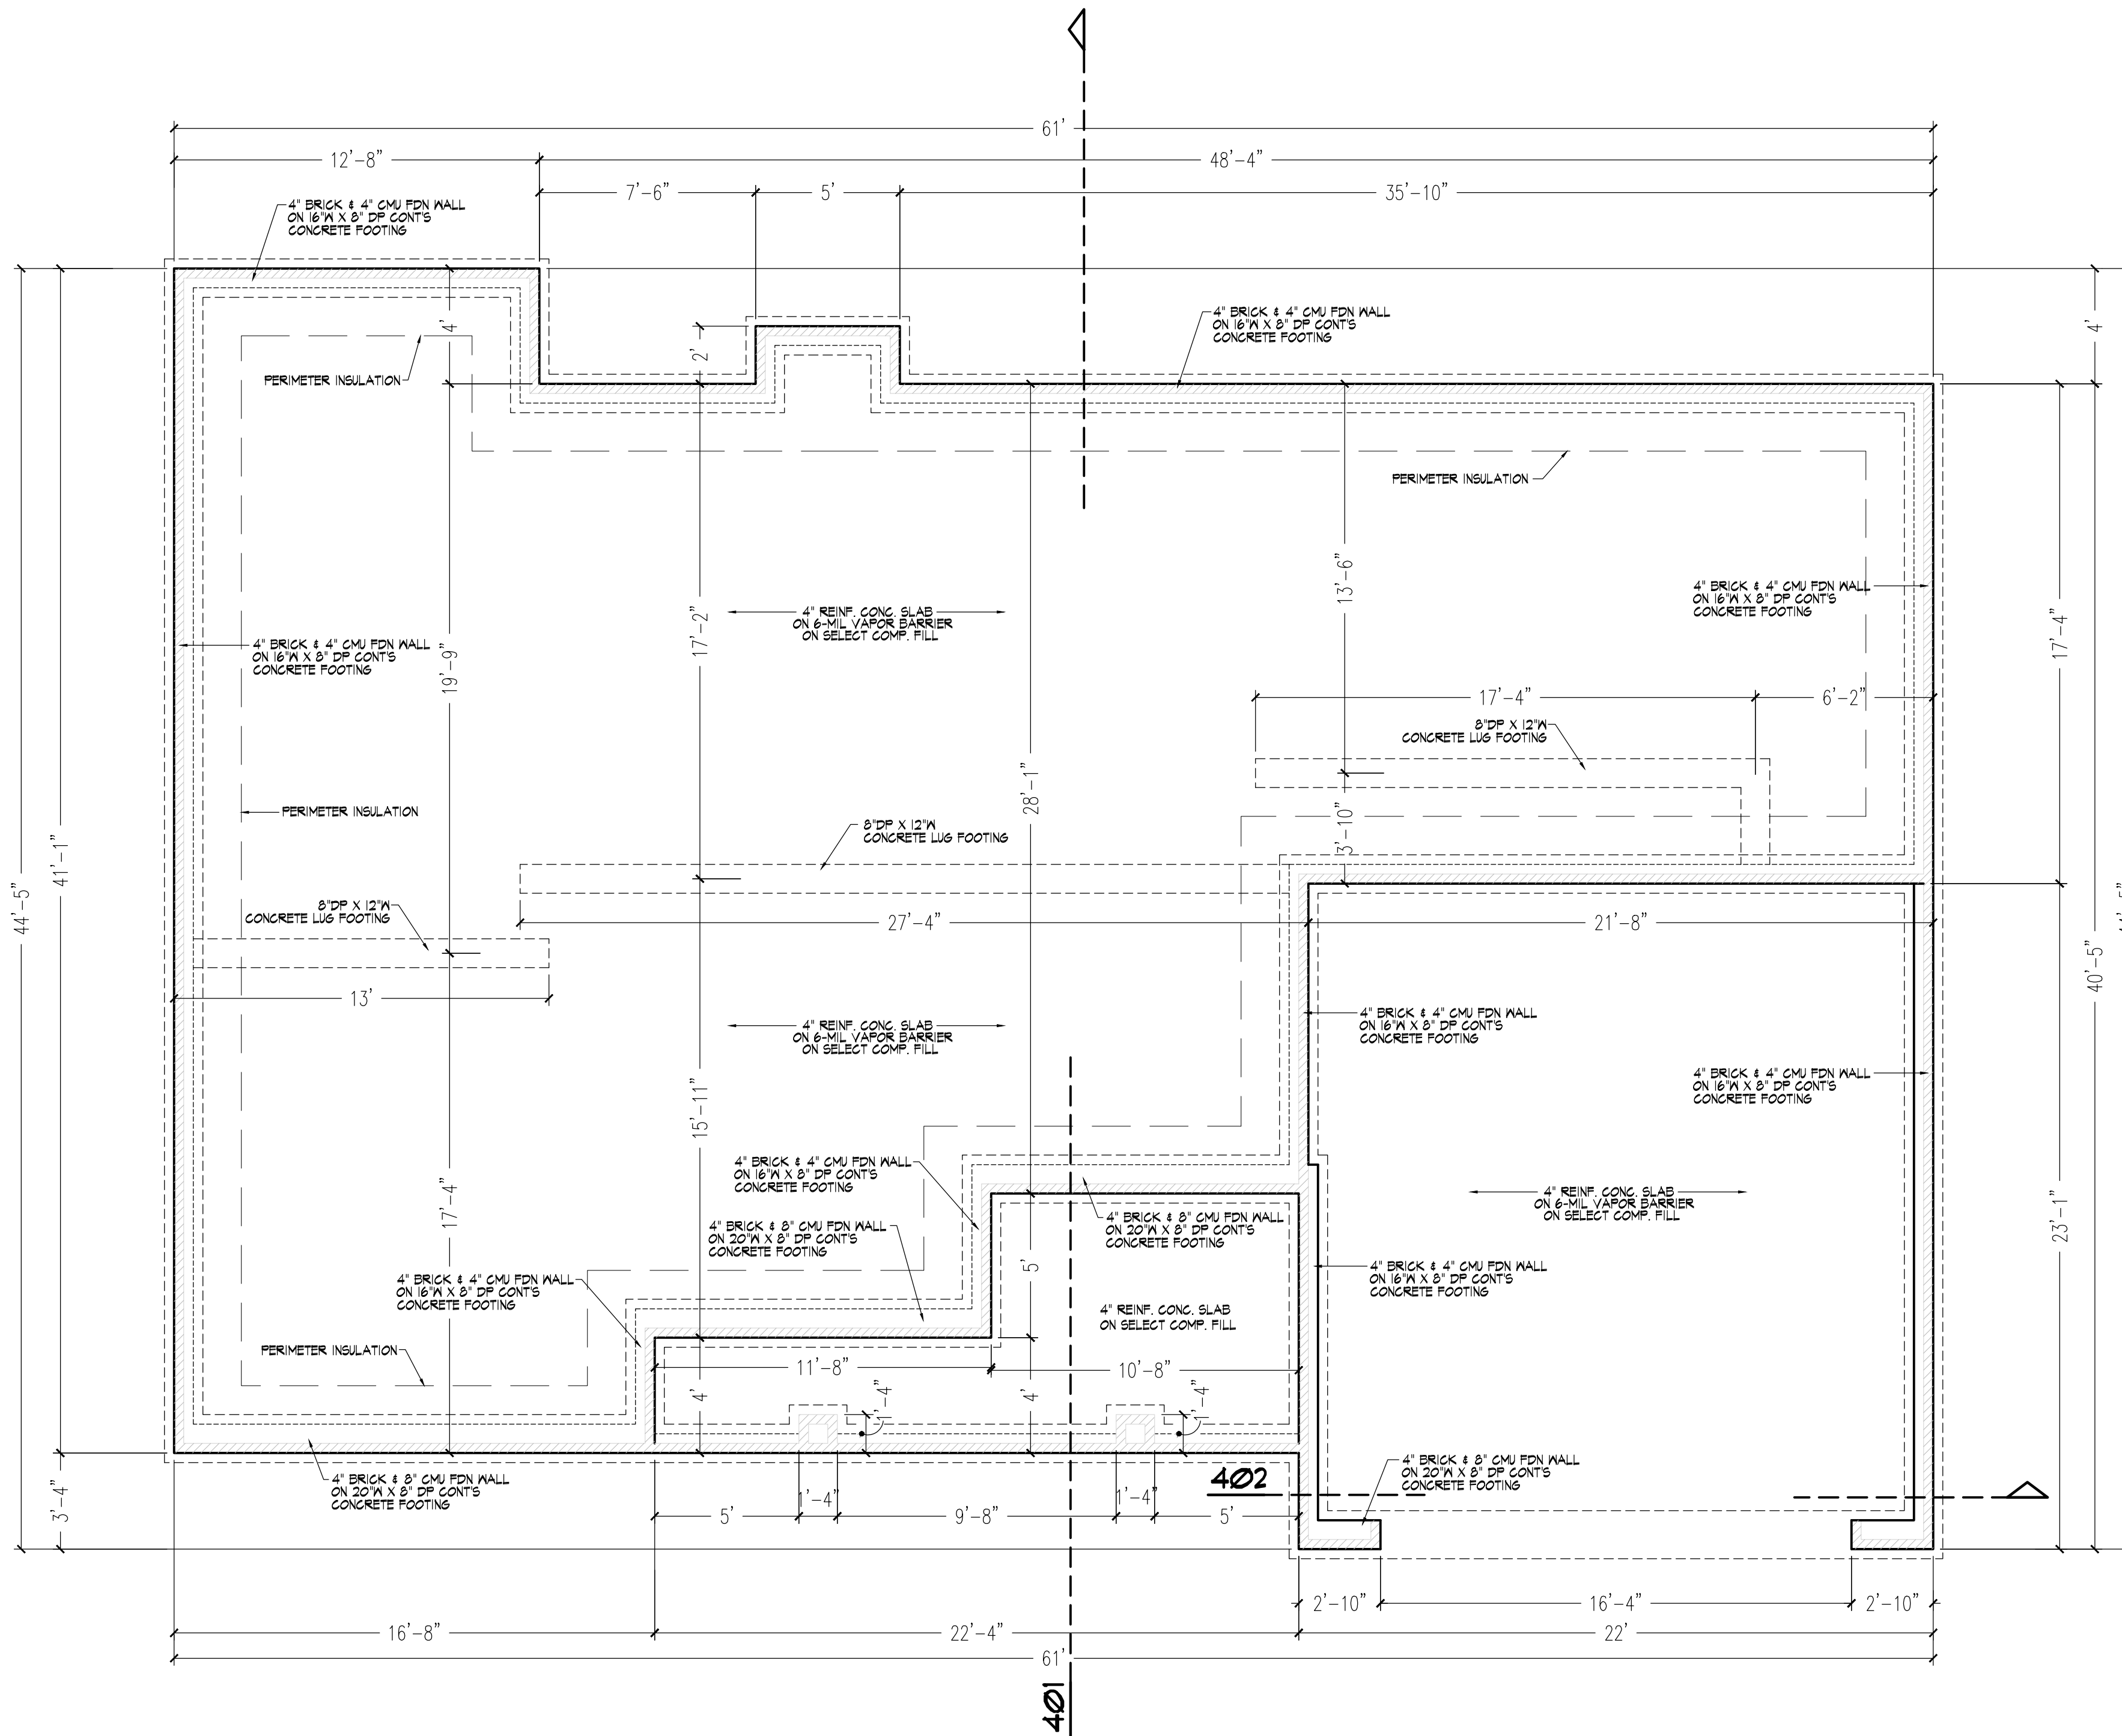

501 Foundation Plan
 Scale: 1/4" = 1'-0"

Revisions

Scale:
 as shown
 Date:
 November 2019


Sheet No.
5

Revisions


Scale:
 as shown
 Date:
 November 2019

Sheet No.
6

| ELECTRICAL SYMBOLS | |
|--------------------|---|
| | TYPICAL WALL RECEPTACLE |
| | 110 V - 42" AFF |
| | HALF HOT AND HALF SWITCHED |
| | WATERPROOF RECEPTACLE |
| | 110 V - GROUND FAULT |
| | 220 V OUTLET |
| | 110 V OUTLET - FLOOR MOUNT CEILING RECEPTACLE |
| | TOUCH - PAD |
| | TYPICAL SWITCH |
| | 3 WAY OR MORE (SEE PLAN) |
| | DIMMER SWITCH |
| | LIGHT - WALL MOUNT |
| | LIGHT - CEILING MOUNT |
| | RECESSED LIGHT |
| | EXHAUST FAN |
| | LIGHT - FAN COMBINATION |
| | FLOOD LIGHTS |
| | FLOURESCENT TUBE |
| | FLOURESCENT LIGHT FIXTURE |
| | CLG. FAN |
| | PHONE JACK |
| | TV CABLE JACK |
| | MASTER FLOOD LIGHT SWITCH |

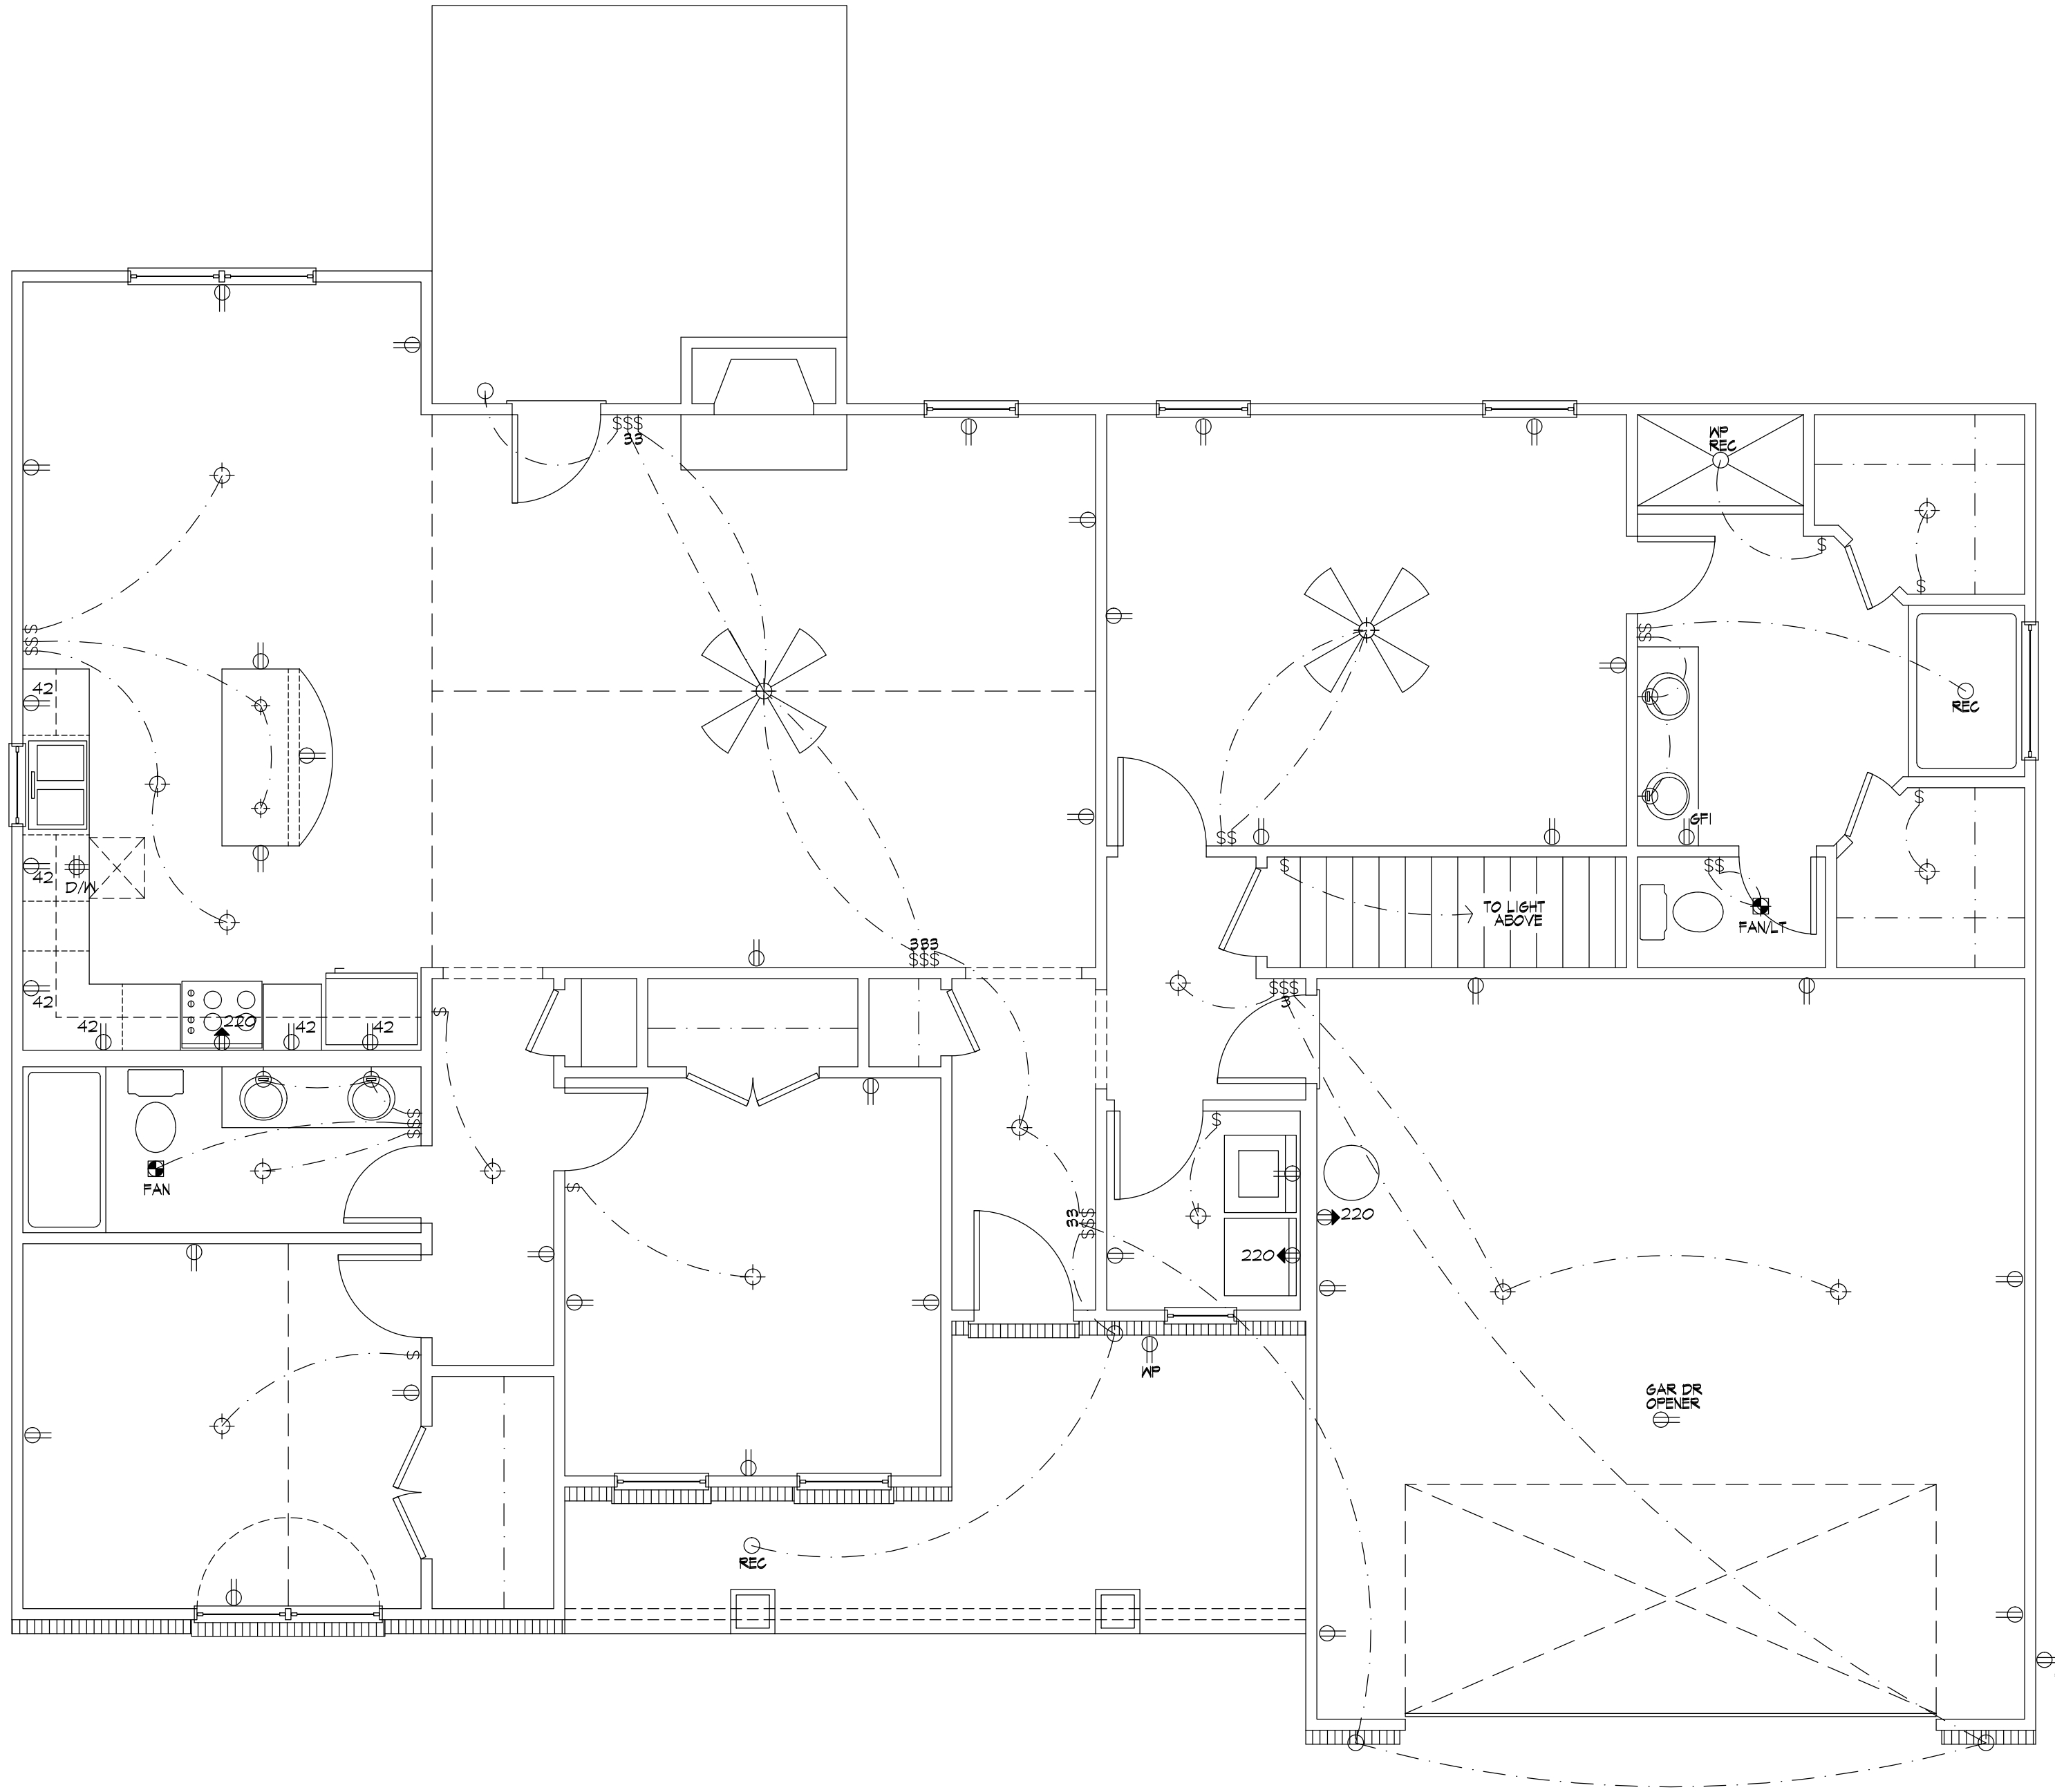

601 Main Floor Electrical Plan
 Scale: 1/4" = 1'-0"

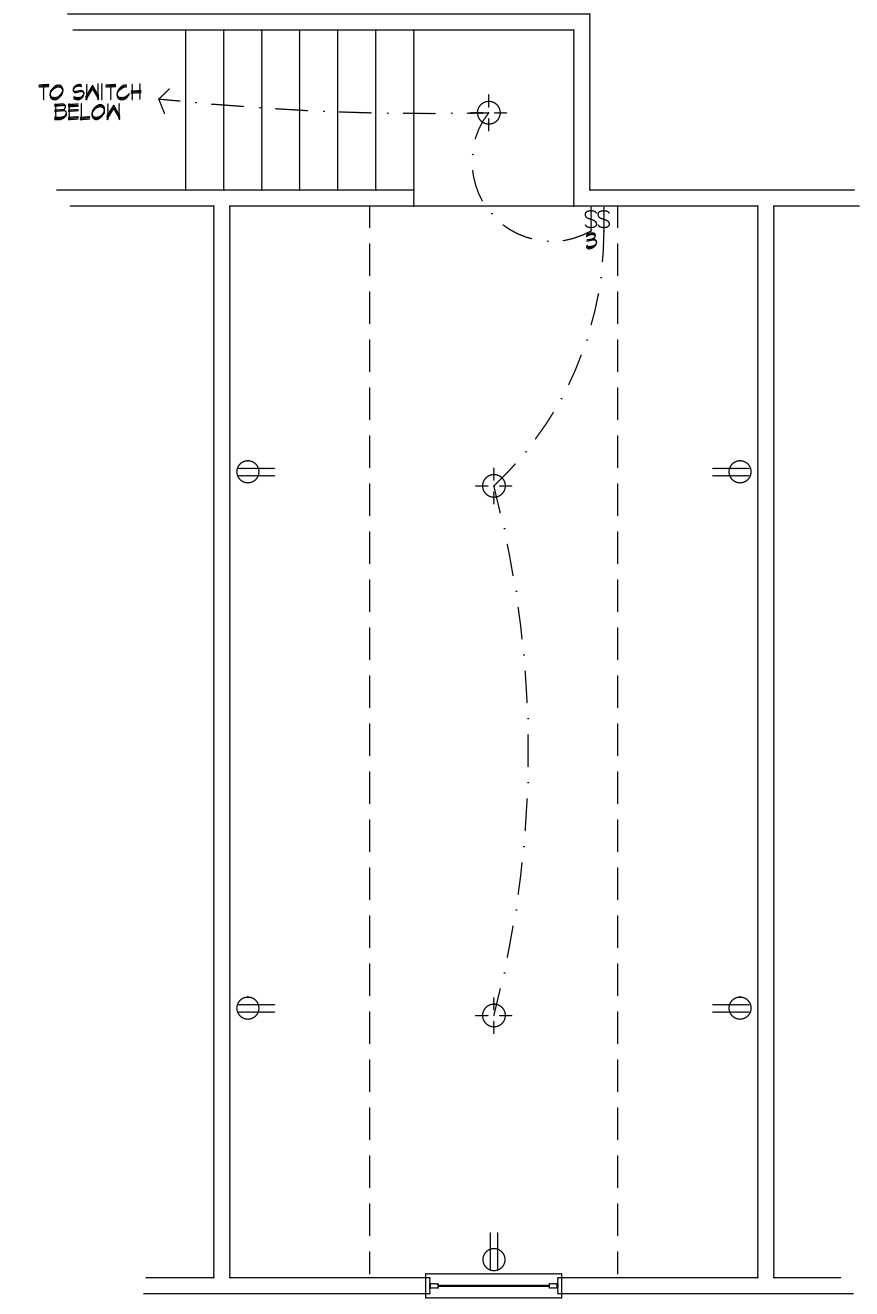

Bonus Room 602 Electrical Floor Plan
 Scale: 1/4" = 1'-0"



ROOF & FLOOR TRUSSES & BEAMS

Reilly Road Industrial Park
Fayetteville, N.C. 28309
Phone: (910) 864-8787
Fax: (910) 864-4444

Bearing reactions less than or equal to 3000# are deemed to comply with the prescriptive Code requirements. The contractor shall refer to the attached Tables (derived from the prescriptive Code requirements) to determine the minimum foundation size and number of wood studs required to support reactions greater than 3000# but not greater than 15000#. A registered design professional shall be retained to design the support system for any reaction that exceeds those specified in the attached Tables. A registered design professional shall be retained to design the support system for all reactions that exceed 15000#.

Signature Curtis Quick
Curtis Quick


LOAD CHART FOR JACK STUDS

(BASED ON TABLES ROU11C, 12, 13)
NUMBER OF JACK STUDS REQUIRED @ EA END OF HEADERS/STROPS

| END REACTION (IP / TON) | REQ'D STUDS FOR EACH END OF HEADERS/STROPS | END REACTION (IP / TON) | REQ'D STUDS FOR EACH END OF HEADERS/STROPS | END REACTION (IP / TON) | REQ'D STUDS FOR EACH END OF HEADERS/STROPS |
|-------------------------|--|-------------------------|--|-------------------------|--|
| 1700 | 1 | 2550 | 1 | 3400 | 1 |
| 3400 | 2 | 5100 | 2 | 6800 | 2 |
| 5100 | 3 | 7650 | 3 | 10200 | 3 |
| 6800 | 4 | 10200 | 4 | 13600 | 4 |
| 8500 | 5 | 12750 | 5 | 17000 | 5 |
| 10200 | 6 | 15300 | 6 | | |
| 11900 | 7 | | | | |
| 13600 | 8 | | | | |
| 15300 | 9 | | | | |

| BUILDER | WELCO CONTRACTORS | CITY / CO. | HARNETT CO. / HARNETT |
|-----------|--------------------|------------|-----------------------|
| JOB NAME | Lot 59 Happy Acres | ADDRESS | Lot 59 Happy Acres |
| PLAN | The Lindsay | MODEL | Model |
| SEAL DATE | Seal Date | DATE REV. | 09/24/20 |
| QUOTE # | Quote # | DRAWN BY | Curtis Quick |
| JOB # | J0920-4402 | SALES REP. | Lenny Norris |

THIS IS A TRUSS PLACEMENT DIAGRAM ONLY. These trusses are designed as individual building components to be incorporated into the building design at the specification of the building designer. See individual design sheets for each truss design identified on the placement drawing. The building designer is responsible for temporary and permanent bracing of the roof and floor system and for the overall structure. The design of the truss support structure including headers, beams, walls, and columns is the responsibility of the building designer. For general guidance regarding bracing, consult BCSI-B1 and BCSI-B3 provided with the truss delivery package or online @ sbcindustry.com.

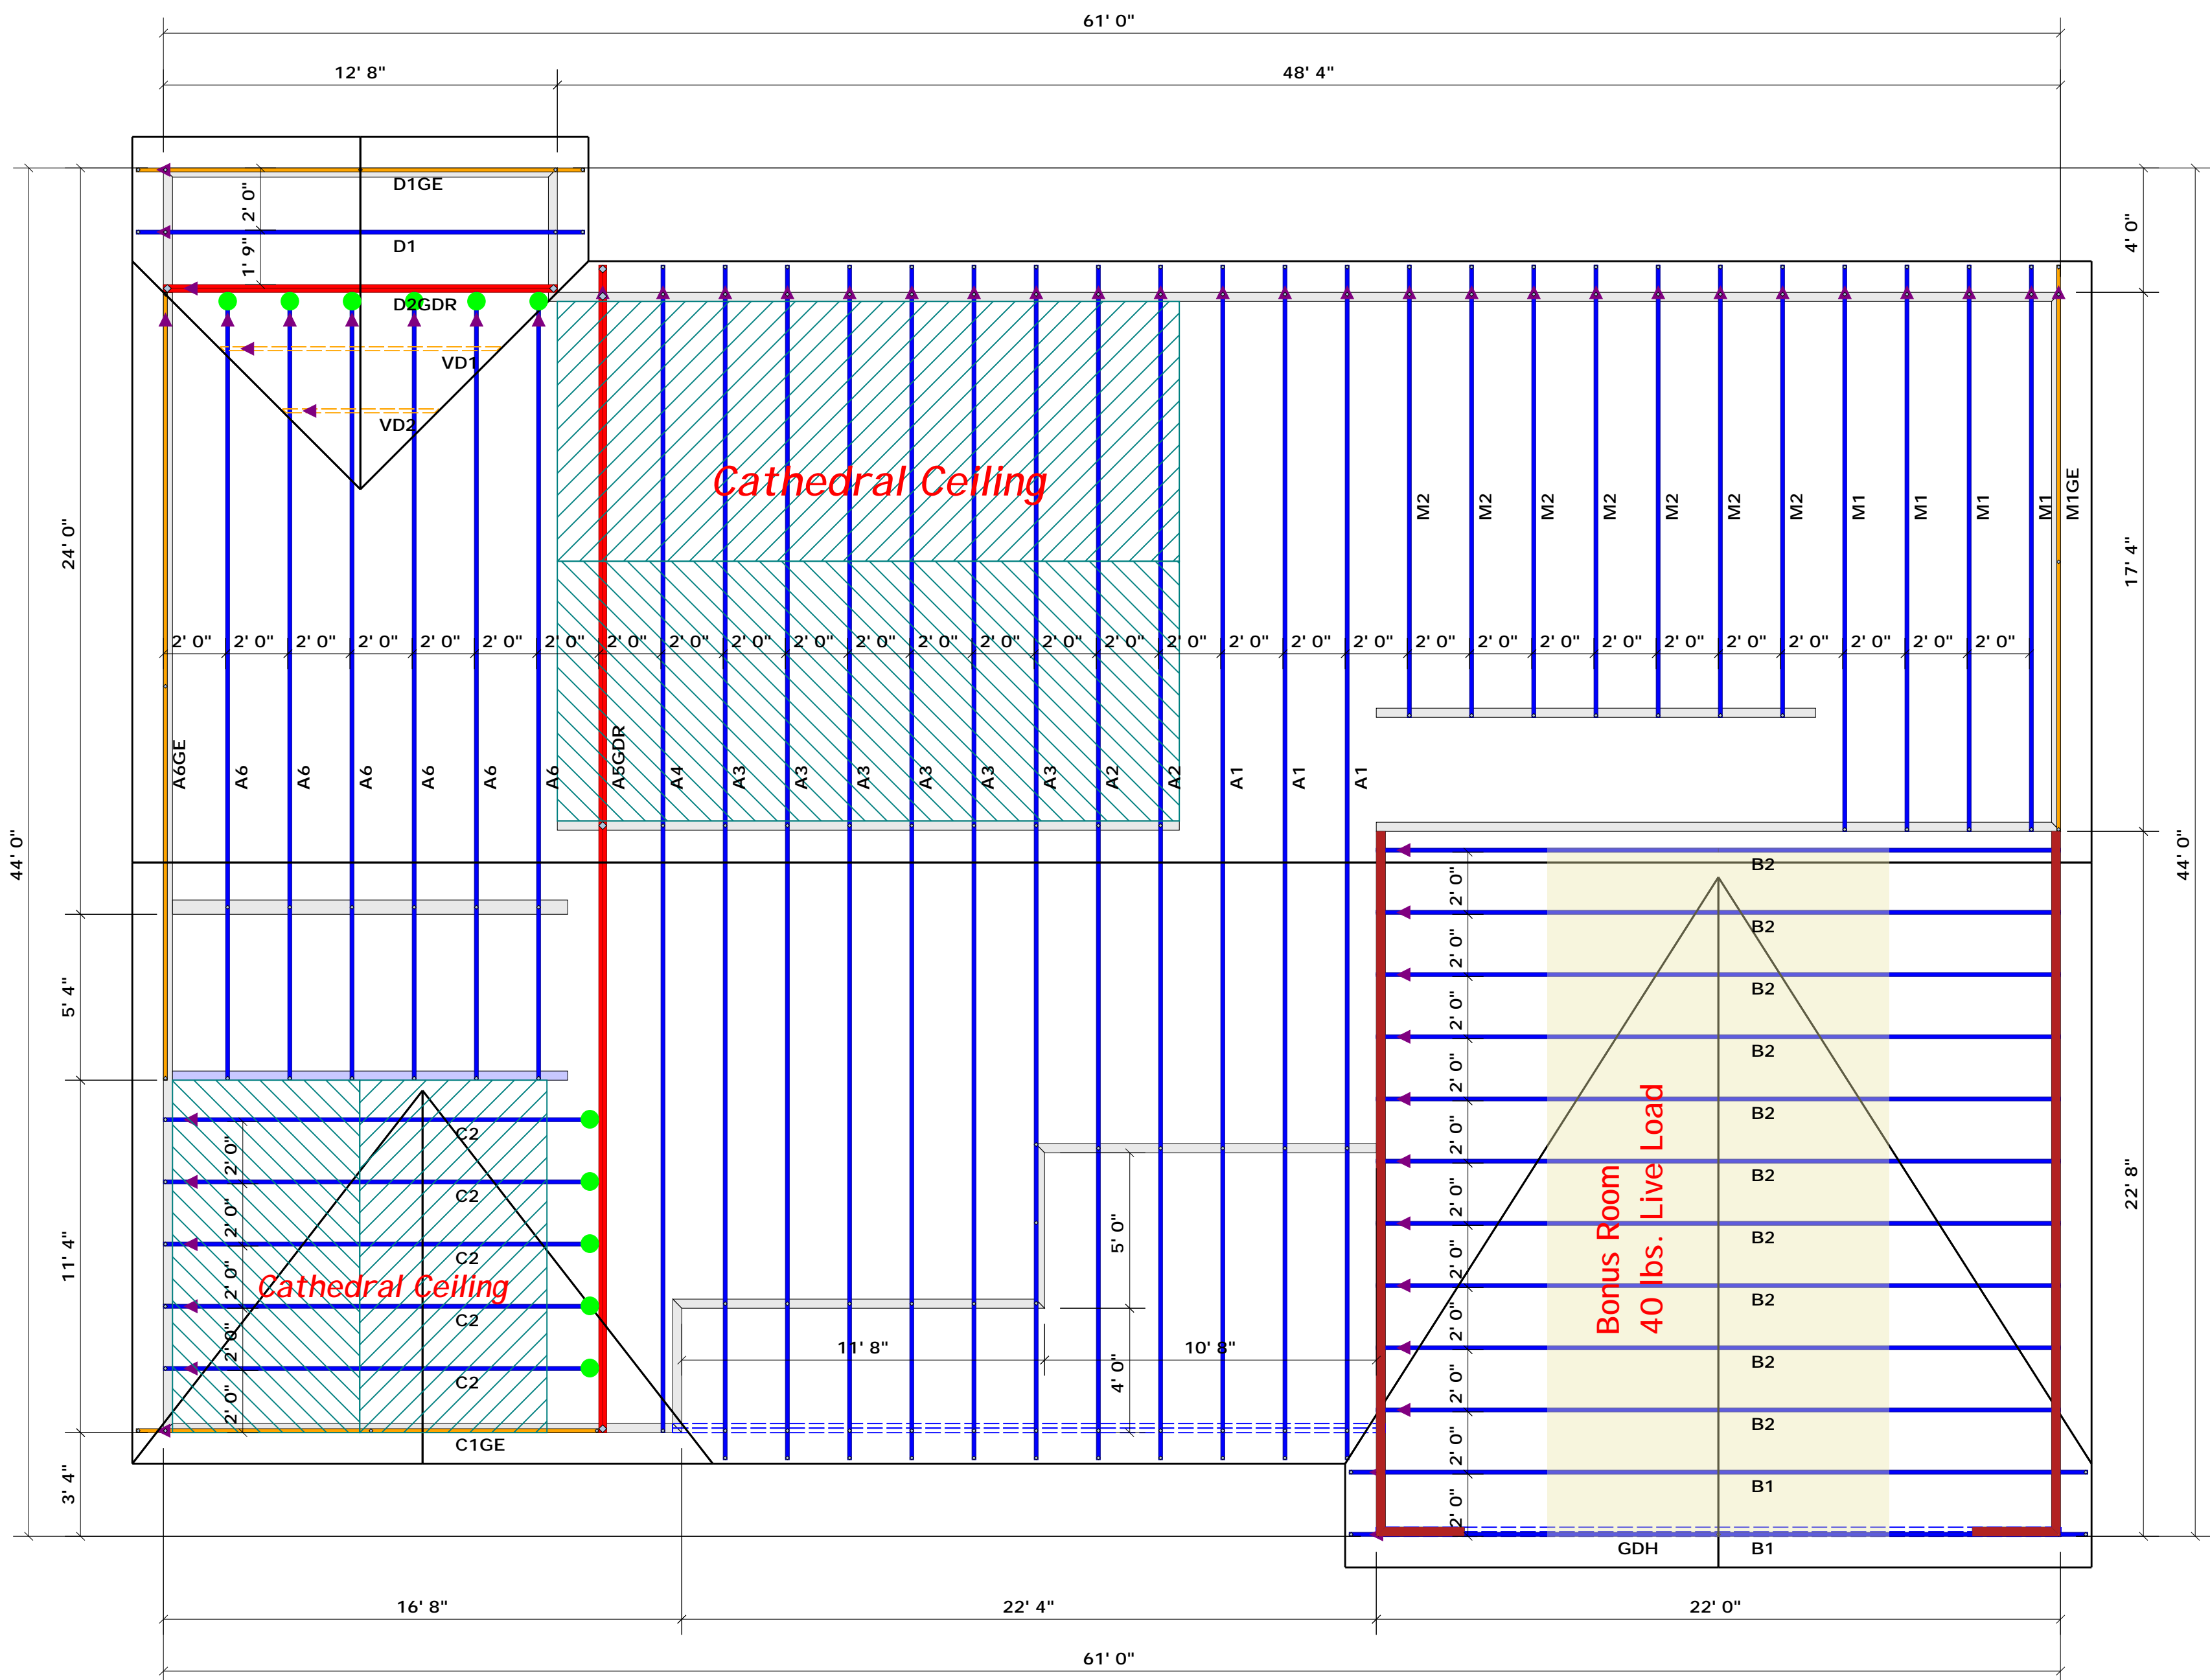

▲ = Denotes Left End of Truss
(Reference Engineered Truss Drawing)
Do Not Erect Trusses Backwards

Hatch Legend
Garage Walls Dropped 1'

Truss Placement Plan
SCALE: 1/4" = 1'

HANGER LEGEND
● = USP HUS26 / Single 2x Hanger

Beam Legend

| PlotID | Length | Product | Plies | Net Qty |
|--------|--------|-----------------------------|-------|---------|
| GDH | 22' 0" | 1-3/4"x 11-7/8" LVL Kerto-S | 2 | 2 |