NOTICE TO CONTRACTOR All construction must comply with current NC Building Codes and is subject to field inspection and verification.

Limited building only review Permit holder responsible for full compliance with the code







GRADE ELEVATIONS SHOWN DO NOT NECESSARILY REFER TO THIS OR ANY OTHER LOT. THEY ARE FOR DIAGRAMMATIC PURPOSES ONLY AND MAY VARY, BUILDER IS RESPONSIBLE FOR ADAPTING THIS PLAN TO SUIT THE EXISTING TOPOGRAPHY OF THE SITE,

ROOF VENTILATION TO BE DETERMINED BY BUILDER AS PER CODE.

ALL EGRESS OR RESCUE WINDOWS FROM SLEEPING ROOMS MUST HAVE A MIN. NET CLEAR OPENING OF 4.0 SQ FT. THE MIN NET CLEAR OPENING HEIGHT DIMENSION SHALL BE 22". THE MIN NET CLEAR OPENING WIDTH SHALL BE 20".

EACH EGRESS WINDOW FROM SLEEPING ROOMS MUST HAVE A SILL HIGHT OF NO MORE THAN 44" FROM THE FLOOR, ALL WINDOW SIZES ARE NOMINAL AND ARE TO BE VERIFIED WITH MANUFACTURER FOR AVAILABILITY AND CONFORMITY TO STATE AND LOCAL CODE REQUIREMENTS.

PORCHES, BALCONIES, OR RAISED FLOOR SURFACES LOCATED MORE THAN 30" ABOVE THE FLOOR OR GRADE BELOW SHALL HAVE GUARDRAILS NOT LESS THAN 32" IN HEIGHT.

ASSUME NO RESPONSIBILITY FOR ANY DISTANCES AFTER START OF CONTRACTOR/BUILDER SHALL CONSULT WITH HOME OWNER ON ALL INTERIOR AND EXTERIOR MOLDINGS, TRIMS, COLORS, FINISHES, CABINET LAYOUTS, AND MANUFACTORS BEFORE CONSTRUCTION BEGINS.

1.1 This plan has been drawn to comply with the 2018 NC Building Code

ALL BEAMS AND FRAMING MEMBERS ARE SIZED BY OTHERS.

1.2 Minimum Design Loads for Building and Other Structures ASCE 7-9B

2 Roof Dead Load 115 PSF 3 Roof Live Load 20 PSF

4 Typical Floor Dead Load 10 PSF

5 Floor Live Loads

5.1 Rooms other than sleeping rooms 40 PSF

5.2 Sleeping Rooms 30 PSF

5.3 Stairs 40 PSF 5.4 Decks 40 PSF

5.5 Exterior Balconies 60 PSF

Wind Loads

6.1 Ultimate Design Wind Speeds 15 MPH

6.2 Wind Importance Factor, IW 1.00

6.3 Exposure B

6.4 Walls (Component and Cladding) 25 PSF

6.5 Roofs (Component and Cladding)

6.5.1 Roof Slopes 2.25/12 to 7/12 34.8 PSF

6.5.2 Roof Slopes 7/12 to 12/12 21 PSF

It is the sole responsibility of the Contractor and/or Builder to conform to all standards, provisions, requirements, methods of construction and uses of materials provided in buildings and/or structures as required by NC Uniform Building Code, Local Agencies and in accordance with good engineering practices. Verify all dimensions prior to construction.




FRONT ELEVATION



FRONT ELEVATION WITH OPTIONAL I CAR GARAGE



FRONT

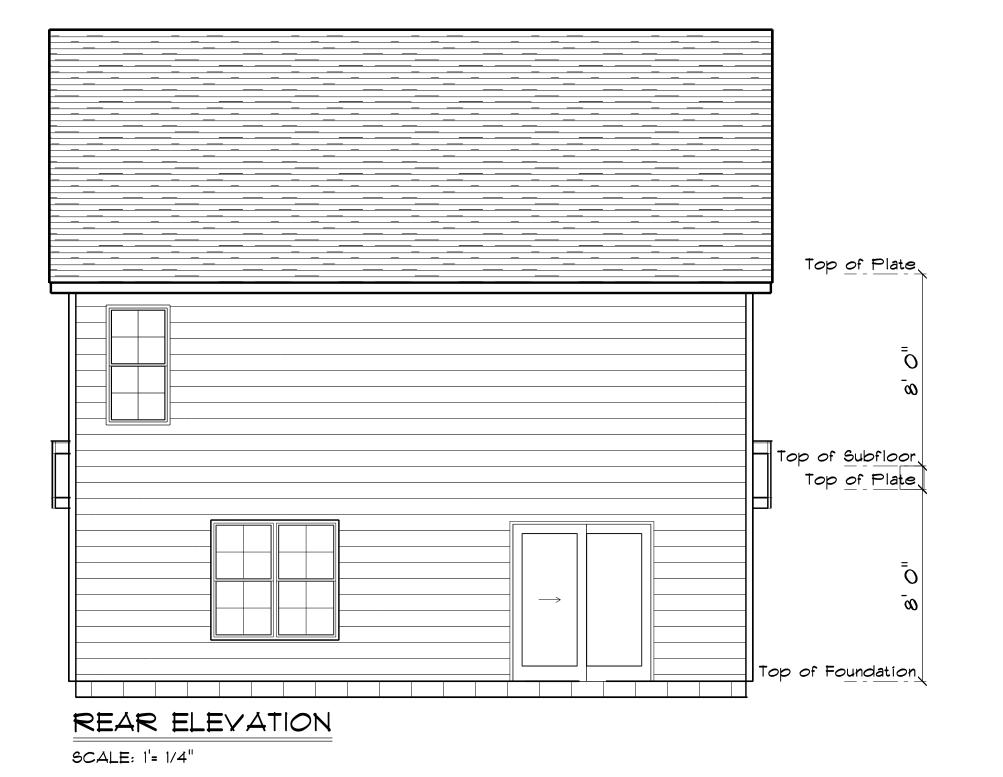







SCALE: 1'= 1/4"

SCALE: 1'= 1/4"

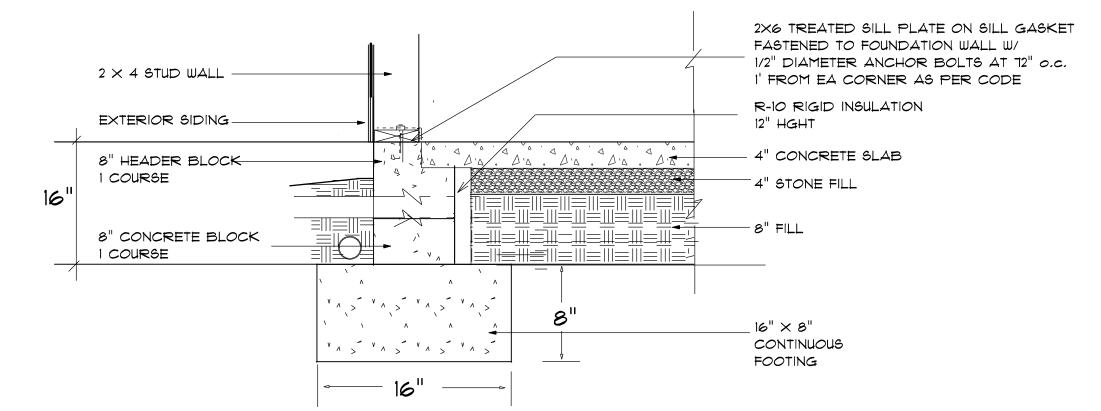


STEM WALL FOUNDATION Detail

not to scale

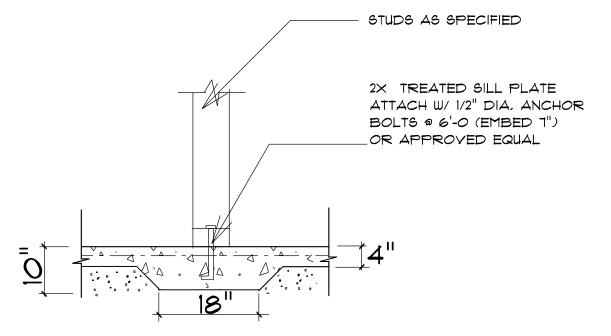

TYPICAL THICKENED SLAB not to scale

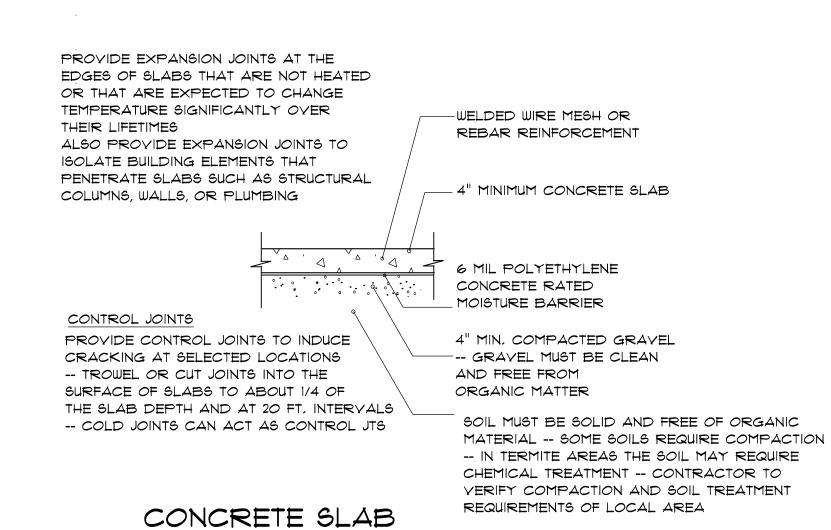

DETAILS / NOTES

not to scale

Termite Soil Treatment: Treat entire slab area soil or crawl space surface before vapor barrier is installed and slab is poured with a state approved termiticide. Termiticide should be applied by a licensed and certified pest control professional by the state of North Carolina.

FOUNDATION NOTES:
ALL FOOTINGS SHALL BEAR ON ORIGINAL UNDISTURBED SOIL.
THE 28 DAY COMPRESSIVE STRENGTH OF ALL FOOTINGS IS 3000 PSI


PROVIDE WATER PROOFING AND PERIMETER DRAINS AS REQUIRED.

FOUNDATION CONCRETE MIX TO HAVE 1-1/2" MAX AGGREGATE SIZE, CONCRETE FILL MIX TO HAVE 1/2" MAX AGGREGATE SIZE,

FOOTING WIDTHS ARE BASED ON A LOAD-BEARING SOIL CAPACITY OF 2000 PSI.

PROVIDE 6 MIL POLY VAPOR BARRIER TO COVER GROUND SURFACE IN CRAWL SPACE

ALL ANCHOR BOLTS TO BE 12" LONG, 1/2" DIA. A36 UNO ANCHOR BOLTS SHALL BE SPACE AT A MAX OF 6' OC AND NO MORE THAN 1' FROM EA CORNER.

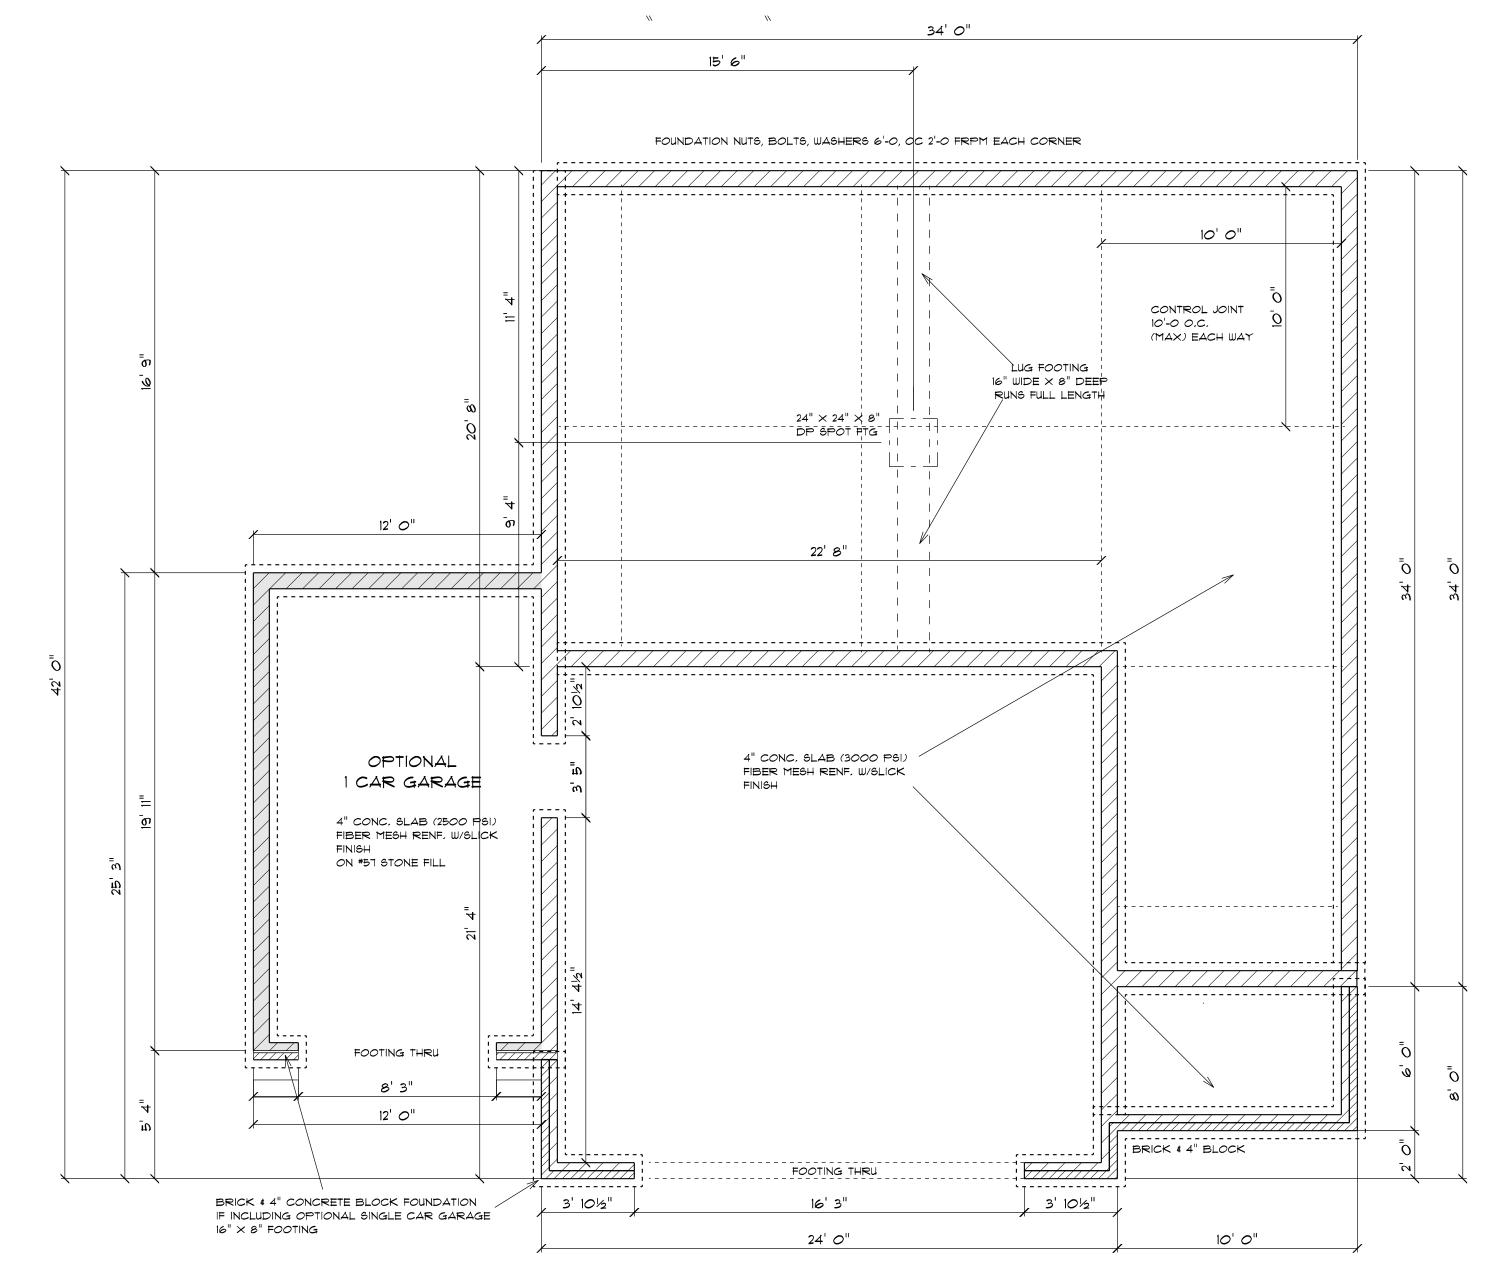

FOUNDATION PLAN

SCALE: 1'= 1/4

OPENING SCHEDULE				
R.O. HEIGHT	R.O. WIDTH	LIBRARY NAME	COUNT	SIZE
80-1/2"	72"	Exterior Door\Patio	1	6'-0"
60-1/2"	32"	Window\Double Hung	1	2'-8" x 5'-0"
60-1/2"	64-1/2"	Window\Double Hung	2	2'-8" x 5'-0" Twin

GENERAL FRAMING NOTES:

ALL LUMBER IN CONTACT WITH CONCRETE OR MASONRY SHALL BE PRESSURE TREATED

FRAMING LUMBER SHALL BE SYP *2 GRADE AND/OR SPRUCE PINE FIR #1 AND/OR #2, KILN DRIED.

WHERE PRE-ENGINEERED JOISTS ARE USED, JOIST MANUFACTURER SHALL PROVIDE SHOP DRAWINGS, WHICH BEAR SEAL OF A N.C. ENGINEER.

STUDS AND JOISTS SHALL NOT BE CUT TO INSTALL PLUMBING OR WIRING WITHOUT ADDING METAL OR WOOD SIDE PANELS TO STRENGTHEN THE MEMBER TO ITS ORIGINAL CAPACITY.

NAIL MULTIPLE MEMBERS WITH 2 ROWS OF 16d NAILS STAGGERED 32" OC AN USE 3-16d NAILS 2" IN AT EACH END. DOUBLE ALL STUDS UNDER ROOF POST DOWNS UNO.

NAIL FLOOR JOISTS TO SILL PLATE WITH 8d TOE NAILS.


ALL EXPOSED FRAMING ON PORCHES AND DECKS SHALL BE PRESSURE TREATED.

PROVIDE WATERPROOFING AND DRAINS AS REQUIRED.

ALL FRAMING TO BE 16" OC UNO. WALL FRAMING DIMENSIONS ARE BASED ON 2 imes 4 STUDS UNO. DOUBLE STUDS UNDER ALL HEADERS.

LVL'S AND TJI'S TO BE SIZED BY OTHERS

EXTERIOR WALLS IN LIVING AREAS ARE 2 X 4

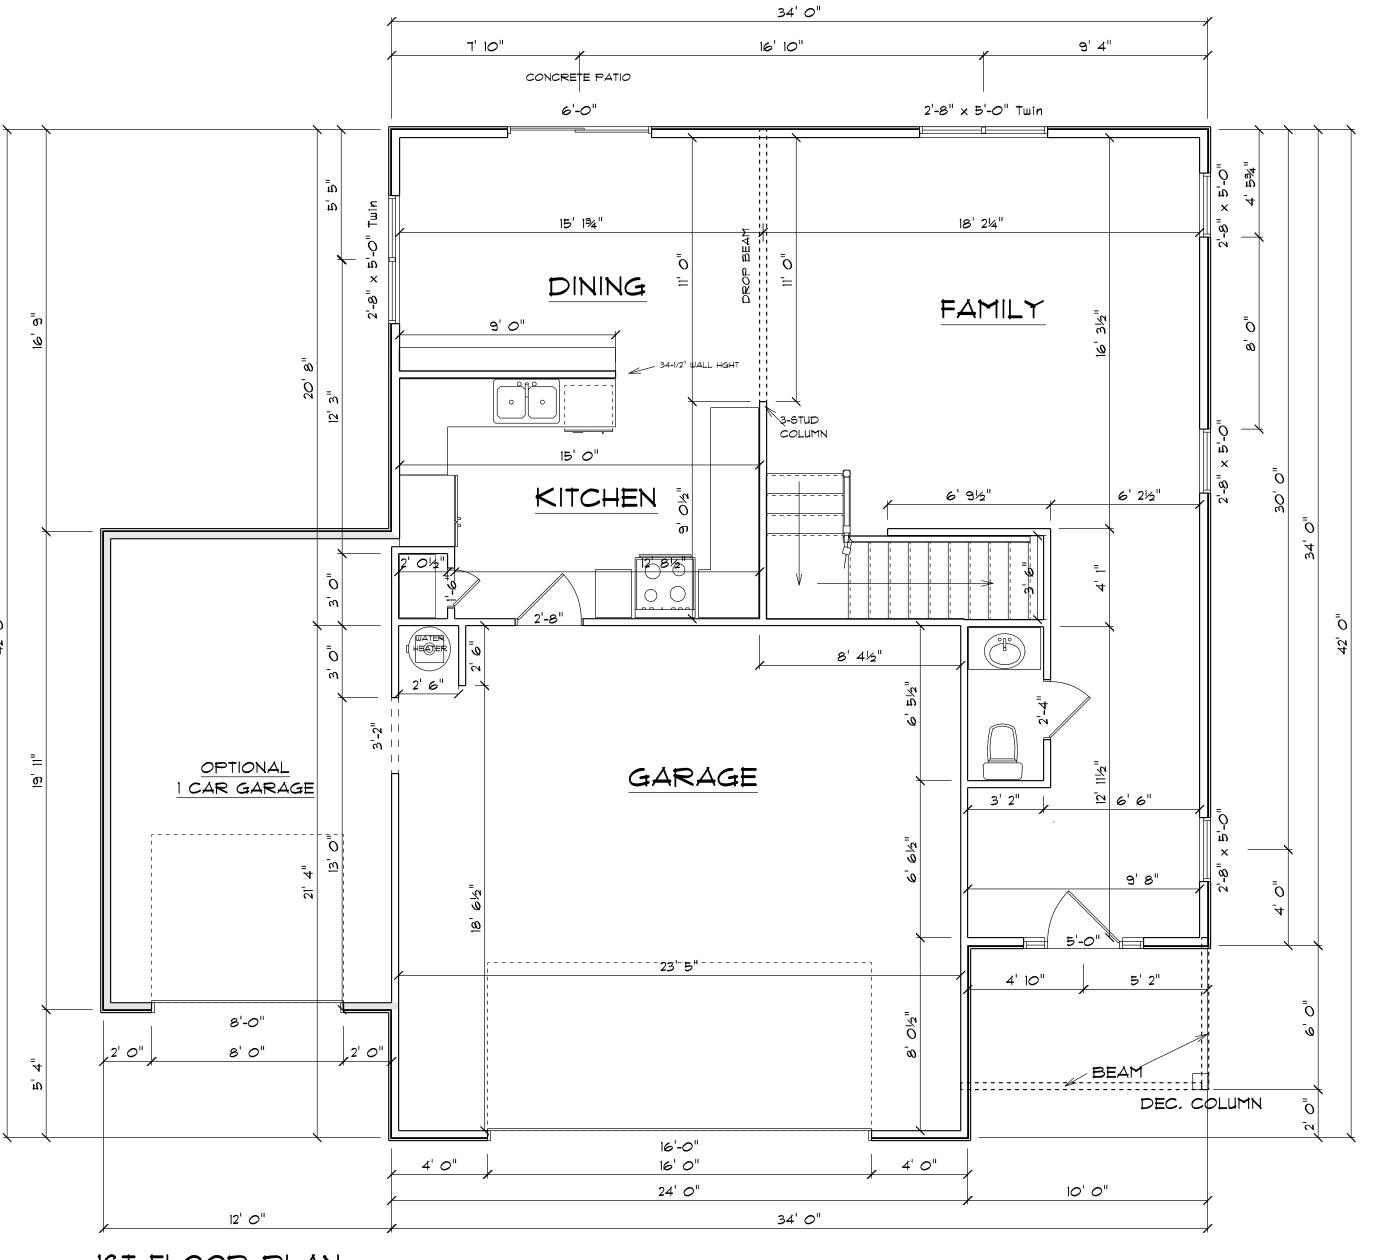

1ST FLOOR PLAN

SCALE: 1'= 1/4"

AREA SCHEDULE			
NAME	AREA		
Heated Floor Area	841.2 sq ft		
Garage	505.8 sq ft		
Covered Porch	58.3 sq ft		
Optional 1 Car Garage	244.5 sq ft		

OPENING SCHEDULE				
R.O. HEIGHT	R.O. WIDTH	LIBRARY NAME	COUNT	SIZE
60-1/2"	32"	Window\Double Hung	5	2'-8" x 5'-0"
36"	24"	Window\Double Hung	1	2'-0" x 3'-0"
60-1/2"	64-1/2"	Window\Double Hung	2	2'-8" x 5'-0" Twin
12"	48"	Window∖Transom	1	4'-0" x 1'-0"

GENERAL FRAMING NOTES:

ALL LUMBER IN CONTACT WITH CONCRETE OR MASONRY SHALL BE PRESSURE TREATED

FRAMING LUMBER SHALL BE SYP #2 GRADE AND/OR

SPRUCE PINE FIR *1 AND/OR *2, KILN DRIED.

WHERE PRE-ENGINEERED JOISTS ARE USED, JOIST MANUFACTURER SHALL PROVIDE SHOP DRAWINGS, WHICH BEAR SEAL OF A N.C. ENGINEER.

STUDS AND JOISTS SHALL NOT BE CUT TO INSTALL PLUMBING OR WIRING WITHOUT ADDING METAL OR WOOD SIDE PANELS TO STRENGTHEN THE MEMBER TO ITS

ORIGINAL CAPACITY.

NAIL MULTIPLE MEMBERS WITH 2 ROWS OF 16d NAILS STAGGERED 32" OC AN USE 3-16d NAILS 2" IN AT EACH END. DOUBLE ALL STUDS UNDER ROOF POST DOWNS UNO.

NAIL FLOOR JOISTS TO SILL PLATE WITH 8d TOE NAILS.


ALL EXPOSED FRAMING ON PORCHES AND DECKS SHALL BE PRESSURE TREATED.

PROVIDE WATERPROOFING AND DRAINS AS REQUIRED.

ALL FRAMING TO BE 16" OC UNO. WALL FRAMING DIMENSIONS ARE BASED ON 2×4 STUDS UNO. DOUBLE STUDS UNDER ALL HEADERS.

LYL'S AND TJI'S TO BE SIZED BY OTHERS


EXTERIOR WALLS IN LIVING AREAS ARE 2 × 4

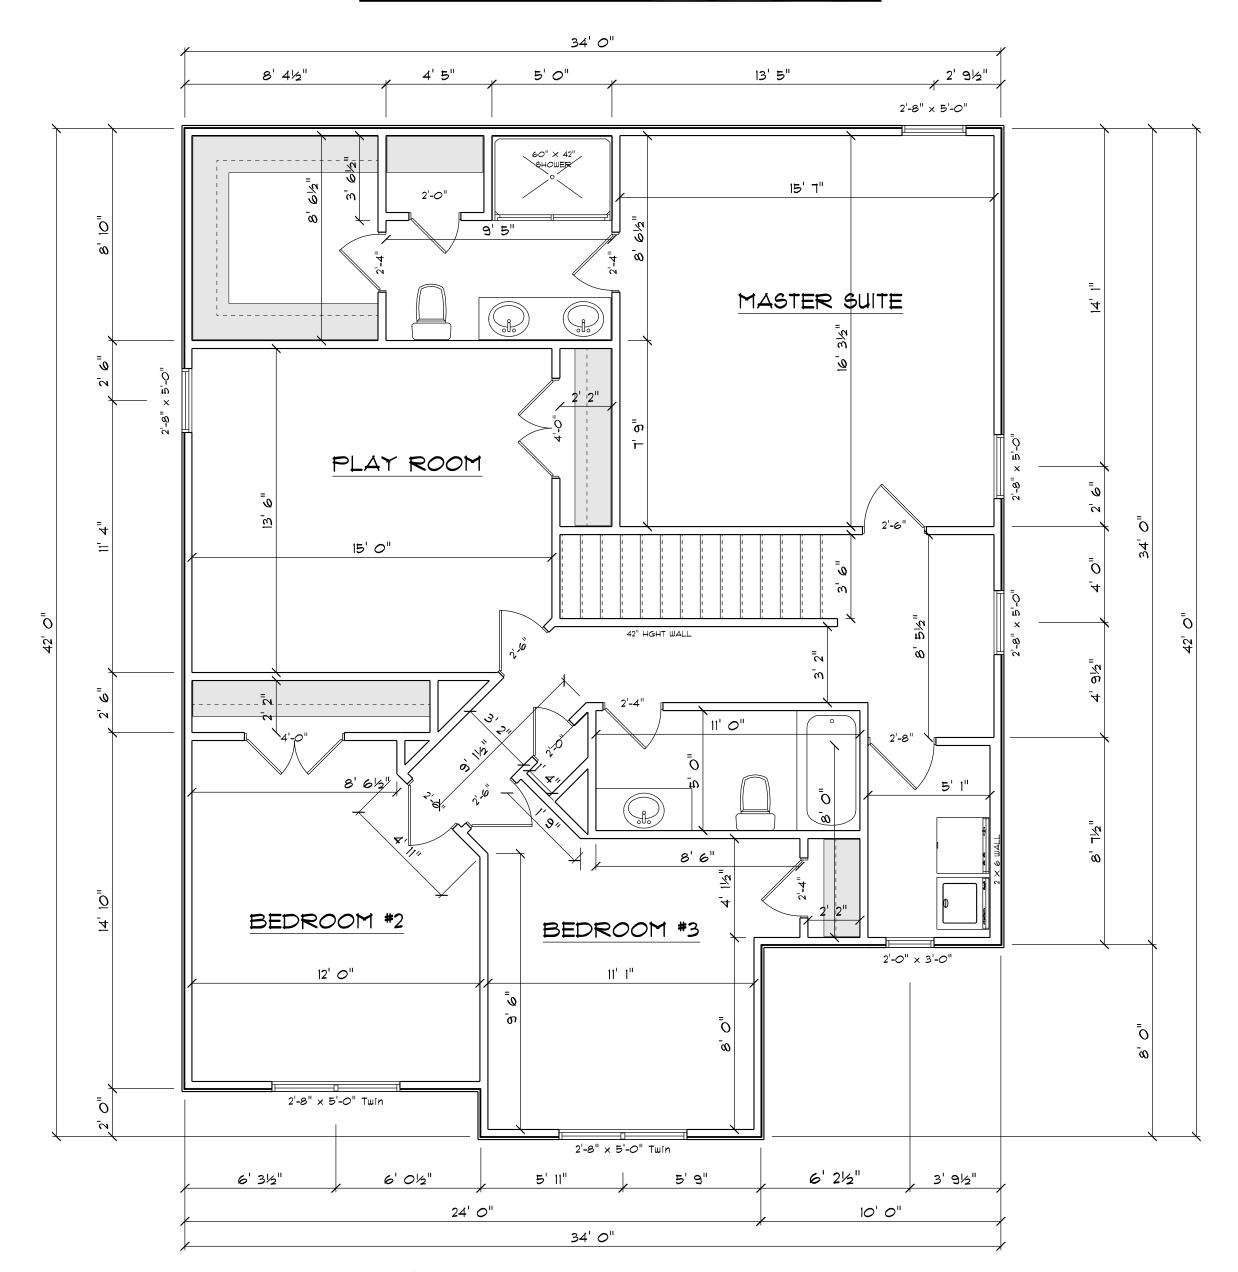


2ND FLOOR PLAN


SCALE: 1'= 1/4"


AREA SCHEDULE		
NAME	AREA	
eated Floor Are 2nd Floor	1302.4 sq ft.	

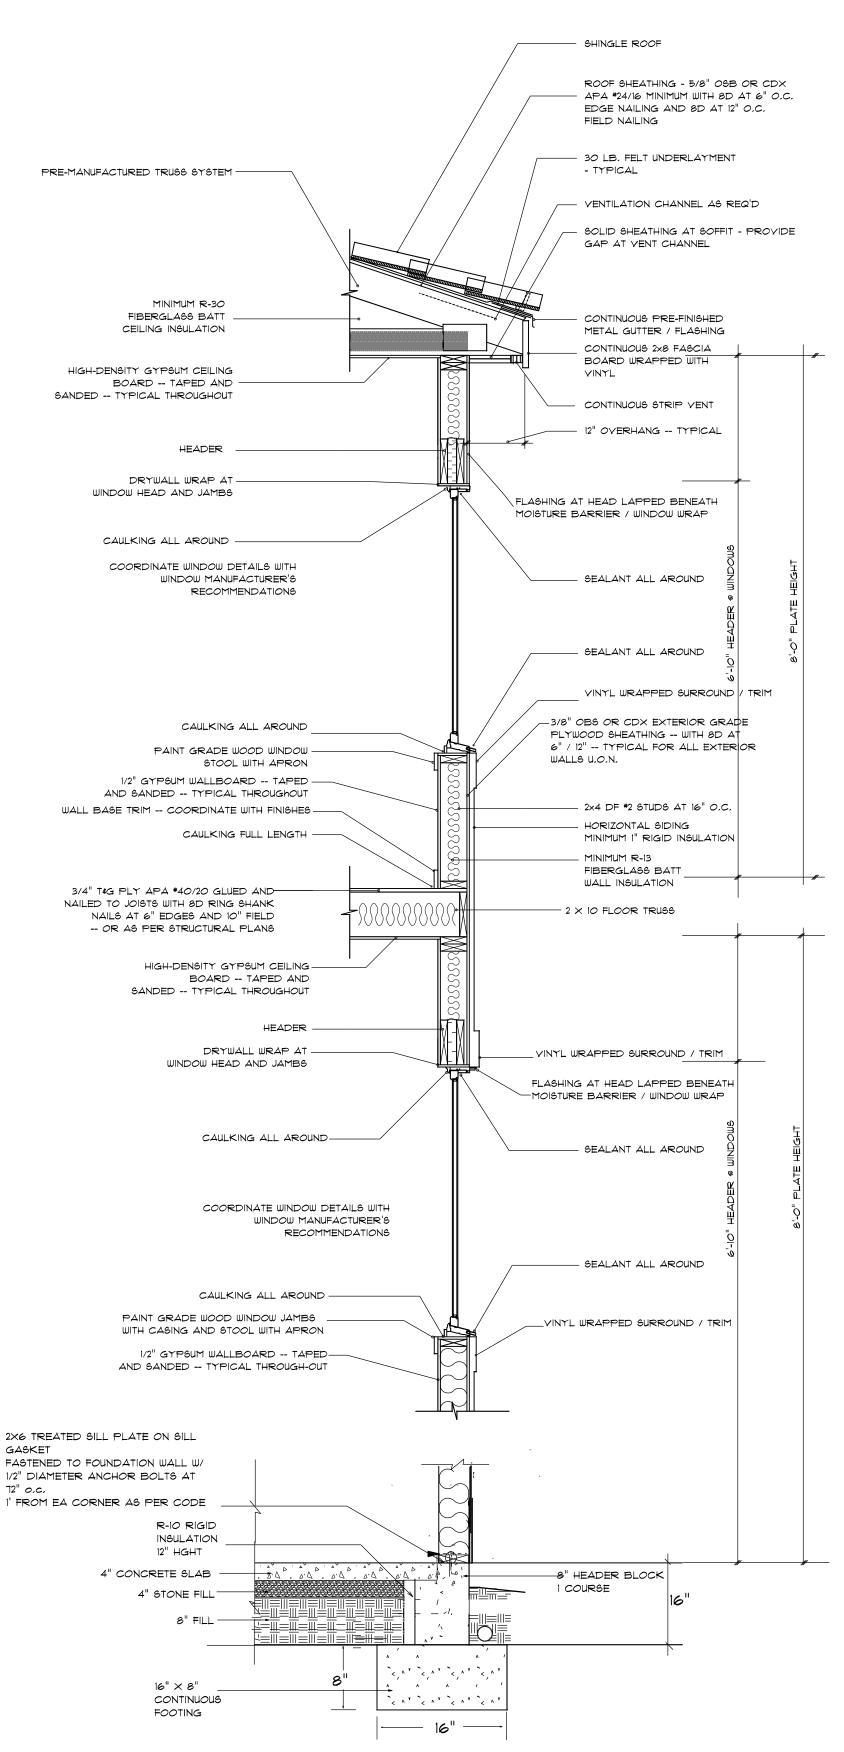

2x4 WITH 8" BLOCK STEM WALL FOUNDATION not to scale

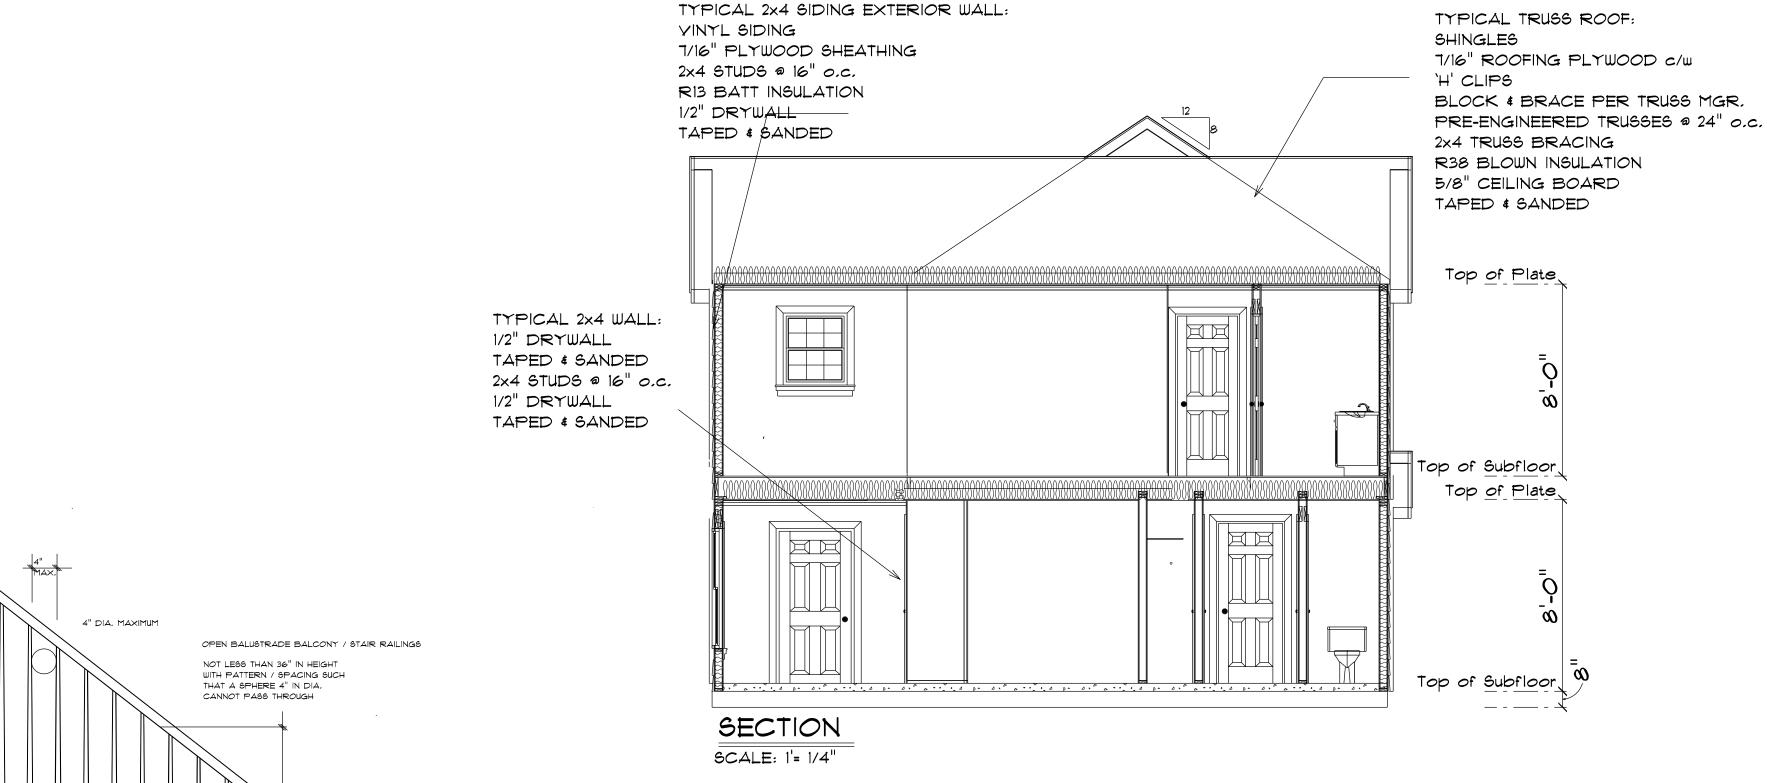

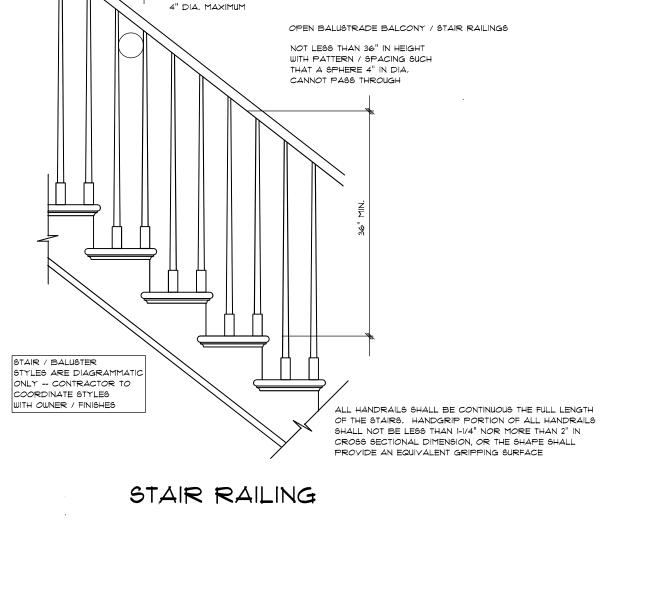

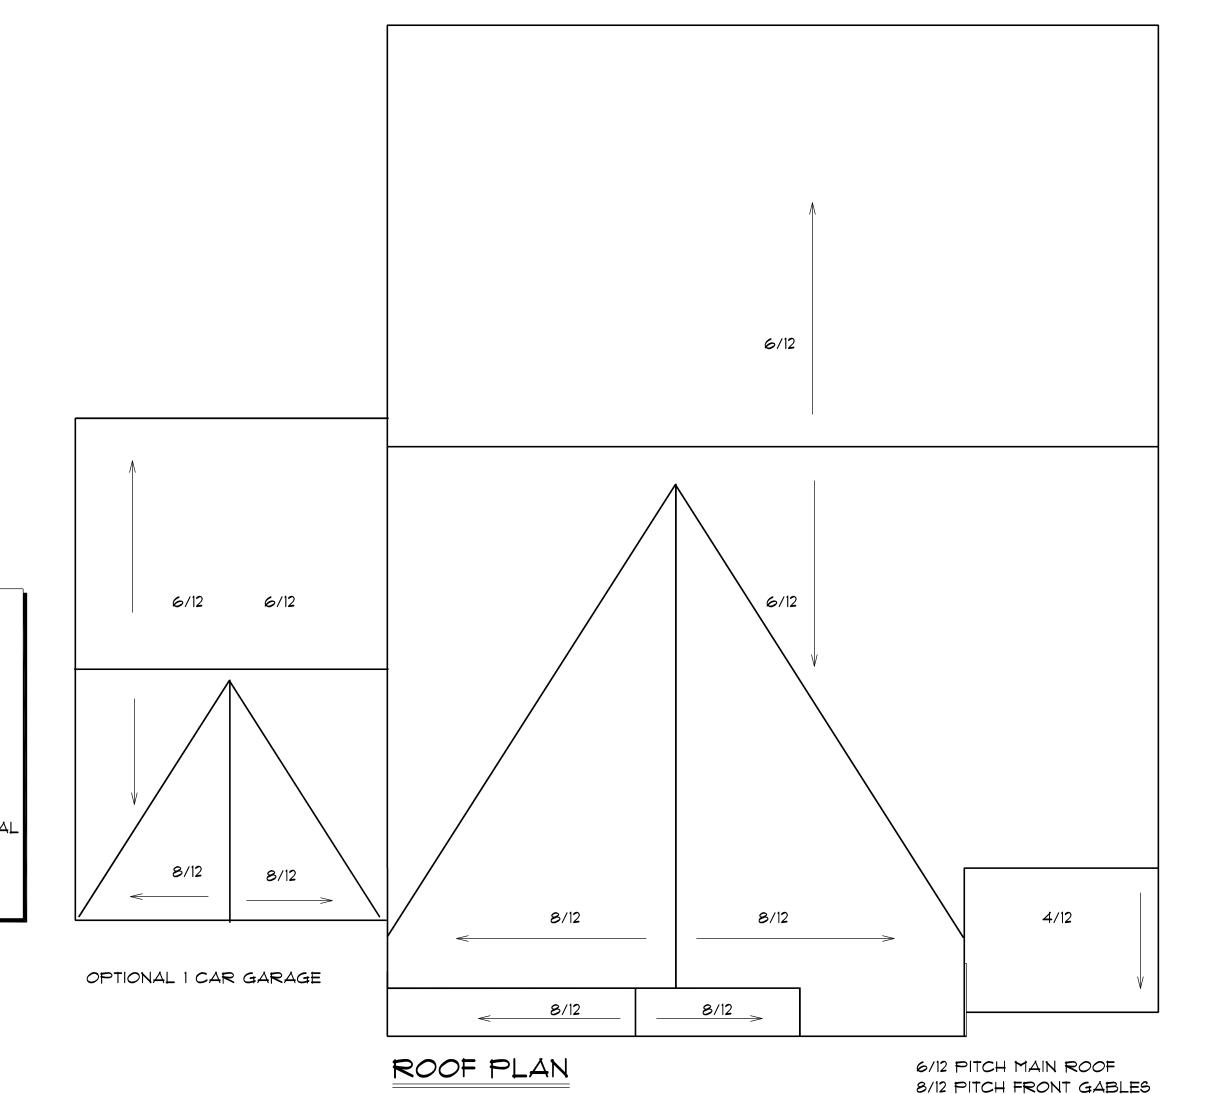

4/12 PITCH SHED ROOFS

12" OH ALL

SCALE: 1'= 1/4"


ROOF NOTES:

TRUSSES, BRACINGS, BRIDGING AND CONNECTORS ARE TO BE DESIGNED BY THE TRUSS MANUFACTURER.


IDENTIFY LUMBER BY OFFICIAL GRADE MARKINGS.

DO NOT CUT OR REMOVE CHORDS OR OTHER TRUSS MEMBERS.
DO NOT NOTCH OR DRILL TRUSS MEMBERS.

WHERE PRE-ENGINEERED ROOF TRUSSES ARE USED, TRUSS
MANUFACTURER SHALL PROVIDE SHOP DRAWINGS, WHICH BEAR SEAL
OF A N. C. REGISTERED ENGINEER.

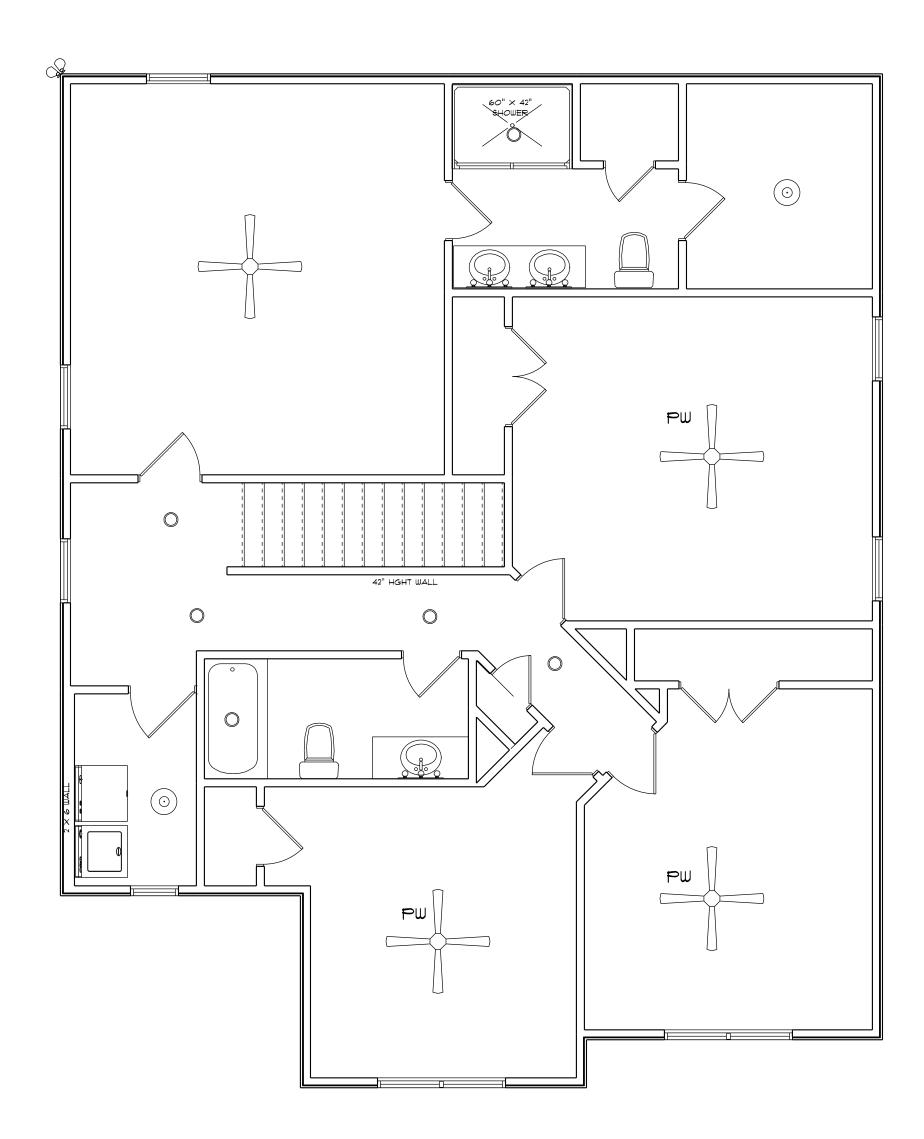

ELECTRICAL LEGEND				
SYMBOL	COUNT	ELECTRICAL		
	1	ceiling fan		
0	6	7 inch led light		
<u></u>	2	10" led light		
Q.D	1	flood light		
000	3	vanity light		

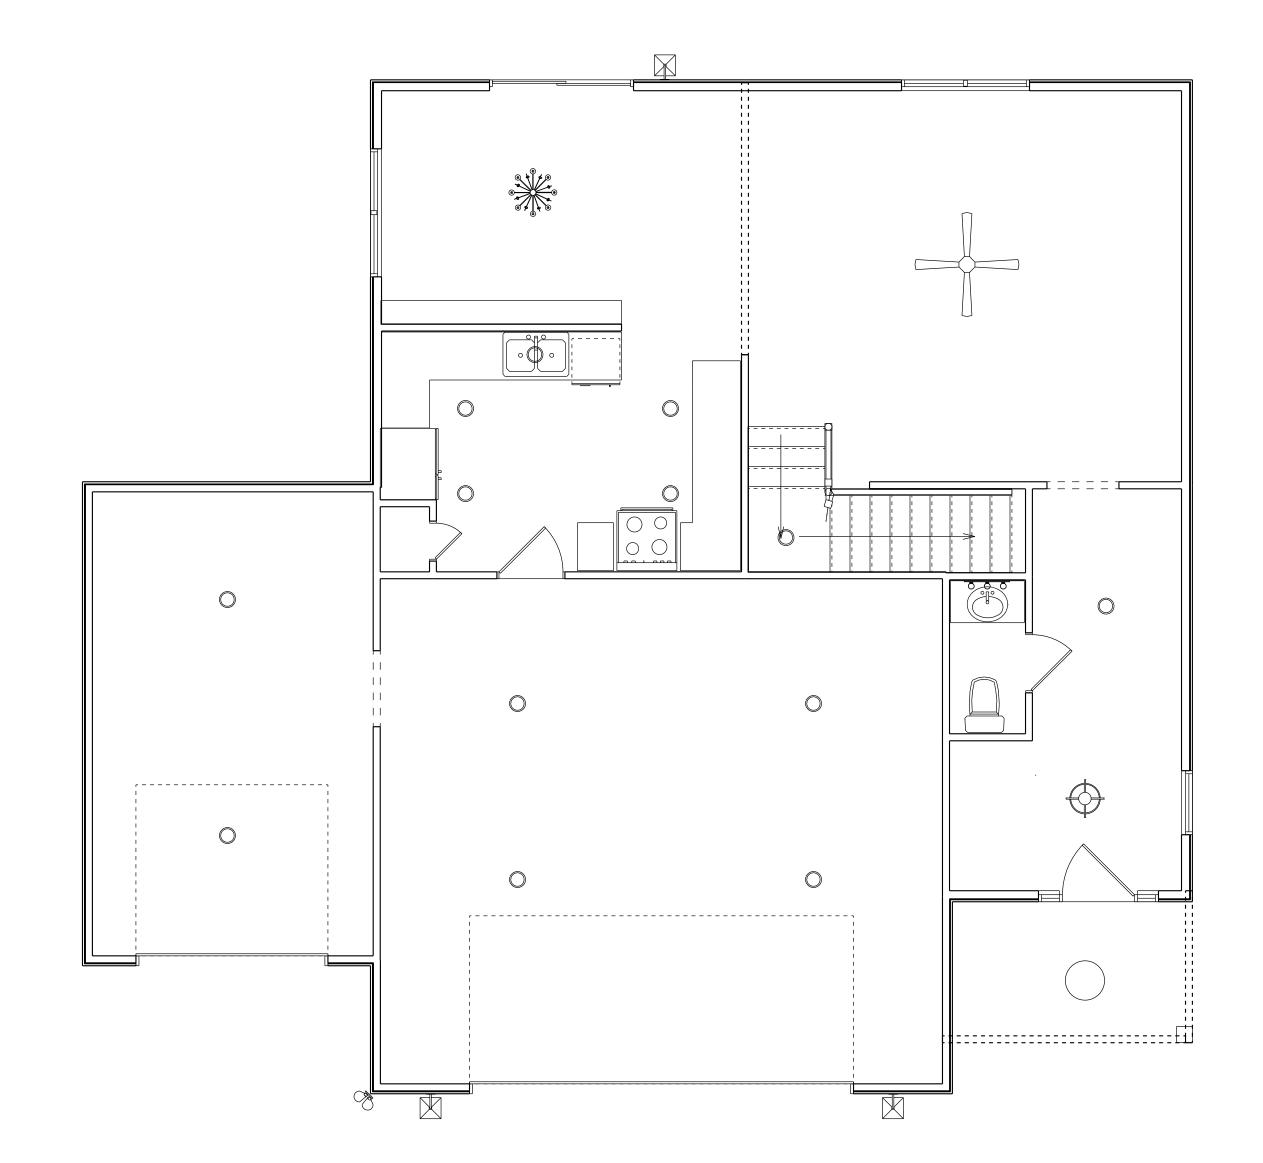


ELECTRICAL LEGEND			
SYMBOL	COUNT	ELECTRICAL	
	1	ceiling fan	
0	13	7" led light	
	1	dinning room light	
	1	out door ceiling light	
\Diamond	1	foyer light	
	3	coach light	
QD	1	flood light	
000	1	vanity light	

LAMCO CUSTOM BUILDERS

THE JACKSON GARAGE LEFT

LECTRICAL LAYOUT

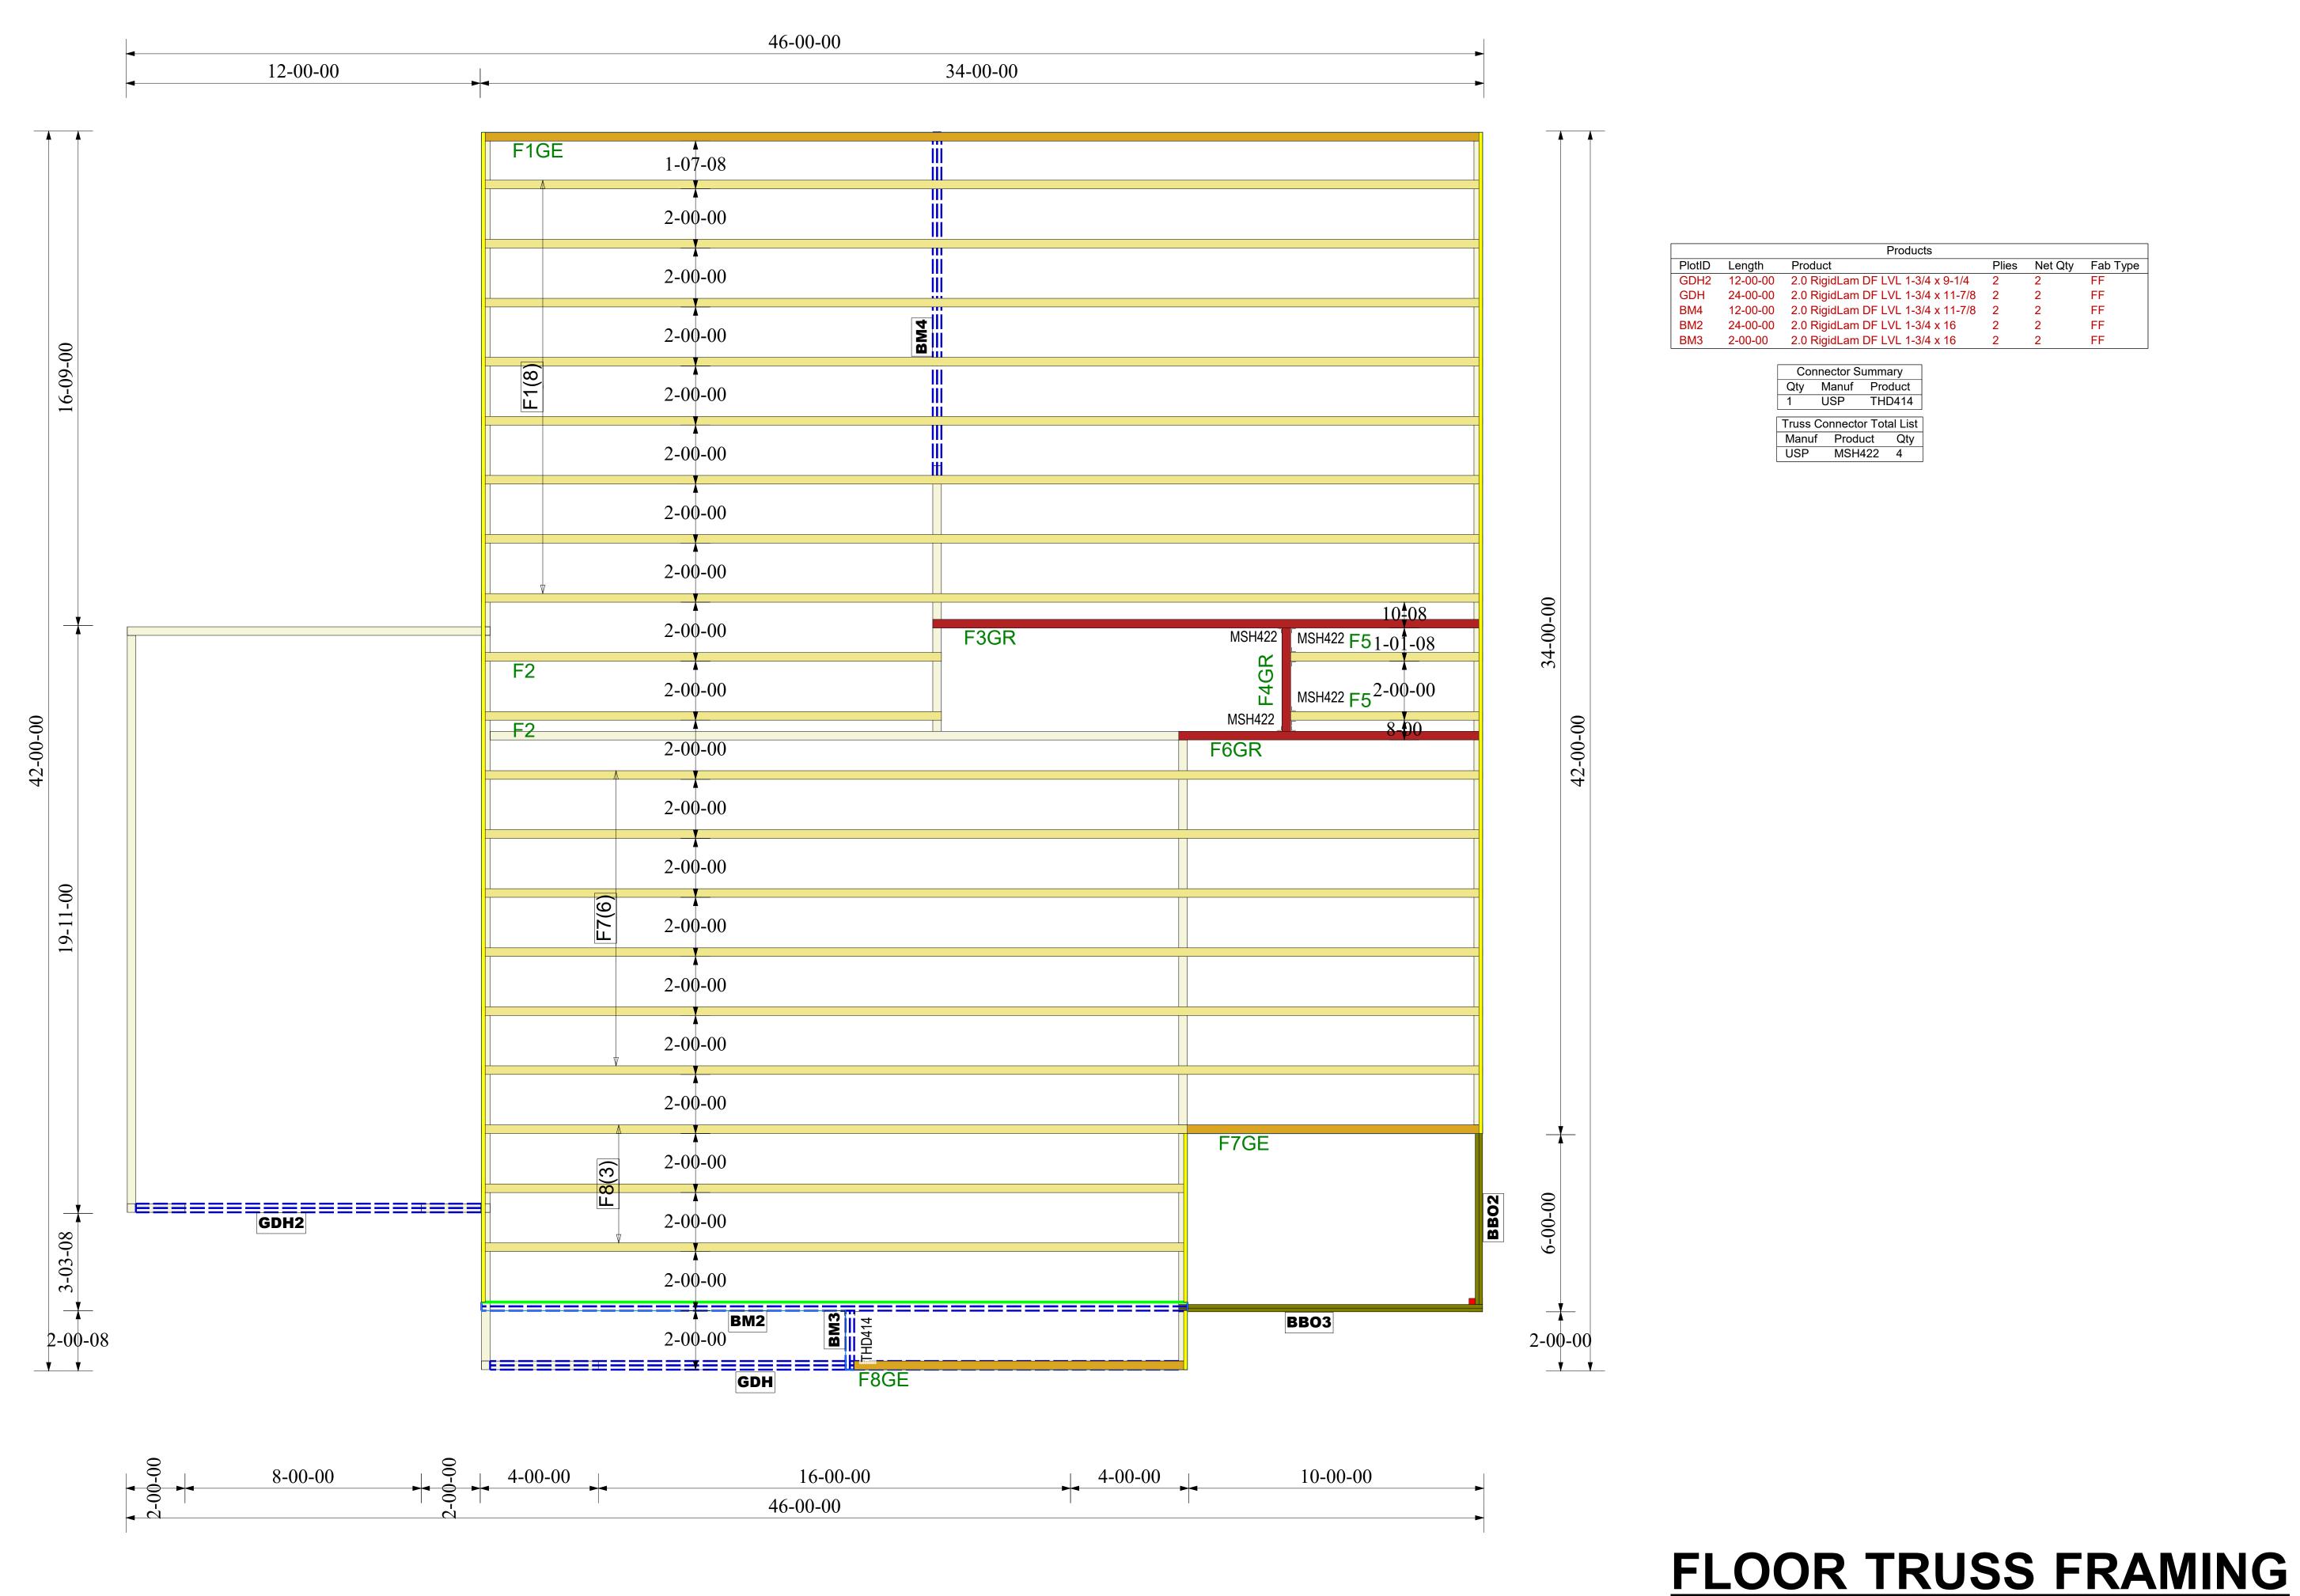



Connector Summary
Qty Manuf Product 1 USP THD414 Truss Connector Total List Manuf Product Qty
USP MSH422 4


Rosemont

LAMCO

_			
	REVISIONS		
	DATE	BY	
	12/31/20	MF	

20120029 SHEET NUMBER

DRAWING SCALE: NTS

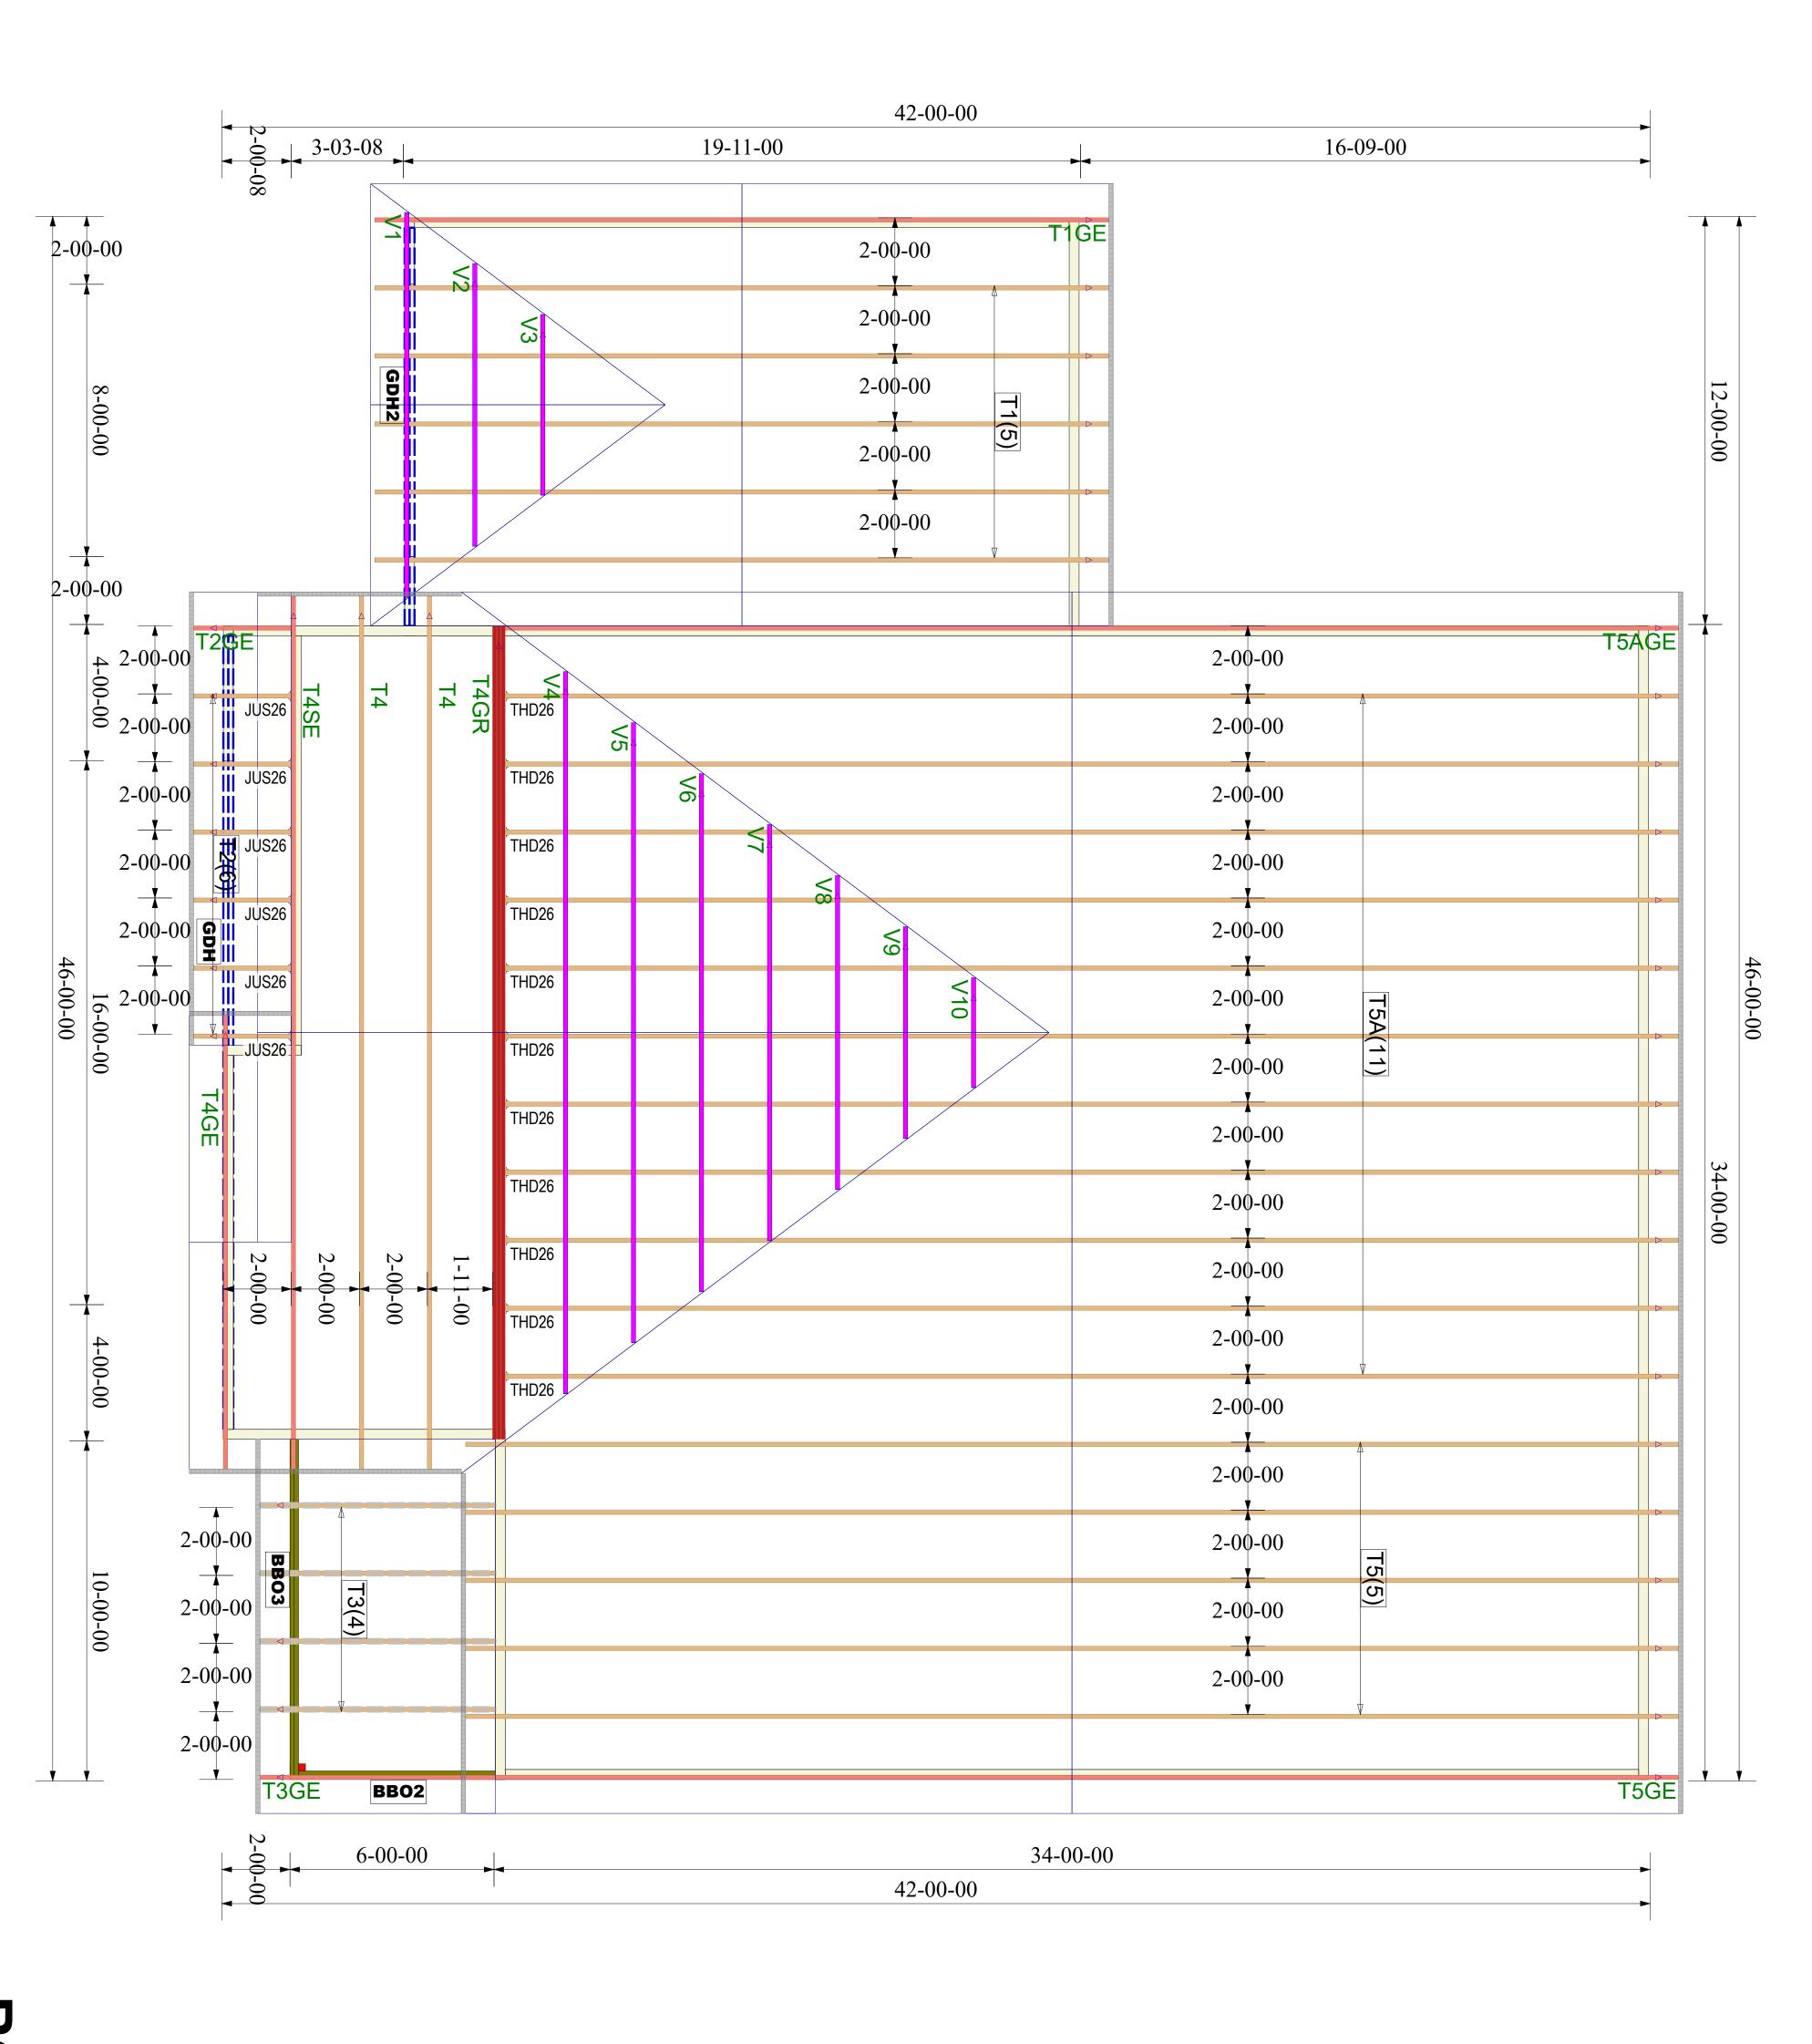

ROOF TRUSS FR.

DRAWING SCALE: NT

Manuf Product Oty
USP JUS26 6
USP One RT7A 59
USP THD26 11

