

DAG 794

STRUCTURAL ENGINEERS
License No. C-3870
183 Wind Chime Ct, Ste 100
Raleigh, North Carolina 27615
Phone (919) 844-1661

Ingineering STR 183 Wi

ESIDENCE

STRUCTURAL ADDEN
1412 BALFOUR DOWNS CIRCLE


ENG: NBG/TRB
DATE: 7-16-2020


ATE: 7-16-2020 PLAN

PROJECT NO. 20-65-256

SHEET NO.

1 of 5

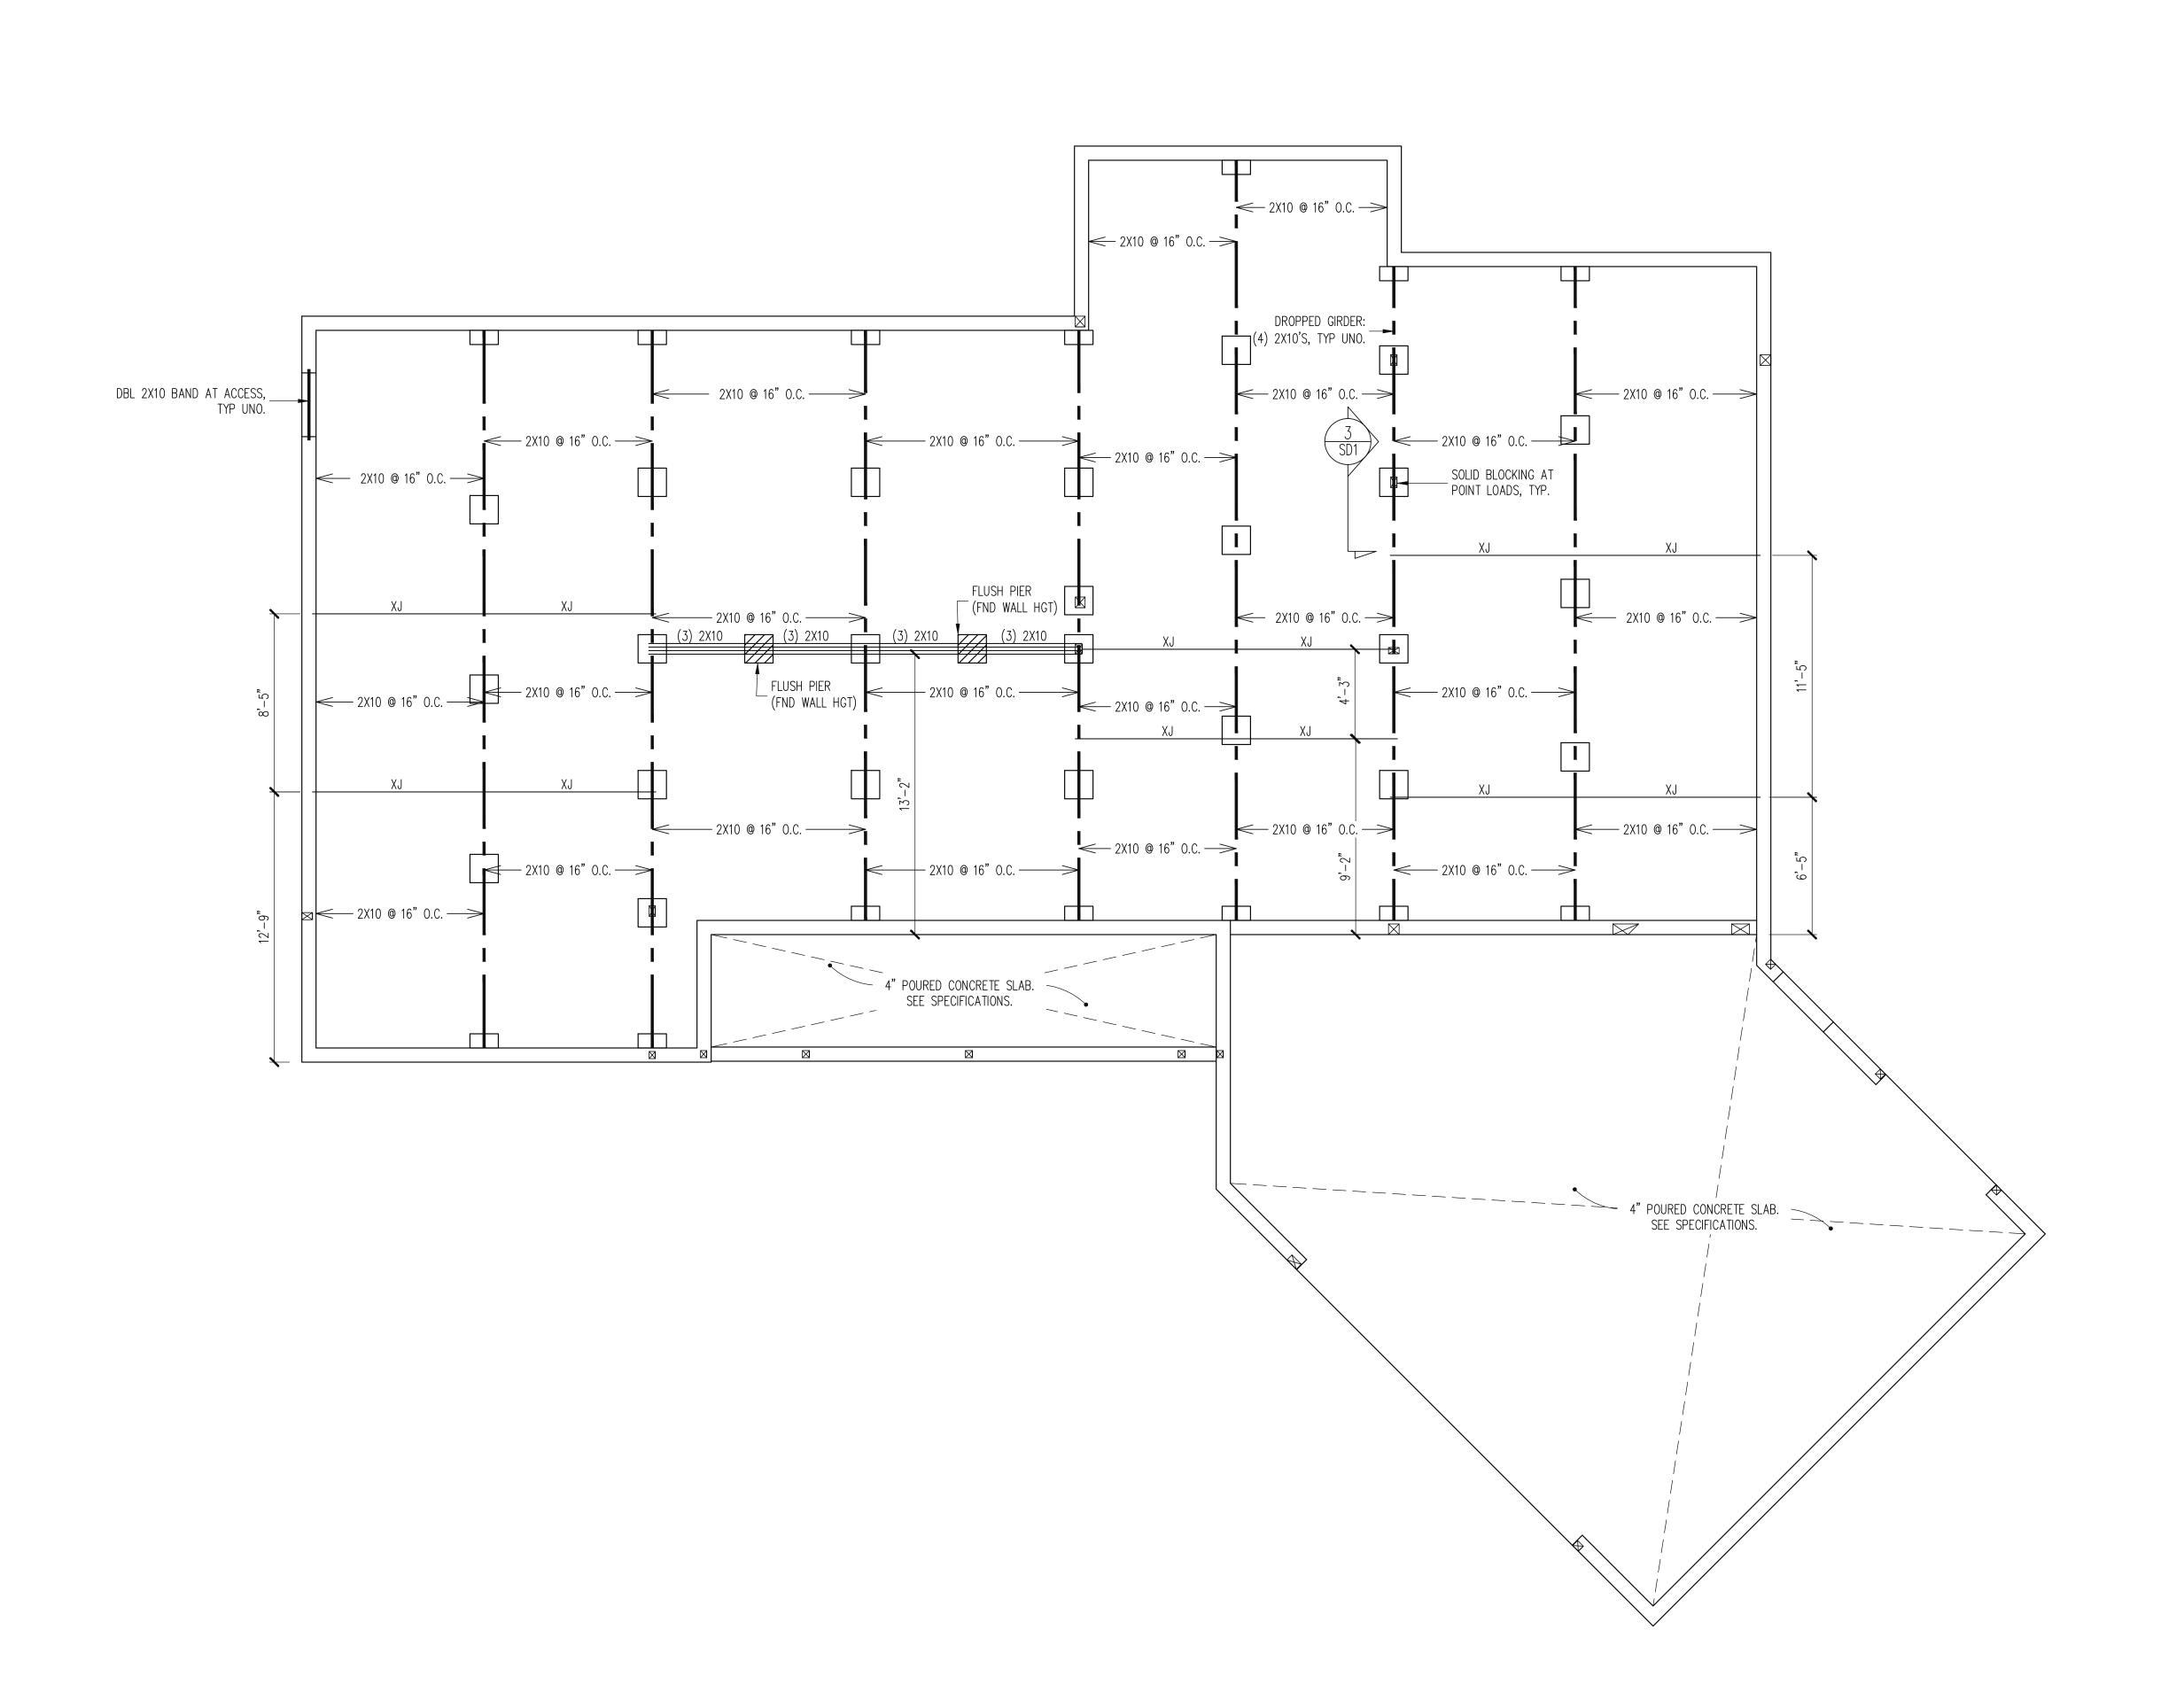

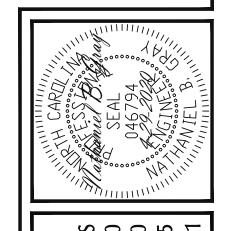


ENG: NBG/TRB DATE: 7-16-2020


PLAN

PROJECT NO. 20-65-256

SHEET NO. **S**2

CRAWL SPACE FRAMING PLAN 2 of 5

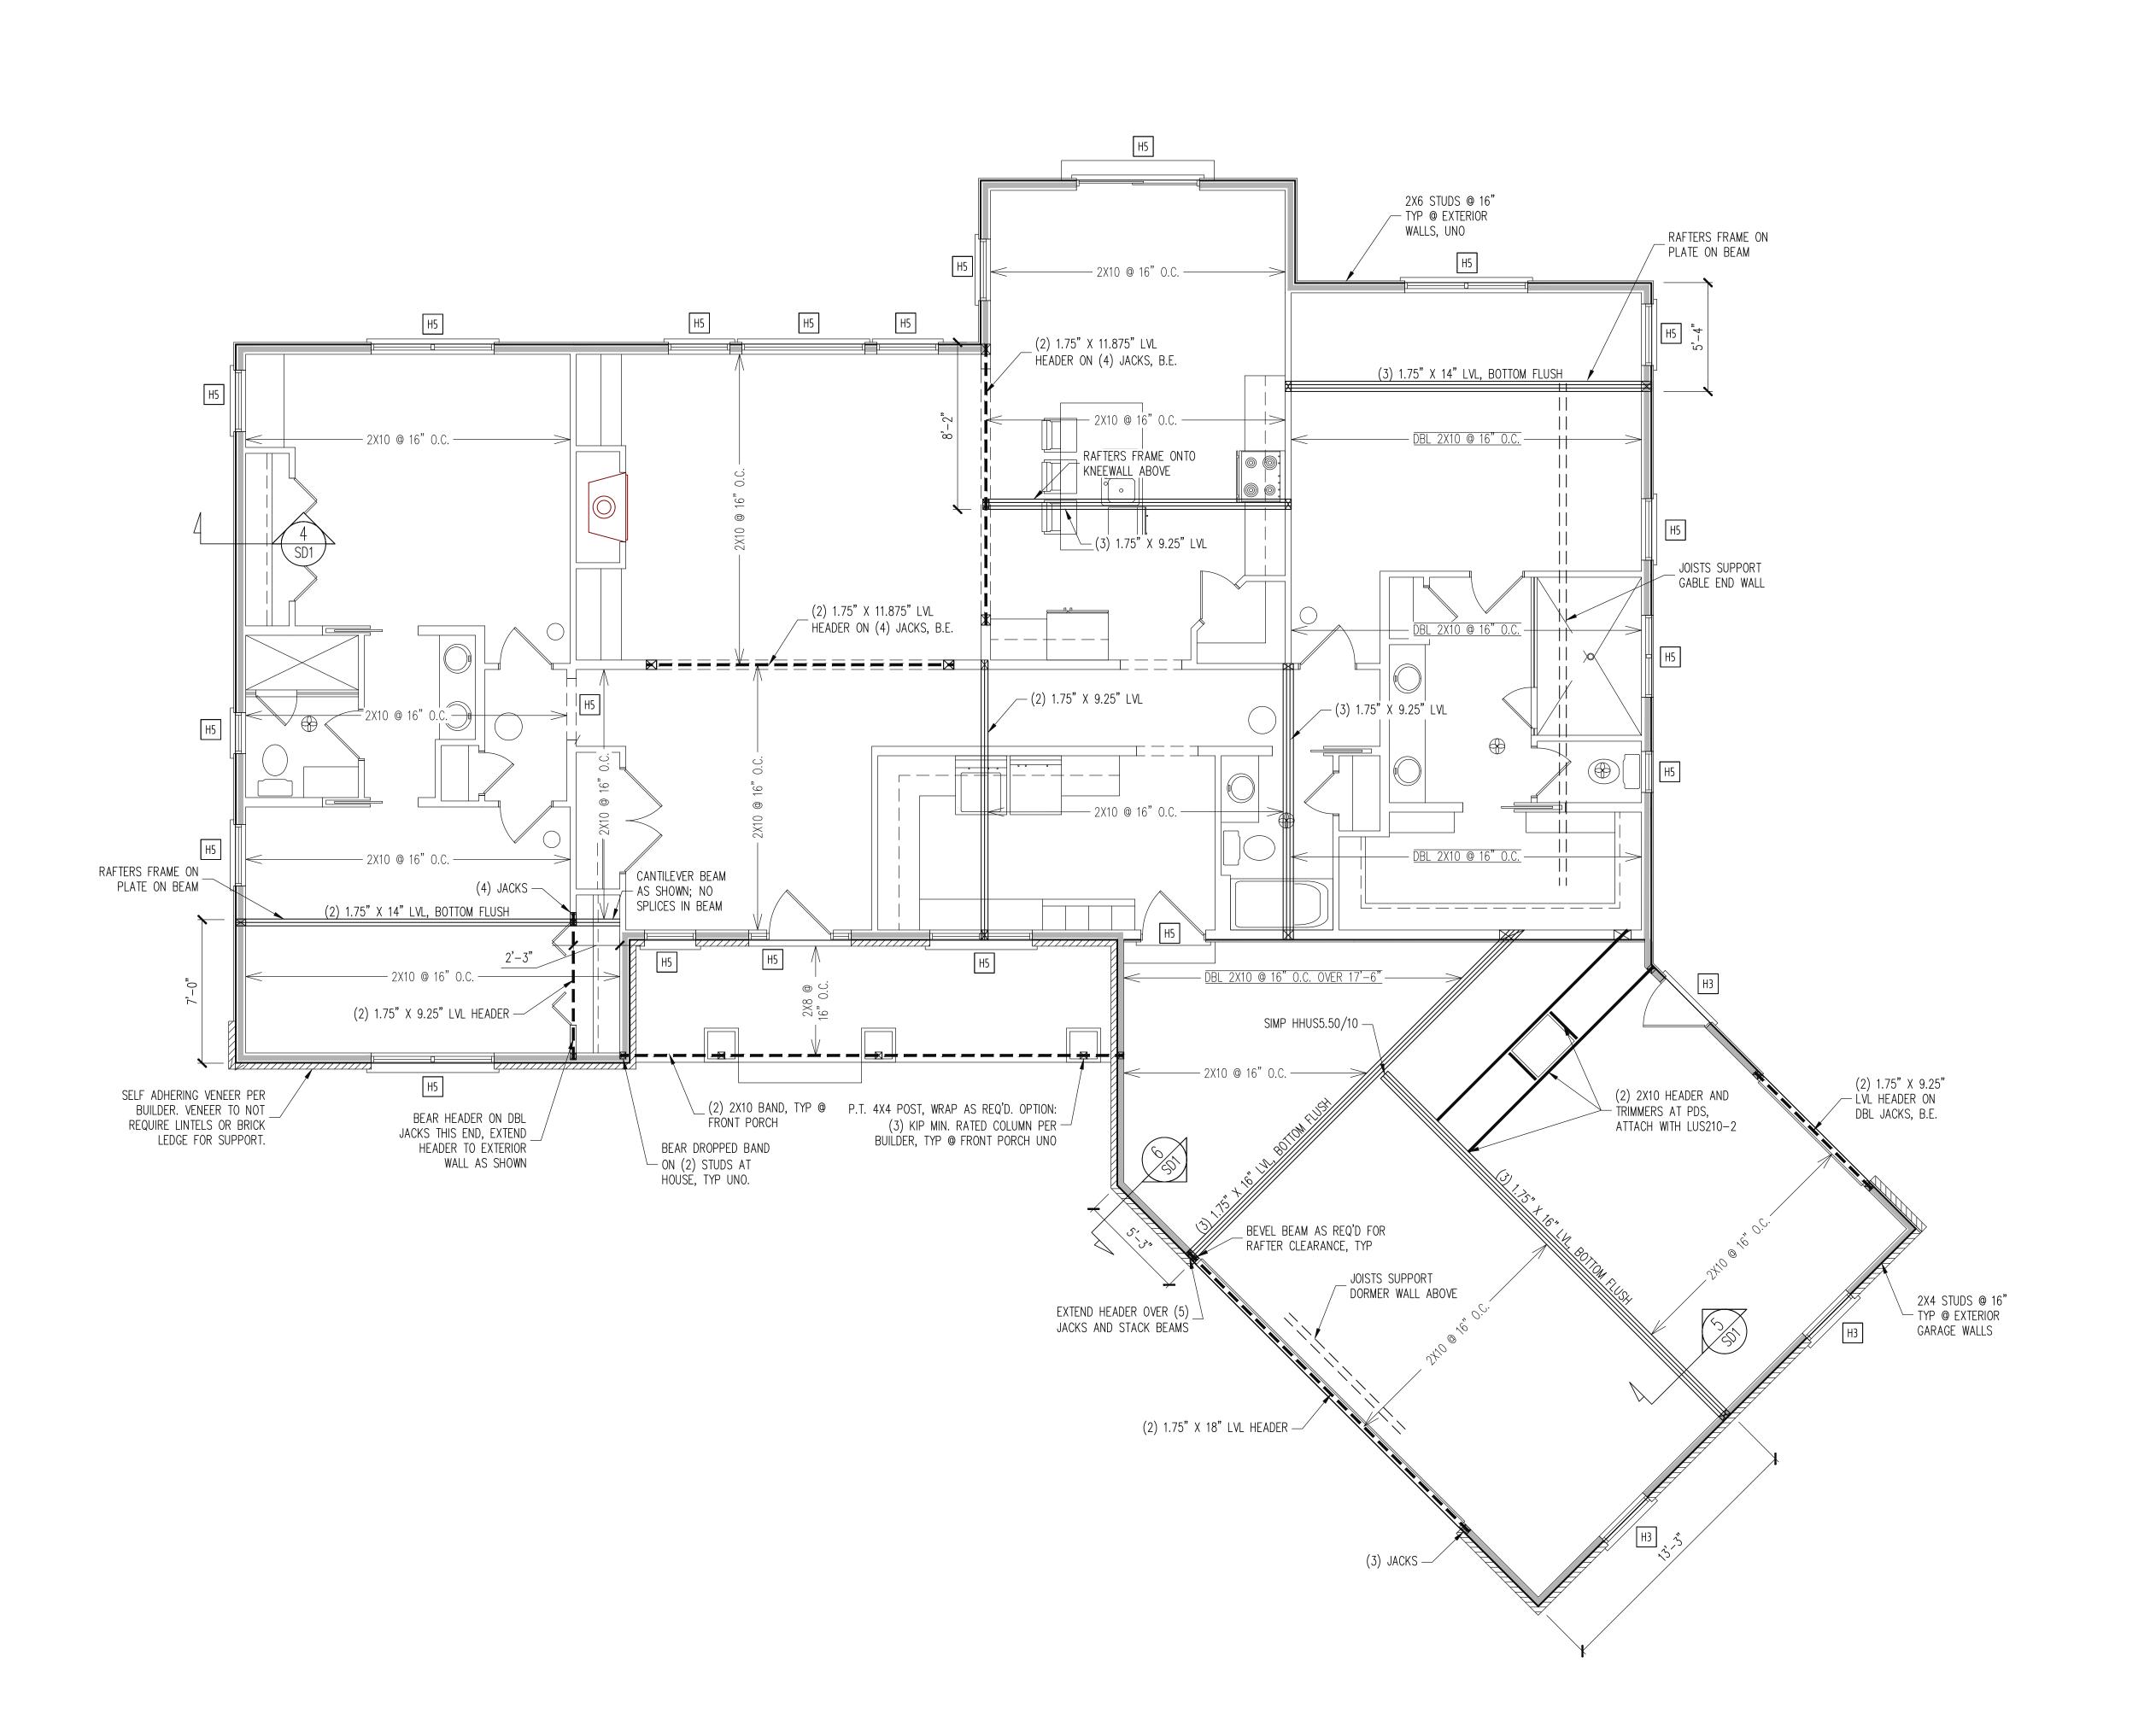

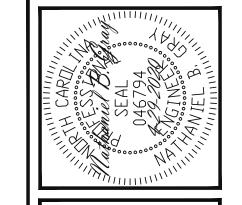

STRUCTURAL ENGINEE License No. C-38 183 Wind Chime Ct, Ste 1 Raleigh, North Carolina 276

ngineering 18 18 ech Ra

ASSOCIA

ARELY LOPEZ RESIDENCE
STRUCTURAL ADDENDUM
R DOWNS CIRCLE

ALL EXTERIOR STUD WALLS, EXTERIOR SIDE, ARE TO BE CONTINUOUSLY SHEATHED WITH 7/16 APA RATED OSB NAILED TO STUDS WITH 8d NAILS @ 6" O.C. AT PANEL EDGES, 12" O.C. IN PANEL FIELD.

CONSTRUCTION SPECIFICATIONS

INSTANT REFERENCES

REFER TO THE CONSTRUCTION SPECIFICATIONS SECTIONS FOR THE FOLLOWING INFORMATION:

PART 17: KING STUDS FOR EXTERIOR WALLS

SEE DETAIL / CONSTRUCTION SPECIFICATIONS
SHEETS FOR I—JOISTS ALLOWABLE SUBSTITUTIONS

WALL BRACING

PART 1.01: CURRENT GOVERNING CODE

PART 14: STUD SUPPORT FOR BEAMS

NOTES:

PROVIDED CONTINUOUS SHEATHING = 285' MIN.

REFERENCE PART 16.02 OF CONSTRUCTION SPECIFICATIONS FOR GENERAL WIND BRACING INFORMATION.

HEADER SCHEDULE

H1 SINGLE 2X4 TURNED FLAT (A)

SHADED WALLS:

- H2 (2) 2X4'S ON SINGLE JACKS (B)
- H3 (2) 2X10'S ON SINGLE JACKS (C)
- H4 (2) 1.75" X 9.25" LVL'S ON DBL JACKS
- H5 (3) 2X10'S ON SINGLE JACKS
- (A) TYPICAL FOR INTERIOR NON LOAD BEARING WALLS ONLY, ROUGH OPENING 38" MAX.
- (B) TYPICAL FOR INTERIOR NON LOAD BEARING WALLS ONLY, ROUGH OPNG 38" TO 74" MAX.
- (C) TYPICAL FOR ALL CONDITIONS NOT LISTED IN (A) OR (B) UNO.

NOTES:

-HEADERS IN NON LOAD BEARING INTERIOR
WALLS ARE NOT LABELED.

1ST FLOOR FRAMING PLAN

ENG: NBG/TRB

DATE: 7-16-2020


PLAN


PROJECT NO.

20-65-256

SHEET NO.

WALLS AND CEILING 1/4" = 1'-0"

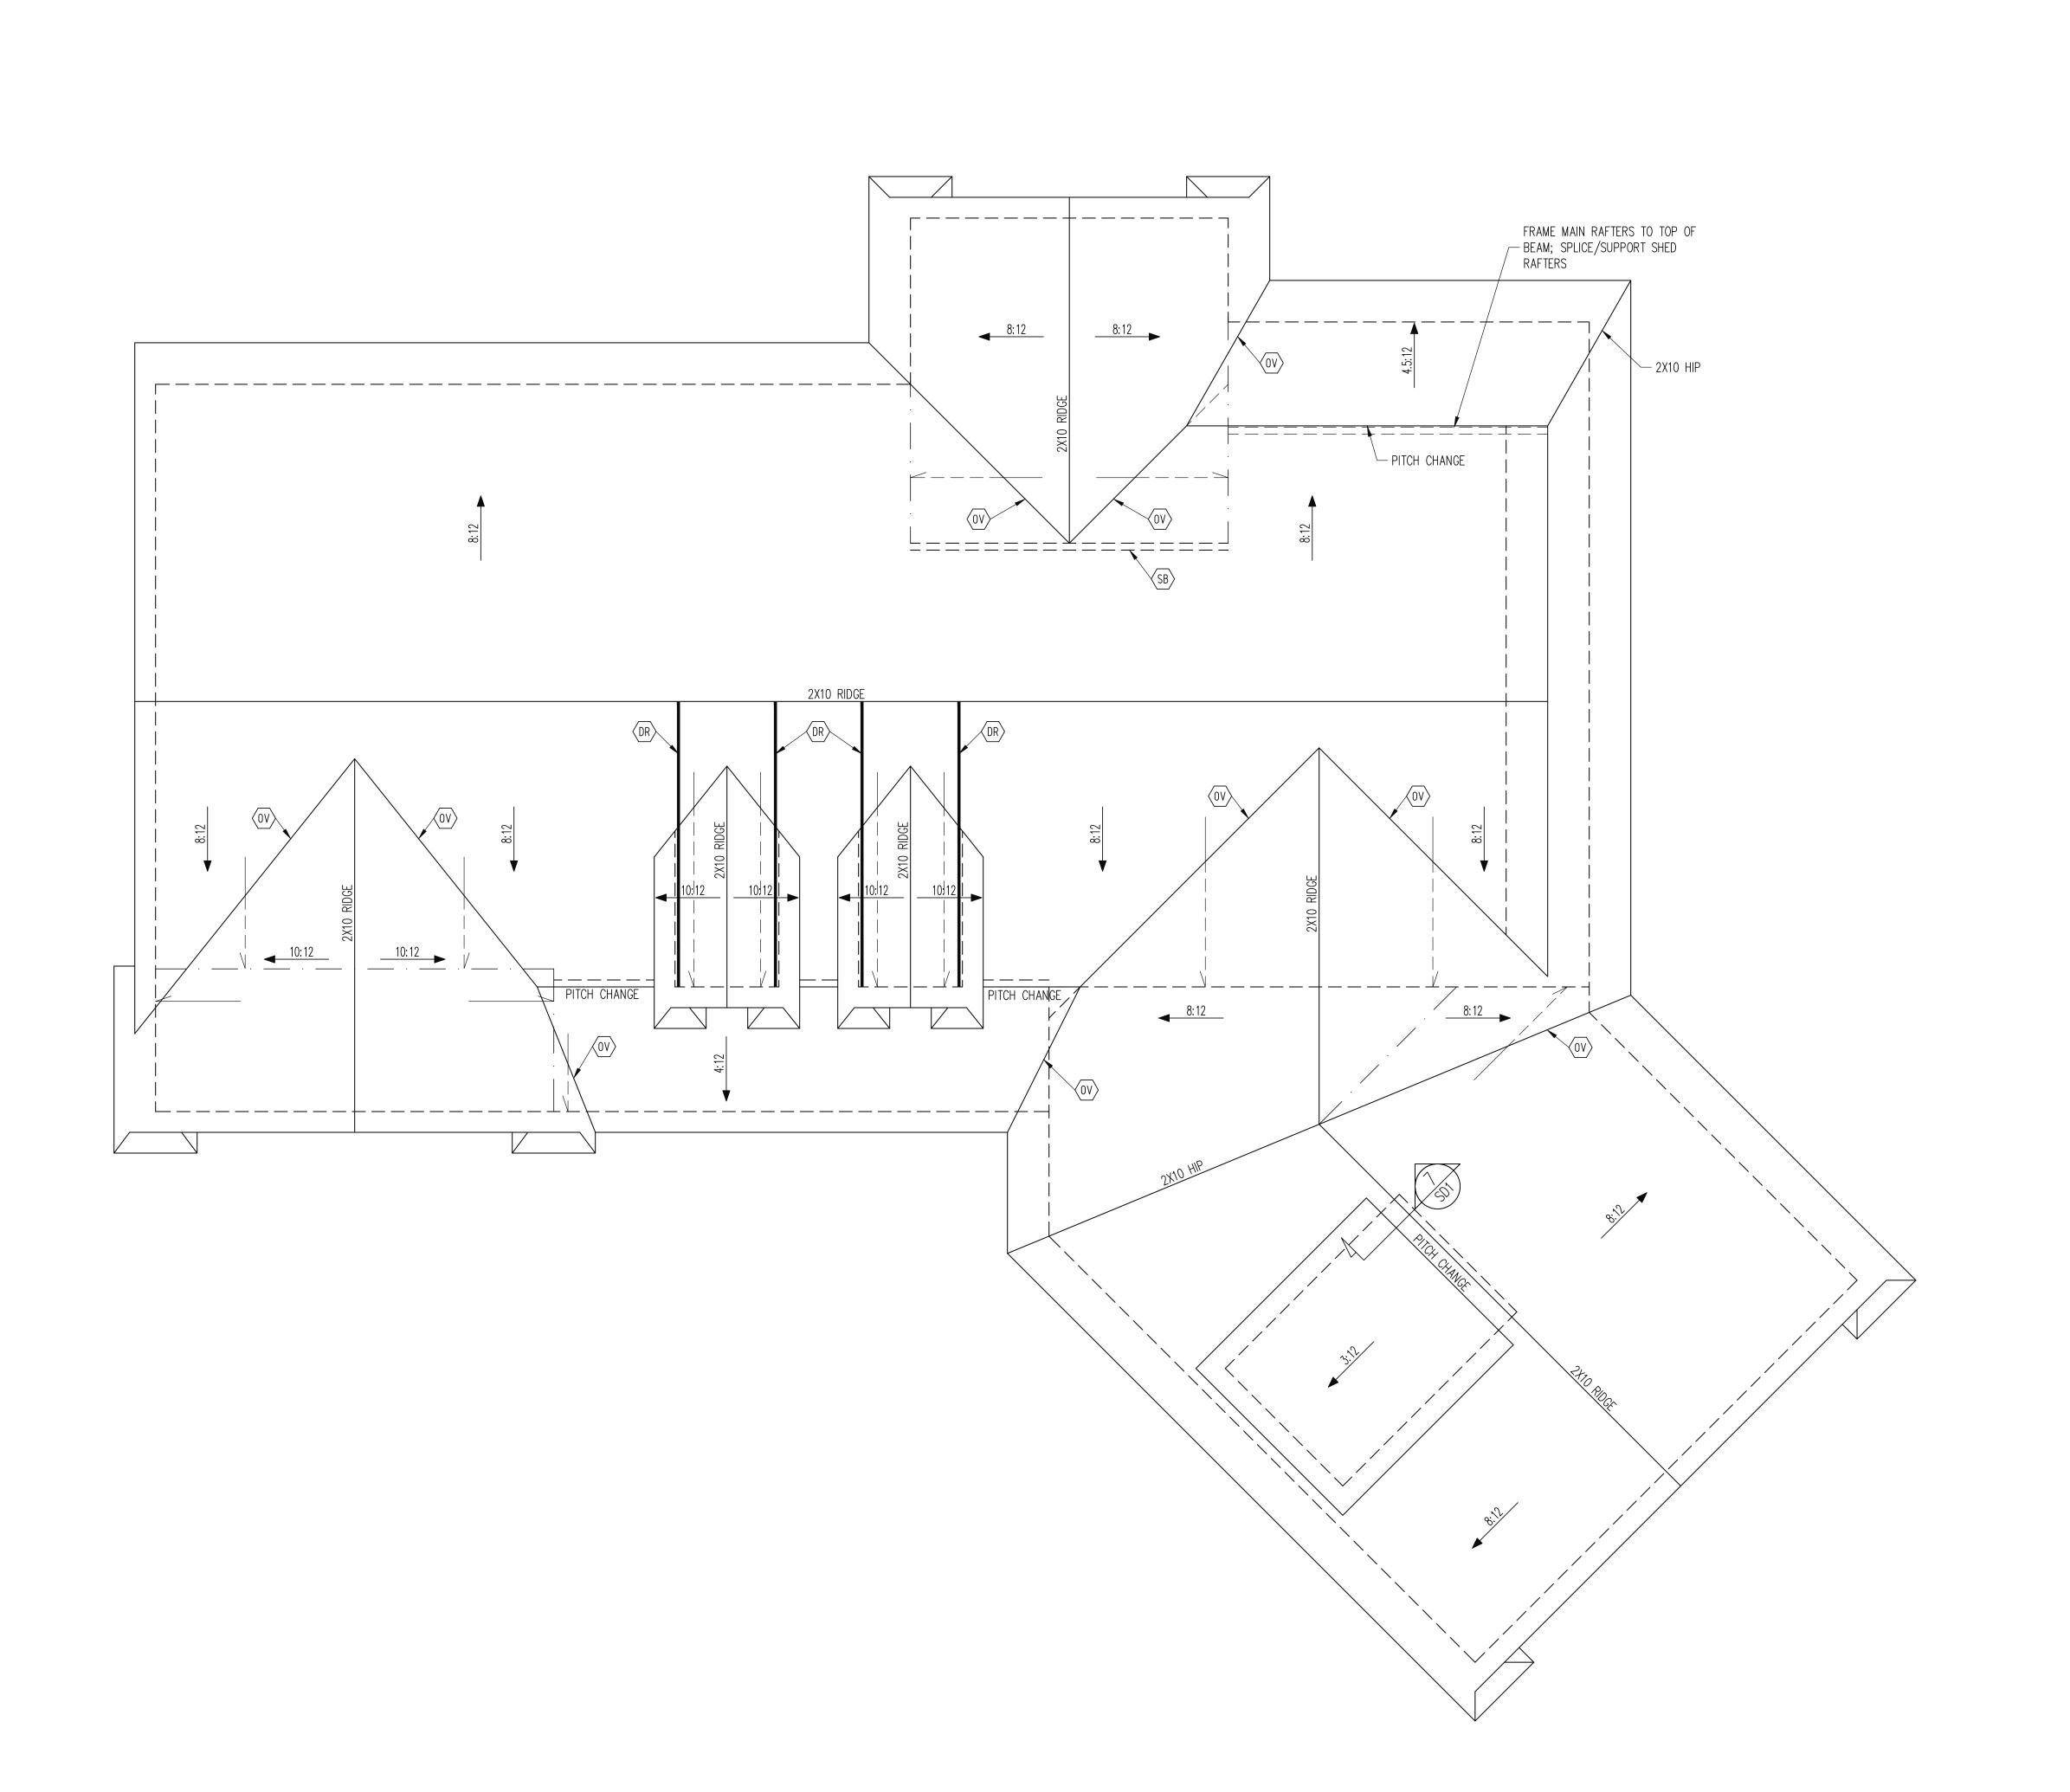

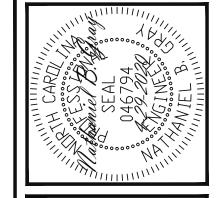

STRUCTURAL ENGINEERS
License No. C-3870
183 Wind Chime Ct, Ste 100
Raleigh, North Carolina 27615
Phone (919) 844-1661

Ingineering 183

PEZ RESIDENCE
AL ADDENDUM
IRCLE

ARELY LOPEZ RES STRUCTURAL ADD 2 BALFOUR DOWNS CIRCLE

ENG: NBG/TRB
DATE: 7-16-2020

PLAN

PROJECT NO. 20-65-256

SHEET NO.

ROOF FRAMING PLAN

1/4" = 1'-0"

FRAMING NOTES

ROOF ONLY

-COMMON RAFTERS 2X8 @ 16" O.C. TYP U.N.O.
-COLLAR TIES 2X4 EVERY 3RD SET OF RAFTERS
TYP U.N.O.
-VERIFY ROOF PITCHES, OVERHANG LENGTHS, AND
KNEEWALL FRAMING HGTS WITH ARCHITECTURAL
DRAWINGS, TYPICAL.

FRAMING SCHEDULE

ROOF ONLY

OV OVERFRAME VALLEY (2X10 SLEEPER)

SB SUPPORT/SPLICE RAFTERS ON BEAM BELOW

DR DOUBLE RAFTER

