**APPROVED** Limited building only review

Permit holder responsible for full compliance with the code

06/11/2020






NOTE: PLANS DESIGNED UNDER 2018 NORTH CAROLINA RESIDENTIAL CODE.

- PLANS TO BE DESIGNED UNDER 2018 NORTH CAROLINA
- RESIDENTIAL CODE.
- HOUSE DESIGNED FOR 115 MPH 3 SECOND GUST (89FASTEST WIND), EXPOSURE B
- ANCHOR BOLTS SHALL BE MIN. 1/2" DIAMETER & SHALL EXTEND A MINIMUM 7" INT
- ANCHOR BOLTS TO BE NO MORE THAN 6' O.C. AND WITHIN 12" OF THE CORNER

- WALL BRACING IS REQUIRED . DESIGNER MUST SPECIFY METHOD OF BRACING PER SECTION R602 (NC 2012 RESIDENTIAL BUILDING CODE ) AND PROVIDE DETAIL

MEAN ROOF HEIGHT = < 30'-0" COMPONENT & CLADDING DESIGNED FOR THE FOLLOWING LOADS MEAN ROOF HEIGHT UP TO 30' 40'-1" - 45' 18.5, -20.2 ZONE 2 18.5, -23.5 ZONE 3 16.5, -21.0 17.3, -22.1 18.0, -22.9 18.5, -23.5 ZONE 4 18.0, -19.5 18.9, -20.5 19.6, -21.3 20.2, -21.8 19.6, -26.3 20.2, -27.0

MINIMUM VALUE\$ FOR ENERGY COMPLIANCE:

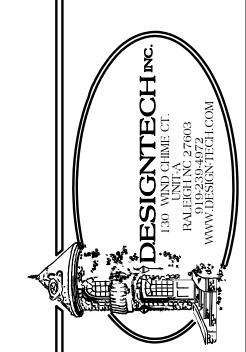

**REVISIONS:** 

NAME:

DRAWN BY:

CHECKED BY:

10-1291-DT

RKR

JCD DATE: 5-27-20 PLAN NO.

DATE:

RIDGE VENT ZONE 5 18.0, -24.1 18.9, -25.3 RIDGE VENT MAX GLAZING U-FACTOR = 0.35 CEILING R-38 WALLS R-15 FLOORS R-19 RIDGE VENT 6'-8" (U.N.O.) WINDOW HGT TYP. **BRACKETS BY** BLDR. (TYP.) FIBER-CEMENT SIDING W/ 5/4" X 4" TRIM (TYP.) **GRADE** PROVIDE STEPS AND 8" MIN MASONRY 5/4" X 4" RAIL AS PER GRADE — FIBER-CEMENT FROM GRADE TO PARGED FOUNDATION— TRIM TYP. SIDING W/ 5/4" X 4" SIDING (TYP.) 5 (TYP.) TRIM (TYP.) 8" COL.BY

# FRONT ELEVATION

SCALE: 1/4"=1'-0"

-SEE ROOF PLAN FOR KNEEWALL HEIGHTS AND LOCATIONS.

BLDR. (TYP.)

-GRADE LINES ARE ASSUMED. VERIFY WITH FINAL GRADING PLAN.

#### ACCESSORIES LEGEND

PROVIDE BLOCKING FOR:

TB = TOWEL BAR TP = TOILET PAPER

TR = TOWEL RING NOTE:

SELECTION BY OWNER PER BUILDER CONTRACT SPECIFICATIONS

MR = MAGAZINE RACK

FIBERGLASS SHINGLES AS SPEC.

(CLASS "C" MIN.) TYP.

MC = MEDICINE CABINET

ABV.: ABOVE C.O.: CASED OPENING REFG.: REFRIGERATOR D.W.: DISHWASHER T.B.D.: TO BE DETERMINED

**BOARD & BATTEN** 

SIDING W/ 5/4" X 4"

TRIM (TYP.)

FIBER-CEMENT

HGT.: HEIGHT W.I.C.: WALK IN CLOSET D.O.: DOUBLE OVEN W: WASHER WD.: WOOD D: DRYER

#### LIST OF ABBREVIATIONS

SHWR.: SHOWER CONT.:CONTINUOUS DN.: DOWN CONC.: CONCRETE K.S.: KNEE SPACE COL.: COLUMN TYP.: TYPICAL ELLIP.: ELLIPSE CLG.: CEILING W/: WITH

CMD= CARBON MONOXIDE DETECTOR TRANS.: TRANSOM CANT.: CANTILEVER M.O.: MASONRY OPENING

5S= 5 SHELVES

1R/1S = 1 ROD AND 1 SHELF

SD= SMOKE DETECTOR

2R/2S = 2 RODS AND 2 SHELVES

### GENERAL PLAN NOTES

- 1.) SEE CHAPTER 6 OF 2018 NCRC FOR WALL CONSTRUCTION.
- 2.) TEMPERED GLASS TO BE USED AT ALL SAFETY 6.) VERIFY ALL WINDOW SIZES, RADIUS, AND REQUIRED LOCATIONS ACCORDING TO 2018 NCRC SECTION R308.4.
- PER TABLE 302.6 OF 2018 NCRC.
- 4.) ALL HABITABLE ROOMS SHALL MEET LIGHT/VENTILATION & EGRESS AS REQUIRED IN 2018 NCRC SECTIONS R303.1 AND R310
- 5.) ALL ANGLED WALLS ARE 45° UNLESS NOTED 9.) ALL CABINET DESIGNS/LAYOUTS TO BE OTHERWISE.
- DETAILS WITH CHOSEN MANUFACTURE.
- 3.) DWELLING/GARAGE FIRE SEPARATION SHALL 7.) LOCATE DORMER FACE TO ALLOW 4" MIN. BELOW WINDOW FRAME.

8.) FLOOR PLAN NOTATIONS GOVERN OVER

ELEVATION SCALE.

10.) ALL FLOOR COVERINGS AND FINISHES BY OWNER/ BLDR. COORDINATE HEIGHTS DUE TO THICKNESS CHANGES.

VERIFIED WITH OWNER VIA SHOP DRAWINGS

FROM CABINET MANUF.

- 11.) ALL WINDOW GLAZING TO HAVE 0.32 U-FACTOR 14.) FINISHES OF ALL INTERIOR BASE BOARD, CLG. MIN. SEE TABLE E-4A, E-4B
- 12.) FINISHES OF SCREEN PORCH COLUMNS, RAILS, FLOORS . CEILINGS :SCREEN DOOR SYSTEM.AND DOOR TO PORCH BY BLDR. & OWNER, PER **CONTRACT SPECIFICATIONS**
- 13.) FINISHES FOR CLOSET SHELVING AND ROD BY BLDR. & OWNER, PER CONTRACT SPECIFICATIONS
  - DETAIL / MOLDING, OPENING DETAILS, PASS-THRUS, WAINSCOTTING DETAILS BY BLDR. & OWNER, PER CONTRACT **SPECIFICATIONS**

AREA CALCULATIONS			
HEATED (SQ. FT.)		UNHEATED (SQ. FT.)	
BASEMENT:	N/A	GARAGE:	N/A
1ST FLOOR:	1291	SCR. PORCH:	N/A
2ND FLOOR:	N/A	PORCH:	94
ATTIC:	N/A	PATIO:	162
		BRICK:	N/A
TOTAL: (HEATED)	1292	TOTAL: (UNHEATED)	156
OVERALL DIMENSION		UNFINISHED (SQ. FT.)	
WIDTH:	47'-10"	BASEMENT:	N/A
DEPTH:	40'-4"	REC ROOM:	N/A
		ATTIC:	N/A

STORAGE:

38


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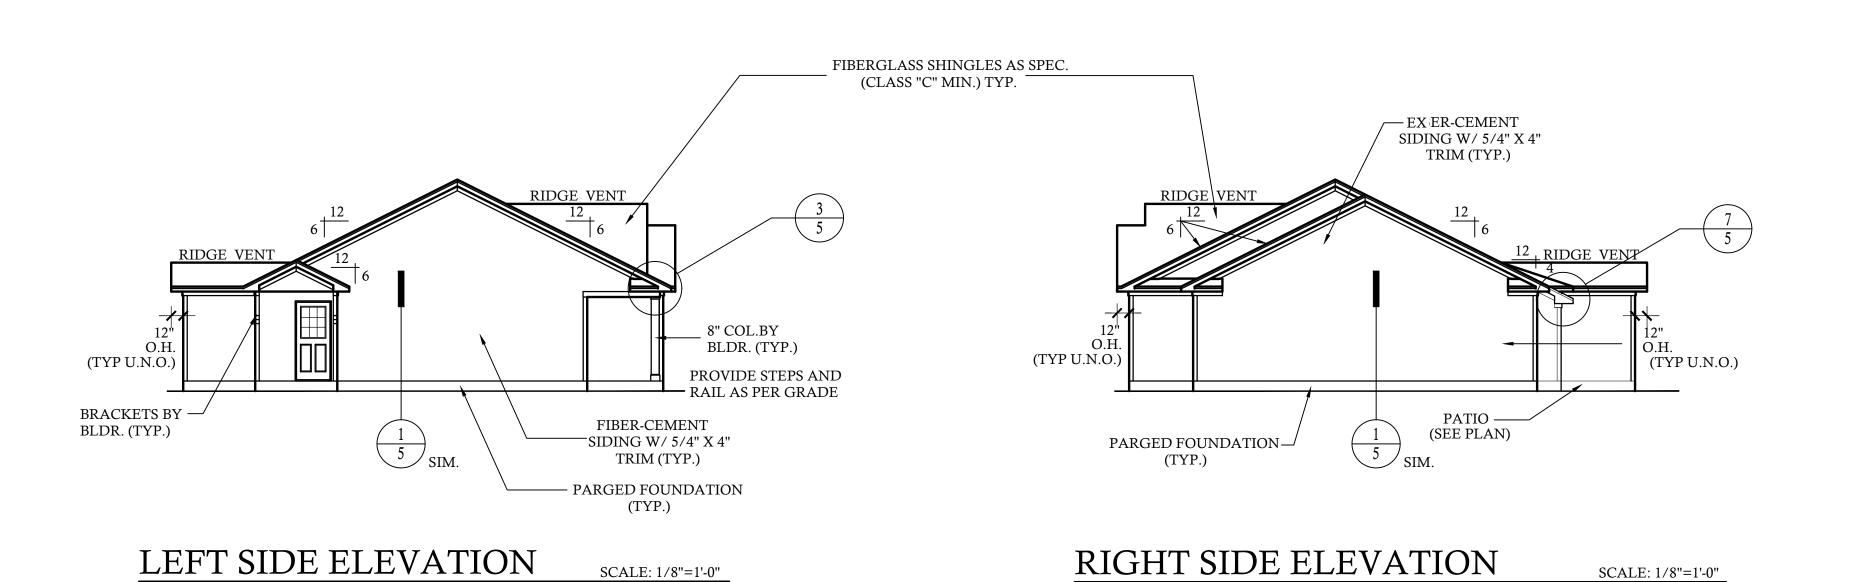
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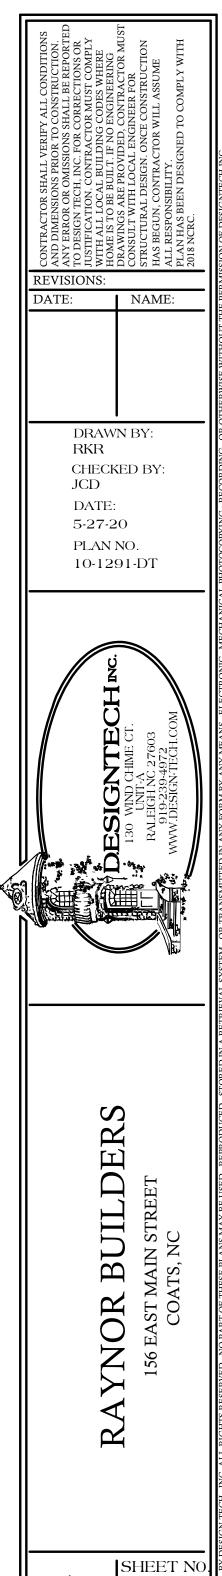
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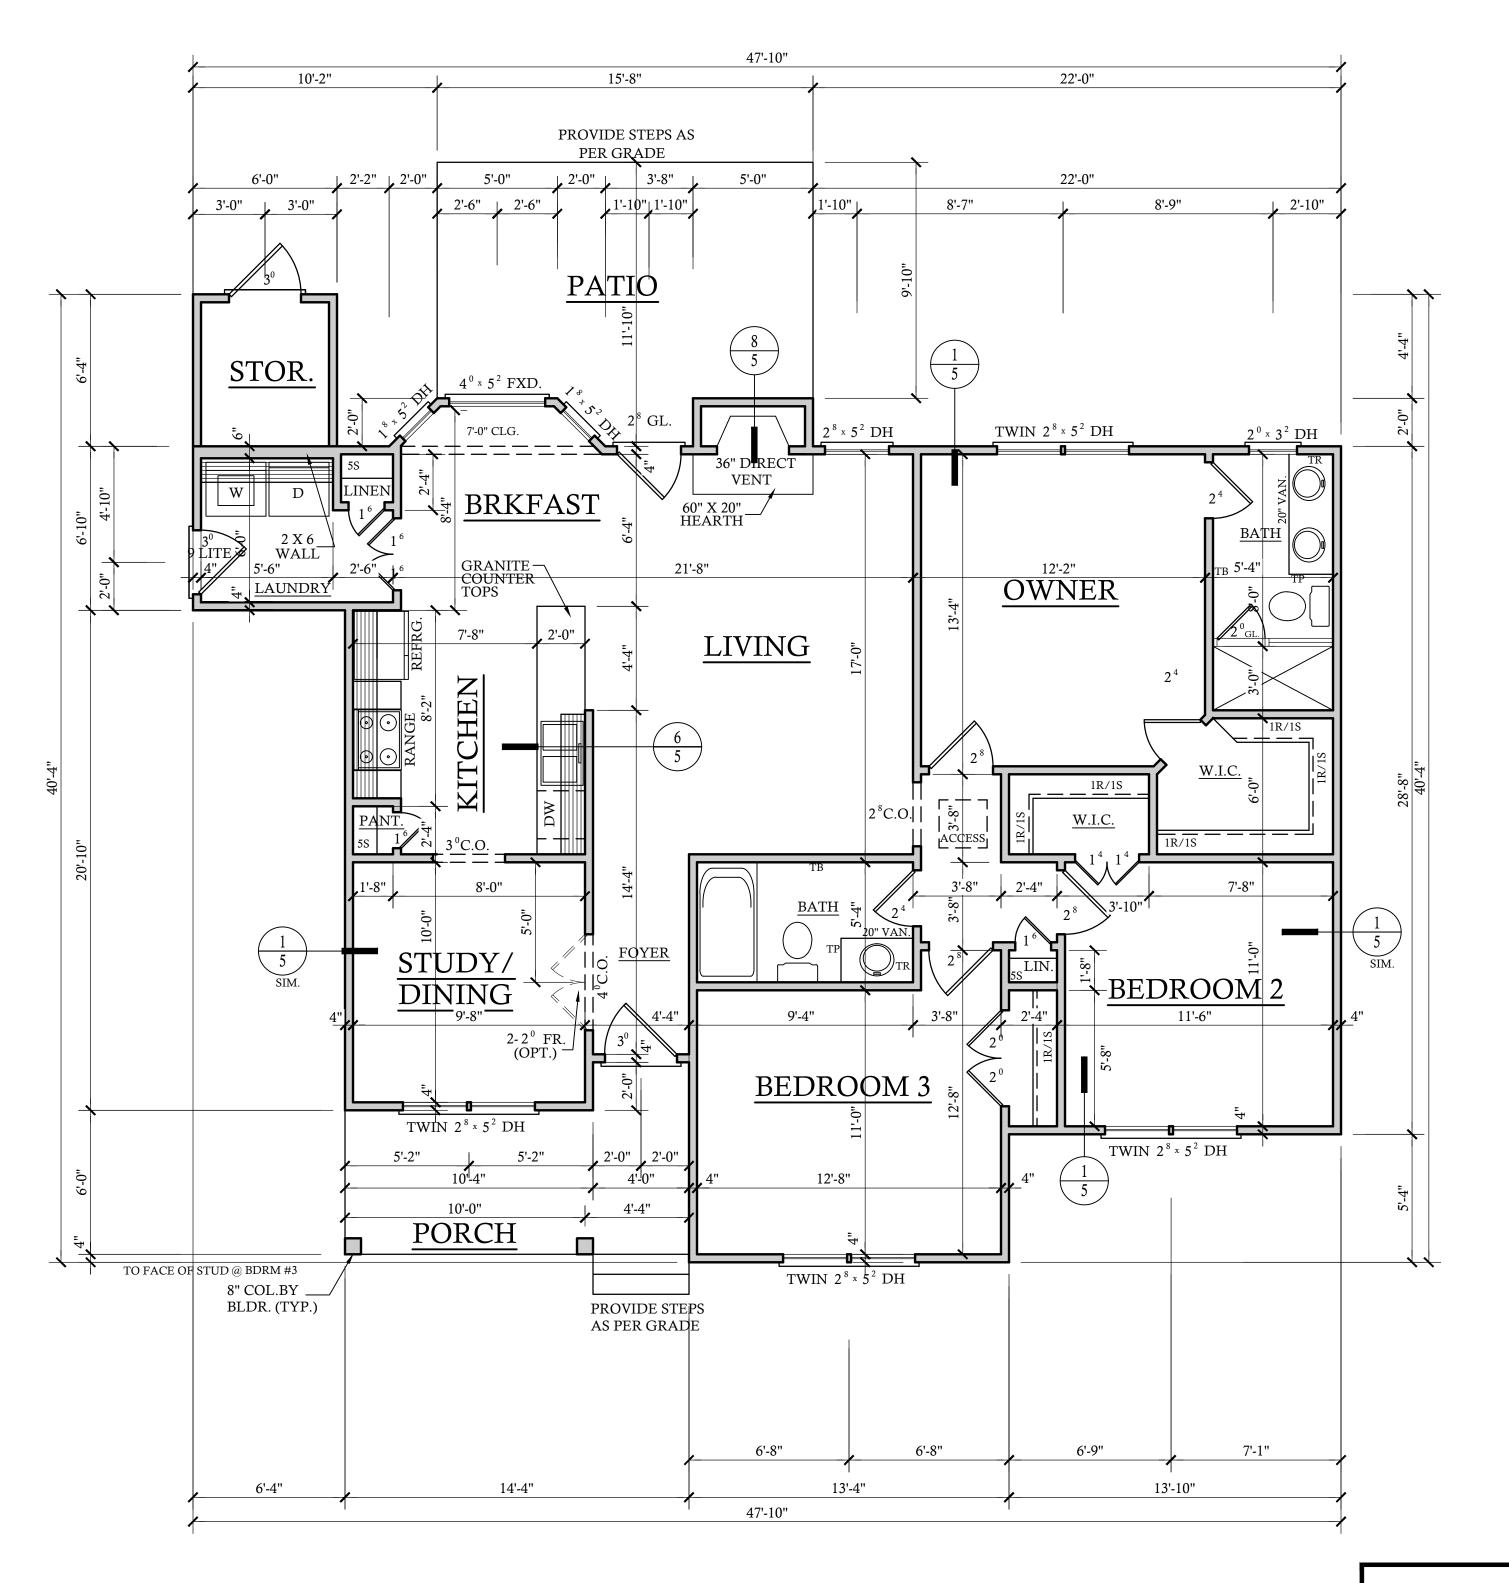
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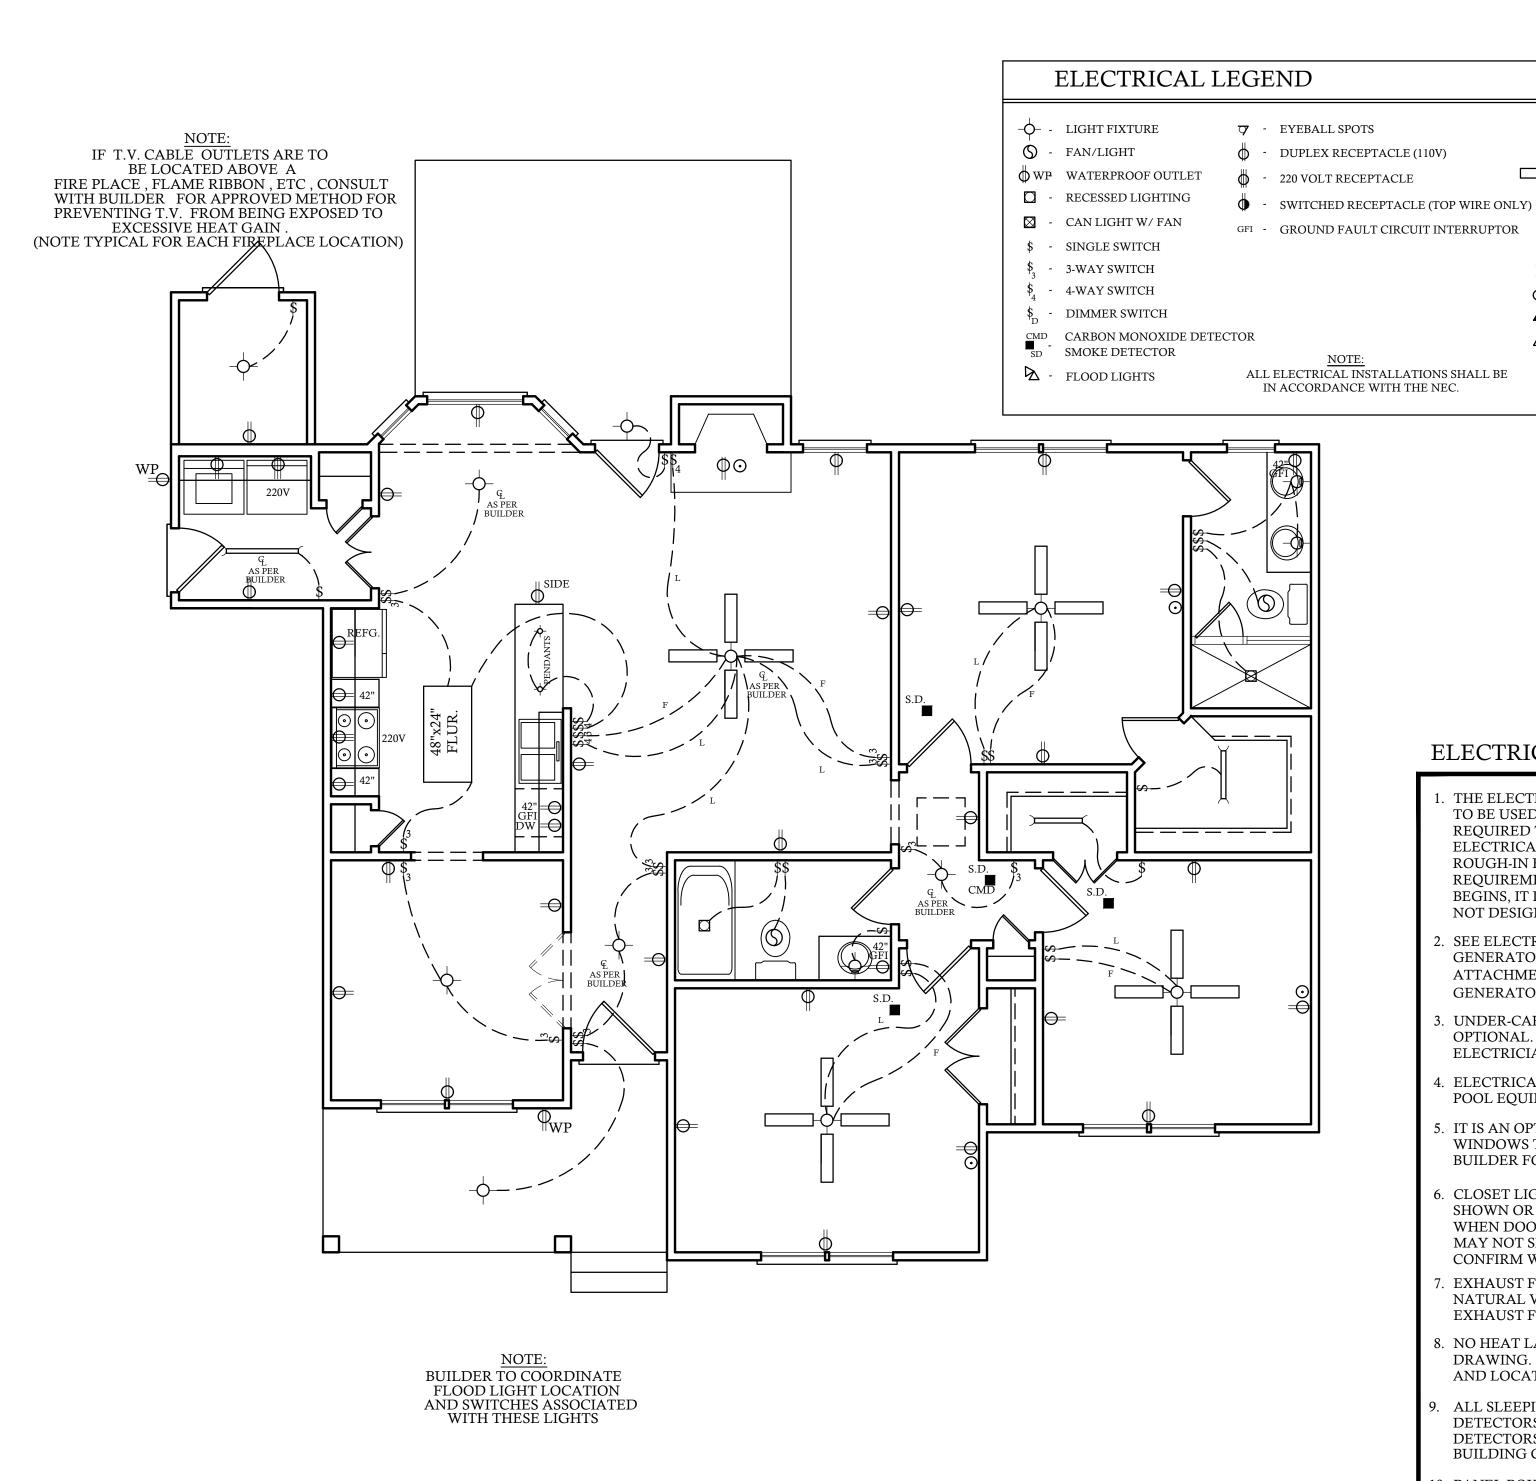


**REVISIONS:** DATE: NAME: DRAWN BY: RKR CHECKED BY: JCD DATE: 5-27-20 PLAN NO. 10-1291-DT ERS RAYNOR BUILD 156 EAST MAIN STREET COATS, NC

FIRST FLOOR PLAN

SCALE: 1/4"=1'-0"

8'-0" CLG. HGT. U.N.O. SET WINDOWS @ 6'-8" U.N.O. A D SHEET NO OF 7

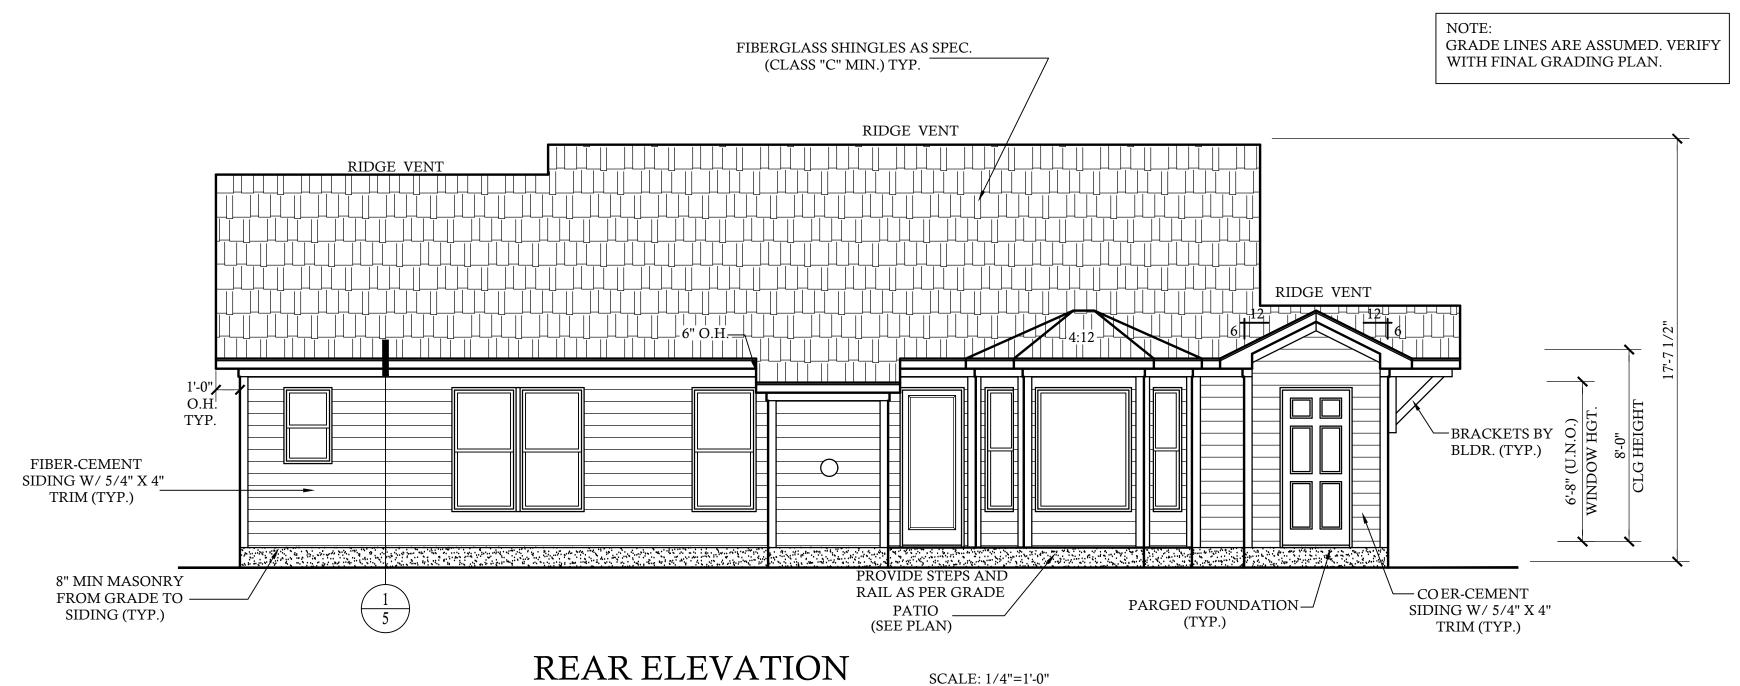

#### **ELECTRICAL NOTES:**

1. THE ELECTRICAL DIAGRAMS SHOWN ON THESE PLANS ARE TO BE USED AS A GUIDE. HOME OWNER AND BUILDER ARE REQUIRED TO REVIEW AND CONFIRM WITH LICENSED ELECTRICAL CONTRACTOR THESE CONTENTS PRIOR TO ROUGH-IN FOR CODE COMPLIANCE AND SPECIAL REQUIREMENTS BY THE HOME OWNER. ONCE CONSTRUCTION BEGINS, IT IS THE RESPONSIBILITY OF THE CONTRACTOR, NOT DESIGN TECH, INCORPORATED.

- CLG FAN/LIGHTS

- CABLE OUTLET

☐ - INTERCOM

TELEPHONE OUTLET

COMPUTER DATA OUTLET

TRACK LIGHTS


FLUORESCENT LIGHTING

- 2. SEE ELECTRICIAN, BUILDER, AND OWNER FOR POSSIBLE GENERATOR LOCATION, SWITCHES, RECEPTACLES, AND ATTACHMENTS. COORDINATE SIZE AND MODEL OF GENERATOR TO HANDLE LOADS ADEQUATELY.
- 3. UNDER-CABINET COUNTER LIGHTING FOR KITCHEN IS OPTIONAL. PLEASE CONFIRM WITH CABINET MAKER AND ELECTRICIAN.
- 4. ELECTRICAL FOR EXTERIOR LANDSCAPE LIGHTING AND POOL EQUIPMENT BY BUILDER AS PER CODE.
- 5. IT IS AN OPTION FOR EVERY TOP RECEPTACLE AT FRONT WINDOWS TO BE ON ONE SWITCH LOCATED BY OWNER/BUILDER FOR WINDOW DECORATION LIGHTING.
- 6. CLOSET LIGHTING TO BE CONTROLLED BY SWITCH AS SHOWN OR IN-JAMB SWITCH WHICH WOULD ILLUMINATE LIGHT WHEN DOOR IS OPENED. SOME ELECTRICAL PLANS MAY OR MAY NOT SHOW CLOSET LIGHTING. SEE OWNER AND CONFIRM WITH BUILDER.
- 7. EXHAUST FANS ARE REQUIRED IN BATHROOMS WITHOUT NATURAL VENTILATION. OUR PLANS WILL ALWAYS SHOW EXHAUST FAN.
- 8. NO HEAT LAMPS OR HEATERS MAY BE SHOWN IN THIS DRAWING. PLEASE CONFIRM WITH BUILDER FOR PRESENCE AND LOCATION.
- ALL SLEEPING AREAS/BEDROOMS SHOULD CONTAIN SMOKE DETECTORS. SOME CORRIDORS ALSO REQUIRE SMOKE DETECTORS. PLEASE SEE LOCAL, STATE, AND FEDERAL BUILDING CODES TO CONFIRM THESE REQUIREMENTS.
- 10. PANEL BOX LOCATION BY ELECTRICIAN/BUILDER AS PER CODE.

CONTRACTOR SHALL VERIFY ALL CONDITIONS AND DIMENSIONS PRIOR TO CONSTRUCTION.
AND DIMENSIONS PRIOR TO CONSTRUCTION.
TO DESIGN TECH, INC. FOR CORRECTIONS OR JUSTIFICATION. CONTRACTOR MUST COMPLY WITH ALL LOCAL BUILDING CODES WHERE HOME IS TO BE BUILT. IF NO ENGINEERING DRAWINGS ARE PROVIDED, CONTRACTOR MUST CONSULT WITH LOCAL ENGINEER FOR STRUCTURAL DESIGN. ONCE CONSTRUCTION HAS BEGUN, CONTRACTOR WILL ASSUME ALL RESPONSIBILITY.

DATE: NAME:


DRAWN BY: RKR CHECKED BY: JCD DATE: 5-27-20 PLAN NO. 10-1291-DT

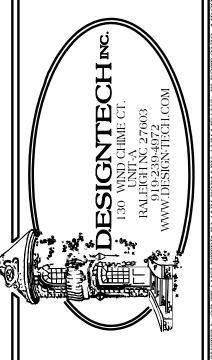

RAYNOR BUILDEI
156 EAST MAIN STREET

SHEET NO

FIRST FLOOR ELECTRICAL PLAN

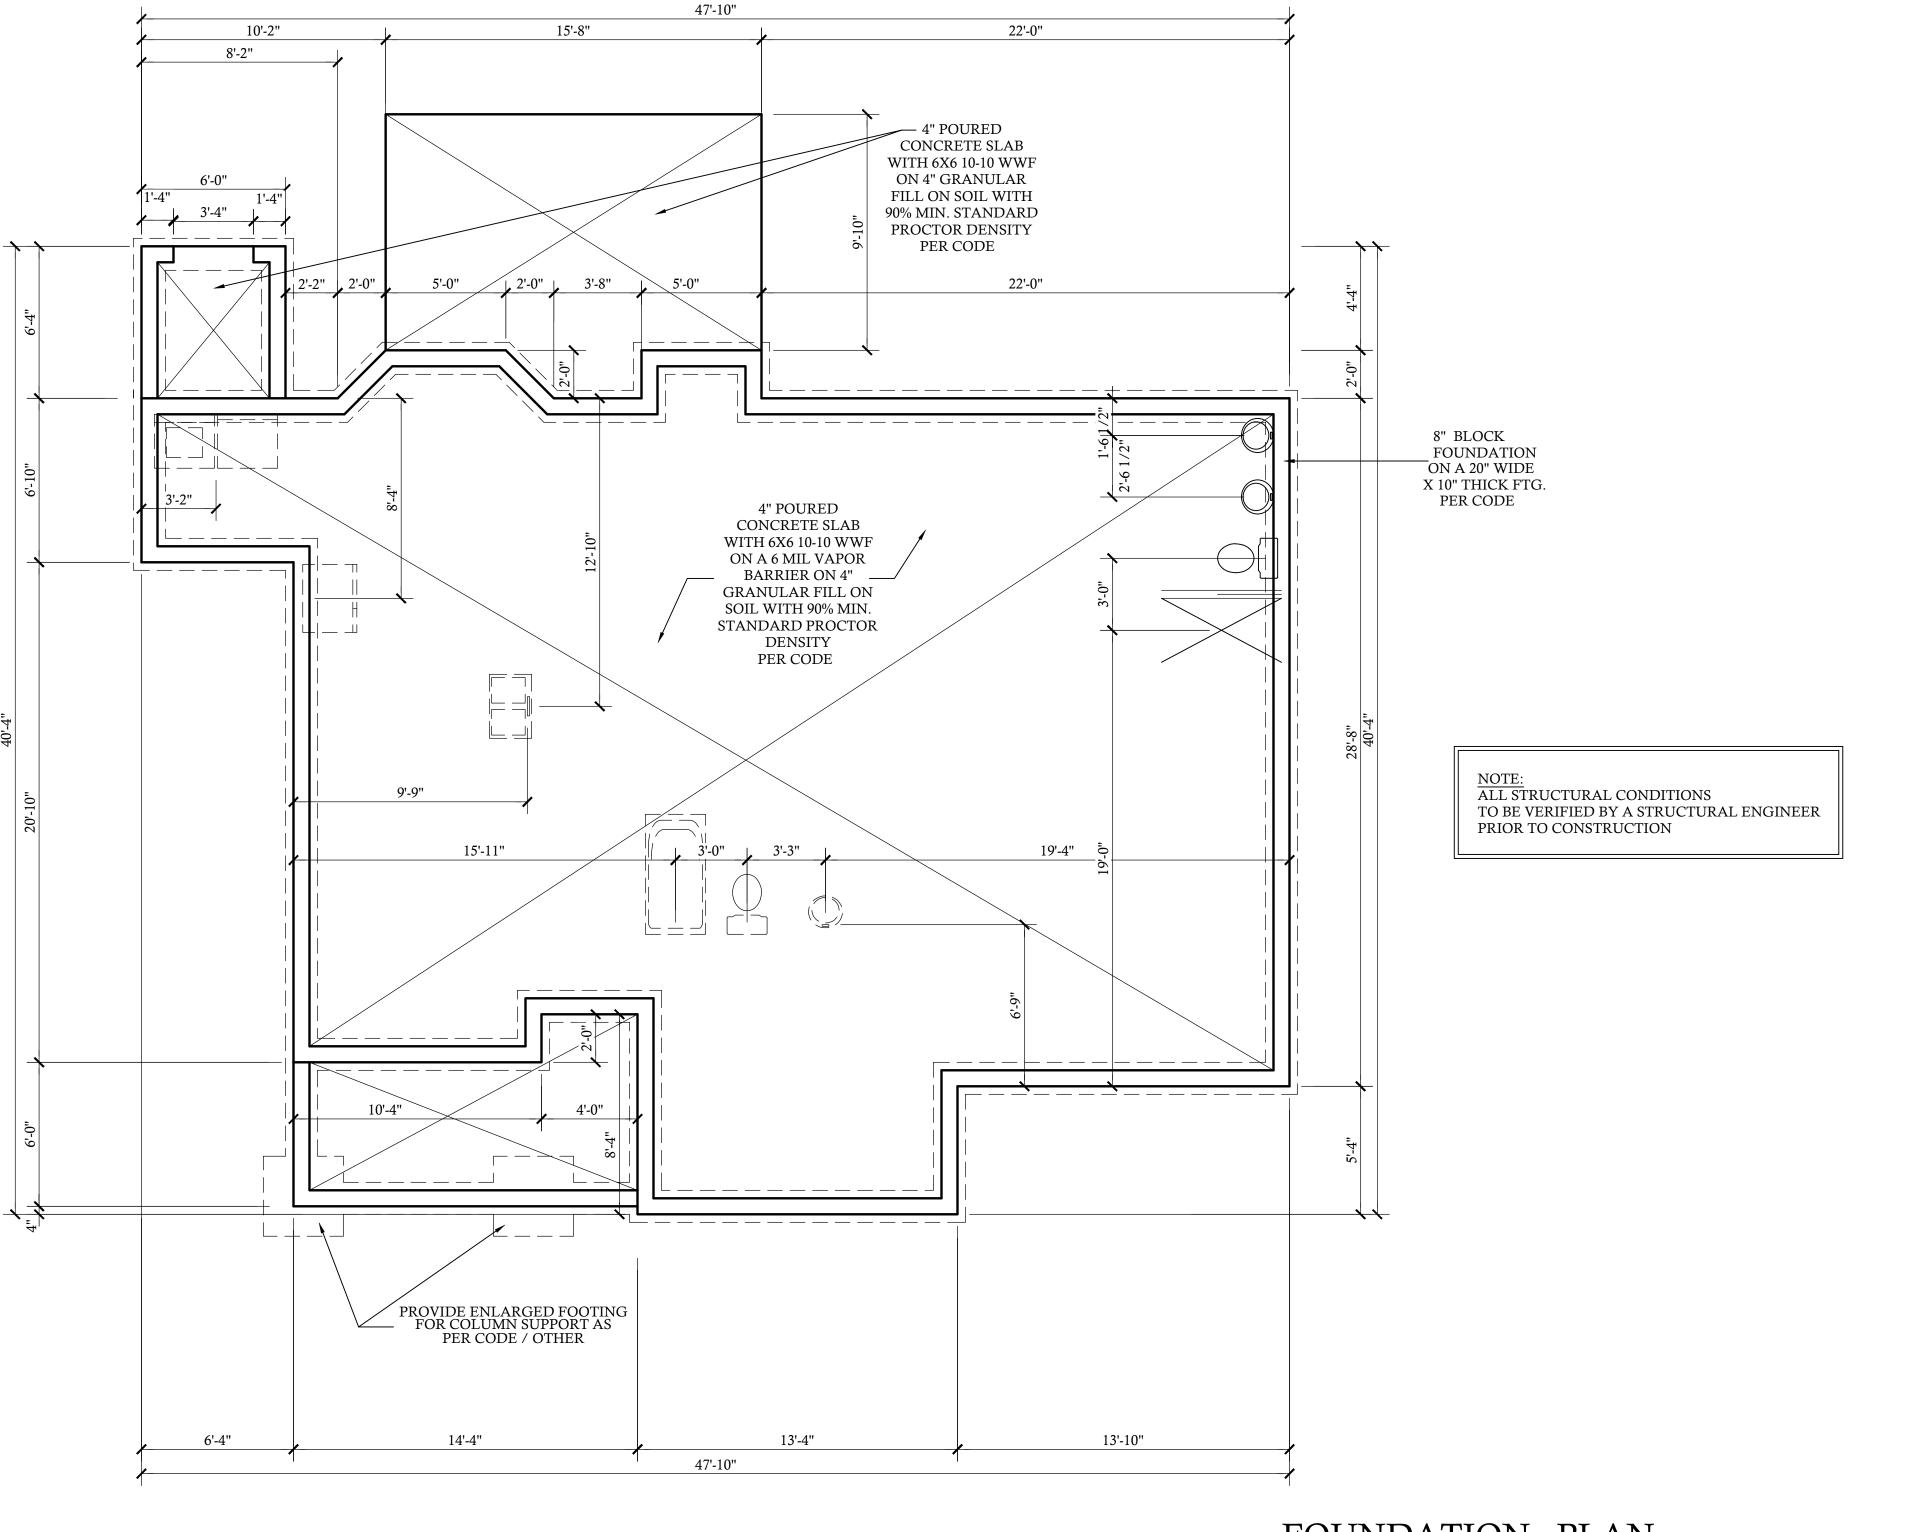


**REVISIONS:** DATE: NAME: DRAWN BY: RKR CHECKED BY: JCD DATE: 5-27-20 PLAN NO. 10-1291-DT ERS RAYNOR BUILD 156 EAST MAIN STREET COATS, NC SHEET NO

FOUNDATION PLAN

SCALE: 1/4"=1'-0"


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NOTE:
ALL STRUCTURAL CONDITIONS
TO BE VERIFIED BY A STRUCTURAL ENGINEER
PRIOR TO CONSTRUCTION

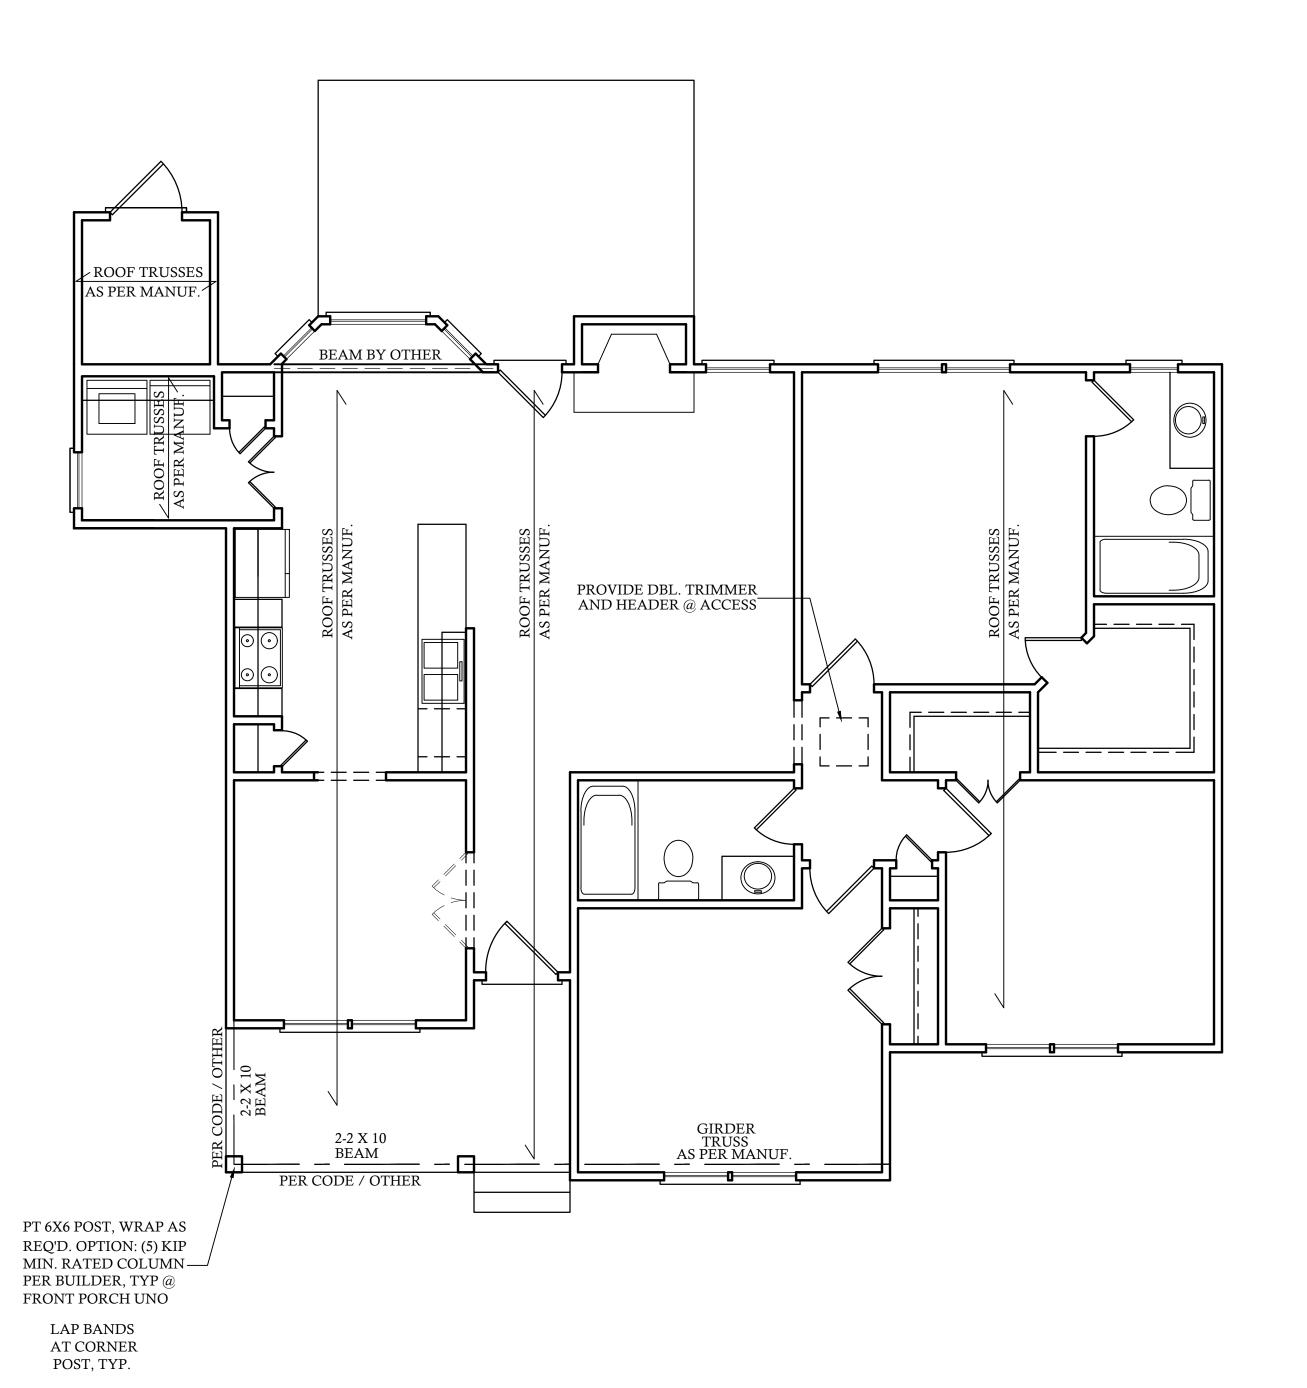DATE: NAME: DRAWN BY: RKR CHECKED BY: JCD DATE: 5-27-20 PLAN NO. 10-1291-DT ERS 156 EAST MAIN STREET COATS, NC RAYNOR BUILD

 $\begin{array}{c|c} \textbf{A} & \hline \\ \textbf{B} & \hline \\ \textbf{D}_{@} & \hline \\ OF & 7 \\ \end{array}$ 




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DATE: NAME:
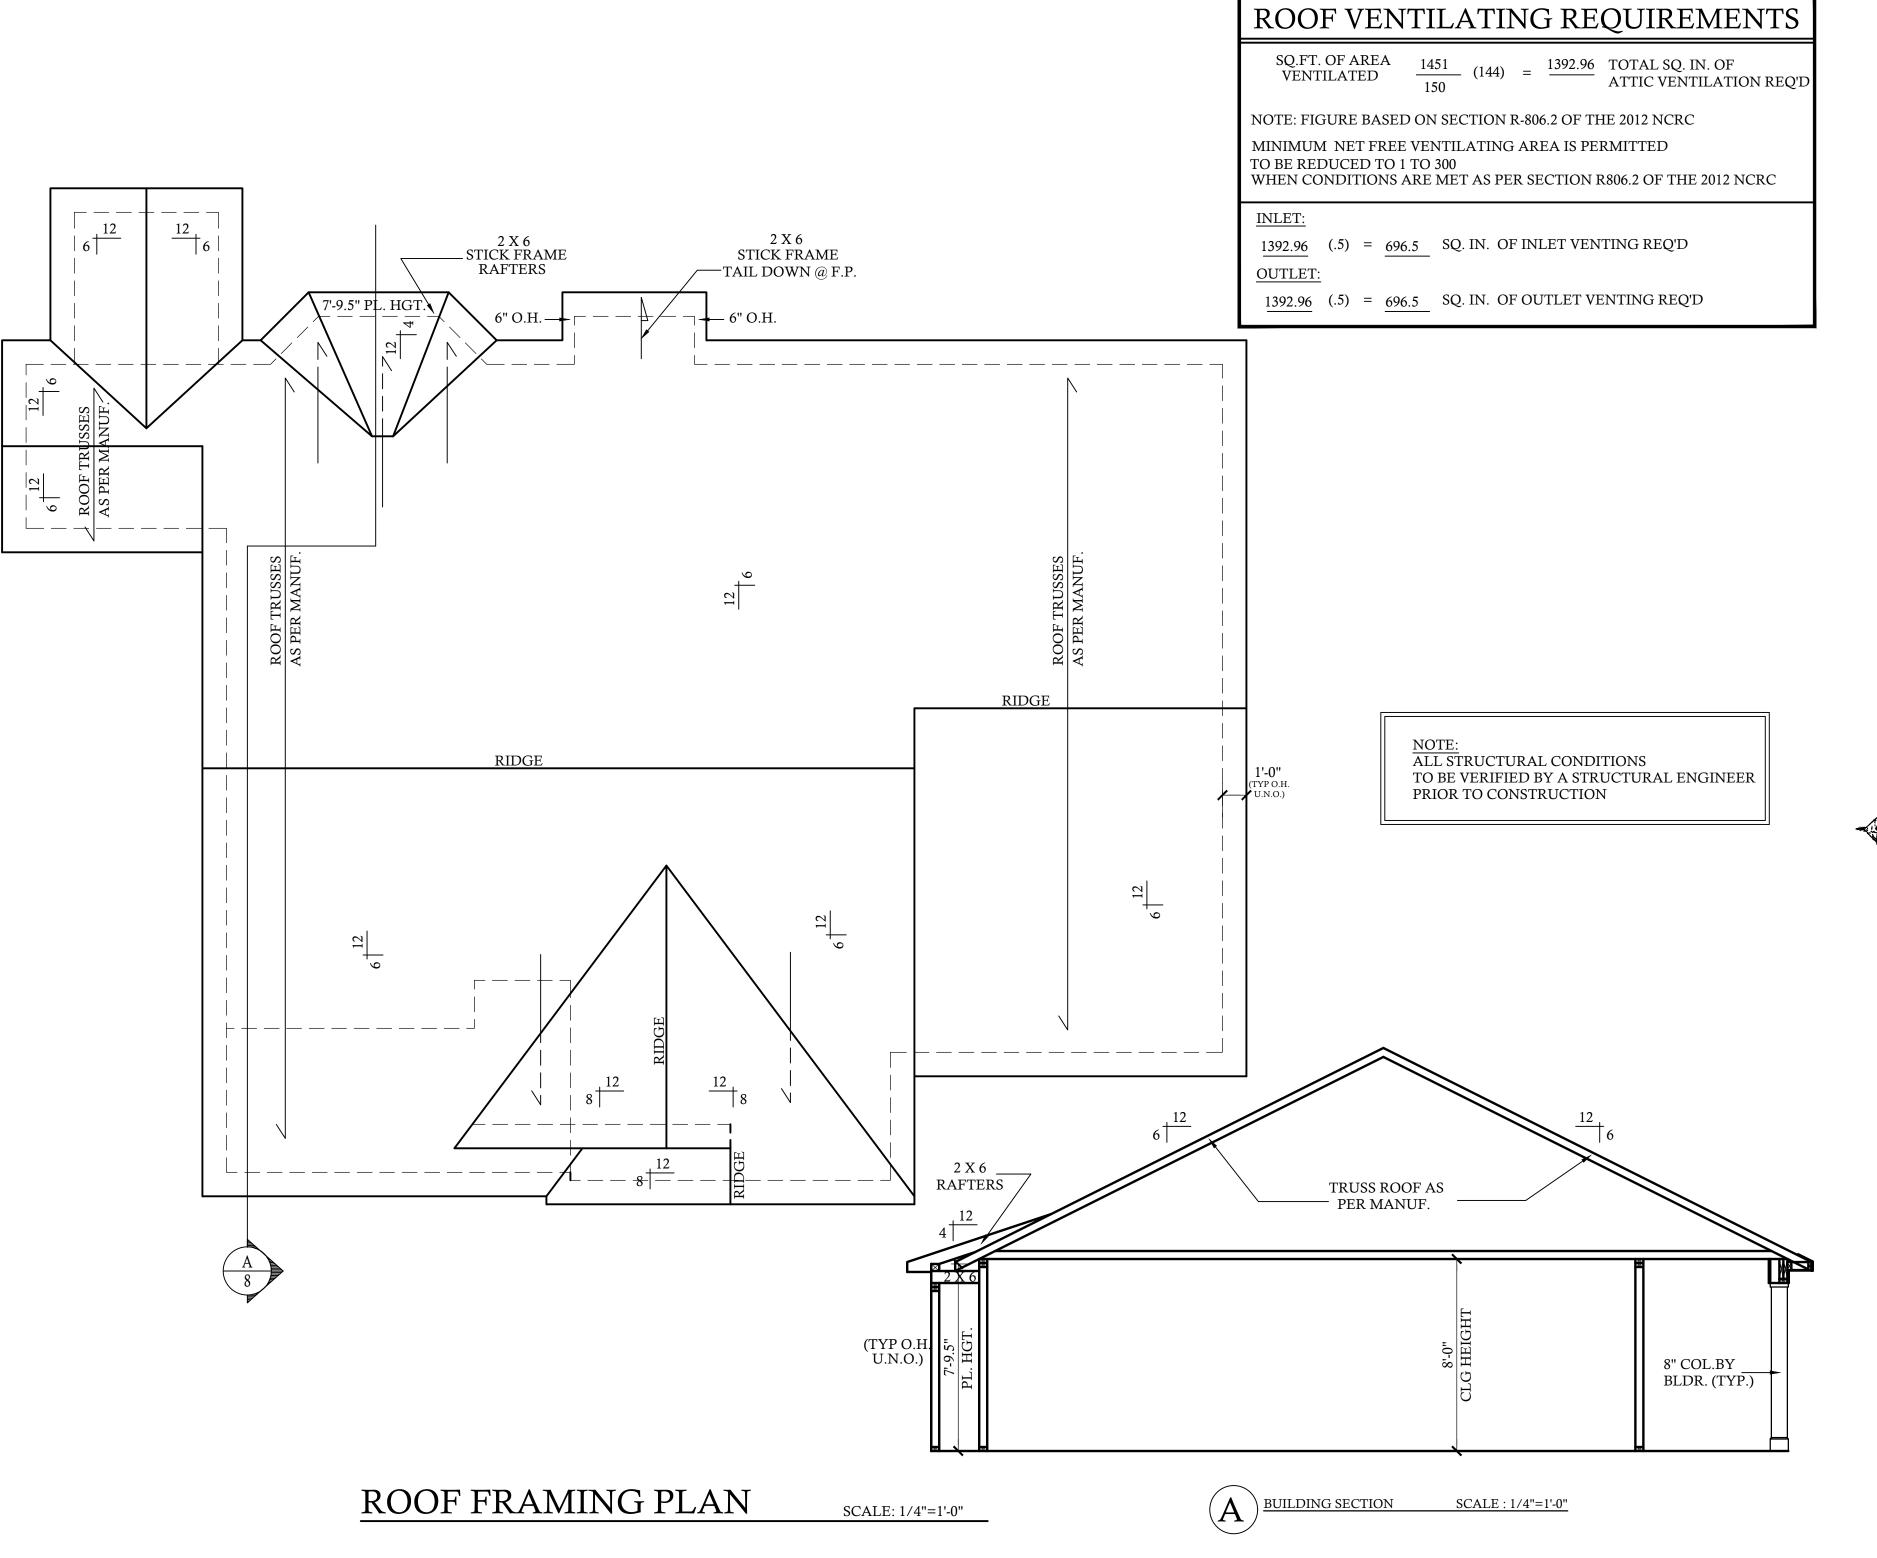
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10-1291-DT





ERS RAYNOR BUILD 156 EAST MAIN STREET COATS, NC

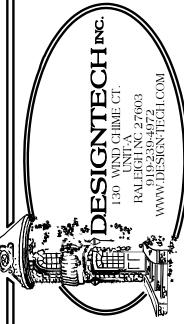SHEET NO

## THIS LAYOUT IS TO BE USED AS A TRUSS PLACEMENT GUIDE ONLY. PLEASE REFER TO BUILDING PLANS FOR BUILDING CONSTRUCTION AND DETAILS, SUCH AS PLUMBING OR DUCT DROPS.

#### CONSTRUCTION COPY-FOR FIELD USE

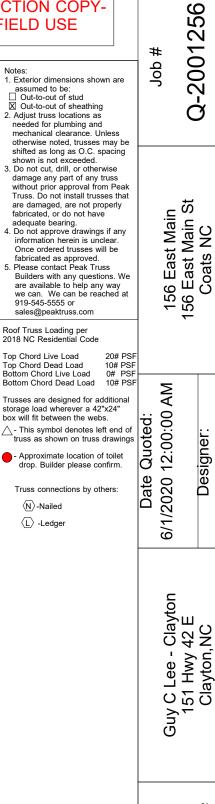

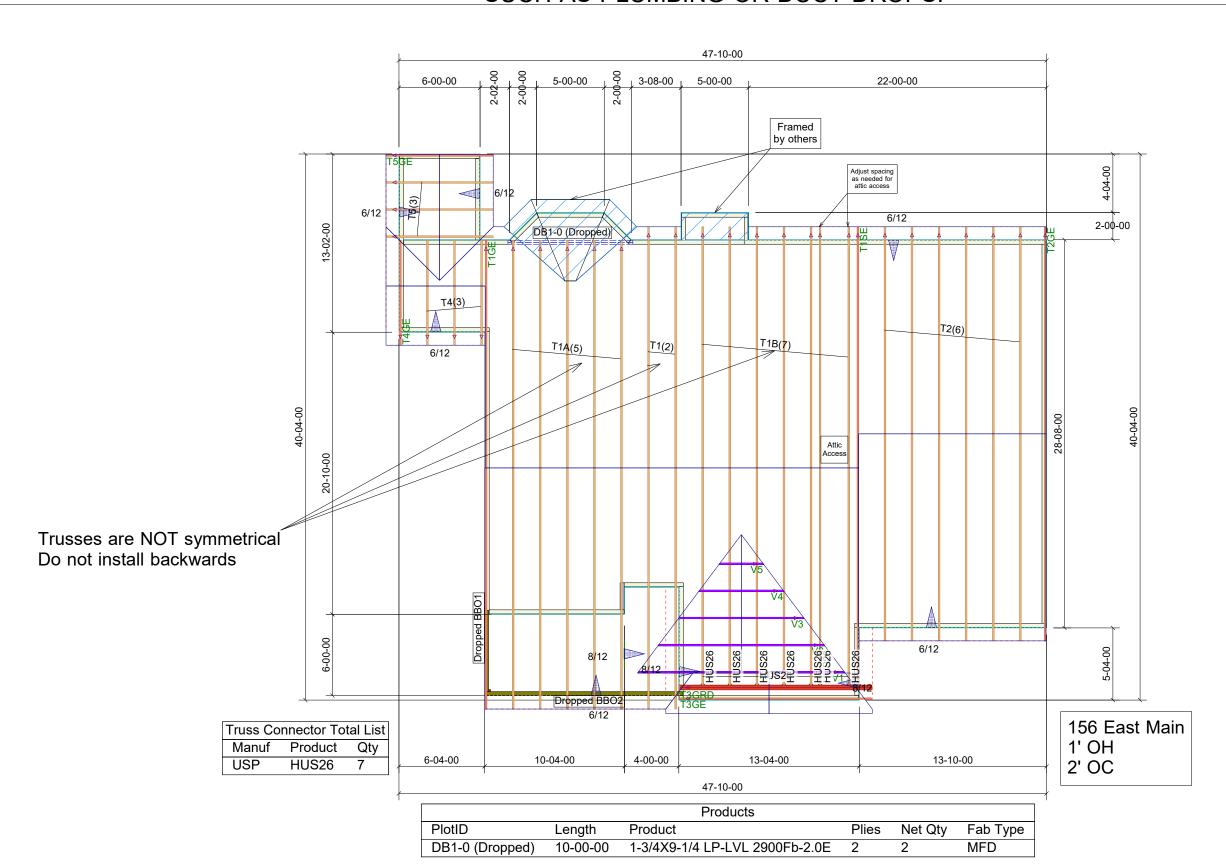

- Adjust truss locations as needed for plumbing and mechanical clearance. Unless otherwise noted, trusses may be shifted as long as O.C. spacing
- damage any part of any truss without prior approval from Peak Truss. Do not install trusses that are damaged, are not properly fabricated, or do not have
- Once ordered trusses will be fabricated as approved.
- Builders with any questions. We are available to help any way we can. We can be reached at 919-545-5555 or sales@peaktruss.com

Roof Truss Loading per 2018 NC Residential Code

Top Chord Dead Load Bottom Chord Live Load Bottom Chord Dead Load

box will fit between the webs.

drop. Builder please confirm.

**Aron Meeks** Designer

Guy C Lee - Clayton 151 Hwy 42 E Clayton, NC 27520

Hill, NC 27562