

## FOUNDATION PLAN

SCALE:1/8"= 1'-0" NOTE:

1. FLOOR LIVE LOAD 40 PSF


2. ROOF LIVE 20 PSF

3. WF1.8 - 1'-8"WX10"D CONT. WALL FOOTING W/3 #4 OR 2 # 5 CONT. WF1.4I - 1'-4"WX12'D INTERIOR CONT. WALL FOOTING W/ 3 #4 OR 2 #5 CONT.


WF2.0 - 24"WX10"D W 3 #4 CONT.

4. CONCRETE: f'c = 3000 PSI5. SLAB ON GRADE: CONCRETE W/FIBERMESH REINFORCING OR 6X6/W1.4XW1.4 WIRE OVER 6 MIL VAPOR BARRIER COMPACTED FILL


6. ASSUMED SOIL BEARING: 2000 PSF

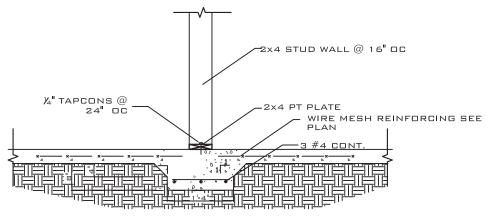

W1.4I - INTERIOR THICKENED SLAB SCALE: NTS

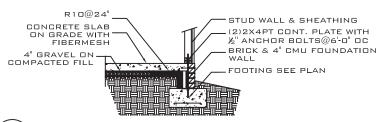

TYPICAL FOUNDATION SECTION

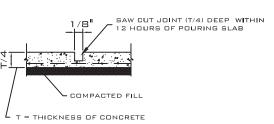

SAW-CUT DETAIL NOT TO SCALE



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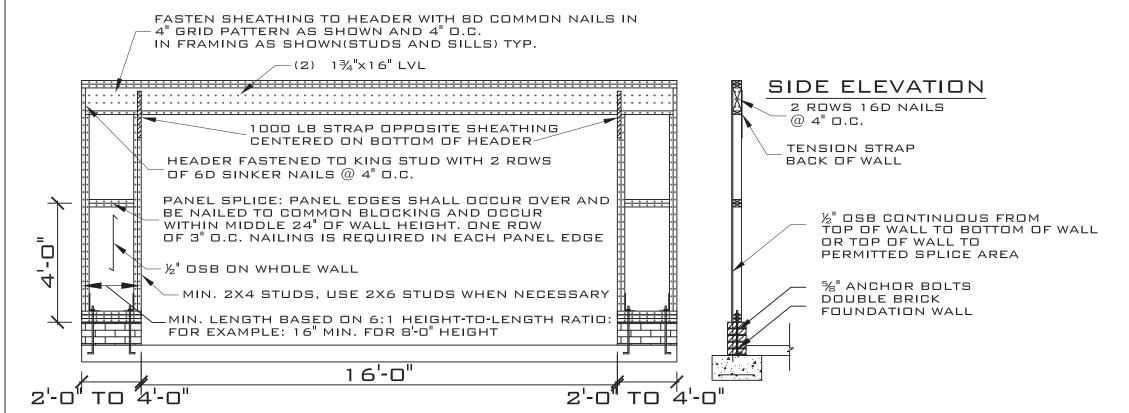
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 $\Gamma$ EV: NO: INO 2C 5.19.20 RE S.SHOWN Y: JRR

PROJECT NO DATE: 06.19 SCALE: AS S DRAWN BY: J CHECKED BY:

Ü PLAN H UILDING DAWSON F 140 MPF TSHER BL 

OND, JEER, 3TE, 3 2841 529 00. JREDNG



## GARAGE PORTAL FRAME DETAIL

NOTE: FOR WIND SPEED OF 110 MPH OR LESS NAIL SPACING CAN BE INCREASED TO 6" OC

## GENERAL NOTES:

GENERAL: ALL NOTES ARE FOR SUPPLEMENTING THE PLANS AND SPECIFICATIONS AND ARE IN NO WAY TO BE CONSIDERED AS EXCLUDING ANY ITEM IN THEM.

CONTRACTOR TO OBTAIN ALL MISC. UTILITIES AND

CODE: DESIGN AND CONSTRUCTION TO BE IN ACCORD WITH THE 2018 NG RESIDENTIAL GODE (NGRG) AND THE PARTICULAR CODES AS REFERENCED IN NGRG.

FLOOR LIVE: ROOF LIVE: 20 PSF 10 PSF 140 MPH CEILING LIVE: WIND SPEED:

FOUNDATION:
MATERIAL SATISFACTORY FOR CONTROLLED FILL AND
BACKFILL MATERIAL AROUND AND ABOVE FOOTINGS
SHALL INCLUDE CLEAN SOIL OR BANKRUN SAND AND
GRAVEL (GW, GC, SC, SM, ML & CL), BUT EXCLUDE
HIGHLY PLASTIC CLAYS (MH & CH) OR HIGH SHRINK
SWELL SOILS. THE FILL MATERIALS SHALL BE FREE
FROM TOPSOIL, ORGANIC CONTAMINATED SOIL AND
ROCK FRAGMENTS HAVING A MAJOR DIMENSION
GREATER THAN FOUR (4) INCHES, AND SHALL CONTAIN
NO ICE OR SNOW.

FOOTINGS ARE DESIGNED FOR AN ASSUMED SOIL

CARE SHOULD BE TAKEN TO ASSURE THAT DURING CARE SHOULD BE IAREN TO ASSURE THAT DURING PLACING OF CONCRETE FOOTINGS ON GRADE NO ORGANIC MATTER, SALTS, OR CLAYS ARE MIXED WITH THE CONCRETE.

CONCRETE: REINFORCED CONCRETE TO HAVE THE FOLLOWING COMPRESSIVE STRENGTH (F'C): 3000 PSI

EXPOSED CONCRETE SHALL BE AIR-ENTRAINED.

REINFORCING STEEL: ASTM A615 GRADE 60.

REINFORCING STEEL MARKED CONTINUOUS (CONT.) SHALL BE LAPPED 48 X BAR DIAMETER AT SPLICES.
ALL REINFORGING STEEL SHALL BE HELD SECURELY IN
PLACE TO PREVENTISED CATALD DURING THE POURING

EXCEPT AS OTHERWISE SHOWN, MINIMUM PROTECTION (CONCRETE COVER) FOR REINFORCING STEEL SHALL BE AS FOLLOWS:

CONCRETE SURFACES EXPOSED TO SOIL: 1 1/2" FOR SLABS 3" FOR FOOTINGS

INTERIOR CONCRETE SURFACES:

CONCRETE SURFACES EXPOSED TO WEATHER:

WOOD: ALL WOOD TO BE SPRUCE PINE FIR (SPF) NO. 2 OR HIGHER. ALL FASTENERS AND HANGERS TO BE HOT DIPPED GALVANIZED (AT A MINIMUM). PRESERVATIVE PRESSURE TREATMENT TO BE IN ACCORDANCE WITH AWPA STANDARD M4-06 & U1-07. MINIMUM PRESERVATION TREATMENTS:

POSTS: UC4A ALL OTHER WOOD MEMBERS: UC3B

LVL SPECS: FB=2900 PSI FV=285 PSI E=1,900,000 PSI

 $\Gamma$ ECT NO: INO 20 06.19.20 RE :: AS SHOWN N BY: JRR KED BY: JRR PROJECT NOTE: 06. SCALE: AS PRAWN BY: HECKED B 

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POFARO MILITARIO

06.20.20