

## FOUNDATION PLAN

SCALE:1/8"= 1'-0" NOTE:

1. FLOOR LIVE LOAD 40 PSF


2. ROOF LIVE 20 PSF

3. WF1.8 - 1'-8"WX10"D CONT. WALL FOOTING W/3 #4 OR 2 # 5 CONT. WF1.4I - 1'-4"WX12'D INTERIOR CONT. WALL FOOTING W/ 3 #4 OR 2 #5 CONT.


WF2.0 - 24"WX10"D W 3 #4 CONT.

4. CONCRETE: f'c = 3000 PSI5. SLAB ON GRADE: CONCRETE W/FIBERMESH REINFORCING OR 6X6/W1.4XW1.4 WIRE OVER 6 MIL VAPOR BARRIER COMPACTED FILL


6. ASSUMED SOIL BEARING: 2000 PSF

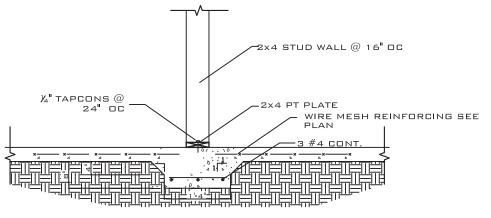

W1.4I - INTERIOR THICKENED SLAB SCALE: NTS

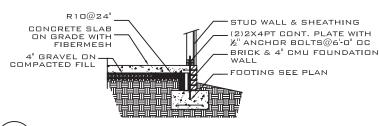

TYPICAL FOUNDATION SECTION

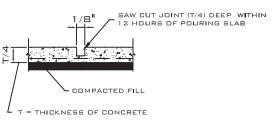

SAW-CUT DETAIL NOT TO SCALE



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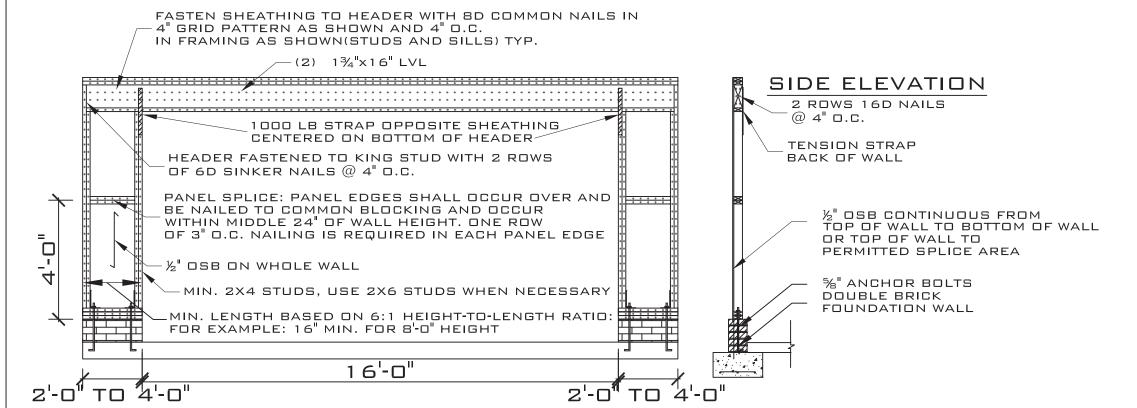
NO: INO 2C 5.19.20 RE S.SHOWN Y: JRR PROJECT NO DATE: 06.19 SCALE: AS S DRAWN BY: J CHECKED BY:

Ü PLAN H UILDING DAWSON F 140 MPF TSHER BL 0.0EC 1E D. 3.R.C 1E FI 20 U.F 

OND, JEER 3TE, 2841 529

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JREDNG



## GARAGE PORTAL FRAME DETAIL

NOTE: FOR WIND SPEED OF 110 MPH OR LESS NAIL SPACING CAN BE INCREASED TO 6" OC

GENERAL NOTES:

GENERAL: ALL NOTES ARE FOR SUPPLEMENTING THE PLANS AND SPECIFICATIONS AND ARE IN NO WAY TO BE CONSIDERED AS EXCLUDING ANY ITEM IN THEM.

CONTRACTOR TO OBTAIN ALL MISC. UTILITIES AND

CODE: DESIGN AND CONSTRUCTION TO BE IN ACCORD WITH THE 2018 NG RESIDENTIAL GODE (NGRG) AND THE PARTICULAR CODES AS REFERENCED IN NGRG.

FLOOR LIVE: ROOF LIVE: 20 PSF 10 PSF 140 MPH CEILING LIVE: WIND SPEED:

FOUNDATION:
MATERIAL SATISFACTORY FOR CONTROLLED FILL AND
BACKFILL MATERIAL AROUND AND ABOVE FOOTINGS
SHALL INCLUDE CLEAN SOIL OR BANKRUN SAND AND
GRAVEL (GW, GC, SC, SM, ML & CL), BUT EXCLUDE
HIGHLY PLASTIC CLAYS (MH & CH) OR HIGH SHRINK
SWELL SOILS. THE FILL MATERIALS SHALL BE FREE
FROM TOPSOIL, ORGANIC CONTAMINATED SOIL AND
ROCK FRAGMENTS HAVING A MAJOR DIMENSION
GREATER THAN FOUR (4) INCHES, AND SHALL CONTAIN
NO ICE OR SNOW.

FOOTINGS ARE DESIGNED FOR AN ASSUMED SOIL

CARE SHOULD BE TAKEN TO ASSURE THAT DURING CARE SHOULD BE IAREN TO ASSURE THAT DOWNS PLACING OF CONCRETE FOOTINGS ON GRADE NO ORGANIC MATTER, SALTS, OR CLAYS ARE MIXED WITH THE CONCRETE.

CONCRETE: REINFORCED CONCRETE TO HAVE THE FOLLOWING COMPRESSIVE STRENGTH (F'G): 3000 PSI

EXPOSED CONCRETE SHALL BE AIR-ENTRAINED.

REINFORCING STEEL: ASTM A615 GRADE 60.

REINFORCING STEEL MARKED CONTINUOUS (CONT.) SHALL BE LAPPED 48 X BAR DIAMETER AT SPLIGES.
ALL REINFORGING STEEL SHALL BE HELD SECURELY IN
PLACE TO PREVENTISED CATION DURING THE POURING

EXCEPT AS OTHERWISE SHOWN, MINIMUM PROTECTION (CONCRETE COVER) FOR REINFORCING STEEL SHALL BE AS FOLLOWS:

CONCRETE SURFACES EXPOSED TO SOIL: 1 1/2" FOR SLABS 3" FOR FOOTINGS

INTERIOR CONCRETE SURFACES:

CONCRETE SURFACES EXPOSED TO WEATHER:

WOOD: ALL WOOD TO BE SPRUCE PINE FIR (SPF) NO. 2 OR HIGHER. ALL FASTENERS AND HANGERS TO BE HOT DIPPED GALVANIZED (AT A MINIMUM). PRESERVATIVE PRESSURE TREATMENT TO BE IN ACCORDANCE WITH AWPA STANDARD M4-06 & U1-07. MINIMUM PRESERVATION TREATMENTS: POSTS: UC4A ALL OTHER WOOD MEMBERS: UC3B

LVL SPECS: FB=2900 PSI FV=285 PSI E=1,900,000 PSI

POFARO MILITARIO

06.20.20

 $\Gamma$ ECT NO: INO 20 06.19.20 RE :: AS SHOWN N BY: JRR KED BY: JRR PROJECT NOTE: 06. SCALE: AS PRAWN BY: HECKED B


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THIS PLAN CONFORMS TO THE 2012 EDITION OF THE ICC/ NORTH CAROLINA RESIDENTIAL BUILDING CODE HOTES:
1) SEE SHEET COCE. | FOR ATTIC VEST LATION
PROPO, Y-CLASSING DESIGN ALLIES, HEAD
2) SEE SHEET D-1 FOR HALL SECTION CETAILS





Wilmington, NC 28409
Office: 910-452-7334
Cell: 910-443-7605
rob@robgrissom.com
www.robgrissom.com
Project: PRINCEPS
Address: PAPSTEAD, NC

Project Location:\_\_\_\_\_\_Subdivision:

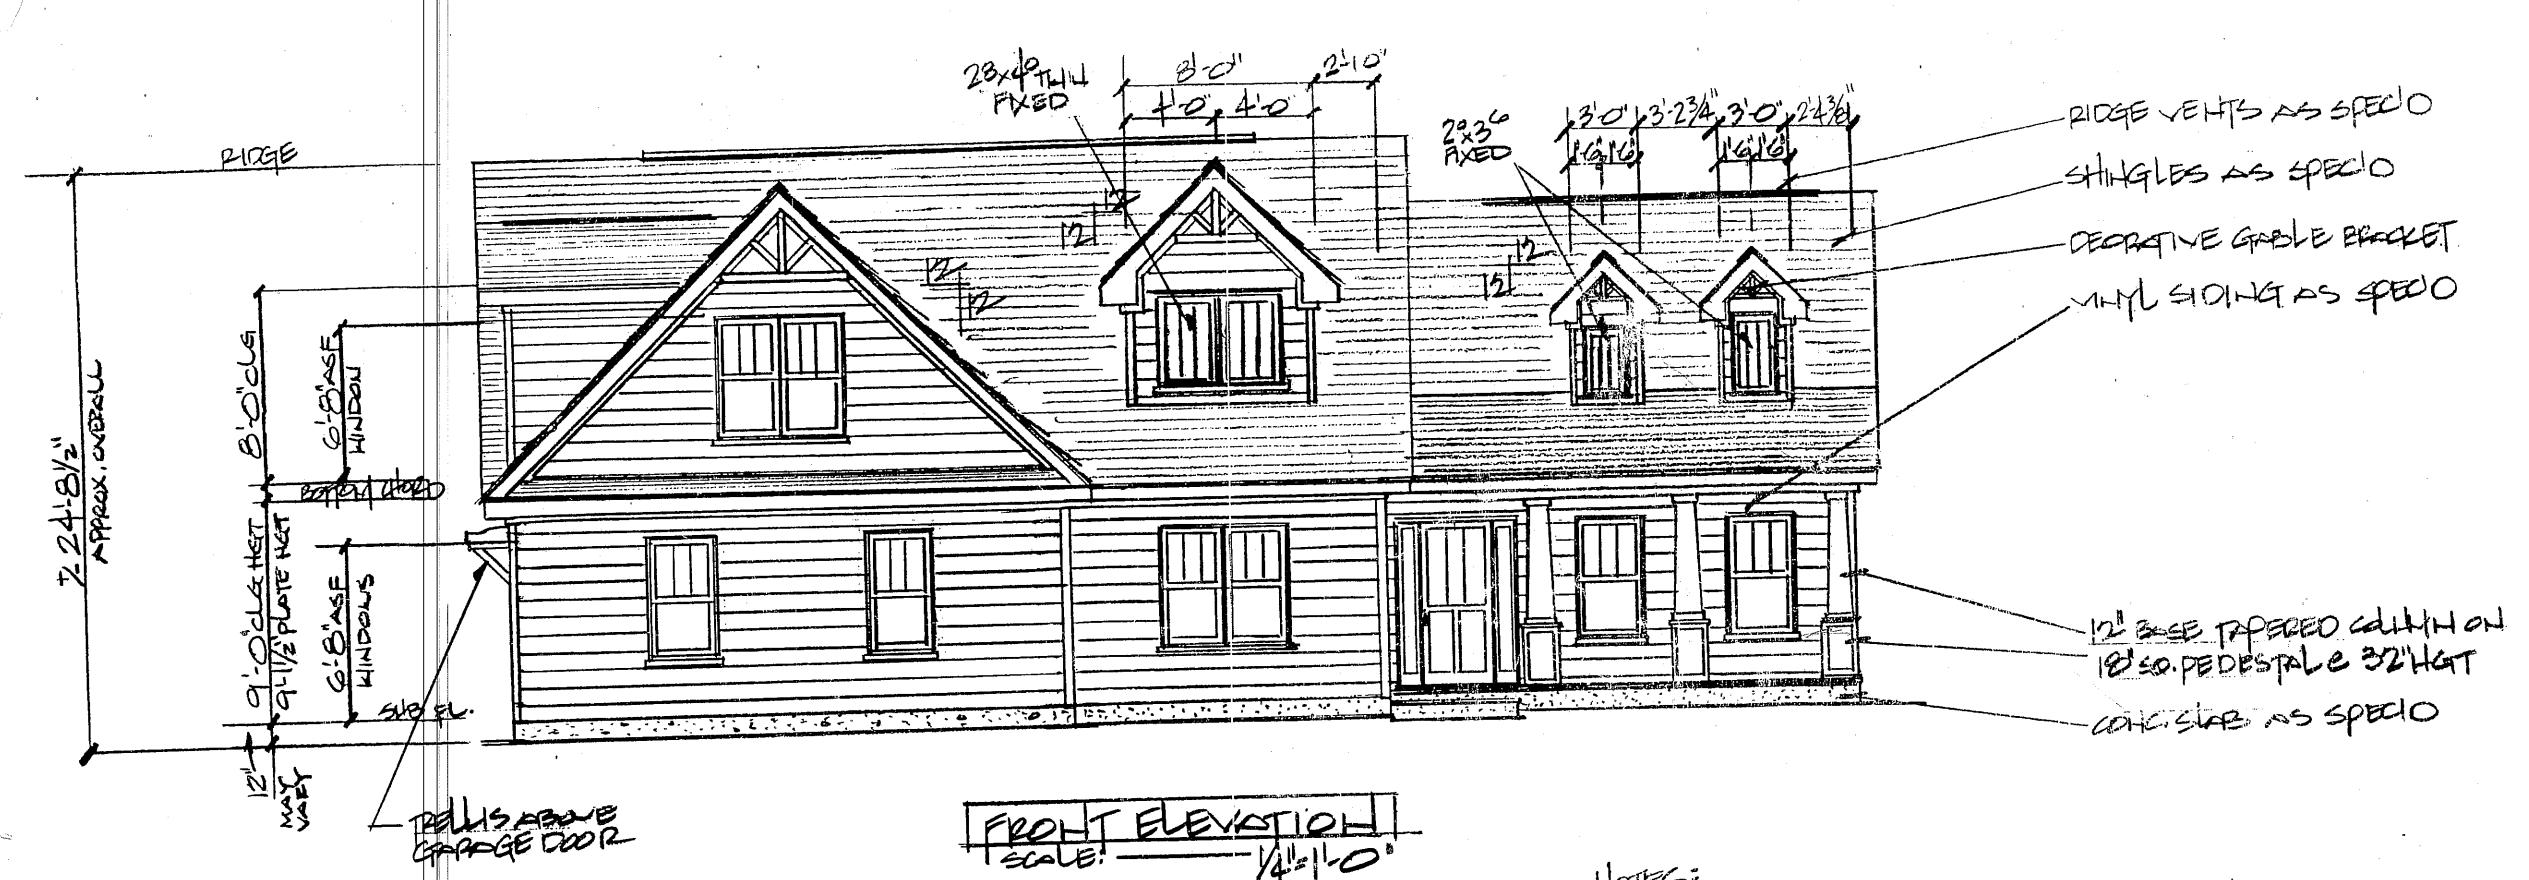
Section: DON ONE THAT THAT

Contractor shall verify all conditions and dimensions prior to construction. Any error or omissions shall be reported to designer for correction or justification. Once construction has commenced, the contractor shall assume all responsibility. Dimensions govern over scale, Codes govern over dimensions.

ALL STRUCTURAL SYSTEMS AND COMPONENTS INCLUDING ROOF SYSTEM, BEAMS, HEADERS, COLUMNS, CANTILEVERS AND OFFSET LOAD BEARING WALLS TO BE SIZED AND SEALED BY A STRUCTURAL ENGINEER AND / OR SUPPLIER.

The drawings and specifications are offered to named client for a conditional one time use. The use is limited to the lot and subdivision specified herein, and only for said location. Contact designer for re-use requirements:

These drawings and specifications are the sole property of Rob Grissom Home Designs

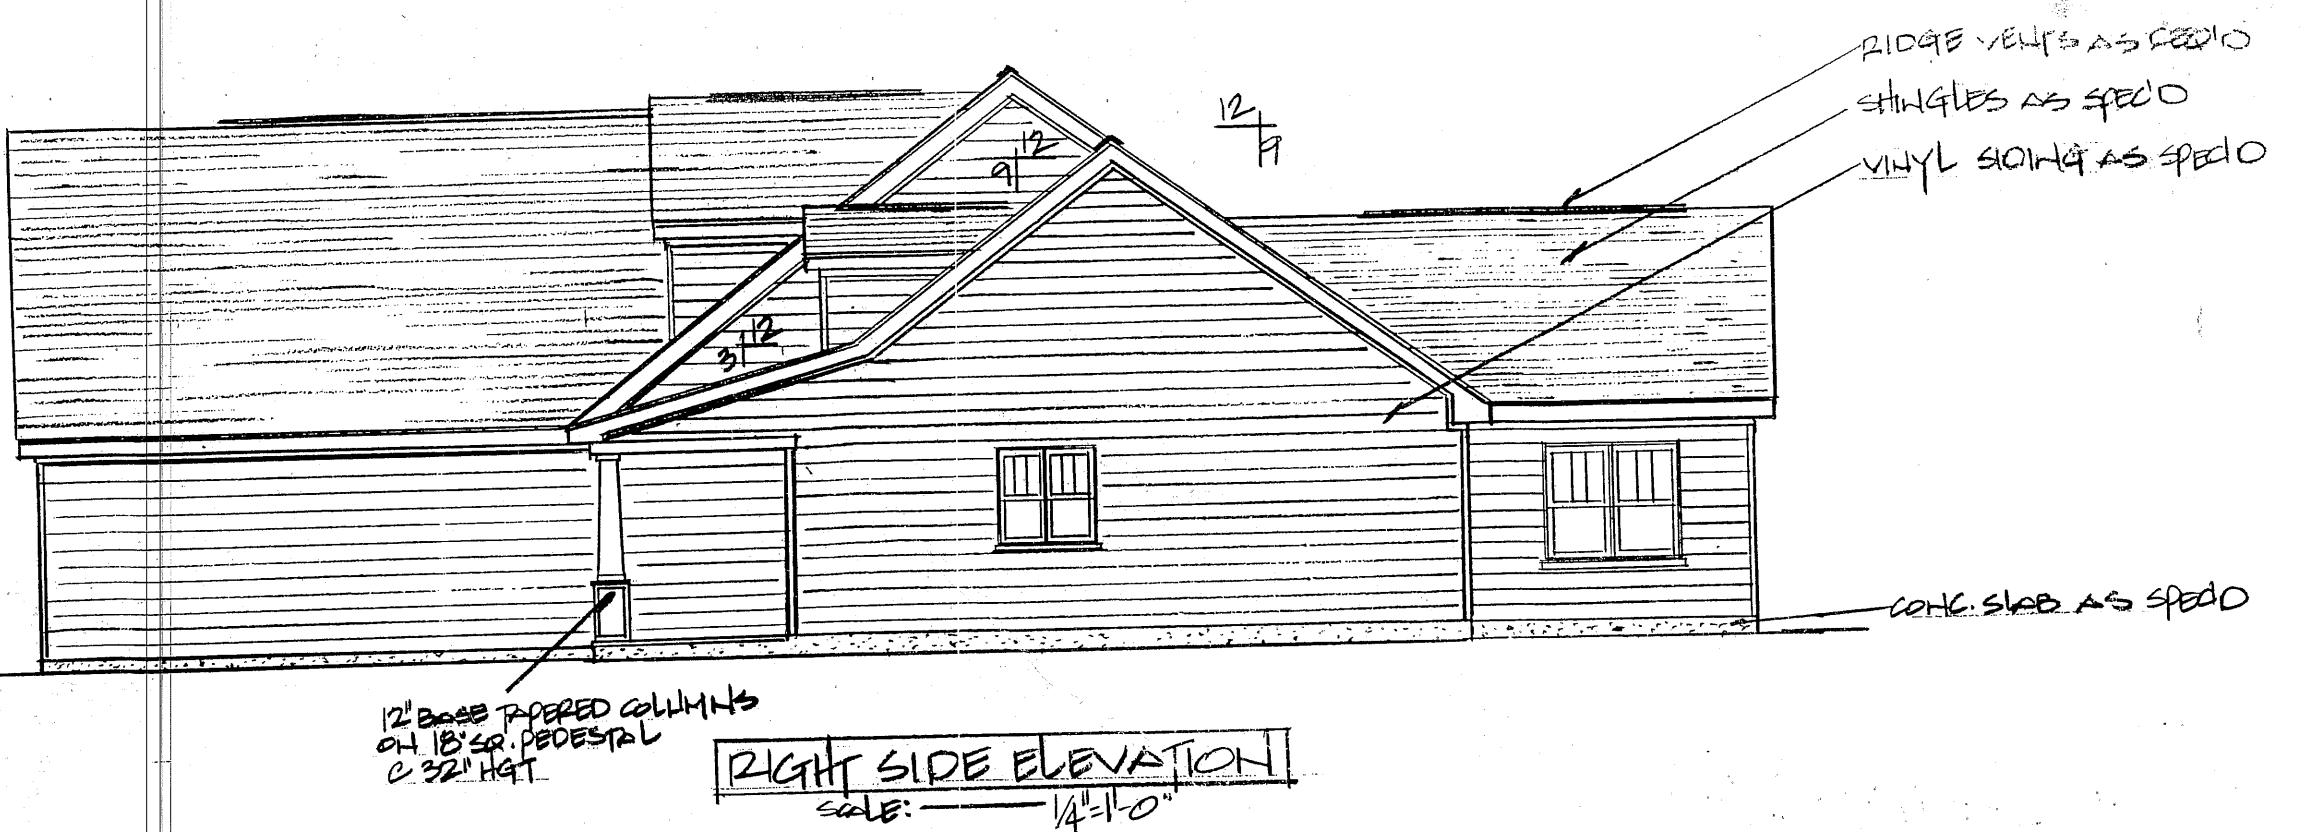





## HOME DESIGNS

106 Doughton Drive Wilmington, NC 28409 Office: 910-452-7334 Cell: 910-443-7605 rob@robgrissom.com www.robgrissom.com

Project Location: Subdivision:

Section: DON ONE TROOT

County: PENDER

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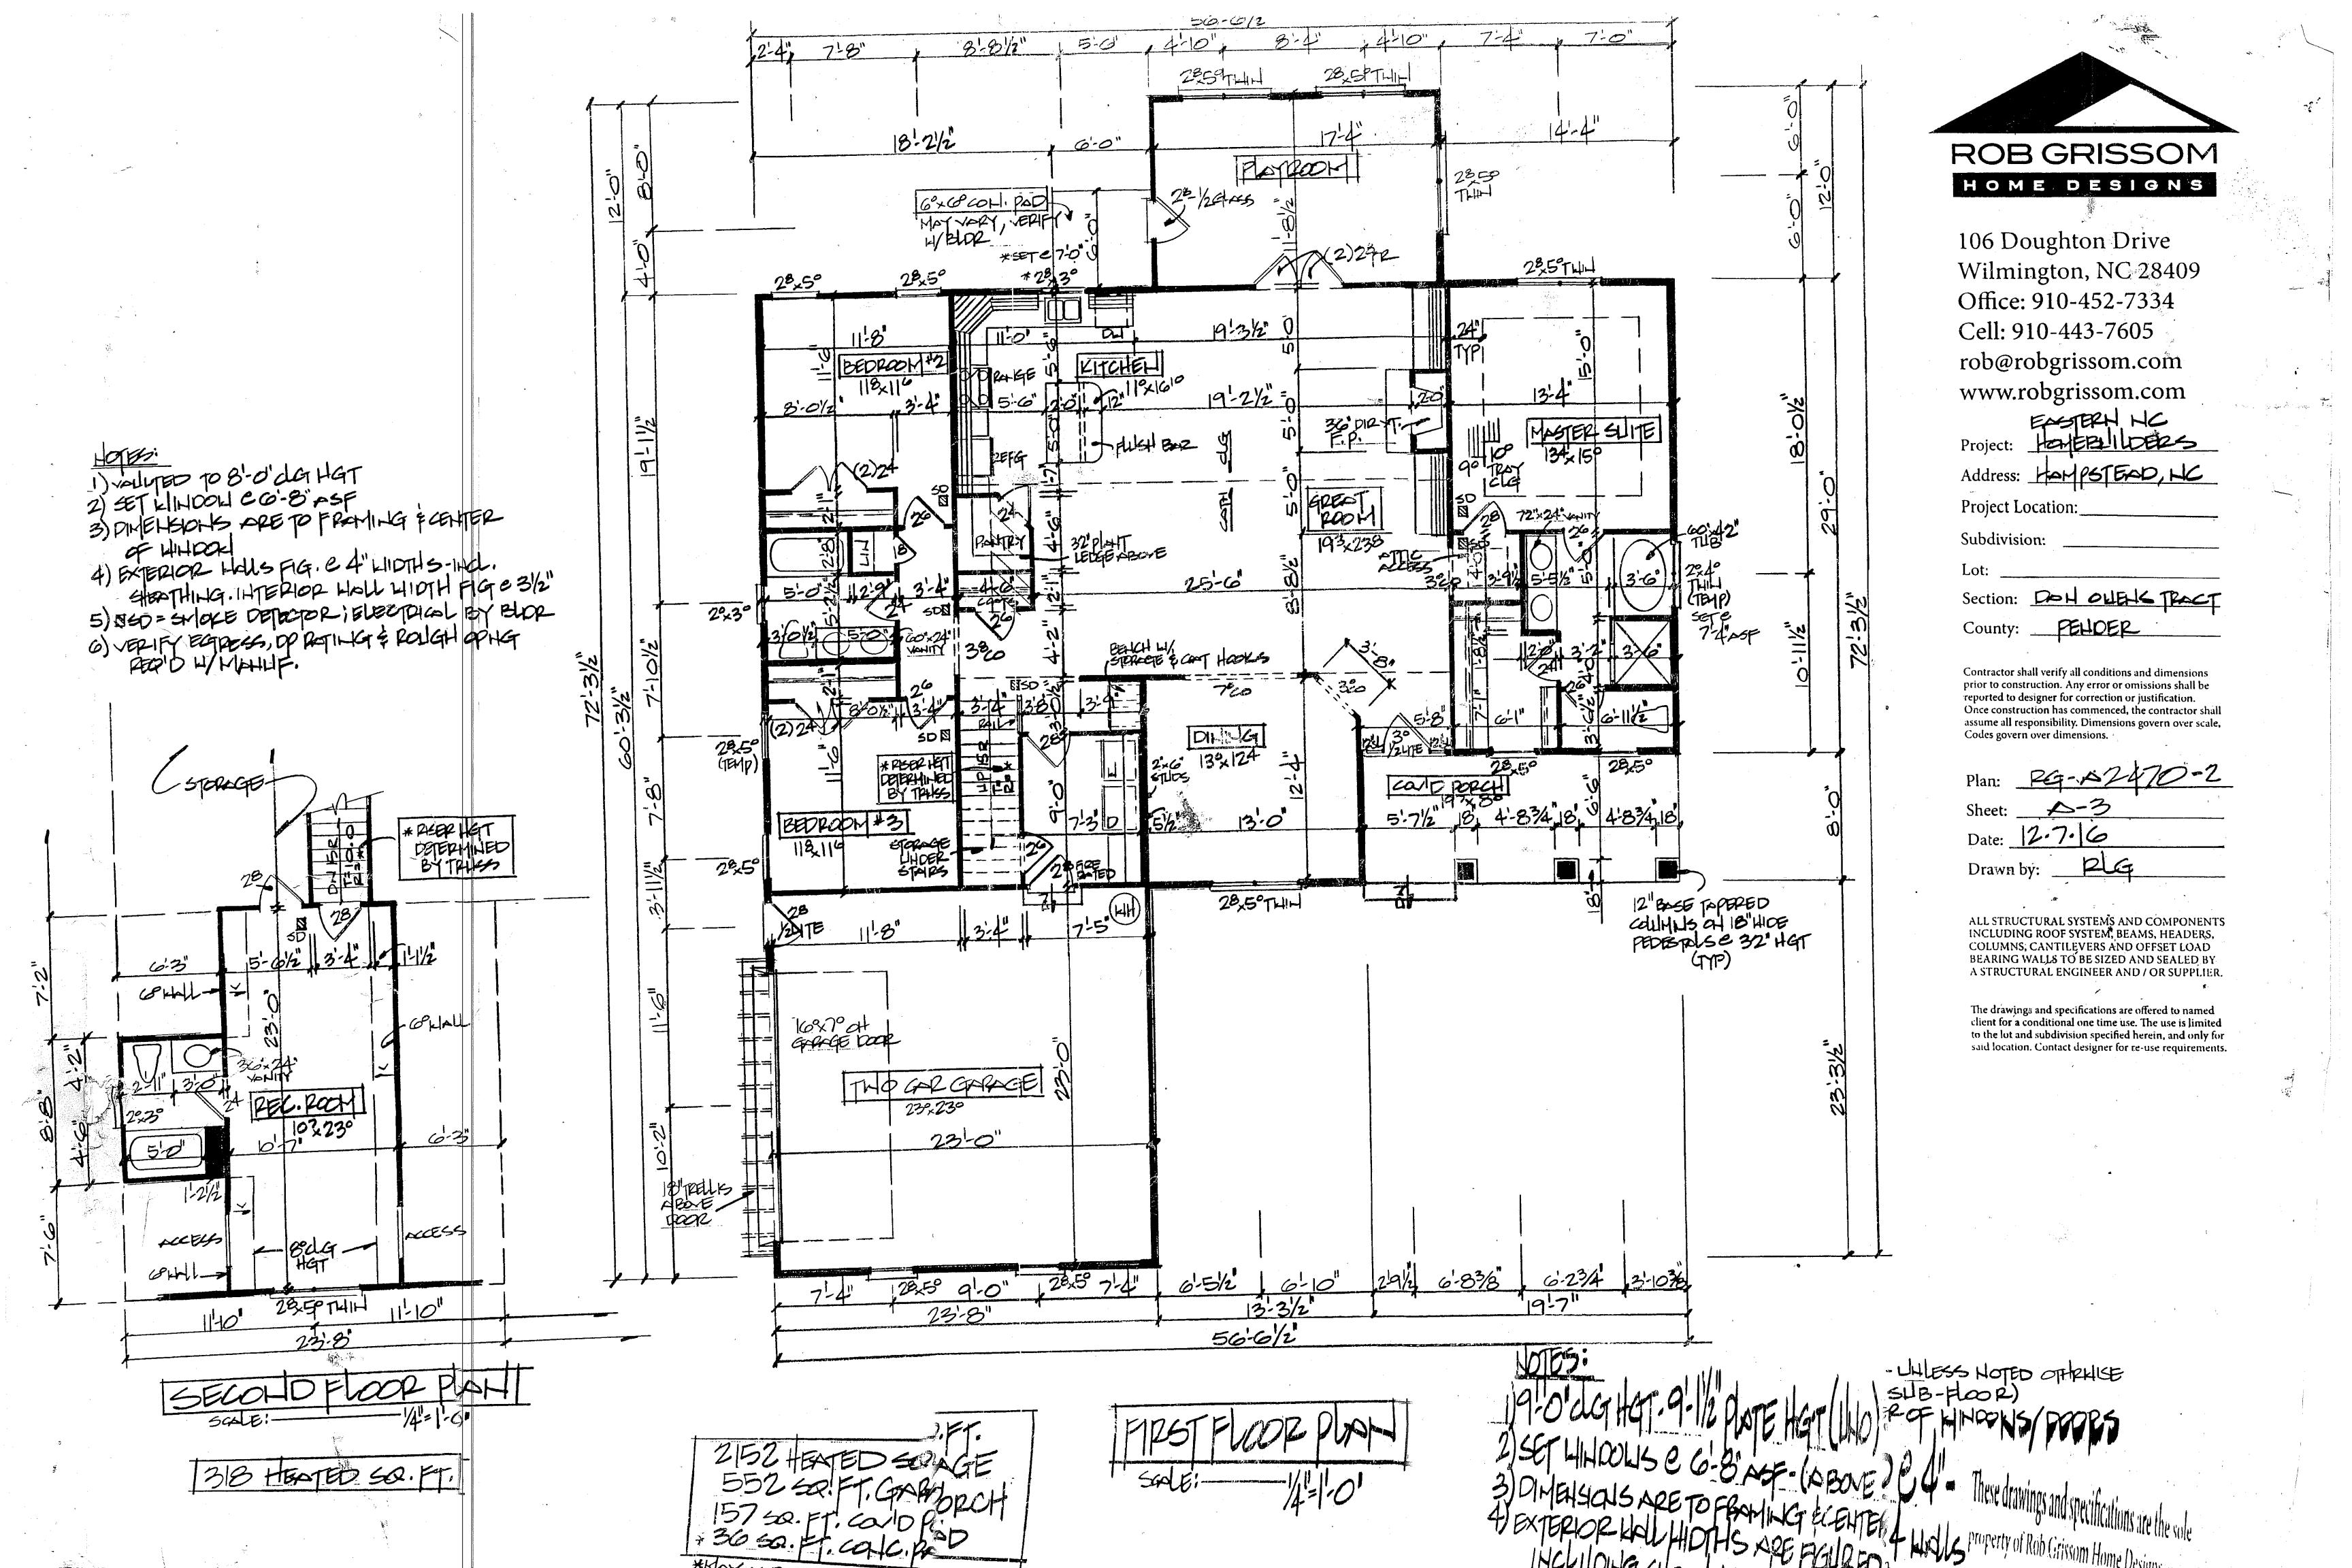
Plan:  $2G-\triangle 2470-2$ Sheet:  $\triangle -2$ Date:  $2\cdot 7\cdot 6$ 


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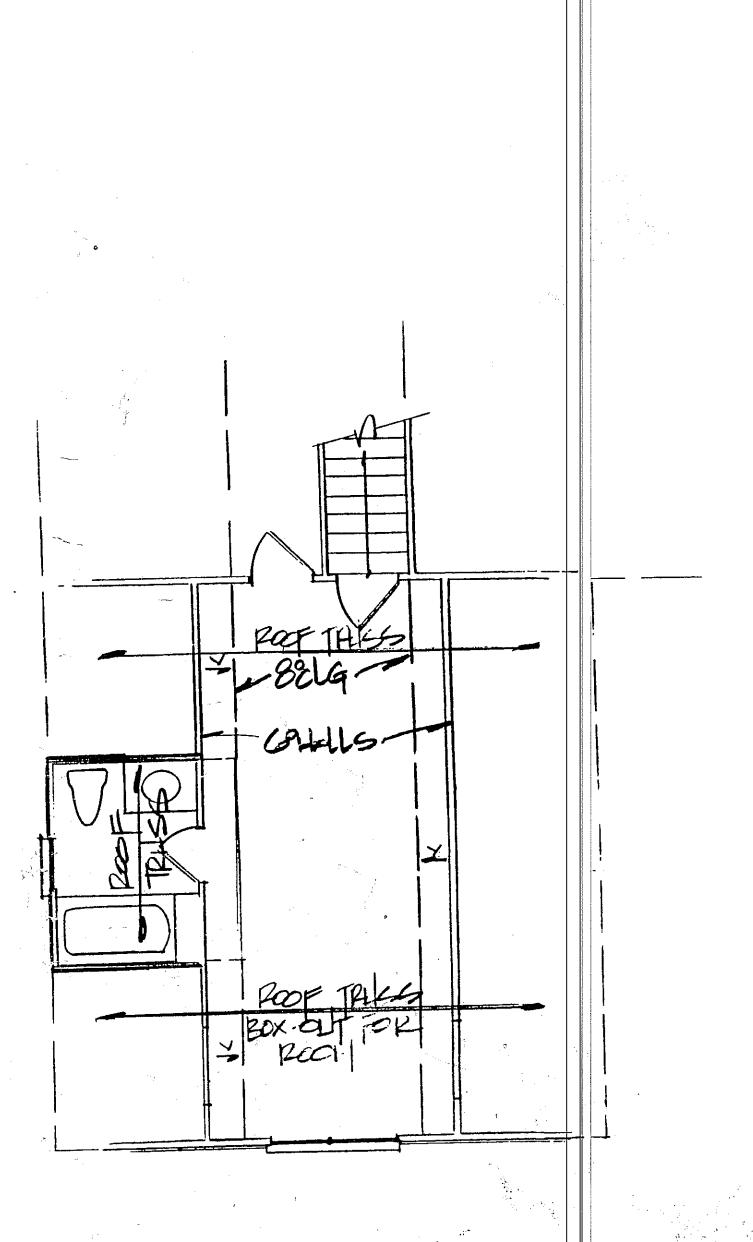
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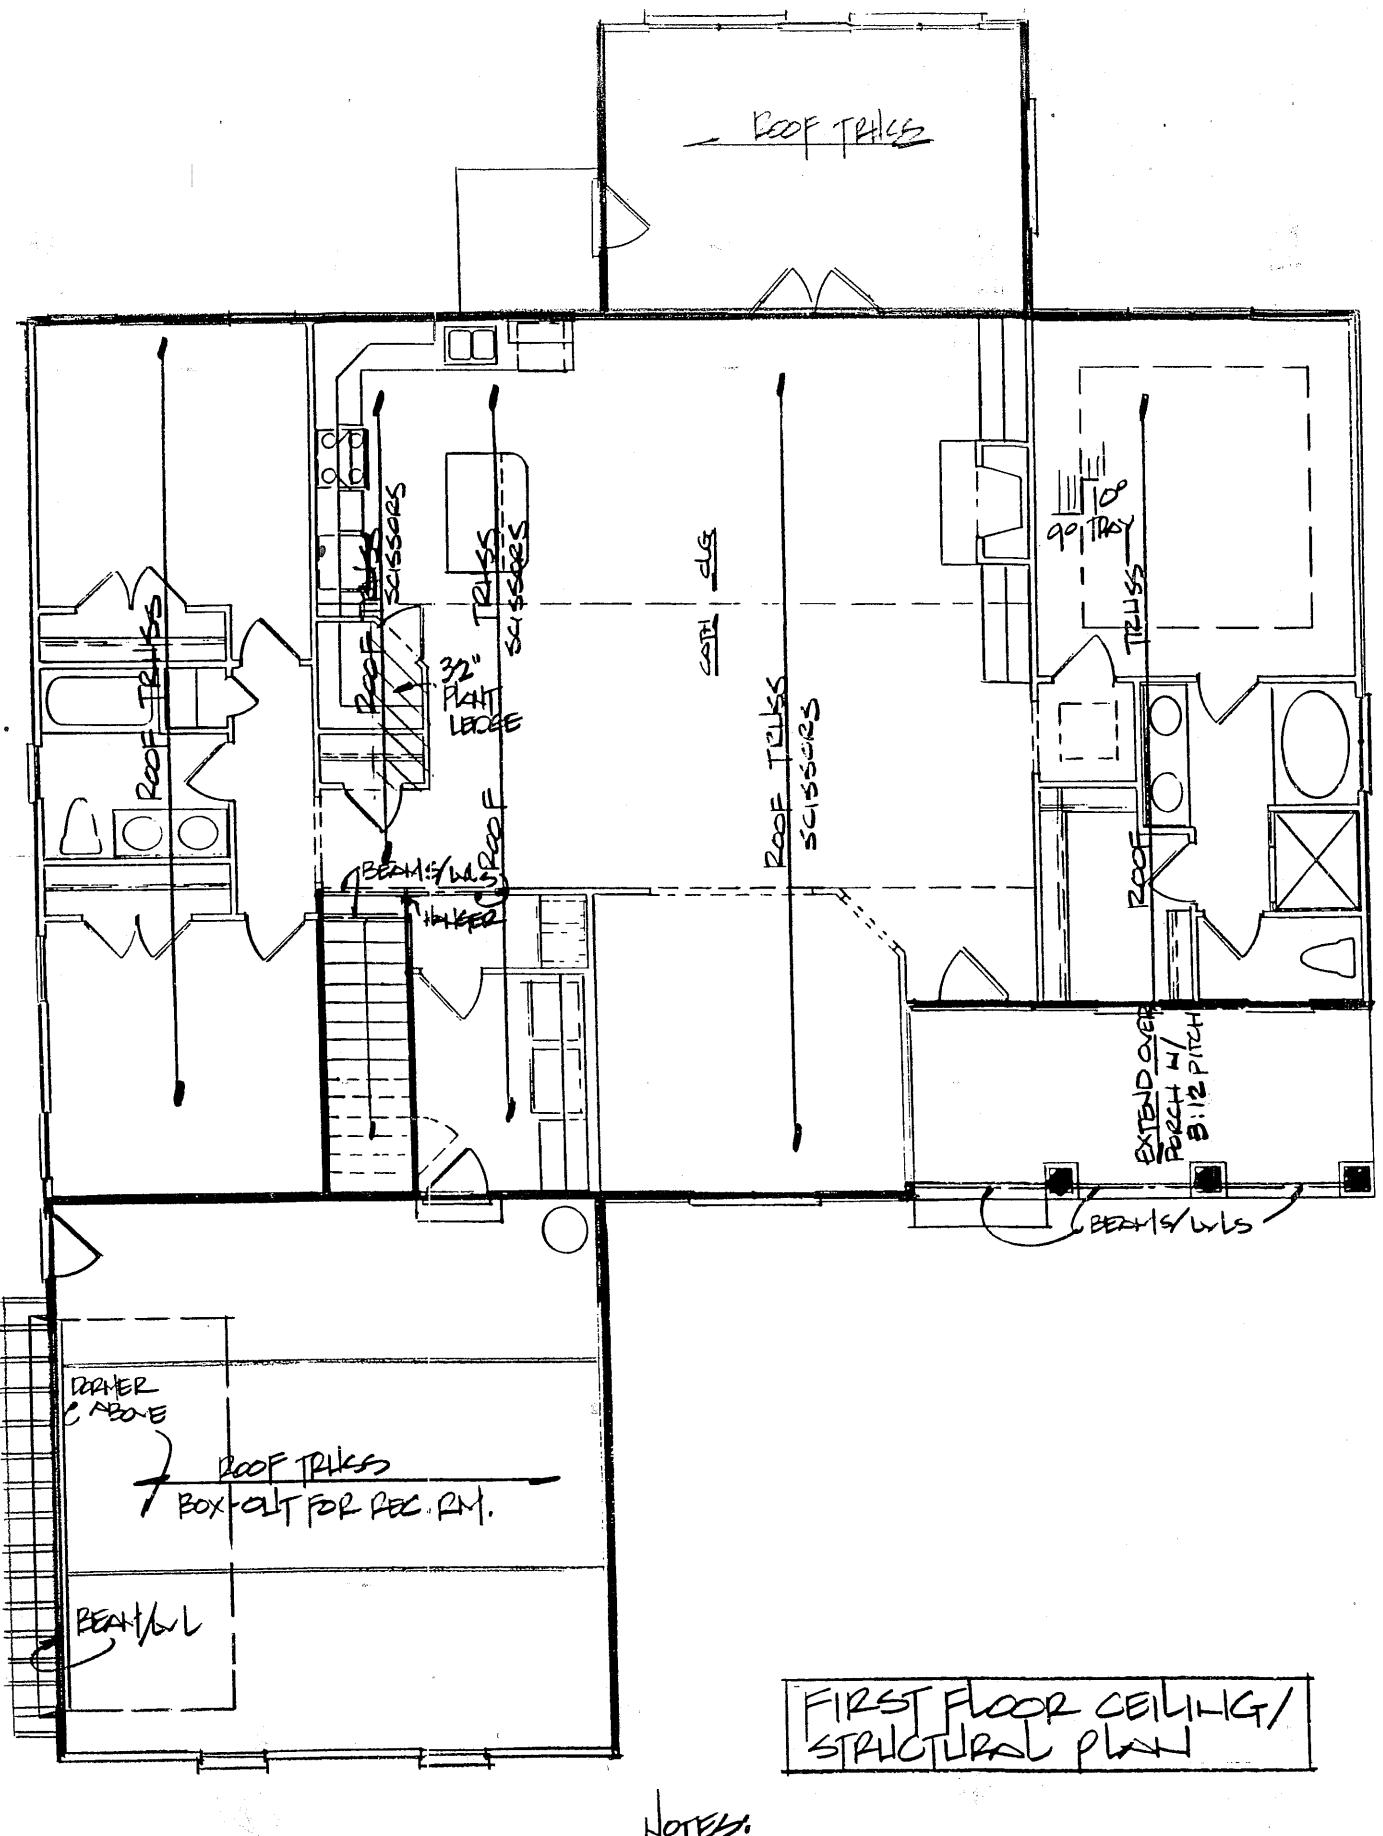
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SECOHD FLOOR CEILING/ SPUCTURAL PLAN



NOTES:

1) STROBD HALLS INDUCATE LOND BEARING HALLS;

2-STRUCTURAL INFO H/TRUSS MANUF.

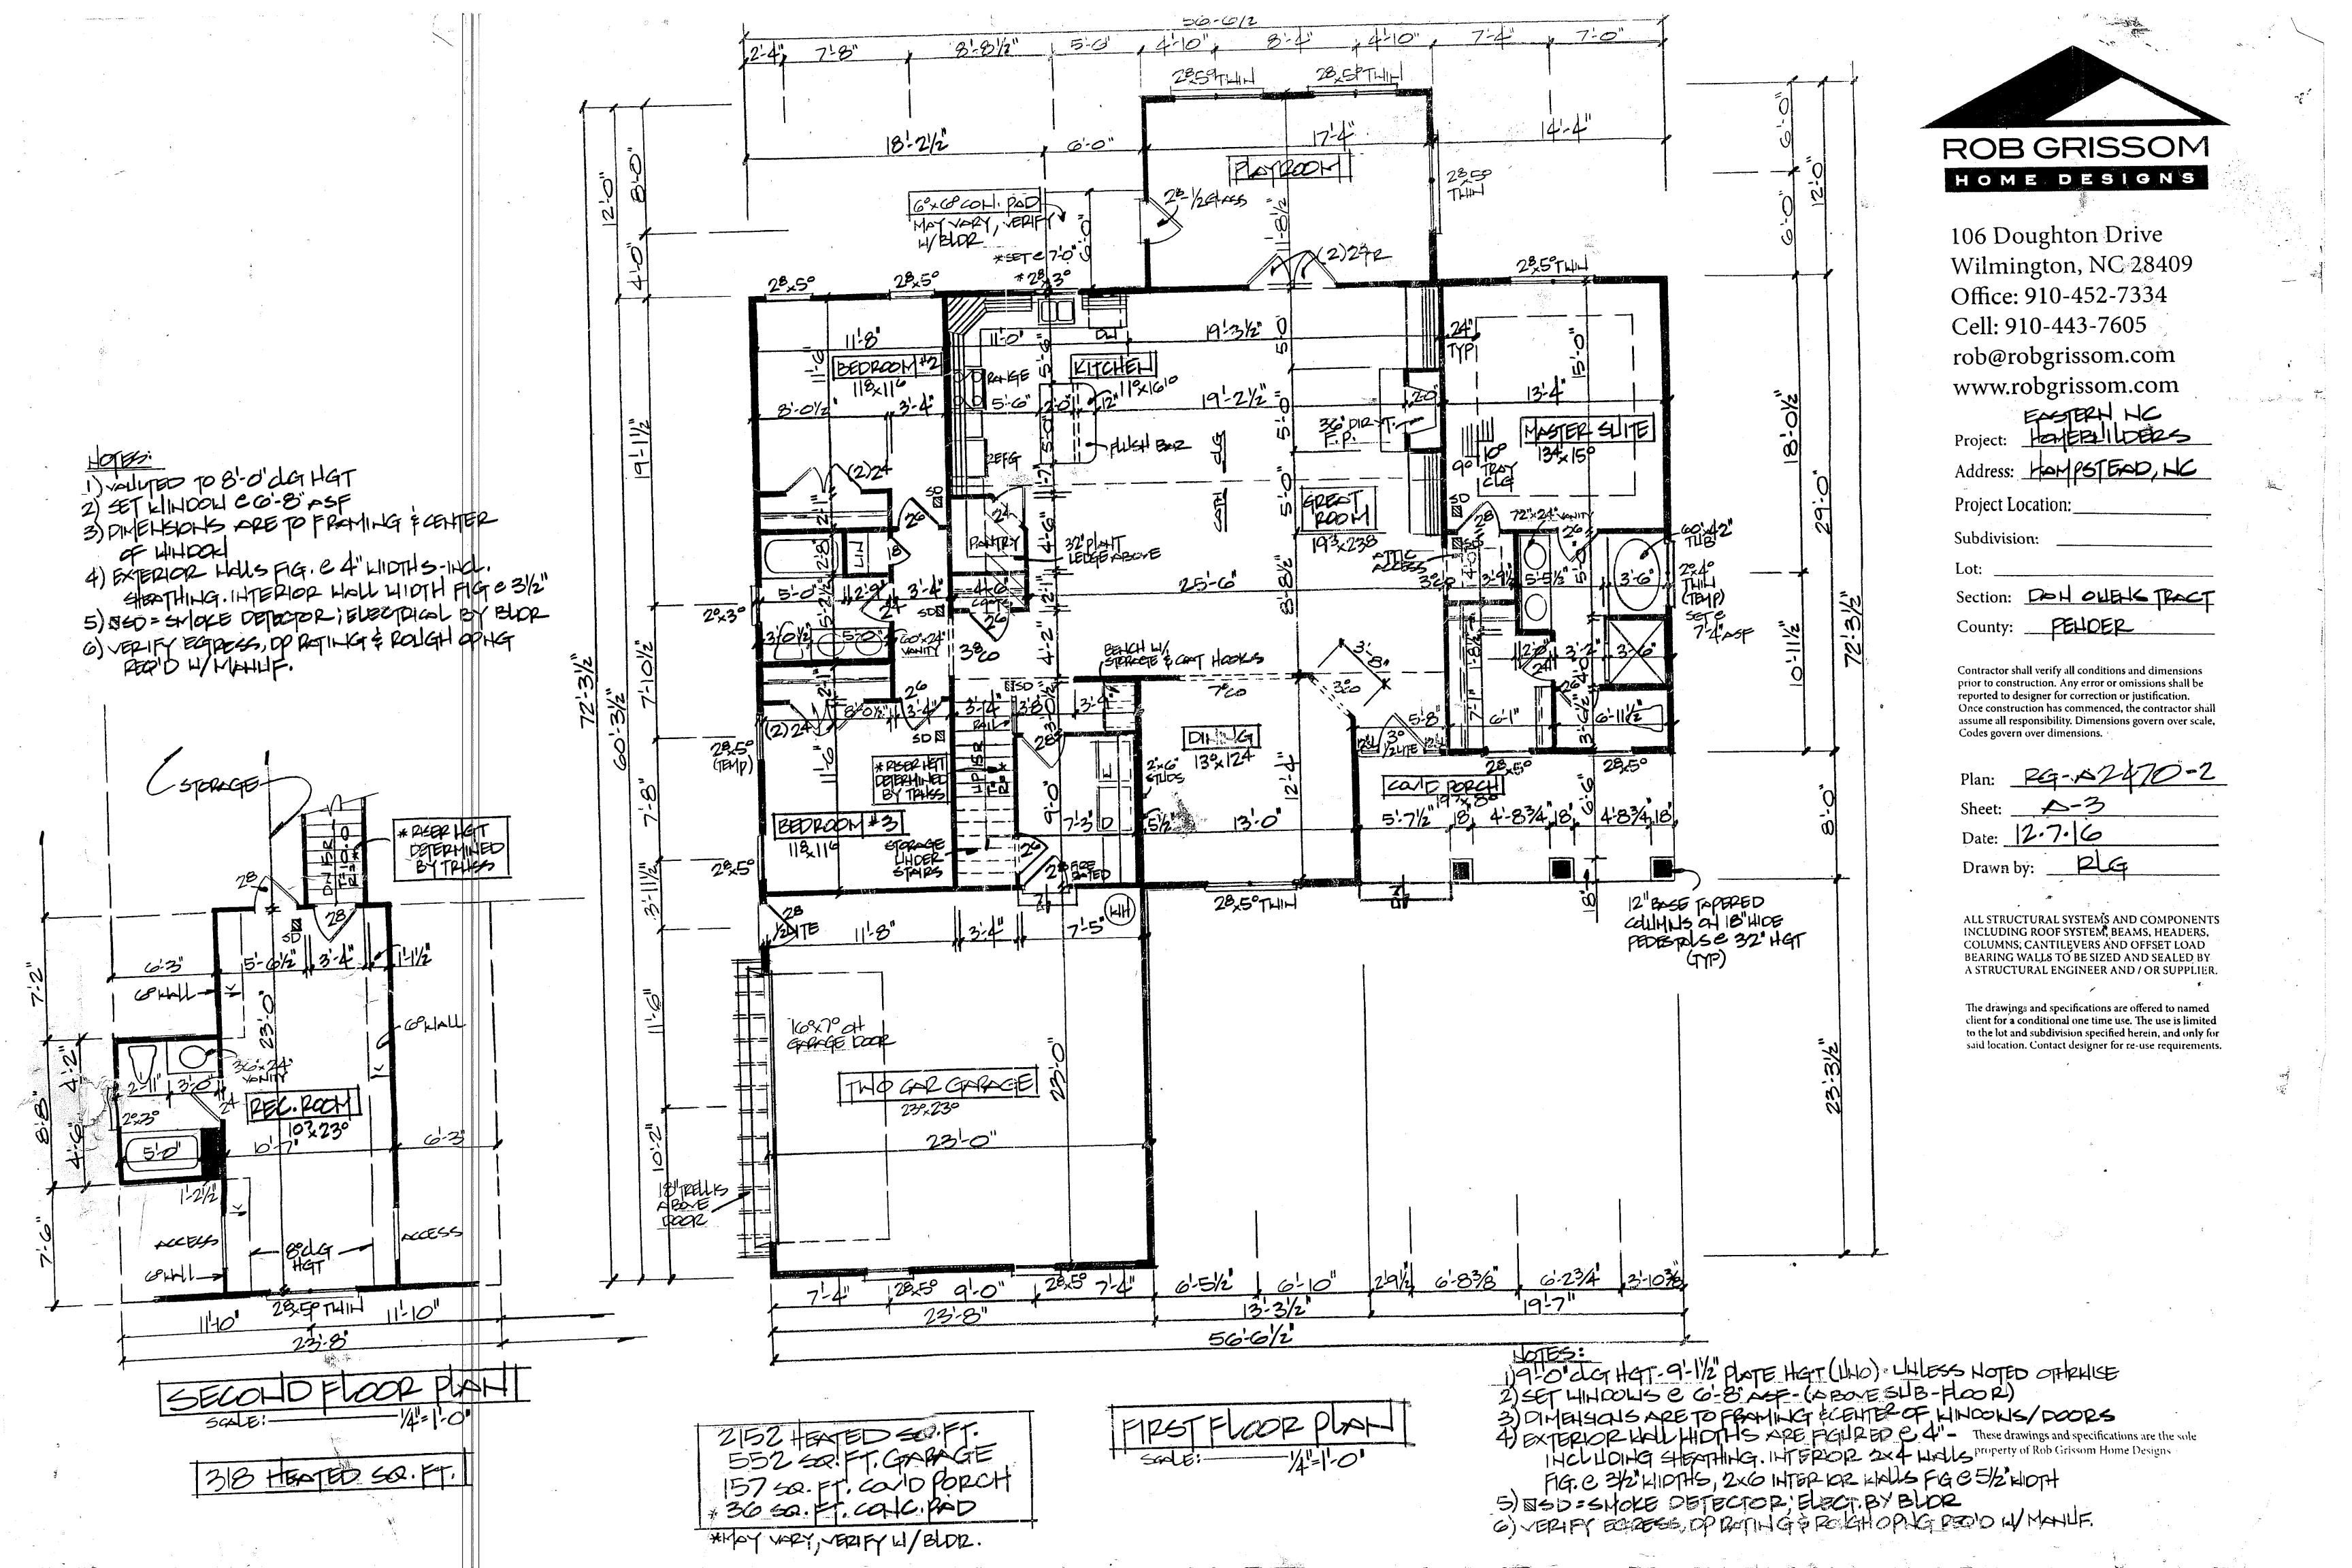OR STRUCTURAL, ENGINEER



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Project: HatERILDERS	<u> </u>
Address: HOMPSTEAD, HO	
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Lot:	
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County: PELICER	

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Once construction has commenced, the contractor shall assume all responsibility. Dimensions govern over scale, Codes govern over dimensions.

Contractor shall verify all conditions and dimensions

Plan:	2G-AV410-L
Sheet:	5-2
Date:	12.7.16
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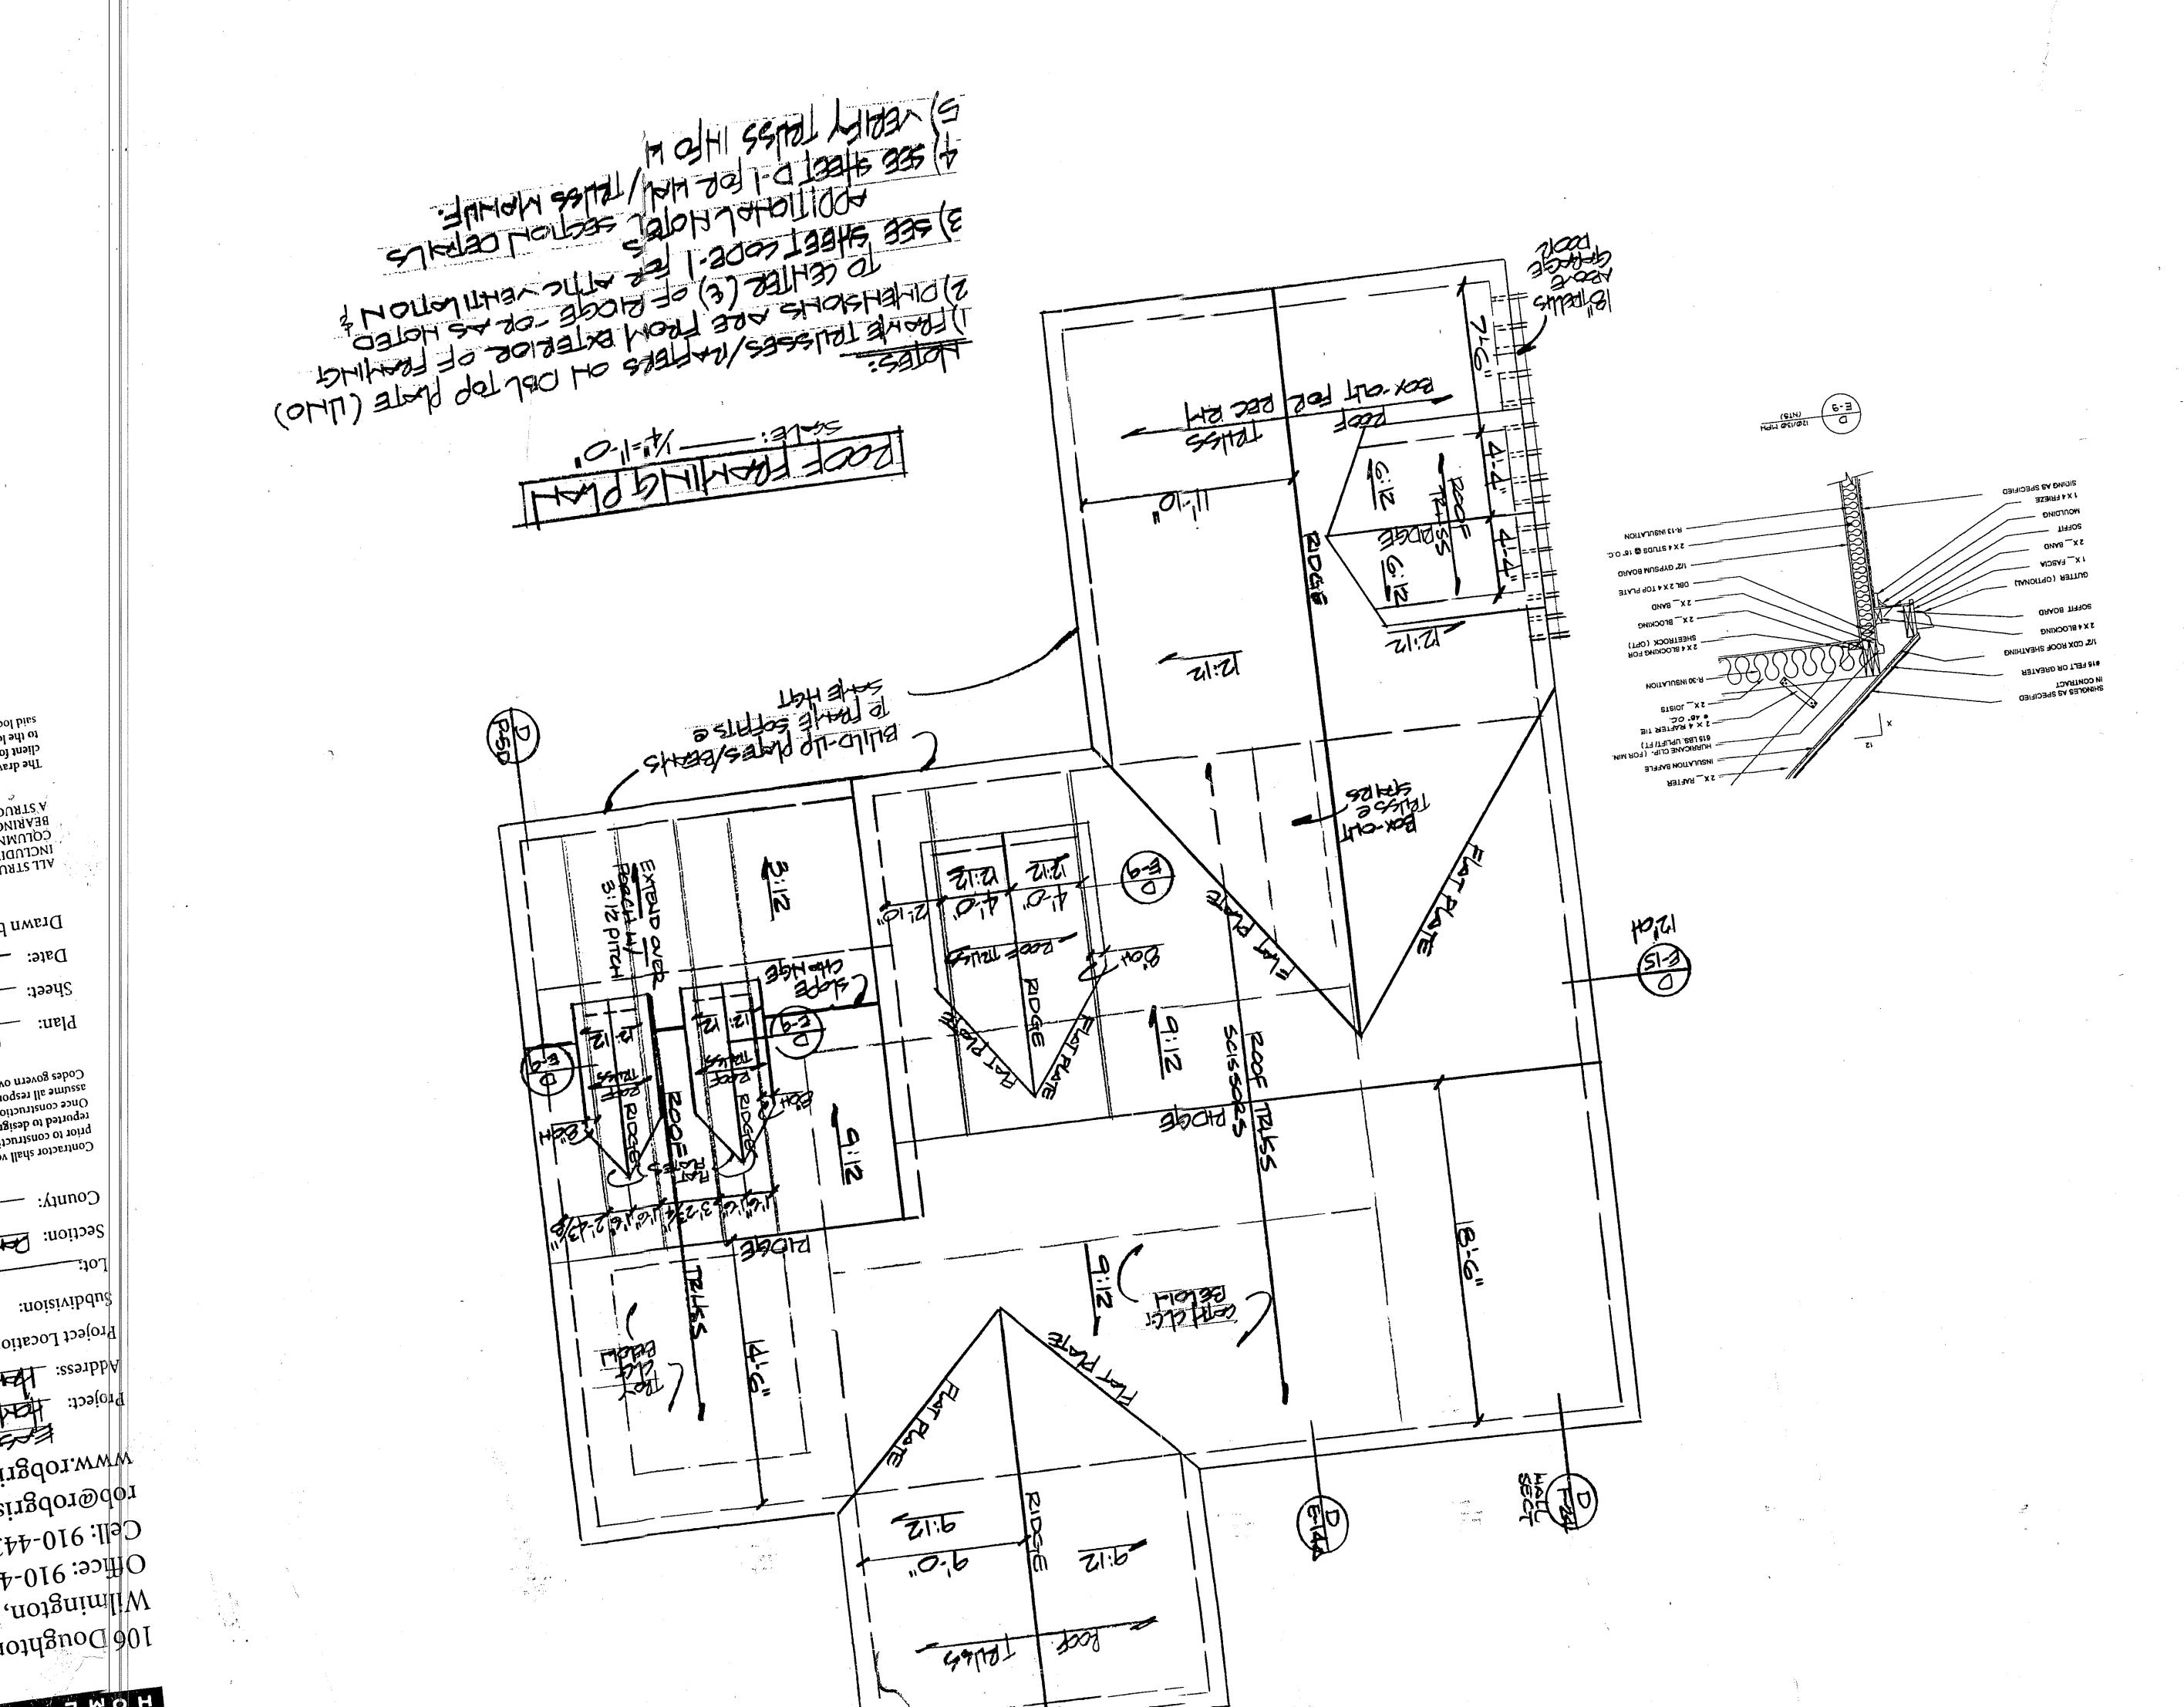
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mos.mossi1gdo1.www mos.mossirgdor@dor Cell: 910-443-7605 Office: 910-452-7334

Wilmington, NC 28409 106 Doughton Drive



## THIS LAYOUT IS TO BE USED AS A TRUSS PLACEMENT GUIDE ONLY. PLEASE REFER TO BUILDING PLANS FOR BUILDING CONSTRUCTION AND DETAILS, SUCH AS PLUMBING OR DUCT DROPS.

12-02-08

Stairs space

3-04-00

23-08-00

DORMER BY

OTHERS

CONSTRUCTION COPY-FOR FIELD USE

# qof

P-5824

Rob Grissom V2 17 Carolina Oaks Ave Smithfield NC 27577

₹ Date Quoted: 1/31/2019 12:00:00 **Designer:** 

Sarah Billings

JE Womble and Sons 805 W Front St Lillington,NC 27546

Hill, NC 27562

Exterior dimensions shown are

 Adjust truss locations as needed for plumbing and mechanical clearance. Unless otherwise noted, trusses may be shifted as long as O.C. spacing shown is not exceeded.
3. Do not cut, drill, or otherwise damage any part of any truss without prior approval from Peak

Truss.
4. Do not approve drawings if any information herein is unclear. Once ordered trusses will be

assumed to be:

☐ Out-to-out of stud

☒ Out-to-out of sheathing

fabricated as approved.

5. Please contact Peak Truss Builders with any questions. We are available to help any way we can. We can be reached at 919-545-5555 or sales@peaktruss.com

Roof Truss Loading per 2012 NC Residential Code

Top Chord Live Load Top Chord Dead Load Bottom Chord Live Load Bottom Chord Dead Load

20# PSF 10# PSF

Trusses are designed for additional storage load wherever a 42"x24" box will fit between the webs.

∴ This symbol denotes left end of truss as shown on truss drawings
 → Approximate location of toilet drop. Builder please confirm.

N -Nailed

L -Ledger

trusses cut short to avoid piggybacks 18-00-00 BBO3 90/12 LOAD BEARING TRAY UP 1' 2-00-00 MASTER TRAY CAP2(11)

> FALSE DORMERS BY OTHERS; TRUSSES FOR

> > 13-03-08

BLOCK BETWEEN FALSE DORMER SUPPORT.

19-07-00

14-04-00

block ridge in field

**ROB GRISSOM V2 ROOF TRUSSES** 2' OC, 1' OH