



Pre-Drawn Plan ID:
BB-2282

These plans are provided as a guide only. The user is responsible for verifying all dimensions and specifications with the local building department. The user is also responsible for obtaining all necessary permits and ensuring that the plans comply with all applicable codes and regulations. The user is not to be held liable for any errors or omissions in these plans.


Date: 12.22.16
 Drawn By: J.A.B.

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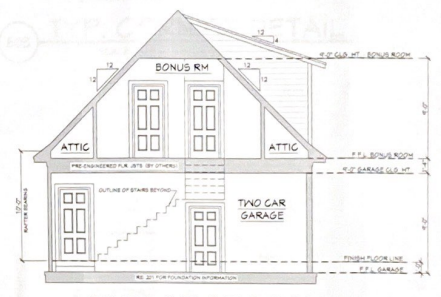


501 BB-2282 FRONT VIEW
 SCALE: 1/4" = 1'-0"

EXTERIOR ELEVATION NOTES:
 1. CONTRACTOR TO VERIFY ALL WINDOW AND DOOR STYLES AND SIZES WITH OWNER PRIOR TO CONSTRUCTION
 2. PROVIDE STEPS AND GUARD RAILS AS PER CODE BASED ON SITE CONDITIONS
 3. GROUND LINES SHOWN FOR REFERENCE ONLY AND VARY DEPENDING ON SITE CONDITIONS
 4. ALL FINISH MATERIALS TO BE VERIFIED WITH OWNER PRIOR TO CONSTRUCTION
 5. REFER TO TYPICAL WALL DETAIL FOR FRAMING METHODS AND OTHER MISC. INFORMATION
 6. CONTRACTOR TO PROVIDE ADEQUATE ROOF VENTILATION AS REQ'D BY CURRENT CODES

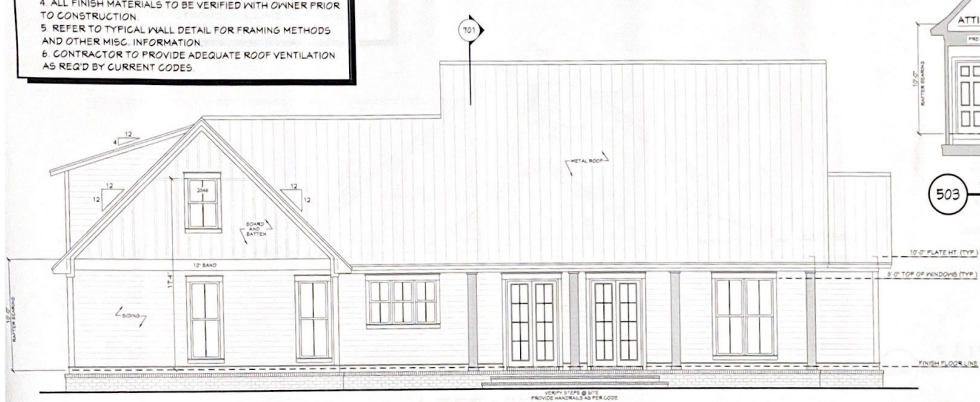

502 REAR VIEW
 SCALE: 1/4" = 1'-0"









503 GARAGE SECTION
 SCALE: 1/4" = 1'-0"



- CROSS SECTION NOTES:**
- 1 CONTRACTOR SHALL COMPLY WITH ALL APPLICABLE CODES AT SITE
 - 2 ONE AS REQ'D BY ALL APPLICABLE CODES AT SITE
 - 3 CONTRACTOR TO PROVIDE RAFTER BRACING TO MEET APPLICABLE CODES
 - 4 CONTRACTOR TO PROVIDE RAFTER BRACING TO MEET APPLICABLE CODES
 - 5 ALL BEAMS TO BE SIZED BY A LICENSED STRUCTURAL ENGINEER
 - 6 ALL LUMBER SIZES AND SPACING TO BE VERIFIED BY CONTRACTOR PRIOR TO CONSTRUCTION
 - 7 CONTRACTOR TO PROVIDE ADEQUATE ROOF VENTILATION AS REQ'D BY CURRENT CODES



701
CROSS SECTION
 SCALE: 3/8"=1'-0"

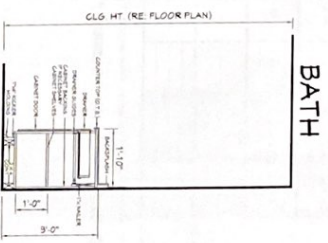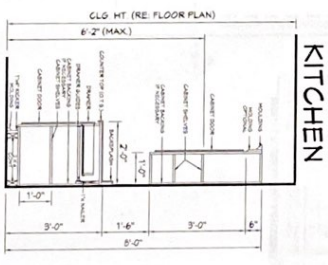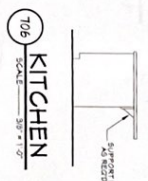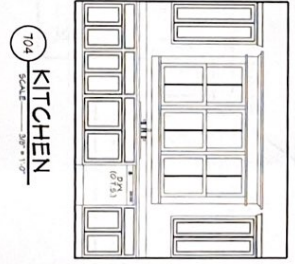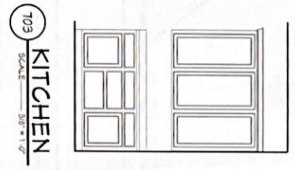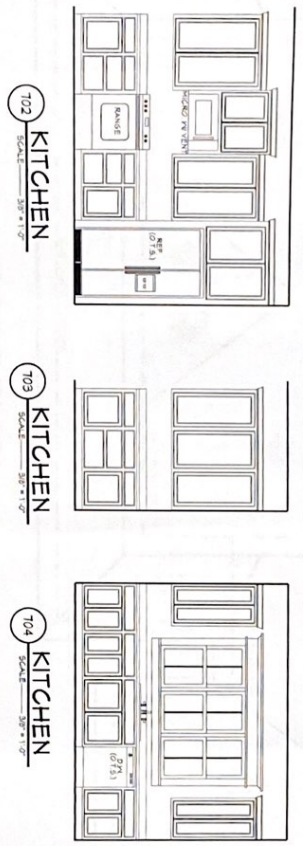

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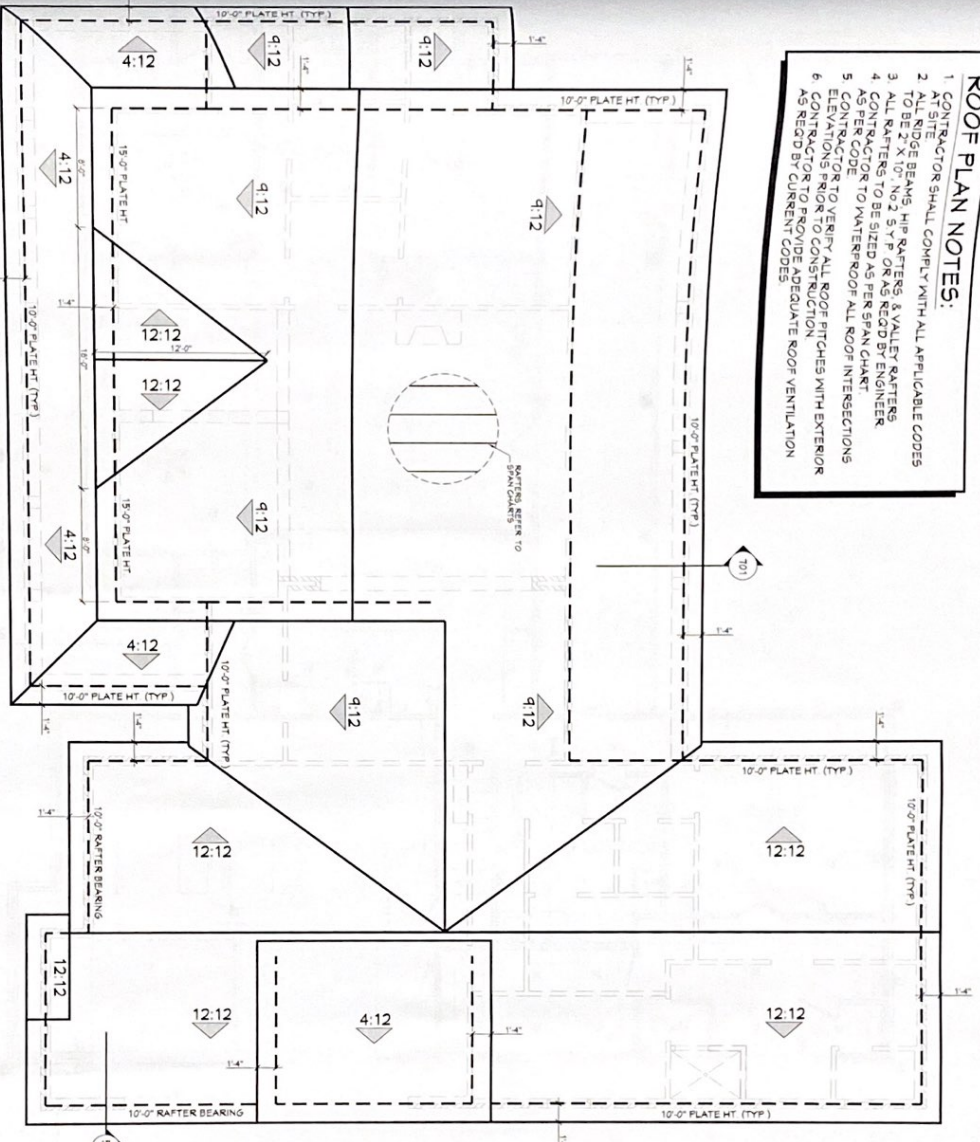
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- ROOF PLAN NOTES:**
1. CONTRACTOR SHALL COMPLY WITH ALL APPLICABLE CODES AT SITE
 2. ALL RIDGE BEAMS, HIP RAFTERS & VALLEY RAFTERS TO BE 2" X 11"
 3. ALL RAFTERS NO 2 S Y P OR AS READ BY ENGINEER
 4. CONTRACTOR TO BE SIZED AS PER SPAN CHART AS PER CODE
 5. CONTRACTOR TO WATERPROOF ALL ROOF INTERSECTIONS
 6. CONTRACTOR TO PROVIDE ADEQUATE ROOF VENTILATION AS READ BY CURRENT CODES



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ROOF PLAN
 SCALE 1/4" = 1'-0"

HIP/VALLEY CONVERSION

RAFTER PITCH	VALLEY PITCH
4:12	12:12
6:12	18:12
8:12	24:12
120:12	360:12

RAFTER LENGTH CHART

RAFTER PITCH	RAFTER LENGTH
4:12	1.08
6:12	1.20
8:12	1.36
10:12	1.50
12:12	1.68
14:12	1.80
16:12	1.98
18:12	2.16
120:12	11.34

RAFTER SPANS

RAFTER SPANS FOR SOUTHERN PINE SPECIES
 LIVE LOAD=50psf, DEAD LOAD=10psf

SIZE	SPACING (INCHES)	SPAN (FEET)
2 X 4	12.0	12.11
2 X 4	16.0	11.2
2 X 4	18.0	10.2
2 X 4	24.0	9.2
2 X 6	12.0	16.4
2 X 6	16.0	14.2
2 X 6	18.0	12.11
2 X 6	24.0	10.2
2 X 8	12.0	22.10
2 X 8	16.0	18.4
2 X 8	18.0	16.10
2 X 8	24.0	14.2

NOTES: THE ABOVE TABLES ARE BASED ON THE IRC 2015 TABLE R402.2 (19)

CEILING JOIST SPANS

CEILING JOIST SPANS FOR SOUTHERN PINE SPECIES
 UNIFORM DEAD LOAD=10psf, UNIFORM LIVE LOAD=20psf (A20)

SIZE	SPACING (INCHES)	SPAN (FEET)
2 X 4	12.0	12.11
2 X 4	16.0	11.2
2 X 4	18.0	10.2
2 X 4	24.0	9.2
2 X 6	12.0	16.4
2 X 6	16.0	14.2
2 X 6	18.0	12.11
2 X 6	24.0	10.2
2 X 8	12.0	22.10
2 X 8	16.0	18.4
2 X 8	18.0	16.10
2 X 8	24.0	14.2

NOTES: THE ABOVE TABLES ARE BASED ON THE IRC 2015 TABLE R402.2 (19)



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