ALL CONSTRUCTION SHALL CONFORM TO THE 2018 EDITION OF THE NC STATE BUILDING CODE.


CODES GOVERN OVER DRAWINGS.


DIMENSIONS GOVERN OVER SCALE.

VERIFY ALL MECHANICAL REQUIREMENTS BEFORE FRAMING.

VUNCANNON DESIGNS DOES NOT ASSUME LIABILITY FOR ANY DEVIATION OF OR CONSTRUCTION METHODS OF THESE PLANS.

BUILDER SHALL VERIFY ALL DIMENSIONS AND CONDITIONS AT TIME OF CONSTRUCTION.

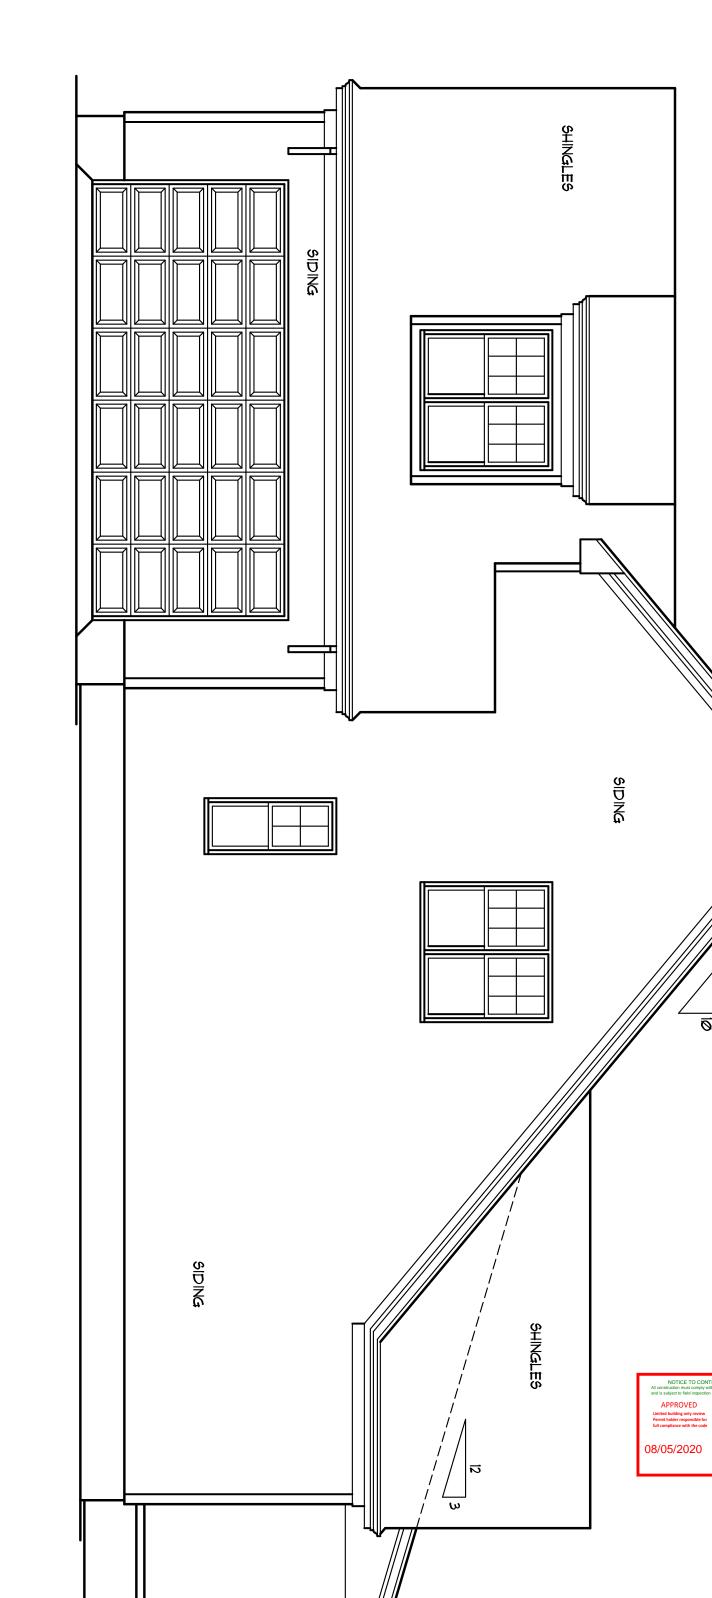

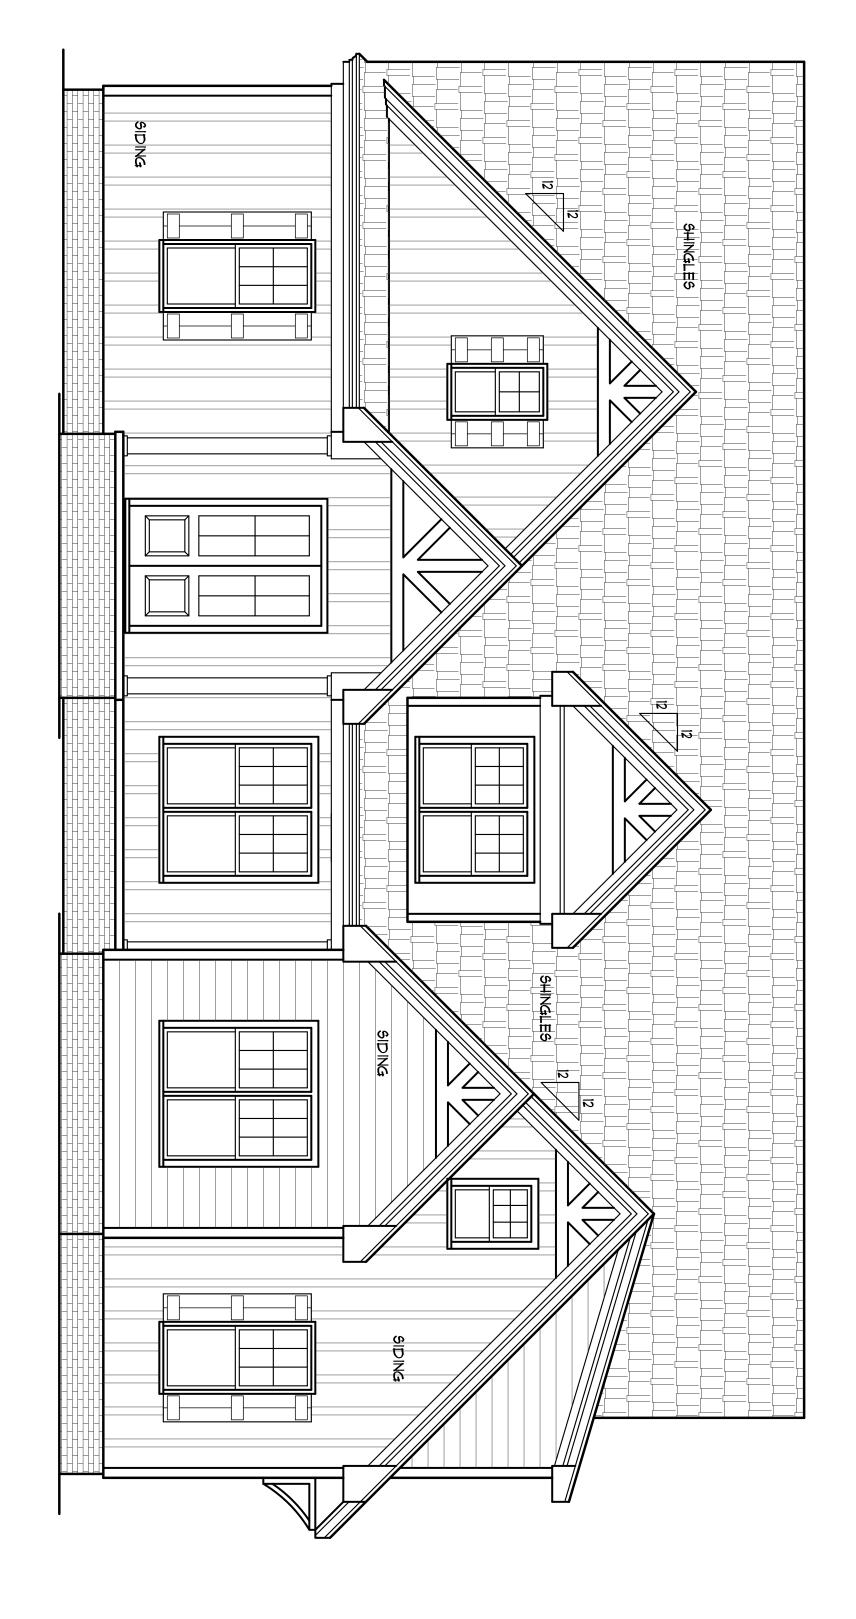

Plan No. 2643=15=

=	DRAWN BY: WRY CHK'D BY: WRY DATE: 03/30/20 REVISIONS:

BUILDER SHALL VERIFY ALL DIMENSIONS AND CONDITIONS AT TIME OF CONSTRUCTION.


ALL CONSTRUCTION SHALL CONFORM TO THE 2018 EDITION OF THE NC STATE BUILDING CODE.

CODES GOVERN OVER DRAWINGS.


DIMENSIONS GOVERN OVER SCALE.

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VUNCANNON DESIGNS DOES NOT ASSUME LIABILITY FOR ANY DEVIATION OF OR CONSTRUCTION METHODS OF THESE PLANS.

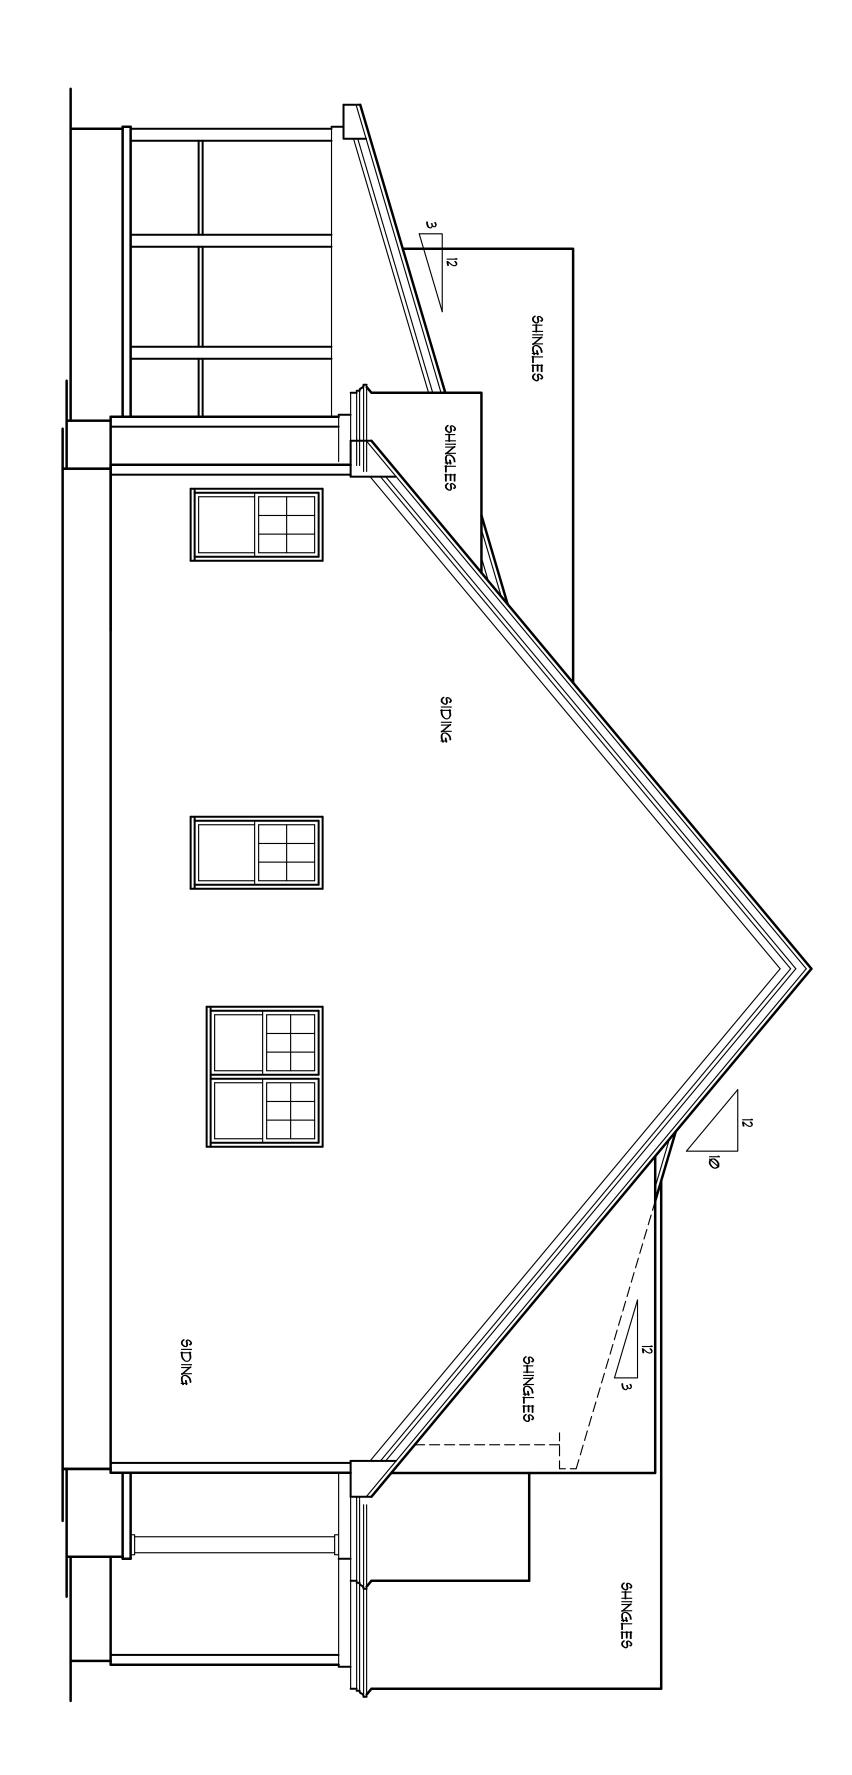


SCALE: 1/4" = 1'-0"

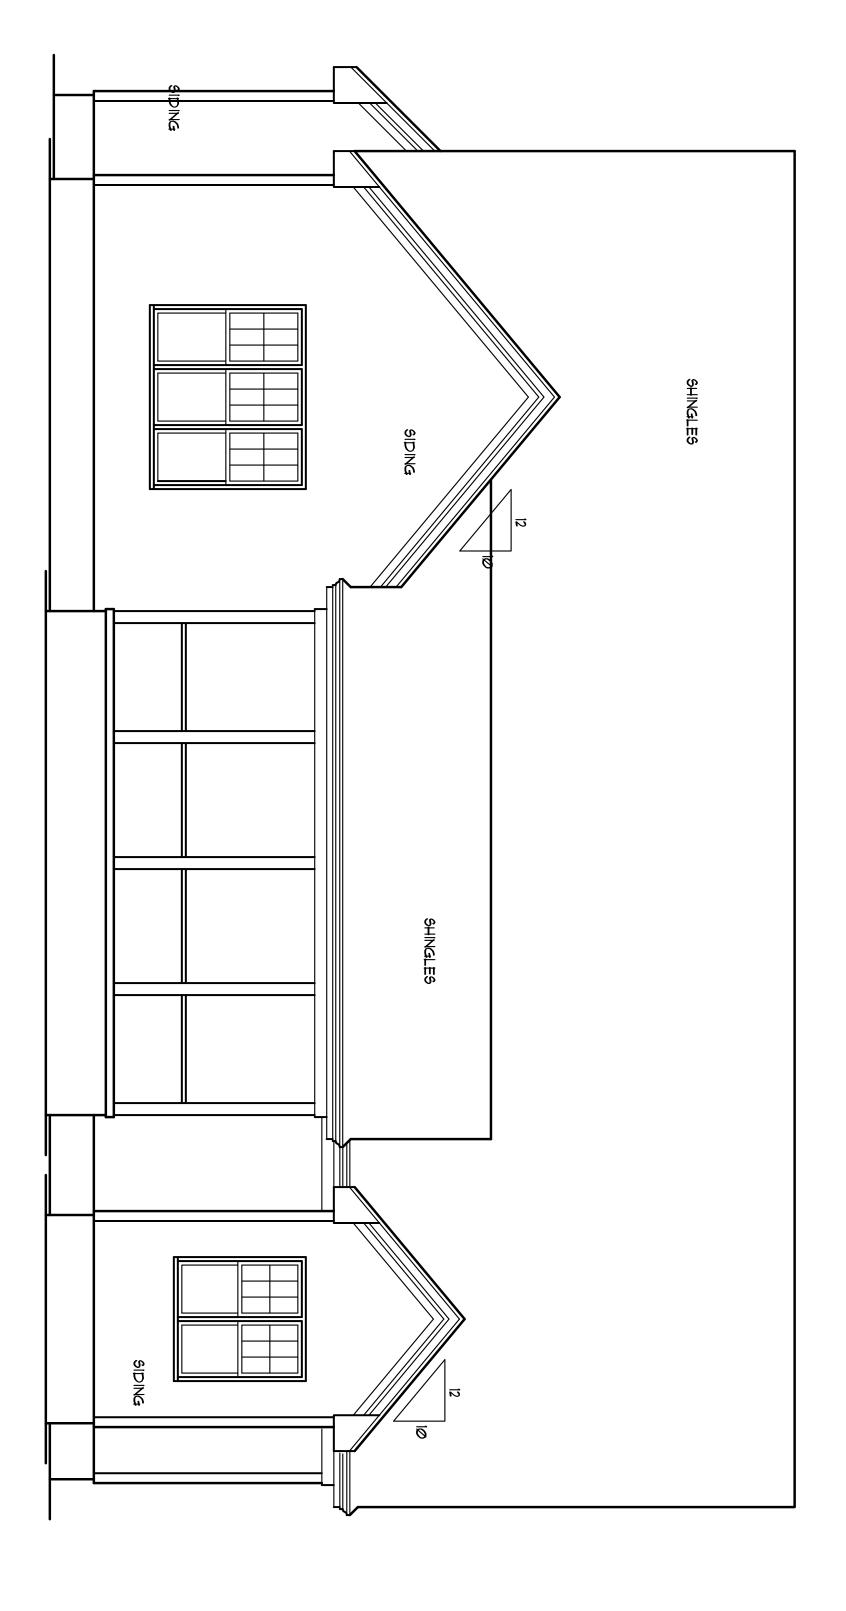


4" = 1'-0"

Plan No. 2643=15

<b>=</b> <del> </del>	DRAWN BY: WRY CHK'D BY: WRY DATE: 03/30/20 REVISIONS:

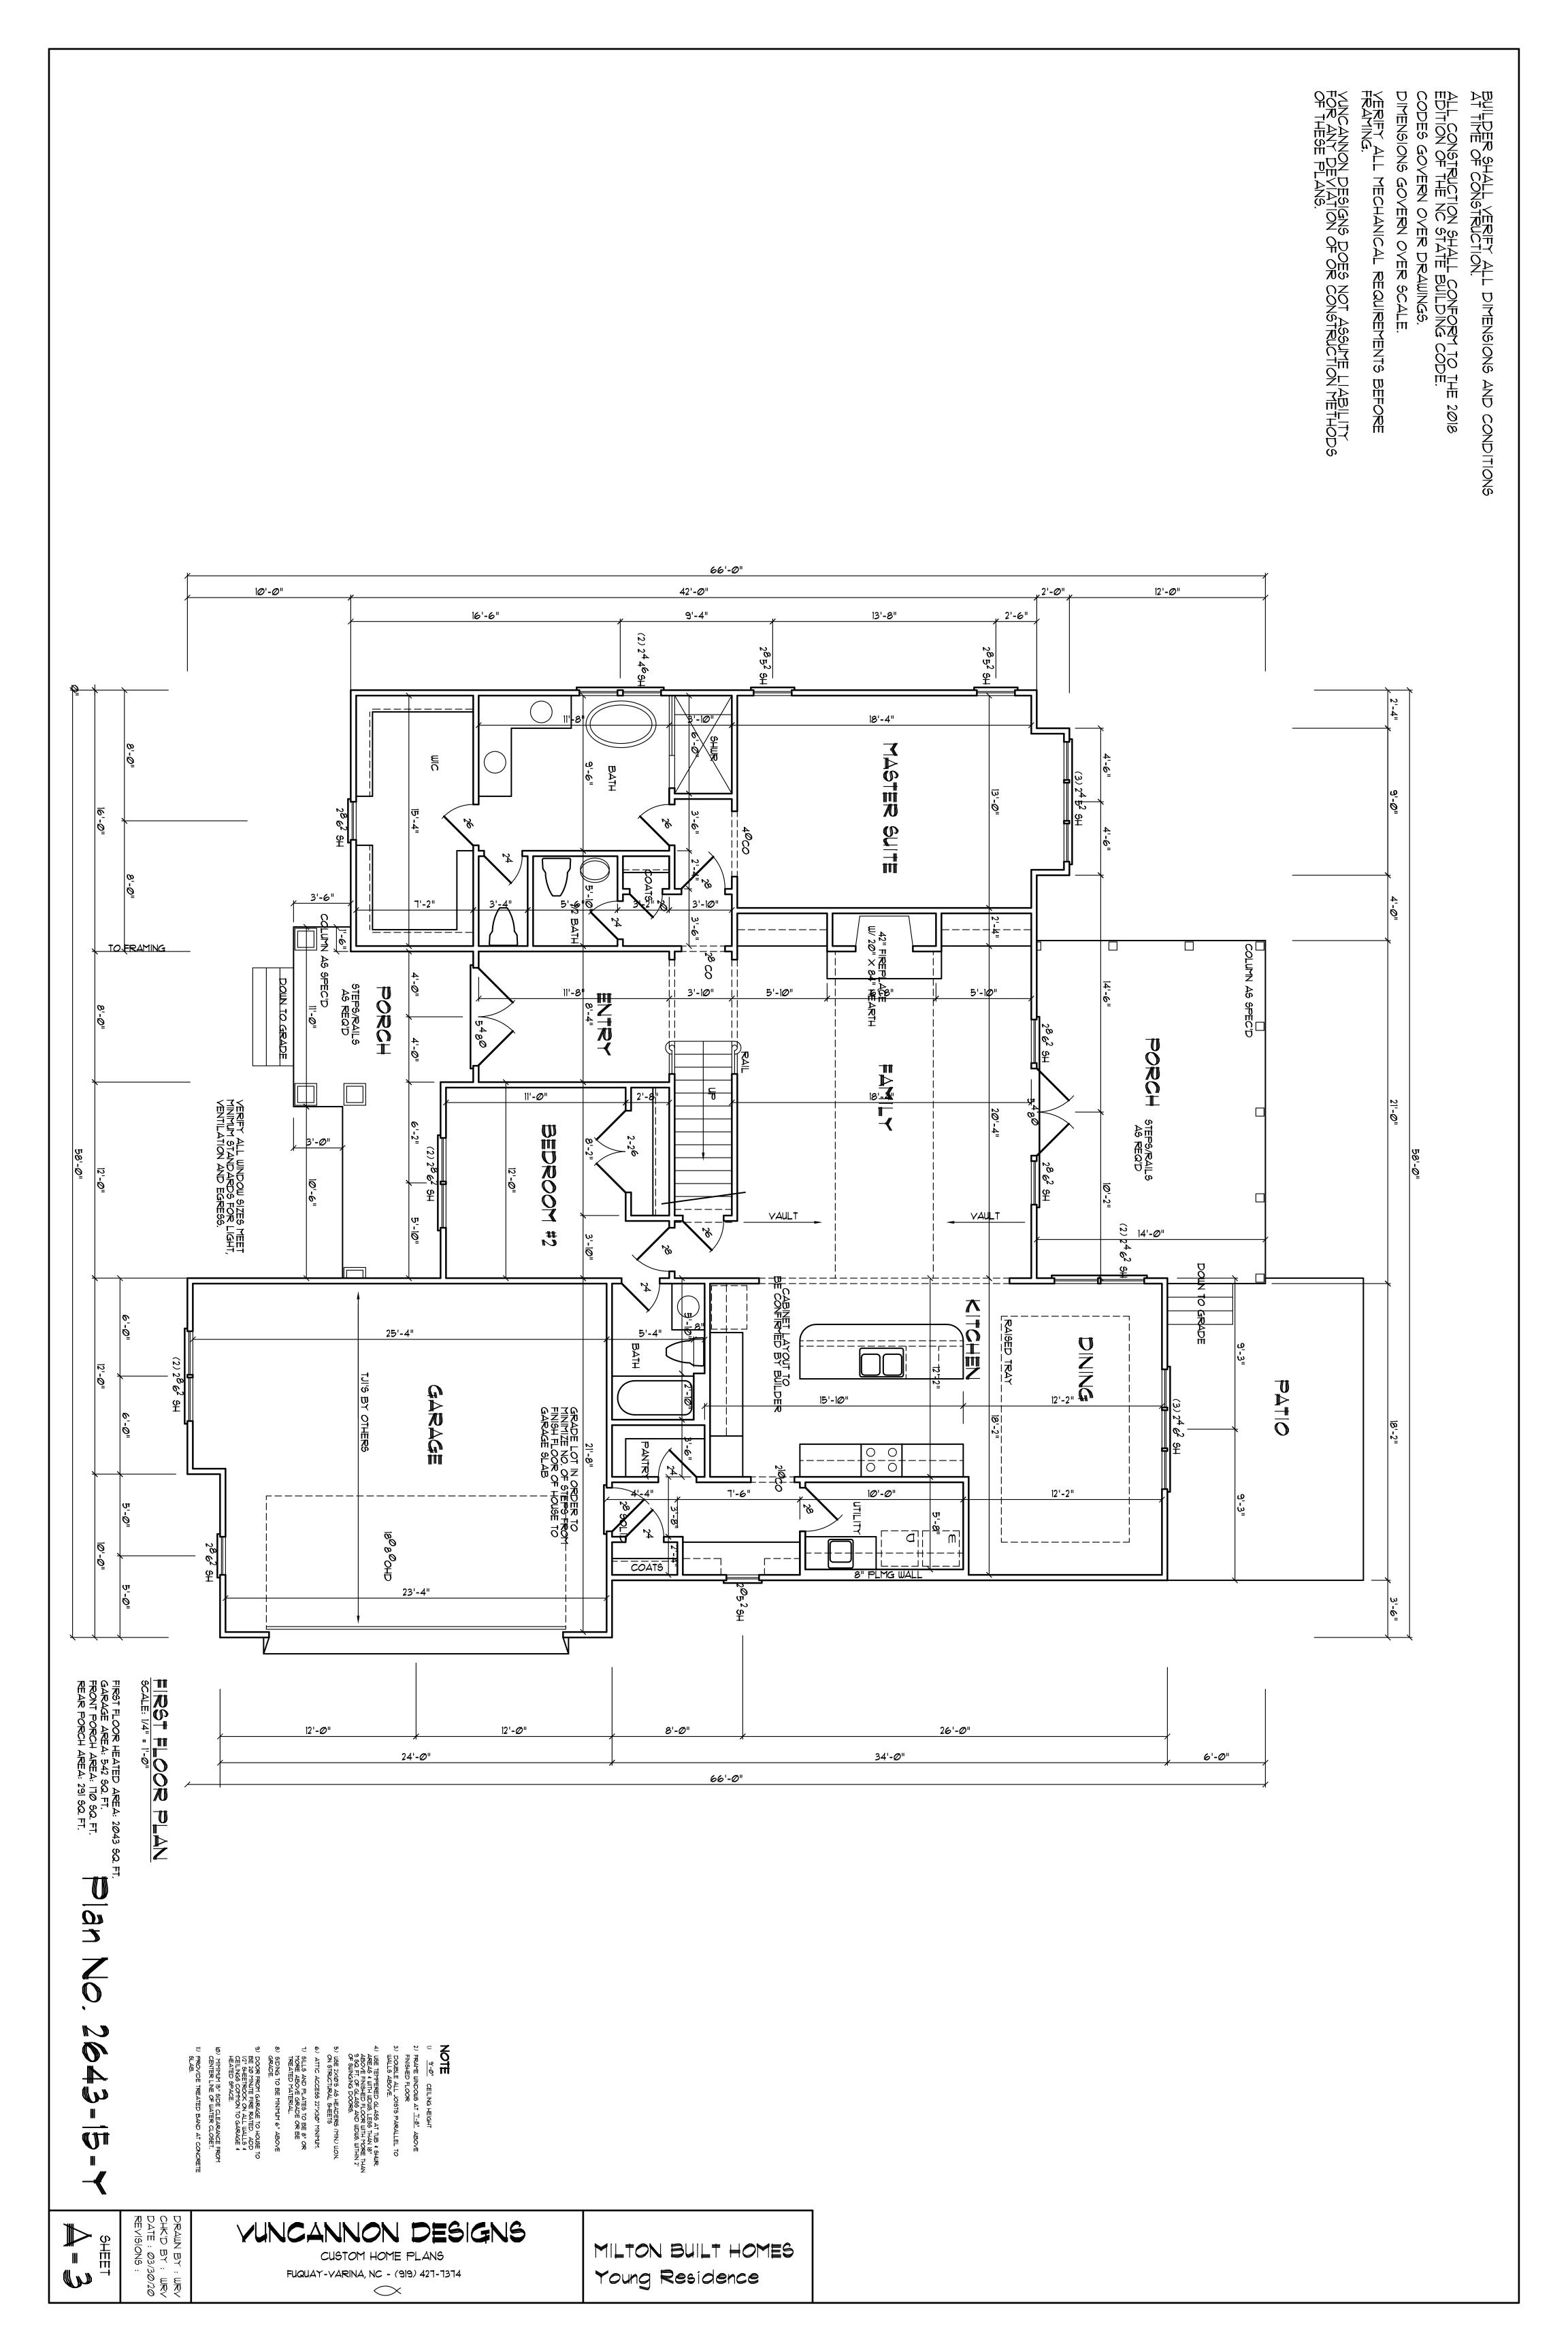

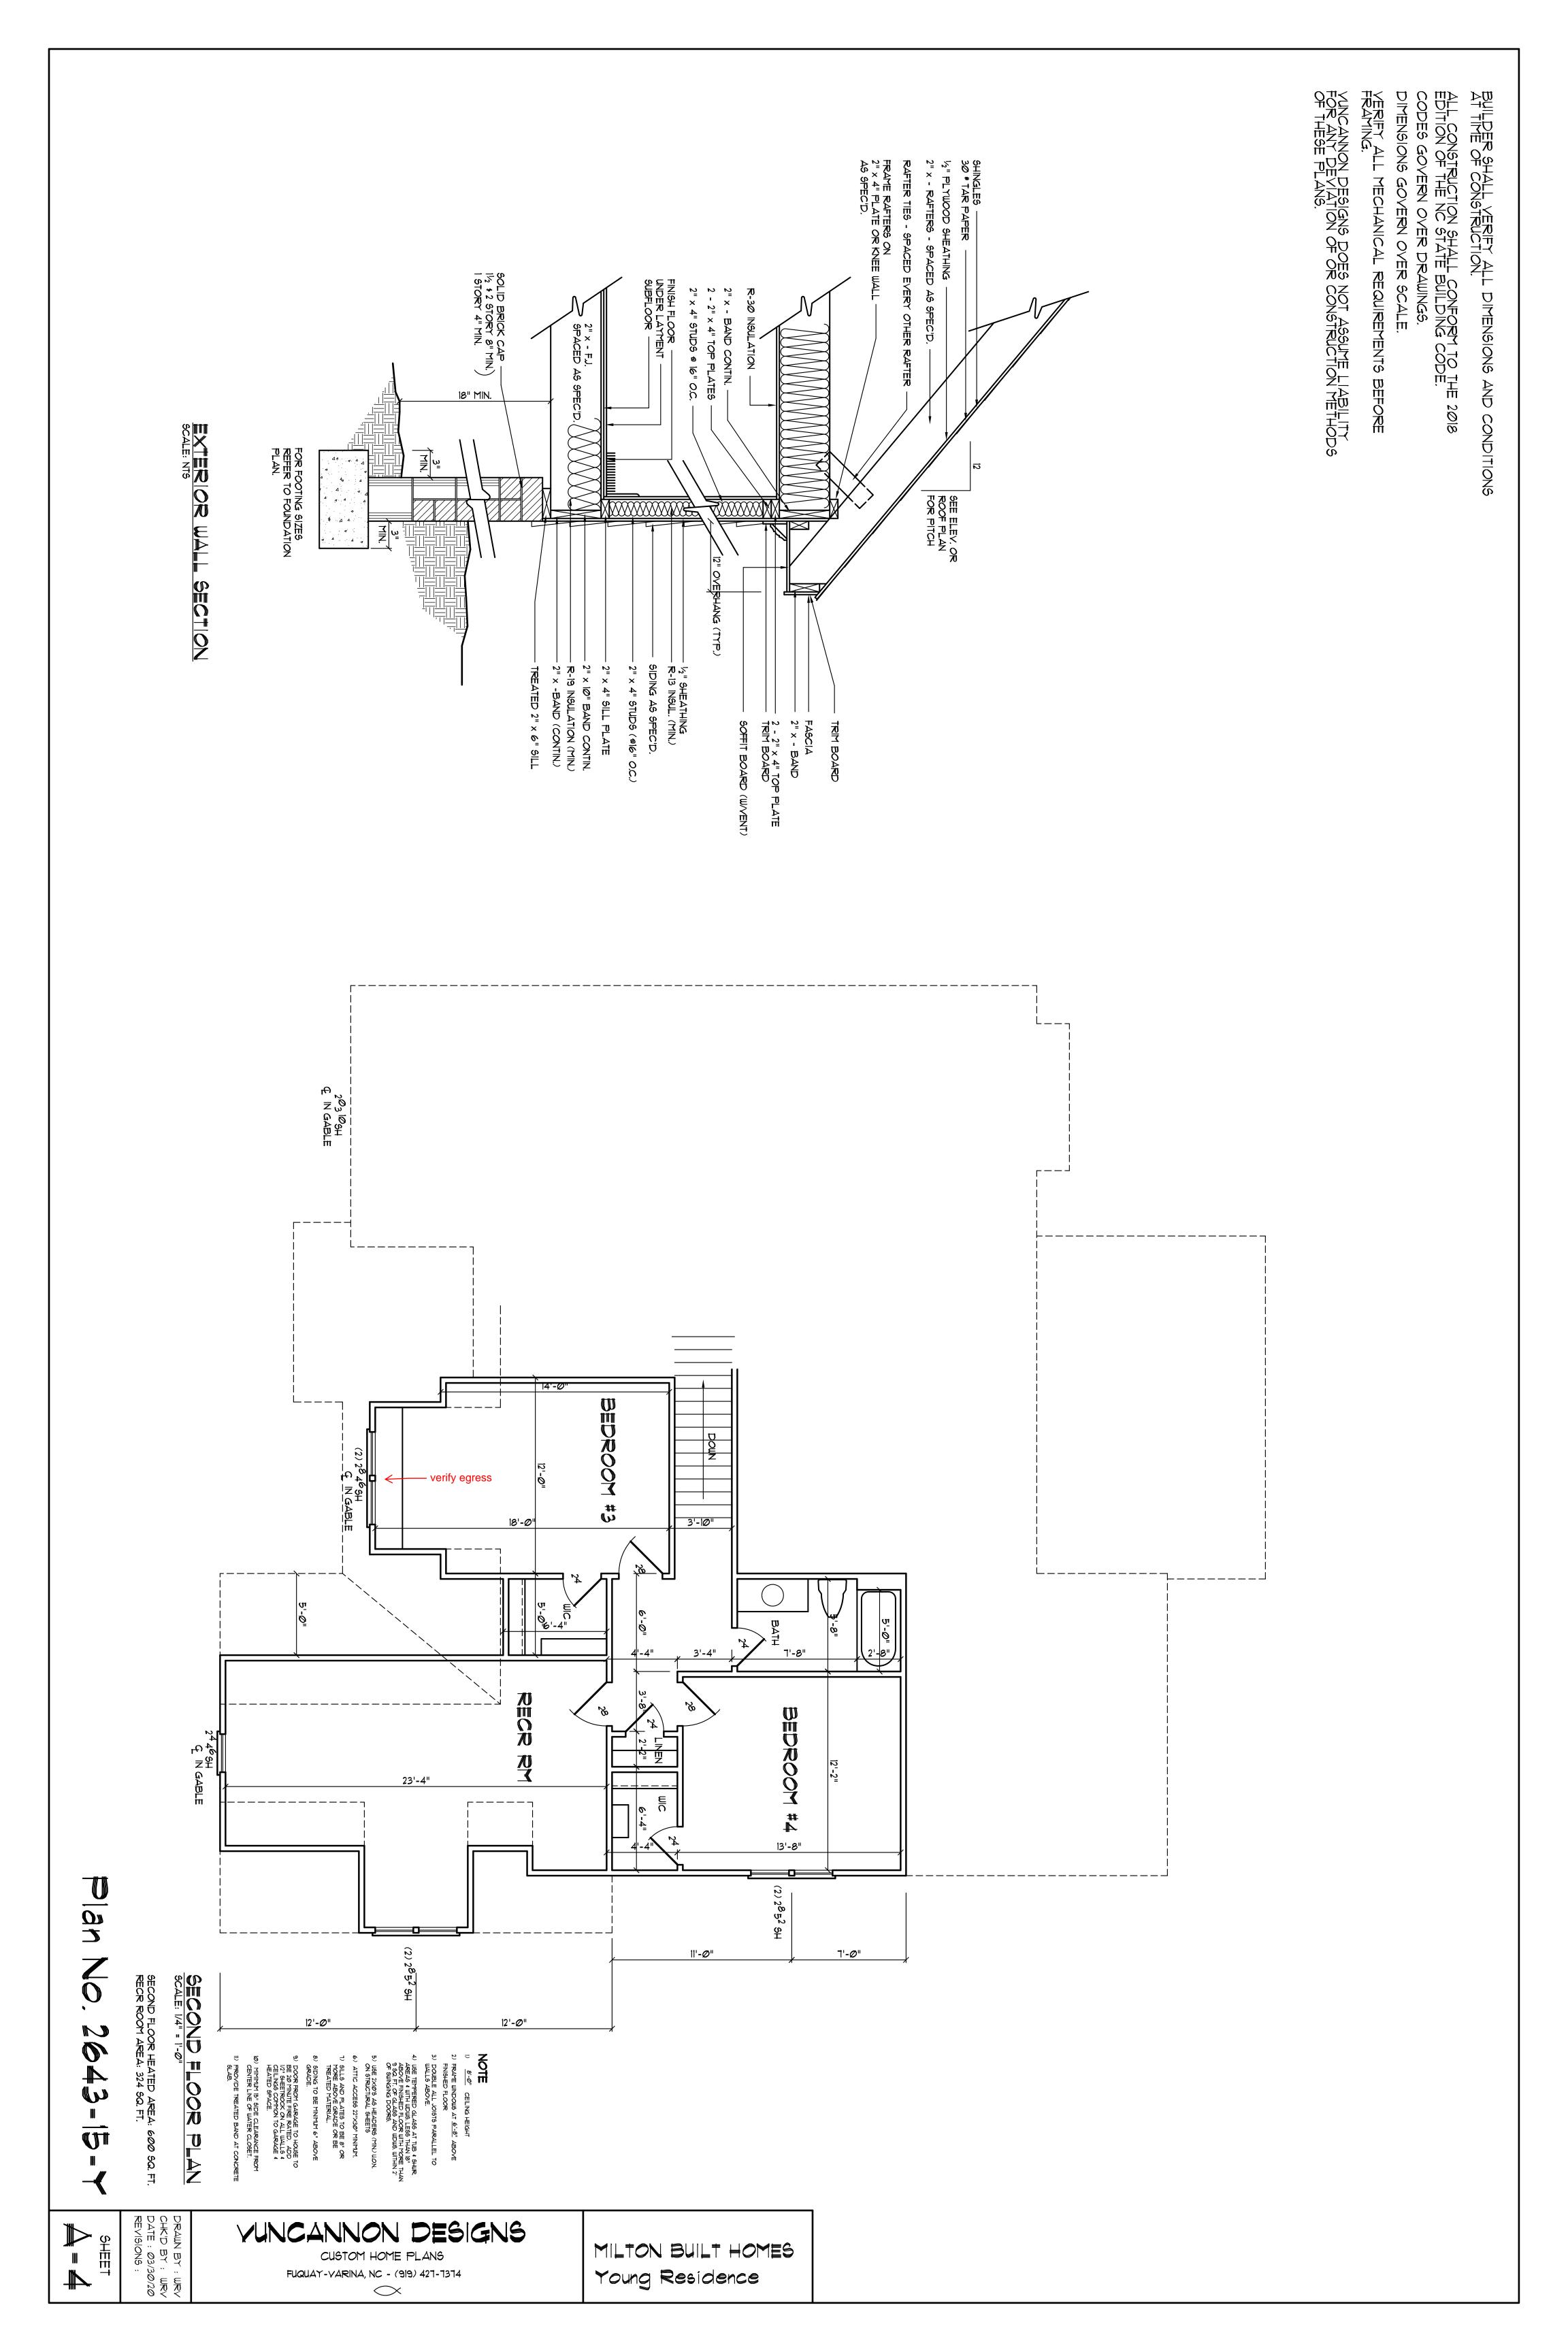

**GENERAL FOUNDATION NOTES:** 

2018 EDITION.

STRUCTURAL CONCRETE UNLESS OTHERWISE

BE PREPARED AND PLACED IN ACCORDANCE

CONDITIONS AND CONTACT SOIL ENGINEER IF

ADJACENT FINISH GRADE OR AS OTHERWISE

FOUNDATION WALL HEIGHT, THICKNESS AND

REFER TO STATE AND LOCAL BUILDING

BEARING CAPACITY=2000 PSF.

SOILS ARE ENCOUNTERED.

R405 OF THE CODE "FOUNDATION

R406 OF THE CODE "FOUNDATION

INSPECTOR.


DAMPPROOFING".

OTHERWISE.

03/30/2020

S1 FOUNDATION PLAN

03 29 2020

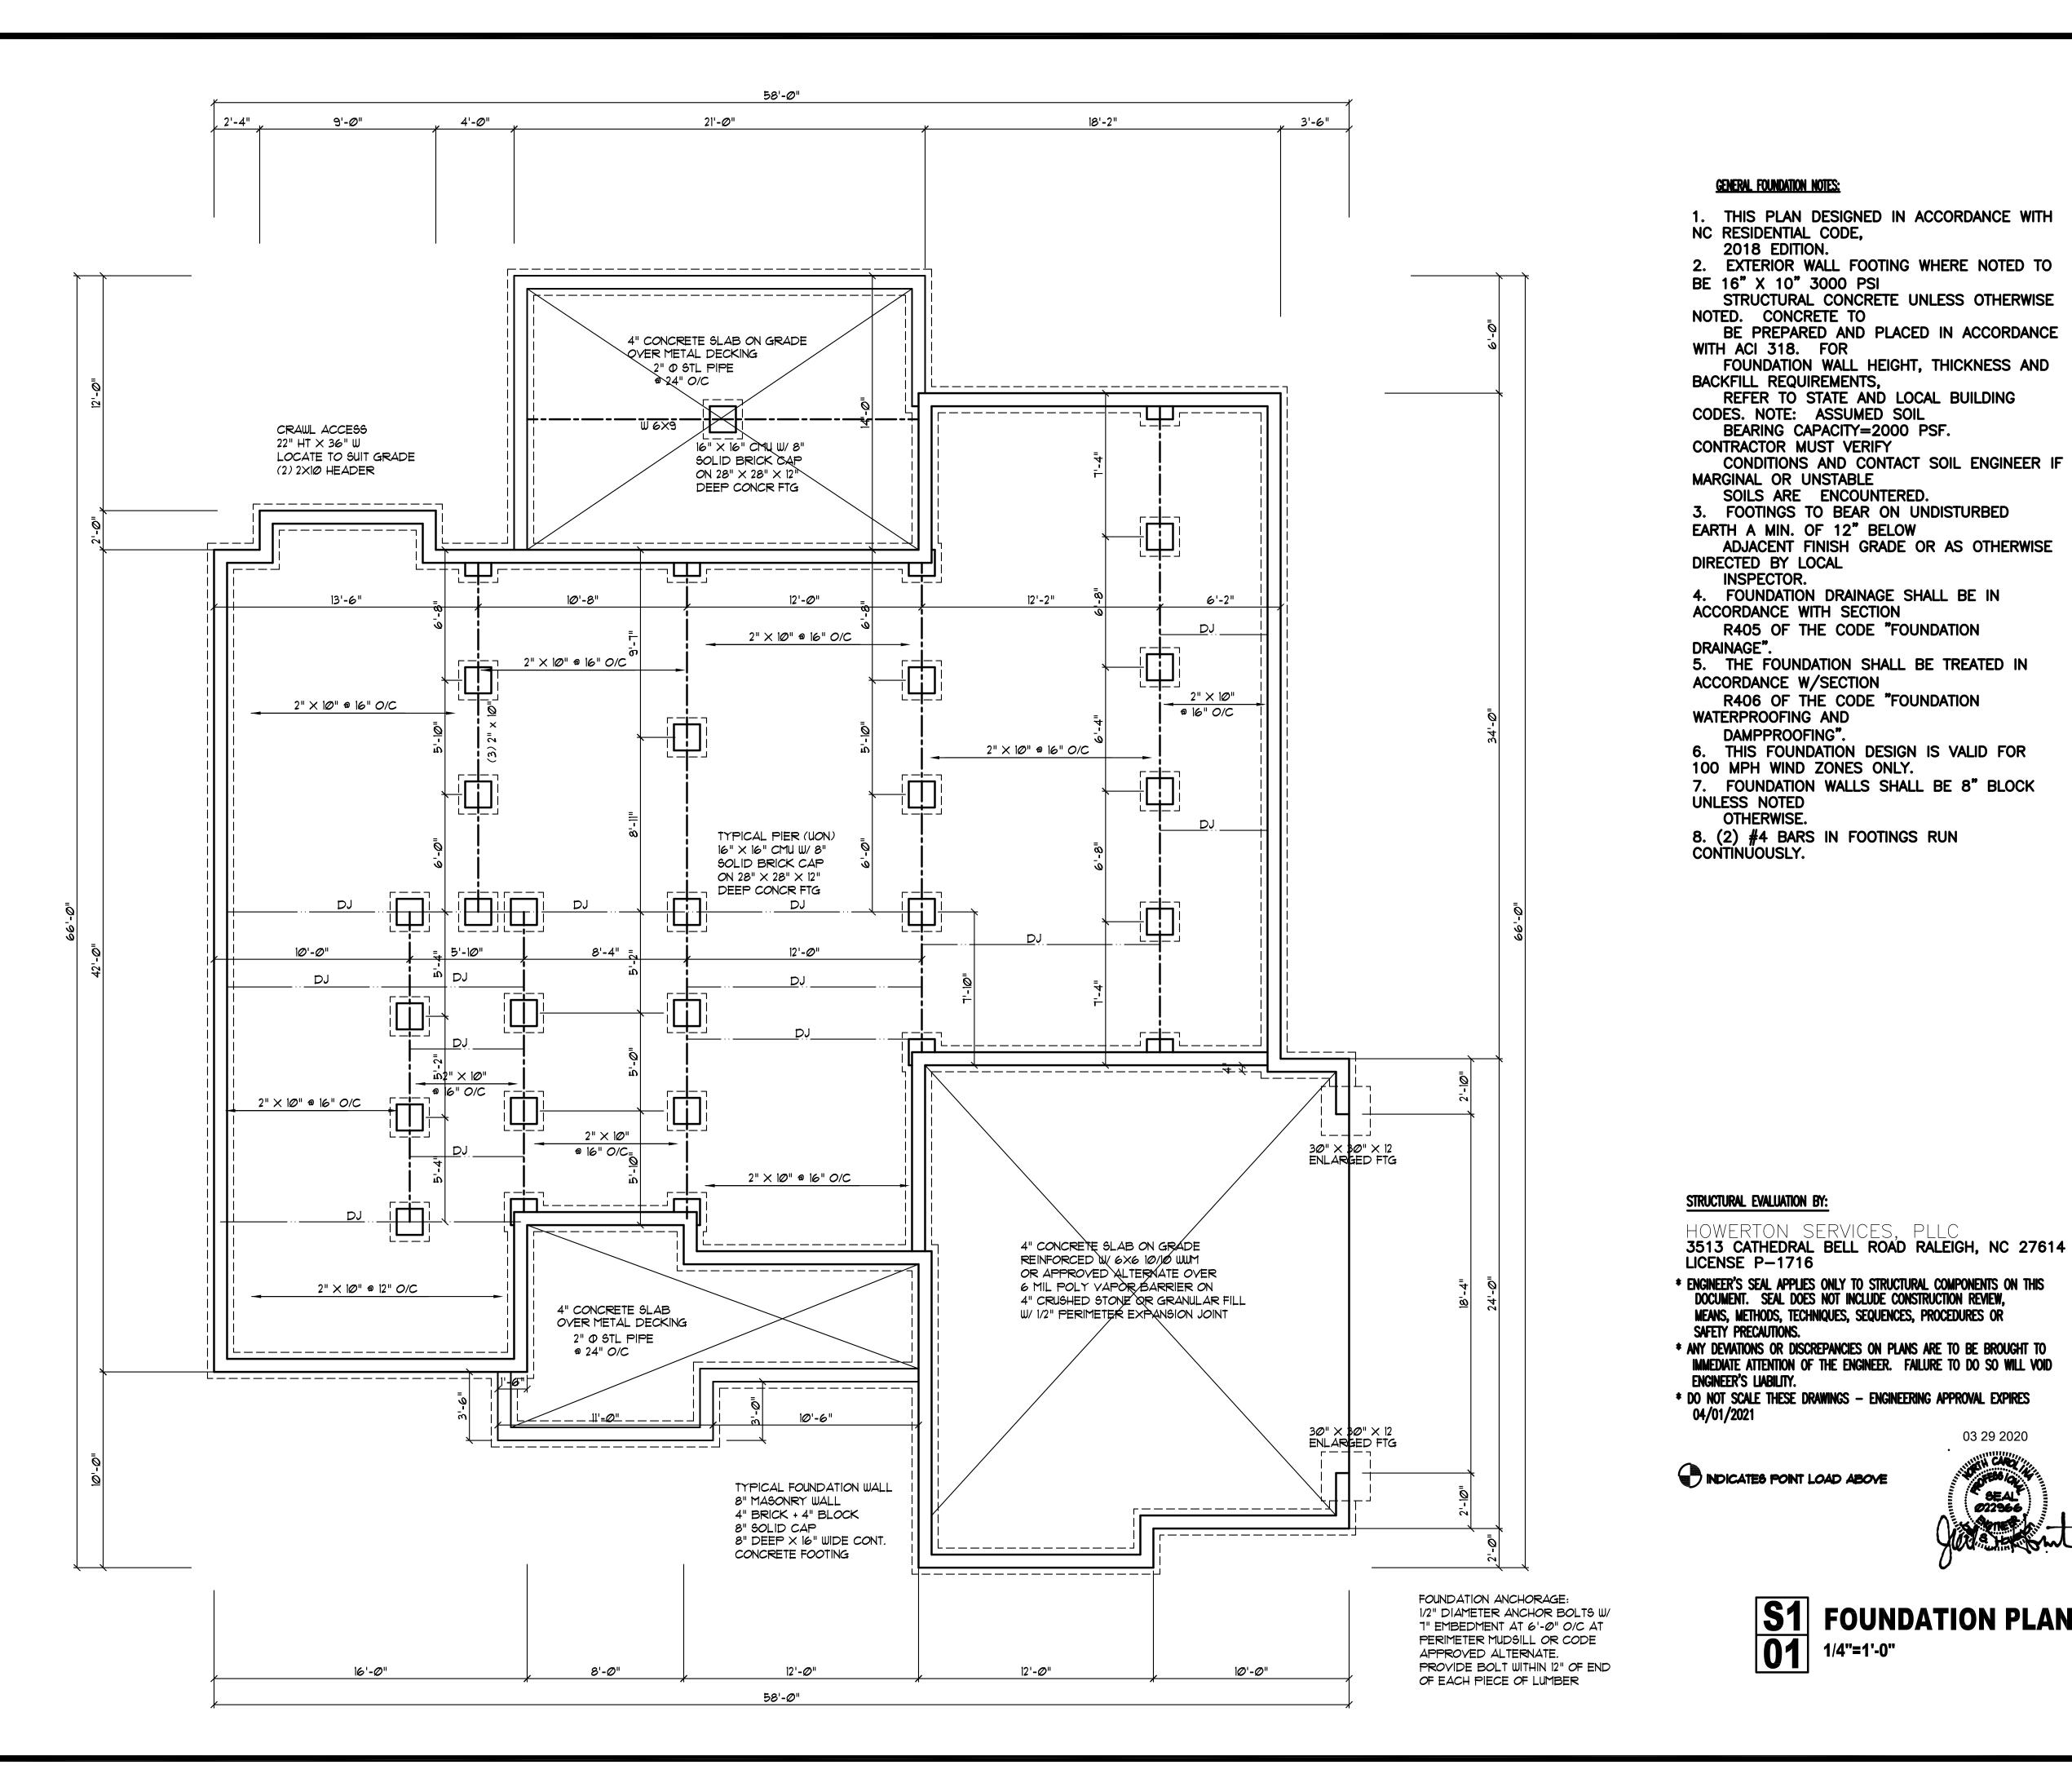


CRAWL SPACE VENTILATION PROVIDE AT LEAST 1.0 SQ. FT. NET FREE VENTILATION AREA FOR EACH 150 SQ. FT. OF CRAWL SPACE

CRAWL SPACE AREA: 2504 / 150 = 16.69 SQ. FT. REQ'D. REDUCE REQUIRED AREA TO 1.0 SQ. FT. NET FREE VENTILATION AREA FOR EACH 1500 SQ. FT. OF CRAWL SPACE WITH APPROVED VAPOR BARRIER

PROVIDE (1) VENT WITHIN 3'-0" OF EACH

REFER TO MANUFACTURER SPECIFICATIONS FOR ACTUAL VENTS USED TO DETERMINE NUMBER OF VENTS REQUIRED

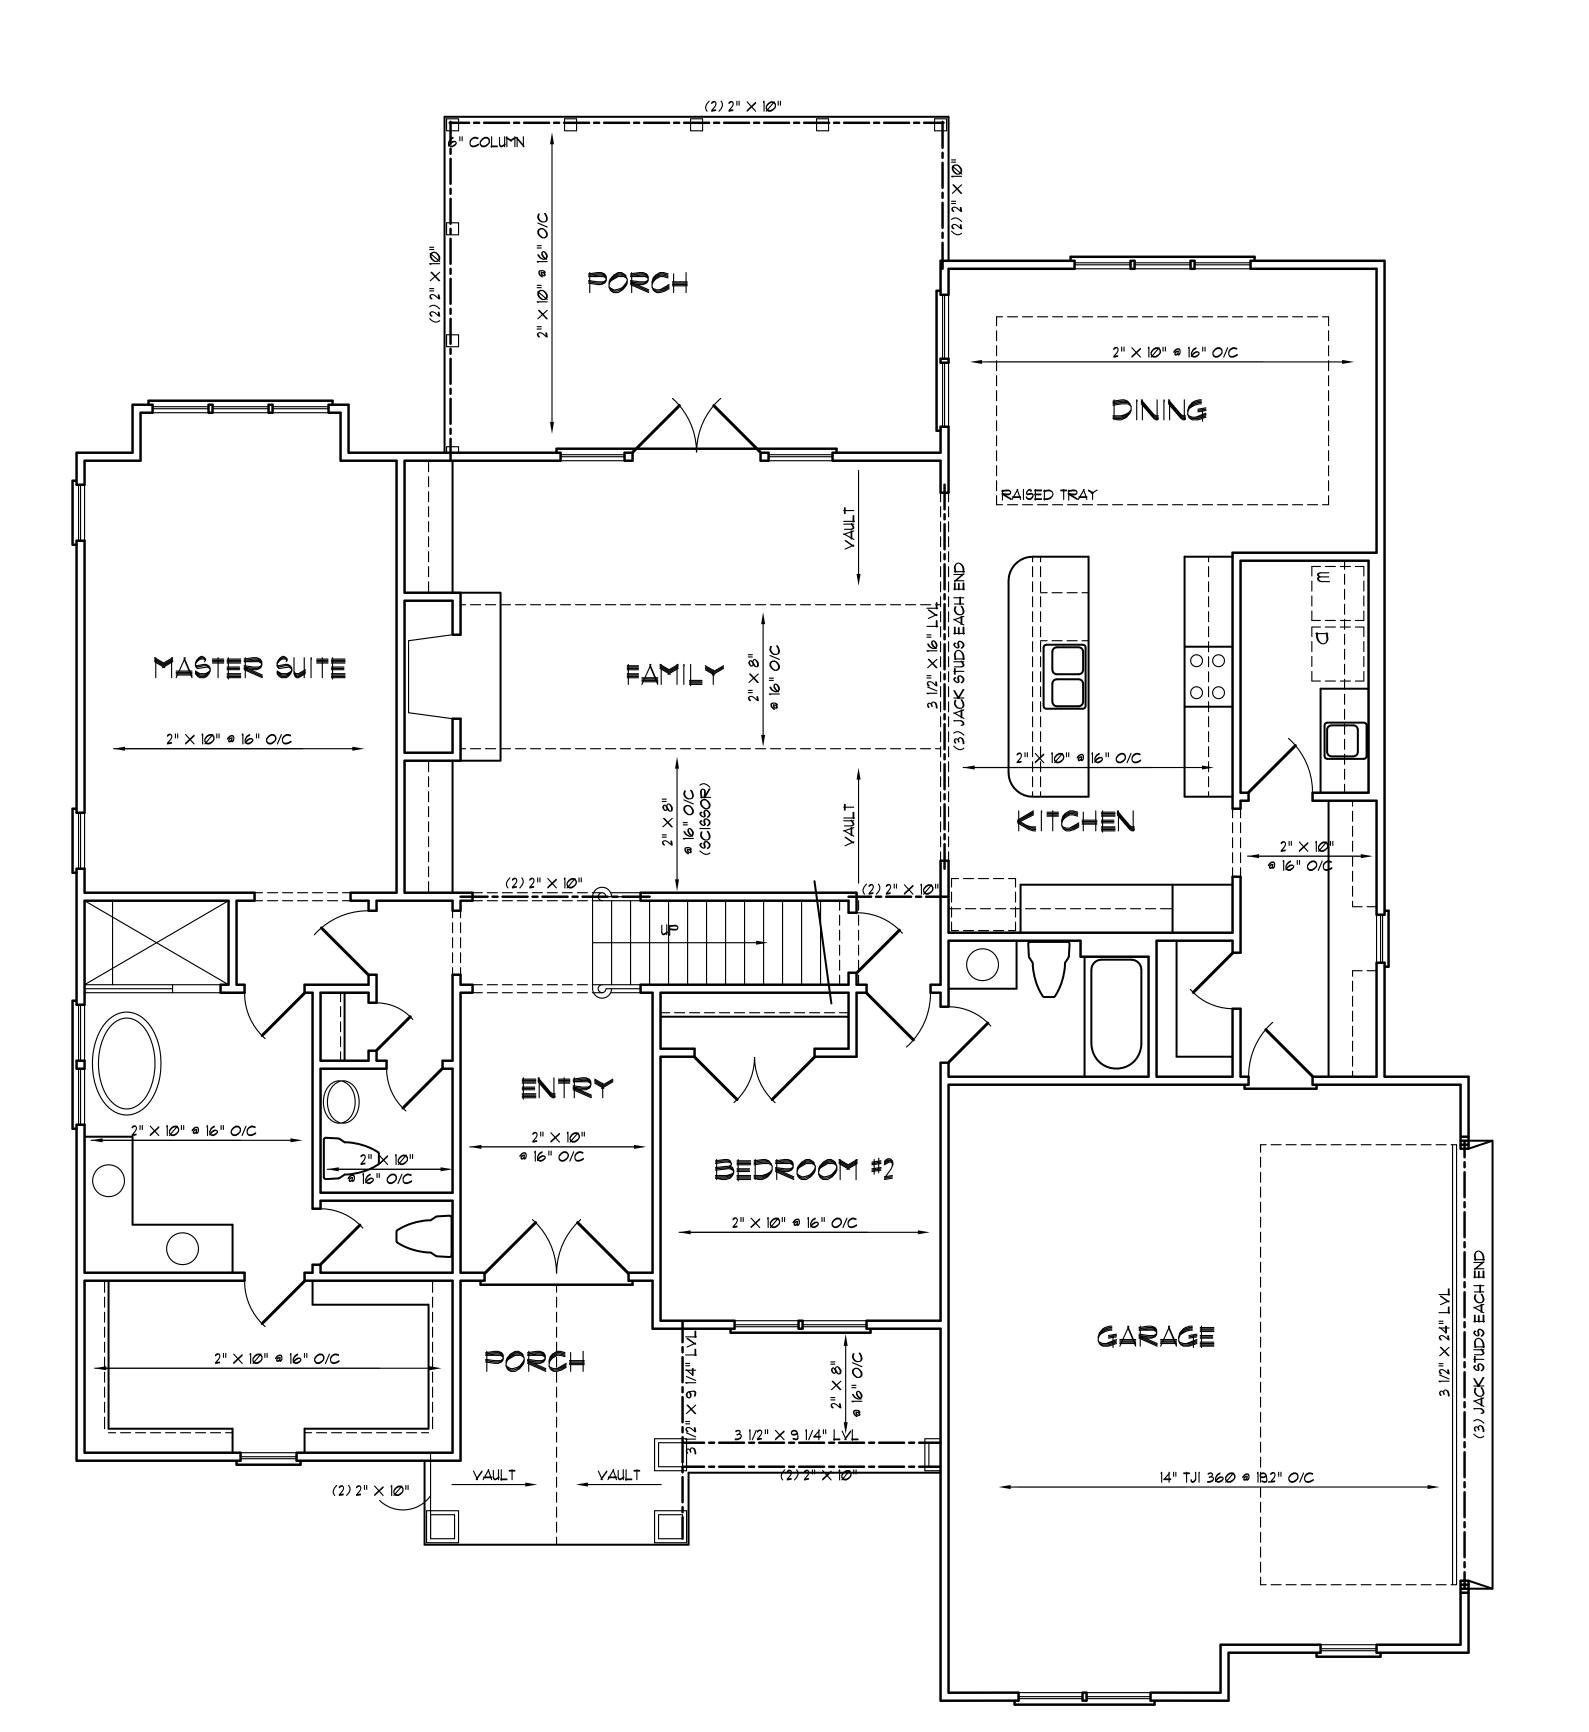

## **GENERAL FRAMING NOTES:**

- THIS PLAN DESIGNED IN ACCORDANCE WITH NC RESIDENTIAL CODE, 2018 EDITION.
   GLAZING AREAS SHOWN ON THESE DESIGN DRAWINGS DO NOT EXCEED 15% OF THE GROSS AREA OF THE EXTERIOR WALLS. THIS STRUCTURE MEETS THE REQUIREMENTS OF
- N1101.2.1, RESIDENTIAL BUILDING, TYPE A-1.

  3. WALL CLADDING IS DESIGNED FOR A 24.1 #/SF OR GREATER POSITIVE/NEGATIVE PRESSURE.

  4. ALL WALLS, FLOORS AND CEILINGS SHALL BE INSULATED IN ACCORDANCE WITH PART IN, ENERGY CONSERVATION, CHAPTER 11, ENERGY EFFICIENCY OF THE CODE FOR ZONE
- 7 (TABLE N1101.2). 5. DESIGN CRITERIA 10 PSF PRIMARY FLOOR 40 PSF 10 PSF 40 PSF SECONDARY FLOOR SLEEPING AREAS 10 PSF 30 PSF 10 PSF ATTIC 20 PSF 10 PSF ROOF 100 MPH
- DEFLECTION LIMITS FLOOR L/360 (LIVE LOAD ONLY) ROOF - L/240
- 6. ALL HEADERS IN LOAD BEARING WALLS SHALL BE DOUBLE 2X10.
- 7. ALL WALLS ARE 2X4 @ 16" O.C. UNLESS OTHERWISE NOTED.
- 8. FLOOR INSULATION = R-19, EXTERIOR =R-15 AND CEILING = R-38.
- 9. PROVIDE DOUBLE FLOOR JOISTS OR TRUSS UNDER WALLS ABOVE.

#### R602.7.5 SUPPORTS FOR HEADERS:

HEADERS SHALL BE SUPPORTED ON EACH END WITH ONE OR MORE JACK STUDS OR WITH APPROVED FRAMING ANCHORS IN ACCORDANCE WITH TABLE R602.7(1) OR R602.7(2). THE FULL—HEIGHT STUD ADJACENT TO EACH END OF THE HEADER SHALL BE END NAILED TO EACH END OF THE HEADER WITH FOUR—16D NAILS (3.5 INCHES X 0.135 INCHES). THE MINIMUM NUMBER OF FULL—HEIGHT STUDS AT EACH END OF A HEADER SHALL BE IN ACCORDANCE WITH TABLE R602.7.5.


## **TABLE R602.7.5**

MINIMUM NUMBER OF FULL-HEIGHT STUDS AT EACH END OF HEADERS IN EXTERIOR WALLS

HEADER SPAN	MAXIMUM STUD SPACING (INCHE PER TABLE R602.3(5)	
	16	
LESS THAN/EQUAL TO 3'	1	1
<b>' 4'</b>	2	1
<b>8'</b>	3	2
12'	5	3
16'	6	4

## STRUCTURAL EVALUATION BY:

- HOWERTON SERVICES, PLLC 3513 CATHEDRAL BELL ROAD RALEIGH, NC 27614 LICENSE P-1716
- \* ENGINEER'S SEAL APPLIES ONLY TO STRUCTURAL COMPONENTS ON THIS DOCUMENT. SEAL DOES NOT INCLUDE CONSTRUCTION REVIEW, MEANS, METHODS, TECHNIQUES, SEQUENCES, PROCEDURES OR SAFETY PRECAUTIONS.
- \* ANY DEVIATIONS OR DISCREPANCIES ON PLANS ARE TO BE BROUGHT TO IMMEDIATE ATTENTION OF THE ENGINEER. FAILURE TO DO SO WILL VOID ENGINEER'S LIABILITY.
- \* DO NOT SCALE THESE DRAWINGS ENGINEERING APPROVAL EXPIRES 04/01/2021

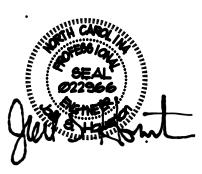

03 29 2020




# FIRST FLOOR FRAMING

1/4"=1'-0"

FIRST FLOOR HEATED AREA: 2043 SQ. FT. GARAGE AREA: 583 SQ. FT. FRONT PORCH AREA: 170 SQ. FT. REAR PORCH AREA: 291 SQ. FT.

03/30/2020

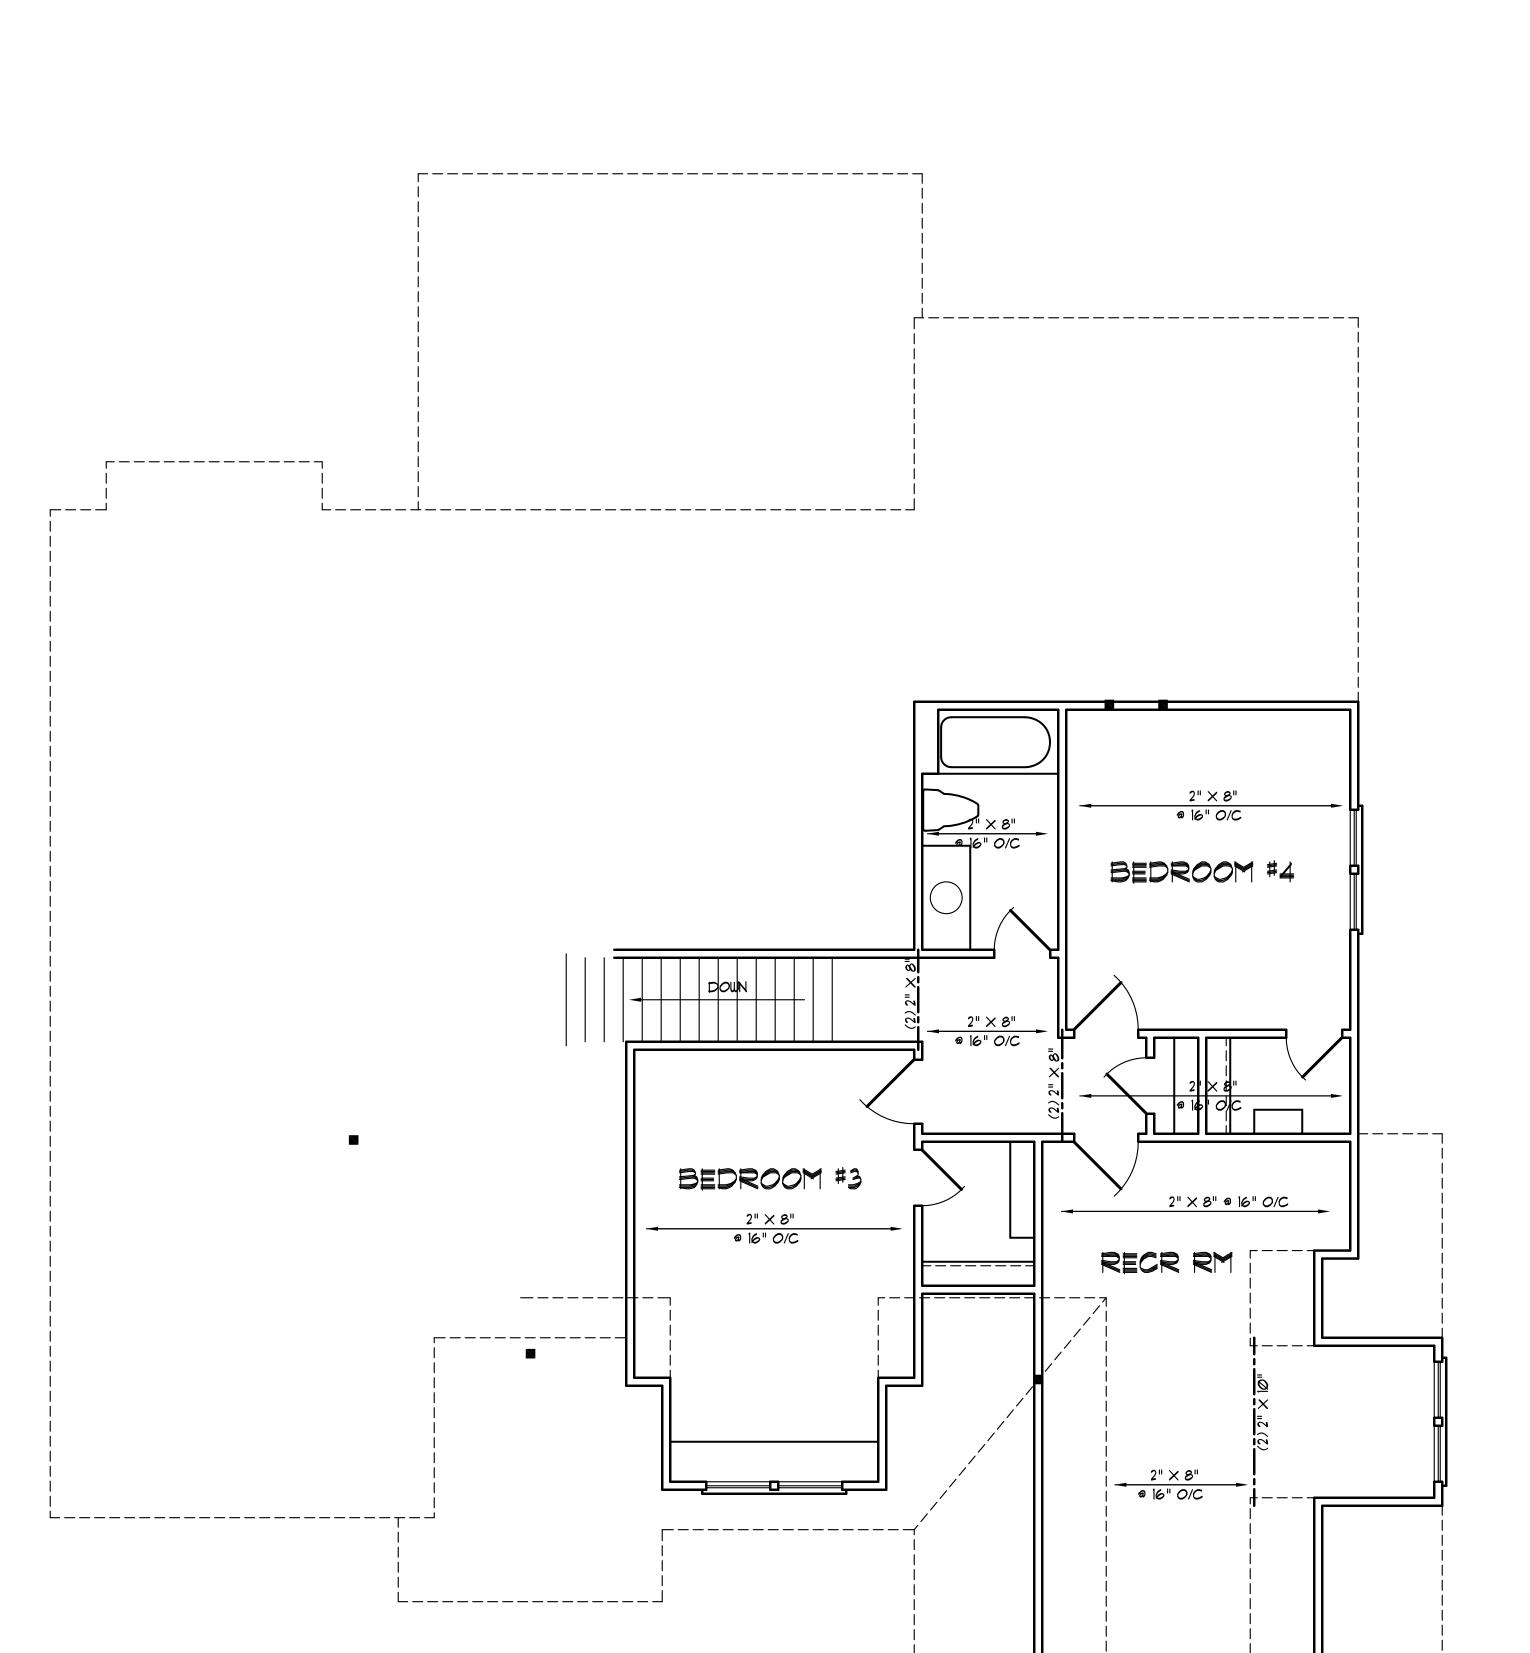

## **GENERAL FRAMING NOTES:**

- 1. THIS PLAN DESIGNED IN ACCORDANCE WITH NC RESIDENTIAL CODE, 2018 EDITION. 2. GLAZING AREAS SHOWN ON THESE DESIGN DRAWINGS DO NOT EXCEED 15 F THE GROSS AREA OF THE EXTERIOR WALLS. THIS STRUCTURE MEETS THE REQUIREMENTS OF N1101.2.1, RESIDENTIAL BUILDING, TYPE A-1.
- 3. WALL CLADDING IS DESIGNED FOR A 24.1 #/SF OR GREATER POSITIVE/NEGATIVE PRESSURE.
  4. ALL WALLS, FLOORS AND CEILINGS SHALL BE INSULATED IN ACCORDANCE WITH PART
- IV, ENERGY CONSERVATION, CHAPTER 11, ENERGY EFFICIENCY OF THE CODE FOR ZONE 7 (TABLE N1101.2).

5. DESÌGN CRITERIA 10 PSF 40 PSF PRIMARY FLOOR 10 PSF 40 PSF SECONDARY FLOOR SLEEPING AREAS 10 PSF 30 PSF 10 PSF 20 PSF 10 PSF 20 PSF DEFLECTION LIMITS FLOOR - L/360

(LIVE LOAD ONLY) ROOF - L/240

- 6. ALL HEADERS IN LOAD BEARING WALLS SHALL BE DOUBLE 2X10.
- 7. ALL WALLS ARE 2X4 0 16" O.C. UNLESS OTHERWISE NOTED.
- 8. FLOOR INSULATION = R-19, EXTERIOR =R-15 AND CEILING = R-38.
- 9. PROVIDE DOUBLE FLOOR JOISTS UNDER WALLS ABOVE.

#### R602.7.5 SUPPORTS FOR HEADERS:

HEADERS SHALL BE SUPPORTED ON EACH END WITH ONE OR MORE JACK STUDS OR WITH APPROVED FRAMING ANCHORS IN ACCORDANCE WITH TABLE R602.7(1) OR R602.7(2). THE FULL-HEIGHT STUD ADJACENT TO EACH END OF THE HEADER SHALL BE END NAILED TO EACH END OF THE HEADER WITH FOUR-16D NAILS (3.5 INCHES X 0.135 INCHES). THE MINIMUM NUMBER OF FULL—HEIGHT STUDS AT EACH END OF A HEADER SHALL BE IN ACCORDANCE WITH TABLE R602.7.5.

## **TABLE R602.7.5**

MINIMUM NUMBER OF FULL-HEIGHT STUDS AT EACH END OF HEADERS IN EXTERIOR WALLS

HEADER SPAN	MAXIMUM STUD SPACING (INCHES) PER TABLE R602.3(5)	
	16	24
LESS THAN/EQUAL TO 3'	1	1
4'	2	1
8*	3	2
<b>12'</b>	5	3
<b>16</b> °	6	4

## STRUCTURAL EVALUATION BY:

3513 CATHEDRAL BELL ROAD RALEIGH, NC 27614 LICENSE P-1716


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03 29 2020



SECOND FLOOR HEATED AREA: 600 SQ. FT. RECR ROOM AREA: 312 SQ. FT.



RUCTURAL EVALUATION BY:

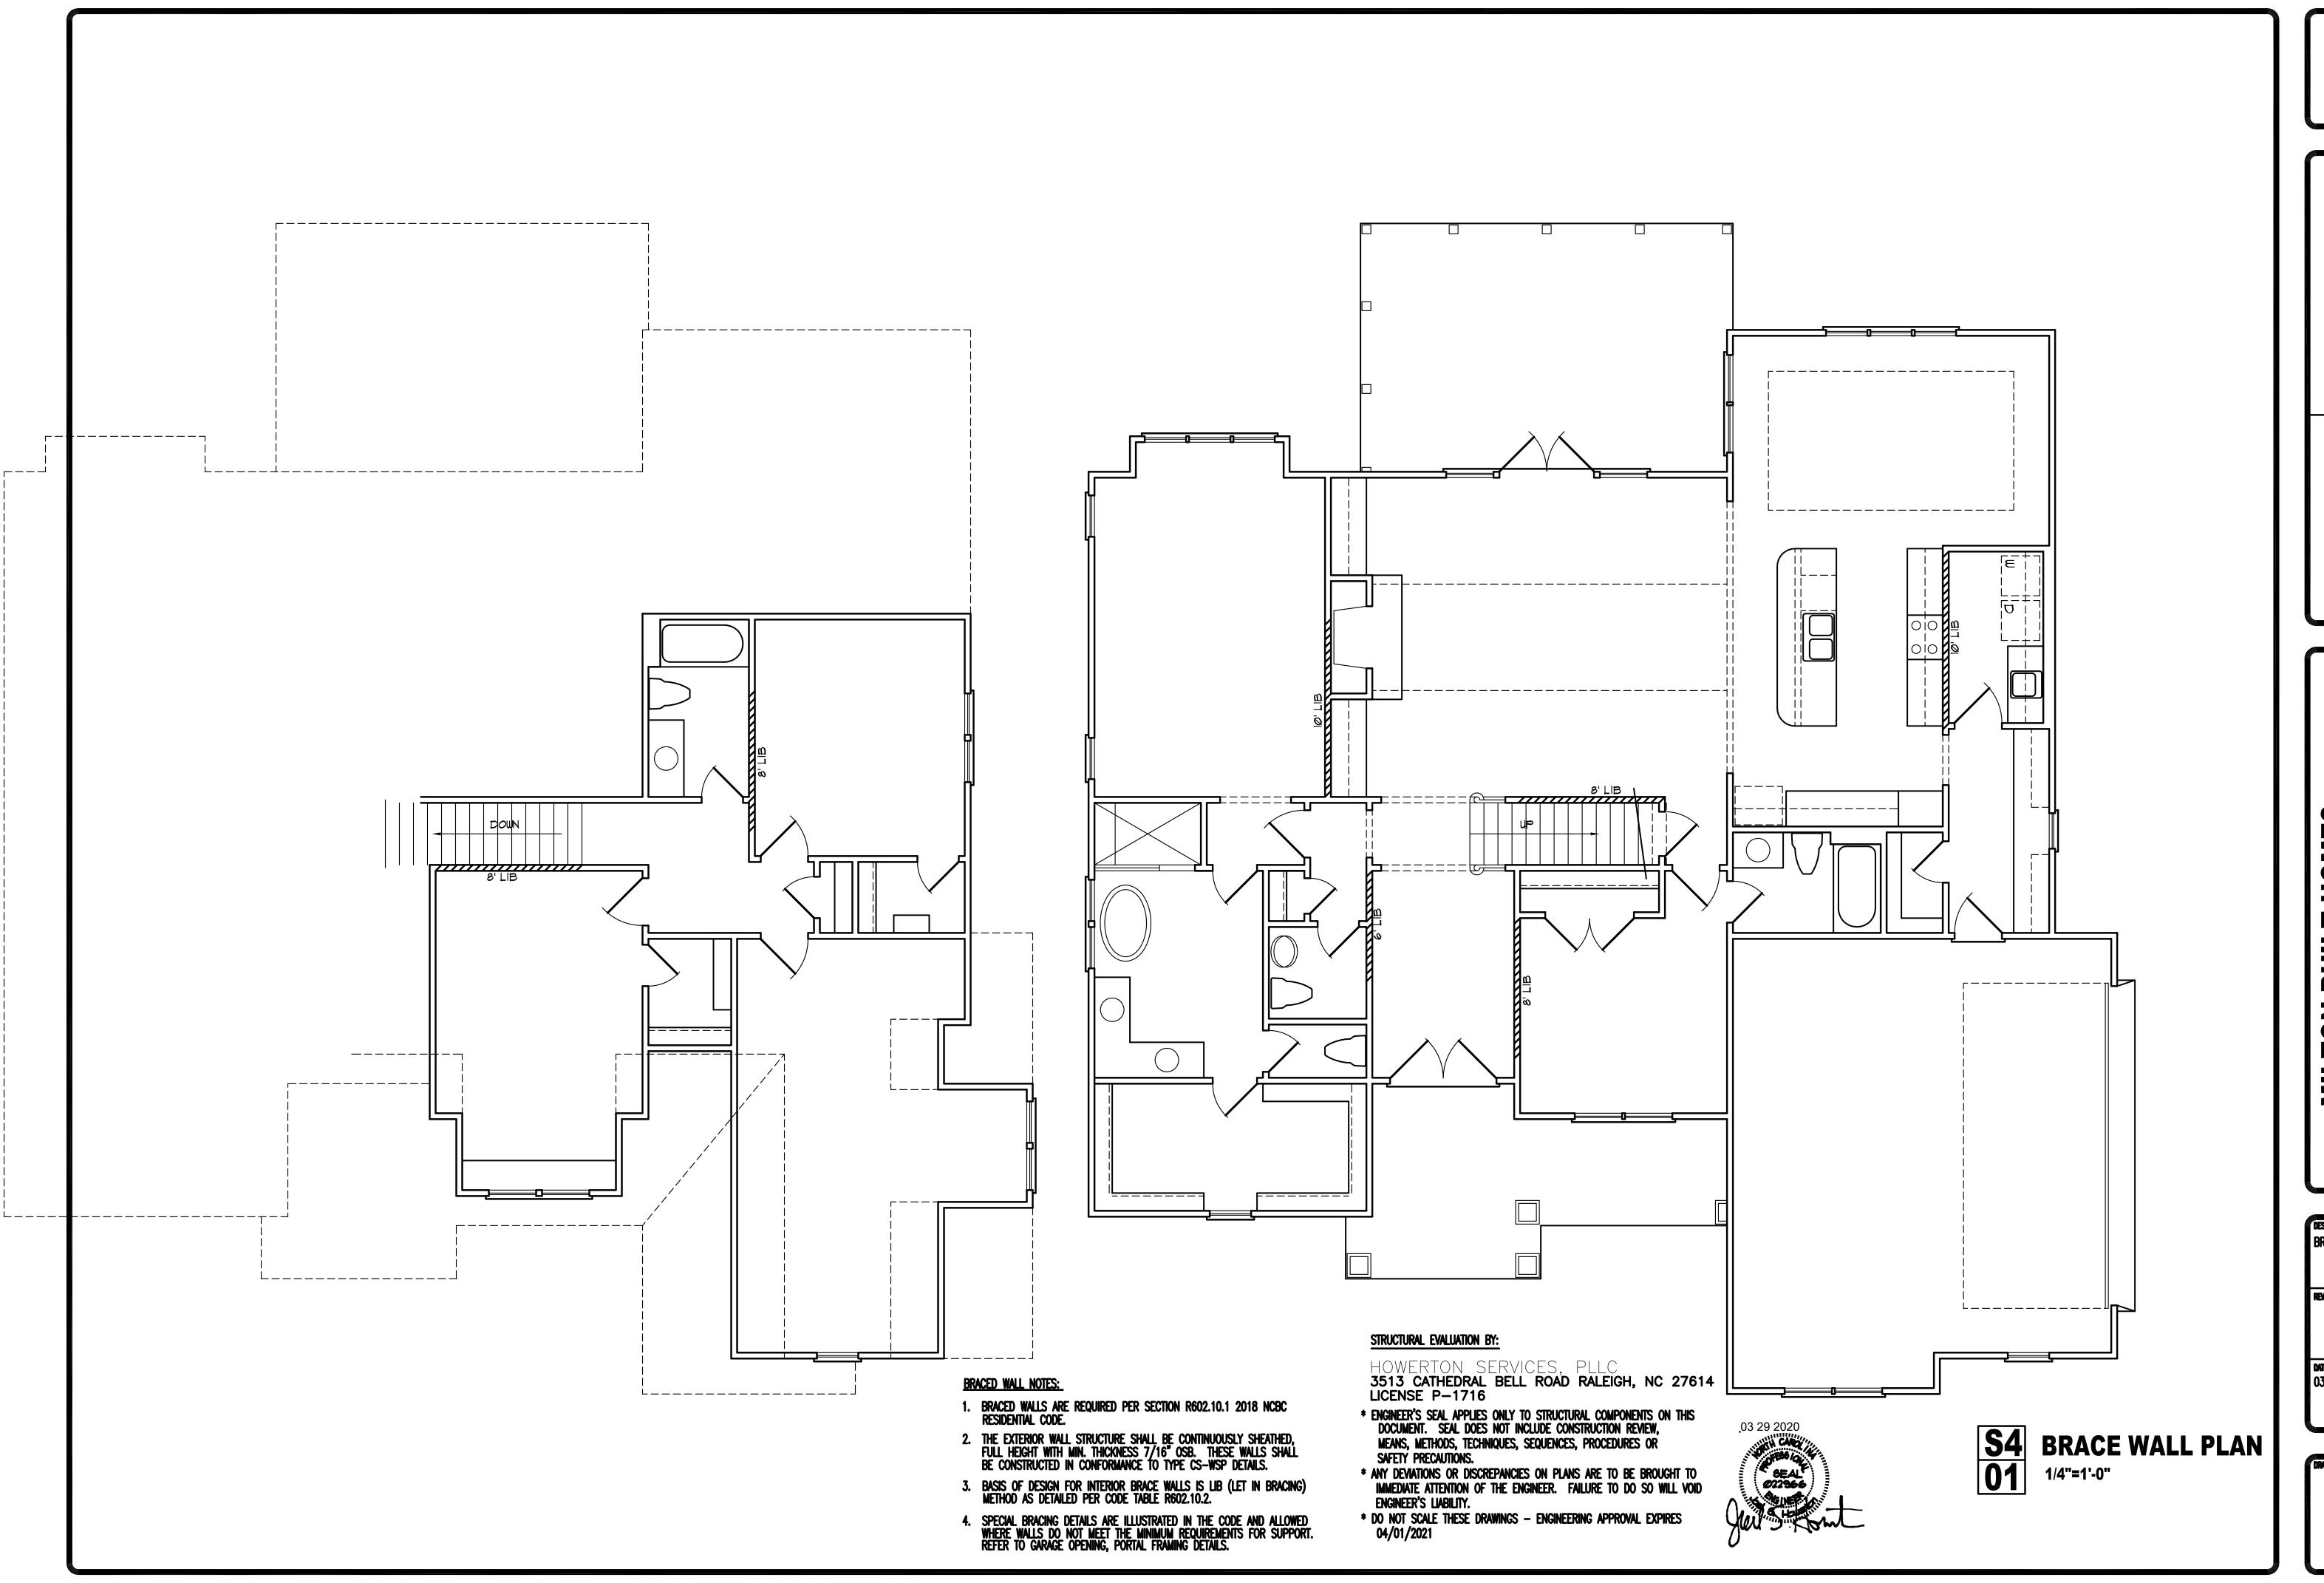OWERTON SERVICES, PLLC
513 CATHEDRAL BELL
DAI FIGH IN C 27614

UNCANNON DESIGNS H

MILTON BUILT HOME Plan No. 2643-15-S

DESCRIPTION:
BRACING PLAN
REVISION:


DATE: 03/30/2020

DRAWNG:

**S4** 

03/30/2020

**S5** 

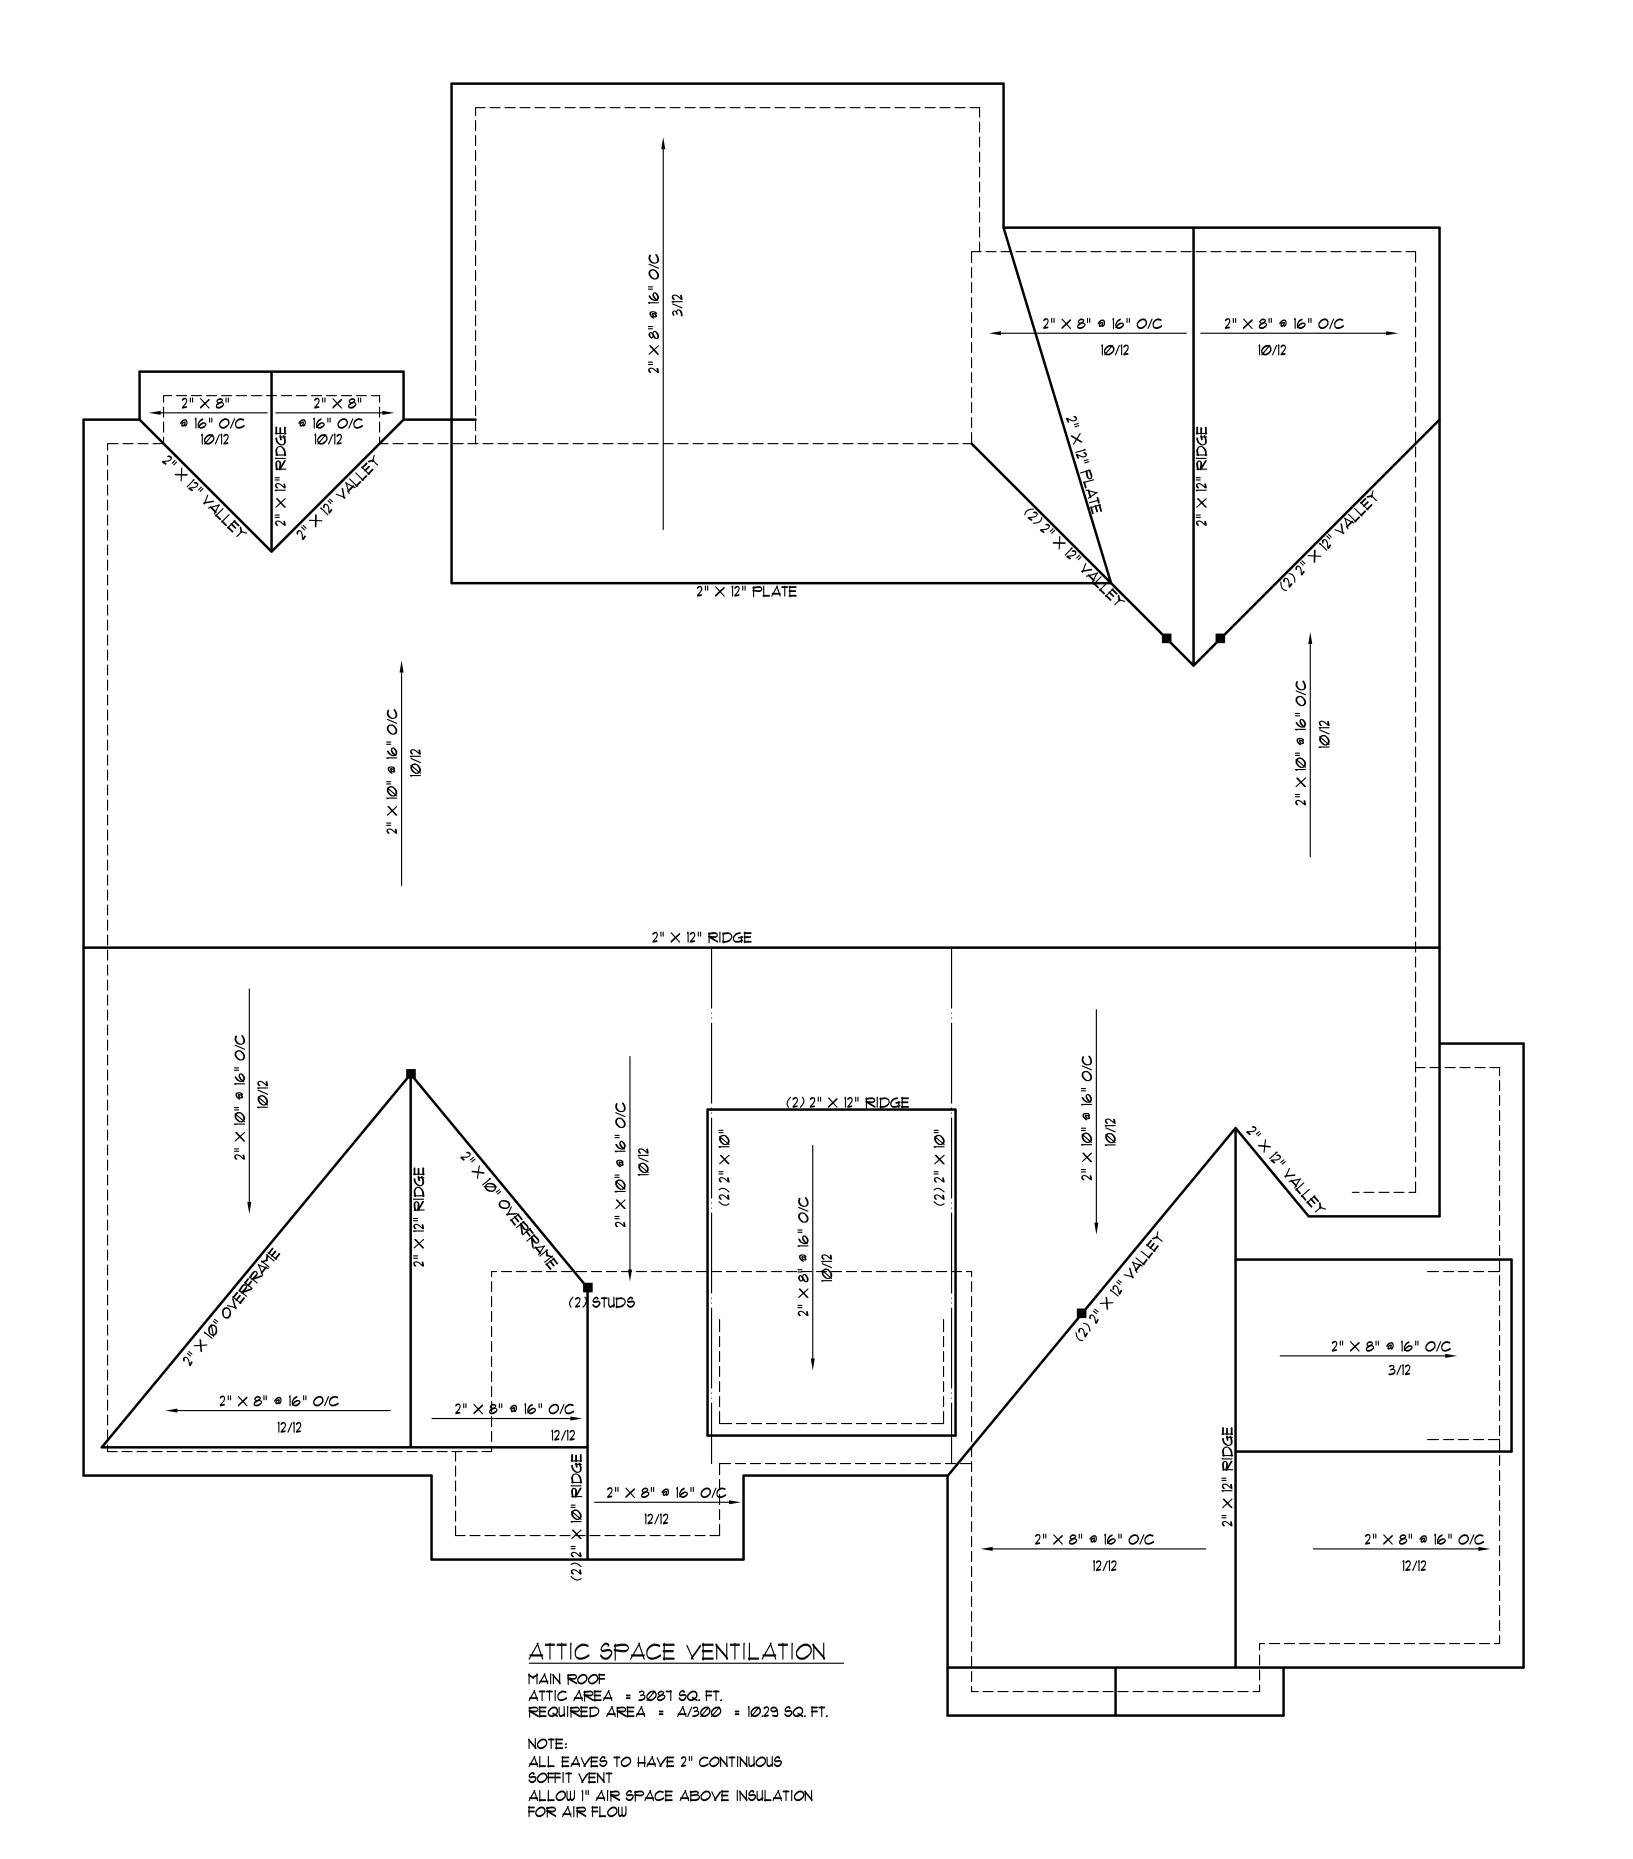

#### **GENERAL ROOF NOTES:**

- 1. THIS PLAN DESIGNED IN ACCORDANCE WITH NC RESIDENTIAL CODE, 2018 EDITION.
- 2. ROOF CLADDING DESIGN VALUES (POSITIVE/NEGATIVE) SHALL BE AS FOLLOWS:

  45.5 #/SE FOR ROOF PITCHES FROM 0 /12 TO 2.25 /12

45.5 #/SF FOR ROOF PITCHES FROM 0 /12 TO 2.25 /12 34.5 #/SF FOR ROOF PITCHES FROM 2.25 /12 TO 7 /12

- 21 #/SF FOR ROOF PITCHES FROM 7 /12 TO 12 /12
  3. ALL ROOFING ELEMENTS SHALL MEET THE REQUIREMENTS OF CHAPTER 8 OF THE CODE.
- 4. ALL LUMBER SHALL BE #2 SPF OR BETTER. RAFTERS MAY BE FINGER JOINTED PER NATIONAL DESIGN SPECIFICATIONS FOR WOOD CONSTRUCTION, AND MUST HAVE THE STRUCTURAL CERTIFICATION STAMPED ON THE MEMBER.
- 5. RAFTER SIZES, SPANS AND SPACING SHALL NOT EXCEED THE FOLLOWING:

 SIZE
 2X6
 2X8
 2X10

 SPACING 12" O.C.
 14'-9"
 19'-6"
 24'-10"

 SPACING 16" O.C.
 13'-5"
 17'-9"
 22'-3"

- 6. ALL RAFTERS TO BE 2X8 @ 16" O.C. #2 SPF UNLESS NOTED OTHERWISE.
  7. 2-2X10 HIPS MAY BE SPLICED WITH A MIN. 6'-0" OVERLAP.
  - 2-2X10 HIPS MAY BE SPLICED WITH A MIN. 6'-0" OVERLAP.
    PROVIDE DOUBLE RAFTER EACH SIDE OF DORMERS WITH DOUBLE HEADER.
- 9. ATTACH VAULTED RAFTERS WITH HURRICANE CLIP SIMPSON "H-5" OR EQUIVALENT.
  PROVIDE DOUBLE OPPOSING RAFTERS WHERE NOTED.
- 10. 2X8 RAFTERS © CATHEDRAL OR VAULTED CEILINGS TO BE FURRED DOWN 2" OR USE 2X10 RAFTERS FOR INSULATION PER CODE.
- 11. PROVIDE 2X4 COLLAR TIES EVERY SECOND RAFTER (TYPICAL)
- 12. PROVIDE 2X4 RAFTER TIES @ 32" O.C. (TYPICAL)
- 13. FRAME RAFTERS ON 2X4 PLATE ON TOP OF CEILING JOISTS UNLESS NOTED OTHERWISE.
- 14. SHINGLES ASSUMED TO BE 240 LB. FIBERGLASS, OR EQUAL. MINIMUM ROOF PITCH TO BE AS INDICATED ON ARCHITECTURAL PLAN SHEETS.
- 15. PROVIDE DOUBLE LAYER OF ROOF FELT WHERE ROOF PITCH IS LESS THAN 4 /12.
- 16. THESE DESIGN DRAWINGS WERE PRODUCED BY HOWERTON CONSULTING ENGINEERING, INC ASSUMES NO LIABILITY FOR THE CORRECTNESS OF ARCHITECTURAL FEATURES, DIMENSIONS OR FIXTURES.
- 17. ALL HIP RIDGES AND VALLEYS SHALL BE DOUBLE 2X10 UNLESS NOTED OTHERWISE.
  18. CONTRACTOR IS RESPONSIBLE FOR REVIEWING DRAWINGS FOR CONSTRUCTABILITY PRIOR TO BEGINNING CONSTRUCTION.
- 19. VALLEY RAFTERS WITH SPANS LONGER THAN 15' SHALL BE LVLs SUPPORTED AS NOTED. PROVIDE TEMPORARY STIFF KNEE SUPPORT UNTIL ALL SHEATHING AND RAFTER TIES/COLLARS ARE
- INSTALLED.

  20. DO NOT SCALE THESE DRAWINGS. IF DESCREPANCIES ARE NOTED, CONTACT THE ENGINEER.

  21. DESIGN BASES PROVIDED BY S&S CONTRACTING INC., FUQUAY VARINA, NO AND THEY

  ARE RESPONSIBLE FOR ALL ARCHITECTURAL FEATURES. DIMENSIONS, COMPLIANCE WITH ALL
- ARE RESPONSIBLE FOR ALL ARCHITECTURAL FEATURES, DIMENSIONS, COMPLIANCE WITH ALL ACCESS/EGRESS REQUIREMENTS, FIRE CODE AND LIFE SAFETY DESIGN ISSUES.

### STRUCTURAL EVALUATION BY:

HOWERTON SERVICES, PLLC 3513 CATHEDRAL BELL ROAD RALEIGH, NC 27614 LICENSE P-1716

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- \* DO NOT SCALE THESE DRAWINGS ENGINEERING APPROVAL EXPIRES 04/01/2021
- INDICATES (3) 2x4 STIFF KNEE ON BEAM BELOW



03 29 2020

**ROOF PLAN**