


Elevation A -Sheet List	
Sheet Number	Sheet Name
ElevA-Pg1	Front & Rear Elevations
ElevA-Pg2	Side Elevations
ElevA-Pg3	1st Floor Plan
ElevA-Pg4	2nd Floor Plan
ElevA-Pg5	Roof Plan
Pg6	Building Section



1 Front Elevation
1/8" = 1'-0"

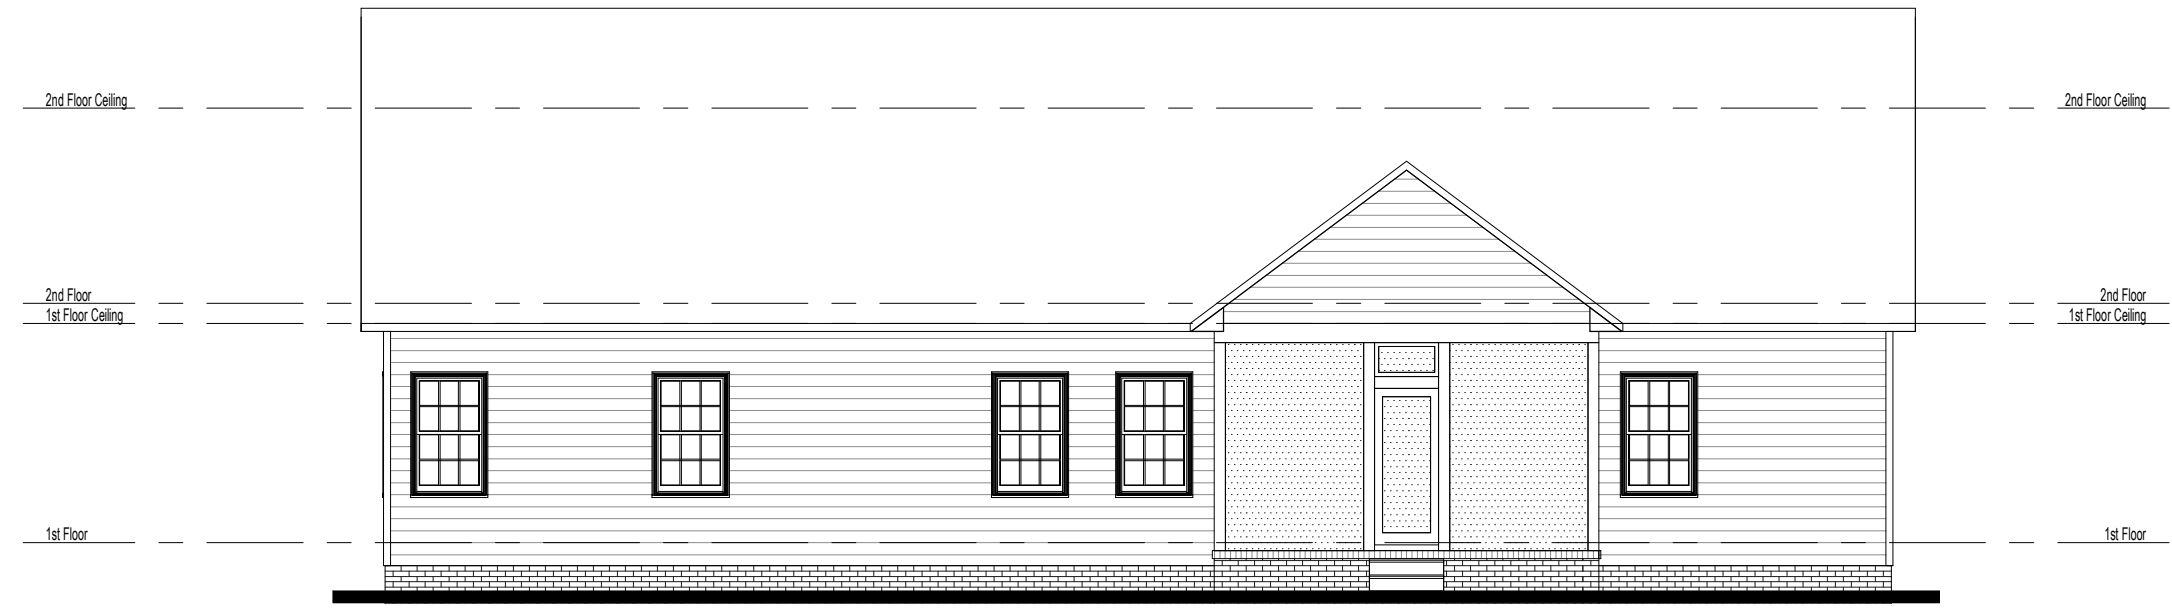

2 Rear Elevation
1/8" = 1'-0"

Area Schedule (Elevation A)	
Name	Area
Heated	
1st Floor	1996 SF
2nd Floor	1026 SF
3022 SF	
Unheated	
Front Porch	141 SF
Garage	549 SF
Screened Porch	256 SF
	946 SF
Under Roof	3968 SF



PAMLICO - Special - Elevation A

Front & Rear Elevations

Job #: Barbour
Address:
County:

Plan Version Date:
12/10/19

Job Version Date:


Sheet #:
ElevA-Pg1




① Right Elevation
1/8" = 1'-0"



② Left Elevation
1/8" = 1'-0"

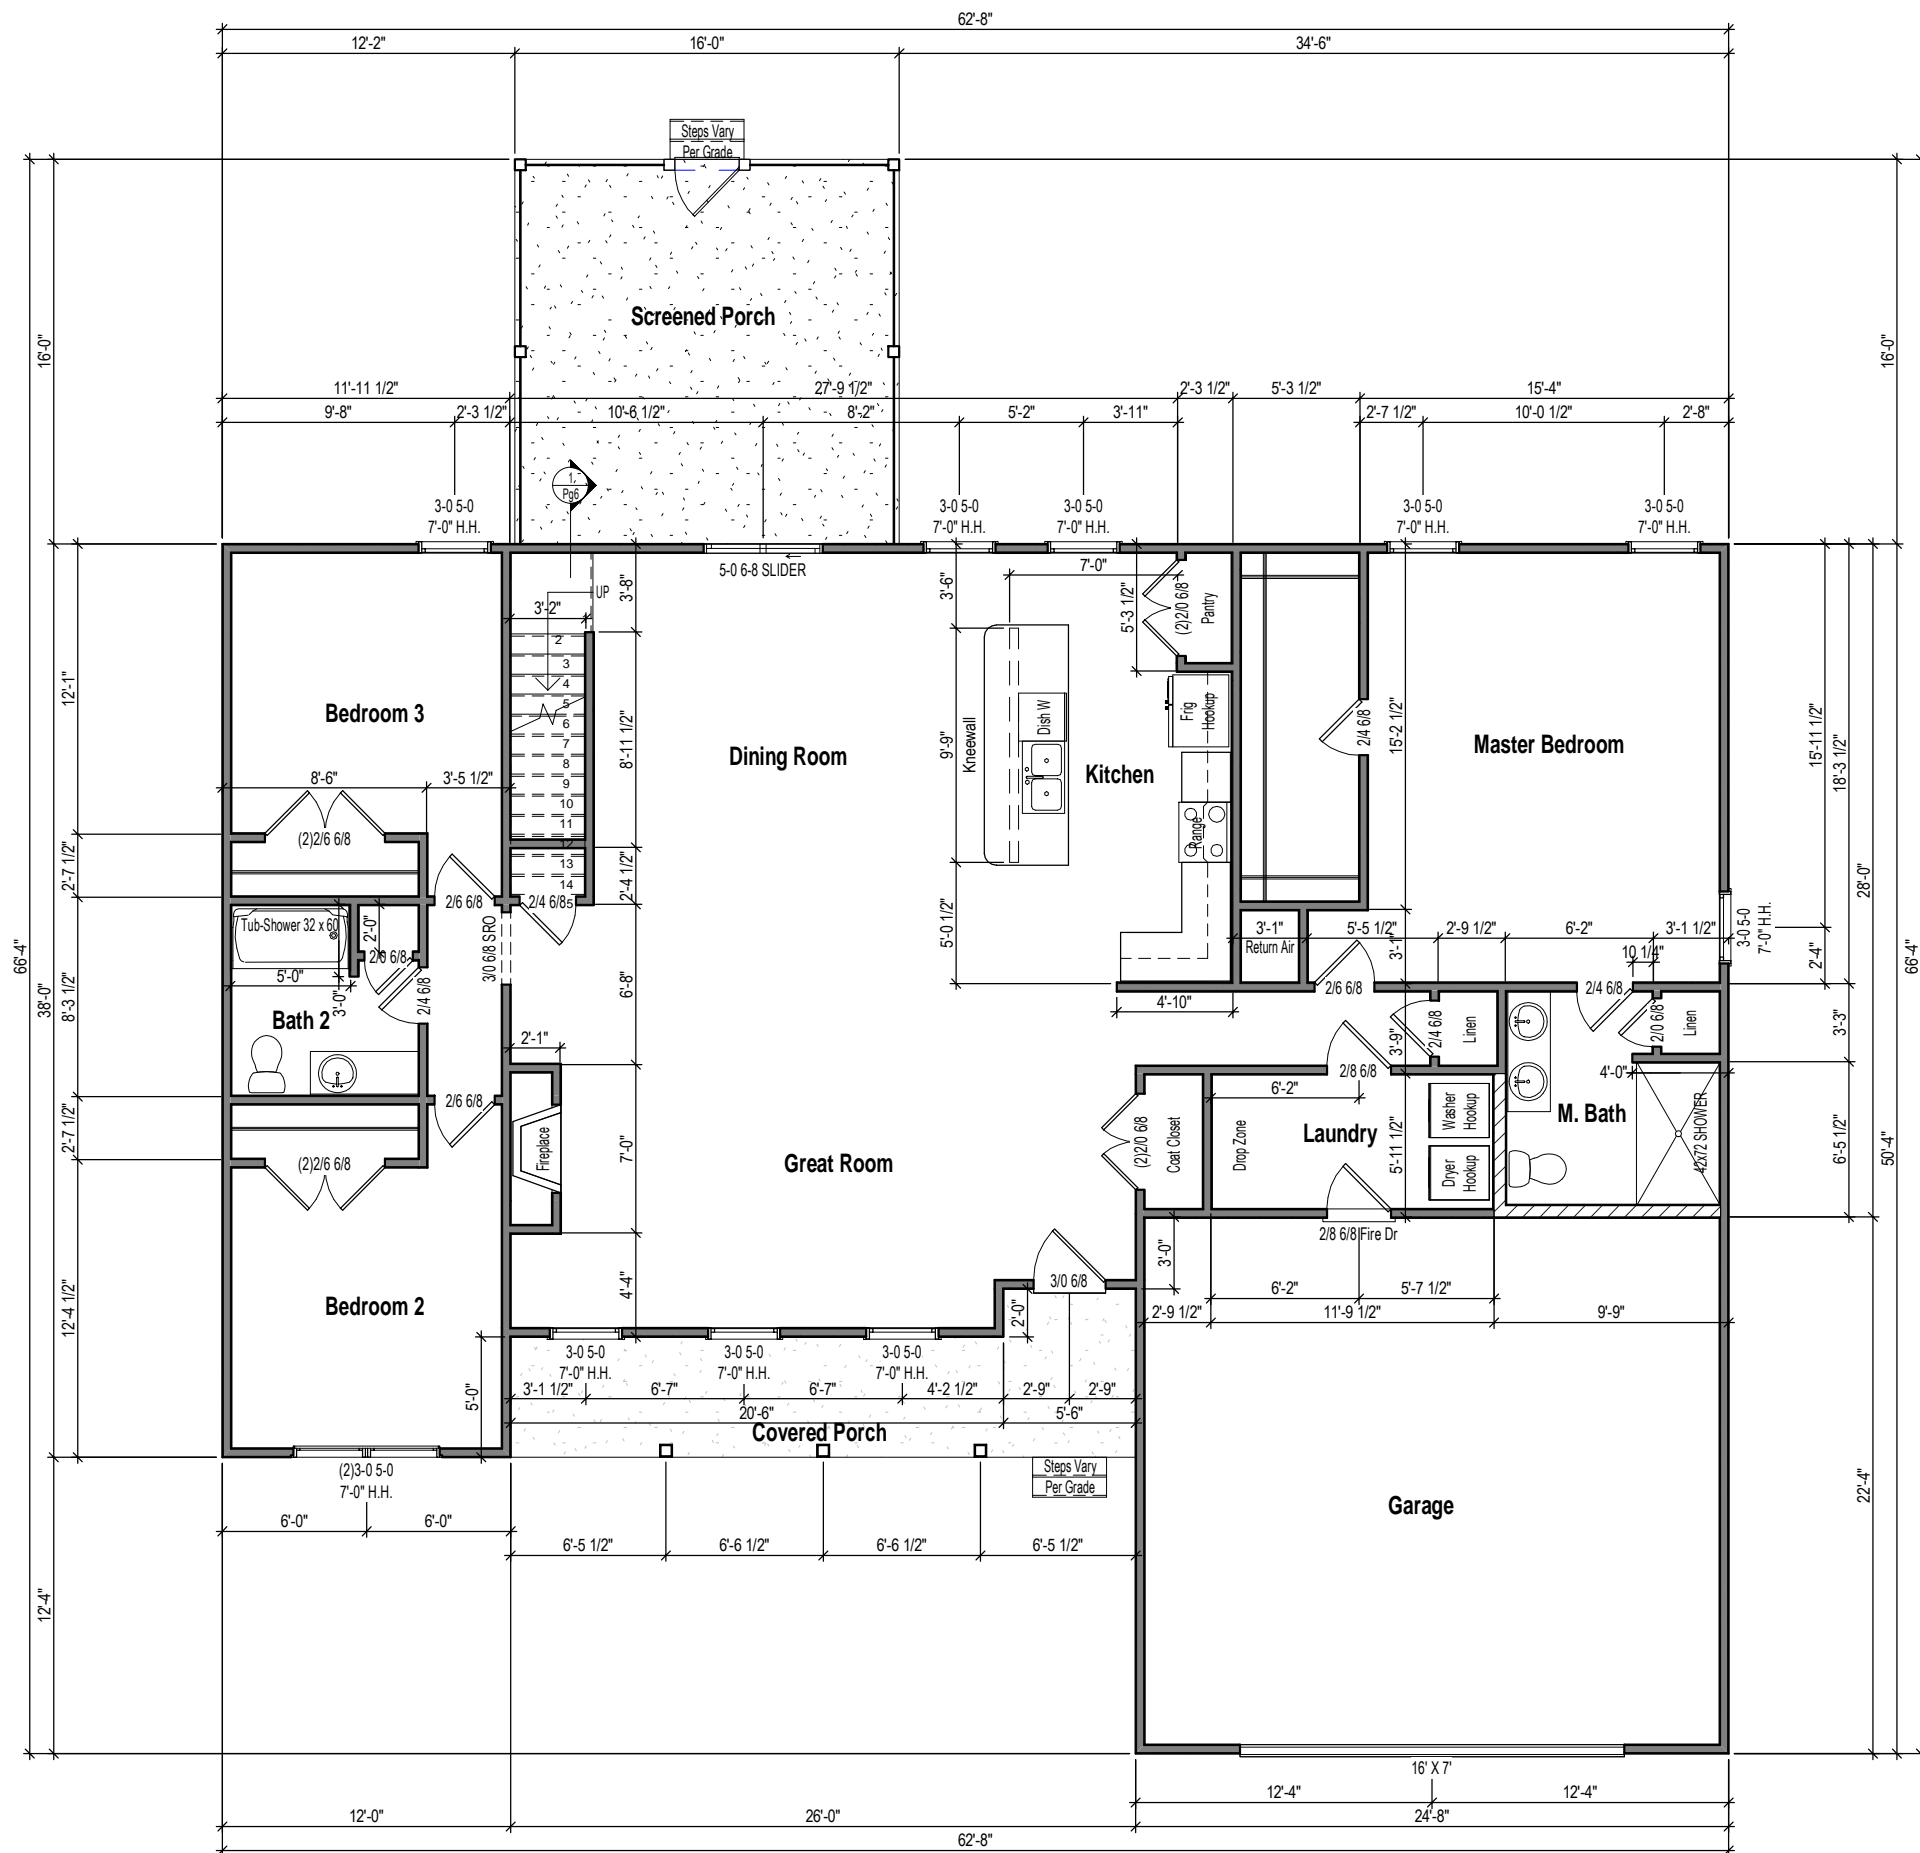

1 1st Floor Plan
1/8" = 1'-0"

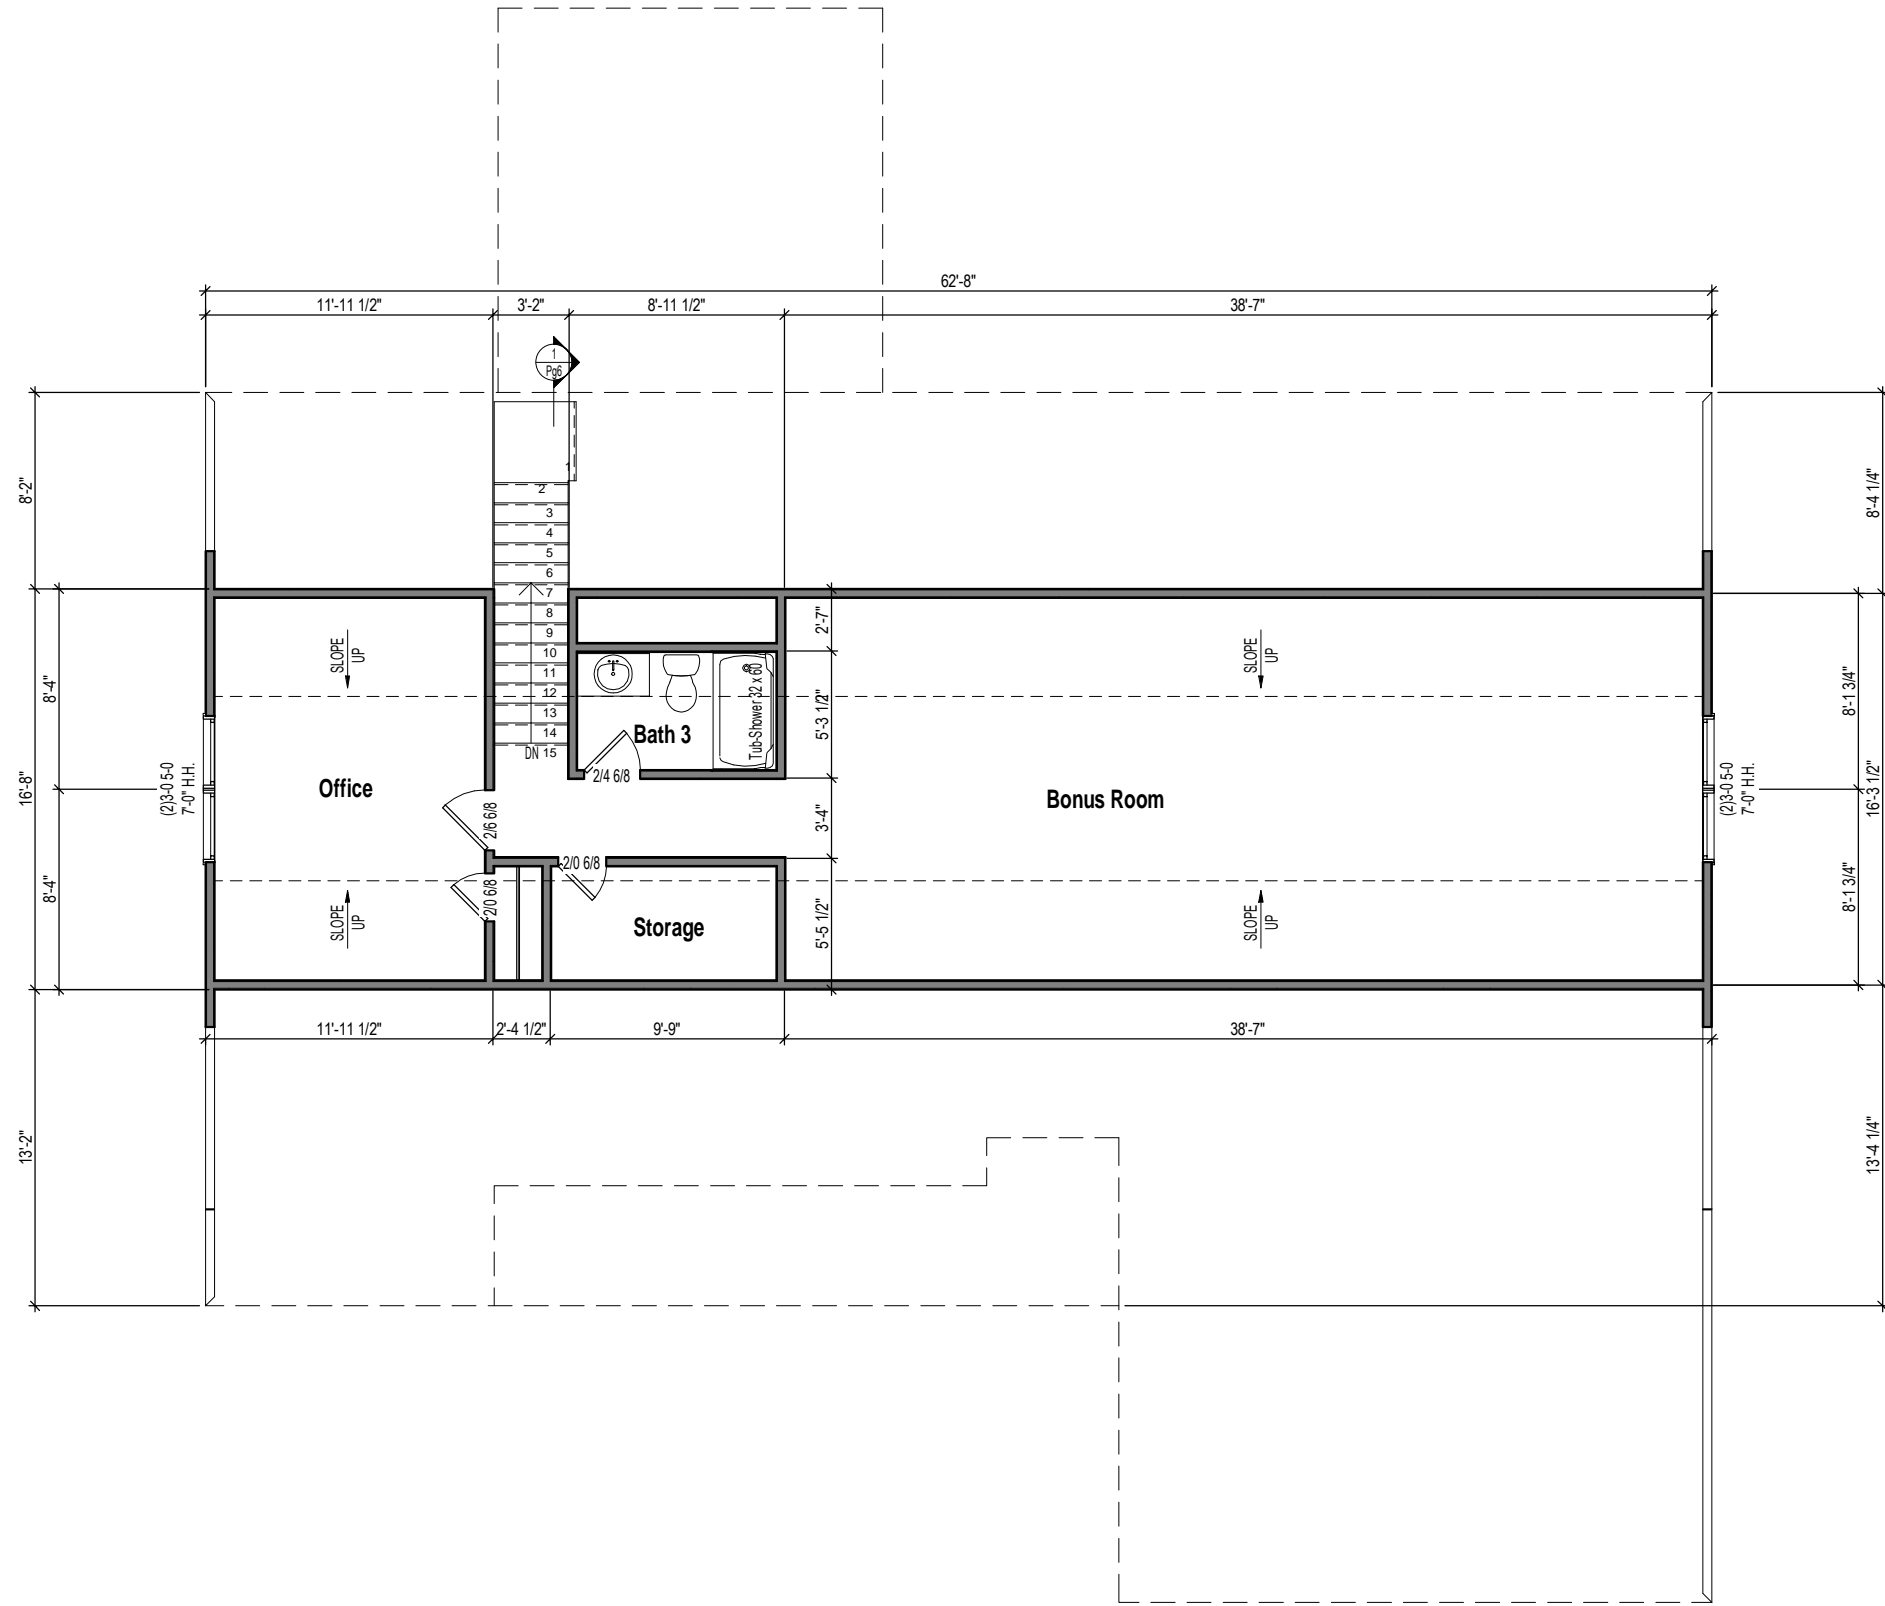


1 2nd Floor Plan
1/8" = 1'-0"


Attic Ventilation Calcs 1/300 (sq.in.)

Area	Ventilation Required (sq.in.)	Max Upper (sq.in.)	Min Upper (sq.in.)	Upper Ventilation (sq.in.)	Lower Ventilation (sq.in.)	Total Ventilation (sq.in.)	Ridge Vent (In.ft.)	Roof Vents (ea)	Soffit Vents (sq.ft.)
1757 SF	844	675	422	540	438	978	36	0	73

- CALCS BASED ON THE FOLLOWING VALUES**
- Ridge Vents = 15 in² of net free area per linear foot
 - Roof Vents = 50 in² of net free area per unit
 - Soffit Vents = 6 in² of net free area per square foot

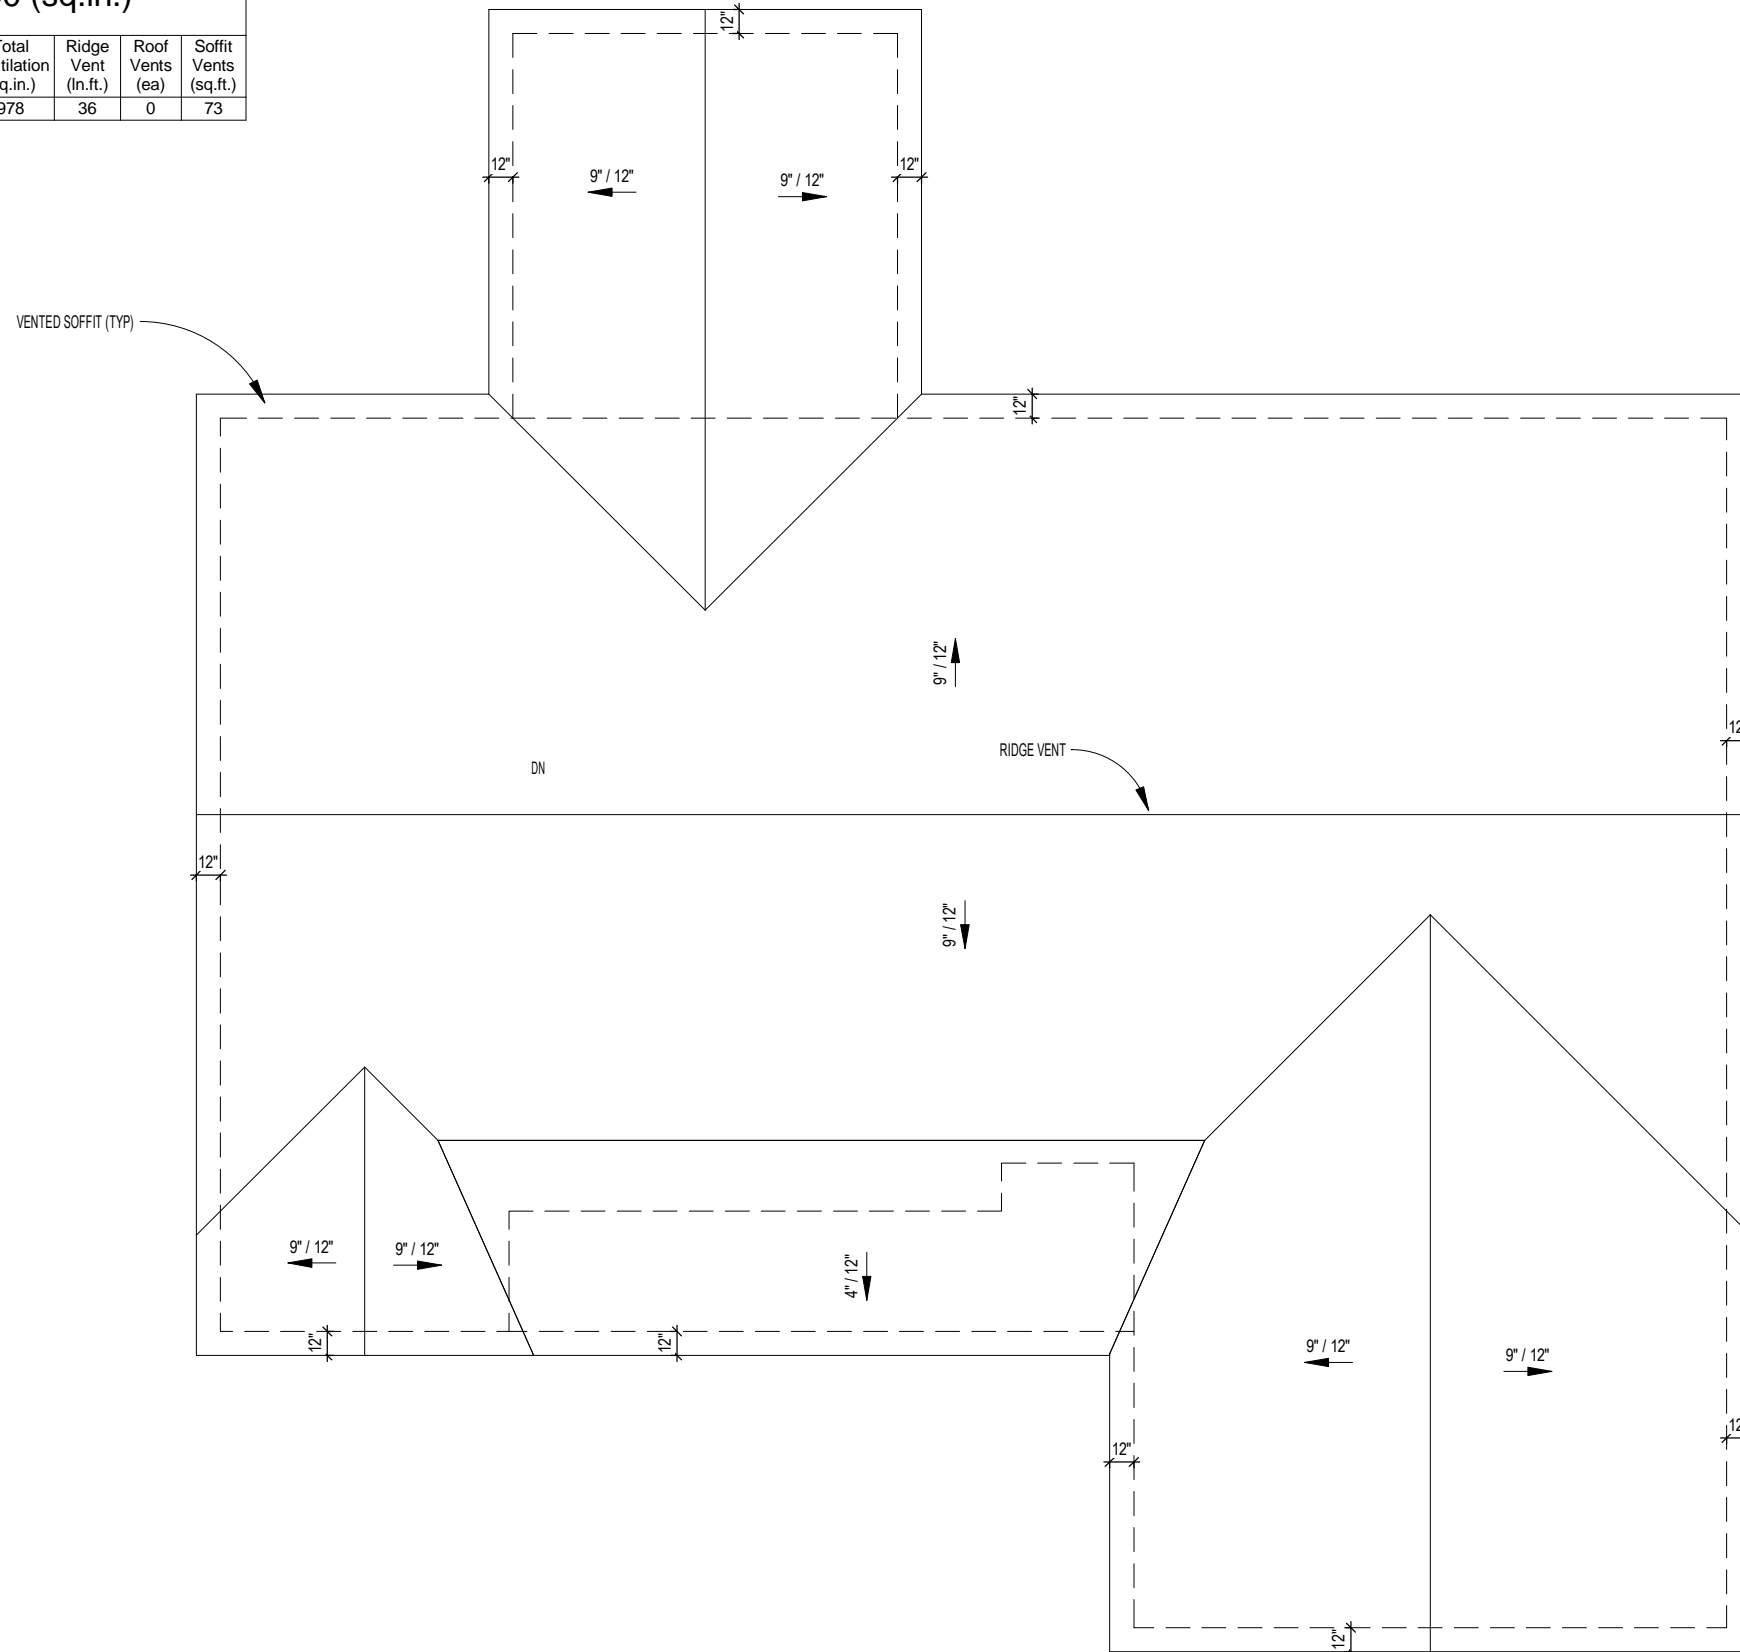

1 Roof Plan
1/8" = 1'-0"

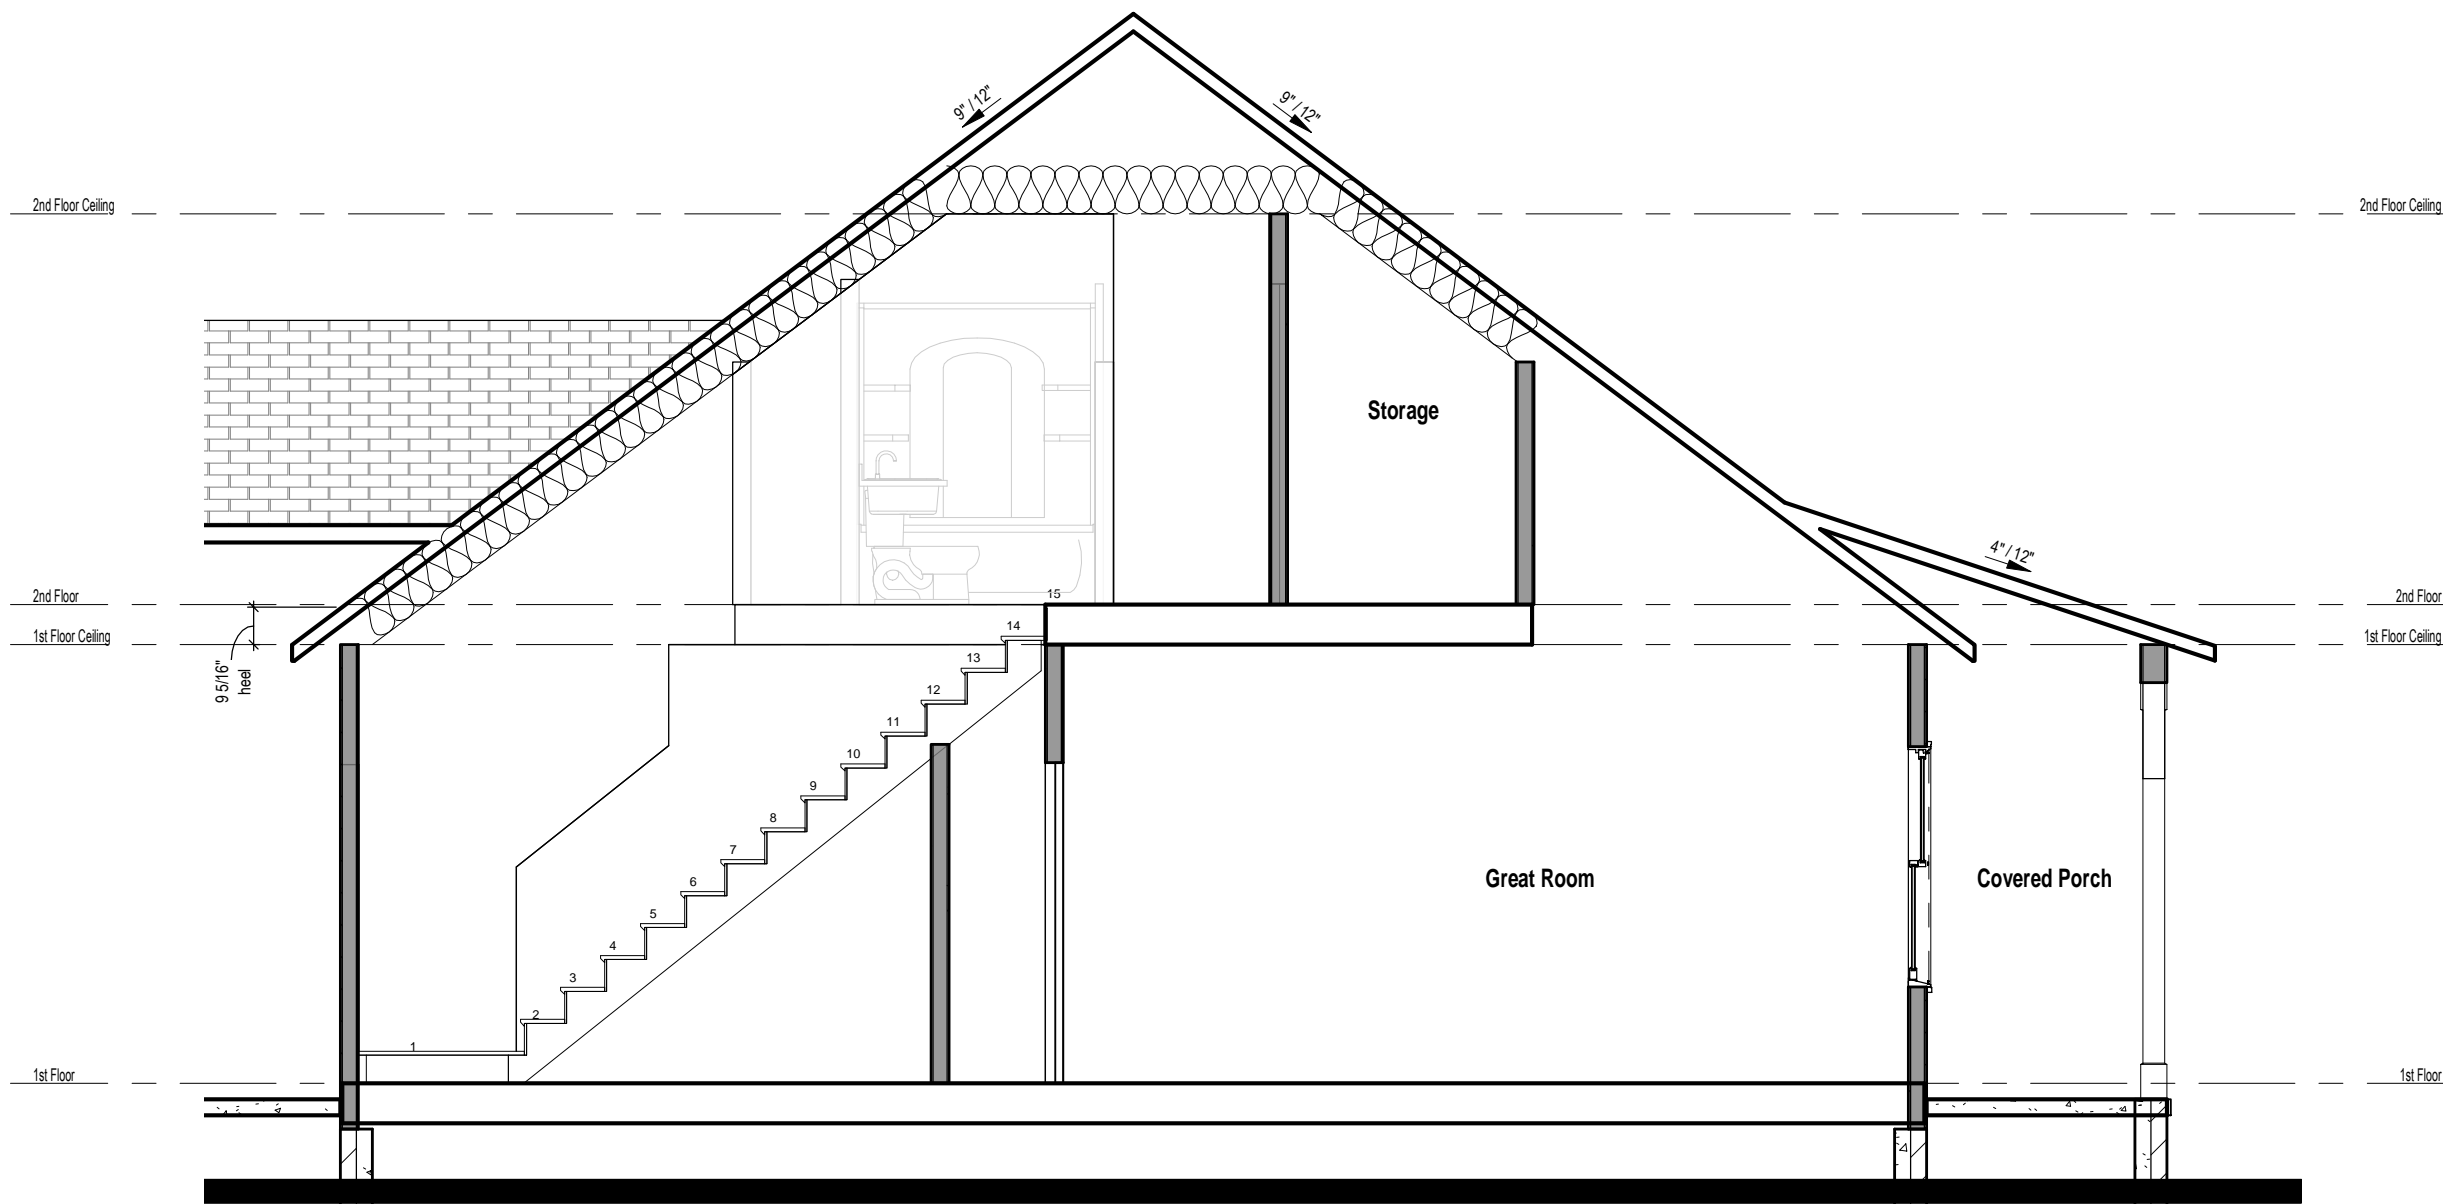

1 Building Section
 1/4" = 1'-0"