

Plans Designed to the 2018 NORTH CAROLINA STATE **RESIDENTIAL BUILDING CODE**

CLIMATE ZONE	ZONE 3	ZONE 4	ZONE 5
FENESTRATION U-FACTOR	0.35	0.35	0.35
SKYLIGHT U-FACTOR	0.65	0.65	0.60
GLAZED FENESTRATION SHGC	0.30	0.30	0.30
CEILING R-VALUE	30	38	38
WALL R-VALUE	13	15	19
FLOOR R-VALUE	19	19	30
*BASEMENT WALL R-VALUE	10/13	10/13	10/13
**SLAB R-VALUE	0	0	10
* CRAWLSPACE WALL R-VALUE	5/13	10/13	10/13

* "10/13" Means R-10 Sheathing Insulation or R-13 Cavity Insulation ** Insulation Depth with Monolithic Slab 18" or From Inspection Gap to bottom of Footing; Insulation Depth with Stem Wall Slab 24" or to bottom of Foundation Wall

DESIGNED FOR WIND SPEED OF 120 MPH, 3 SECOND GUST (93 FASTEST MILE) EXPOSURE "B"

DESIGN PRESSURES FOR DOORS AND WINDOWS						
POSITIVE AND NEGATIVE IN PSF						
	MEAN ROOF HEIGHT (FT)					
VELOCITY (MPH)	15	25	35			
115	15	17	19			
120	20	23	25			

ASSUMED MEAN ROOF HEIGHT 15'1"

AIR LEAKAGE

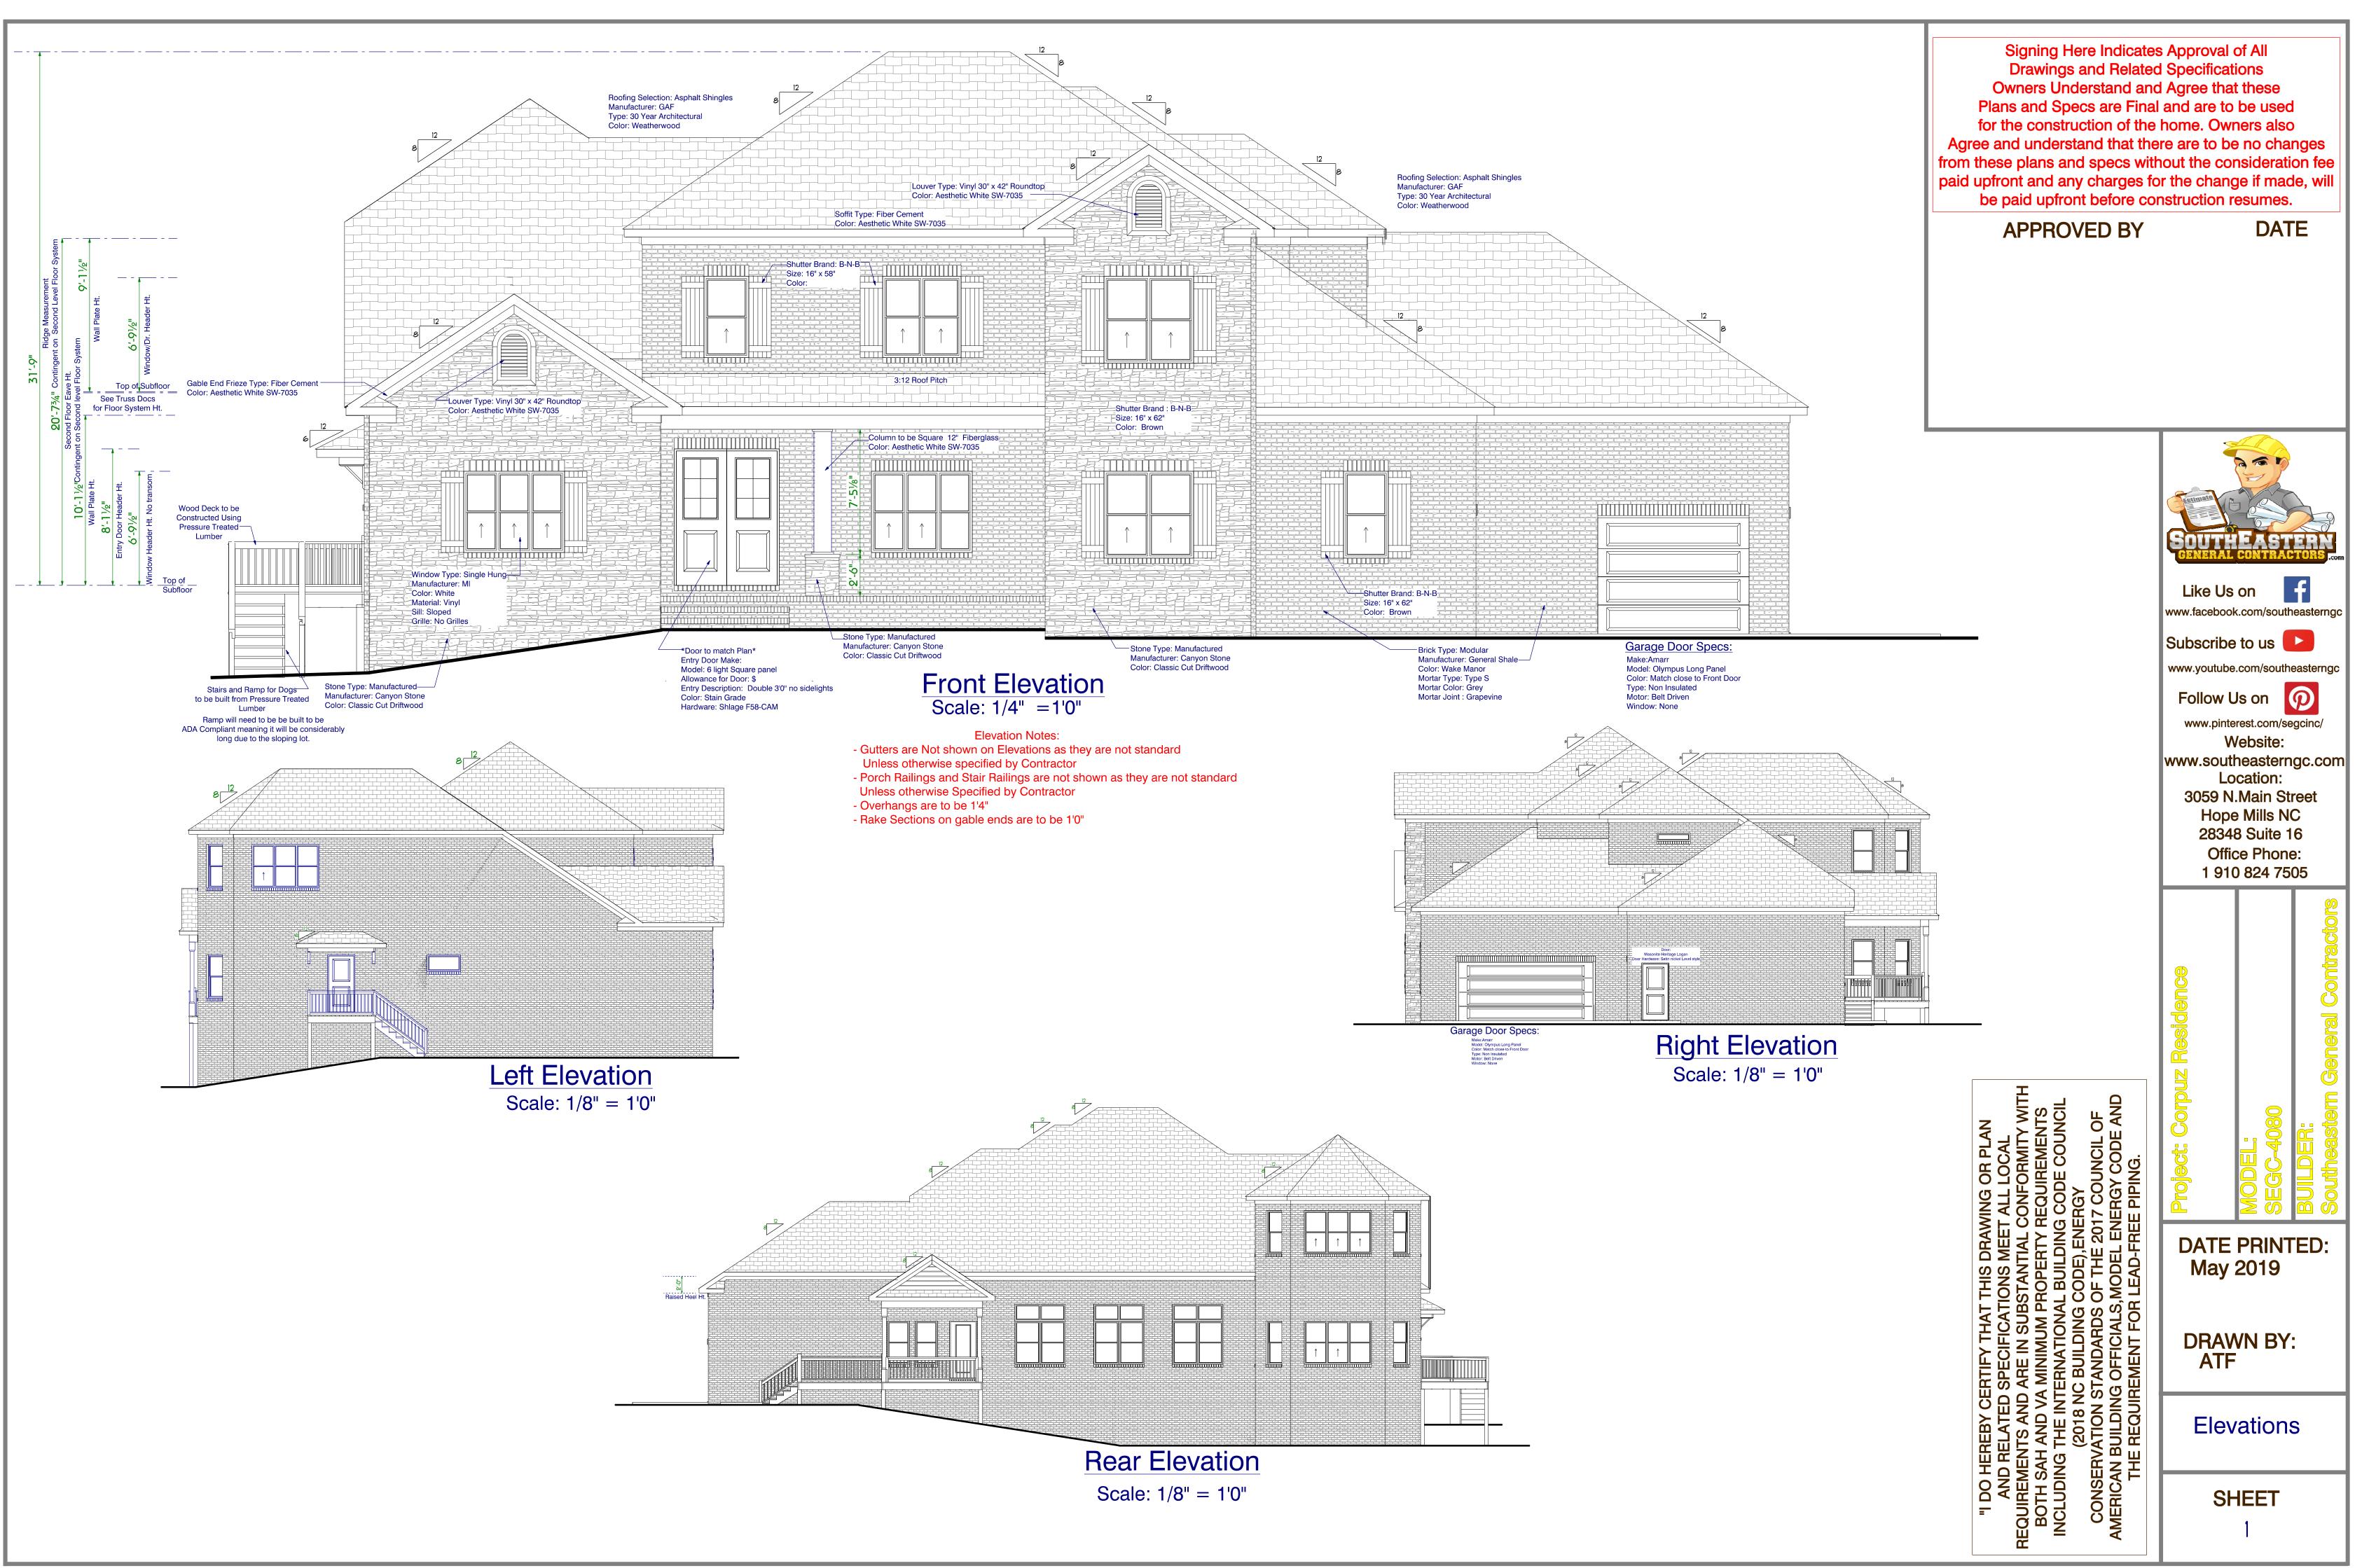
Section N1102.4

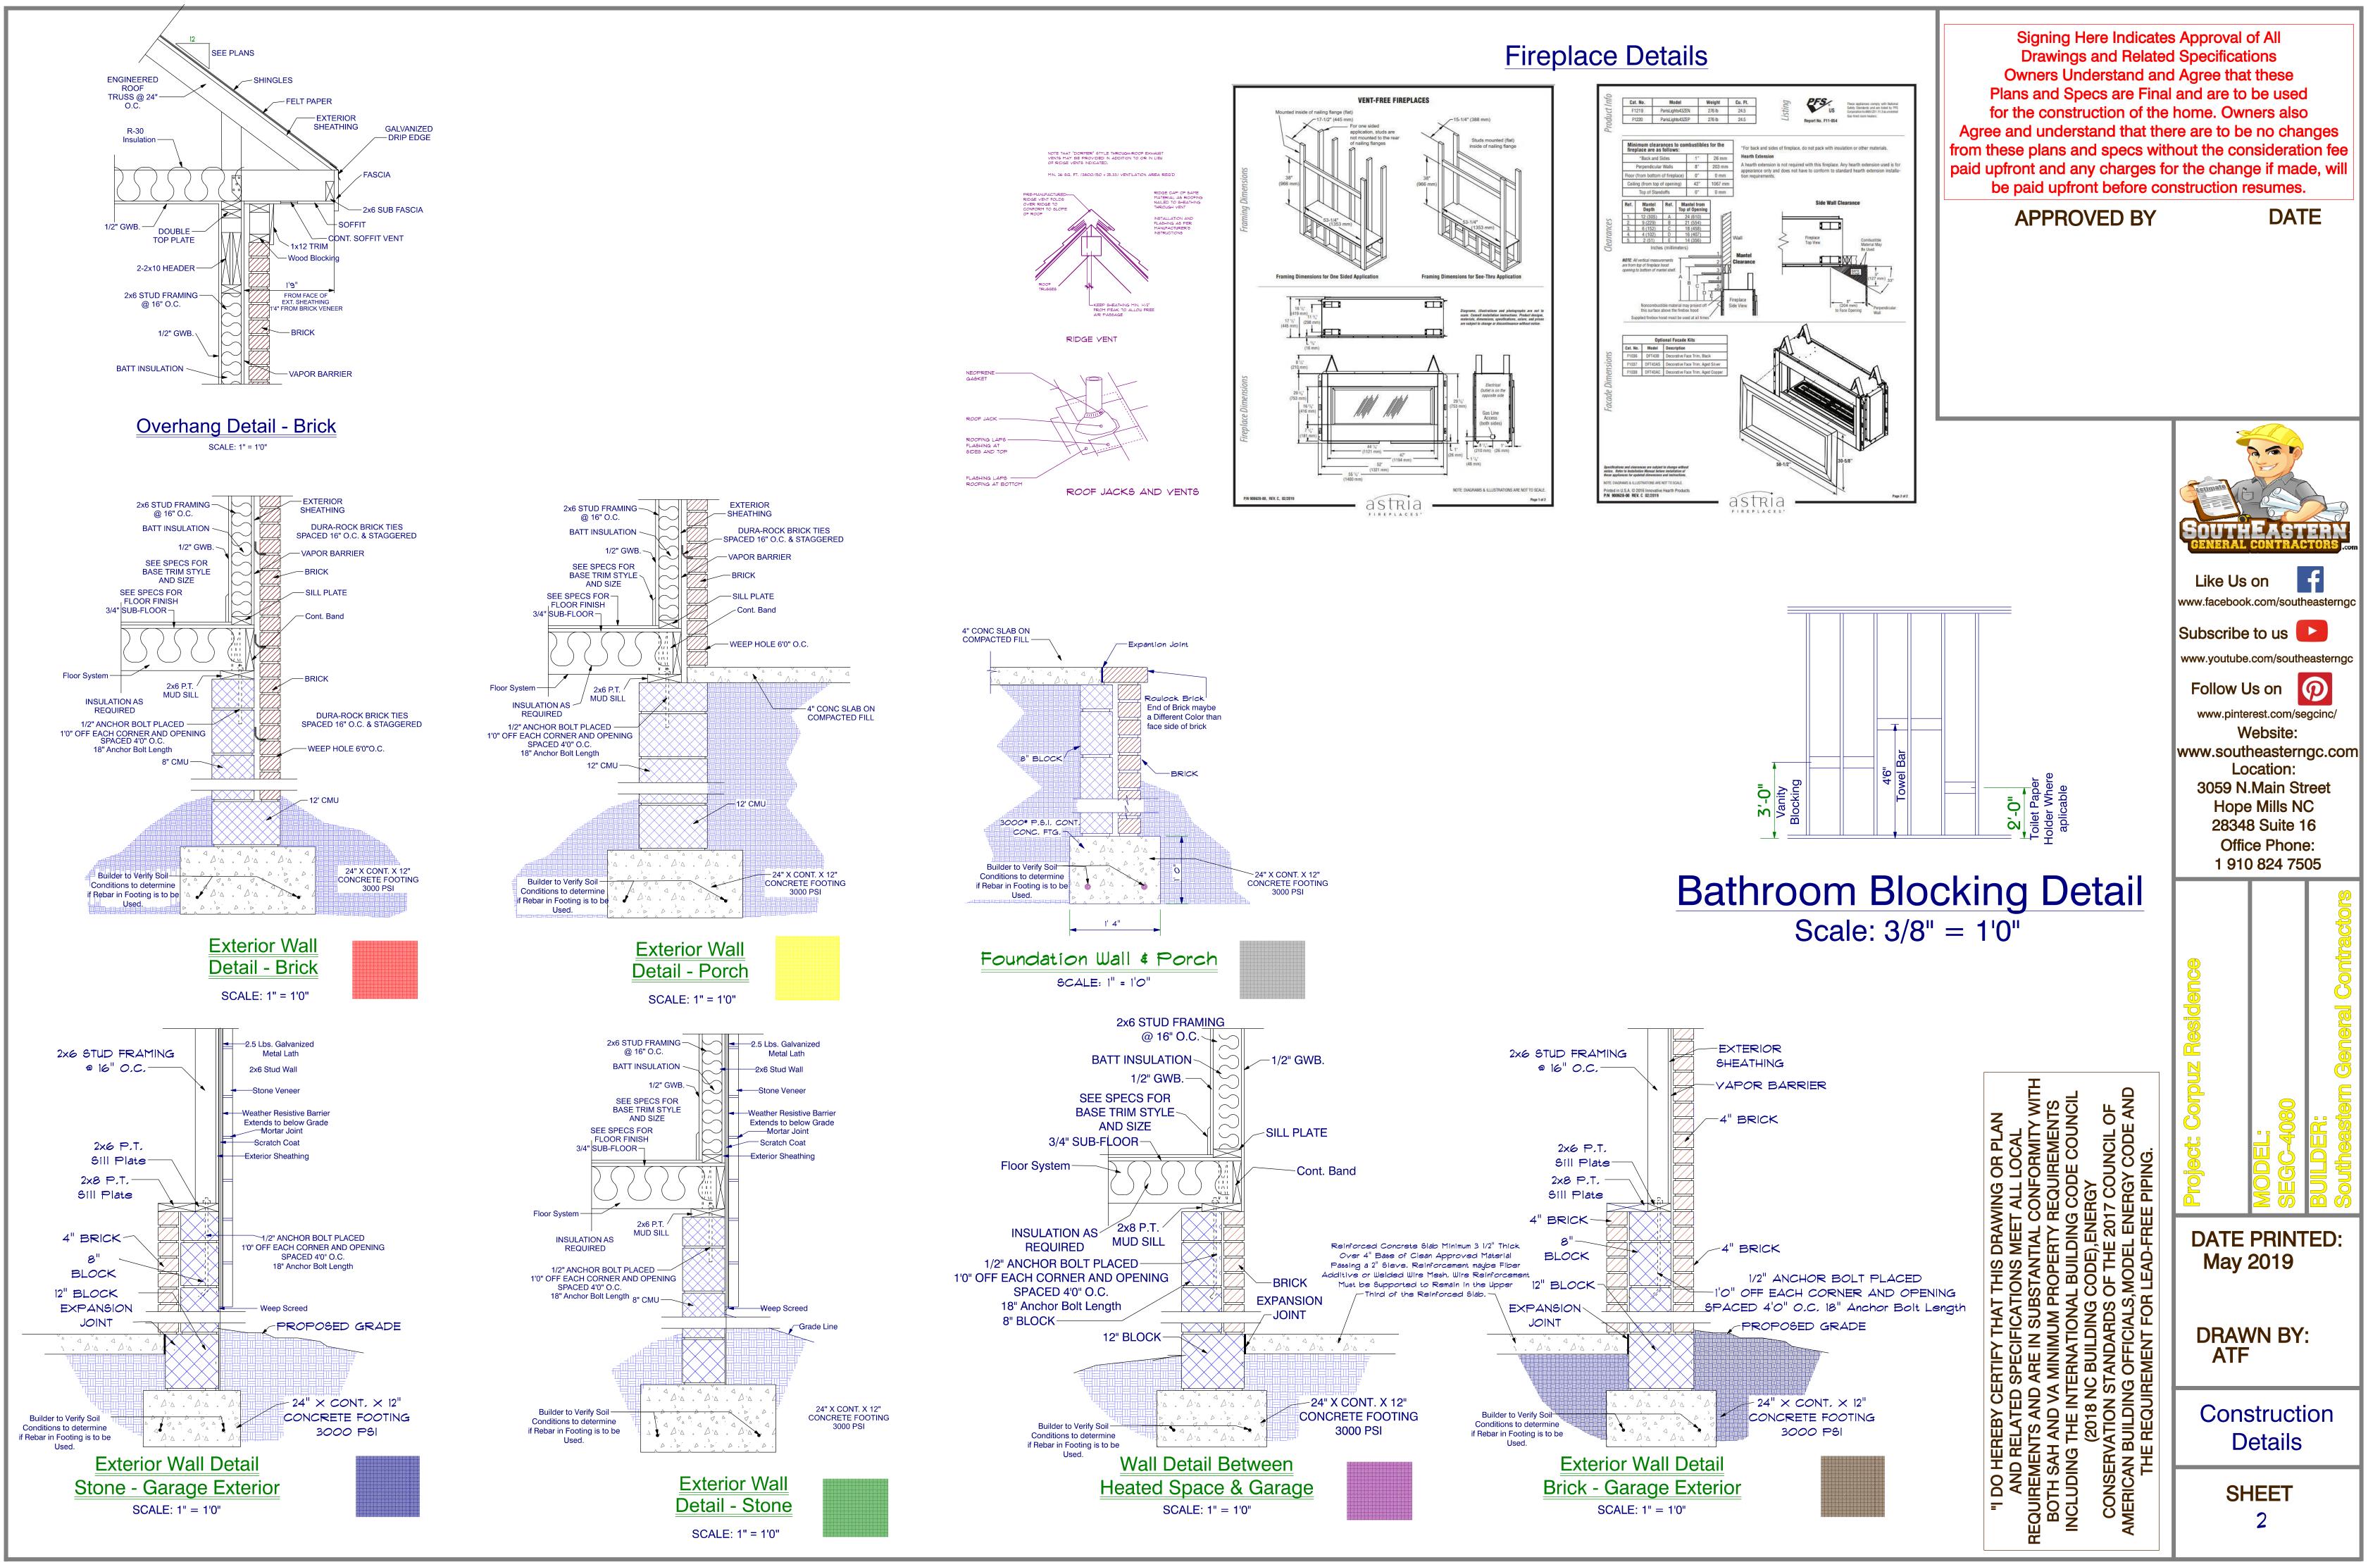
N1102.4.1 Building Thermal Envelope.

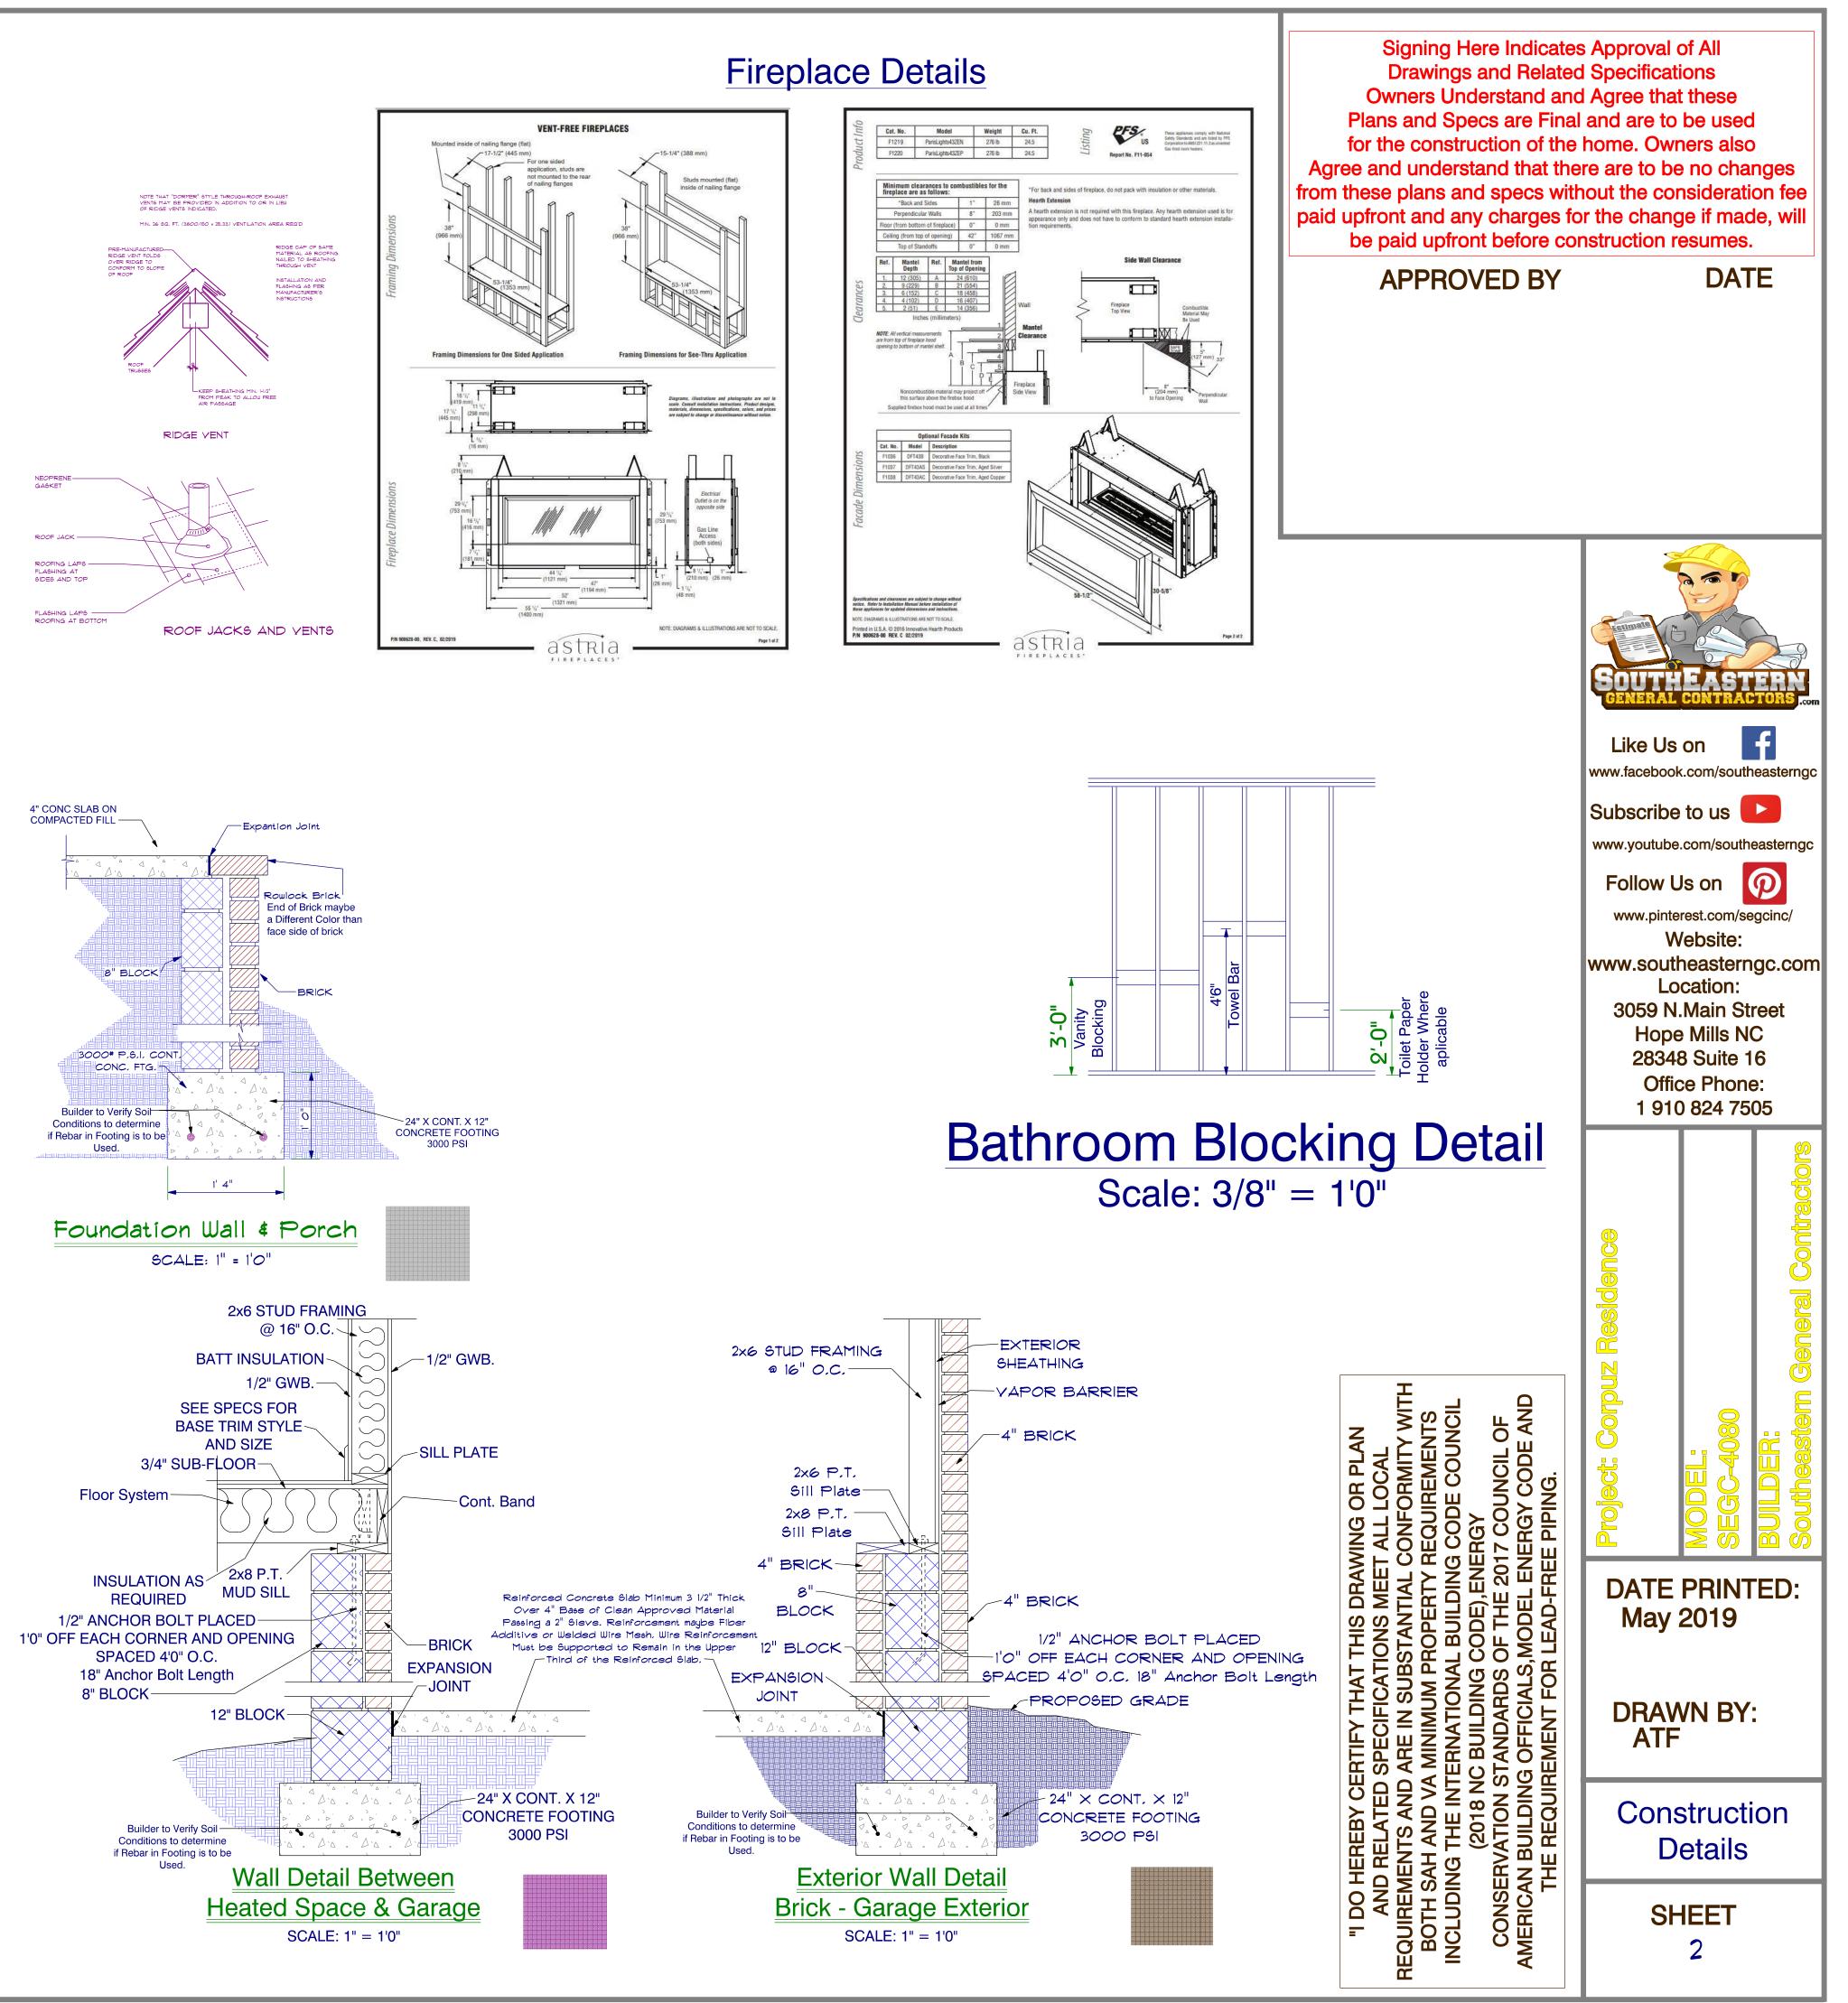
The Building Thermal Envelope shall be durably sealed with an Air Barrier System to limit infiltration. The sealing methods between dissimilar materials shall allow for differential expansion and contraction. For all homes, where present, the following shall be caulked, gasketed, weatherst 8 ripped or otherwise sealed with an air barrier material or solid material consistent with Appendix E-2.4 of this code:

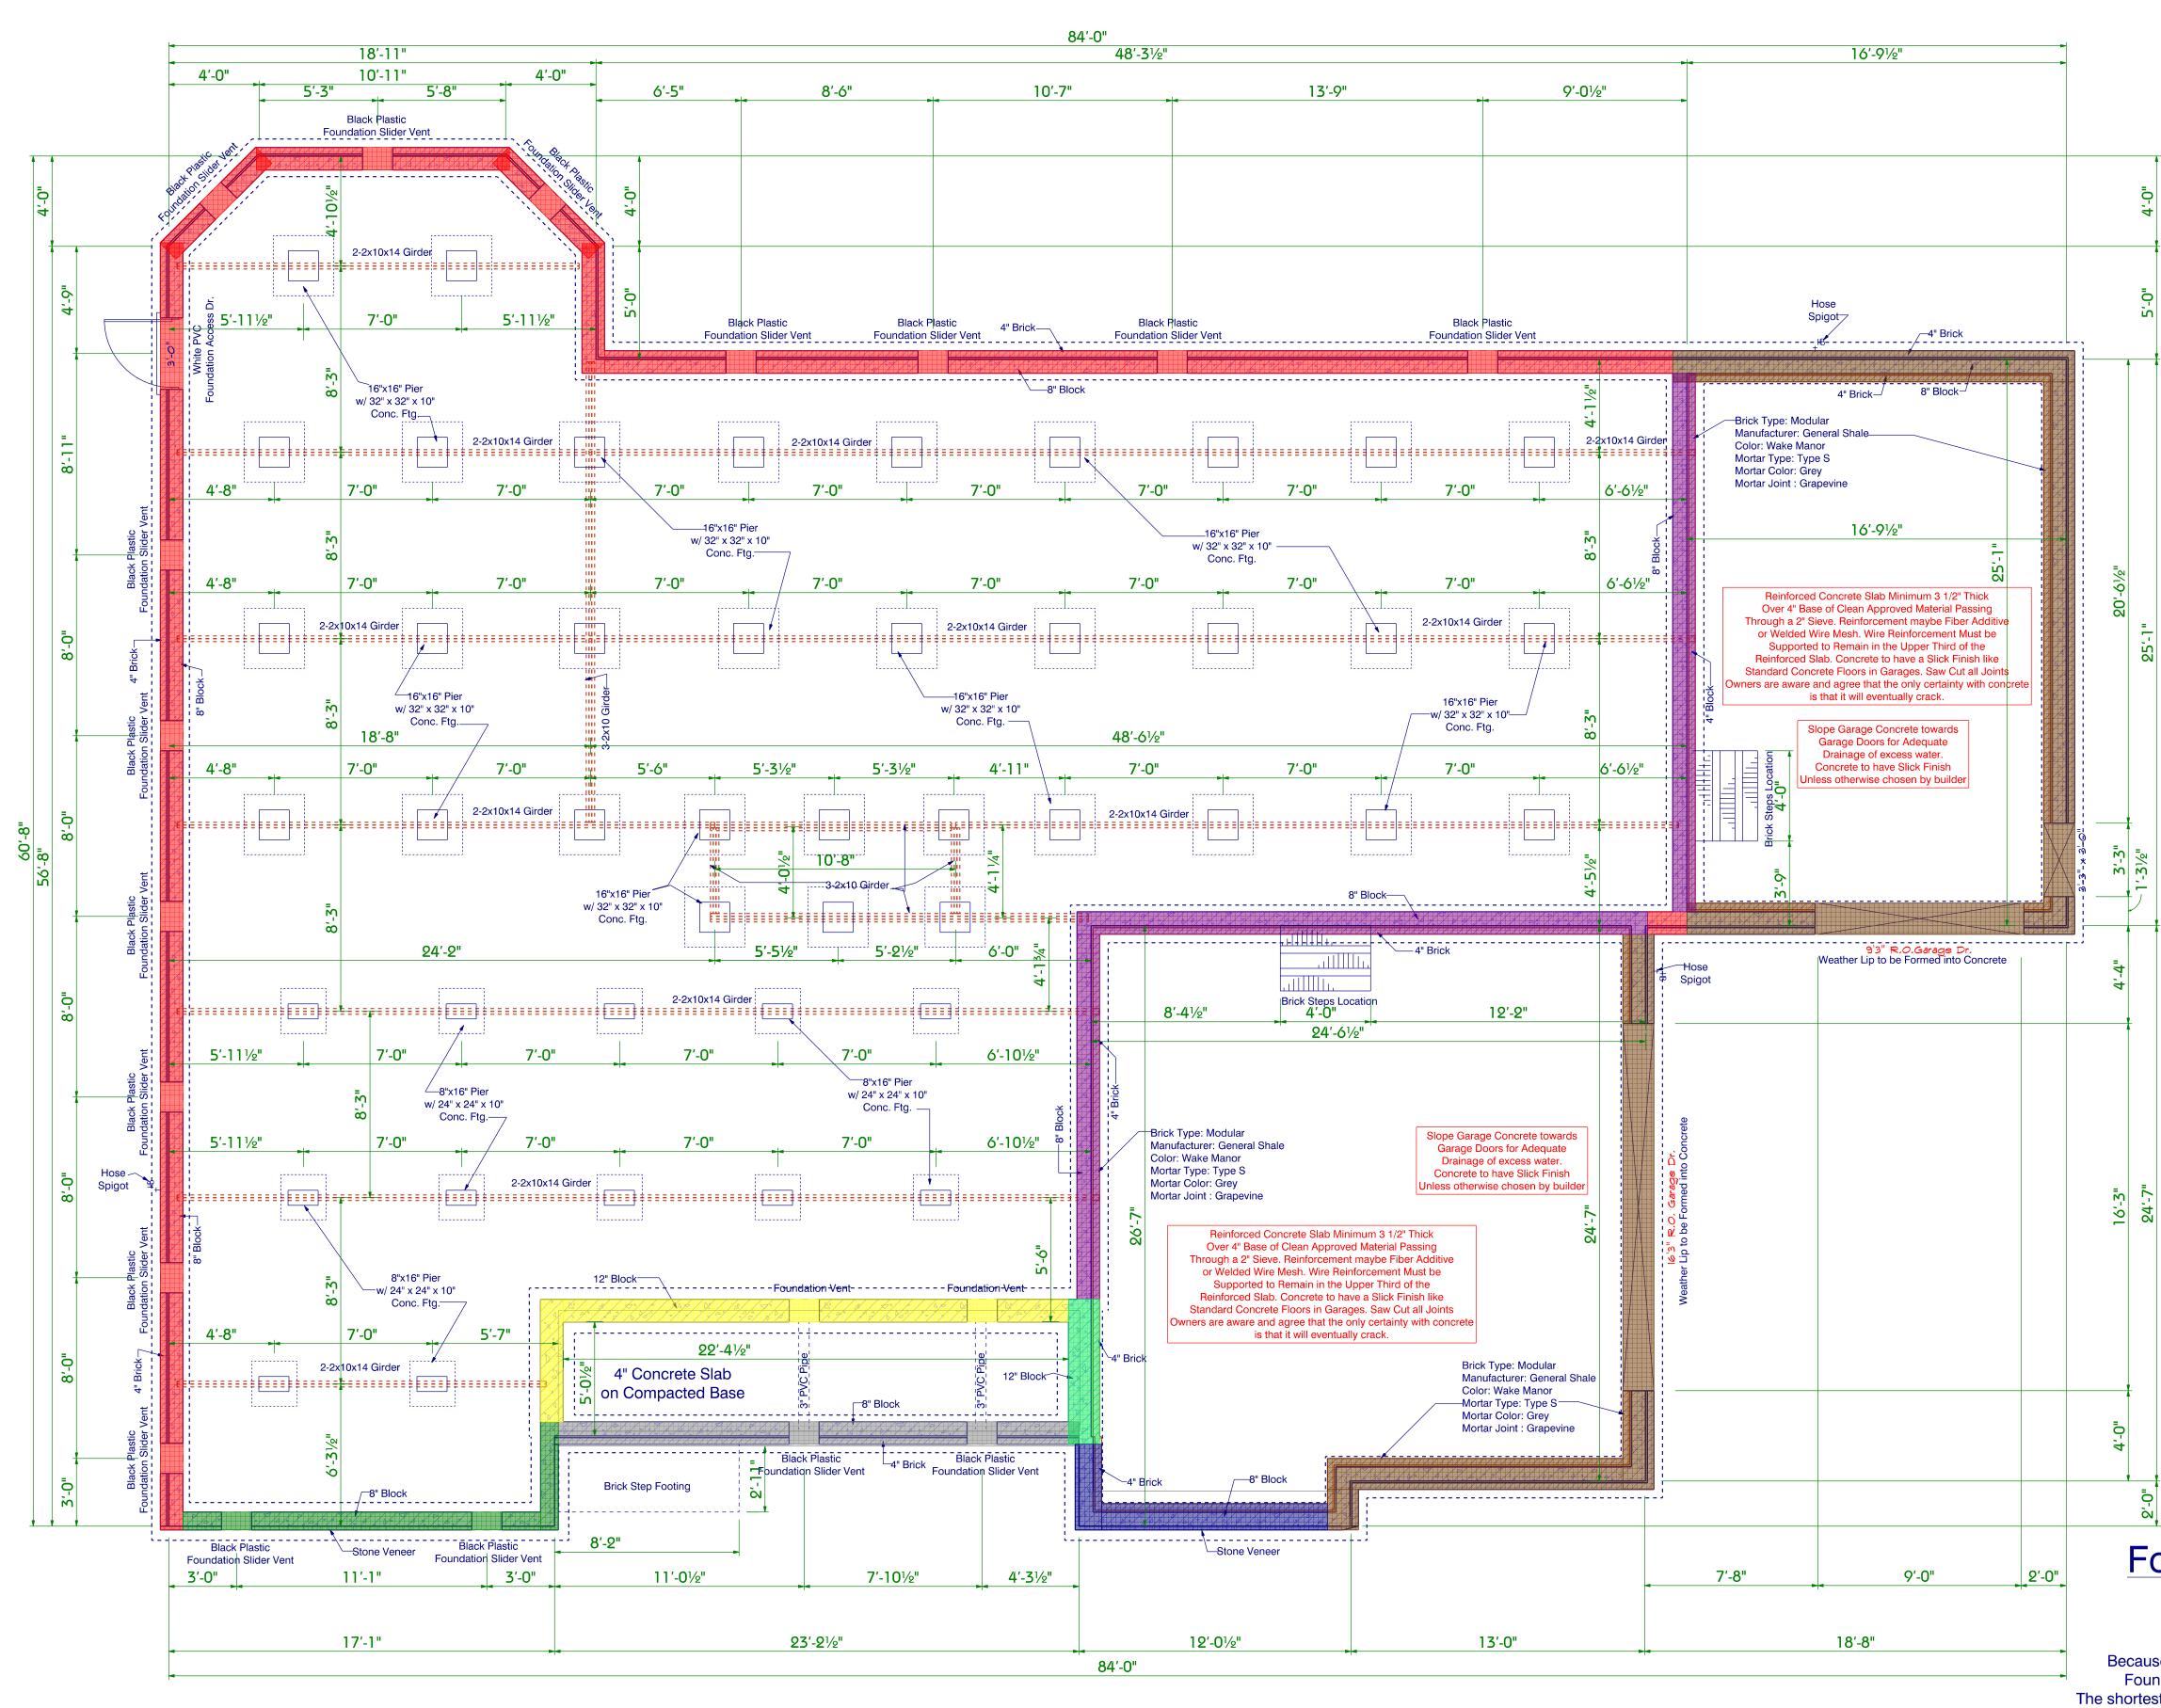
1. Blocking and sealing floor/ceiling systems and under knee walls open to unconditoned or exterior space. 2. Capping and sealing shafts or chases, including flue shafts. 3. Capping and sealing soffit or dropped ceiling areas.

Design Loads	Live Load	Dead Load	Deflection
USE	(PSF)	(PSF)	(LL)
Attics without storage	10	10	L/240
Attics with Limited storage	20	10	L/360
Attics with fixed stairs	40	10	L/360
Balconies and Decks	40	10	L/360
Fire Escapes	40	10	L/360
Guardrails and Handrails	200		
Guardrail in-fill conponents	50		
Passenger vehicle garages	50	10	L/360
Rooms other than sleeping	40	10	L/360
Sleeping rooms	30	10	L/360
Stairs	40		L/360
Snow	20		










Signing Here Indicates Approval of All Drawings and Related Specifications **Owners Understand and Agree that these** Plans and Specs are Final and are to be used for the construction of the home. Owners also Agree and understand that there are to be no changes Foundation Notes: from these plans and specs without the consideration fee - Crawlspace to be Cleaned , Raked level, paid upfront and any charges for the change if made, will and free of any debris, trash, and vegetation All masonry pieces and concrete are to be be paid upfront before construction resumes. removed from the crawlspace. - Masons to install Grout Stop in foundation walls DATE **APPROVED BY** so that the 18 inch anchor bolts are fully embedded into the mortar. Anchor Bolts to be 18" Long 5/8" Diameter. Spaced 1'0" off the corners and 6'0' O.C. - Inside all garages are to have brick on the foundation wall - Anchor bolts are to be installed straight and at the right height to make sure the mud sill is installed properly with enough room for the washer and nut. - All piers are to be filled solid with mortar/concrete. - All Remaining pallets, block, bricks , bags of mortar are to be placed neatly at the rear of the property and covered/ protected with plastic, not visible from the front of the property. - Waterproof all masonry that is below grade Notes for Framing Contractor: 2 6 -7'0" Spacing of Piers = Use 2x10x14 for Girders -8'0" Spacing of Piers = Use 2x10x16 for Girders -Use this method so that joints break over the piers. -2x2 Ledgers need 3 nails under each joist above them Wall Description Wall Type Like Us on -----8" Block/4" Brick Wall with 24" Wide www.facebook.com/southeasterngc by 12" Deep Continuous Footing , Subscribe to us 8" Block/Stone Veneer wall with 24" Wide by 12" Deep Continuous Footing ---www.youtube.com/southeasterngc 12" Block/4" Brick wall with 24" Wide Follow Us on by 12" Deep Continuous Footing @ Garage Brick Veneer in Garage to Match Selection _ _ _ _ _ _ _ _ _ _ _ _ _ _ _ www.pinterest.com/segcinc/ 8" Block/4" Brick wall with 24" Wide ,........... Website: by 12" Deep Continuous Footing @ Garage Brick Veneer in Garage to match Selection www.southeasterngc.com Location: 12" Block Wall with 24" Wide by 12" Deep Continuous Footing 3059 N.Main Street Hope Mills NC 8" Block wall with 4" Brick on Garage Side and Stone Veneer on Exterior Side. 28348 Suite 16 24" Wide by 12" Deep Continuous Footing **Office Phone:** Brick inside garage to match Selection 1 910 824 7505 -----8" Block/4" Brick @ Porch with 24" Wide by 12" Deep Continuous Footing --------8" Block wall with 4" Brick on Garage Side ----and 4" Brick on Exterior Side. 24" Wide by 12" Deep Continuous Footing Brick inside garage to match selection Note Taken from 2018 NC Residential Code R403.1.5 Slope The top surface of footings shall be level (4/2 inch in 10 feet) or shall be brought level, under the width of the wall, with masonry units with full mortar joints. The bottom surface of footings shall not have a slope exceeding one unit vertical in 10 units horizontal (10-percent slope). Footings shall be stepped where it is necessary to change the elevation of the top surface of the footings or where the slope of the bottom surface of the footings will exceed one unit vertical in 10 units horizontal (10-percent slope). "I DO HEREBY CERTIFY THAT THIS DRAWING OR PLAN AND RELATED SPECIFICATIONS MEET ALL LOCAL AND RELATED SPECIFICATIONS MEET ALL LOCAL REQUIREMENTS AND ARE IN SUBSTANTIAL CONFORMITY WITH BOTH SAH AND VA MINIMUM PROPERTY REQUIREMENTS INCLUDING THE INTERNATIONAL BUILDING CODE COUNCIL (2018 NC BUILDING CODE), ENERGY CONSERVATION STANDARDS OF THE 2017 COUNCIL OF AMERICAN BUILDING OFFICIALS, MODEL ENERGY CODE AND THE REQUIREMENT FOR LEAD-FREE PIPING. OF DATE PRINTED: May 2019 Foundation Plan Crawlspace Scale: 1/4" = 1'0" **DRAWN BY:** Because this is a sloping lot, Pier Heights and ATF Foundation Wall Heights will be different. The shortest wall height will be at the front of the home and will be 32" in Height from Grade level. **Foundation Plan** SHEET
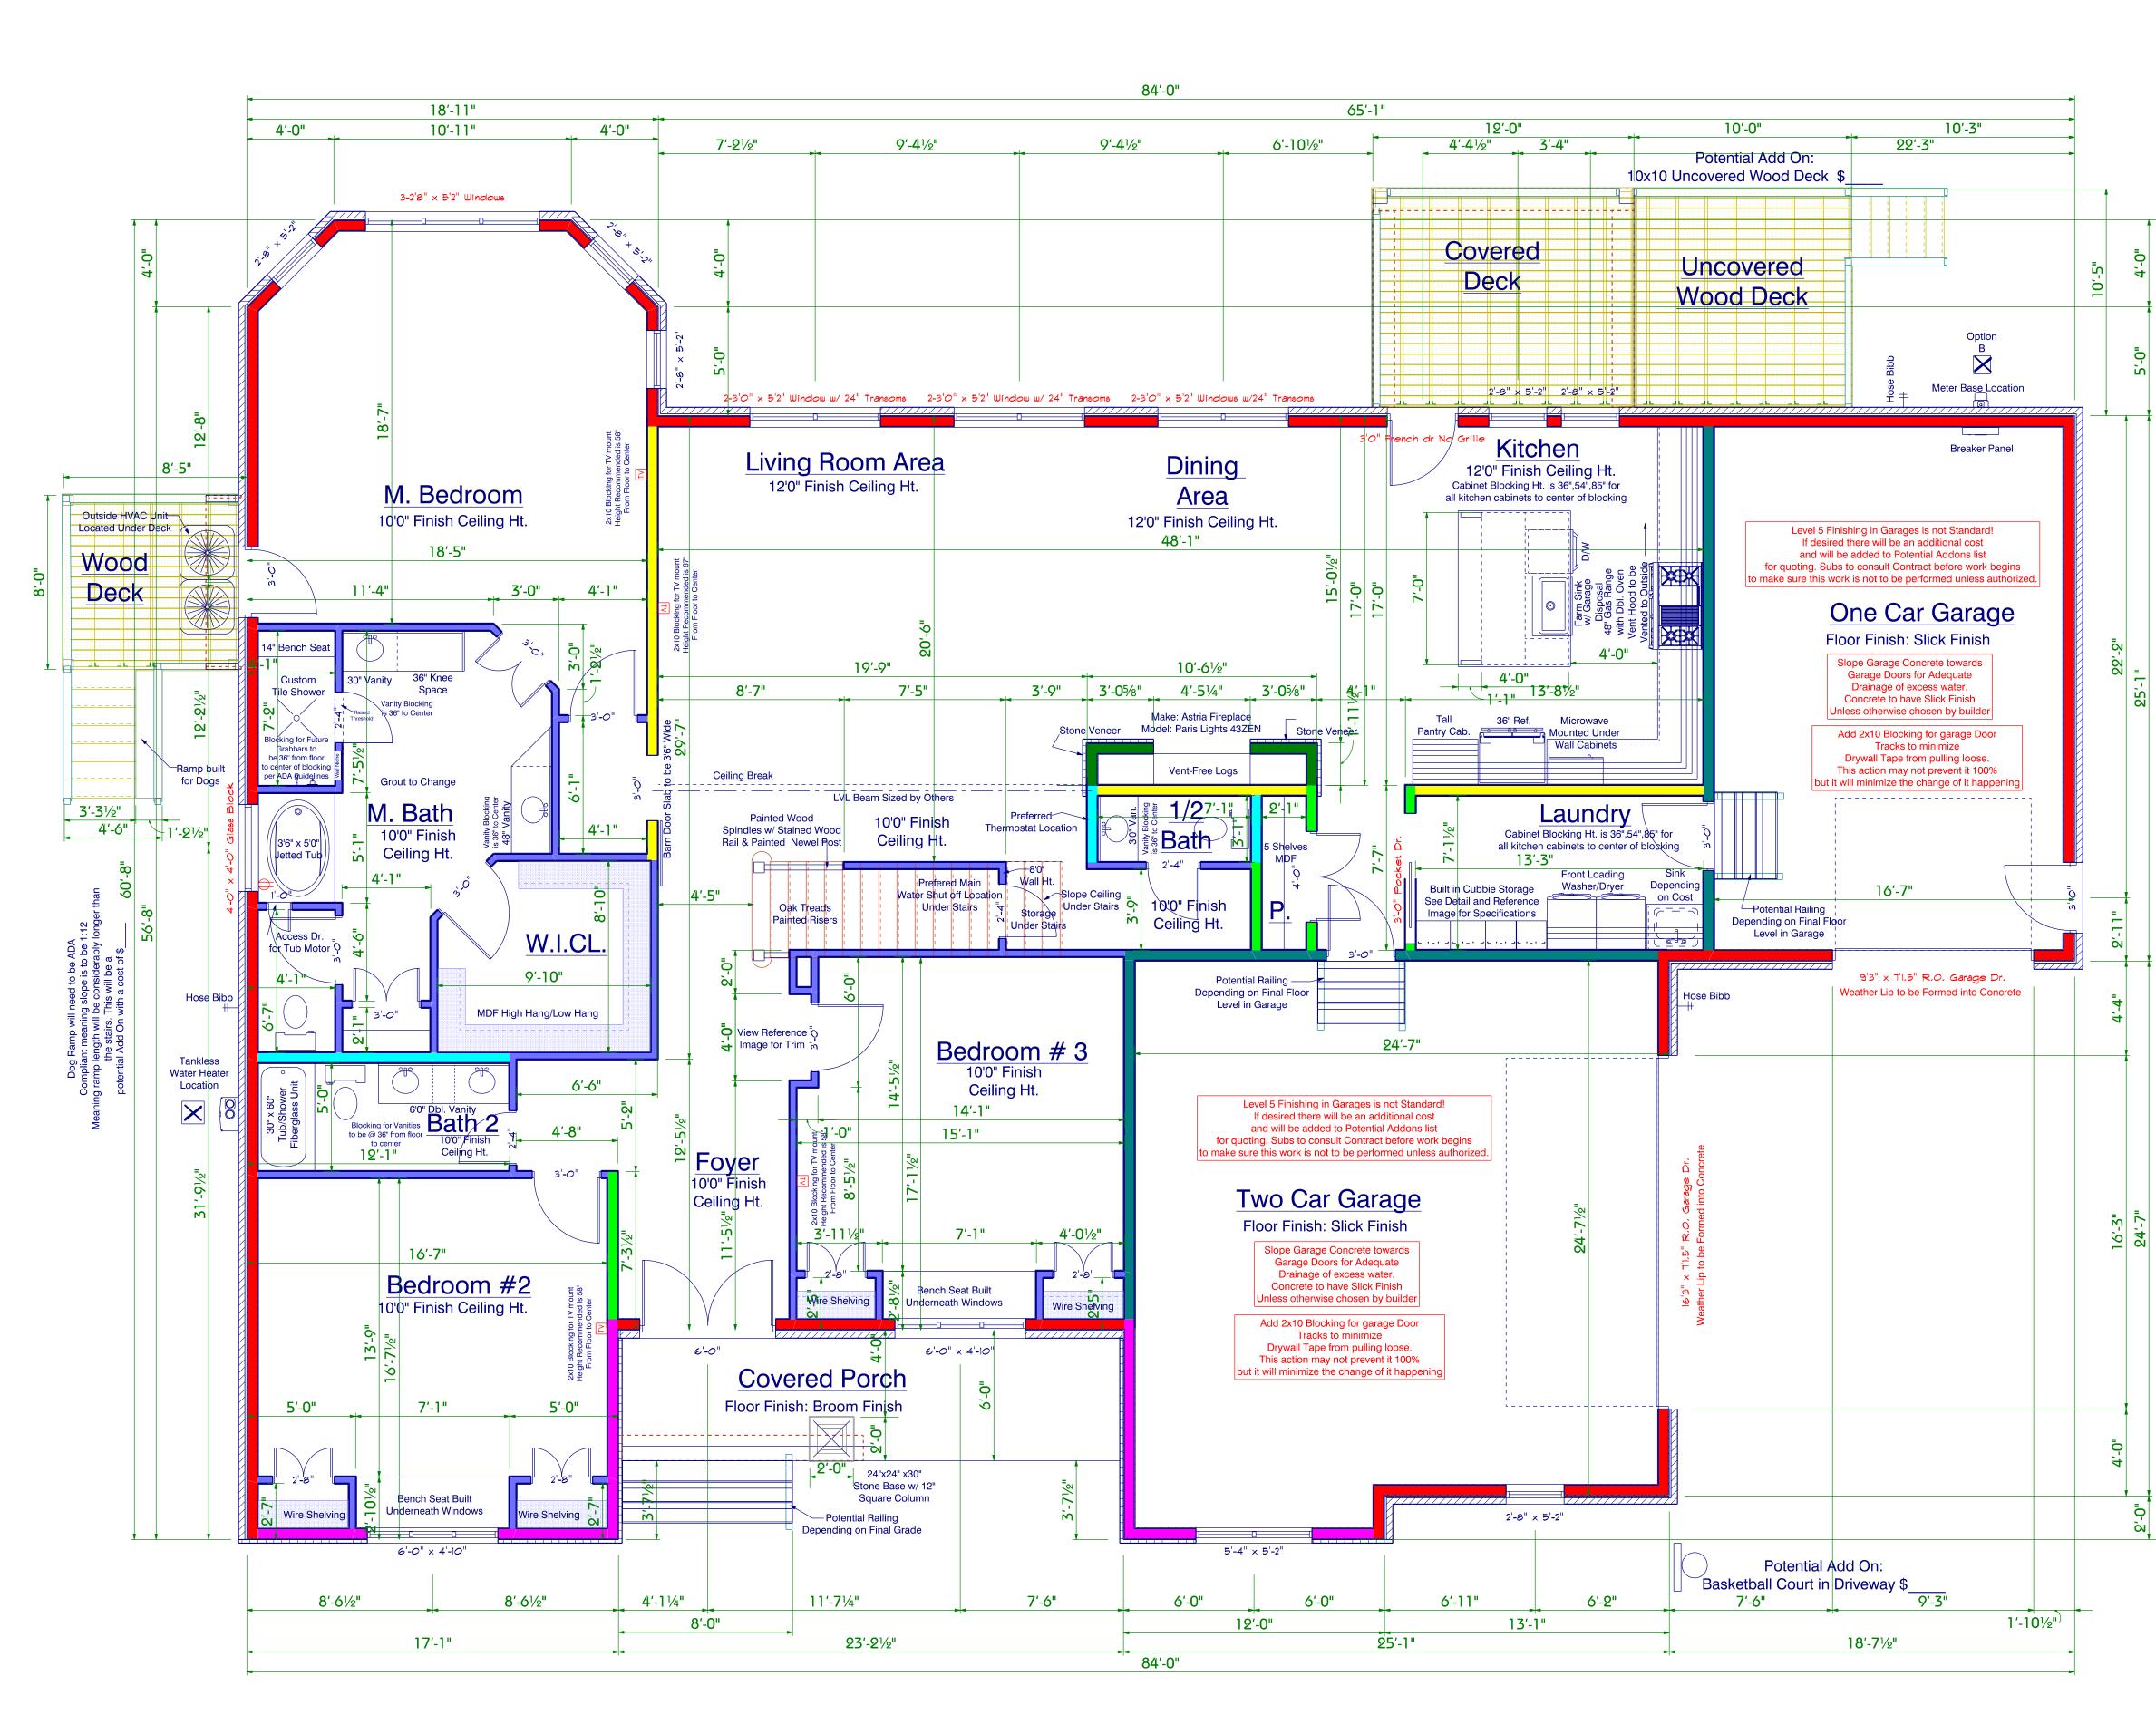
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