BUILDING CODE COMPLIANCE / PROJECT INFORMATION

ALL CONSTRUCTION TO COMPLY WITH LOCAL CODES AND ORDINANCES CURRENTLY IN USE WITH THE LOCAL JURISDICTION.

FOLLOW ALL APPLICABLE STATE AND LOCAL CODES. 2018 NORTH CAROLINA STATE SUPPLEMENTS AND AMENDMENTS

CONTRACTOR AND BUILDER SHALL REVIEW ENTIRE PLAN TO VERIFY CONFORMANCE WITH ALL CURRENT APPLICABLE CODES IN EFFECT AT TIME OF CONSTRUCTION. BY USING THESE DRAWINGS FOR CONSTRUCTION IT IS UNDERSTOOD THAT CONFORMANCE WITH ALL APPLICABLE CODES IS THE RESPONSIBILITY OF THE BUILDER AND CONTRACTOR.

PRODUCT:

SINGLE FAMILY RESIDENCE

OCCUPANCY CLASSIFICATION RESIDENTIAL R-3

CONSTRUCTION TYPE: TYPE VB

INDEX	
T-1	TITLE SHEET/ COVER SHEET
A-1.1	EXTERIOR ELEVATIONS
A-1.2	EXTERIOR ELEVATIONS
A-1.3	ROOF PLAN
A-1.4	SECTIONS
A-1.5	SECTIONS
A-1.6	1ST FLOOR PLAN
A-1.7	2ND FLOOR PLAN
A-1.8	3RD FLOOR PLAN
	ACT FLOOR ATTUTY REAL
E1.0	1ST FLOOR UTILITY PLAN
E2.0	2ND FLOOR UTILITY PLAN
E3.0	3RD FLOOR UTILITY PLAN

ALL CONSULTANT DRAWINGS ACCOMPANYING THESE GMD DESIGN GROUP DRAWINGS HAVE MOT BEEN PREPARED BY OR UNDER THE DIRECTION OF GMD DESIGN GROUP, INC. GMD DESIGN GROUP INC. THEREFORE ASSUMES NO LIABILITY FOR THE COMPLETENESS OR CORRECTNESS OF THESE DRAWINGS.

'THE NELSON' SF						
AREA	CLASSIC					
1st FLOOR	1052 SF					
2nd FLOOR	1281 SF					
TOTAL LIVING	2333 SF					
UNFINISHED 3rd FLOOR	573 SF					
GARAGE	401 SF					
COV. PORCH	401 SF					

GENERAL NOTES DESIGNER NORTH CAROLINA:

THESE DOCUMENTS ARE THE PROPERTY OF THE DESIGNER AND SHALL NOT BE COPIED, DUPLICATED, ALTERED, MODIFIES OR REVISED IN ANY WAY WITHOUT THE EXPRESSED WRITTEN APPROVAL OF THE DESIGNER.

CONTRACTOR SHALL VERIFY ALL CONDITIONS AND DIMENSIONS AT THE SITE AND ALL INCONSISTENCES SHALL BE BROUGHT TO THE ATTENTION OF THE DEVELOPER AND THE DESIGNER BEFORE PROCEEDING WITH WORK.

ANY ERRORS OR OMISSIONS FOUND IN THESE DRAWINGS SHALL BE BROUGHT TO DEVELOPERS AND DESIGNERS ATTENTION IMMEDIATELY.

DO NOT SCALE DRAWINGS, WRITTEN DIMENSIONS TAKE PRECEDENCE OVER SCALED DIMENSIONS.

ALL DIMENSIONS ARE TO FACE OF STUD OR TO FACE OF FRAMING UNLESS OTHERWISE NOTED.

ALL TRUSS DRAWINGS TO BE REVIEWED AND APPROVED BY THE STRUCTURAL ENGINEER PRIOR TO ISSUANCE OF BUILDING PERMIT.

ALL OR EQUAL SUBSTITUTIONS MUST BE SUBMITTED TO AND APPROVED BY CITY BUILDING OFFICIAL PRIOR TO INSTALLATION.

ALL ANGLED PARTITIONS ARE 45 DEGREES UNLESS OTHERWISE NOTED. PROVIDE FIREBLOCKING. (PER LOCAL CODES.)

ALL ELECTRICAL AND MECHANICAL EQUIPMENT AND METERS ARE SUBJECT TO RELOCATION DUE TO FIELD CONDITIONS, CONTRACTOR TO VERIFY.

PROVIDE BLOCKING AND/OR BACKING AT ALL TOWEL BAR, TOWEL RING AND/OR TOILET PAPER HOLDER LOCATIONS, AS SHOWN PER PLAN. TYPICAL AT ALL BATHROOMS AND POWDER ROOMS. VERIFY LOCATIONS AT FRAMING WALK.

ELASTOMERIC SHEET WATERPROOFING, FURNISH AND INSTALL ALL WATERPROOFING COMPLETE. A 40 MIL. SELF-ADHERING MEMBRANE OF RUBBERIZED ASPHALT INTEGRALLY BONDED TO POLYETHYLENE SHEETING, OR EQUAL. INSTALL PER MANUFACTURE'S AND TRADE ASSOCIATION'S PRINTED INSTALLATION INSTRUCTIONS. 6"MINIMUM LAP AT ALL ADJACENT WALL SURFACES.

TO THE BEST OF THE DESIGNER'S KNOWLEDGE THESE DOCUMENTS ARE IN CONFORMANCE WITH THE REQUIREMENTS OF THE BUILDING AUTHORITIES HAVING JURISDICTION OVER THIS TYPE OF CONSTRUCTION AND OCCUPANCY.

SHOP DRAWING REVIEW AND DISTRIBUSTION, ALONG WITH PRODUCT SUBMITTALS, REQUESTED IN THE CONSTRUCTION DOCUMENTS, SHALL BE THE SOLE RESPONSIBILITY OF THE GENERAL CONTRACTOR, UNLESS DIRECTED OTHERWISE UNDER A SEPARATE AGREEMENT.

DEVIATIONS FROM THESE DOCUMENTS IN THE CONSTRCTION PHASE SHALL BE REVIEWED BY THE DESIGNER AND THE OWNER PRIOR TO THE START OF WORK IN QUESTION. ANY DEVIATIONS FROM THESE DOCUMENTS WITHOUT PRIOR REVIEW, SHALL BE THE SOLE RESPONSIBILITY OF THE GERAL CONTRACTOR.

THE GENERAL CONTRACTOR SHALL BE RESPONSIBLE FOR ALL WORK AND MATERIALS REPRESENTED ON THESE DOCUMENTS INCLUDING THE WORK AND MATERIALS FUNISHED BY SUBCONTRACTORS AND VENDORS.

THE BUILDER SHALL FURNISH ANY AND ALL REPORTS RECEIVED FROM THE GEOTECHNICAL ENGINEER (SOILS REPORT), ON THE STUDY OF THE PROPOSED SITE, TO THE DESIGNER, STRUCTURAL ENGINEER, AND GENERAL CONTRACTOR. IN THE EVENT THE GEOTECHNICAL REPORTS DO NOT EXIST, THE SOILS CONDITION SHALL BE ASSUMED TO BE A MINIMUM DESIGN SOIL PRESSURE STATED BY THE STRUCTURAL ENGINEER OF RECORD FOR THE PURPOSE OF STRUCTURAL DESIGN.GENERAL CONTRACTOR SHALL ASSURE THE SOIL CONDITIONS MEET OR EXCEED THE CRITERIA.

ALL WORK PERFORMED BY THE GENERAL CONTRACTOR SHALL COMPLY AND CONFORM WITH LOCAL AND STATE BUILDING CODES, ORDINANCES AND REGULATIONS, ALONG WITH ALL OTHER AUTHORITIES HAVING JURISDICTION. THE GENERAL CONTRACTOR IS RESPONSIBLE TO BE AWARE OF THESE REQUIREMENTS AND GOVERNING REGULATIONS.

PROVIDE AN APPROVED WASHER DRAIN PAN AT SECOND FLOOR ONLY THAT DRAINS TO

WINDOW SUPPLIER TO VERIFY AT LEAST ONE WINDOW IN ALL BEDROOMS TO HAVE A CLEAR OPENABLE AREA OF 4.0 SQ FT. THE MINIMUM NET CLEAR OPENING HEIGHT SHALL BE 22" AND THE MINIMUM NET CLEAR OPENING WIDTH SHALL BE 20". GLAZING TOTAL AREA OF NOT LESS THAN 5.0 SQ FT. IN THE CASE OF A GROUND WINDOW AND NOT LESS THAN 5.7 SQ FT IN THE CASE OF AN UPPER STORY WINDOW. (PER NCRC SECTION R310.1.1)

ALL HANDRAIL BALLUSTERS TO BE SPACED SUCH THAT A 4"SPHERE CANNOT PASS BETWEEN BALLUSTERS. (PER LOCAL CODES.)

PROVIDE STAIR HANDRAILS AND GUARDRAILS PER LOCAL CODES

BUILDER SET:

THE SCOPE OF THIS SET OF PLANS IS TO PROVIDE A "BUILDER SET" OF CONSTRUCTION DOCUMENTS AND GENERAL NOTES HEREINAFTER REFERRED TO AS "PLANS". THIS SET OF PLANS IS SUFFICIENT TO OBTAIN A BUILDING PERMIT; HOWEVER, ALL MATERIALS AND METHODS OF CONSTRUCTION NECESSARY TO COMPLETE THE PROJECT ARE NOT NECESSARILY DESCRIBED. THE PLANS DELINEATE AND DESCRIBE ONLY LOCATIONS, DIMENSIONS, TYPES OF MATERIALS, AND GENERAL METHODS OF ASSEMBLING OR FASTENING. THEY ARE NOT INTENDED TO SPECIFY PARTICULAR PRODUCTS OR OTHER METHODS OF ANY SPECIFIC MATERIALS, PRODUCT OR METHOD. THE IMPLEMENTATION OF THE PLANS REQUIRES A CLIENT / CONTRACTOR THOROUGHLY KNOWLEDGEABLE WITH THE APPLICABLE BUILDING CODES AND METHODS OF CONSTRUCTION SPECIFIC TO THIS PRODUCT TYPE AND TYPE OF CONSTRUCTION.

CONSTRUTION REQUIREMENTS AND QUALITY: PROVIDE WORK OF THE SPECIFIC QUALITY; WHERE QUALITY LEVEL IS NOT INDICATED, PROVIDE WORK OF QUALITY CUSTOMARY IN SIMILAR TYPES OF WORK. WHERE THE PLANS AND SPECIFICATIONS, CODES, LAWS, REGULATIONS, MANUFACTURER'S RECOMMENDATIONS OR INDUSTRY STANDARDS REQUIRE WORK OF HIGHER QUALITY OR PERFORMANCE, PROVIDE WORK COMPLYING WITH THOSE REQUIREMENTS AND QUALITY. WHERE TWO OR MORE QUALITY PROVISIONS OF THOSE REQUIREMENTS CONFLICT WITH THE MOST STRINGENT REQUIREMENT; WHERE REQUIREMENTS ARE DDIFFERENT BUT APPARENTLY EQUAL, AND WHERE IT IS UNCERTAIN WHICH REQUIREMENT IS MOST STRINGENT, OBTAIN CLARIFICATION FROM MCKEE HOMES LLC. BEFORE PROCEEDING.

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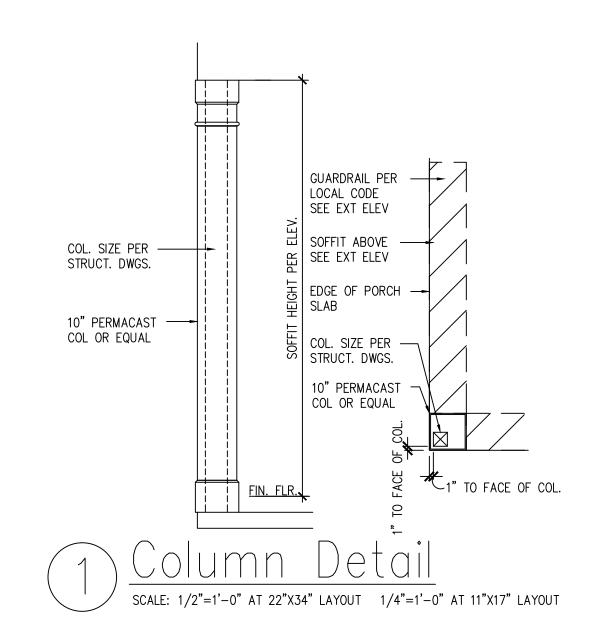
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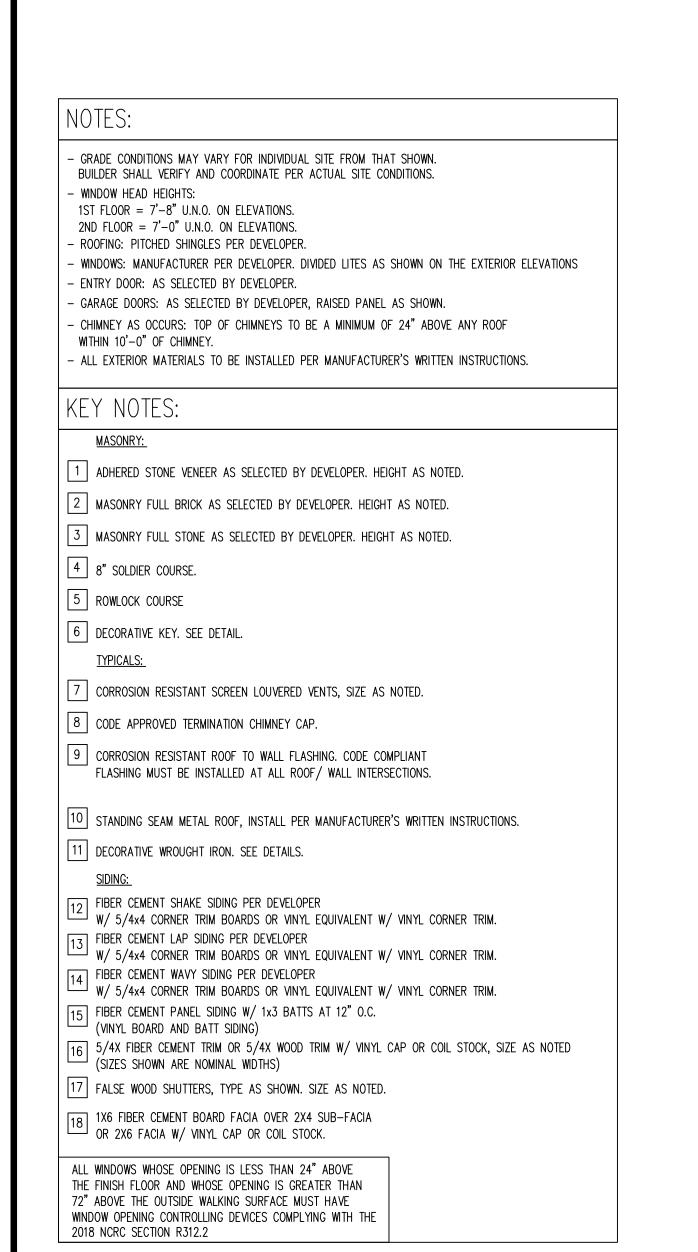
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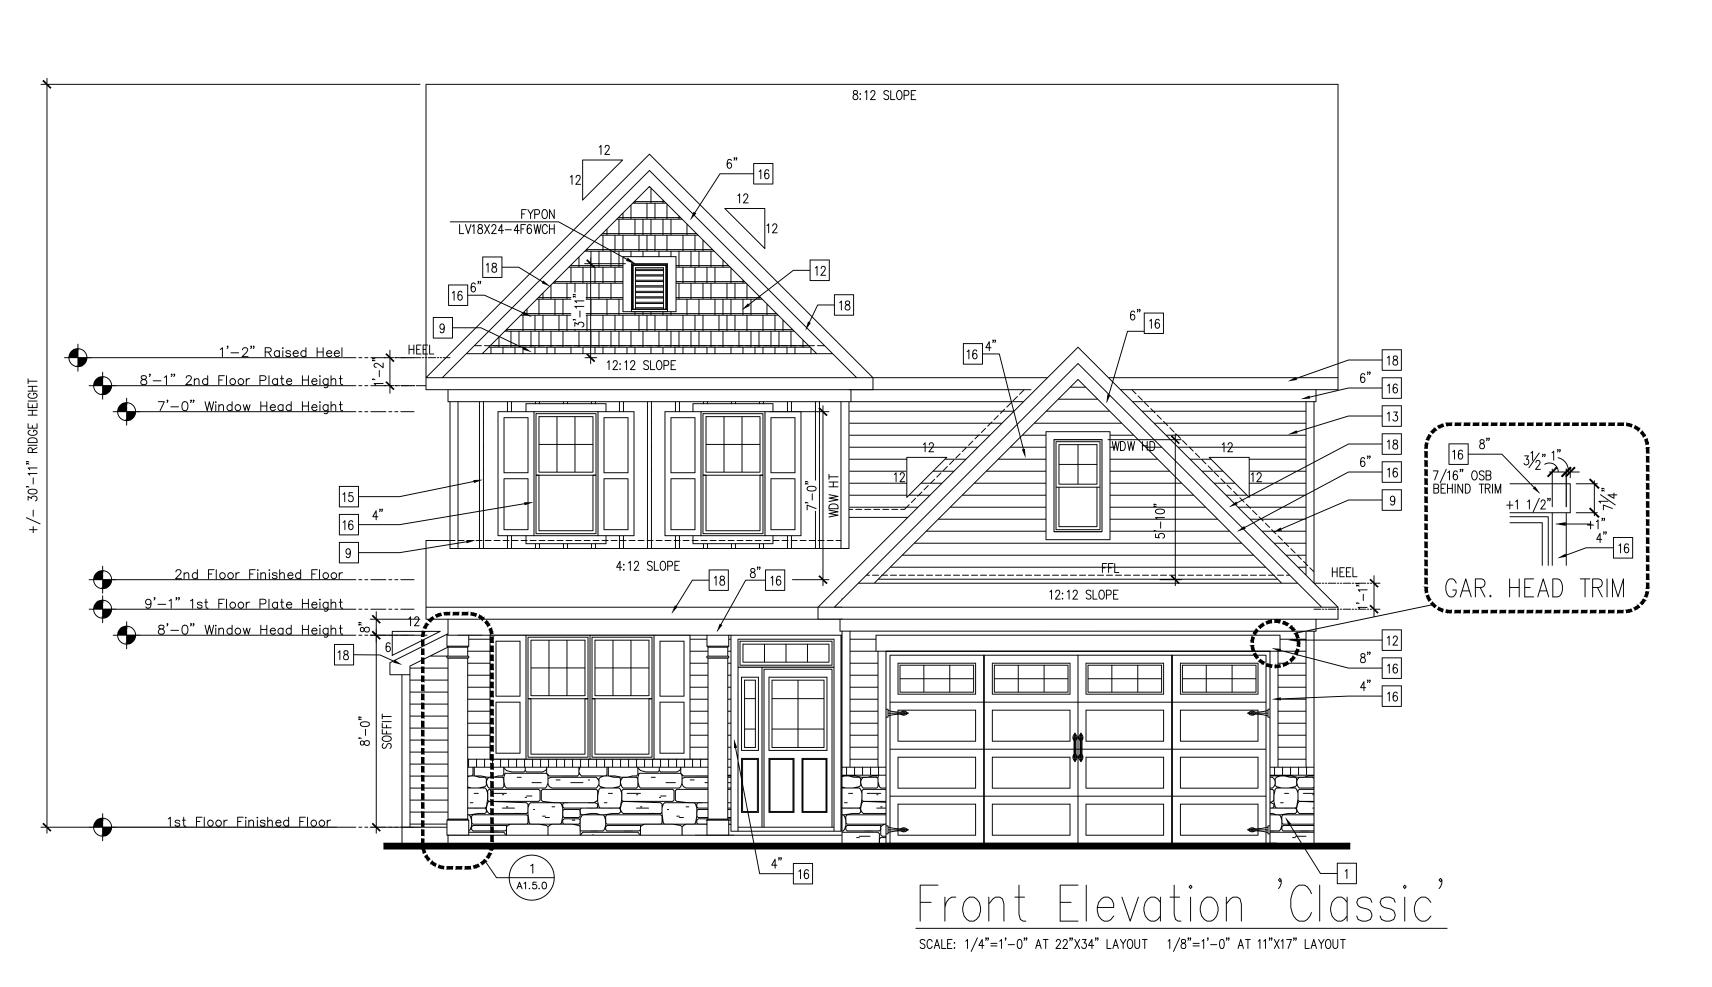
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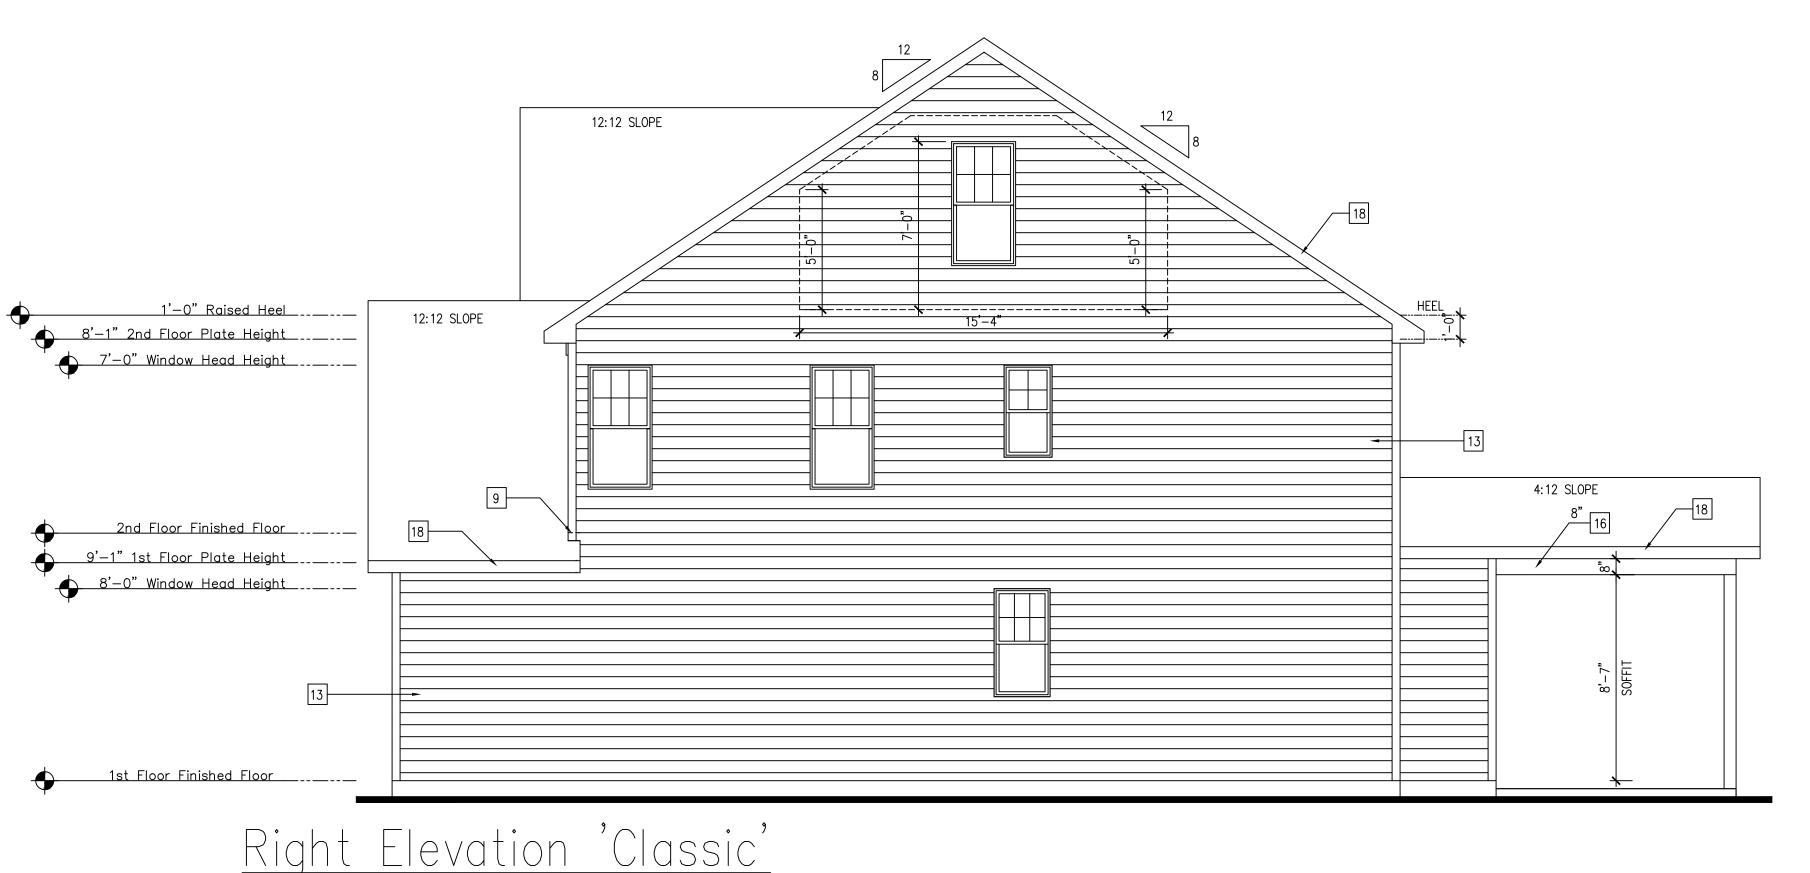
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SCALE: 1/4"=1'-0" AT 22"X34" LAYOUT 1/8"=1'-0" AT 11"X17" LAYOUT

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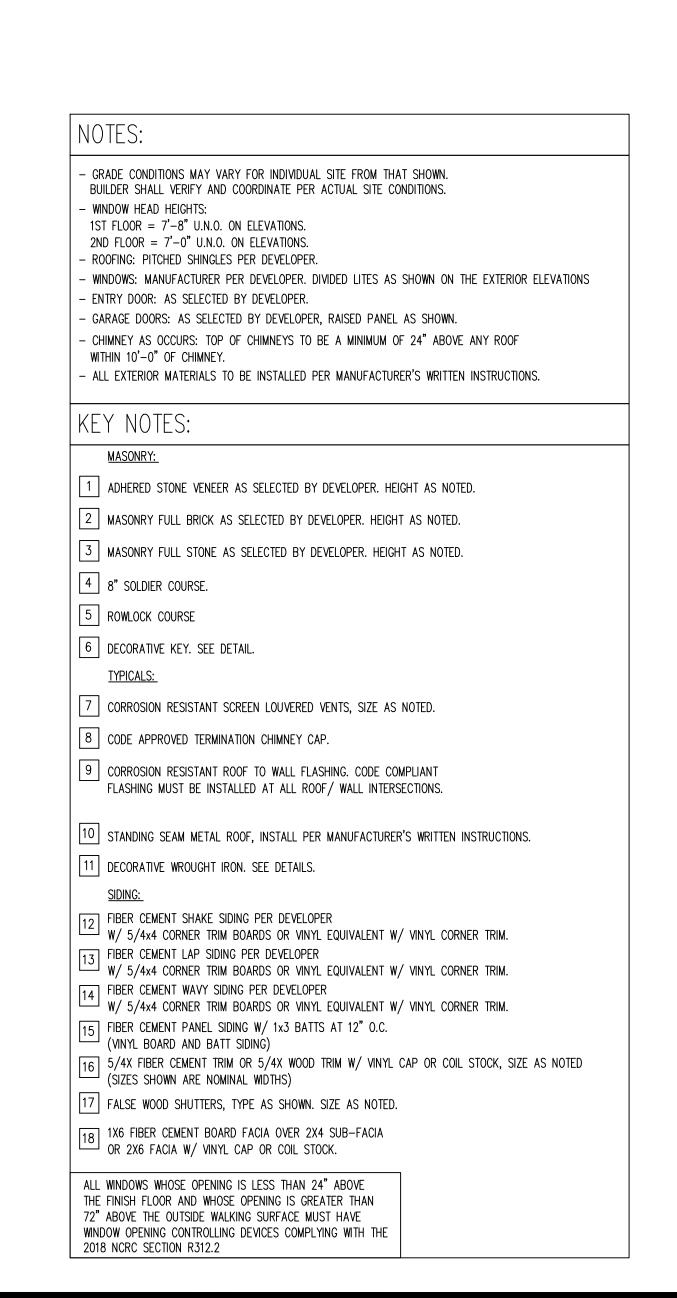
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NC ATTIC VENT CALC.: 1:150 RATIO

THE NET FREE VENTILATIONG ARA SHALL NOT BE LESS THAN 1/150 OF THE AREA OF THE SPACE VENTILATED, PROVIDED THAT AT LEAST 50 PERCENT AND NOT MORE THAN 80 PERCENT OF THE REQUIRED VENTILATING AREA IS PROVIDED BY VENTILATORS LOCATED IN THE UPPER PORTION OF THE SPACE TO BE VENTILATED AT LEAST 3 FEET ABOVE THE EAVE OR CORNICE VENTS WITH THE BALANCE OF THE REQUIRED VENTILATION PROVIDED BY EAVE OR CORNICE VENTS.

. EXCLOSED ATTIC/RAFTER SPACES REQUIRING LESS THAN 1 SQ FT OF VENTILATION MAY BE VENTED WITH CONTINUOUS SOFFIT VENTILATION ONLY.

2. ENCLOSED ATTIC/RAFTER SPACES OVER UNCONDITIONED SPACE MAY BE VENTED WITH CONTINUOUS SOFFIT VENT ONLY.

GENERAL CONTRACTOR SHALL VERIFY THE NET FREE VENTILATION OF THE VENT PRODUCT SELECTED BY OWNER. VERIFY WITH MANUFACTURER OF HIGH AND LOW VENTS TO BE USED FOR MINIMUM CALCULATED VENTS REQUIRED. THE REQUIRED VENTILATION SHALL BE MAINTAINED. PROVIDE INSULATION STOP SUCH THAT INSULATION DOES NOT OBSTRUCT FREE AIR MOVEMENT AS REQUIRED BY THE BUILDING OFFICIAL.

ALL OVERLAP FRAMED ROOF AREAS SHALL HAVE OPENINGS BETWEEN THE ADJACENT ATTICS IN THE ROOF SHEATHING (AS ALLOWED BY THE STRUCTURAL ENGINEER) TO ALLOW PASSAGE AND ATTIC VENTILATION BETWEEN THE TWO OR ISOLATED ATTIC SPACES SHALL BE VENTED INDEPENDENTLY.

PER DEVELOPER, AT ALL CANTILEVERED FLOORS, CANTILEVERED ARCHITECTURAL POP-OUTS, AND ANY DOUBLE FRAMING PROJECTIONS THAT ARE SEPARATED FROM THE VENTING CALCULATIONS SHOWN ABOVE, PROVIDE A CONTINUOUS 2" CORROSION RESISTANT SOFFIT VENT AT UNDERSIDE OF FRAMED ELEMENT.

(PER NCRC SECTION R806.2)

1 SQUARE INCH VENT FOR EVERY 150 SQUARE INCHES OF CEILING *144 SQ. IN. = 1 SQ. FT. BLDG. CEILING (SF) X 144 = BLDG (SQ. IN.) BLDG. (SQ. IN.) / 150 = SQ. IN. OF VENT REQUIRED SQ. IN. OF VENT REQUIRED / 2 = 50% AT HIGH & 50% AT LOW.

ROOF AREA 1: = 1409 SF

1409 SQ. FT. X 144 = 202896 SQ. IN. 202896 SQ. IN. / 150 = 1352.64 SQ. IN. OF VENT REQ'D 1352.64 SQ. IN. / 2 = 676.32 SQ. IN

676.32 SQ. IN. OF VENT AT HIGH & 676.32 SQ. IN. OF VENT AT LOW REQUIRED.

ROOF AREA 2: = 103 SF

103 SQ. FT. X 144 = 14832 SQ. IN. 14832 SQ. IN. / 150 = 98.88 SQ. IN. OF VENT REQ'D 98.88 SQ. IN. /2 = 49.44 SQ. IN

49.44 SQ. IN. OF VENT AT HIGH & 49.44 SQ. IN. OF VENT AT LOW REQUIRED.

ROOF AREA 3: = 214 SF

214 SQ. FT. X 144 = 30816 SQ. IN.

30816 SQ. IN. / 150 = 205.44 SQ. IN. OF VENT REQ'D 205.44 SQ. IN. / 2 = 102.72 SQ. IN

102.72 SQ. IN. OF VENT AT HIGH & 102.72 SQ. IN. OF VENT AT LOW REQUIRED.

ROOF AREA 4: = 247 SF

237.12 SQ. IN. / 2 = 118.56 SQ. IN

247 SQ. FT. X 144 = 35568 SQ. IN. 35568 SQ. IN. / 150 = 237.12 SQ. IN. OF VENT REQ'D

118.56 SQ. IN. OF VENT AT HIGH & 118.56 SQ. IN. OF VENT AT LOW REQUIRED.

ALL ROOF DRAINAGE SHALL BE PIPED TO STREET OR APPROVED

DRAINAGE FACILITY. - DASHED LINES INDICATE WALL BELOW.

- LOCATE GUTTER AND DOWNSPOUTS PER BUILDER. PITCHED ROOFS AS NOTED.

- TRUSS MANUFACTURER SHALL SUBMIT STRUCTURAL CALCS AND SHOP DRAWINGS TO THE BUILDER'S GENERAL CONTRACTOR AND BUILDING DEPARTMENT FOR REVIEW PRIOR TO FABRICATIONS. - ALL PLUMBING VENTS SHALL BE COMBINED INTO A MINIMUM AMOUNT OF ROOF PENETRATIONS. ALL ROOF PENETRATIONS SHALL OCCUR

NC ATTIC VENT CALC.: 1:300 RATIO

AS AN ALTERNATE TO THE 1/50 RATIO LISTED ABOVE, THE NET FREE CROSS-VENTILATION AREA MAY BE REDUCED TO 1/300 WHEN A CLASS I OR II VAPOR RETARDER IS INSTALLED ON THE WARM — IN — WINTER SIDE OF THE CEILING.

GENERAL CONTRACTOR SHALL VERIFY THE NET FREE VENTILATION OF THE VENT PRODUCT SELECTED BY OWNER.. VERIFY WITH MANUFACTURER OF HIGH AND LOW VENTS TO BE USED FOR MINIMUM CALCULATED VENTS REQUIRED. THE REQUIRED VENTILATION SHALL BE MAINTAINED. PROVIDE INSULATION STOP SLICH THAT INSULATION DOES NOT OBSTRUCT FREE AIR MOVEMENT AS REQUIRED BY THE BUILDING OFFICIAL.

ALL OVERLAP FRAMED ROOF AREAS SHALL HAVE OPENINGS BETWEEN THE ADJACENT ATTICS IN THE ROOF SHEATHING (AS ALLOWED BY THE STRUCTURAL ENGINEER) TO ALLOW PASSAGE AND ATTIC VENTILATION BETWEEN THE TWO OR ISOLATED ATTIC SPACES SHALL BE VENTED INDEPENDENTLY.

PER DEVELOPER, AT ALL CANTILEVERED FLOORS, CANTILEVERED ARCHITECTURAL POP-OUTS, AND ANY DOUBLE FRAMING PROJECTIONS THAT ARE SEPARATED FROM THE VENTING CALCULATIONS SHOWN ABOVE, PROVIDE A CONTINUOUS 2" CORROSION RESISTANT SOFFIT VENT AT UNDERSIDE OF FRAMED ELEMENT.

(PER NCRC SECTION R806.2)


TO THE REAR OF THE MAIN RIDGE.

1 SQUARE INCH VENT FOR EVERY 150 SQUARE INCHES OF CEILING *144 SQ. IN. = 1 SQ. FT. BLDG. CEILING (SF) X 144 = BLDG (SQ. IN.) BLDG. (SQ. IN.) $/ 30p_{4\overline{0}9}$ SQ. IN. OF VENT REQUIRED SQ. IN. OF VENT REQUIRED $\frac{1}{2} = 50\%$ AT HIGH & 50% AT LOW.

ROOF AREA 1:

1409 SQ. FT. X 144 = 202896 SQ. IN. 202896 SQ. IN. / 300 = 676.32 SQ. IN. OF VENT REQ'D676.32 SQ. IN. / 2 = 338.16 SQ. IN

338.16 SQ. IN. OF VENT AT HIGH & 338.16 SQ. IN. OF VENT AT LOW REQUIRED.

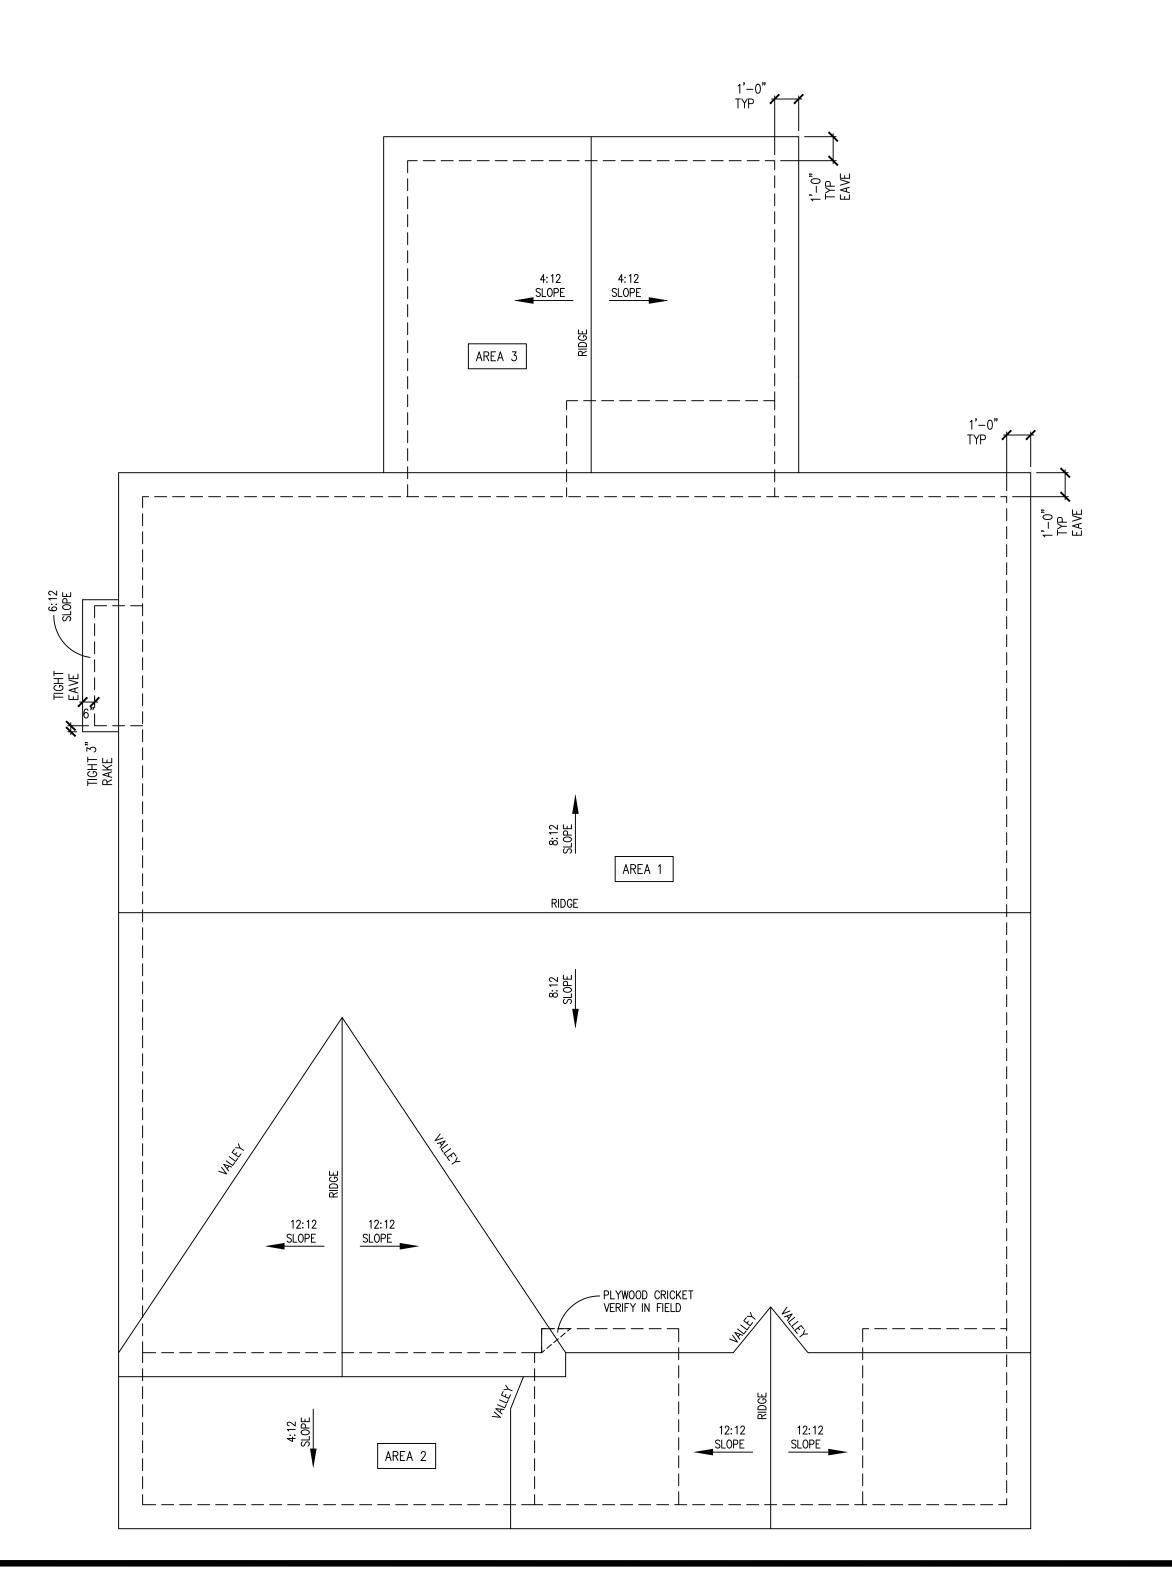



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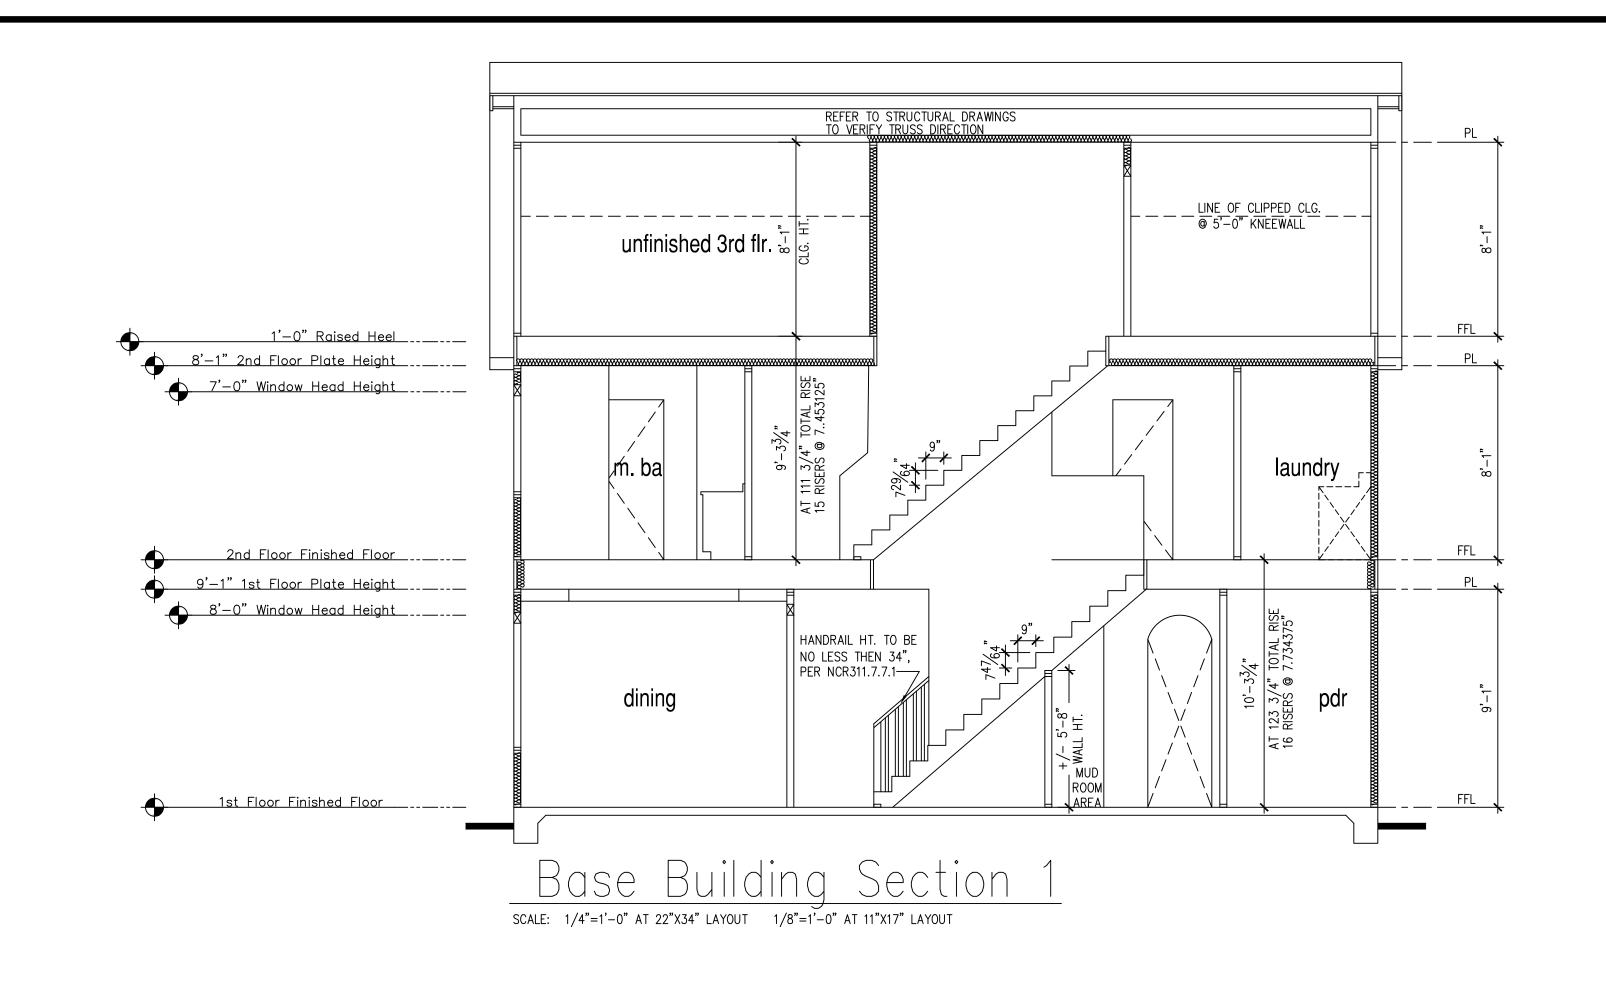
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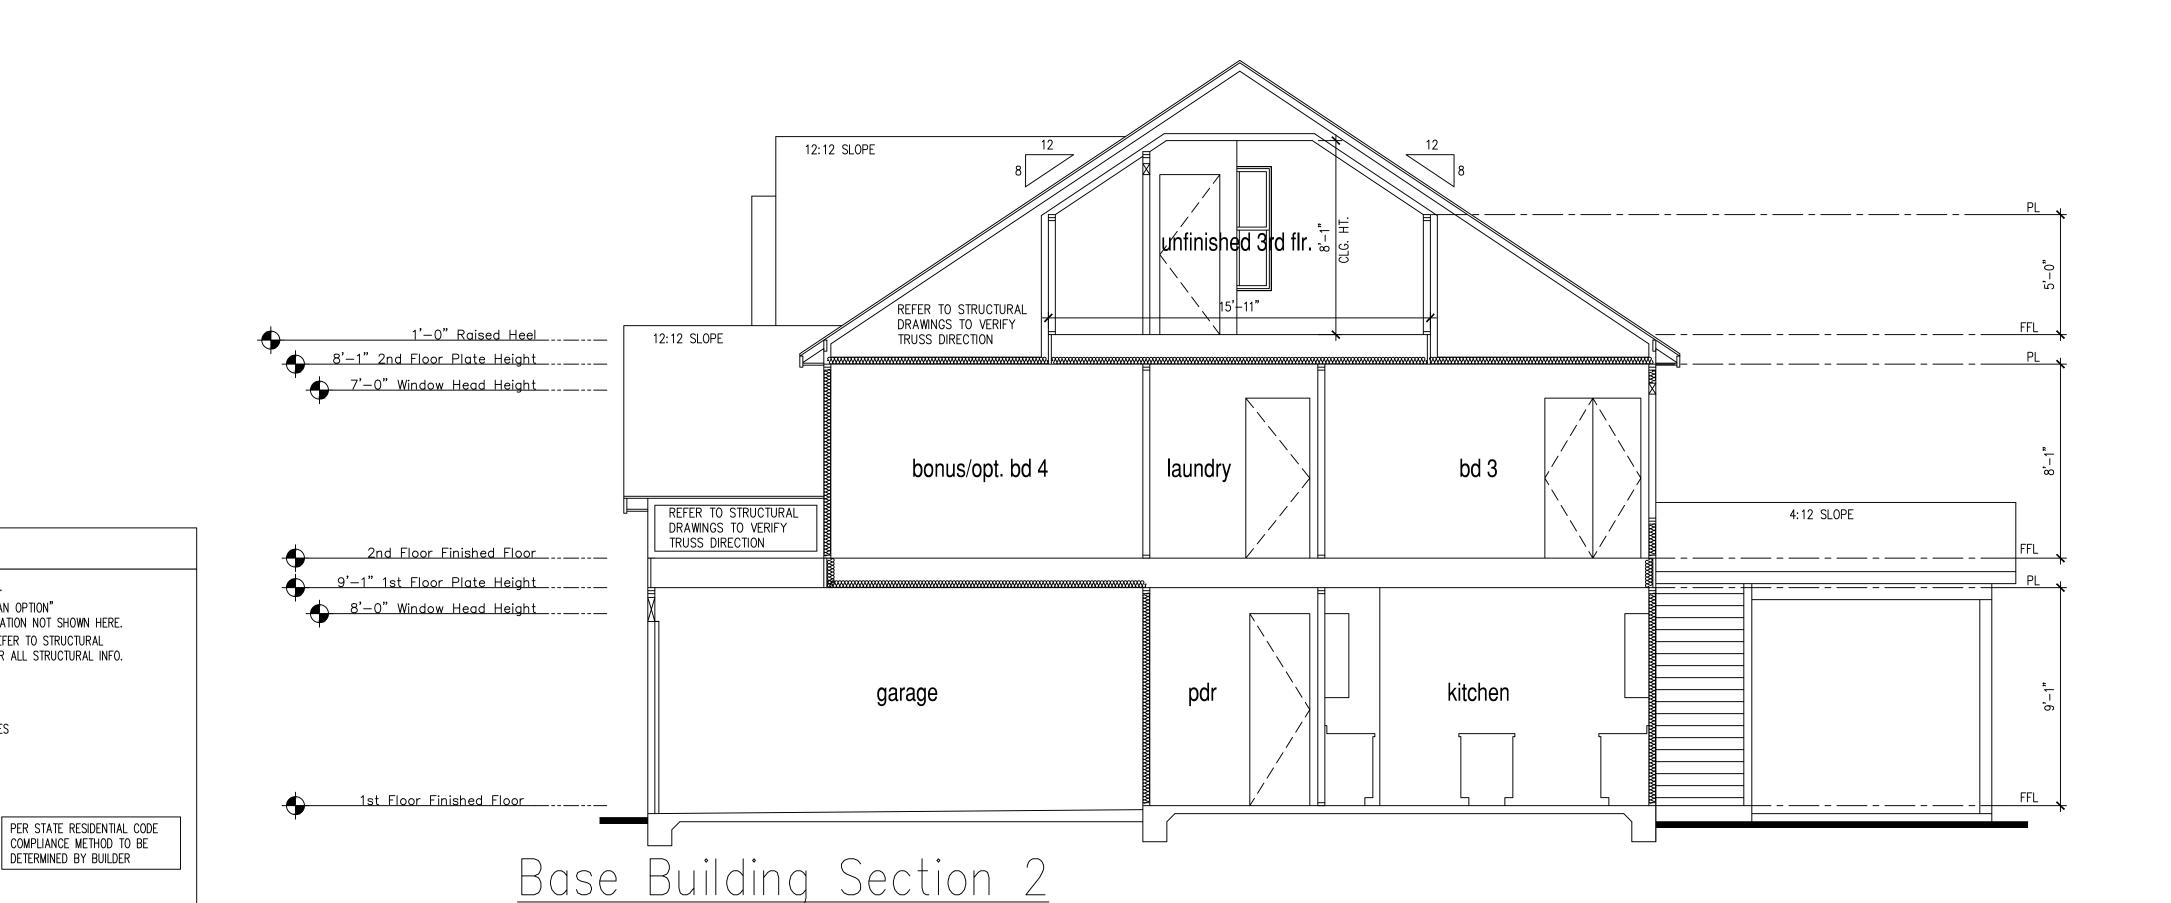
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SCALE: 1/4"=1'-0" AT 22"X34" LAYOUT 1/8"=1'-0" AT 11"X17" LAYOUT

9'-1" STAIR NOTE:
(USE 14" TJI WITH 3/4" PLYWOOD SUBFLOOR)
16 TREADS AT 10" EACH VERIFY
17 RISERS AT +/- 7.28" = 123 3/4" TOTAL
RISE VERIFY

NOTES:

- REFER TO FLOOR PLAN NOTES FOR TYPICAL FIRE PROTECTION NOTES AND LOCATIONS.
- THESE BUILDING SECTIONS MAY VARY AT ALTERNATE ELEVATION STYLES AND AT "PLAN OPTION" CONDITIONS. REFER TO MAIN FLOOR PLAN AND ALTERNATE FLOOR PLANS FOR INFORMATION NOT SHOWN HERE.
 BUILDING SECTIONS SHOWN HERE DEPICT VOLUMN SPACES WITHIN THE STRUCTURE. REFER TO STRUCTURAL DRAWINGS, TRUSS DRAWINGS, STRUCTURAL DETAILS AND CALCULATIONS BY OTHER FOR ALL STRUCTURAL INFO.
- ROOFING: PITCHED SHINGLE ROOF. REFER TO ROOF PLAN FOR TYPICLAS.
- WOOD FLOORS: FLOOR SHEATHING OVER FLOOR JOIST REFER TO STRUCTURAL AND TRUSS DRAWINGS BY OTHERS.
- VERIFY STAIRS MINIMUM AND MAXIMUM REQUIREMENTS FOR CONSTRUCTION CLEARANCES
- WITH LOCAL CODES.

 INSULATION:
- EXTERIOR WALLS ZONE 3: R-13 BATTS MINIMUM. VERIFY
 EXTERIOR WALLS ZONE 4: R-15 BATTS MINIMUM. VERIFY
 CELLING WITH ATTIC APOVE: P-38 BATTS MINIMUM. VERIFY
- CEILING WITH ATTIC ABOVE: R-38 BATTS MINIMUM. VERIFY

FLOOR OVER GARAGE: ATTIC KNEEWALL: R-19 BATTS MINIMUM. VERIFY R-19 BATTS MINIMUM. VERIFY

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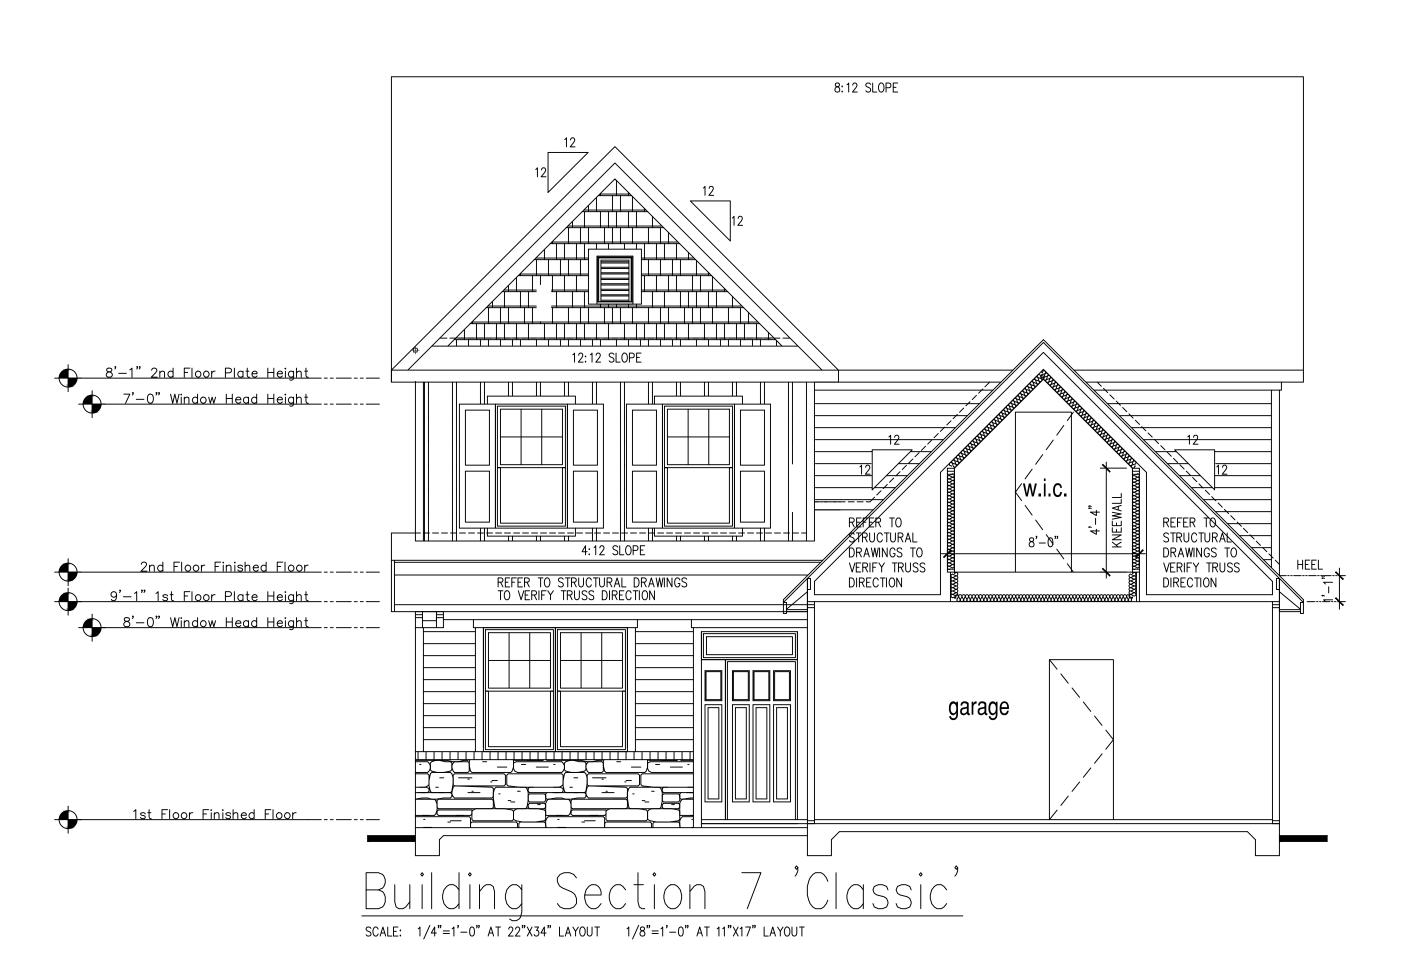
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9'-1" STAIR NOTE: (USE 14" TJI WITH 3/4" PLYWOOD SUBFLOOR) 16 TREADS AT 10" EACH VERIFY 17 RISERS AT +/- 7.28" = 123 3/4" TOTAL RISE VERIFY

NOTES:

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- INSULATION: EXTERIOR WALLS ZONE 3: R-13 BATTS MINIMUM. VERIFY EXTERIOR WALLS ZONE 4: R-15 BATTS MINIMUM. VERIFY

CEILING WITH ATTIC ABOVE: R-38 BATTS MINIMUM. VERIFY

FLOOR OVER GARAGE: ATTIC KNEEWALL:

R-19 BATTS MINIMUM. VERIFY R-19 BATTS MINIMUM. VERIFY PER STATE RESIDENTIAL CODE COMPLIANCE METHOD TO BE DETERMINED BY BUILDER

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- FOR ADDITIONAL NOTES SEE GENERAL NOTES ON TITLE SHEET AND DETAILS.
- WINDOW HEAD HEIGHTS:

1ST FLOOR = 7'-8" U.N.O. ON ELEVATIONS.

2ND FLOOR = 7'-0" U.N.O. ON ELEVATIONS.

ALL DIMENSIONS TO WINDOWS AND DOORS ARE TO CENTERLINE.

WALL LEGEND:

FULL HEIGHT 2X4 WOOD STUD PARTITION FULL HEIGHT
2X6 WOOD STUD PARTITION

BRICK / STONE VENEER

STUD WALL BELOW HEIGHT AND STUD SIZE AS NOTED

LOW GYPSUM BOARD WALL
HEIGHT AND STUD SIZE AS NOTED

DRYWALL OPENING. HEIGHT AS NOTED ON PLAN.

KEY NOTES FOR NORTH CAROLINA:

FIRE PROTECTION:

- HOUSE TO GARAGE FIRE SEPARATION. GARAGE/ HOUSE SEPARATION AT VERTICAL SURFACES SHALL BE PROTECTED WITH ONE (1) LAYER 1/2" GYPSUM BOARD.

 GARAGE/ HOUSE SEPARATION AT HORIZONTIAL SURFACES SHALL BE PROTECTED WITH ONE (1) LAYER 5/8" TYPE 'X' GYPSUM BOARD.
- 2 HOUSE TO GARAGE DOOR SEPARATION. PROVIDE 1-3/8" SOLID CORE DOOR OR APPROVED 20 MINUTE
- BENEATH STAIRS AND LANDINGS. 1/2" GYPSUM BOARD ON WALLS AND CEILING OF ENCLOSED ACCESSIBLE AREAS

MEP'S

- GAS WATER HEATER ON 18" HIGH PLATFORM.
- 5 FAU 8'X12' PLATFORM. VERIFY WITH TRUSS MANUFACTURER
- 6 A/C CONDENSER PAD. (VERIFY)
- PRE-FABRICATED METAL FIREPLACE.
- INSTALL PER MANUFACTURER'S WRITTEN INSTRUCTIONS.
- 8 ATTIC ACCESS LARGE ENOUGH TO REMOVE LARGEST PIECE
 OF EQUIPMENT BUT NOT LESS THEN 30"x20". FIRE RATED
 ACCESS AS NOTED. (PER NCRC SECTION R807.)
 ATTIC ACCESS LADDER, VERIFY LOCATION AND SIZE WITH TRUSSES.
 (25 1/2" X 54" SIZE.)
 TYPICALS:
- 9 TEMPERED SAFETY GLASS.
- 10 PLYWOOD SHELF ABOVE WITH DRYWALL FINISH OVER. HEIGHT AS NOTED.
- 11 HALF WALL, HEIGHT AS NOTED.
- 12 INTERIOR SOFFITS: FFL = 8'-1" U.N.O. SFL = 7'-6" U.N.O.

BATHS:

- 13 SHOWER. TEMPERED GLASS ENCLOSURE.
- 14 TUB-SHOWER COMBO. TEMPERED GLASS ENCLOSURE.
- 15 CERAMIC TILE SHOWER AND FLOOR. TEMPERED GLASS ENCLOSURE.
- 16 42"x60" ACRYLIC TUB W/ CERAMIC PLATFORM

KITCHEN:

- 30" SLIDE-IN ELECTRICAL RANGE W/ HOOD AND MICRO ABV. VENT PER MANUFACTURER'S WRITTEN INSTRUCTIONS.
- 18 36" GAS COOKTOP AND HOOD.
- VENT PER MANUFACTURER'S WRITTEN INSTRUCTIONS.
- 19 ELECTRIC OVEN WITH MICROWAVE OVEN.


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(USE 14" TJI WITH 3/4" PLYWOOD SUBFLOOR)

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RISE VERIFY



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WALL LEGEND:

FULL HEIGHT 2X4 WOOD STUD PARTITION *TITITIL* FULL HEIGHT 2X6 WOOD STUD PARTITION

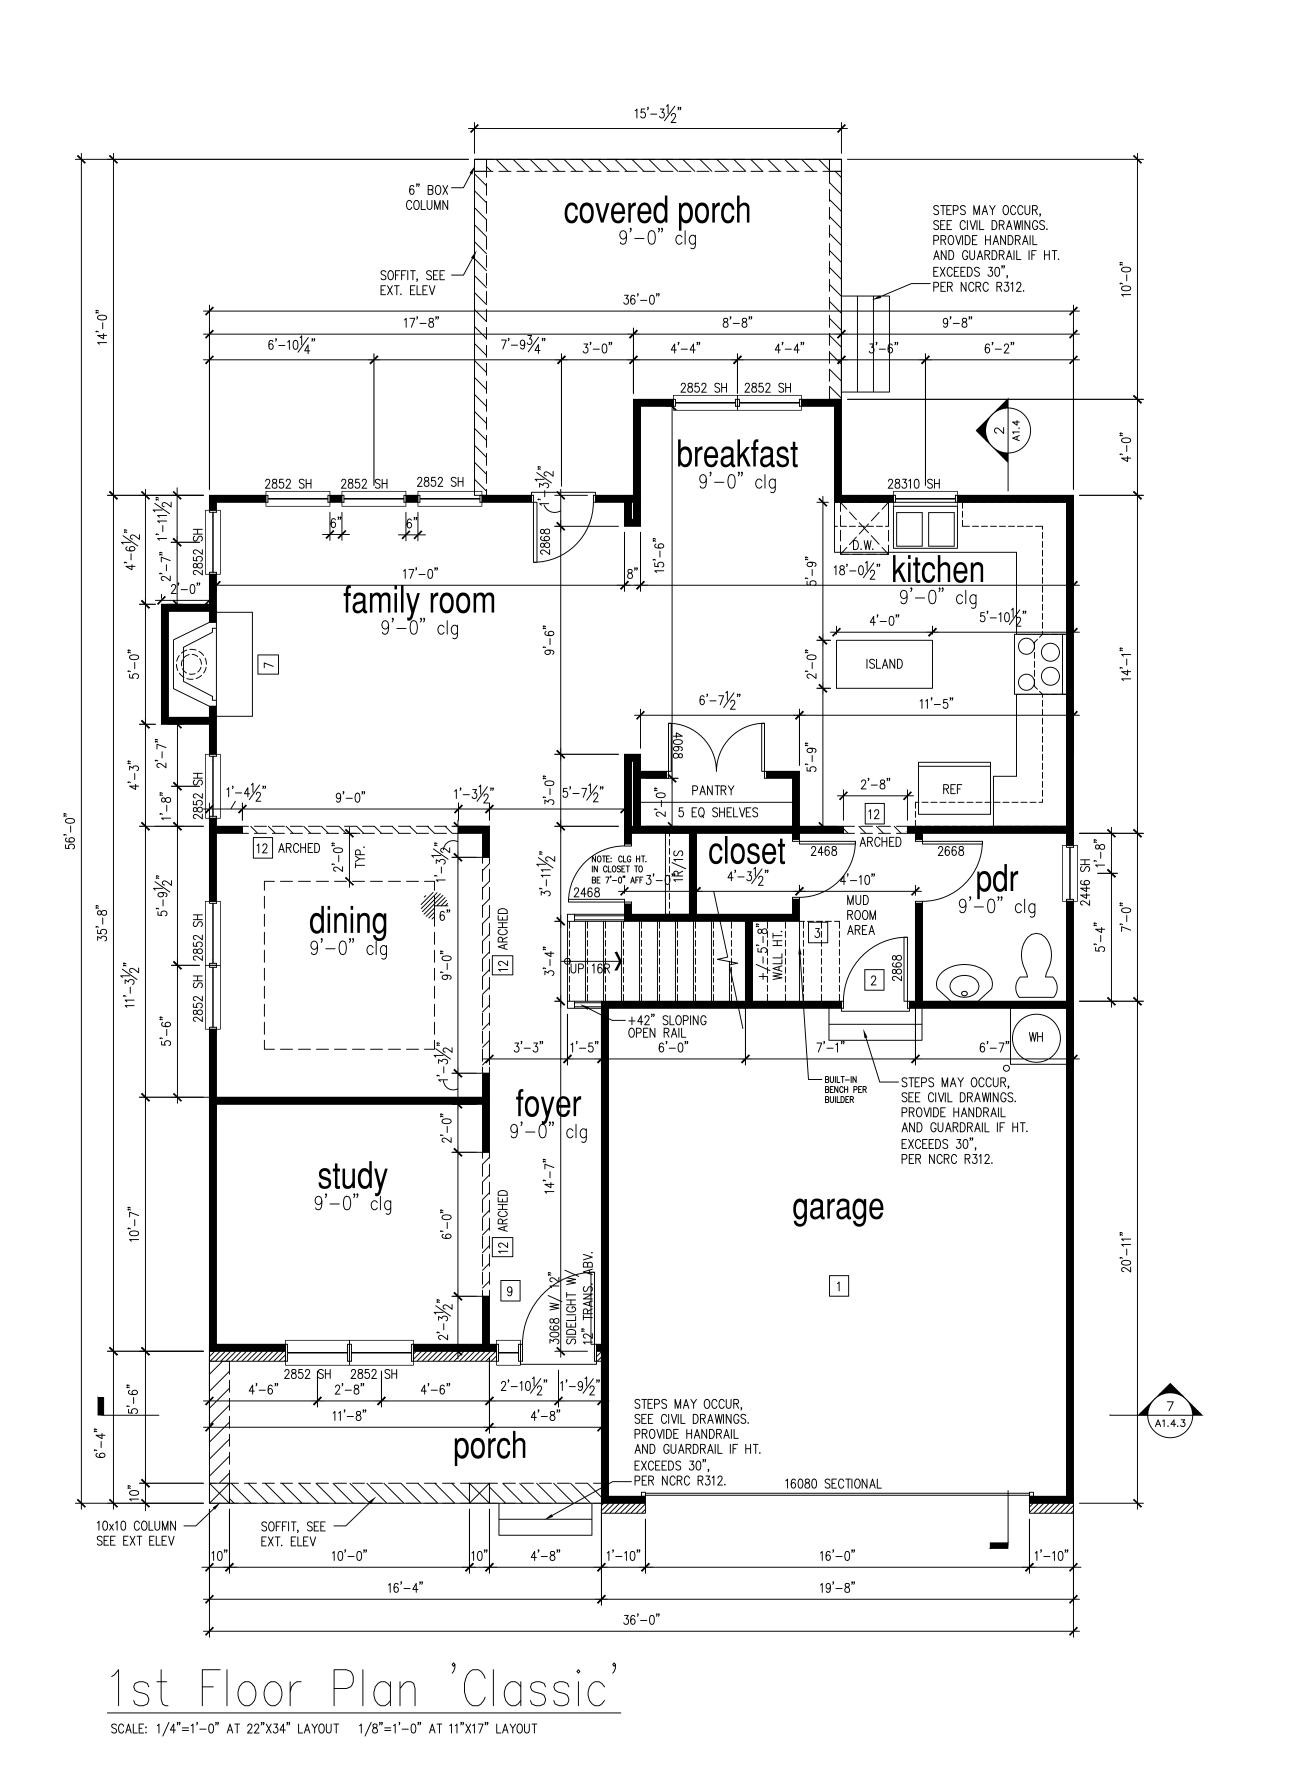BRICK / STONE VENEER

STUD WALL BELOW

LOW GYPSUM BOARD WALL

HEIGHT AND STUD SIZE AS NOTED

HEIGHT AND STUD SIZE AS NOTED DRYWALL OPENING. HEIGHT AS NOTED ON PLAN.

KEY NOTES FOR NORTH CAROLINA:

FIRE PROTECTION:

- 1 HOUSE TO GARAGE FIRE SEPARATION. GARAGE/ HOUSE SEPARATION AT VERTICAL SURFACES SHALL BE PROTECTED WITH ONE (1) LAYER 1/2" GYPSUM BOARD. GARAGE/ HOUSE SEPARATION AT HORIZONTIAL SURFACES SHALL BE PROTECTED WITH ONE (1) LAYER 5/8" TYPE 'X' GYPSUM BOARD.
- 2 HOUSE TO GARAGE DOOR SEPARATION. PROVIDE 1-3/8" SOLID CORE DOOR OR APPROVED 20 MINUTE
- BENEATH STAIRS AND LANDINGS. 1/2" GYPSUM BOARD ON WALLS AND CEILING OF ENCLOSED ACCESSIBLE


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- 6 A/C CONDENSER PAD. (VERIFY)
- PRE-FABRICATED METAL FIREPLACE.
- INSTALL PER MANUFACTURER'S WRITTEN INSTRUCTIONS.
- 8 ATTIC ACCESS LARGE ENOUGH TO REMOVE LARGEST PIECE OF EQUIPMENT BUT NOT LESS THEN 30"x20". FIRE RATED ACCESS AS NOTED. (PER NCRC SECTION R807.) ATTIC ACCESS LADDÈR, VERIFY LOCATION AND SIZE WITH TRUSSES. (25 1/2" X 54" SIZE.) TYPICALS:
- 9 TEMPERED SAFETY GLASS.
- 10 PLYWOOD SHELF ABOVE WITH DRYWALL FINISH OVER. HEIGHT AS NOTED.
- | 11 | HALF WALL, HEIGHT AS NOTED.
- 12 INTERIOR SOFFITS: FFL = 8'-1" U.N.O. SFL = 7'-6" U.N.O.

- 13 SHOWER. TEMPERED GLASS ENCLOSURE.
- 14 TUB-SHOWER COMBO. TEMPERED GLASS ENCLOSURE.
- 15 CERAMIC TILE SHOWER AND FLOOR. TEMPERED GLASS ENCLOSURE.
- 16 42"x60" ACRYLIC TUB W/ CERAMIC PLATFORM

- [17] 30" SLIDE-IN ELECTRICAL RANGE W/ HOOD AND MICRO ABV. VENT PER MANUFACTURER'S WRITTEN INSTRUCTIONS.
- 18 36" GAS COOKTOP AND HOOD.
 VENT PER MANUFACTURER'S WRITTEN INSTRUCTIONS.
- 19 ELECTRIC OVEN WITH MICROWAVE OVEN.

'THE NELSO	N'SF
AREA	CLASSIC
1st FLOOR	1052 SF
2nd FLOOR	1281 SF
TOTAL LIVING	2333 SF
UNFINISHED 3rd FLOOR	573 SF
GARAGE	401 SF
COV PORCH	401 SF

9'-1" STAIR NOTE:
(USE 14" TJI WITH 3/4" PLYWOOD SUBFLOOR)
16 TREADS AT 10" EACH VERIFY
17 RISERS AT +/- 7.28" = 123 3/4" TOTAL RISE VERIFY

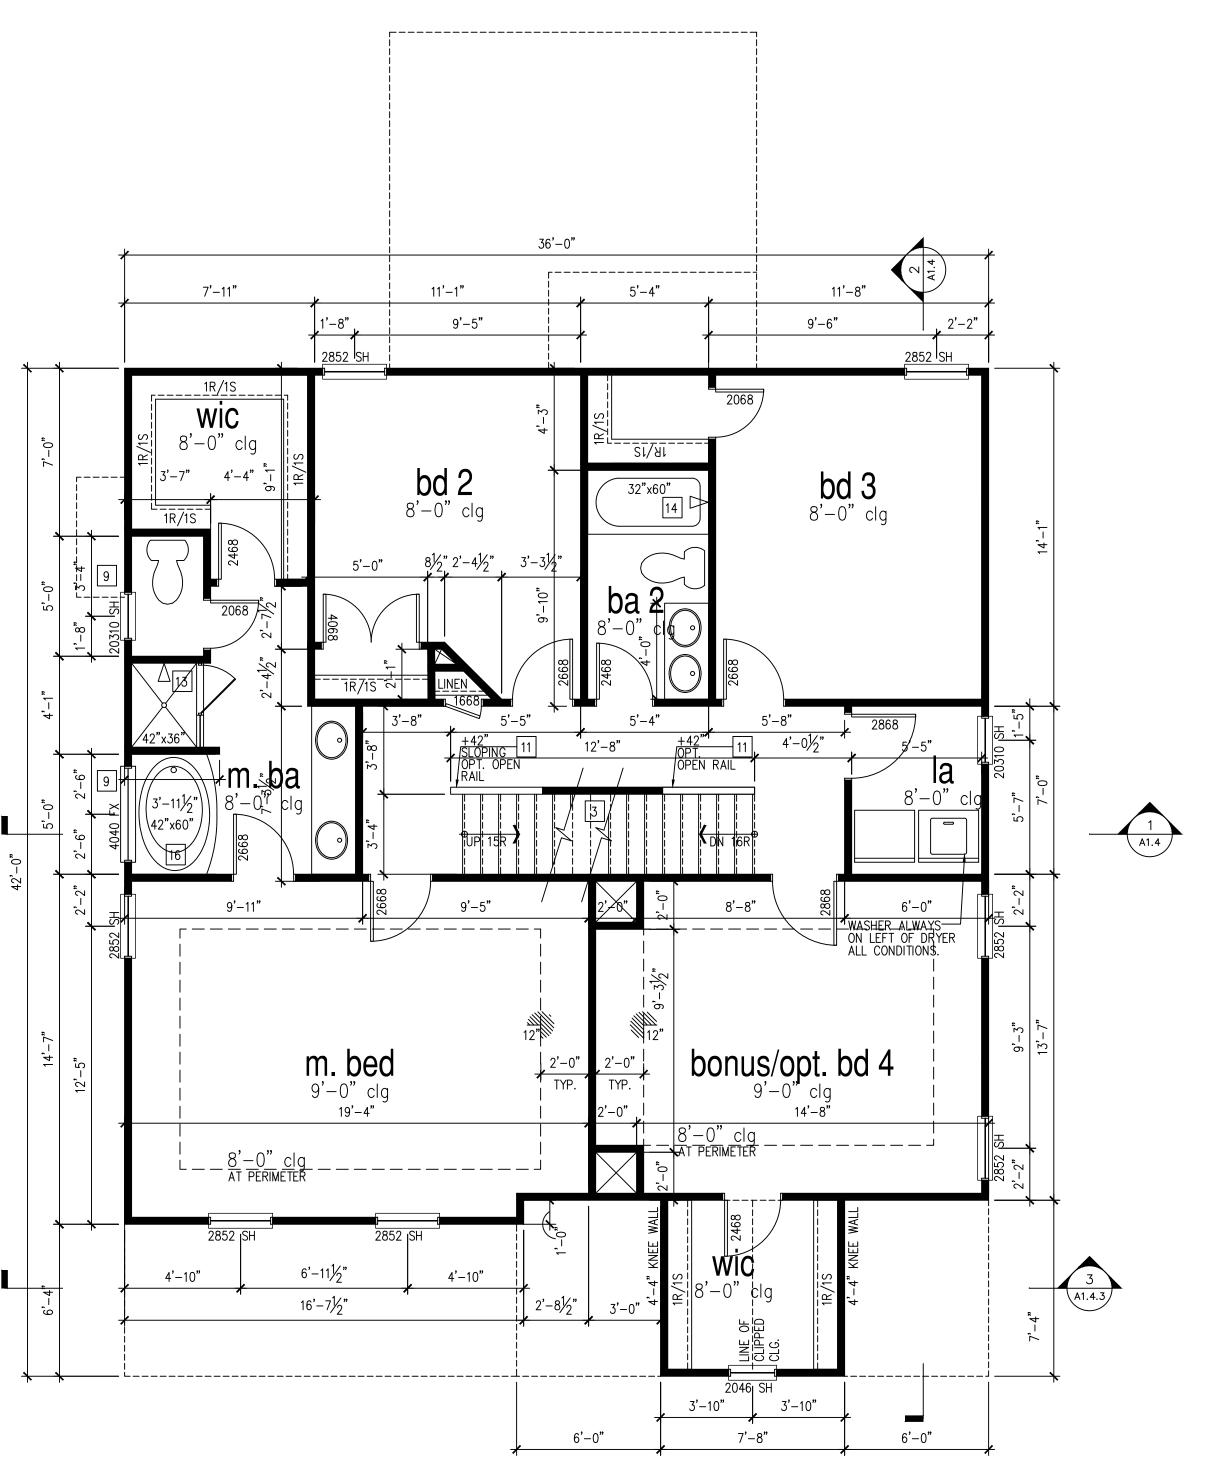

2nd Floor Plan 'Classic' SCALE: 1/4"=1'-0" AT 22"X34" LAYOUT 1/8"=1'-0" AT 11"X17" LAYOUT

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Garage

- FOR ADDITIONAL NOTES SEE GENERAL NOTES ON TITLE SHEET AND DETAILS. - WINDOW HEAD HEIGHTS: 1ST FLOOR = 7'-8" U.N.O. ON ELEVATIONS. 2ND FLOOR = 7'-0" U.N.O. ON ELEVATIONS. ALL DIMENSIONS TO WINDOWS AND DOORS ARE TO CENTERLINE.

WALL LEGEND:

FULL HEIGHT 2X4 WOOD STUD PARTITION

7////// FULL HEIGHT 2X6 WOOD STUD PARTITION

BRICK / STONE VENEER

STUD WALL BELOW HEIGHT AND STUD SIZE AS NOTED

LOW GYPSUM BOARD WALL HEIGHT AND STUD SIZE AS NOTED

DRYWALL OPENING. HEIGHT AS NOTED ON PLAN.

KEY NOTES FOR NORTH CAROLINA:

FIRE PROTECTION:

- 1 HOUSE TO GARAGE FIRE SEPARATION. GARAGE/ HOUSE SEPARATION AT VERTICAL SURFACES SHALL BE PROTECTED WITH ONE (1) LAYER 1/2" GYPSUM BOARD. GARAGE/ HOUSE SEPARATION AT HORIZONTIAL SURFACES SHALL BE PROTECTED WITH ONE (1) LAYER 5/8" TYPE 'X' GYPSUM BOARD.
- 2 HOUSE TO GARAGE DOOR SEPARATION. PROVIDE 1-3/8" SOLID CORE DOOR OR APPROVED 20 MINUTE
- BENEATH STAIRS AND LANDINGS. 1/2" GYPSUM BOARD ON WALLS AND CEILING OF ENCLOSED ACCESSIBLE


- GAS WATER HEATER ON 18" HIGH PLATFORM.
- 5 | FAU 8'X12' PLATFORM. VERIFY WITH TRUSS MANUFACTURER
- 6 A/C CONDENSER PAD. (VERIFY)
- PRE-FABRICATED METAL FIREPLACE.
- install per manufacturer's written instructions.
- 8 ATTIC ACCESS LARGE ENOUGH TO REMOVE LARGEST PIECE OF EQUIPMENT BUT NOT LESS THEN 30"x20". FIRE RATED ACCESS AS NOTED. (PER NCRC SECTION R807.) ATTIC ACCESS LADDÈR, VERIFY LOCATION AND SIZE WITH TRUSSES. (25 1/2" X 54" SIZE.) TYPICALS:
- 9 TEMPERED SAFETY GLASS.
- 10 PLYWOOD SHELF ABOVE WITH DRYWALL FINISH OVER. HEIGHT AS NOTED.
- 11 HALF WALL, HEIGHT AS NOTED.
- 12 INTERIOR SOFFITS: FFL = 8'-1" U.N.O. SFL = 7'-6" U.N.O.

- 13 SHOWER. TEMPERED GLASS ENCLOSURE.
- 14 TUB-SHOWER COMBO. TEMPERED GLASS ENCLOSURE.
- 15 CERAMIC TILE SHOWER AND FLOOR. TEMPERED GLASS ENCLOSURE.
- 16 42"x60" ACRYLIC TUB W/ CERAMIC PLATFORM

- [17] 30" SLIDE-IN ELECTRICAL RANGE W/ HOOD AND MICRO ABV. VENT PER MANUFACTURER'S WRITTEN INSTRUCTIONS.
- 18 36" GAS COOKTOP AND HOOD.
 VENT PER MANUFACTURER'S WRITTEN INSTRUCTIONS.
- 19 ELECTRIC OVEN WITH MICROWAVE OVEN.

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TOTAL LIVING	2333 SF
UNFINISHED 3rd FLOOR	573 SF
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9'-1" STAIR NOTE:
(USE 14" TJI WITH 3/4" PLYWOOD SUBFLOOR)
16 TREADS AT 10" EACH VERIFY
17 RISERS AT +/- 7.28" = 123 3/4" TOTAL RISE VERIFY

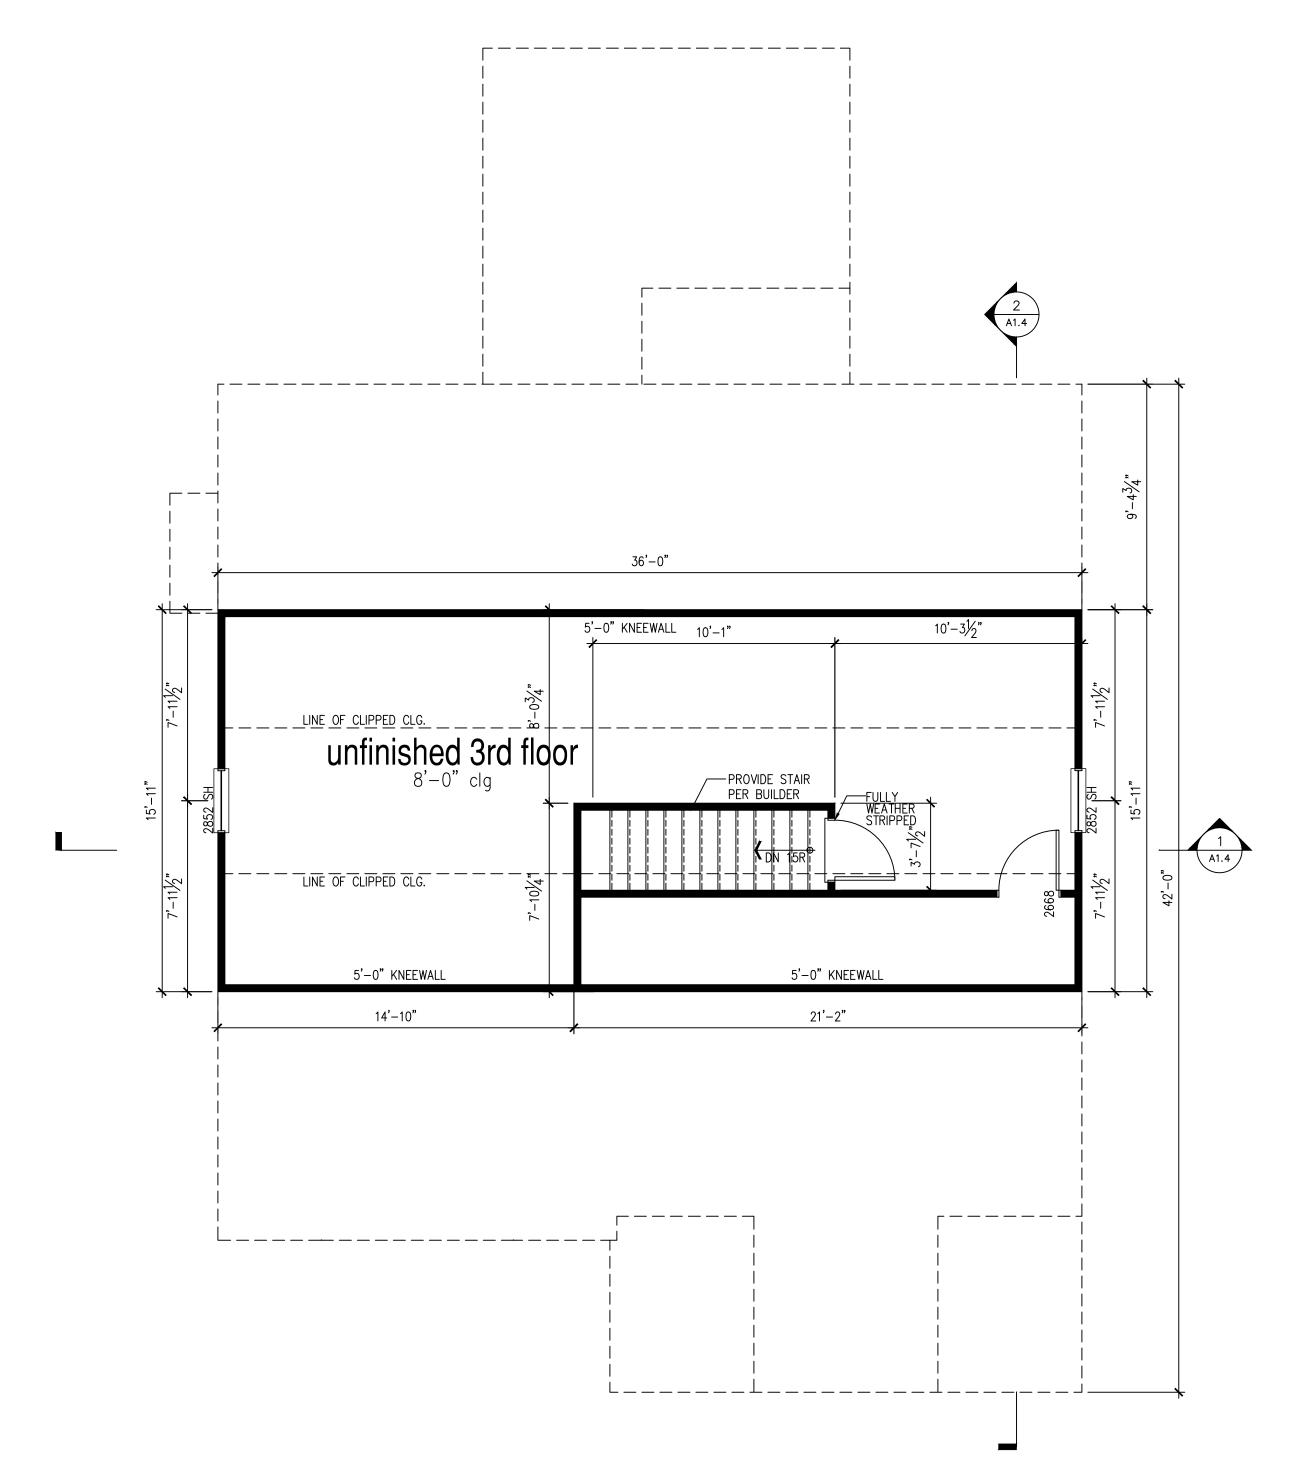

3rd Floor Plan 'Classic' SCALE: 1/4"=1'-0" AT 22"X34" LAYOUT 1/8"=1'-0" AT 11"X17" LAYOUT

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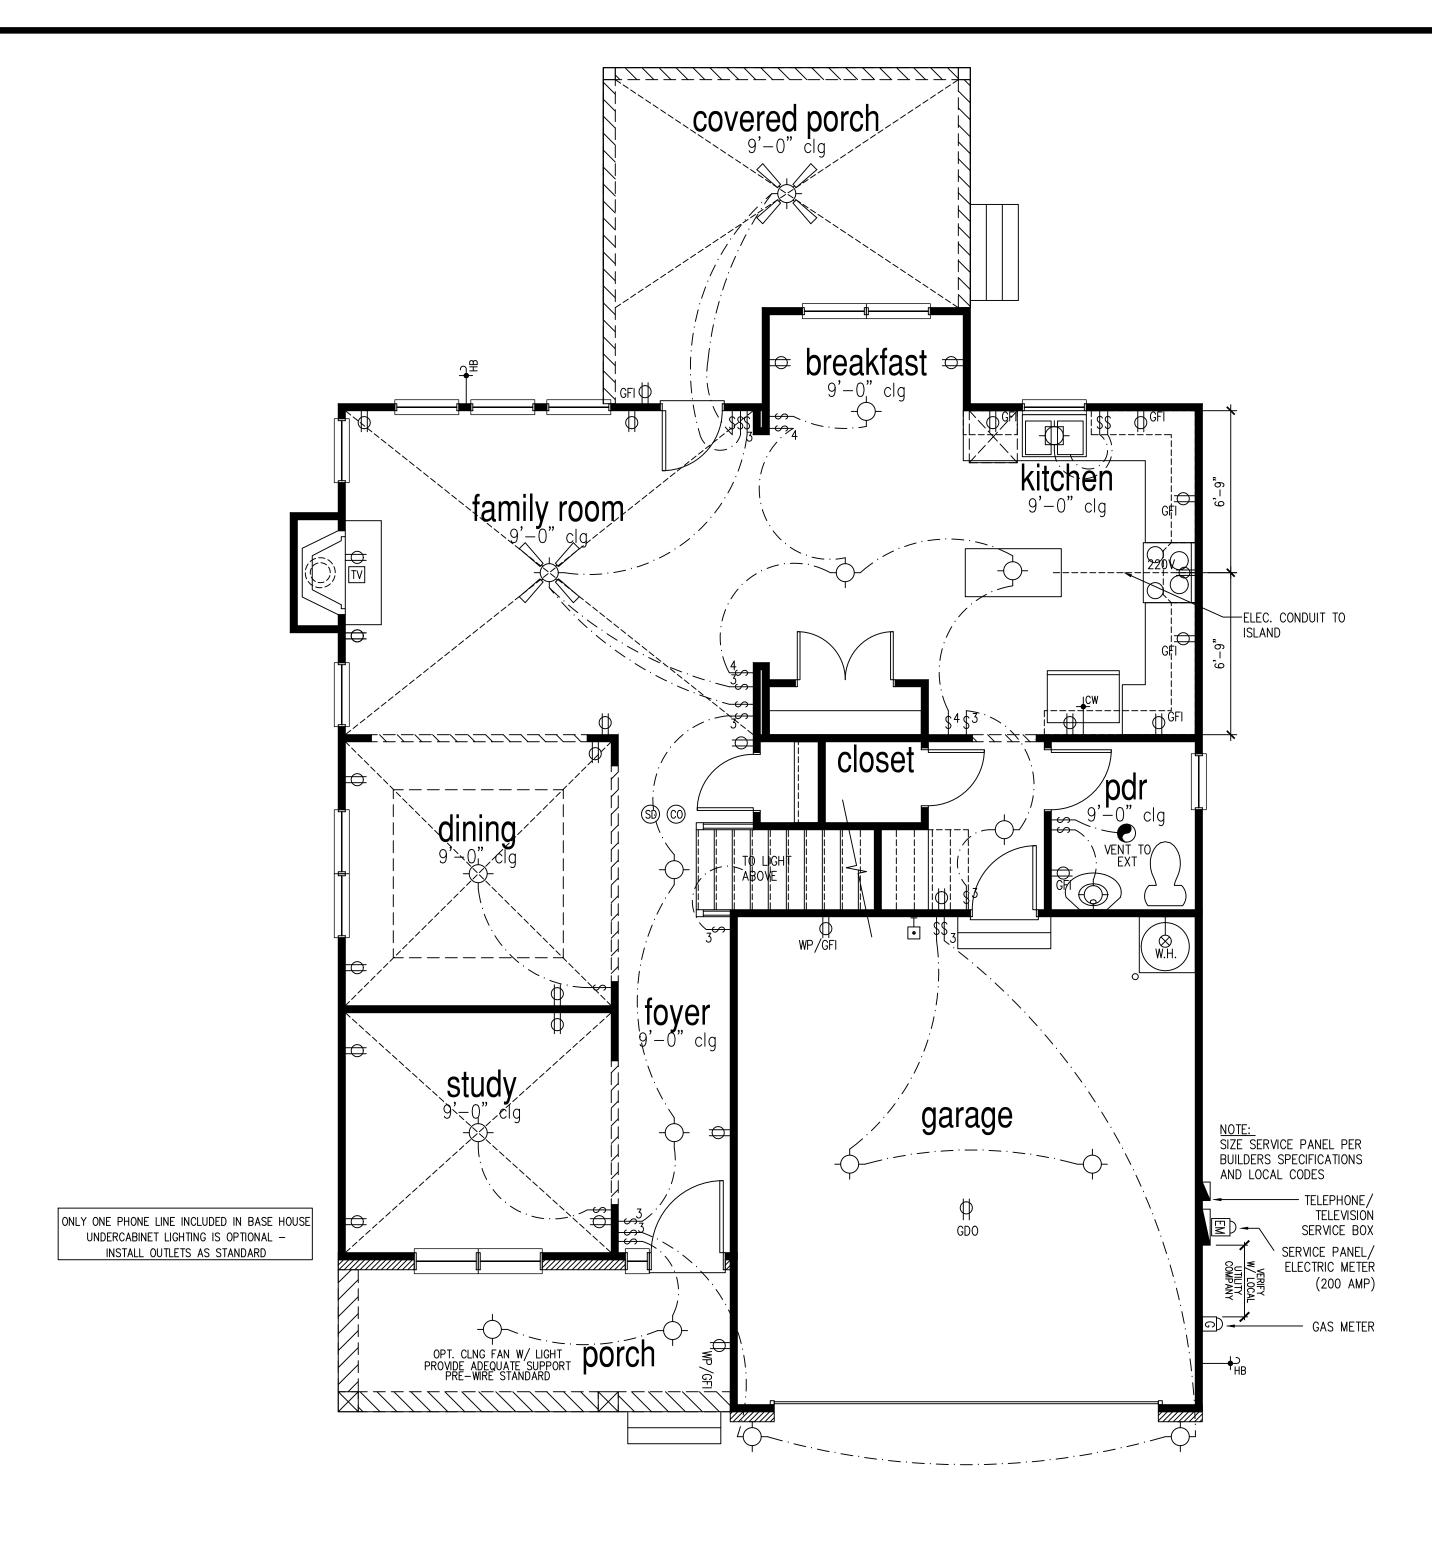
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1st Floor Plan 'Classic' SCALE: 1/4"=1'-0" AT 22"X34" LAYOUT 1/8"=1'-0" AT 11"X17" LAYOUT

NOTES:	LEGEND:			
PROVIDE GROUNDING ELECTRICAL ROD PER LOCAL CODES.	DUPLEX OUTLET	-CEILING MOUNTED INCANDESCENT LIGHT FIXTURE	CH CHIMES	CEILING FAN
PROVIDE AND INSTALL ARC FAULT CIRCUIT—INTERRUPTERS (AFCI) AS REQUIRED BY NATIONAL ELECTRICAL CODE (NEC) AND MEETING THE REQUIREMENTS OF ALL GOVERNING CODES.	WP/GFI WEATHERPROOF GFI DUPLEX OUTLET	WALL MOUNTED INCANDESCENT LIGHT FIXTURE	PUSHBUTION SWITCH	(PROVIDE ADEQUATE SUPPORT)
ALL EXHAUST FANS SHALL HAVE BACKDRAFT DAMPERS.	GROUND-FAULT CIRCUIT-INTERRUPTER DUPLEX OUTLET		(SD) IIOV SMOKE SETECTOR W/ BATTERY BACKUP	CELLING FAN WITH INCANDESCENT LIGHT FIVEID
- FAN/LIGHTS IN WET/DAMP LOCATIONS SHALL BE LABLED "SUITABLE FOR WET OR DAMP LOCATIONS."	The policies contains			()_ CEILING FAIN WITH INCANDESCENT LIGHT FIXTOR
ELECTRICAL SYSTEMS ARE SHOWN FOR INTENT ONLY. THESE SYSTEMS SHALL BE ENGINEERED BY OTHERS. THE CONTRACTOR SHALL BE RESPONSIBLE FOR PROPER INSTALLATION AND PLACEMENT.	HALF-SWITCHED DUPLEX OUTLET	EXHAUST FAN (VENT TO EXTERIOR)	© CO2 DETECTOR	(PROVIDE ADEQUATE SUPPORT)
	⇒ ^{220V} 220 VOLT OUTLET	EXHAUST FAN/LIGHT COMBINATION (VENT TO EXTERIOR)	T) THERMOSTAT	⊢──⊗ GAS SUPPLY WITH VALVE
PROVIDE AND INSTALL LOCALLY CERTIFIED SMOKE DETECTORS AND CO2 DETECTORS AS REQUIRED BY NATIONAL FIRE PROTECTION ASSOCIATION (NFPA) AND MEETING THE REQUIREMENTS OF ALL GOVERNING CODES.	J REINFORCED JUNCTION BOX	FLUORESCENT LIGHT FIXTURE	PH TELEPHONE	——♦D HOSE BIBB
PROVIDE AND INSTALL GROUND FAULT CIRCUIT-INTERRUPTERS (GFI) AS REQUIRED BY NATIONAL ELECTRICAL	NEITH GROED CONGINENT BOX	TEGOREGOEIN EIGHT TIXTORE		THB 1103E BIBB
CODE (NEC) AND MEETING THE REQUIREMENTS OF ALL GOVERNING CODES.	\$ WALL SWITCH	TECH HUB SYSTEM	TV TELEVISION	
- ELECTRICAL CONTRACTOR TO PROVIDE REQUIRED DIRECT HOOK-UPS/CUTOFFS.				
HVAC CONTRACTOR TO VERIFY THERMOSTAT LOCATIONS.	\$, THREE-WAY SWITCH		ELECTRIC METER	WALL SCONCE
ALL ELECTRICAL AND MECHANICAL EQUIPMENT (FUNACES, A/C UNITS, ELECTRICAL PANELS, SANITARY SUMP PITS, DRAIN TILE SUMP, AND WATER HEATERS) ARE SUBJECT TO RELOCATION DUE TO FIELD CONDITIONS.				
- PROVIDE POWER, LIGHT AND SWITCH AS REQUIRED FOR ATTIC FURNACE PER CODE AND MANUFACTURER'S	\$4 FOUR-WAY SWITCH		ELECTRIC PANEL	
WRITTEN INSTRUCTIONS.			DISCONNECT SWITCH	

Oakmont Estates Classic Nelson Lot

Foundation

Crawlspac

Garage,

Right Hand


Homes, McKee

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03.17.19

SHEET NO:

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2nd Floor Plan 'Classic'

SCALE: 1/4"=1'-0" AT 22"X34" LAYOUT 1/8"=1'-0" AT 11"X17" LAYOUT

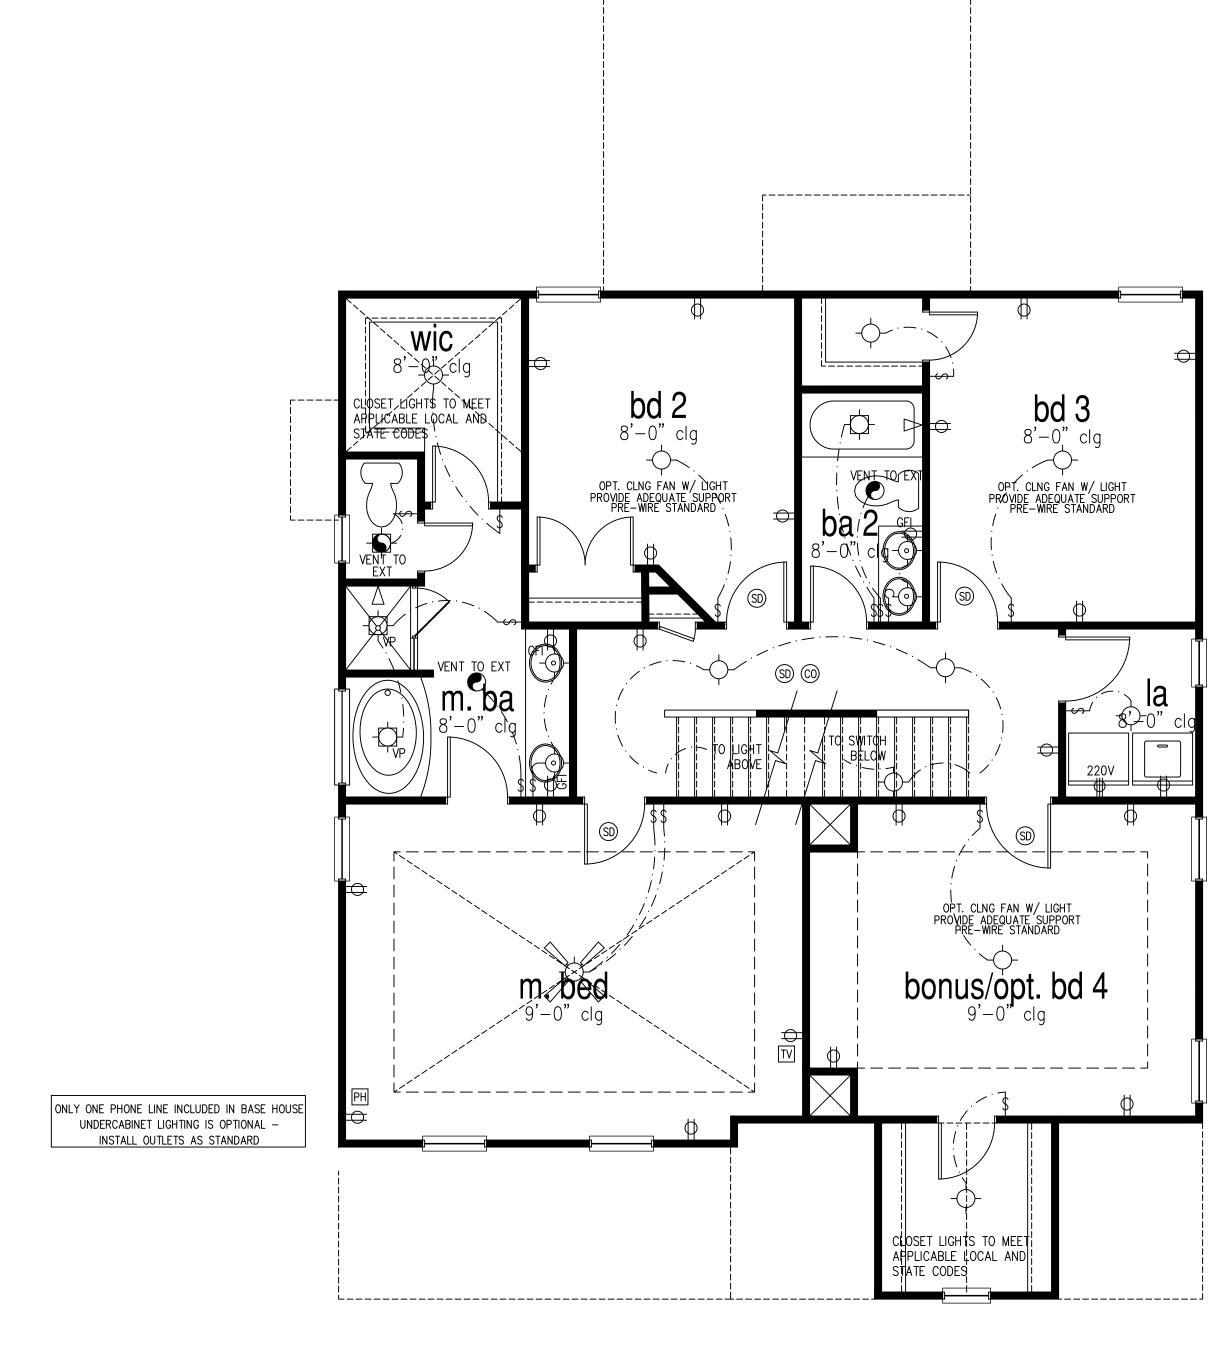NOTES:	LEGE	ND:						
- PROVIDE GROUNDING ELECTRICAL ROD PER LOCAL CODES.	ф	DUPLEX OUTLET		CEILING MOUNTED INCANDESCENT LIGHT FIXTURE	СН	CHIMES		CEILING FAN
- PROVIDE AND INSTALL ARC FAULT CIRCUIT-INTERRUPTERS (AFCI) AS REQUIRED BY NATIONAL ELECTRICAL CODE (NEC) AND MEETING THE REQUIREMENTS OF ALL GOVERNING CODES.	WP/GFI	WEATHERPROOF GFI DUPLEX OUTLET	⊢	WALL MOUNTED INCANDESCENT LIGHT FIXTURE		PUSHBUTION SWITCH		(PROVIDE ADEQUATE SUPPORT)
- ALL EXHAUST FANS SHALL HAVE BACKDRAFT DAMPERS.	Ф ^{GFI}	GROUND-FAULT CIRCUIT-INTERRUPTER DUPLEX OUTLET		RECESSED INCANDESCENT LIGHT FIXTURE (VP) = VAPOR PROOF	(SD)	IIOV SMOKE SETECTOR W/ BATTERY BACKUP		
- FAN/LIGHTS IN WET/DAMP LOCATIONS SHALL BE LABLED "SUITABLE FOR WET OR DAMP LOCATIONS."	11	BOT LEX GOTTET		` ',		,		CEILING FAN WITH INCANDESCENT LIGHT FIXTU
- ELECTRICAL SYSTEMS ARE SHOWN FOR INTENT ONLY. THESE SYSTEMS SHALL BE ENGINEERED BY OTHERS. THE	Ф	HALF-SWITCHED DUPLEX OUTLET	•	EXHAUST FAN (VENT TO EXTERIOR)		CO2 DETECTOR		(PROVIDE ADEQUATE SUPPORT)
CONTRACTOR SHALL BE RESPONSIBLE FOR PROPER INSTALLATION AND PLACEMENT. - PROVIDE AND INSTALL LOCALLY CERTIFIED SMOKE DETECTORS AND CO2 DETECTORS AS REQUIRED BY	⇒ ^{220V}	220 VOLT OUTLET	-5	EXHAUST FAN/LIGHT COMBINATION (VENT TO EXTERIOR)	T	THERMOSTAT	⊢⊗	GAS SUPPLY WITH VALVE
NATIONAL FIRE PROTECTION ASSOCIATION (NFPA) AND MEETING THE REQUIREMENTS OF ALL GOVERNING CODES.	J	REINFORCED JUNCTION BOX		FLUORESCENT LIGHT FIXTURE	PH	TELEPHONE	——————————————————————————————————————	HOSE BIBB
- PROVIDE AND INSTALL GROUND FAULT CIRCUIT-INTERRUPTERS (GFI) AS REQUIRED BY NATIONAL ELECTRICAL							'HB	
CODE (NEC) AND MEETING THE REQUIREMENTS OF ALL GOVERNING CODES.	\$	WALL SWITCH		TECH HUB SYSTEM	TV	TELEVISION	— 	1/4" WATER STUB OUT
- ELECTRICAL CONTRACTOR TO PROVIDE REQUIRED DIRECT HOOK-UPS/CUTOFFS.	'						CW	
- HVAC CONTRACTOR TO VERIFY THERMOSTAT LOCATIONS.	\$,	THREE-WAY SWITCH				ELECTRIC METER	<u> </u>	WALL SCONCE
– ALL ELECTRICAL AND MECHANICAL EQUIPMENT (FUNACES, A/C UNITS, ELECTRICAL PANELS, SANITARY SUMP PITS, DRAIN TILE SUMP, AND WATER HEATERS) ARE SUBJECT TO RELOCATION DUE TO FIELD CONDITIONS.	13	FOUR-WAY SWITCH				■ ELECTRIC PANEL	**	
 PROVIDE POWER, LIGHT AND SWITCH AS REQUIRED FOR ATTIC FURNACE PER CODE AND MANUFACTURER'S WRITTEN INSTRUCTIONS. 	 ₱4	FOUR-WAT SWITCH				ELECTRIC PANEL		
MATTER INSTRUCTIONS.						DISCONNECT SWITCH		

Foundation

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Crawlspac

Garage,


Classic

Estates Oakmont Homes, Nelson

PRINT DATE: 03.17.19

SHEET NO:

E2.0

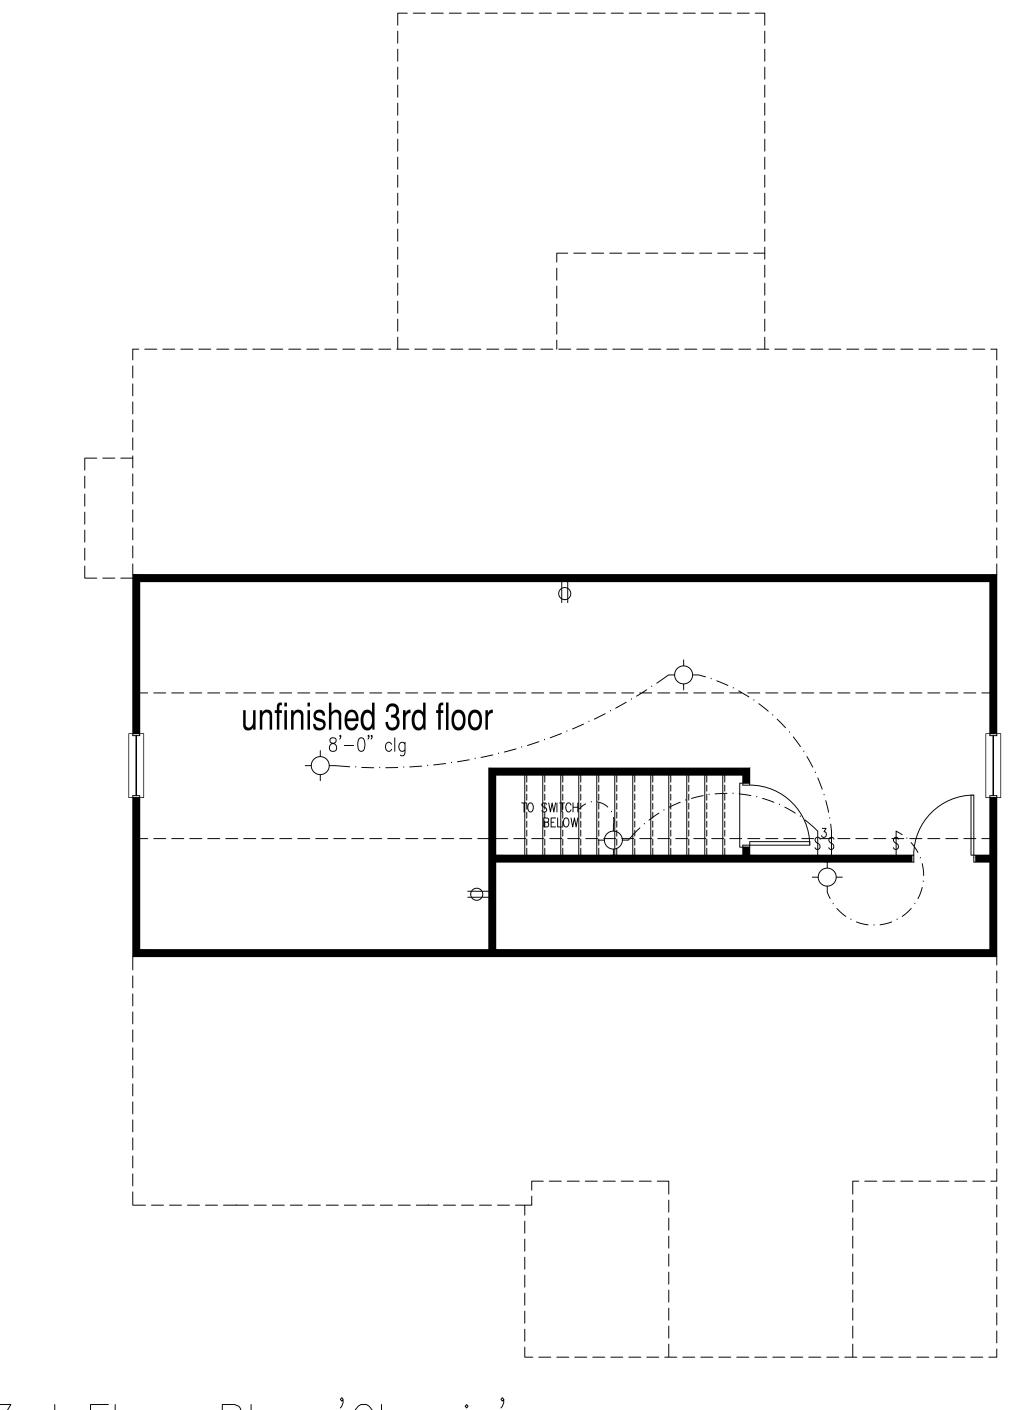

3rd Floor Plan 'Classic'

SCALE: 1/4"=1'-0" AT 22"X34" LAYOUT 1/8"=1'-0" AT 11"X17" LAYOUT


NOTES:	LEGEND);						
- PROVIDE GROUNDING ELECTRICAL ROD PER LOCAL CODES.	Ф	DUPLEX OUTLET	<u></u>	CEILING MOUNTED INCANDESCENT LIGHT FIXTURE	СН	CHIMES		CEILING FAN
 PROVIDE AND INSTALL ARC FAULT CIRCUIT—INTERRUPTERS (AFCI) AS REQUIRED BY NATIONAL ELECTRICAL CODE (NEC) AND MEETING THE REQUIREMENTS OF ALL GOVERNING CODES. 	WP/GFI	WEATHERPROOF GFI DUPLEX OUTLET	⊢	WALL MOUNTED INCANDESCENT LIGHT FIXTURE	Ī	PUSHBUTION SWITCH		(PROVIDE ADEQUATE SUPPORT)
- ALL EXHAUST FANS SHALL HAVE BACKDRAFT DAMPERS.		GROUND-FAULT CIRCUIT-INTERRUPTER DUPLEX OUTLET		RECESSED INCANDESCENT LIGHT FIXTURE (VP) = VAPOR PROOF	(SD)	IIOV SMOKE SETECTOR W/ BATTERY BACKUP		
- FAN/LIGHTS IN WET/DAMP LOCATIONS SHALL BE LABLED "SUITABLE FOR WET OR DAMP LOCATIONS."	M	DOFLEX GOTLET		MESESSES MEANISESSEM FIATOME (M) MARKET		HOV SMOKE SELECTOR HY BATTERY BATTER		CEILING FAN WITH INCANDESCENT LIGHT FIXTUR
- ELECTRICAL SYSTEMS ARE SHOWN FOR INTENT ONLY. THESE SYSTEMS SHALL BE ENGINEERED BY OTHERS. THE	φ	HALF-SWITCHED DUPLEX OUTLET	•	EXHAUST FAN (VENT TO EXTERIOR)	(0)	CO2 DETECTOR		(PROVIDE ADEQUATE SUPPORT)
CONTRACTOR SHALL BE RESPONSIBLE FOR PROPER INSTALLATION AND PLACEMENT. - PROVIDE AND INSTALL LOCALLY CERTIFIED SMOKE DETECTORS AND CO2 DETECTORS AS REQUIRED BY	⇒ ^{220V}	220 VOLT OUTLET	-5	EXHAUST FAN/LIGHT COMBINATION (VENT TO EXTERIOR)	T	THERMOSTAT	⊢⊗	GAS SUPPLY WITH VALVE
NATIONAL FIRE PROTECTION ASSOCIATION (NFPA) AND MEETING THE REQUIREMENTS OF ALL GOVERNING CODES.	(J)	REINFORCED JUNCTION BOX		FLUORESCENT LIGHT FIXTURE	PH	TELEPHONE	——————————————————————————————————————	HOSE BIBB
- PROVIDE AND INSTALL GROUND FAULT CIRCUIT—INTERRUPTERS (GFI) AS REQUIRED BY NATIONAL ELECTRICAL CODE (NEC) AND MEETING THE REQUIREMENTS OF ALL GOVERNING CODES.		WALL SWITCH		TECH HUB SYSTEM	TV	TELEVISION	nb	1/4" WATER STUB OUT
- ELECTRICAL CONTRACTOR TO PROVIDE REQUIRED DIRECT HOOK-UPS/CUTOFFS.	Ψ			123.1 1.102 0.10.2		122 10/01		TY T WITTEN GIOD GOT
- HVAC CONTRACTOR TO VERIFY THERMOSTAT LOCATIONS.	\$,	THREE-WAY SWITCH				ELECTRIC METER	7	WALL SCONCE
- ALL ELECTRICAL AND MECHANICAL EQUIPMENT (FUNACES, A/C UNITS, ELECTRICAL PANELS, SANITARY SUMP PITS, DRAIN TILE SUMP, AND WATER HEATERS) ARE SUBJECT TO RELOCATION DUE TO FIELD CONDITIONS.	13	FOLID_WAY SWITCH				ELECTRIC PANEL	7	
- PROVIDE POWER, LIGHT AND SWITCH AS REQUIRED FOR ATTIC FURNACE PER CODE AND MANUFACTURER'S	P4	\$4 FOUR-WAY SWITCH				LLLOTING FAINEL		
WRITTEN INSTRUCTIONS.						DISCONNECT SWITCH		



McKee Homes, LLC Lot 289 Oakmont Estates

03.17.19

E3.0

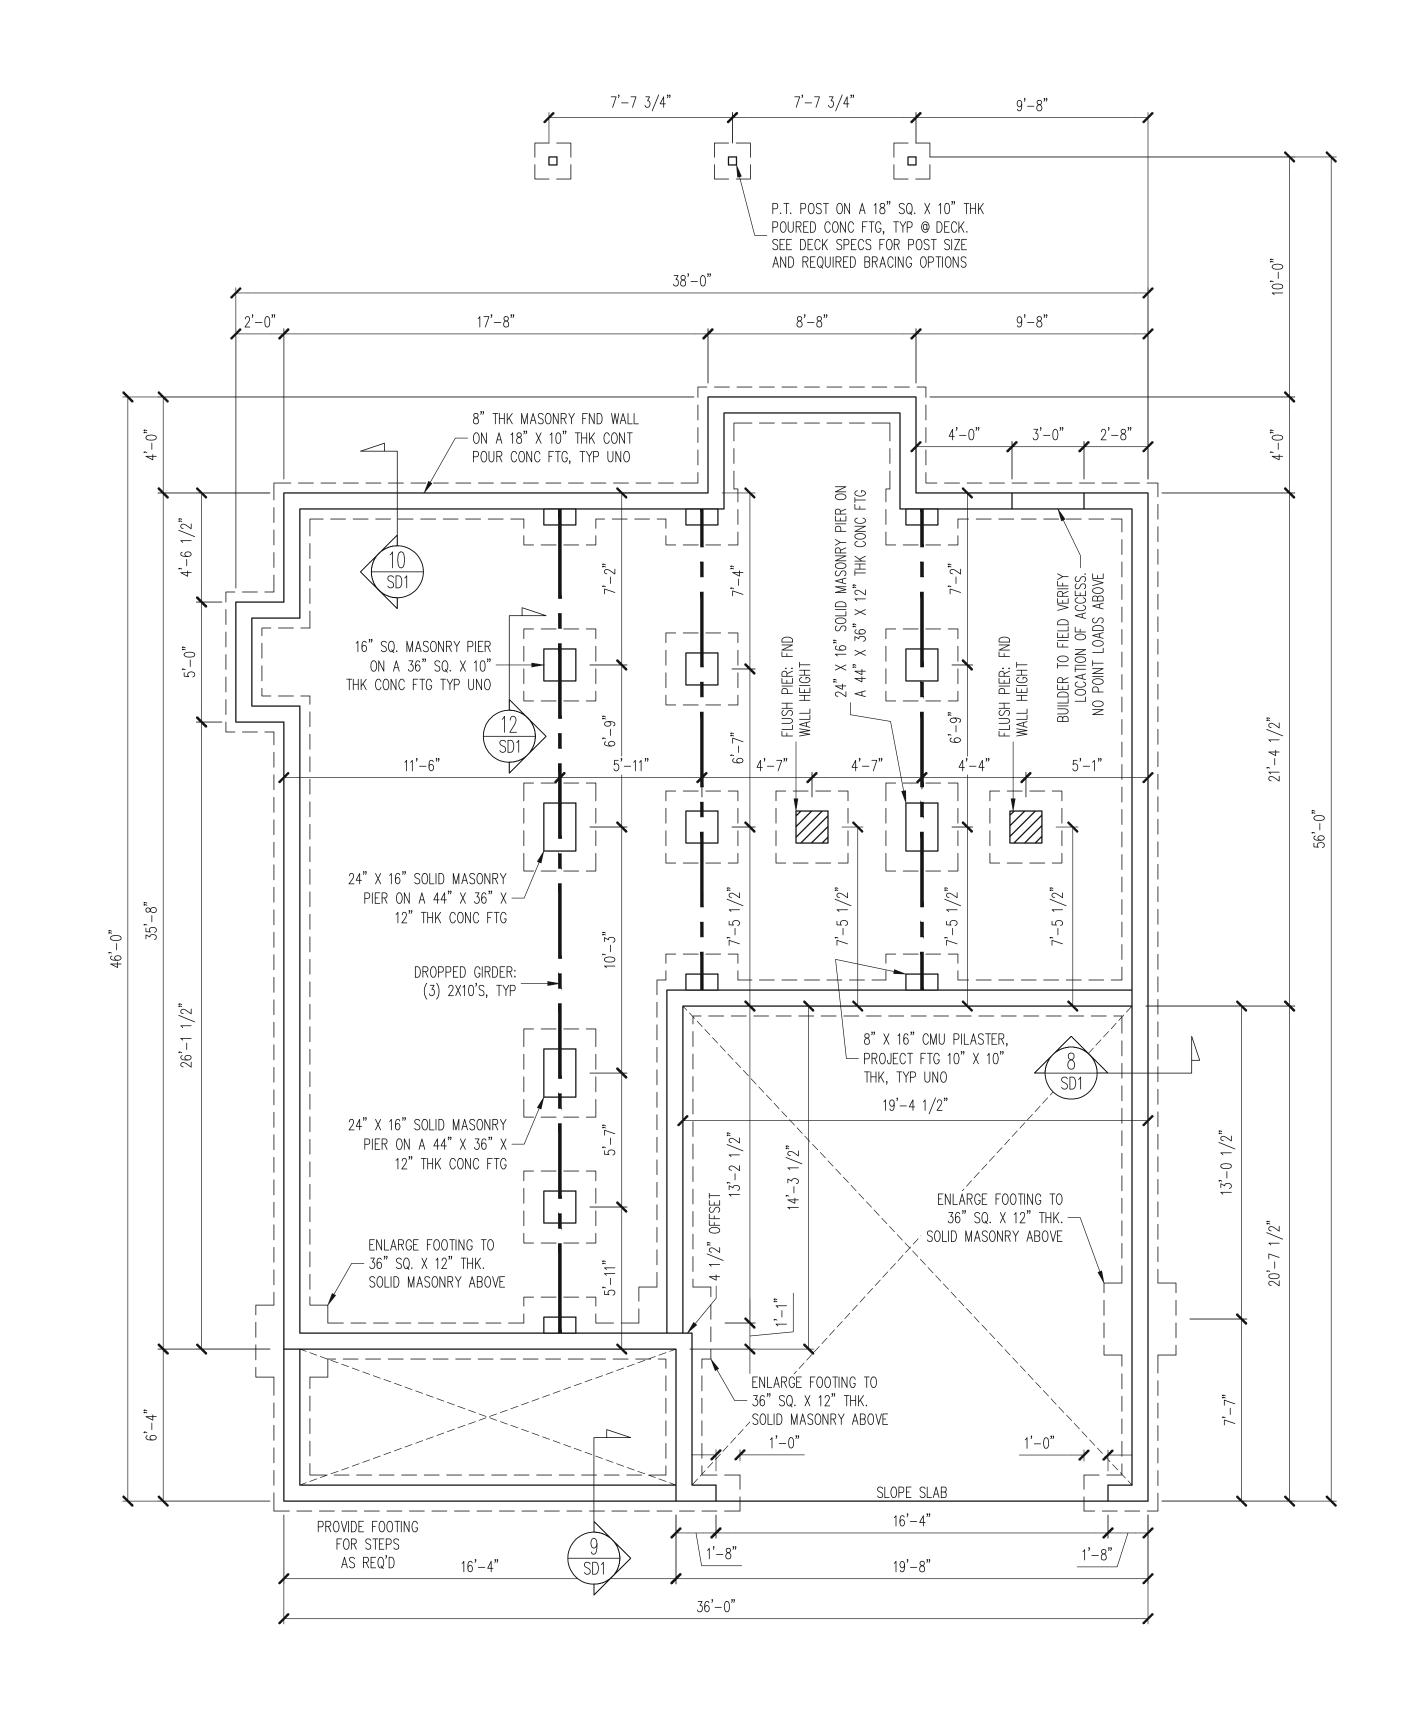


FOUNDATION PLAN
CRAWLSPACE OPTION
CLASSIC ELEVATION
1/4" = 1'-0"

NOTES:
- HEIGHT AND BACKFILL LIMITATIONS FOR FOUNDATION WALLS ARE TO BE GOVERNED BY THE NCSBC, LATEST EDITION.

FIBER MESH REINFORCED CONCRETE MAY BE USED IN LIEU OF WELDED WIRE FABRIC. SEE SECTION 6.01 OF THE CONSTRUCTION SPECIFICATIONS FOR ALLOWABLE SUBSTITUTION DETAILS.

STRUCTURAL ENGINEERS
License No. C-3870
183 Wind Chime Court, Suite 100
Raleigh, North Carolina 27615



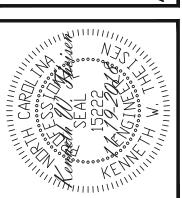

SEAL VALID FOR 1 YEAR ONLY.

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A. assumes no liability for these plans on or permitting takes place more than the seal date without written.


ENGINEERING SEAL VALID FOR 1 The structural design of this plar Engineering Tech Associates, P.A. for the client listed only. Enginee Associates, P.A. assumes no liab if construction or permitting take 1 year after the seal date without permission from Engineering Tech


		ENG: KWT/DTN		DATE: 11-19-2018
	MNG	ENG	REV:	DATE
CLIENT: MCKEE HOMES	SCOPE STRUCTURAL ADDENDUM	LOI #:		


PLAN NO. NELSON RH

PROJECT NO. 18-29-064R

SHEET NO.

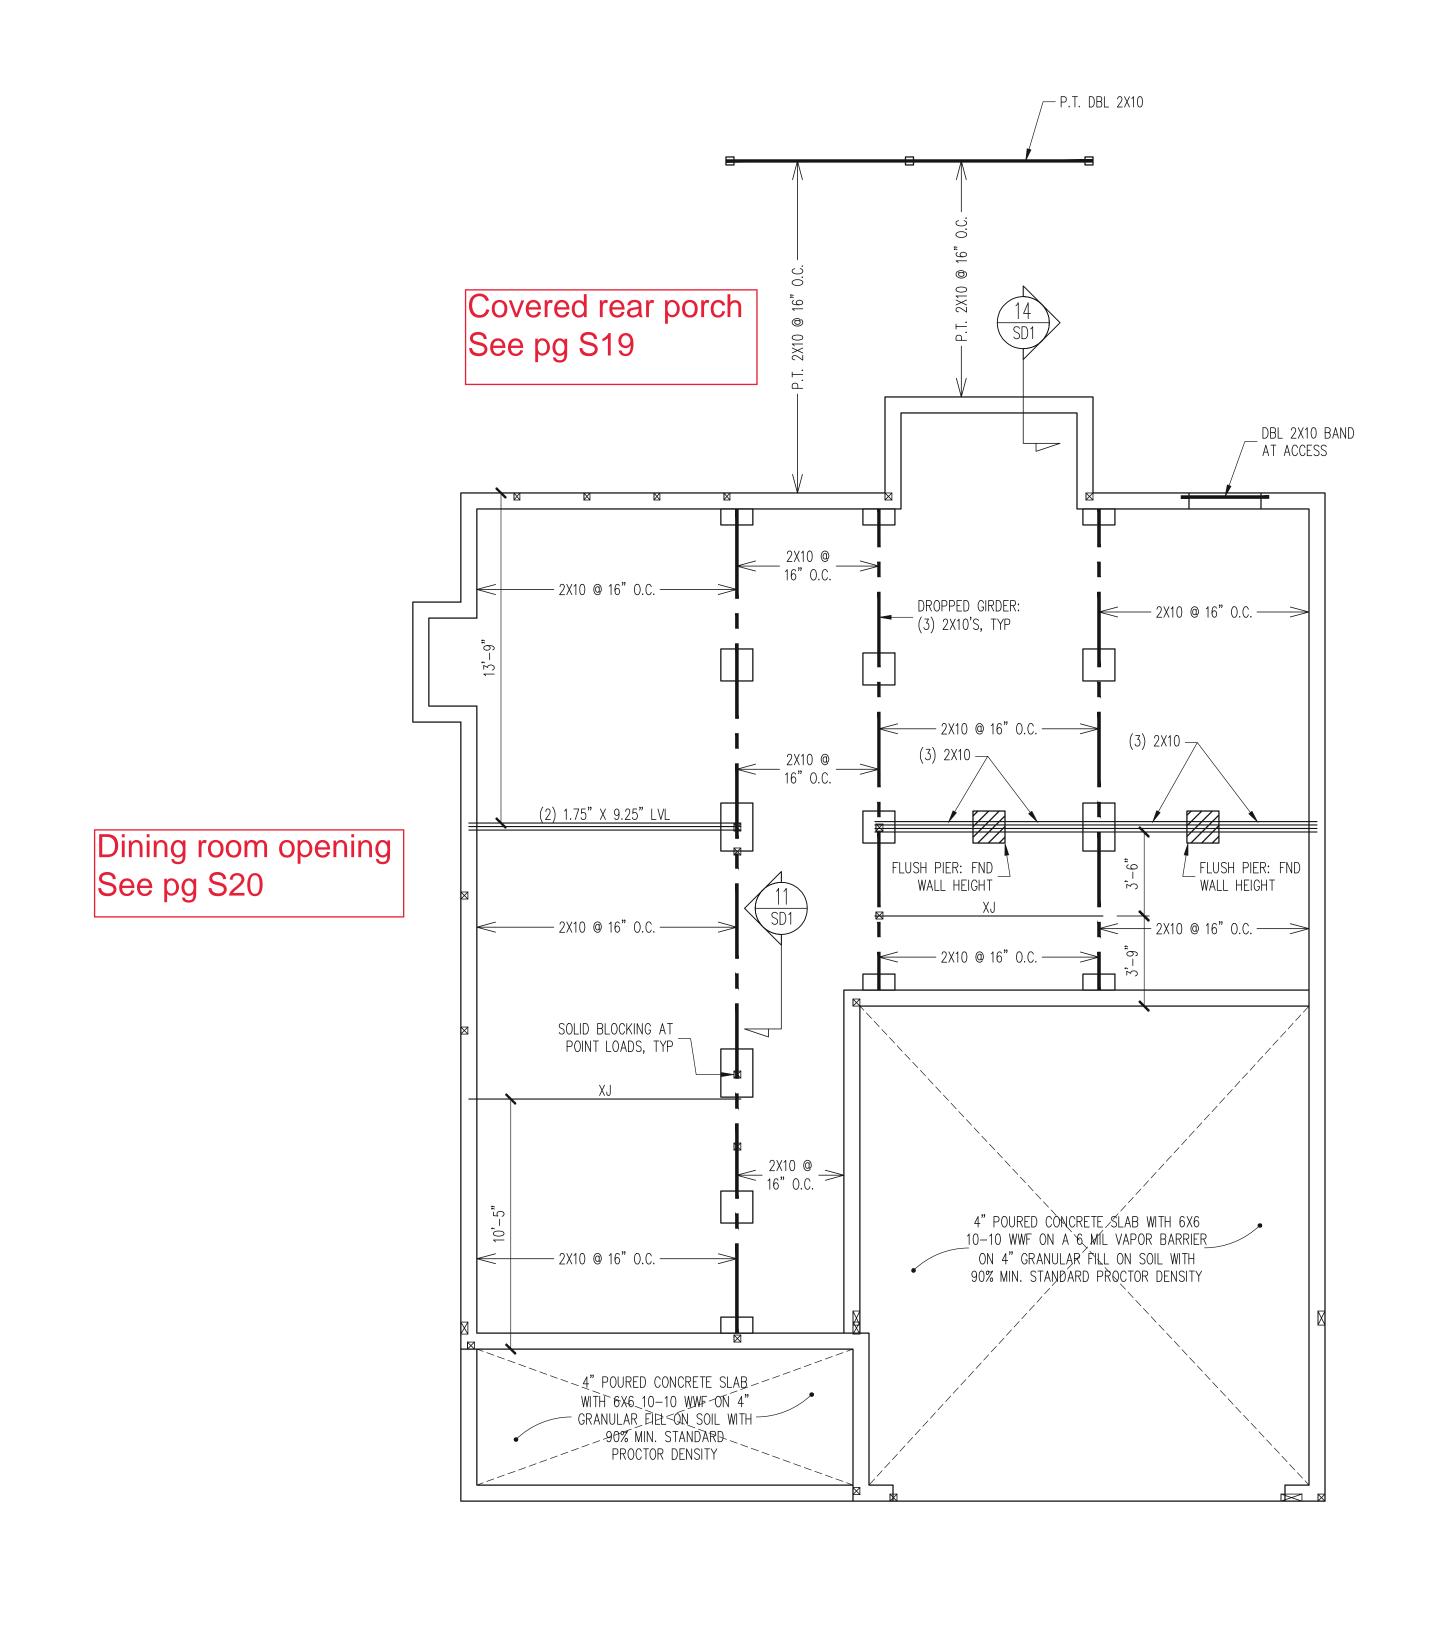

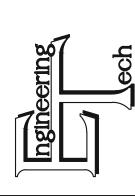

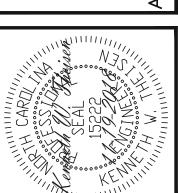

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		ENG KWT/DTN		DATF 11-19-2018
	MUO	ENG	REV:	DATE
CLIENT: MCKEE HOMES	SCOPE STRUCTURAL ADDENDUM	#:		

PLAN NO. **NELSON RH**

PROJECT NO. 18-29-064R

> SHEET NO. **S8**

NOTES:

- HEIGHT AND BACKFILL LIMITATIONS FOR FOUNDATION WALLS ARE TO BE GOVERNED BY THE NCSBC, LATEST EDITION.

FIBER MESH REINFORCED CONCRETE MAY BE USED IN LIEU OF WELDED WIRE FABRIC. SEE SECTION 6.01 OF THE CONSTRUCTION SPECIFICATIONS FOR ALLOWABLE SUBSTITUTION DETAILS.

8 of 22

CRAWL SPACE FRAMING PLAN CLASSIC ELEVATION 1/4" = 1'-0"

Covered rear porch See pg S19 _ ROOF TRUSSES PER MANU EXTEND HEADER TRUSSES BEAR ON WALL AS SHOWN AND CANTILEVER TO STAIRS TRUSSES BEAR _ ON WALL (2) 1.75" X 14" LVL X 9.25" LVL JACKS B.E. HEADERS, TRIMMERS, AND ATTACHMENTS
PER TRUSS MANU AT STAIRS -14" FLOOR TRUSSES @ 24 (3) STUDS -(Z) –14" FLOOR TRUSSÉS @ 24" O.C. (2) 1.75" X 14" LVL — (2) 1.75" X 11.875" LVL HEADER ON TRPL JACKS B.E. S1 GB (3) STUDS, NO DBL TOP PLATE SPLICES WITHIN 6" OF BEAM -14" FLOOR TRUSSES @ 24" O.C. — 14" FLOOR TRUSSES @ 24" O.C. — TRUSSES BEAR BEAR DROPPED BAND ON (2) SOM HOUSE, TYP @ FRONT PORCH ON WALL EXTEND HEADER _ AS SHOWN (4) 1.75" 14" LVL, BOLTED H3 - ATTIC TRUSSES PER MANU -(2) 1.75" X 11.875" LVL (7) JACKS — HEADER ON DBL JACKS — B.E., EXTEND AS SHOWN LAP BANDS @ CORNER ─ POST, TYP DBL 2X10 BAND, DROPPED, _ TYP @ FRONT PORCH P.T. 4X4 POST, WRAP AS REQ'D. OPTION: (3) KIP MIN. RATED COLUMN PER BUILDER, TYP @ FRONT PORCH

Dining room opening See pg S20

1ST FLOOR ONLY

CONTINUOUSLY SHEATHED WITH 7/16 APA RATED OSB NAILED TO STUDS WITH 8d NAILS @ 6" O.C. AT PANEL EDGES, 12" O.C. IN PANEL FIELD. BLOCKING AT HORIZONTAL JOINTS IN BRACED WALL LINES

-WALL BRACING IS BY ENGINEERED DESIGN AND NOT PRESCRIPTIVE PER SECTION 602.10 OF THE 2018 NCRC. CONTINUOUS SHEATHING HAS BEEN PROVIDED, ALONG WITH ALTERNATIVE METHODS TO INSURE THE MINIMUM INTENT OF SECTION 602.10 OF THE 2018 NCRC HAS BEEN MET AND EXCEEDED.

TRUSS OR 2X6 BLOCKING REQUIRED ABOVE ALL BRACED WALLS. NAIL SUBFLOOR ABOVE WALL TO TRUSS / BLOCKING WITH 8d NAILS @ 6" O.C.. TOE NAIL TRUSS / BLOCKING ABOVE WALL TO TOP PLÁTE WITH 16d TOE NAILS @ 6" O.C. ATTACH SOLE PLATE OF BRACED WALL TO FOUNDATION BELOW PER TYPICAL BRACED WALL DETAILS

REQUIRED STUDS FOR BEAM SUPPORT

HEADER SCHEDULE

- H1 SINGLE 2X4 TURNED FLAT (A)
- H3 (2) 2X10'S ON SINGLE JACKS (C)
- H4 (2) 1.75" X 9.25" LVL'S ON DBL JACKS
- H5 (2) 2X10'S ON DBL JACKS
- (A) TYPICAL FOR INTERIOR NON LOAD BEARING
- (B) TYPICAL FOR INTERIOR NON LOAD BEARING

1ST FLOOR FRAMING PLAN

CLASSIC ELEVATION

WALLS AND CEILING

1/4" = 1'-0"

-HEADERS IN NON LOAD BEARING INTERIOR WALLS ARE NOT LABELED. -KING STUDS EXTERIOR WALLS: SINGLE KING STUDS FOR 6' MAX OPENINGS. DBL KING STUDS FOR 10' MAX OPENINGS. TRPL KING STUDS FOR 14' MAX OPENINGS. QUAD KING STUDS FOR 18' MAX OPENINGS. KING STUDS REQUIRED (ROUND UP) UNO

WALL BRACING

ALL EXTERIOR STUD WALLS ARE TO BE ONLY REQUIRED AT SHADED WALLS, UNO

SHADED WALLS:

GB - INTERIOR BRACED WALL WITH GYPSUM BOARD. 1/2" GB BOTH SIDES OF WALL ATTACHED TO PANEL EDGES, INCLUDING TOP AND BOTTOM PLATES, AT 7" O.C.

PF - PORTAL FRAME PER TYPICAL DETAIL

BUILDER PERMITTED TO SUBSTITUTE INTERIOR OSB SHEATHING WITH THERMO-PLY BLUE PROTECTIVE SHEATHING. REFERENCE TECHNICAL EVALUATION REPORT COL#P-1038 PROVIDED BY DRJ ENGINEERING, LLC AND SEALED BY RYAN DEXTER, P.E.

FRAMING SCHEDULE 1ST FLOOR ONLY


REFER TO SECTIONS 5.02 - 5.06 OF THE CONSTRUCTION SPECIFICATIONS FOR REQUIRED NUMBER OF STUDS FOR BEAM SUPPORT, TYP UNO.

- H2 (2) 2X4'S ON SINGLE JACKS (B)

- _____
- WALLS ONLY, ROUGH OPENING 38" MAX.
- WALLS ONLY, ROUGH OPNG 38" TO 74" MAX.
- (C) TYPICAL FOR ALL CONDITIONS NOT LISTED IN (A) OR (B) UNO.

FOR 2X6 WALLS, ONE HALF THE AMOUNT OF



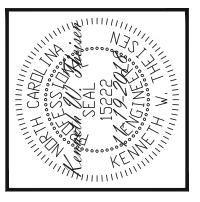


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PLAN NO. **NELSON RH**

PROJECT NO. 18-29-064R

> SHEET NO. **S10**

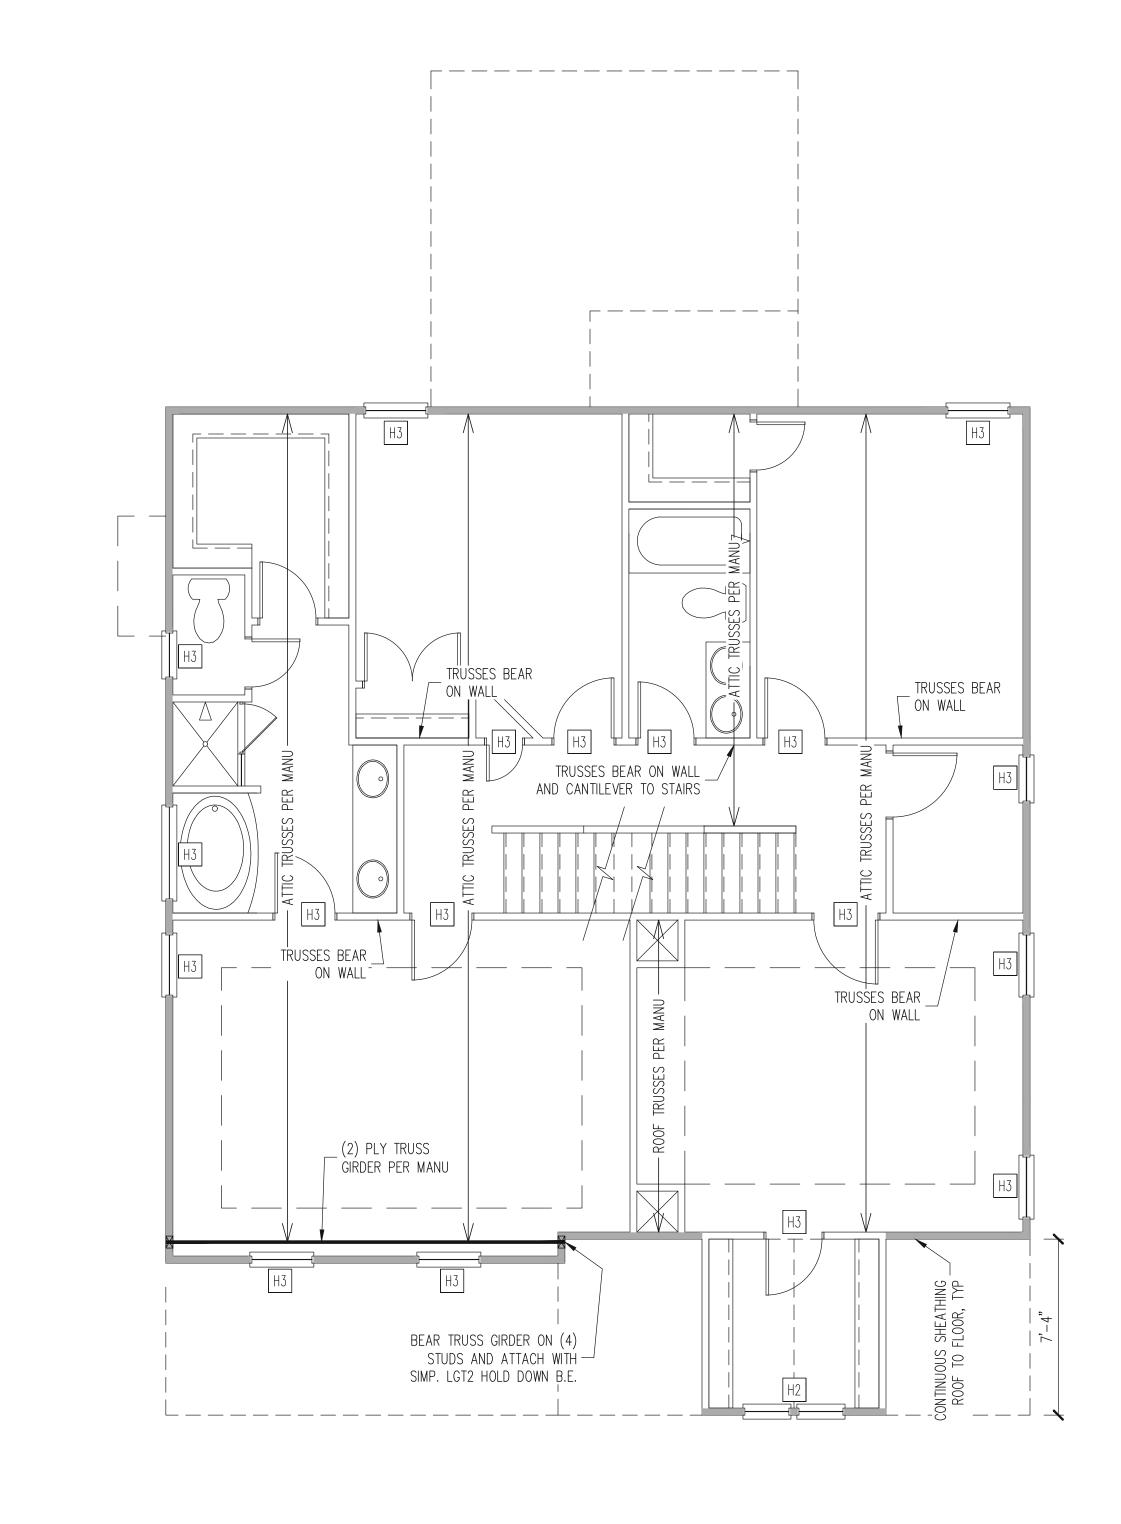

2ND FLOOR FRAMING PLAN CLASSIC ELEVATION

 $\frac{\text{WALLS AND CEILING}}{1/4" = 1'-0"}$

2ND FLOOR ONLY

ALL EXTERIOR STUD WALLS ARE TO BE CONTINUOUSLY SHEATHED WITH 7/16 APA RATED OSB NAILED TO STUDS WITH 8d NAILS @ 6" O.C. AT PANEL EDGES, 12" O.C. IN PANEL FIELD.

TRUSS OR 2X6 BLOCKING REQUIRED ABOVE AND BELOW ALL BRACED WALLS. NAIL SUBFLOOR ABOVE WALL TO BLOCKING WITH 8d NAILS @ 6" O.C.. TOE NAIL TRUSS / BLOCKING ABOVE WALL TO TOP PLATE WITH 16d TOE NAILS @ 6" O.C. NAIL SOLE PLATE OF BRACED WALL TO TRUSS / BLOCKING BELOW WALL WITH (3) 16d NAILS @ 16" O.C. BLOCKING AT HORIZONTAL JOINTS IN BRACED WALL LINES ONLY REQUIRED AT SHADED WALLS, UNO

SHADED WALLS:

-PROVIDED CONTINUOUS SHEATHING = 145' MIN. -WALL BRACING IS BY ENGINEERED DESIGN AND NOT PRESCRIPTIVE PER SECTION 602.10 OF THE 2018 NCRC. CONTINUOUS SHEATHING HAS BEEN PROVIDED, ALONG WITH ALTERNATIVE METHODS TO INSURE THE MINIMUM INTENT OF SECTION 602.10 OF

REQUIRED STUDS FOR BEAM SUPPORT

REFER TO SECTIONS 5.02 - 5.06 OF THE CONSTRUCTION SPECIFICATIONS FOR REQUIRED NUMBER OF STUDS FOR BEAM SUPPORT, TYP UNO.

- H1 SINGLE 2X4 TURNED FLAT (A)
- H2 (2) 2X4'S ON SINGLE JACKS (B)
- H3 (2) 2X10'S ON SINGLE JACKS (C)
- H4 (2) 1.75" X 9.25" LVL'S ON DBL JACKS
- H5 (2) 2X10'S ON DBL JACKS -----
- WALLS ONLY, ROUGH OPNG 38" TO 74" MAX.
- (C) TYPICAL FOR ALL CONDITIONS NOT LISTED IN (A) OR (B) UNO.

WALLS ARE NOT LABELED. DBL KING STUDS FOR 10' MAX OPENINGS. TRPL KING STUDS FOR 14' MAX OPENINGS. KING STUDS REQUIRED (ROUND UP) UNO

WALL BRACING


THE 2018 NCRC HAS BEEN MET AND EXCEEDED.

HEADER SCHEDULE

- (A) TYPICAL FOR INTERIOR NON LOAD BEARING WALLS ONLY, ROUGH OPENING 38" MAX.
- (B) TYPICAL FOR INTERIOR NON LOAD BEARING

-HEADERS IN NON LOAD BEARING INTERIOR -KING STUDS EXTERIOR WALLS: SINGLE KING STUDS FOR 6' MAX OPENINGS. QUAD KING STUDS FOR 18' MAX OPENINGS. FOR 2X6 WALLS, ONE HALF THE AMOUNT OF



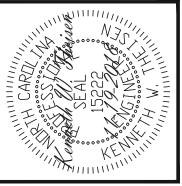



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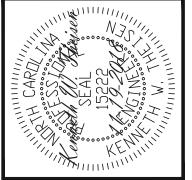
PLAN NO. **NELSON RH**

PROJECT NO. 18-29-064R

> SHEET NO. S12



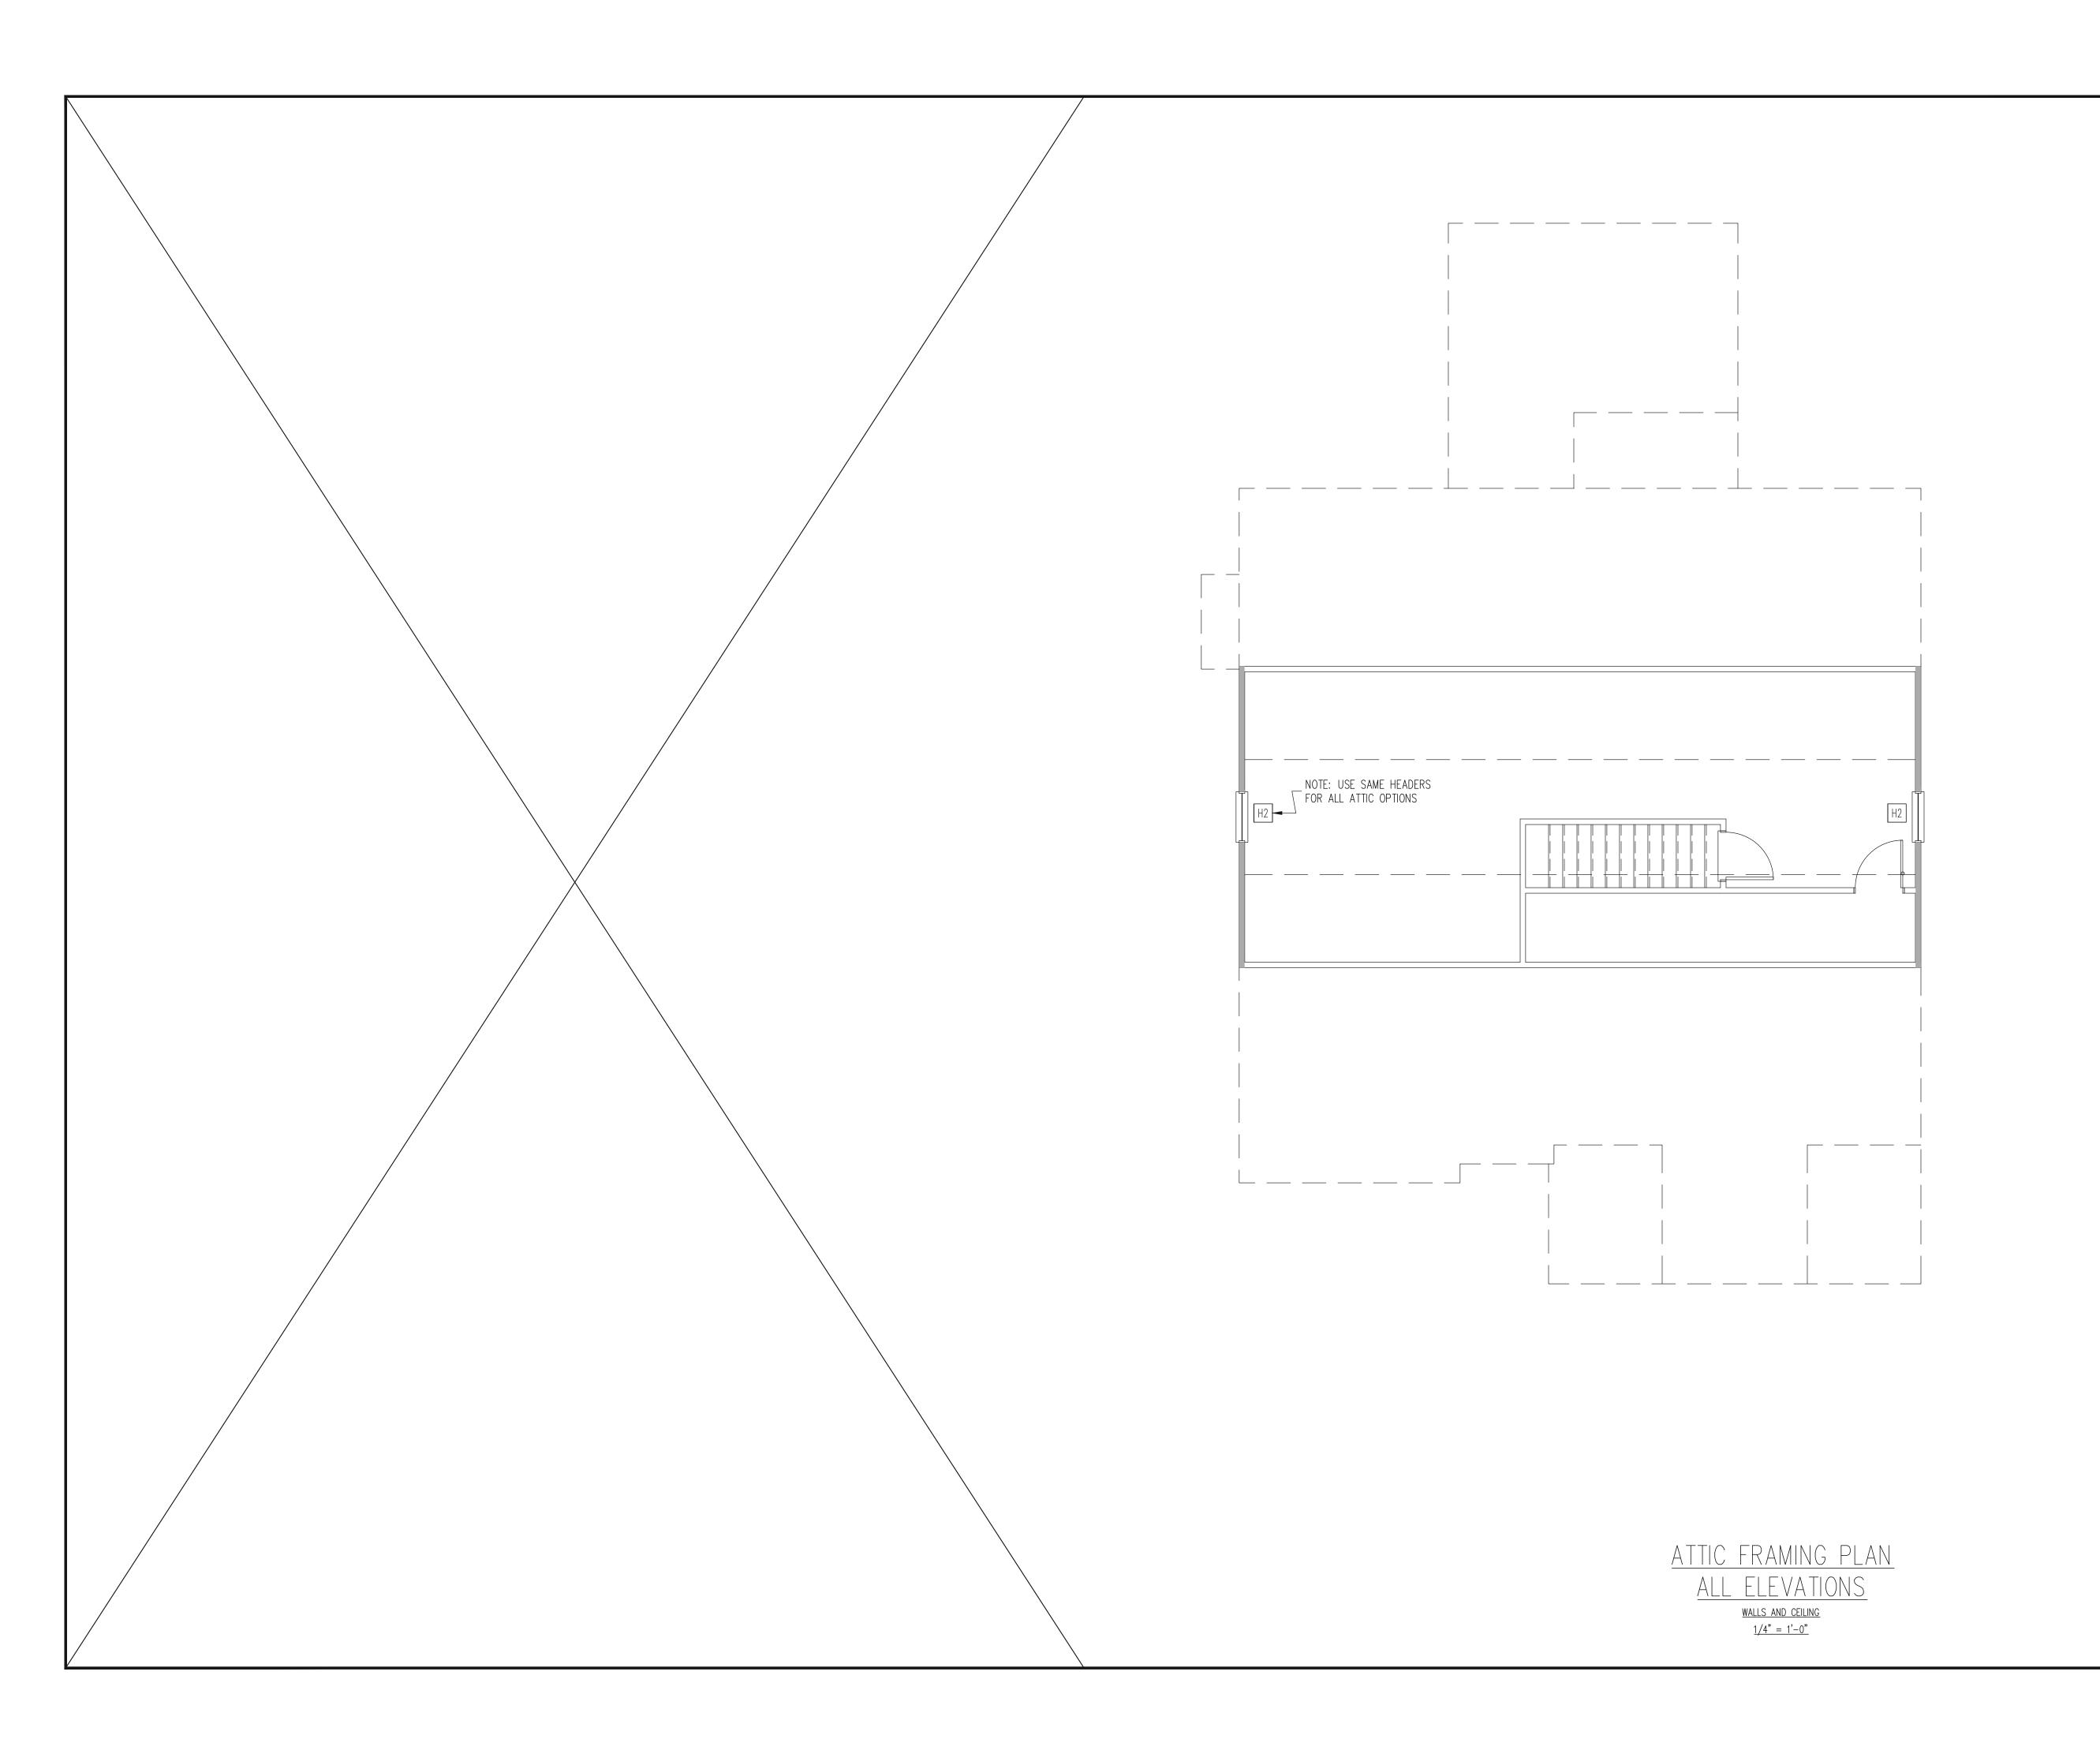

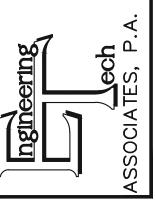

PANEL EDGES, 12" O.C. IN PANEL FIELD. TRUSS OR 2X6 BLOCKING REQUIRED ABOVE AND BELOW ALL BRACED WALLS. NAIL SUBFLOOR ABOVE WALL TO BLOCKING WITH 8d NAILS @ 6" O.C.. TOE NAIL TRUSS / BLOCKING ABOVE WALL TO TOP PLATE WITH 16d TOE NAILS @ 6" O.C. NAIL SOLE BELOW WALL WITH (3) 16d NAILS @ 16" O.C. BLOCKING AT HORIZONTAL JOINTS IN BRACED WALL LINES ONLY REQUIRED AT SHADED WALLS, UNO -----

SHADED WALLS:

WALL BRACING

2ND FLOOR ONLY

CONTINUOUSLY SHEATHED WITH 7/16 APA RATED OSB NAILED TO STUDS WITH 8d NAILS @ 6" O.C. AT

ALL EXTERIOR STUD WALLS ARE TO BE

-PROVIDED CONTINUOUS SHEATHING = 31' MIN. -WALL BRACING IS BY ENGINEERED DESIGN AND NOT PRESCRIPTIVE PER SECTION 602.10 OF THE 2018 NCRC. CONTINUOUS SHEATHING HAS BEEN PROVIDED, ALONG WITH ALTERNATIVE METHODS TO INSURE THE MINIMUM INTENT OF SECTION 602.10 OF THE 2018 NCRC HAS BEEN MET AND EXCEEDED.

REQUIRED STUDS FOR BEAM SUPPORT

REFER TO SECTIONS 5.02 - 5.06 OF THE CONSTRUCTION SPECIFICATIONS FOR REQUIRED NUMBER OF STUDS FOR BEAM SUPPORT, TYP UNO.

HEADER SCHEDULE

H1 SINGLE 2X4 TURNED FLAT (A)

H2 (2) 2X4'S ON SINGLE JACKS (B)

H3 (2) 2X10'S ON SINGLE JACKS (C)

H4 (2) 1.75" X 9.25" LVL'S ON DBL JACKS

H5 (2) 2X10'S ON DBL JACKS -----

- (A) TYPICAL FOR INTERIOR NON LOAD BEARING WALLS ONLY, ROUGH OPENING 38" MAX.
- (B) TYPICAL FOR INTERIOR NON LOAD BEARING WALLS ONLY, ROUGH OPNG 38" TO 74" MAX.
- (C) TYPICAL FOR ALL CONDITIONS NOT LISTED IN (A) OR (B) UNO.

-HEADERS IN NON LOAD BEARING INTERIOR WALLS ARE NOT LABELED. -KING STUDS EXTERIOR WALLS: SINGLE KING STUDS FOR 6' MAX OPENINGS. DBL KING STUDS FOR 10' MAX OPENINGS. TRPL KING STUDS FOR 14' MAX OPENINGS. QUAD KING STUDS FOR 18' MAX OPENINGS. FOR 2X6 WALLS, ONE HALF THE AMOUNT OF KING STUDS REQUIRED (ROUND UP) UNO

CLIENT: SCOPE: LOT #:


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PLAN NO. **NELSON RH**

PROJECT NO. 18-29-064R

> SHEET NO. **S13**

Covered rear porch See pg S19

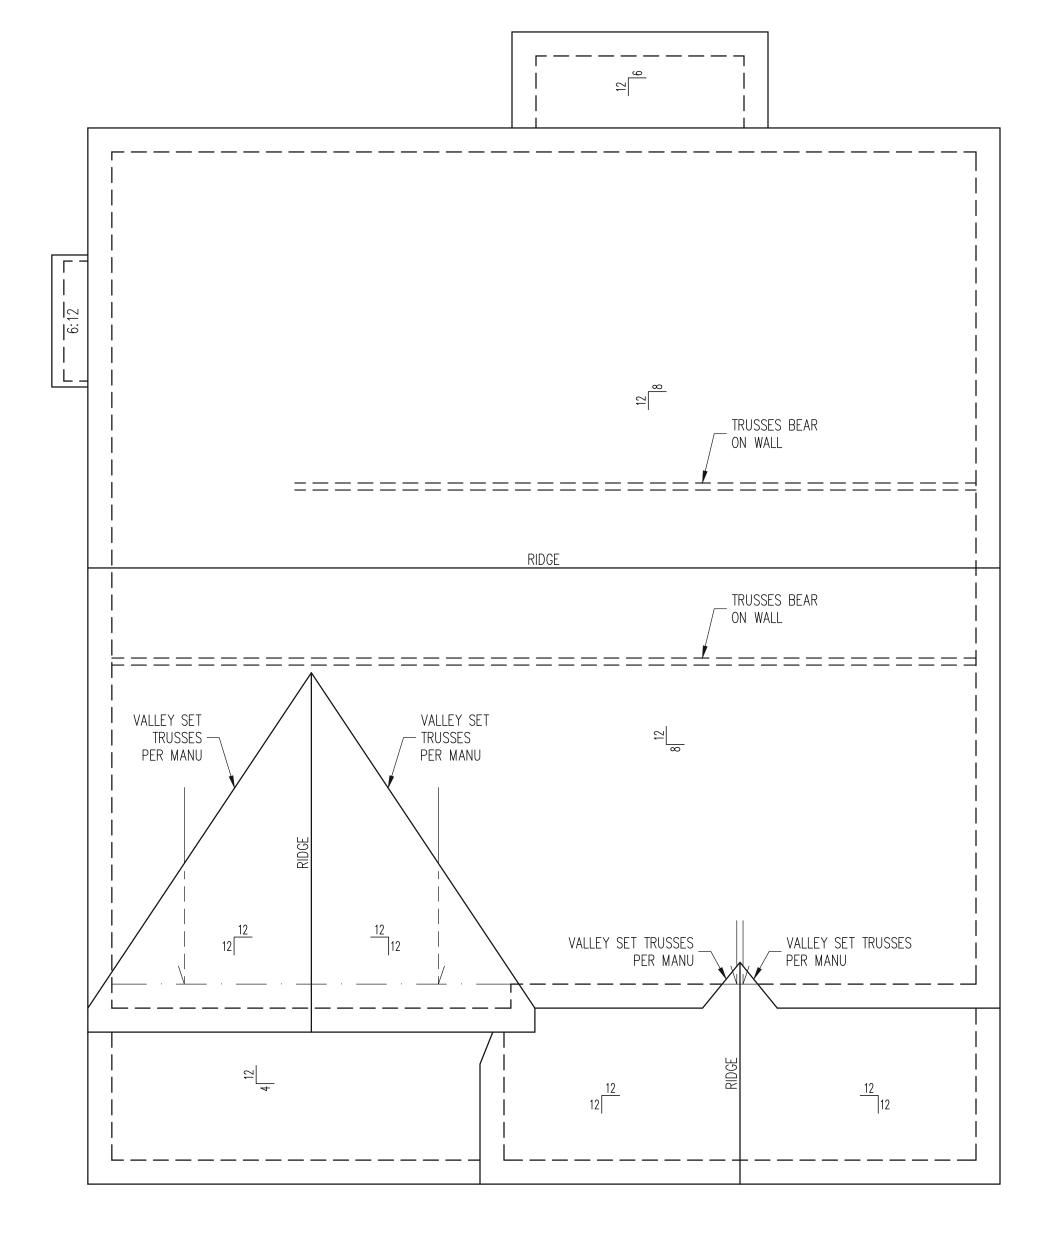


ROOF FRAMING PLAN <u>CLASSIC ELEVATION</u> 1/4" = 1'-0"

FRAMING NOTES

ROOF ONLY

-ROOF TRUSSES PER MANU TYPICAL UNO
-ATTACH ROOF TRUSSES TO DBL TOP PLATE
WITH SIMP. H2.5A HURRICANE TIES TYP UNO
-VERIFY ALL ARCHITECTURAL OVERHANGS, ROOF PITCHES, AND KNEEWALL HEIGHTS PRIOR TO CONSTRUCTION



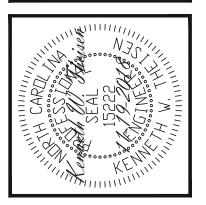



		ENG. KWT/DTN		DATF 11:19:2018
	MUC	ENG	REV:	DATE
MCKEE HOMES	STRUCTURAL ADDENDUM			
CLIENT:	SCOPE	:* IOI		


PLAN NO. **NELSON RH**

PROJECT NO. 18-29-064R

SHEET NO. S15

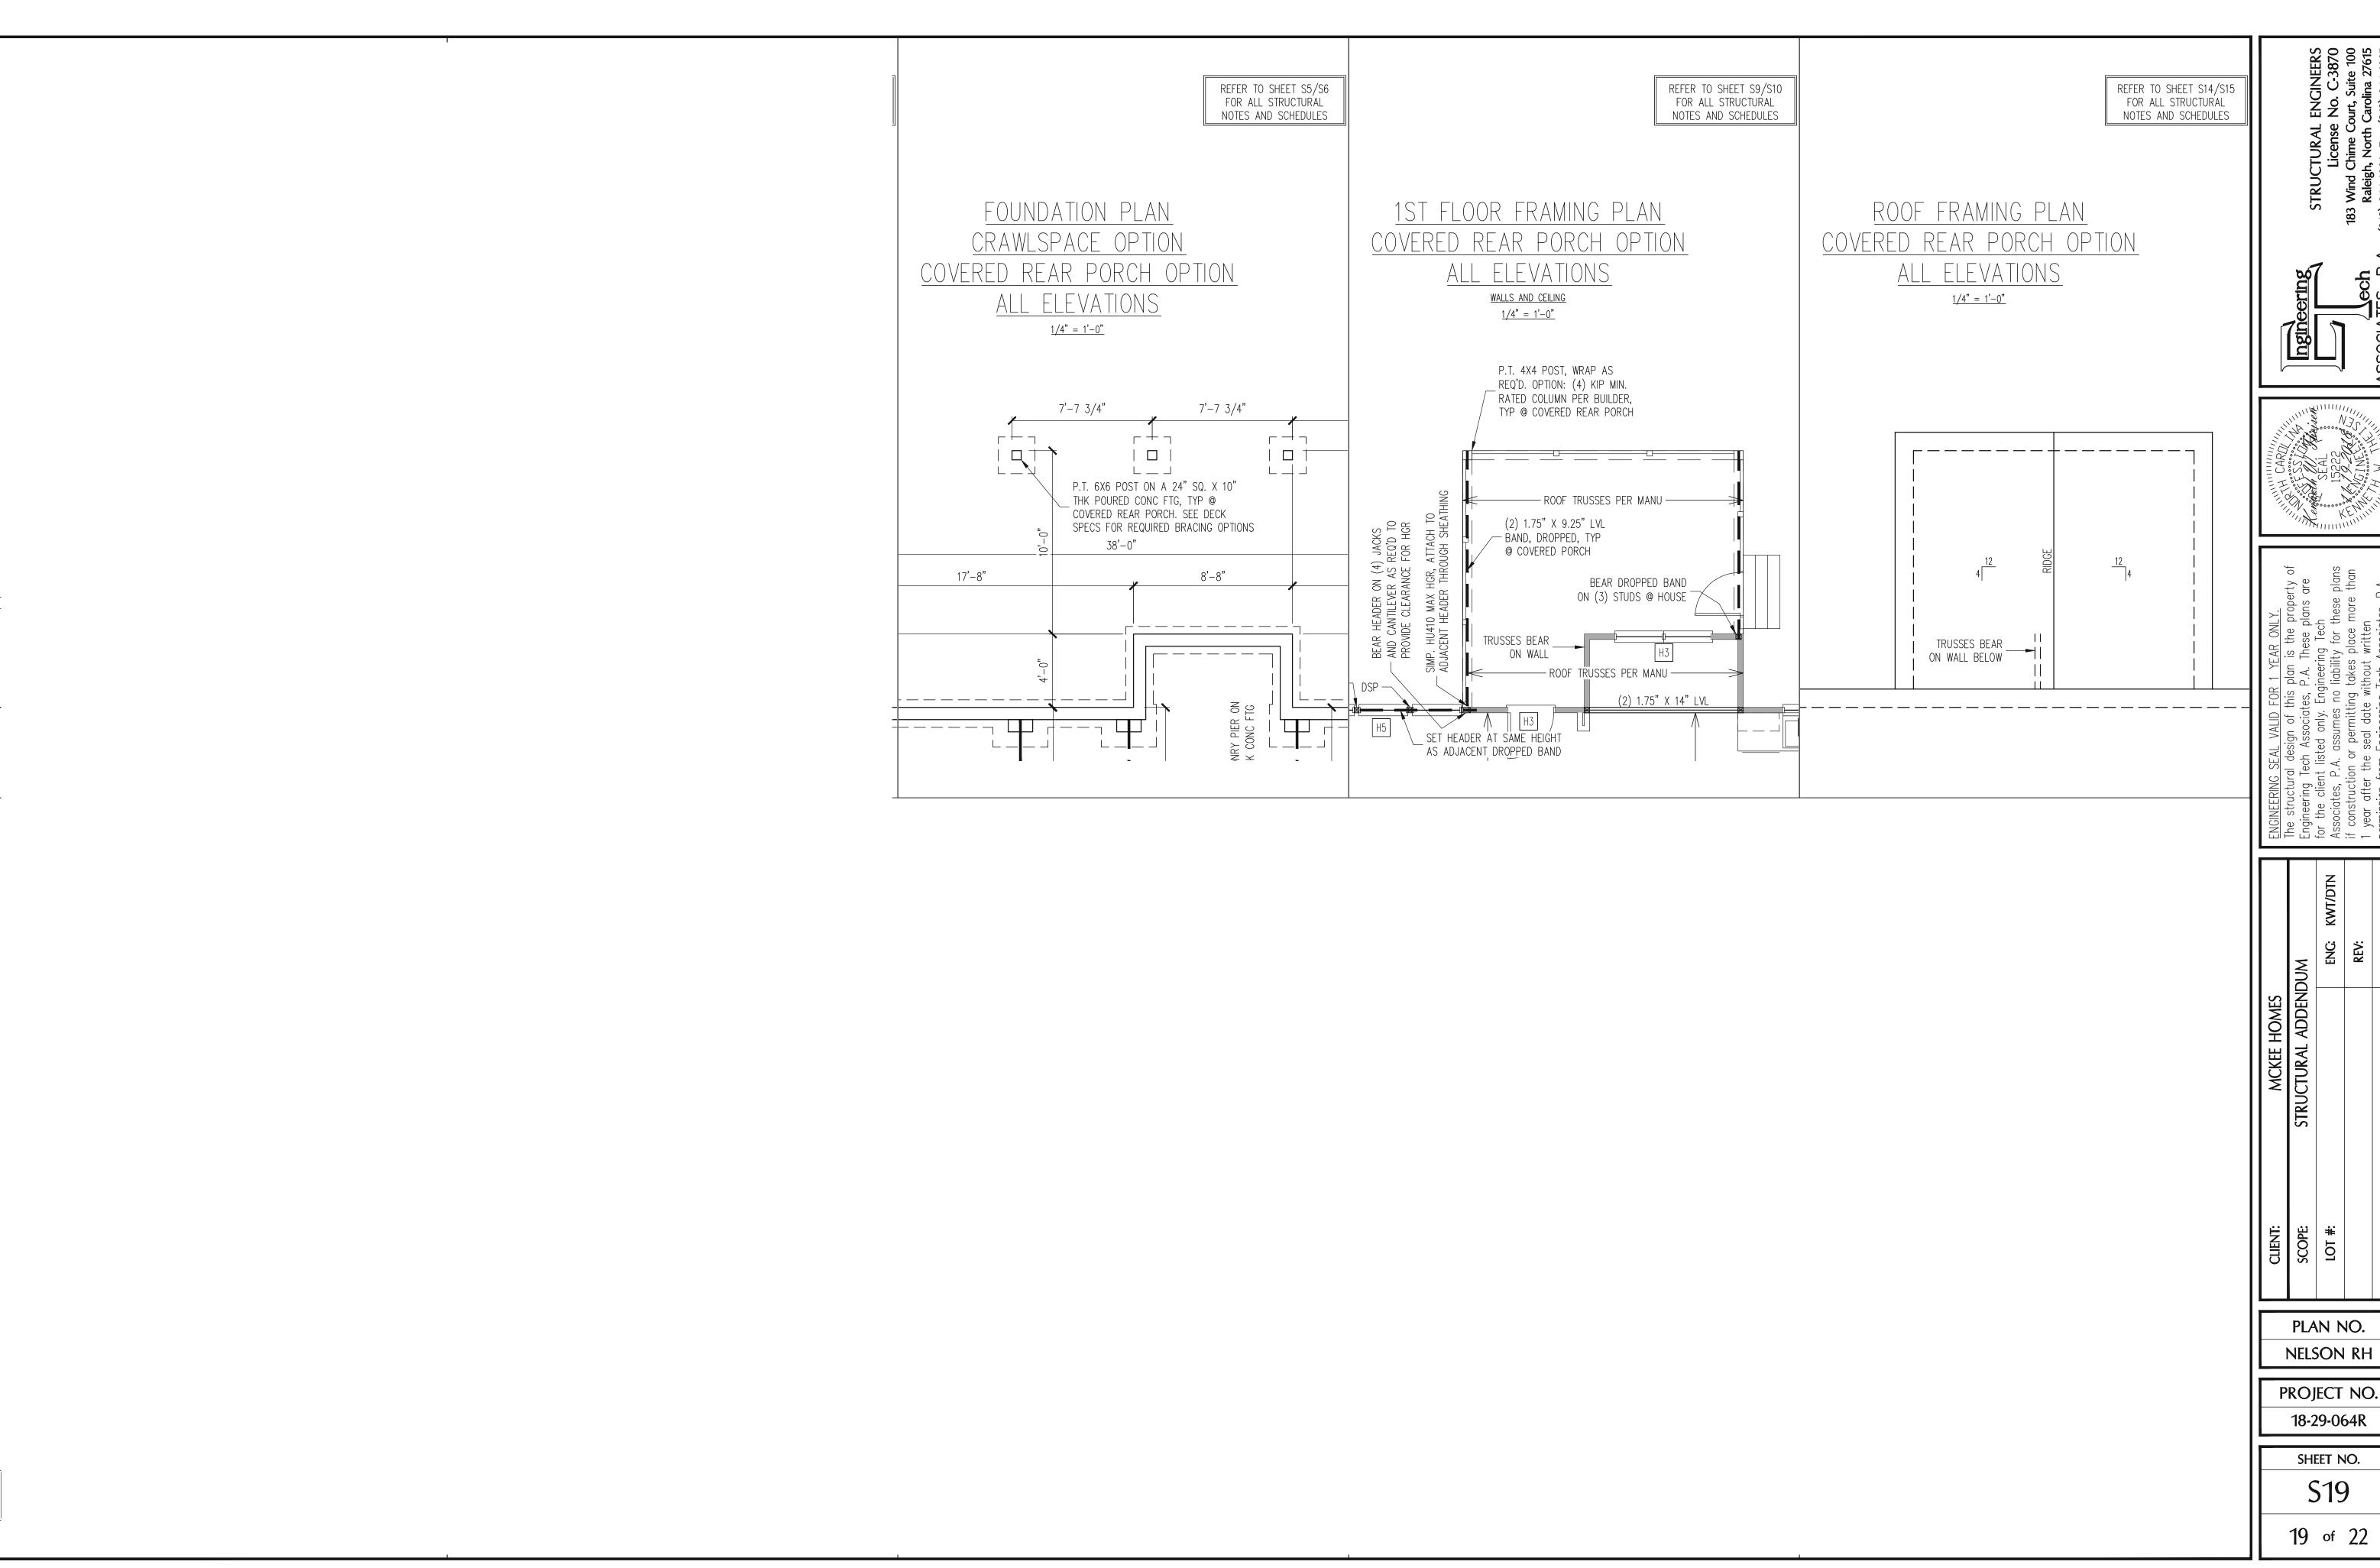

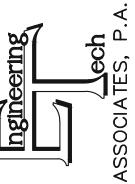


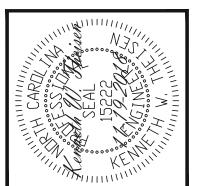



PLAN NO.

PROJECT NO. 18-29-064R

S19

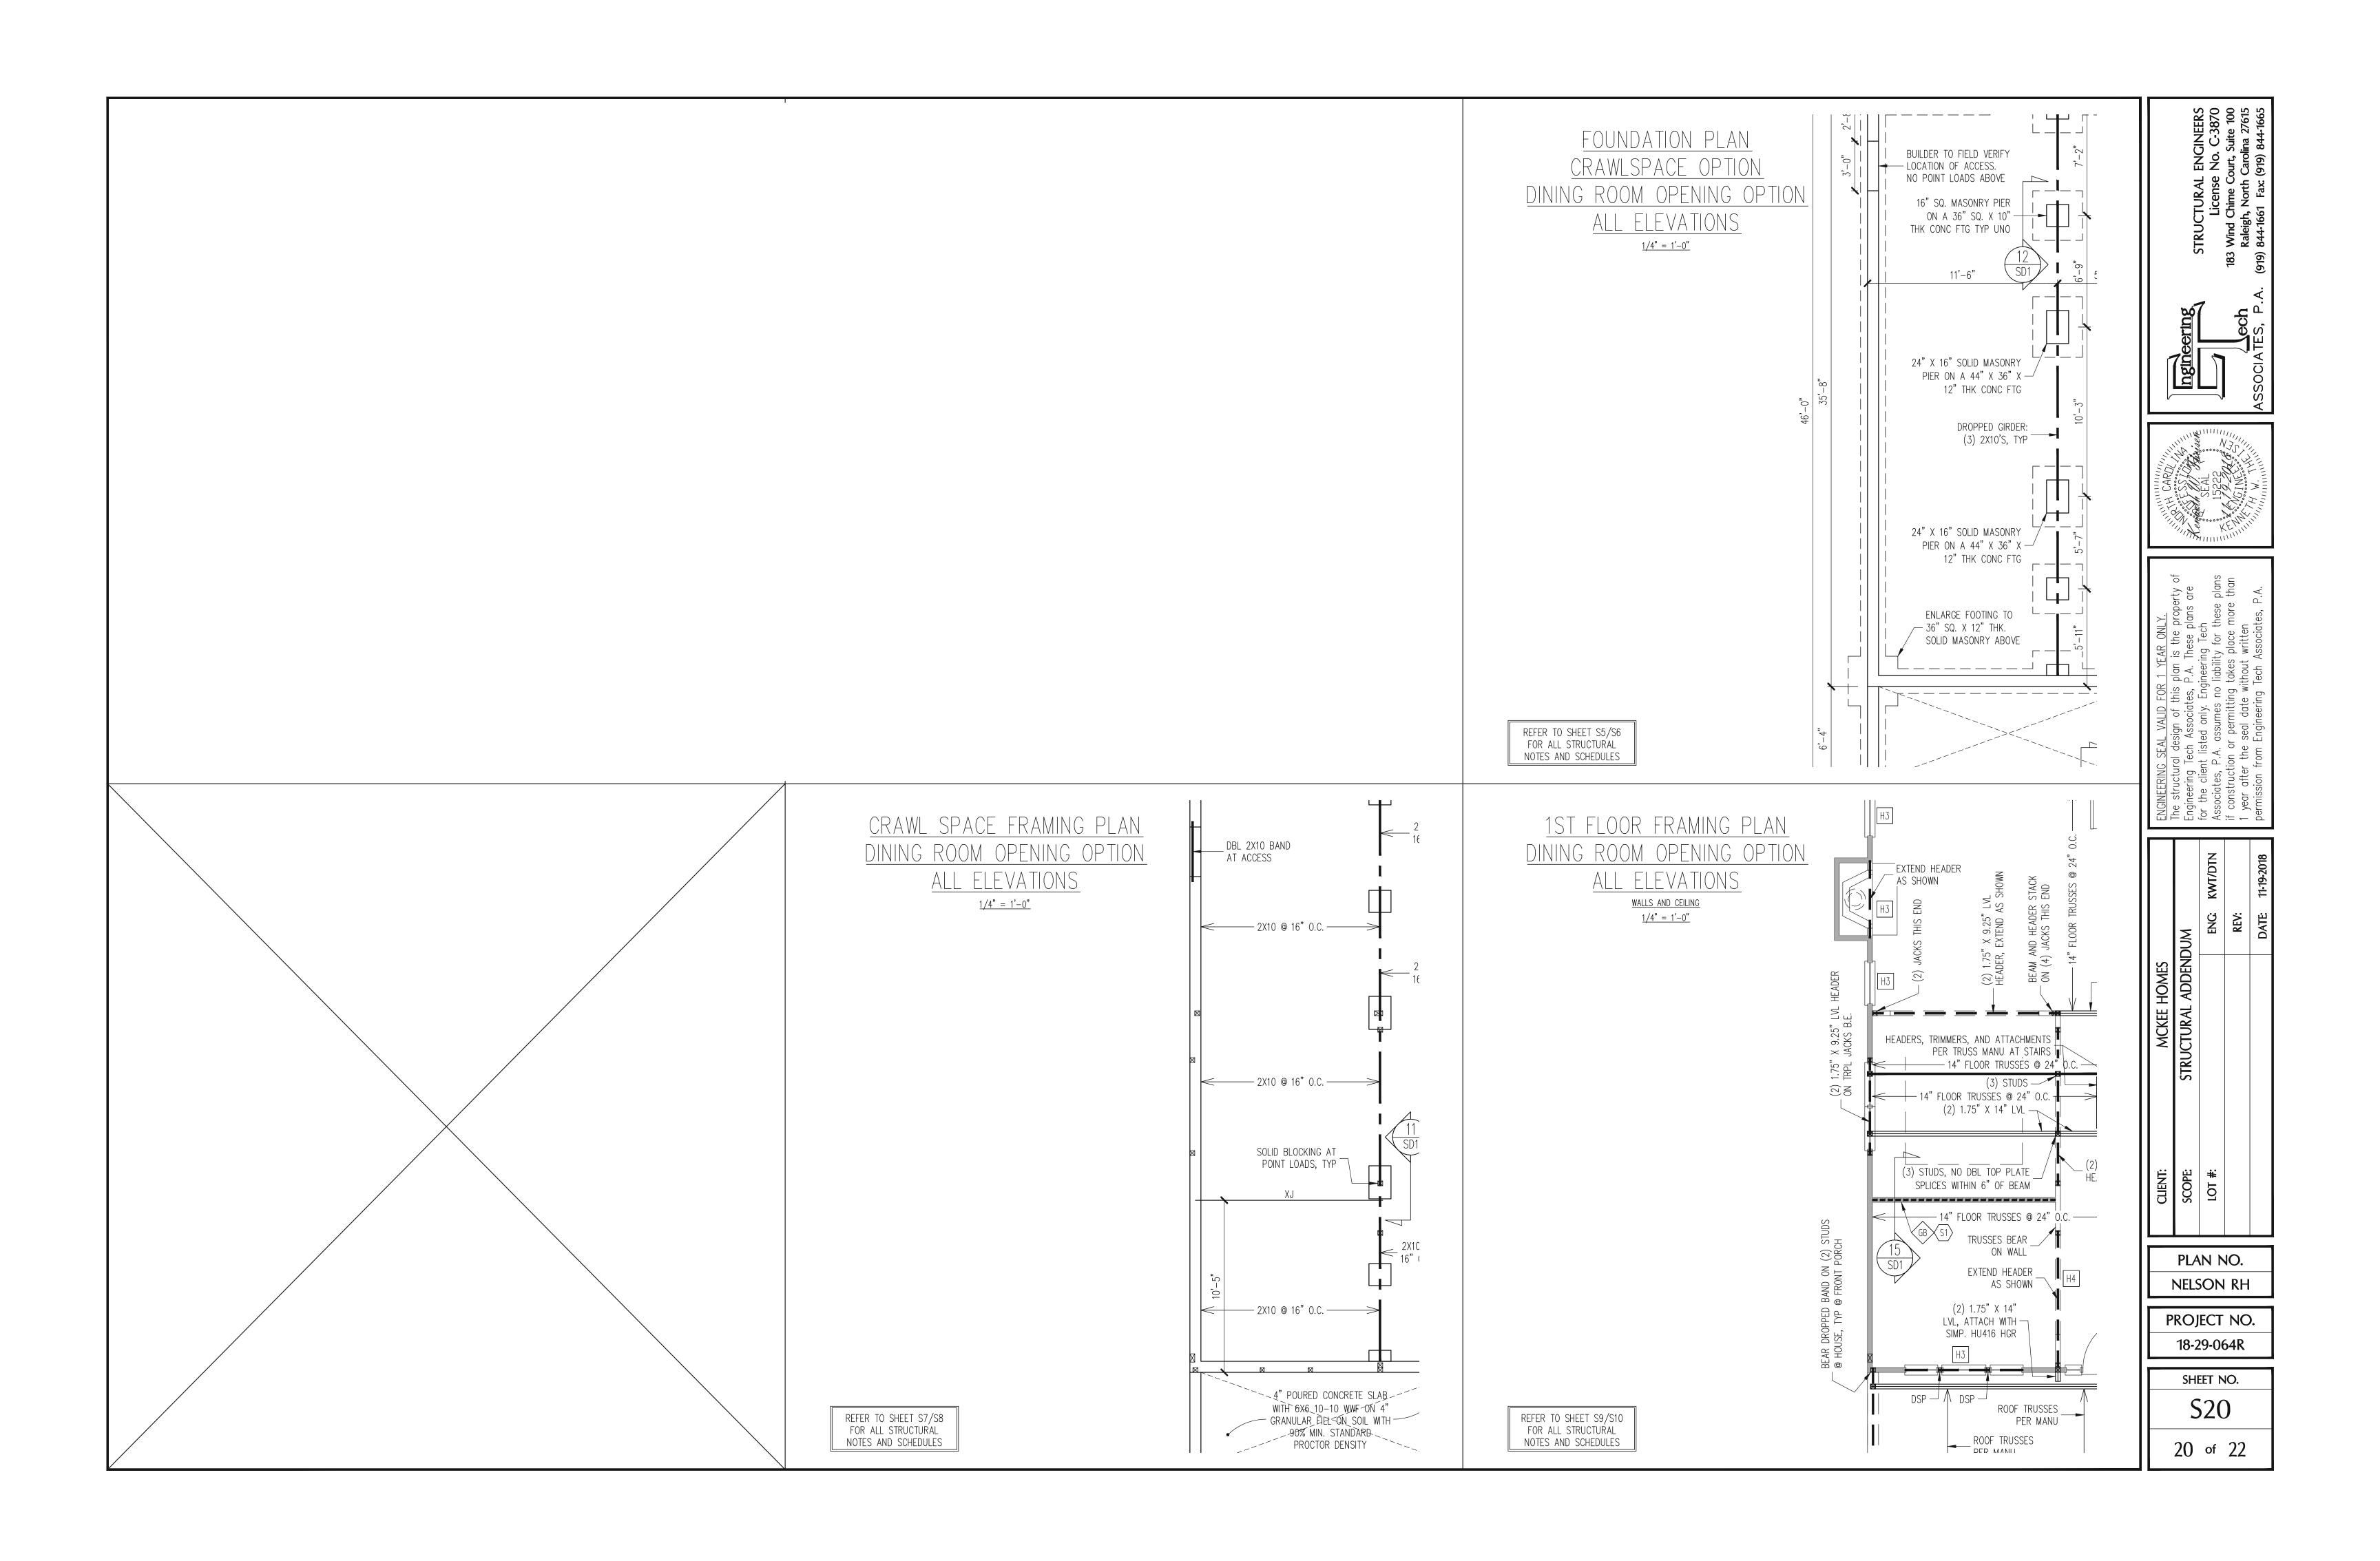

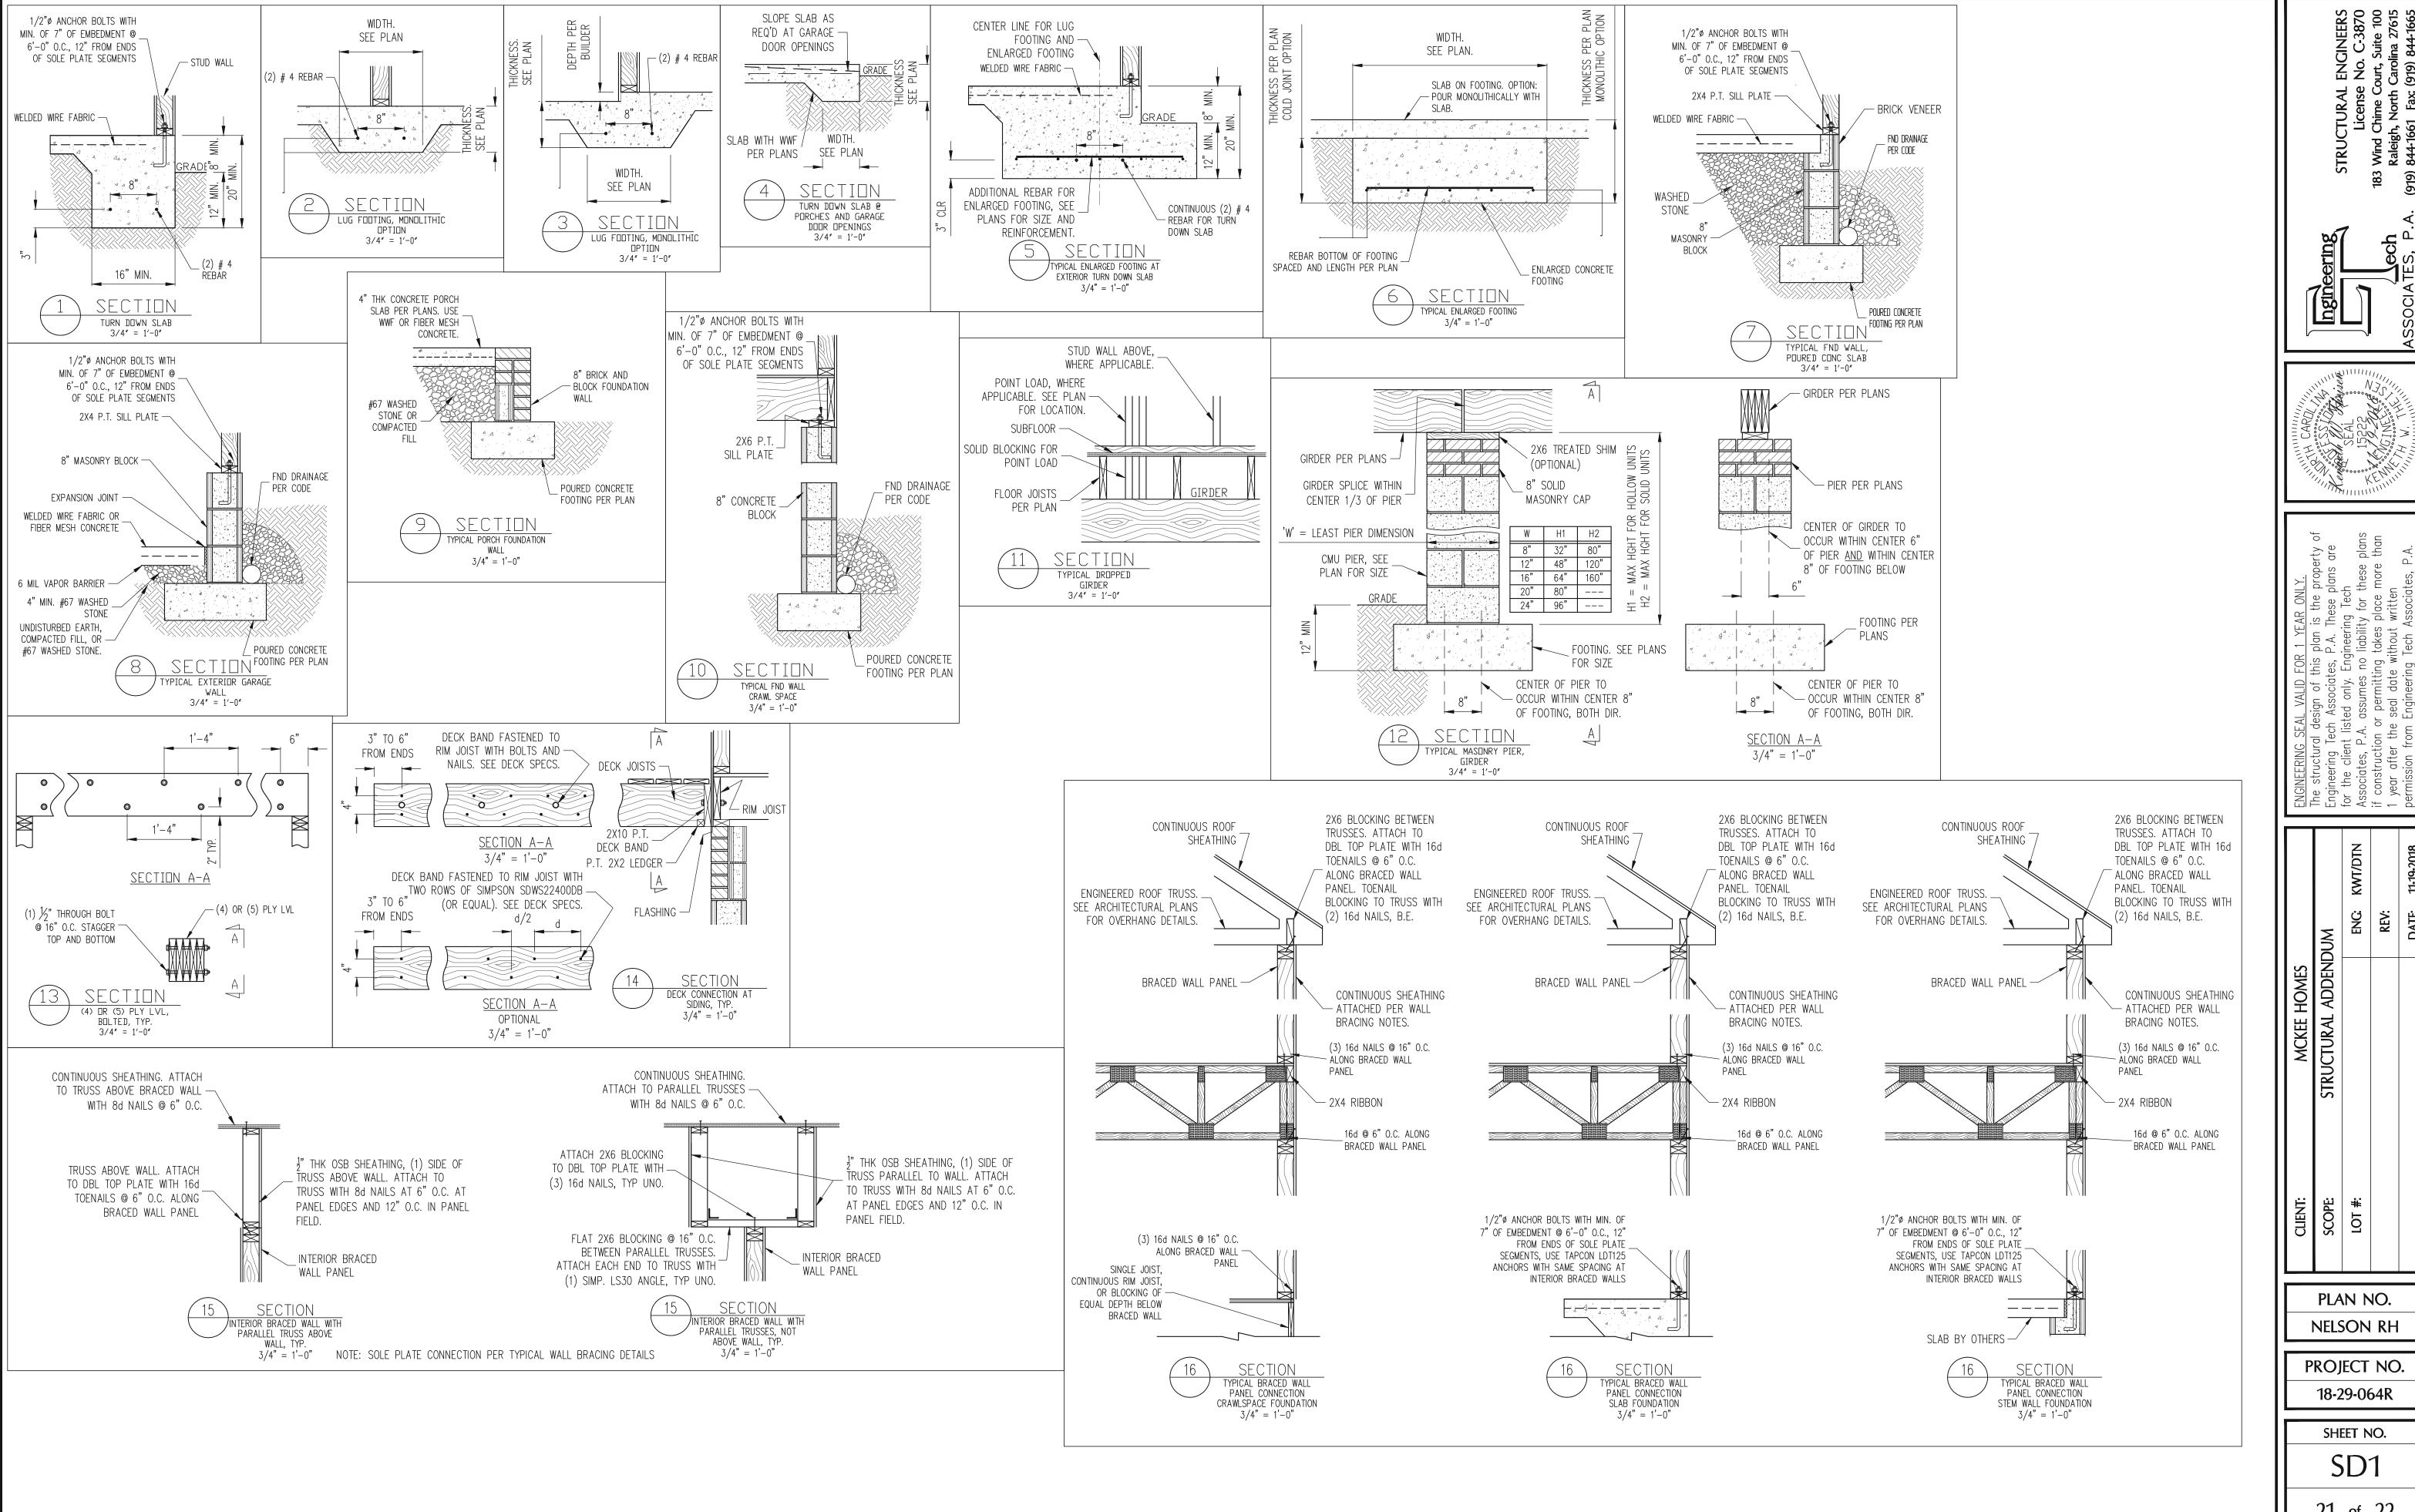


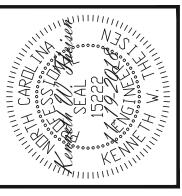

PLAN NO. **NELSON RH**

PROJECT NO. 18-29-064R

SHEET NO.

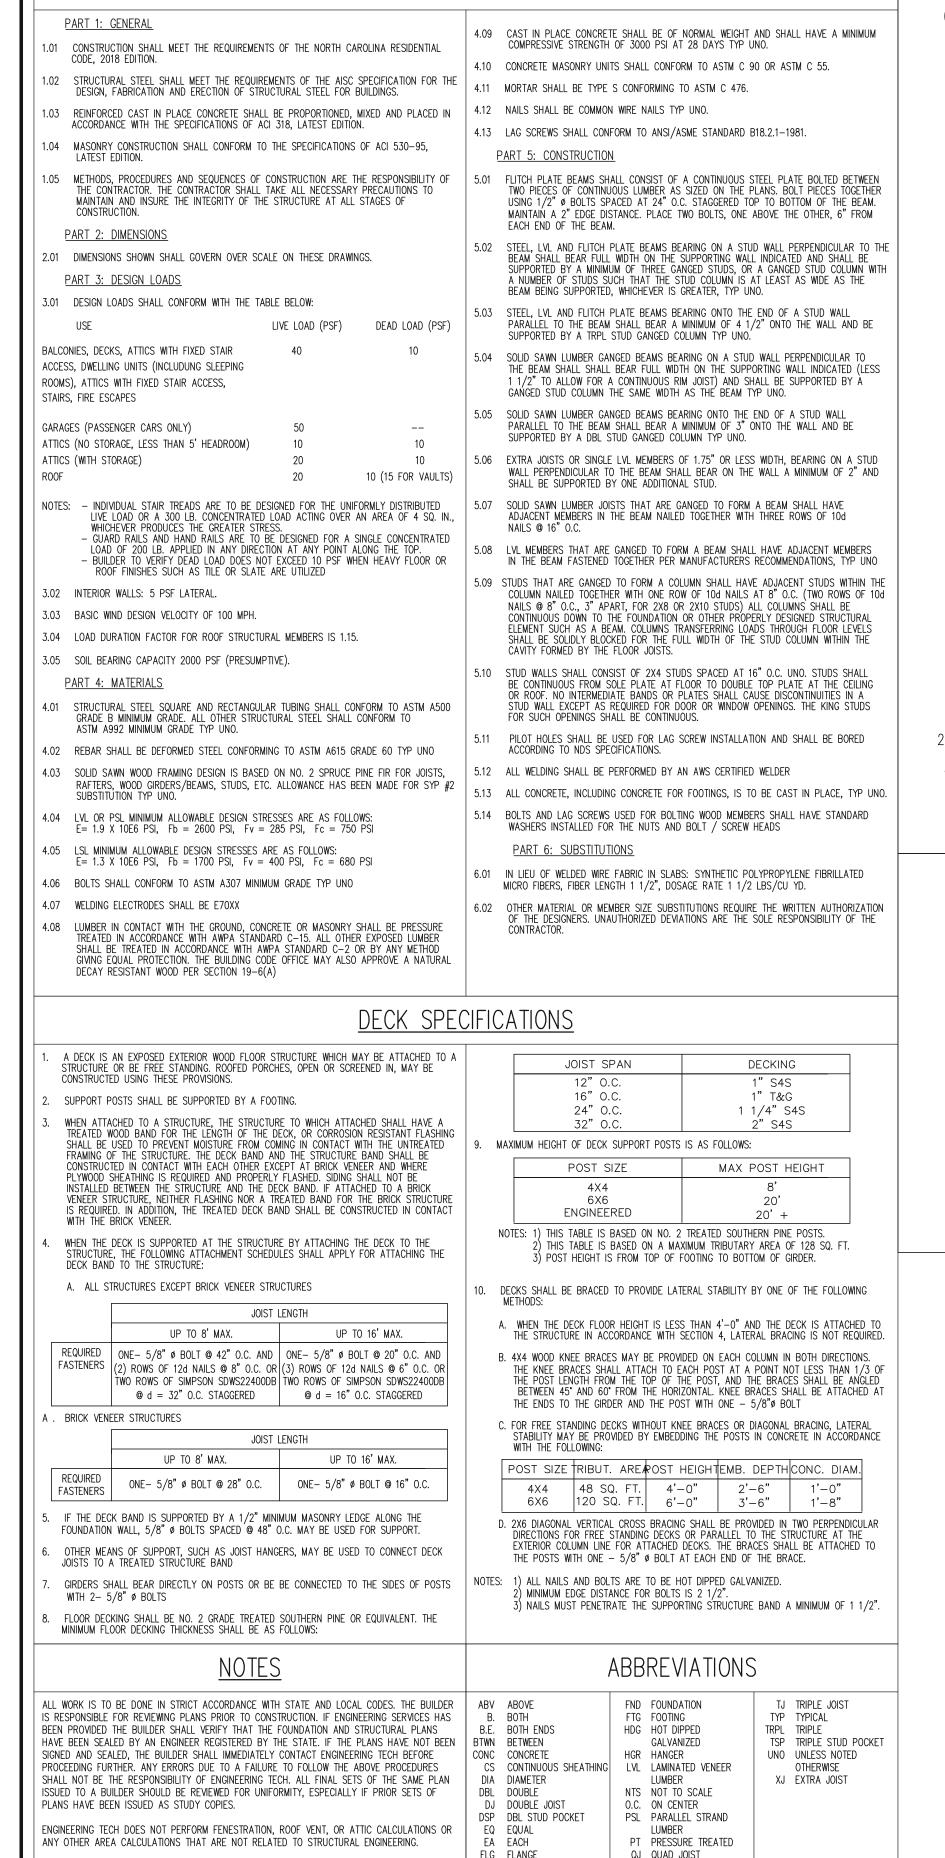

I FL PL FLITCH PLATE

FLR FLOOR


SP STUD POCKET

SQ SQUARE

TRUSSES TO BE DESIGNED BY AN ENGINEER REGISTERED IN NORTH CAROLINA. FINAL TRUSS

DRAWING SHOULD BE SUBMITTED TO ENGINEERING TECH ASSOCIATES, PA FOR REVIEW

CONSTRUCTION SPECIFICATIONS

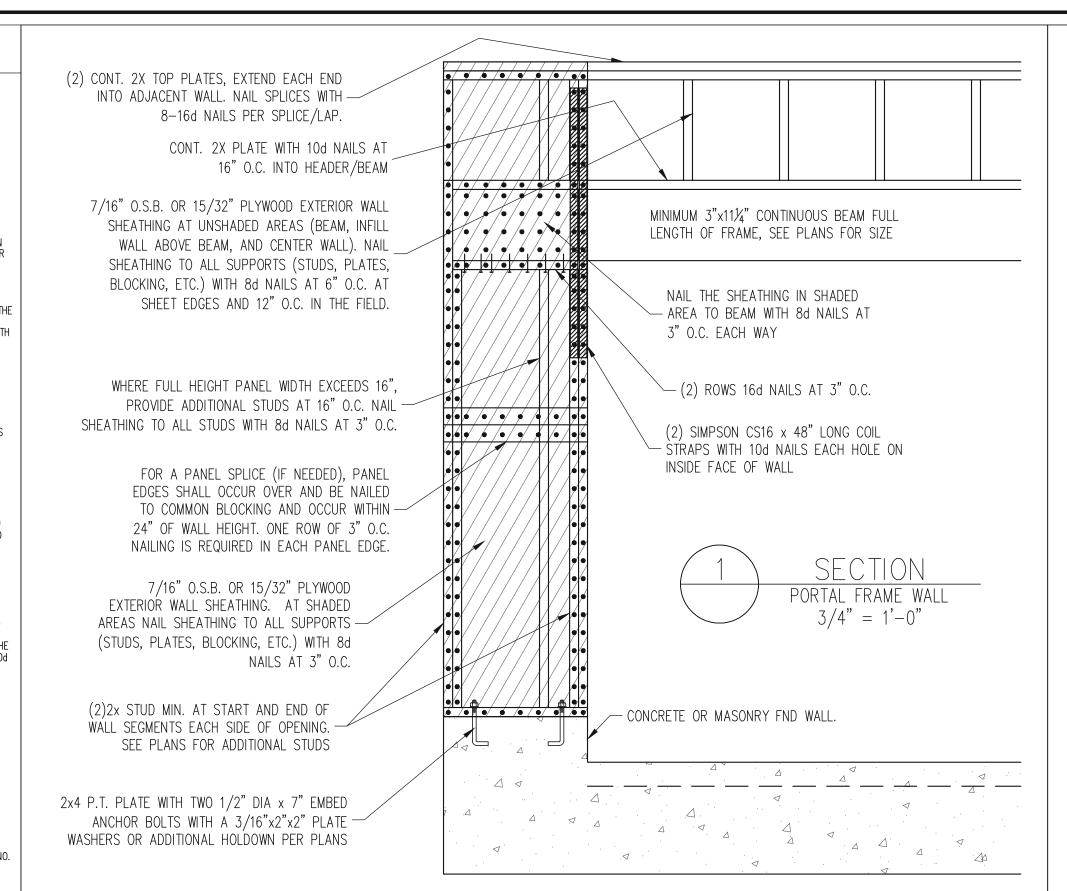

TRUSS GIRDER

SOUTHERN YELLOW PINE

DBL TOP PLATE ABOVE


SUPPORT STUDS


PER MANU

- SIMP. LGT2

SUPPORT STUDS

PER PLAN

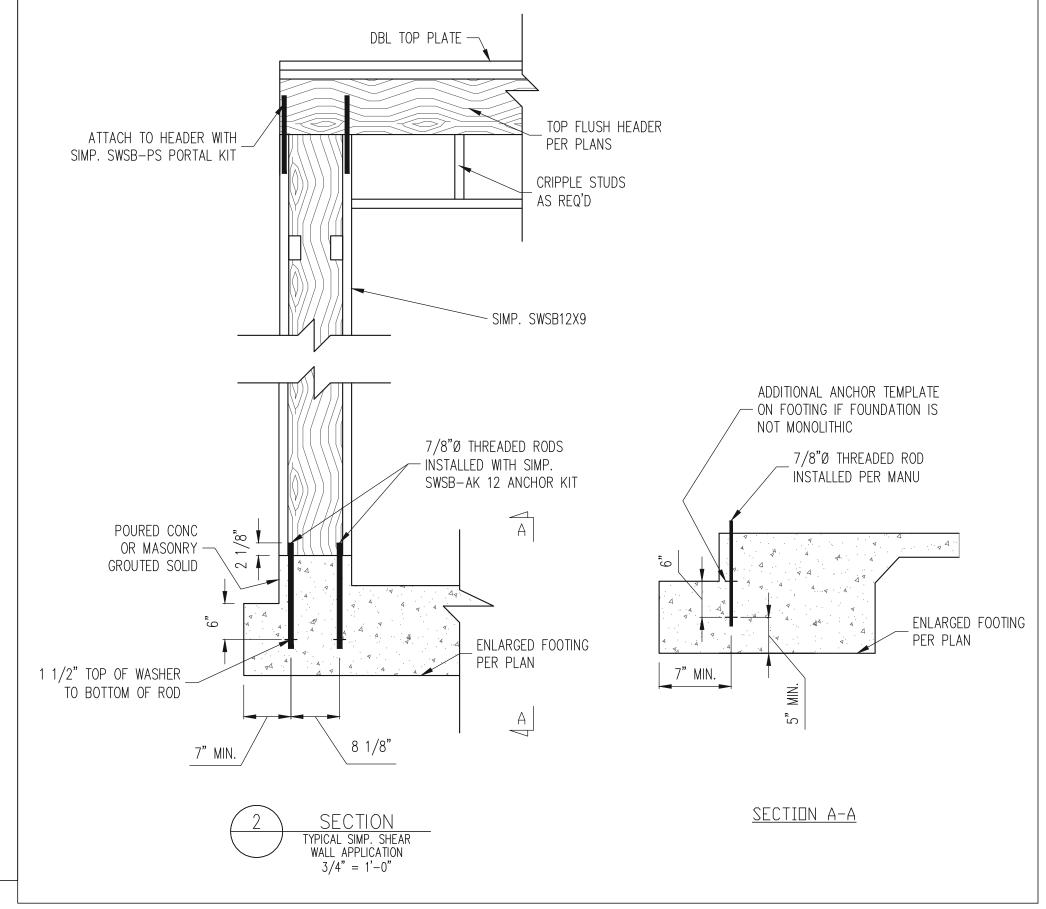

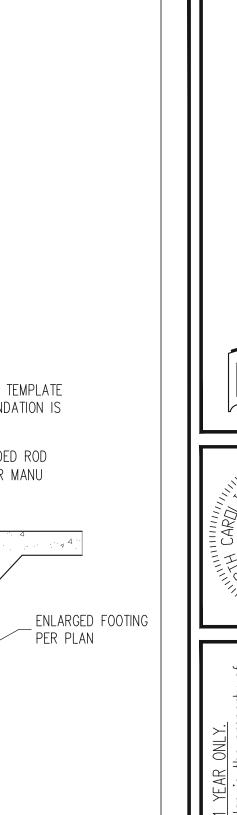

PLAN NO. NELSON RH

PROJECT NO. 18-29-064R

SHEET NO.