ABBREVIATIONS INDEX ABV ABOVE A/C AIR CONDITIONING A/D. AREA DRAIN A/J. ADJISTABLE ALT ALTERNATE ALIM ALIMINM ARCH. ARCHITECTURAL BA BATHROOM BD BOARD BF BI-FOLD (DOOR) L LENGTH LA LAUNDRY LAV LAVATORY LVR LOUVER MAX MAXIMUM MECH MECHANICAL MER. MANUFACTURER MIN MINIMUM MISC MISCELLANEOUS TITLE SHEET / COVER SHEET STRUCTURAL IST FLOOR PLAN A-I.I CRAWL FOUNDATION PLAN BF BI-FOLD (DOOR) BLD BULDING BLK BLOOK (CMUs) BLH BELON BM BEAM BP BI-PASS (DOOR) BOT BOTTOM BTINN BETWEEN CAB CABULET MISC MISCELLAMEOUS N NORTH CALE OGD. OVERHEAD GARAGE DOOR OH OVERHEAD OF OPTIONAL PAR PARALLE. PJB. PLGH BUTTON PIDE POWDER PED PEDESTAL 9-la A-1.1.1 IST FLOOR PLAN MONO SLAB FOUNDATION PLAN S-lb A-I.I.2 IST FLOOR PLAN STEM WALL FOUNDATION PLAN S-Ic SECOND FLOOR FRAMING PLAN A-I.2 2ND FLOOR PLAN 5-2 CAB CABINET CER CERAMIC POR POWDER PED PEDESTAL PL PLATE PR PAIR PLATE PY PAIR PLATE PY PAIR PALYWINT CHLORIDE PIPE PAYT PAYEMENT PY PRESSARE PY PAYEMENT PY PRESSARE PY PAYEMENT PY PRESSARE PY PAYEMENT PY PRESSARE PY PAYEMENT PY PAYEM A-I.2.I 2ND FLOOR PLAN 5-3 ATTIC FLOOR FRAMING PLAN CER GERANIC C.J. CONTROL JOINT OR CONSTRUCTION JOINT CL (LOSET OR CENTER LINE CLE CLEAR CLEAR COLLOWERTE MASONRY UNIT COLL COLLOW CONCECTE MASONRY UNIT COLL CONCECTE CAREETE CREATERSON RESISTANT CERT CAREATE CHECK CONCECTE CHECK 5-4 CEILING FRAMING PLAN SECTIONS S-5 ROOF FRAMING PLAN A-I.4 BRACED WALL NOTES AND DETAILS DETAILS EXTERIOR ELEVATIONS 'COASTAL' A-150 STRUCTURAL NOTES C.T. CERAMIC TILE D DRYER DRI DOUBLE HIMS DIM DIMENSION DISP DISPOSAL DN DOWN DS DOWNSPOUT DW DISH WASHER DWG DRAWING E EAST EA EACH REPRISON REP A-1.5.1 EXTERIOR FLEVATIONS GOASTAL EXTERIOR ELEVATIONS 'COASTAL' A-I.5.2 TOTAL SHEETS EXTERIOR ELEVATIONS 'COASTAL A-I.5.3 EXTERIOR ELEVATIONS 'COASTAL' A-I.5.4 A-I.5.5 ROOF PLAN COASTAL A-1.6.0 EXTERIOR ELEVATIONS 'TRADITIONAL' ELEV ELEVATION ELEC ELECTRICAL ELECTRICAL EST ELECTRICAL EST EDITERIOR ENT FALL EXT EXTERIOR FALL FALL EXT EXTERIOR FALL FILOR EXTERIOR ELEVATIONS 'TRADITIONAL' A-161 A-I.6.2 EXTERIOR ELEVATIONS 'TRADITIONAL A-I.6.3 EXTERIOR ELEVATIONS 'TRADITIONAL EXTERIOR ELEVATIONS 'TRADITIONAL' A-I.6.4 ROOF PLAN 'TRADITIONAL' A-165 EXTERIOR ELEVATIONS 'CRAFTSMAN' A-1.7.0 A-171 EXTERIOR ELEVATIONS 'CRAFTSMAN' WIG WALK-IN CLOSET W WO WITH OR WITHOUT A-I.7.2 EXTERIOR ELEVATIONS OPTIONS WP WATERPROOF(ING) WWM WELDED WIRE MESH A-1.7.3 EXTERIOR ELEVATIONS OPTIONS #L PROPERTY LINE Ø ROUND / DIAMETER A-1.7.4 EXTERIOR ELEVATIONS OPTIONS HD HEAD OR HARD HDR HEADER HGT HEIGHT HVAC HEATING/PAITLATING/AIR COND. HVD HARDWOOD JITI INTERIOR JGT JOJGT LJUNT KIT KITCHEN A-1.7.5 EXTERIOR ELEVATIONS OPTIONS A-1.7.6 EXTERIOR ELEVATIONS OPTIONS ROOF PLAN 'CRAFTSMAN' A-177 BUILDING CODE COMPLIANCE A-I.8.0 EXTERIOR ELEVATIONS 'EURO' PROJECT INFORMATION A-I.8.I EXTERIOR ELEVATIONS 'EURO' A-I.8.2 EXTERIOR ELEVATIONS 'EURO' ALL CONSTRUCTION TO COMPLY WITH LOCAL CODES AND ORDINANCES EXTERIOR ELEVATIONS 'EURO' CURRENTLY IN USE WITH THE LOCAL JURISDICTION. A-I.8.3 A-I.8.4 EXTERIOR ELEVATIONS 'EURO' APPLICABLE CODES: FOLLOW ALL APPLICABLE STATE AND LOCAL CODES. 2012 NORTH CAROLINA STATE SUPPLEMENTS AND AMENDMENTS A-I.8.5 ROOF PLAN 'EURO' CONTRACTOR AND BUILDER SHALL REVIEW ENTIRE PLAN TO VERIFY CONFORMANCE WITH ALL CURRENT APPLICABLE CODES IN EFFECT AT TIME OF CONSTRUCTION. BY USING THESE DRAWINGS FOR CONSTRUCTION IT IS UNDERSTOOD THAT CONFORMANCE WITH ALL APPLICABLE CODES IS THE RESPONSIBILITY OF THE BUILDER AND CONTRACTOR. FLO IST FLOOR UTILITY PLAN EI.I IST FLOOR UTILITY PLAN E2.0 2ND FLOOR UTILITY PLAN SINGLE FAMILY RESIDENCE / 3 STORY TOWNHOMES OCCUPANCY CLASSIFICATION CONSTRUCTION TYPE TYPE VB (2 HOUR DWELLING SEPARATION BETWEEN UNITS.) ALL CONSULTANT DRAWINGS ACCOMPANYING THESE GMD DESIGN GROUP DRAWINGS HAVE NOT BEEN PREPARED BY OR UNDER THE DIRECTION OF GMD DESIGN GROUP, INC. GMD DESIGN GROUP INC. THEREFORE ASSUMES NO LIABILITY FOR THE COMPLETENESS OR CORRECTNESS OF THESE DRAWINGS GENERAL NOTES DESIGNER NORTH CAROLINA:

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PROJECT TITLE:

The Winston

CONSULTANTS:

CONTACT: XXXX XXXXX

EMAIL: XXXXXXX

BUILDER SET:

BUILDER: LOCAL JURISDICTION: DESIGNER: MCKEE HOMES GMD DESIGN GROUP STREET ADDRESS CITY, STATE ZIP CODE 120 NANDINA COURT FAYETTEVILLE, NC 28311 108 S. SALEM ST. SUITE 203 APEX, NC 27502 PHONE: (919) 320-3022 CONTACT: SCOTT GARDENER PHONE: (XXX)XXX-XXXX CONTACT: XXXX XXXXX EMAIL: SCOTT@GMDDESIGNGROUP.COM EMAII . XXXXXXX MEP ENGINEERS: CIVIL ENGINEER: STRUCTURAL ENGINEER: NAME STREET ADDRESS CITY, STATE ZIP CODE STREET ADDRESS CITY, STATE ZIP CODE STREET ADDRESS CITY, STATE ZIP CODE PHONE: (XXX)XXX-XXXX PHONE: (XXX)XXX-XXXX PHONE: (XXX)XXX-XXXX

CONTACT: XXXX XXXXX

EMAIL: XXXXXXX

CLIENTS NAME

CONTACT: XXXX XXXXX

EMAIL: XXXXXXX

AREA CALCULATIONS:

FOR CONSTRUCTION

13036RAL

TITLE SHEET

November 28, 2016

THESE DOCUMENTS ARE THE PROPERTY OF THE DESIGNER AND SHALL NOT BE COPIED, DUPLICATED, ALTERED, MODIFIED OR REVISED IN ANY WAY WITHOUT THE EXPRESSED WRITTEN APPROVAL OF THE DESIGNER.

CONTRACTOR SHALL VERIFY ALL CONDITIONS AND DIMENSIONS AT THE SITE AND ALL INCONSISTENCES SHALL BE BROUGHT TO THE ATTENTION OF THE DEVELOPER AND THE DESIGNER BEFORE PROCEEDING WITH WORK.

ANY ERRORS OR OMISSIONS FOUND IN THESE DRAWINGS SHALL BE BROUGHT TO

DO NOT SCALE DRAWINGS. WRITTEN DIMENSIONS TAKE PRECEDENCE OVER SCALED ALL DIMENSIONS ARE TO FACE OF STUD OR TO FACE OF FRAMING UNLESS

ALL TRUSS DRAWINGS TO BE REVIEWED AND APPROVED BY THE STRUCTURAL ENGINEER PRIOR TO ISSUANCE OF BUILDING PERMIT.

ALL OR EQUAL SUBSTITUTIONS MUST BE SUBMITTED TO AND APPROVED BY CITY

ALL ANGLED PARTITIONS ARE 45 DEGREES UNLESS OTHERWISE NOTED. PROVIDE FIREBLOCKING, (PER LOCAL CODES.)

ALL ELECTRICAL AND MECHANICAL EQUIPMENT AND METERS ARE SUBJECT TO RELOCATION DUE TO FIELD CONDITIONS, CONTRACTOR TO VERIFY.

PROVIDE BLOCKING AND/OR BACKING AT ALL TOWEL BAR, TOWEL RING AND/OR TOILET PAPER HOLDER LOCATIONS, AS SHOWN PER PLAN. TYPICAL AT ALL BATHROOMS AND POWDER ROOMS. VERIFY LOCATIONS AT FRAMING WALK.

ELASTOMERIC SHEET WATERPROOFING: FURNISH AND INSTALL ALL WATERPROOFING COMPLETE. A 40 MIL. SELF-ADHERING MEMBRANE OF RUBBERIZED ASPHALT INTEGRALLY BONDED TO POLYETHYLENE SHEETING, OR EQUAL. INSTALL PER MANUFACTURE'S AND TRADE ASSOCIATION'S PRINTED
INSTALLATION INSTRUCTIONS, 6" MINIMUM LAP AT ALL ADJACENT WALL SURFACES.

TO THE BEST OF THE DESIGNER'S KNOWLEDGE THESE DOCUMENTS ARE IN CONFORMANCE WITH THE REQUIREMENTS OF THE BUILDING AUTHORITIES HAVING JURISDICTION OVER THIS TYPE OF CONSTRUCTION AND OCCUPANCY.

SHOP DRAWING REVIEW AND DISTRIBUSTION, ALONG WITH PRODUCT SUBMITTALS, REQUESTED IN THE CONSTRUCTION DOCUMENTS, SHALL BE THE SOLE RESPONSIBILITY OF THE GENERAL CONTRACTOR, UNLESS DIRECTED OTHERWISE UNDER A SEPARATE AGREEMENT.

DEVIATIONS FROM THESE DOCUMENTS IN THE CONSTRUCTION PHASE SHALL BE REVIEWED BY THE DESIGNER AND THE OWNER PRIOR TO THE START OF MORK IN QUESTION. ANY DEVIATIONS FROM THESE DOCUMENTS WITHOUT PRIOR REVIEW, SHALL BE THE SOLE RESPONSIBILITY OF THE GENERAL CONTRACTOR.

THE GENERAL CONTRACTOR SHALL BE RESPONSIBLE FOR ALL WORK AND MATERIALS REPRESENTED ON THESE DOCUMENTS INCLUDING THE WORK AND MATERIALS FURNISHED BY SUBCONTRACTORS AND VENDORS. THE BUILDER SHALL FURNISH ANY AND ALL REPORTS RECEIVED FROM THE

GEOTECHNICAL ENGINEER (SOILS REPORT), ON THE STUDY OF THE PROPOSED SITE, TO THE DESIGNER, STRUCTURAL ENGINEER, AND GENERAL CONTRACTOR. IN THE EVENT THE GEOTECHNICAL REPORTS DO NOT EXIST, THE SOILS CONDITION SHALL BE ASSUMED TO BE A MINIMUM DESIGN SOIL PRESSURE STATED BY THE STRUCTURAL ENGINEER OF RECORD FOR THE PURPOSE OF STRUCTURAL DESIGN. GENERAL CONTRACTOR SHALL ASSURE THE SOIL CONDITIONS MEET OR EXCEED

ALL WORK PERFORMED BY THE GENERAL CONTRACTOR SHALL COMPLY AND CONFORM WITH LOCAL AND STATE BUILDING CODES, ORDINANCES AND REGULATIONS, ALONG MITH ALL OTHER AUTHORITIES HAVING JURISDICTION. THE GENERAL CONTROLTOR IS RESPONSIBLE TO BE AWARE OF THESE REGUIREMENTS AND GOVERNING REGULATIONS

PROVIDE AN APPROVED WASHER DRAIN PAN AT SECOND FLOOR ONLY

WINDOW SUPPLIER TO VERIFY AT LEAST ONE WINDOW IN ALL BEDROOMS TO HAVE A CLEAR OPENABLE AREA OF 4.0 50 FT. THE MINIMUM NET CLEAR OPENING HEIGHT SHALL BE 22" AND THE MINIMUM NET CLEAR OPENING MIDTH SHALL BE 20", GLAZING TOTAL AREA OF NOT LESS THAN 5.0 50 FT IN THE CASE OF A GROUND WINDOW AND NOT LESS THAN 5.75 SO FT IN THE CASE OF AN UPPER STORY WINDOW (PER NORG SECTION R3IO.L.)

ALL HANDRAIL BALLIGHTERS TO BE SPACED SUCH THAT A 4" SPHERE CANNOT PASS BETHEEN BALLIGHTERS. (PER LOCAL CODES) PROVIDE STAIR HANDRAILS AND GUARDRAILS PER

NECESSARILY DESCRIBED. THE PLANS DELINEATE AND DESCRIBE ONLY LOCATIONS, DIMENSIONS, TYPES OF MATERIALS, AND GENERAL METHODS OF ASSEMBLING OR FASTENING. THEY ARE NOT INTENDED TO SPECIFY PARTICULAR PRODUCTS OR OTHER METHODS OF ANY SPECIFIC MATERIALS, PRODUCT OR METHOD. THE IMPLEMENTATION OF THE PLANS REQUIRES ALIENT / CONTRACTOR THOROUGHLY KNOWLEDGEABLE WITH THE APPLICABLE BUILDING CODES AND METHODS OF CONSTRUCTION SPECIFIC TO THIS PRODUCT TYPE AND TYPE OF CONSTRUCT CONSTRUCTION REQUIREMENTS AND QUALITY: PROVIDE WORK OF THE SPECIFIC QUALITY

CONSTRUCTION REQUIREMENTS AND QUALITY: PROVIDE MORK OF THE SPECIFIC QUALITY; WHERE QUALITY LEVEL IS NOT INDICATED, PROVIDE WORK OF QUALITY CUSTOMARY IN SIMILAR TYPES OF WORK, WHERE THE PLANS AND SPECIFICATIONS, CODES, LAVE, REQULATIONS, MANUFACTURER'S RECOMMENDATIONS OR INDUSTRY STANDARDS REQUIRE WORK OF HIGHER QUALITY OR PERFORMANCE, PROVIDE WORK COMPLYING WITH THOSE REQUIREMENTS AND QUALITY. WHERE TWO OR MORE QUALITY PROVISIONS OF THOSE REQUIREMENTS CONFLICT WITH THE TWO ST STRINGENT REQUIREMENT, WHERE REQUIREMENTS ARE DIFFERENT BUT APPARENTLY EQUILA, AND WHERE IT IS INCERTAIN WHICH REQUIREMENT IS MOST STRINGENT, OBTAIN CLASSIFICATION OF THE STRINGENT, OBTAIN CLASSIFICATION OF THE PROVISION O CLARIFICATION FROM THE GMD DESIGN GROUP BEFORE PROCEEDING

THE SCOPE OF THIS SET OF PLANS IS TO PROVIDE A "BUILDER'S SET"
OF CONSTRUCTION DOCUMENTS AND GENERAL NOTES HEREINAFTER REFERRED TO AS "PLANS"
THIS SET OF PLANS IS SUFFICIENT TO OBTAIN A BUILDING PERMIT; HOWEVER, ALL MATERIALS

AND METHODS OF CONSTRUCTION NECESSARY TO COMPLETE THE PROJECT ARE NOT

NECESSARILY DESCRIBED THE PLANS DELINEATE AND DESCRIBE ONLY LOCATIONS

SHEET TITLE

FOR ADDITIONAL NOTES SEE GENERAL NOTES ON TITLE SHEET AND DETAILS. WINDOW HEAD HEIGHTS: IST FLOOR = 7'-8" U.N.O. ON ELEVATIONS.

2ND FLOOR = 6'-10" U.N.O. ON ELEVATIONS.
ALL DIMENSIONS TO MINDOWS AND DOORS ARE TO CENTERLINE.

MALL LEGEND:

FULL HEIGHT 2X4 WOOD STUD PARTITION

FULL HEIGHT 2X6 WOOD STUD PARTITION

STUD WALL BELOW HEIGHT AND STUD SIZE AS NOTED BRICK / STONE VENEER

DRYWALL OPENING. HEIGHT AS NOTED ON PLAN.

KEY NOTES FOR NORTH CAROLINA:

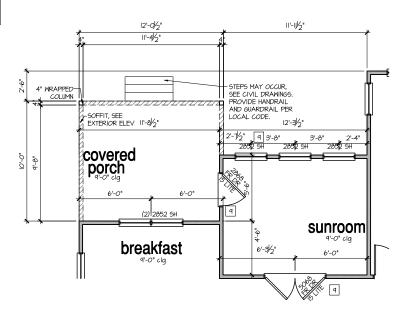
FIRE PROTECTION:

- HOUSE TO GARAGE FIRE SEPARATION, GARAGE/HOUSE SEPARATION AT VERTICAL SURFACES SHALL BE PROTECTED WITH ONE (I) LAYER 1/2° GYPSUM BOARD, (PER NCRC TABLE R302.6.) GARAGE/HOUSE SEPARATION AT HORIZONTIAL SURFACES SHALL BE PROTECTED WITH ONE (I) LAYER 5/8° TYPE: X° GYPSUM BOARD, (PER NCRC TABLE R302.6.)
- | HOUSE TO GARAGE DOOR SEPARATION, PROVIDE 1-3/8" SOLID CORE DOOR OR APPROVED 20 MINUTE RATED DOOR, (PER NCRC SECTION R3025,1.)
- 3) BENEATH STAIRS AND LANDINGS, I/2" GYPSUM BOARD ON WALLS AND CEILING OF ENCLOSED ACCESSIBLE AREAS. (PER NORC SECTION R302.T.) IN CONCEALED SPACES BETWEEN STAIR STRINGERS PROVIDE FIREBLOCKING PER R302.I.
- | GAS MATER HEATER ON 18" HIGH PLATFORM. (PER CHAPTER 5 NCRC-PLIMBING)
 | FAU 8'X12' PLATFORM. VERIFY WITH TRUSS MANUFACTURER.
- 6 A/C CONDENSER PAD. (VERIFY)
- PRE-FABRICATED METAL FIREPLACE.
 INSTALL PER MANUFACTURER'S WRITTEN INSTRUCTIONS.
- ATTIC ACCESS LARGE ENOUGH TO REMOVE LARGEST PIECE OF EQUIPMENT BUT NOT LESS THAN 30'x20'. FIRE RATED ACCESS AS NOTED. (FIRE NCRC SECTION RROTT) ATTIC ACCESS LADDER, VERIFY LOCATION AND SIZE WITH TRUSSES. (25 I/2" X 54" SIZE.)
- TYPICALS:
- 1 TEMPERED SAFETY GLASS. (PER NCRC SECTION 308.4)
- 10 PLYWOOD SHELF ABOVE WITH DRYWALL FINISH OVER. HEIGHT AS NOTED.
- III HALF WALL, HEIGHT AS NOTED.
- [2] INTERIOR SOFFITS: FFL = 8'-1" U.N.O. SFL = 7'-6" U.N.O.
- [3] SHOWER, TEMPERED GLASS ENCLOSURE.
- [4] TUB-SHOWER COMBO. TEMPERED GLASS ENCLOSURE.
- [5] CERAMIC TILE SHOWER AND FLOOR, TEMPERED GLASS ENCLOSURE.
- 6 42"x60" ACRYLIC TUB W CERAMIC PLATFORM


KITCHEN:

- 30" SLIDE-IN ELECTRICAL RANGE W HOOD AND MICRO ABV. VENT PER MANUFACTURER'S WRITTEN INSTRUCTIONS.
- [18] 36" GAS COOKTOP AND HOOD. VENT PER MANUFACTURER'S WRITTEN INSTRUCTIONS.
- [19] ELECTRIC OVEN WITH MICROWAVE OVEN.

9'-1" STAIR NOTE:
(USE 14" T.J.I WITH 3/4" PLYWOOD SUBFLOOR)
IS TREADS AT 10" EACH VERIFY
IT RISERS AT 1/- 1.28" = 123 3/4" TOTAL
PIEC VERIFY RISE VERIFY



Opt. Sunroom

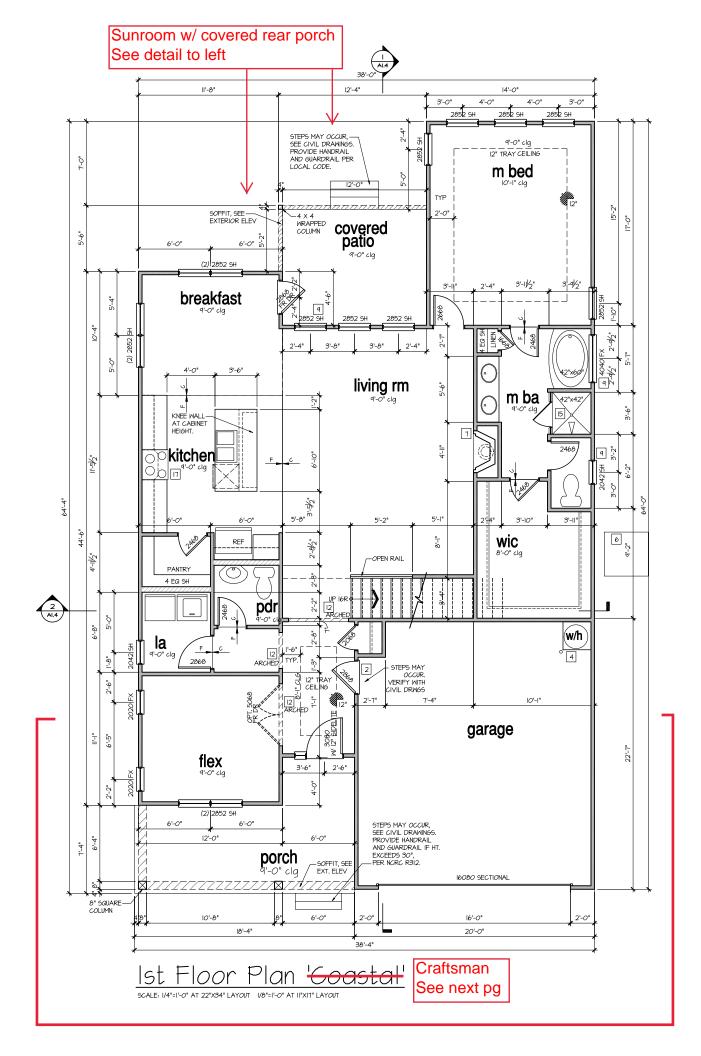



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PROJECT TITLE:

The Winston

FOR CONSTRUCTION



13036RAL SHEET TITLE:

1st FLOOR PLAN

November 28, 2016

A1.1

FOR ADDITIONAL NOTES SEE GENERAL NOTES ON TITLE SHEET AND DETAILS. MINDON HEAD HEIGHTS: IST FLOOR = 7'-8" UN.O. ON ELEVATIONS. 2ND FLOOR = 6'-10" UN.O. ON ELEVATIONS.

ALL DIMENSIONS TO WINDOWS AND DOORS ARE TO CENTERLINE.

WALL LEGEND:

FULL HEIGHT 2X4 WOOD STUD PARTITION

FULL HEIGHT 2X6 WOOD STUD PARTITION

STUD WALL BELOW HEIGHT AND STUD SIZE AS NOTED BRICK / STONE VENEER

LOW GYPSUM BOARD WALL HEIGHT AND STUD SIZE AS NOTED DRYWALL OPENING. HEIGHT AS NOTED ON PLAN.

KEY NOTES FOR NORTH CAROLINA:

FIRE PROTECTION:

- HOUSE TO GARAGE FIRE SEPARATION, GARAGE/HOUSE SEPARATION AT VERTICAL SURFACES SHALL BE PROTECTED WITH ONE (I) LAYER 1/2" GYPSUM BOARD, (PER NCRC TABLE R302.6.) GARAGE/HOUSE SEPARATION AT HORIZONTIAL SURFACES SHALL BE PROTECTED WITH ONE (I) LAYER 5/8" TYPE 'X' GYPSUM BOARD. (PER NCRC TABLE R302.6.)
- [2] HOUSE TO GARAGE DOOR SEPARATION, PROVIDE I-3/6" SOLID CORE DOOR OR APPROVED 20 MINUTE RATED DOOR. (PER NCRC SECTION R302.5.I.)
- 3 BENEATH STARS AND LANDINGS, I/2" GYPSIM BOARD ON WALLS AND CEILING OF ENCLOSED ACCESSIBLE AREAS, (PER NORC SECTION RSO2.1.) IN CONCEALED SPACES BETWEEN STAIR STRINGERS PROVIDE FIREBLOCKING PER RSO2.1.
- GAS WATER HEATER ON 18" HIGH PLATFORM. (PER CHAPTER 5 NCRC-PLUMBING)
- 5 FAU 8'XI2' PLATFORM. VERIFY WITH TRUSS MANUFACTURER.
- 6 A/C CONDENSER PAD. (VERIFY)
- T PRE-FABRICATED METAL FIREPLACE.
 INSTALL PER MANUFACTURER'S WRITTEN INSTRUCTIONS.
- ATTIC ACCESS LARGE ENOUGH TO REMOVE LARGEST PIECE
 OF EQUIPMENT BUT NOT LESS THAN 30"x20". FIRE RATED
 ACCESS AS NOTED. (PER NCRC SECTION R807).
 ATTIC ACCESS LADDER, VERIFY LOCATION AND SIZE WITH TRUSSES.
 (25 1/2" X 54" SIZE.) TYPICALS:
- TEMPERED SAFETY GLASS. (PER NCRC SECTION 308.4)
- 10 PLYWOOD SHELF ABOVE WITH DRYWALL FINISH OVER, HEIGHT AS NOTED.
- III HALF WALL, HEIGHT AS NOTED.
- 12 INTERIOR SOFFITS: FFL = 8'-1" U.N.O. SFL = 7'-6" U.N.O. BATHS:
- 3 SHOWER, TEMPERED GLASS ENCLOSURE.
- [4] TUB-SHOWER COMBO. TEMPERED GLASS ENCLOSURE.
- 15 CERAMIC TILE SHOWER AND FLOOR. TEMPERED GLASS ENCLOSURE.
- 16 42"x60" ACRYLIC TUB W CERAMIC PLATFORM

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 VENT PER MANUFACTURER'S WRITTEN INSTRUCTIONS.
- 19 ELECTRIC OVEN WITH MICROWAVE OVEN.

9'-1" STAIR NOTE: (USE 14" T.J WITH 3/4" PLYMOOD SUBFLOOR) 16 TREADS AT 10" EACH VERIFY 11 RISERS AT 4/- 1.28" = 123 3/4" TOTAL RISE VERIFY

'THE WINSTON' - CRAFTSMAN SF		
AREA	ELEV	
Ist FLOOR	1492 SF	
2nd FLOOR	733 SF	
TOTAL LIVING	2225 SF	
GARAGE	436 SF	
PORCH	150 SF	

OPT. SUNROOM

PORCH W OPT. SUNROOM

	pdr ; UP 16R		
		9 STEPS MAY	
2020 FX	30 2 12 RAY 12 12 12 12 12 12 12 12 12 12 12 12 12	OCCUR. VERIFY WITH CIVIL DRN65 7'-4" 10'-1"	
=	N 200 0 0 0 0 0 0 0 0 0 0 0 0 0 0 0 0 0	garage	22'-7"
2-2"	flex 9-0' clg 5-6' 2-6'	OPT. STONE WRAP, — SEE EXT. ELEV.	
5-10"	(2) 2852 5H 6'-O" 6'-O" 6'-O"	STEP5 MAY OCCUR, SEE CIVIL DRAWINGS. PROVIDE HAMRAIL AND GUARDRAIL IF HT.	
12.	porch 9-0" clg / Ext. Elev	EXCEEDS 30", — PER NCRC R312. 16080 SECTIONAL	
14" TAPERED COLUMN ON 20" STONE BASE SEE EXT ELEV	q-8°]-2° 6'-0°	STONE VENEER, SEE EXT. ELEV 16-0' 2'-0'	,
5.L LAT LLLY	18'-4"	20'-0* 38'-4'	

122 SF

II9 SF

<u>Ist Floor Plan 'Craftsman'</u>



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13036RAL

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 GARAGE/HOUSE SEPARATION AT HORIZONTIAL, SURFACES SHALL BE PROTECTED WITH ONE (I) LAYER 5/8" TYPE: "X" GYPSUM BOARD, (PER NCRC TABLE R302.6.)

 [2] HOUSE TO GARAGE DOOR SEPARATION, PROVIDE I-3/8" SOLID CORE DOOR OR APPROVED 20 MINUTE RATED DOOR, (PER NCRC SECTION R302.5.)

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 ATTIC ACCESS LADDER, VERIFY LOCATION AND SIZE WITH TRUSSES. (25 1/2" x 54" SIZE.)

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BATHS:

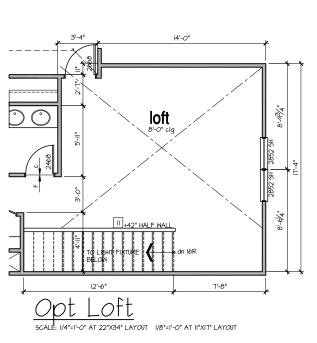
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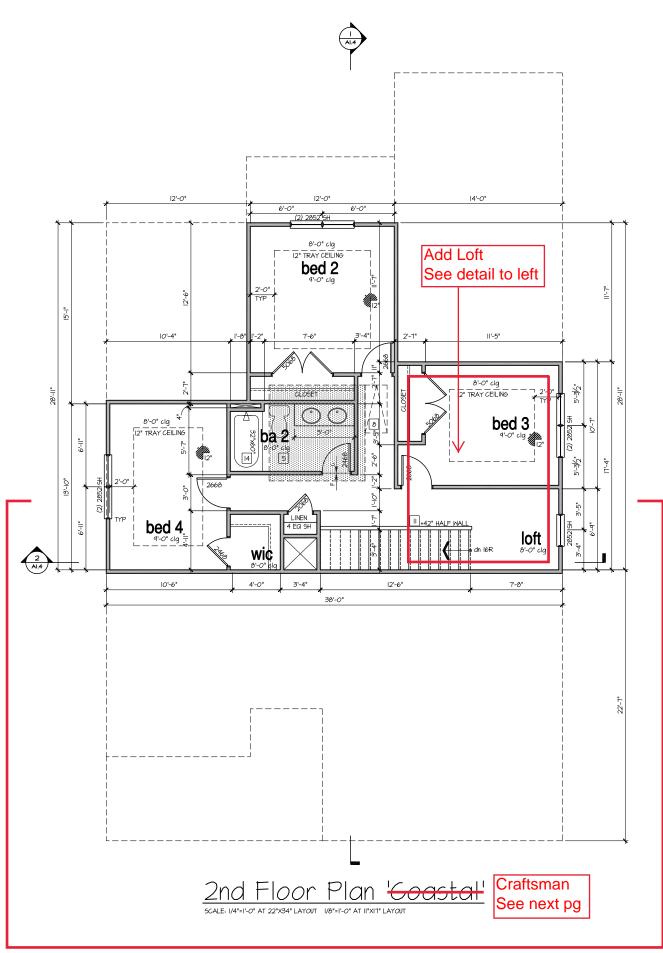
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(USE 14" T.JI WITH 3/4" PLYWOOD SUBFLOOR)
16 TREADS AT IO" EACH VERIFY
17 RISERS AT +/- 1.26" = 123 3/4" TOTAL
RISE VERIFY







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The Winston

FOR CONSTRUCTION



13036RAL

2nd FLOOR PLAN

November 28, 2016

A1.2

FOR ADDITIONAL NOTES SEE GENERAL NOTES ON TITLE SHEET AND DETAILS. - MINDOM HEAD HEIGHTS: IST FLOOR = 7'-8' UN.O. ON ELEVATIONS. 2ND FLOOR = 6'-10" U.N.O. ON ELEVATIONS. ALL DIMENSIONS TO WINDOWS AND DOORS ARE TO CENTERLINE.

WALL LEGEND:

FULL HEIGHT 2X4 WOOD STUD PARTITION

VIIIIIIIIII

FULL HEIGHT 2X6 WOOD STUD PARTITION

STUD WALL BELOW HEIGHT AND STUD SIZE AS NOTED BRICK / STONE VENEER

DRYWALL OPENING. HEIGHT AS NOTED ON PLAN. LOW GYPSUM BOARD WALL HEIGHT AND STUD SIZE AS NOTED

KEY NOTES FOR NORTH CAROLINA:

FIRE PROTECTION:

- HOUSE TO GARAGE FIRE SEPARATION, GARAGE/HOUSE SEPARATION AT VERTICAL SURFACES SHALL BE PROTECTED WITH ONE (I) LAYER I/2" GYPSUM BOARD, (PER NCRC TABLE R302.6.) GARAGE/HOUSE SEPARATION AT HORIZONTIAL SURFACES SHALL BE PROTECTED WITH ONE (I) LAYER 5/9° TYPE 'X' GYPSUM BOARD. (PER NCRC TABLE R302.6.)
- 3 BENEATH STAIRS AND LANDINGS, I/2" GYPSUM BOARD ON WALLS AND CEILING OF ENCLOSED ACCESSIBLE AREAS, FOREN NCC SECTION ROQ2.T IN CONCEALED SPACES BETWEEN STAIR STRINGERS PROVIDE FIREBLOCKING PER R302.I.
- GAS WATER HEATER ON 18" HIGH PLATFORM. (PER CHAPTER 5 NCRC-PLUMBING)
- 5 FAU 8'XI2' PLATFORM. VERIFY WITH TRUSS MANUFACTURER.
- 6 A/C CONDENSER PAD. (VERIFY)
- PRE-FABRICATED METAL FIREPLACE.
 INSTALL PER MANUFACTURER'S WRITTEN INSTRUCTIONS.
- ATTIC ACCESS LARGE ENOUGH TO REMOVE LARGEST PIECE OF EQUIPMENT BUT NOT LESS THAN 30"x20". FIRE RATED ACCESS AS NOTED, (FER NCRC SECTION R80T).
 ATTIC ACCESS LADDER, VERIFY LOCATION AND SIZE WITH TRUSSES. (25 1/2" x 54" SIZE.)

TYPICALS:

- TEMPERED SAFETY GLASS. (PER NCRC SECTION 308.4)
- PLYWOOD SHELF ABOVE WITH DRYWALL FINISH OVER. HEIGHT AS NOTED.
- III HALF WALL, HEIGHT AS NOTED.
- BATHS:
- 3 SHOWER, TEMPERED GLASS ENCLOSURE.
- 14 TUB-SHOWER COMBO. TEMPERED GLASS ENCLOSURE.
- [5] CERAMIC TILE SHOWER AND FLOOR, TEMPERED GLASS ENCLOSURE.
- 16 42"x60" ACRYLIC TUB W CERAMIC PLATFORM

KITCHEN:


- TI 30" SLIDE-IN ELECTRICAL RANGE W HOOD AND MICRO ABV. VENT PER MANUFACTURER'S WRITTEN INSTRUCTIONS.
- | B36" GAS COOKTOP AND HOOD. | VENT PER MANUFACTURER'S WRITTEN INSTRUCTIONS.
- 19 ELECTRIC OVEN WITH MICROWAVE OVEN.

9'-1" STAIR NOTE: (USE 14" TJI WITH 3/4" PLYMOOD SUBFLOOR) 16 TREADS AT 10" EACH VERIFY 17 RISERS AT 4/- 1.28" = 123 3/4" TOTAL RISE VERIFY

'THE WINSTON' - CRAFTSMAN SF		
AREA	ELEV	
Ist FLOOR	1492 SF	
2nd FLOOR	733 SF	
TOTAL LIVING	2225 SF	
GARAGE	436 SF	
PORCH	150 SE	

122 SF

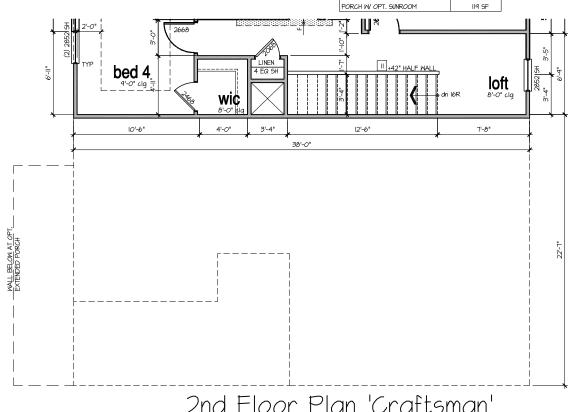OPT. SUNROOM



2nd Floor Plan 'Craftsman'



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13036RAL

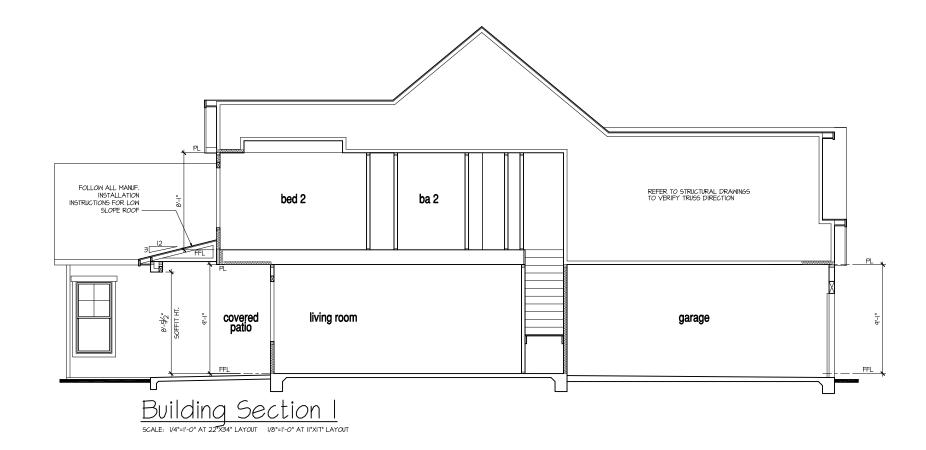
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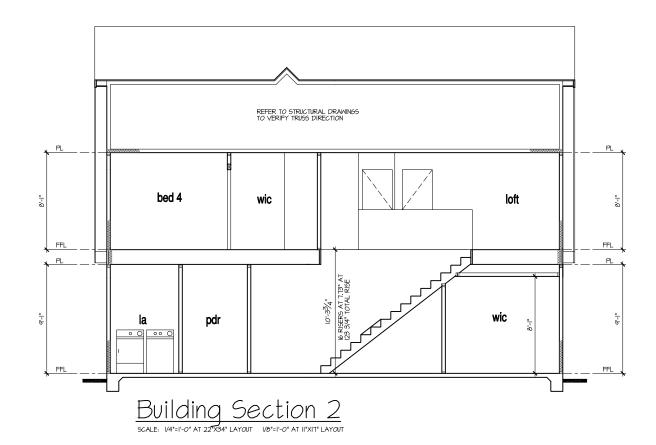
2nd FLOOR PLAN

PRINT DATE:

November 28, 2016

A1.2.1







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PROJECT NO:

BUILDING SECTIONS

PRINT DATE:

November 28, 2016

A1.4



- REFER TO FLOOR PLAN NOTES FOR TYPICAL FIRE PROTECTION NOTES AND LOCATIONS.
- REFER TO FLOOR PLAN NOTES FOR TYPICAL FIRE PROTECTION NOTES AND LOCATIONS.

 THESE BUILDING SECTIONS MAY VARY AT ALTERNATE ELEVATION STYLES AND AT *PLAN OPTION*
 CONDITIONS. REFER TO MAIN FLOOR PLAN AND ALTERNATE FLOOR PLANS FOR INFORMATION NOT SHOWN HERE.

 BUILDING SECTIONS SHOWN HERE DEPICT VOLUMS SPACES WITHIN THE STRUCTURE. REFER TO STRUCTURAL
 DRAWINGS, TRUSS DRAWINGS, STRUCTURAL DETAILS AND CALCULATIONS BY OTHER FOR ALL STRUCTURAL INFO.

 ROOFING: PITCHED SHINGLE ROOF, REFER TO ROOF PLAN FOR TYPICALS.

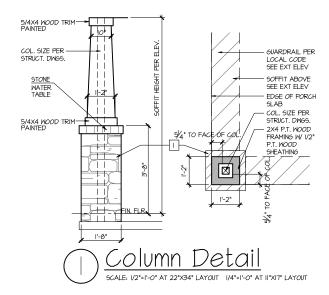
- WOOD FLOORS: FLOOR SHEATHING OVER FLOOR JOIST. REFER TO STRUCTURAL AND TRUGS DRAWINGS BY OTHERS.
- VERIFY STAIRS MINIMUM AND MAXIMUM REQUIREMENTS FOR CONSTRUCTION CLEARANCES WITH LOCAL CODES.

INSULATION:
EXTERIOR WALLS ZONE 3:
EXTERIOR WALLS ZONE 4:
R-I3 BATTS MINIMUM, VERIFY
R-I5 BATTS MINIMUM, VERIFY

CEILING WITH ATTIC ABOVE COMPRESSED INSULATION:
R-30 BATTS MINIMUM, VERIFY
CEILING WITH ATTIC ABOVE UNCOMPRESSED INSULATION (HEELS IN TRUSSES).
R-30 BATTS MINIMUM, VERIFY

FLOOR OVER GARAGE: R-I9 BATTS MINIMUM. VERIFY R-I9 BATTS MINIMUM. VERIFY ATTIC KNEEWALL:

PER STATE RESIDENTIAL CODE COMPLIANCE METHOD TO BE DETERMINED BY BUILDER.



SLOPED SOFFIT SMOOTH PANELSIDING

2040 SH — (OBSCURED)

9-

DORMER DETAIL



GRADE CONDITIONS MAY VARY FOR INDIVIDUAL SITE FROM THAT SHOWN,
 BUILDER SHALL VERIFY AND COORDINATE PER ACTUAL SITE CONDITIONS.

- WINDOW HEAD HEIGHTS: IST FLOOR = 7'-8" U.N.O. ON ELEVATIONS.
- 2ND FLOOR = 6'-IO" U.N.O. ON ELEVATIONS.
- ROOFING: PITCHED SHINGLES PER DEVELOPER.
- WINDOWS: MANUFACTURER PER DEVELOPER. DIVIDED LITES AS SHOWN ON THE EXTERIOR ELEVATIONS
- ENTRY DOOR: AS SELECTED BY DEVELOPER.
- GARAGE DOORS: AS SELECTED BY DEVELOPER, RAISED PANEL AS SHOWN.
- CHIMNEY AS OCCURS: TOP OF CHIMNEYS TO BE A MINIMUM OF 24" ABOVE ANY ROOF WITHIN 10'-0" OF CHIMNEY.
- ALL EXTERIOR MATERIALS TO BE INSTALLED PER MANUFACTURER'S WRITTEN INSTRUCTIONS.
- PROTECTION AGAINST DECAY: PER NCRC R3IT.I
 (ALL PORTIONS OF A PORCH, SCREEN PORCH OR DECK FROM THE BOTTOM OF
 THE HEADER DOWN, INCLUDING POST, RAILS, PICKETS, STEPS AND FLOOR STRUCTURE.)

KEY NOTES:

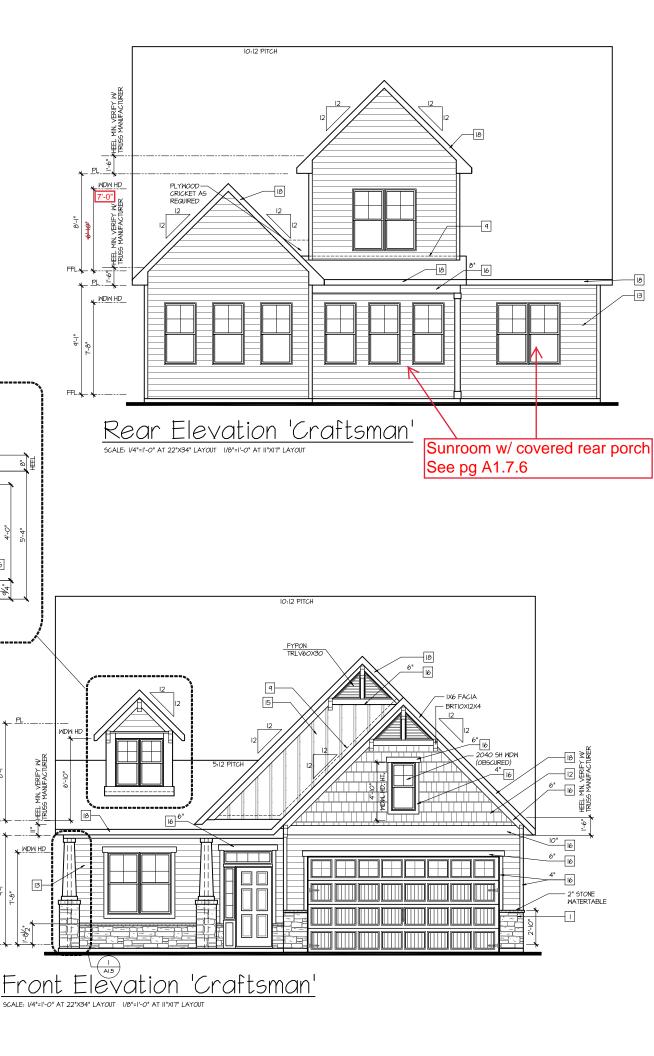
MASONRY:

- ADHERED STONE VENEER AS SELECTED BY DEVELOPER. HEIGHT AS NOTED.
- 2 MASONRY FULL BRICK AS SELECTED BY DEVELOPER, HEIGHT AS NOTED.
- 3 MASONRY FULL STONE AS SELECTED BY DEVELOPER, HEIGHT AS NOTED.
- 4 8" SOLDIER COURSE.
- 5 ROWLOCK COURSE 6 DECORATIVE KEY. SEE DETAIL.
- TYPICALS:
- 7 CORROSION RESISTANT SCREEN LOUVERED VENTS, SIZE AS NOTED.
- 8 CODE APPROVED TERMINATION CHIMNEY CAP.
- CORROSION RESISTANT ROOF TO WALL FLASHING, CODE COMPLIANT FLASHING MIST BE INSTALLED AT ALL ROOF/WALL INTERSECTIONS.
 (SIDE WALL-STEP FLASHING IS REQUIRED IN NC R405.2.8.3)
- O STANDING SEAM METAL ROOF, INSTALL PER MANUFCATURER'S WRITTEN INSTRUCTIONS.
- III DECORATIVE WROUGHT IRON, SEE DETAILS.

- 12 FIBER CEMENT SHAKE SIDING PER DEVELOPER
- W 5/4x4 CORNER TRIM BOARDS OR VINYL EQUIVALENT W VINYL CORNER TRIM.

 3 FIBER CEMENT LAP SIDING PER DEVELOPER
 W 5/4x4 CORNER TRIM BOARDS OR VINYL EQUIVALENT W VINYL CORNER TRIM.

- [5] FIBER CEMENT PANEL SIDING W IX3 BATTS AT 12" O.C. (VINYL BOARD AND BATT SIDING)
- 16 5/4X FIBER CEMENT TRIM OR 5/4X WOOD TRIM W VINYL CAP OR COIL STOCK, SIZE AS NOTED
- (SIZES SHOWN ARE NOMINAL WIDTHS) FALSE WOOD SHUTTERS, TYPE AS SHOWN. SIZE AS NOTED.
- 18 IX6 FIBER CEMENT BOARD FACIA OVER 2X4 SUB-FACIA OR 2X6 FACIA W VINYL CAP OR COIL STOCK.
- ALL MINDOWS WHOSE OPENING IS LESS THAN 24" ABOVE THE FINISH FLOOR AND WHOSE OPENING IS GREATER THAN 12" ABOVE THE OFFICE MALKING SURFACE MUST HAVE WINDOWN OPENING LIMITING DEVICES COMPLYING MITH THE 2012 NCRC SECTION R612.3 AND 612.4.





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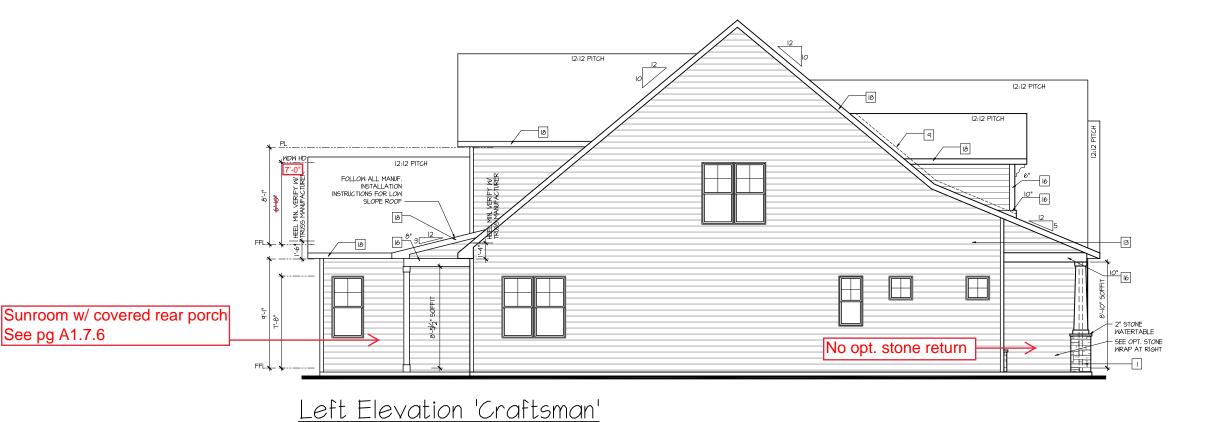
CLIENTS NAME



CRAFTSMAN EXTERIOR ELEVATIONS

November 28, 2016

A1.7.0



SCALE: I/4"=I'-O" AT 22"X34" LAYOUT I/6"=I'-O" AT II"XI7" LAYOUT

NOTES:

GRADE CONDITIONS MAY VARY FOR INDIVIDUAL SITE FROM THAT SHOWN,
 BUILDER SHALL VERIFY AND COORDINATE PER ACTUAL SITE CONDITIONS.

WINDOW HEAD HEIGHTS: IST FLOOR = 7'-8" U.N.O. ON ELEVATIONS.

2ND FLOOR = 6'-IO" U.N.O. ON ELEVATIONS.

ROOFING: PITCHED SHINGLES PER DEVELOPER.

WINDOWS: MANUFACTURER PER DEVELOPER. DIVIDED LITES AS SHOWN ON THE EXTERIOR ELEVATIONS

See pg A1.7.6

ENTRY DOOR: AS SELECTED BY DEVELOPER.

GARAGE DOORS: AS SELECTED BY DEVELOPER, RAISED PANEL AS SHOWN.

CHIMNEY AS OCCURS: TOP OF CHIMNEYS TO BE A MINIMUM OF 24" ABOVE ANY ROOF WITHIN 10'-0" OF CHIMNEY.

ALL EXTERIOR MATERIALS TO BE INSTALLED PER MANUFACTURER'S WRITTEN INSTRUCTIONS.

PROTECTION AGAINST DECAY: PER NCRC R3IT.I
(ALL PORTIONS OF A PORCH, SCREEN PORCH OR DECK FROM THE BOTTOM OF
THE HEADER DOWN, INCLUDING POST, RAILS, PICKETS, STEPS AND FLOOR STRUCTURE.)

KEY NOTES:

MASONRY:

ADHERED STONE VENEER AS SELECTED BY DEVELOPER. HEIGHT AS NOTED.

2 MASONRY FULL BRICK AS SELECTED BY DEVELOPER. HEIGHT AS NOTED.

3 MASONRY FULL STONE AS SELECTED BY DEVELOPER. HEIGHT AS NOTED.

4 8" SOLDIER COURSE.

5 ROWLOCK COURSE 6 DECORATIVE KEY, SEE DETAIL.

TYPICALS: 7 CORROSION RESISTANT SCREEN LOUVERED VENTS, SIZE AS NOTED.

8 CODE APPROVED TERMINATION CHIMNEY CAP.

CORROSION RESISTANT ROOF TO MALL FLASHING, CODE COMPLIANT FLASHING MIST BE INSTALLED AT ALL ROOF/MALL INTERSECTIONS.
(SIDE WALL-STEP FLASHING IS REQUIRED IN NC R405.2.8.3)

O STANDING SEAM METAL ROOF, INSTALL PER MANUFCATURER'S WRITTEN INSTRUCTIONS.

II DECORATIVE WROUGHT IRON. SEE DETAILS.

SIDING:

12 FIBER CEMENT SHAKE SIDING PER DEVELOPER

W 5/4x4 CORNER TRIM BOARDS OR VINYL EQUIVALENT W VINYL CORNER TRIM.

3 FIBER CEMENT LAP SIDING PER DEVELOPER
W 5/4x4 CORNER TRIM BOARDS OR VINYL EQUIVALENT W VINYL CORNER TRIM.

[5] FIBER CEMENT PANEL SIDING W IX3 BATTS AT 12" O.C. (VINYL BOARD AND BATT SIDING)

6 5/4X FIBER CEMENT TRIM OR 5/4X WOOD TRIM W VINYL CAP OR COIL STOCK, SIZE AS NOTED

(SIZES SHOWN ARE NOMINAL WIDTHS) FALSE WOOD SHUTTERS, TYPE AS SHOWN. SIZE AS NOTED.

(6) IX6 FIBER CEMENT BOARD FACIA OVER 2X4 SUB-FACIA OR 2X6 FACIA W VINYL CAP OR COIL STOCK.

ALL MINDOWS WHOSE OPENING IS LESS THAN 24" ABOVE THE FINISH FLOOR AND WHOSE OPENING IS GREATER THAN 12" ABOVE THE PINISH SHALKING SURFACE MIST HAVE WINDOWN OPENING LIMITING DEVICES COMPLYING MITH THE 2012 NCRC SECTION R612.3 AND 612.4.



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PROJECT NO:

CRAFTSMAN EXTERIOR

ELEVATIONS

November 28, 2016

A1.7.1



<u>Sunroom 'Craft</u>sman'

12:12 PITCH 12:12 PITCH 12:12 PITCH - 2" STONE WATERTABLE SEE OPT. STONE WRAP AT RIGHT No opt. stone return

Left Elevation w/ Opt.

Sunroom 'Craftsman

SCALE: I/4"=I'-0" AT 22"X34" LAYOUT I/8"=I'-0" AT II"XI7" LAYOUT



GRADE CONDITIONS MAY VARY FOR INDIVIDUAL SITE FROM THAT SHOWN, BUILDER SHALL VERIFY AND COORDINATE PER ACTUAL SITE CONDITIONS.

WINDOW HEAD HEIGHTS: IST FLOOR = 7'-8" U.N.O. ON ELEVATIONS.

2ND FLOOR = 6'-IO" U.N.O. ON ELEVATIONS.

ROOFING: PITCHED SHINGLES PER DEVELOPER.

WINDOWS: MANUFACTURER PER DEVELOPER. DIVIDED LITES AS SHOWN ON THE EXTERIOR ELEVATIONS

ENTRY DOOR: AS SELECTED BY DEVELOPER.

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KEY NOTES:

MASONRY:

ADHERED STONE VENEER AS SELECTED BY DEVELOPER. HEIGHT AS NOTED.

2 MASONRY FULL BRICK AS SELECTED BY DEVELOPER. HEIGHT AS NOTED.

3 MASONRY FULL STONE AS SELECTED BY DEVELOPER. HEIGHT AS NOTED.

4 8" SOLDIER COURSE.

5 ROWLOCK COURSE

TYPICALS:

6 DECORATIVE KEY, SEE DETAIL.

7 CORROSION RESISTANT SCREEN LOUVERED VENTS, SIZE AS NOTED.

8 CODE APPROVED TERMINATION CHIMNEY CAP.

CORROSION RESISTANT ROOF TO WALL FLASHING. CODE COMPLIANT FLASHING MIST BE INSTALLED AT ALL ROOF/WALL INTERSECTIONS. (SIDE WALL-STEP FLASHING IS REQUIRED IN NC R405.2.8.3)

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W 5/4x4 CORNER TRIM BOARDS OR VINYL EQUIVALENT W VINYL CORNER TRIM.

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W 5/4x4 CORNER TRIM BOARDS OR VINYL EQUIVALENT W VINYL CORNER TRIM.

[5] FIBER CEMENT PANEL SIDING W IX3 BATTS AT 12" O.C. (VINYL BOARD AND BATT SIDING)

6 5/4X FIBER CEMENT TRIM OR 5/4X WOOD TRIM W VINYL CAP OR COIL STOCK, SIZE AS NOTED

(SIZES SHOWN ARE NOMINAL WIDTHS)

FALSE WOOD SHUTTERS, TYPE AS SHOWN. SIZE AS NOTED.

18 IX6 FIBER CEMENT BOARD FACIA OVER 2X4 SUB-FACIA OR 2X6 FACIA W VINYL CAP OR COIL STOCK.

ALL MINDOWS WHOSE OPENING IS LESS THAN 24" ABOVE THE FINISH FLOOR AND WHOSE OPENING IS GREATER THAN 12" ABOVE THE OFFICE MALKING SURFACE MUST HAVE WINDOWN OPENING LIMITING DEVICES COMPLYING MITH THE 2012 NCRC SECTION R612.3 AND 612.4.



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PROJECT NO:

CRAFTSMAN EXTERIOR ELEVATIONS

November 28, 2016

A1.7.6

N.C ATTIC VENT CALC. FOR WINSTON 'CRAFTSMAN': 1:150 RATIO.

THE NET FREE VENTILATING AREA SHALL NOT BE LESS THAN I/150 OF THE AREA OF THE SPACE VENTILATED, PROVIDED THAT AT LEAST 50 PERCENT AND NOT MORE THAN 80 PERCENT THAT AT LEAST 30 PERCENT AND MOT PICKE THAT OF PLACETY OF THE REQUIRED VENTILATING AREA IS PROVIDED BY VENTILATORS LOCATED IN THE UPPER PORTION OF THE SPACE TO BE VENTILATED AT LEAST 3 FEET ABOVE THE EAVE OR ORNICE VENTS WITH THE BALANCE OF THE REQUIRED VENTILATION PROVIDED BY EAVE OR CORNICE VENTS.

EXCEPTIONS:

EXCEPTIONS:

EXCLOSED ATTIC/RAFTER SPACES REQUIRING LESS THAN

I SQ FT OF VENTILATION MAY BE VENTED WITH CONTINUOUS

SOFFIT VENTILATION ONLY.

2. ENCLOSED ATTIC/RAFTER SPACES OVER UNCONDITIONED SPACE MAY BE VENTED WITH CONTINUOUS SOFFIT VENT ONLY

GENERAL CONTRACTOR SHALL VERIFY THE NET FREE VENTILATION OF THE VENT PRODUCT SELECTED BY OWNER. VERIFY WITH MANNEACTURER OF HIGH AND LOW VENTS TO BE USED FOR MINIMUM CALCULATED VENTS REQUIRED. THE REQUIRED VENTILATION SHALL BE MAINTAINED. PROVIDE INSULATION STOP SUCH THAT INSULATION DOES NOT OBSTRUCT FREE AIR MOVEMENT AS REQUIRED BY THE FILLY DIME CREEK! BY THE BUILDING OFFICIAL.

BY THE BUILDING OFFICIAL.
ALL OVERLIAPS FRAMED ROOF AREAS SHALL HAVE
OPENINGS BETWEEN THE ADJACENT ATTICS IN THE ROOF
SHEATHING AS ALLOWED BY THE STRUCTURAL ENGINEER)
TO ALLOW PASSAGE AND ATTIC VENTILATION
BETWEEN THE TWO OR ISOLATED ATTIC SPACES SHALL
BE VENTED INDEPENDENTLY TO CBC REQUIREMENTS.

PER DEVELOPER, AT ALL CANTILEVERED FLOORS, CANTILEVERED ARCHITECTURAL POP-CUTS, AND ANY DOUBLE FRAMING PRO-JECTIONS THAT ARE SEPARATED FROM THE VENTING CALCULATIONS SHOWN ABOVE, PROVIDE A CONTINUOUS 2° CORRESION RESISTANT SOFFIT VENT AT UNDERSIDE OF FRAMED ELEMENT.

(PER 2012 NCRC SECTION R806.2)

I SQUARE INCH VENT FOR EVERY 150 SQUARE INCHES OF CEILING *144 SQ. IN. = 1 SQ. FT. BLDG. CEILING (SF) X 144 = BLDG (SQ. IN.)

BLDG. (5Q. IN.) / I5O = 5Q. IN. OF VENT REQUIRED SQ. IN. OF VENT REQUIRED / 2 = 50% AT HIGH & 50% AT LOW.

ROOF AREA I: = 2200 SF

2200 SQ. FT. X 144 = 316800 SQ. IN. 316800 SQ. IN. / 150 = 2112 SQ. IN. OF VENT REQ'D 2112 SQ. IN. / 2 = 1056 SQ. IN

1056 SQ. IN. OF VENT AT HIGH & 1056 SQ. IN. OF VENT AT LOW REQUIRED.

ROOF AREA 2: = 249 SF

249 SQ. FT. X 144 = 35856 SQ. IN. 35856 SQ. IN. / 150 = 239.04 SQ. IN. OF VENT REQ'D 239.04 SQ. IN. / 2 = 119.52 SQ. IN

119.52 SQ. IN. OF VENT AT HIGH & 119.52 SQ. IN. OF VENT AT LOW REQUIRED.

118 SQ. FT. X 144 = 16992 SQ. IN. 16992 SQ, IN, / 150 = 113,28 SQ, IN, OF VENT REQ'D

113.28 SQ. IN. / 2 = 56.64 SQ. IN

56.64 SQ. IN. OF VENT AT HIGH & 56.64 SQ. IN. OF VENT AT LOW REQUIRED.

NOTES:

- ALL ROOF DRAINAGE SHALL BE PIPED TO STREET OR APPROVED DRAINAGE FACILITY.

- DASHED LINES INDICATE WALL BELOW.

LOCATE GUTTER AND DOWNSPOUTS PER BUILDER.

- PITCHED ROOFS AS NOTED

- TRUSS MANUFACTURER SHALL SUBMIT STRUCTURAL CALCS AND SHOP DRAWINGS TO THE BUILDER'S GENERAL CONTRACTOR AND BUILDING DEPARTMENT FOR REVIEW PRIOR TO FABRICATIONS.

- ALL PLUMBING VENTS SHALL BE COMBINED INTO A MINIMUM AMOUNT OF ROOF PENETRATIONS, ALL ROOF PENETRATIONS SHALL OCCUR TO THE REAR OF THE MAIN RIDGE.

N.C. ATTIC VENT CALC. FOR WINSTON 'CRAFTSMAN': 1:300 RATIC

AS AN ALTERNATE TO THE 1/150 RATIO LISTED ABOVE, THE NET FREE CROSS-VENTILATION AREA MAY BE REDUCED TO 1/300 WHEN A CLASS I OR II VAPOR RETARDER IS INSTALLEI ON THE WARM - IN - WINTER SIDE OF THE CELLING.

GENERAL CONTRACTOR SHALL VERIEY THE NET FREE GENERAL CONTRACTOR SHALL VERIET THE NET FREE VENTLATION OF THE VENT PRODUCT SELECTED BY OWNER. VERIETY WITH MANUFACTURER OF HIGH AND LOM VENTS TO BE USED FOR MINIMUM CALCULATED VENTS REQUIRED. THE REQUIRED VENTLATION SHALL BE MAINTAINED. PROVIDE INSULATION STOP SICH THAT INSULATION DOES NOT OBSTRUCT FREE AIR MOVEMENT AS REQUIRED BY THE BUILDING OFFICIAL.

OF THE BUILDING OFFICIAL.
ALL OVERLAP FRAMED ROOF AREAS SHALL HAVE
OPENINGS BETWEEN THE ADJACENT ATTICS IN THE ROOF
SHEATHING IGS ALLOWED BY THE STRUCTURAL ENGINEER)
TO ALLOW PASSAGE AND ATTIC VENTILATION
BETWEEN THE TWO OR BOLATED ATTIC SPACES SHALL
BE VENTED INDEPENDENTLY TO GBC REQUIREMENTS.

PER DEVELOPER, AT ALL CANTILEVERED FLOORS, CANTILEVERED ARCHITECTURAL POP-OUTS, AND ANY DOUBLE PRAMING PROJECTIONS THAT ARE SEPARATED FROM THE VENTING CALCULATIONS SHOWN ABOVE, PROVIDE A CONTINUIS 2° CORRESION RESISTANT SOFFIT VENT AT UNDERSIDE OF FRAMED ELEMENT.

(PER 2012 NCRC SECTION R806.2)

I SQUARE INCH VENT FOR EVERY 300 SQUARE INCHES OF CEILING *144 SQ. IN. = 1 SQ. FT. BLDG. CEILING (SF) X 144 = BLDG (SQ. IN.) BLDG. (SQ. IN.) / 300 = SQ. IN. OF VENT REQUIRED SQ. IN. OF VENT REQUIRED / 2 = 50% AT HIGH & 50% AT LOW.

ROOF AREA I: = 2200 SF

2200 SQ FT X 144 = 316800 SQ IN 316800 SQ. IN. / 300 = 1056 SQ. IN. OF VENT REQ'D 1056 SQ. IN. / 2 = 528 SQ. IN

528 SQ. IN. OF VENT AT HIGH & 528 SQ. IN. OF VENT AT LOW REQUIRED.

28.32 SQ. IN. OF VENT AT HIGH \$ 28.32 SQ. IN. OF VENT AT LOW REQUIRED.

No opt. extended

SCALE: I/4"=I'-0" AT 22"X34" LAYOUT I/8"=I'-0" AT II"XI7" LAYOUT

wrap porch

ROOF AREA 2: = 249 SF

249 SQ, FT, X 144 = 35856 SQ, IN, 35856 SQ, IN, / 300 = 119,52 SQ, IN, OF VENT REQ'D 119,52 SQ, IN, / 2 = 59,76 SQ, IN

59.76 SQ. IN. OF VENT AT HIGH & 59.76 SQ. IN. OF VENT AT LOW REQUIRED.

ROOF AREA 3. = 118 SE

| 18 50. Ft. x | 44 = 16992 50. IN. | 16992 50. IN. / 300 = 56.64 50. IN. OF VENT REQ'D | 56.64 50. IN. / 2 = 28.32 50. IN

AT SINGLE FAMILY DETACHED PLANS: PREFINISHED VENTED SOFFIT AT EAVE PER MANUFACTURER. (VERITY FIRE SEPARATION DISTANCE FOR SOFFIT PROTECTION PER 2012 NCRC SECTION R703.11.3 AND TABLE R302.1)

Add sunroom w/ covered rear porch I'-O" TYP EAVE ROOF AT COVERED TOUCH W OPT. SUNROOM T -VALLEY @ OPT. SUNROOM 12:12 SL*O*PE I2:I2 SLOPE AREA 3 12:12 SL*O*PE 12:12 SLOPE CRICKET A REQUIRED CRICKET AS REQUIRED @ OPT. SUNROOM 12:12 SL*O*PE I2:I2 SLOPE AREA I 0 0 0 0 0 0 No opt. 3rd car garage ROOF AT OPT. 3RD CAR GARAGE —PITCH BREAK W OPT. 3-CAR GARAGE (2) 2040 SH BACKSIDE ROOF AT OPT. EXTENDED POR PAINTED BLACK SEE EXT. ELEV. AREA 2 5:12 5LOPE RIDGE SLOPE SLOPE SLOPE SLOPE RIDGE 6:12 5:12 5LOPE 3'-23/4" 5'-61/2" 10'-0" 10'-0" 2040 SH BACKSIDE PAINTED BLACK SEE EXT. ELEV. Roof Plan 'Craftsman'



GMD DESIGN GROUP CAROLINAS, INC. IO2 FOUNTAIN BROOK CIRCLE SUITE C CARY, NC. 27511 PHONE: (919) 320-3022

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NO:	DATE:	REVISION:
\triangle	xx-xx-xx	

PROJECT TITLE:

The Winston

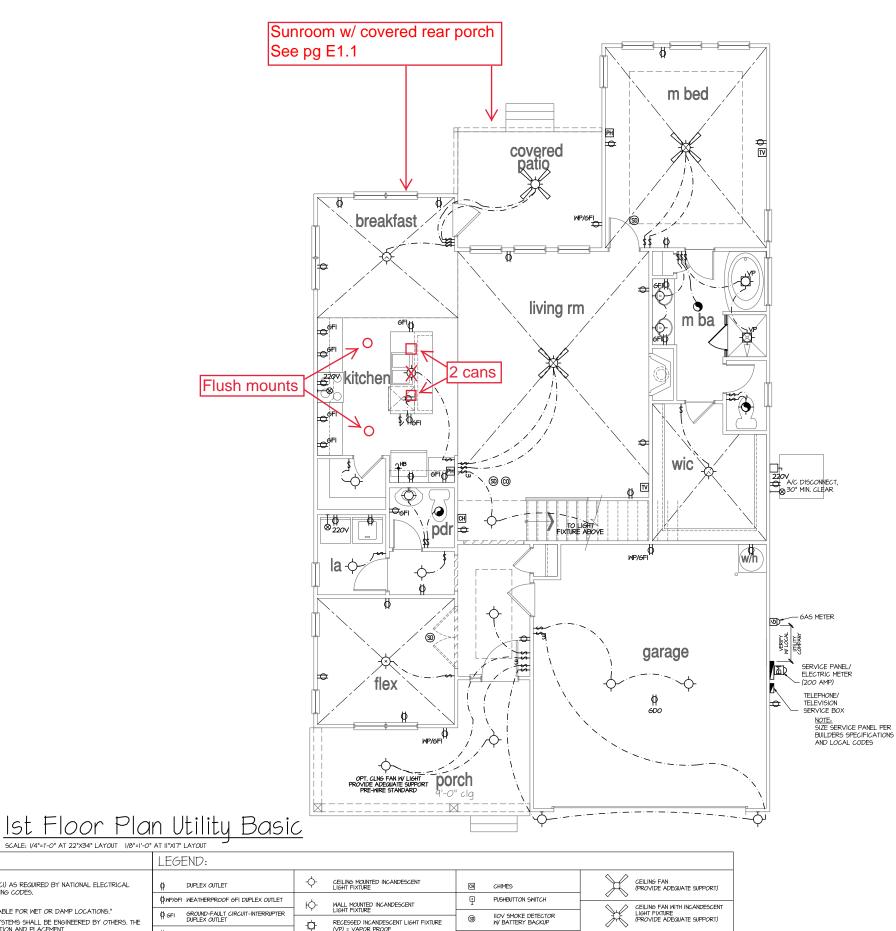
FOR CONSTRUCTION



PROJECT NO: 13036RAL

CRAFTSMAN ROOF PLAN

November 28, 2016



CO2 DETECTOR

TELEVISION

☐ ELECTRIC METER

ELECTRIC PANEL

DISCONNECT SWITCH

PH TELEPHONE

EXHAUST FAN (VENT TO EXTERIOR)

EXHAUST FAN/LIGHT COMBINATION (VENT TO EXTERIOR)

FLUORESCENT LIGHT FIXTURE

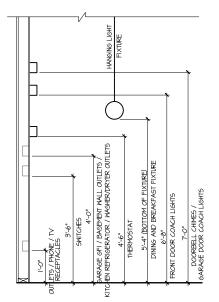
TECH HUB SYSTEM

----- GAS SUPPLY WITH VALVE


CM 1/4" WATER STUB OUT

WALL SCONCE

—→ HOSE BIBB



STANDARD ELECTRICAL BOX HEIGHTS

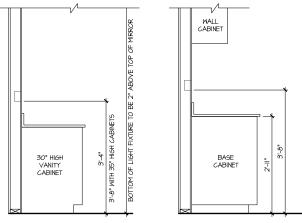

SWITCH AND RECEPTACLE BOXES OVER BATH CABINETS

SWITCH AND RECEPTACLE BOXES OVER KITCHEN CABINETS



- PROVIDE DECORDING LLLOTRICAL RAD FILE LOOKE COURT PROVIDE DAY IN INSTALL ARC FALL CITYUTI-INTERRUPTERS (AFCI) AS REQUIRED BY NATIONAL ELECTRICAL CODE (NEC) AND MEETING THE REQUIREMENTS OF ALL GOVERNING CODES.
- ALL EXHAUST FANS SHALL HAVE BACKDRAFT DAMPERS.
- FAN/LIGHTS IN WET/DAMP LOCATIONS SHALL BE LABLED "SUITABLE FOR WET OR DAMP LOCATIONS."
- ELECTRICAL SYSTEMS ARE SHOWN FOR INTENT ONLY. THESE SYSTEMS SHALL BE ENGINEERED BY OTHERS. THE CONTRACTOR SHALL BE RESPONSIBLE FOR PROPER INSTALLATION AND PLACEMENT.
- PROVIDE AND INSTALL LOCALLY CERTIFIED SHOKE DETECTORS AND CO2 DETECTORS AS REQUIRED BY NATIONAL FIRE PROTECTION ASSOCIATION (NFPA) AND MEETING THE REQUIREDHENTS OF ALL GOVERNING CODES. PROVIDE AND INSTALL GROUND FAULT CIRCUIT-INTERRUPTERS (GFI) AS REQUIRED BY NATIONAL ELECTRICAL CODE (NEC) AND MEETING THE REQUIREDHENTS OF ALL GOVERNING CODES.

HALF-SWITCHED DUPLEX OUTLET

220V 220 VOLT OUTLET

\$ WALL SWITCH

\$4 FOUR-WAY SWITCH

\$3

REINFORCED JUNCTION BOX

THREE-WAY SWITCH

- ELECTRICAL CONTRACTOR TO PROVIDE REQUIRED DIRECT HOOK-UPS/CUTOFFS.
- HVAC CONTRACTOR TO VERIFY THERMOSTAT LOCATIONS.
- ALL ELECTRICAL AND MECHANICAL EQUIPMENT (FURNACES, A/C UNITS, ELECTRICAL PANELS, SANITARY SUMP PI' DRAIN TILE SWMP, AND MATER HEATERS) ARE SUBJECT TO RELOCATION DUE TO FIELD CONDITIONS. PROVIDE POWER, LIGHT AND SMITCH AS REQUIRED FOR ATTIC FURNACE PER CODE AND MANUFACTURER'S WRITTEN INSTRUCTIONS.

group

GMD DESIGN GROUP CAROLINAS, INC. IO2 FOUNTAIN BROOK CIRCLE SUITE C CARY, NC. 275II PHONE: (919) 320-3022

NO:	DATE:	REVISION:
$\overline{\mathbb{A}}$	xx-xx-xx	

PROJECT TITLE:

The Winston

FOR CONSTRUCTION

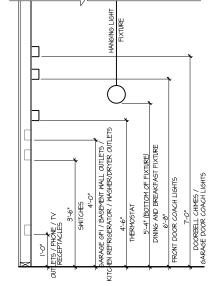
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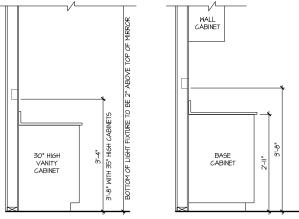
1st FLOOR **UTILITY PLAN**

November 28, 2016

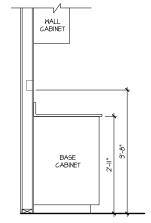
E1.0



STANDARD ELECTRICAL BOX HEIGHTS



SWITCH AND RECEPTACLE BOXES OVER BATH CABINETS SWITCH AND RECEPTACLE BOXES OVER KITCHEN CABINETS



NOTES: LEGEND: PROVIDE GROUNDING ELECTRICAL ROD PER LOCAL CODES. PROVIDE BACKETING LELCTRICAL RAD I STATE LANGUAGE (REC.) AS REQUIRED BY NATIONAL ELECTRICAL CODE (NEC.) AND MEETING THE REQUIREMENTS OF ALL GOVERNING CODES. CEILING FAN (PROVIDE ADEQUATE SUPPORT) CEILING MOUNTED INCANDESCENT LIGHT FIXTURE DUPLEX OUTLET CHIMES WP/GFI WEATHERPROOF GFI DUPLEX OUTLET PUSHBUTTON SWITCH ALL EXHAUST FANS SHALL HAVE BACKDRAFT DAMPERS. ф WALL MOUNTED INCANDESCENT LIGHT FIXTURE CEILING FAN WITH INCANDESCENT LIGHT FIXTURE (PROVIDE ADEQUATE SUPPORT) FAN/LIGHTS IN WET/DAMP LOCATIONS SHALL BE LABLED "SUITABLE FOR WET OR DAMP LOCATIONS." GFI GROUND-FAULT CIRCUIT-INTERRUPTER DUPLEX OUTLET (S) IIOV SMOKE DETECTOR W BATTERY BACKUP - ELECTRICAL SYSTEMS ARE SHOWN FOR INTENT ONLY, THESE SYSTEMS SHALL BE ENGINEERED BY OTHERS. THE CONTRACTOR SHALL BE RESPONSIBLE FOR PROPER INSTALLATION AND PLACEMENT.

- PROVIDE AND INSTALL LOCALLY CERTIFIED SHOKE DETECTORS AND CO2 DETECTORS AS REQUIRED BY NATIONAL FIRE PROTECTION ASSOCIATION (MFPA) AND MEETING THE REQUIREMENTS OF ALL GOVERNING CODES.

- PROVIDE AND INSTALL GROUND FAULT CIRCUIT-INTERRIPTERS (GFI) AS REQUIRED BY NATIONAL ELECTRICAL CODE (NEC) AND MEETING THE REQUIREMENTS OF ALL GOVERNING CODES. RECESSED INCANDESCENT LIGHT FIXTURE (VP) = VAPOR PROOF HALF-SWITCHED DUPLEX OUTLET CO2 DETECTOR ----- GAS SUPPLY WITH VALVE EXHAUST FAN (VENT TO EXTERIOR) 220V 220 VOLT OUTLET THERMOSTAT PH TELEPHONE REINFORCED JUNCTION BOX —→ HOSE BIBB EXHAUST FAMILIGHT COMBINATION (VENT TO EXTERIOR) ELECTRICAL CONTRACTOR TO PROVIDE REQUIRED DIRECT HOOK-UPS/CUTOFFS. TELEVISION \$ WALL SWITCH HVAC CONTRACTOR TO VERIFY THERMOSTAT LOCATIONS. - ALL ELECTRICAL AND MECHANICAL EQUIPMENT (FURNACES, A/C UNITS, ELECTRICAL PANELS, SANITARY SUMP PIT DRAIN TILE SUMP, AND MATER HEATERS) ARE SUBJECT TO RELOCATION DUE TO FIELD CONDITIONS. ☐ ELECTRIC METER \$ 3 THREE-WAY SWITCH FLUORESCENT LIGHT FIXTURE ELECTRIC PANEL PROVIDE POWER, LIGHT AND SMITCH AS REQUIRED FOR ATTIC FURNACE PER CODE AND MANUFACTURER'S WRITTEN INSTRUCTIONS. WALL SCONCE \$4 FOUR-WAY SWITCH TECH HUB SYSTEM DISCONNECT SWITCH



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NO:	DATE:	REVISION:
$\overline{\mathbb{Q}}$	xx-xx-xx	

PROJECT TITLE:

covered

breakfast

Opt. Sunroom

SCALE: I/4"=I'-O" AT 22"X34" LAYOUT I/8"=I'-O" AT II"XIT" LAYOUT

The Winston

FOR CONSTRUCTION

sunroom

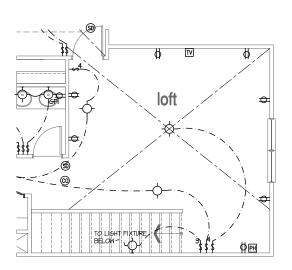


1st FLOOR **UTILITY PLAN**

PRINT DATE:


November 28, 2016

E1.1




Opt Loft

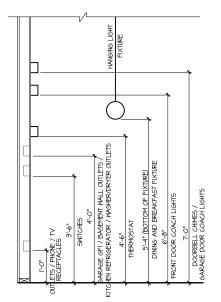
SCALE: 1/4*=1'-0" AT 22"X34" LAYOUT 1/8*=1'-0" AT 11"X17" LAYOUT



STANDARD ELECTRICAL BOX HEIGHTS

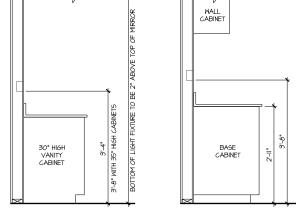

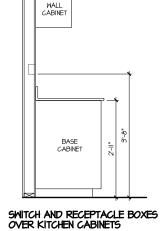SWITCH AND RECEPTACLE BOXES OVER BATH CABINETS



NOTES:

PROVIDE GROUNDING ELECTRICAL ROD PER LOCAL CODES.

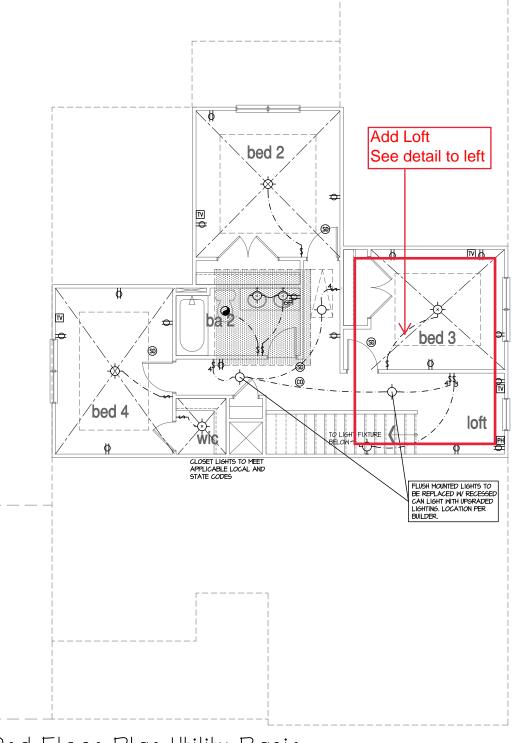
ALL EXHAUST FANS SHALL HAVE BACKDRAFT DAMPERS.

HVAC CONTRACTOR TO VERIFY THERMOSTAT LOCATIONS.

FAN/LIGHTS IN WET/DAMP LOCATIONS SHALL BE LABLED "SUITABLE FOR WET OR DAMP LOCATIONS."

ELECTRICAL CONTRACTOR TO PROVIDE REQUIRED DIRECT HOOK-UPS/CUTOFFS.

LEGEND: PROVIDE DECORATION LELECTRICAL RAD FIRST EXCHANGE FERS (AFCI) AS REQUIRED BY NATIONAL ELECTRICAL CODE (NEC) AND MEETING THE REQUIREMENTS OF ALL GOVERNING CODES. CEILING FAN (PROVIDE ADEQUATE SUPPORT) DUPLEX OUTLET CHIMES ØWP/GFI WEATHERPROOF GFI DUPLEX OUTLET PUSHBUTTON SWITCH Ю-WALL MOUNTED INCANDESCENT LIGHT FIXTURE CEILING FAN WITH INCANDESCENT LIGHT FIXTURE (PROVIDE ADEQUATE SUPPORT) GROUND-FAULT CIRCUIT-INTERRUPTER DUPLEX OUTLET (SI) IIOV SMOKE DETECTOR W BATTERY BACKUP - ELECTRICAL SYSTEMS ARE SHOWN FOR INTENT ONLY, THESE SYSTEMS SHALL BE ENGINEERED BY OTHERS. THE CONTRACTOR SHALL BE RESPONSIBLE FOR PROPER INSTALLATION AND PLACEMENT. - PROVIDE AND INSTALL LOCALLY CERTIFIED SHOKE DETECTORS AND CO2 DETECTORS AS REQUIRED BY NATIONAL FIRE PROTECTION ASSOCIATION (NFPA) AND MEETING THE REQUIREMENTS OF ALL GOVERNING CODES. - PROVIDE AND INSTALL GROUND FAULT CIRCUIT-INTERRIPTERS (GFI) AS REQUIRED BY NATIONAL ELECTRICAL CODE (NEC) AND MEETING THE REQUIREMENTS OF ALL GOVERNING CODES. RECESSED INCANDESCENT LIGHT FIXTURE (VP) = VAPOR PROOF HALF-SWITCHED DUPLEX OUTLET CO2 DETECTOR ----- GAS SUPPLY WITH VALVE EXHAUST FAN (VENT TO EXTERIOR) 220V 220 VOLT OUTLET PH TELEPHONE REINFORCED JUNCTION BOX —→ HOSE BIBB EXHAUST FAN/LIGHT COMBINATION (VENT TO EXTERIOR) TELEVISION \$ WALL SWITCH CM 1/4" WATER STUB OUT - ALL ELECTRICAL AND MECHANICAL EQUIPMENT (FURNACES, A/C UNITS, ELECTRICAL PANELS, SANITARY SUMP PI' DRAIN TILE SWMP, AND MATER HEATERS) ARE SUBJECT TO RELOCATION DUE TO FIELD CONDITIONS. ☐ ELECTRIC METER FLUORESCENT LIGHT FIXTURE \$3 THREE-WAY SWITCH ELECTRIC PANEL PROVIDE POWER, LIGHT AND SMITCH AS REQUIRED FOR ATTIC FURNACE PER CODE AND MANUFACTURER'S WRITTEN INSTRUCTIONS. WALL SCONCE \$4 FOUR-WAY SWITCH TECH HUB SYSTEM DISCONNECT SWITCH



2nd Floor Plan Utility Basic



PROJECT TITLE:

The Winston


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2nd FLOOR **UTILITY PLAN**

November 28, 2016

E2.0



STRUCTURAL ENGINEERS
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wear after the seal date without written

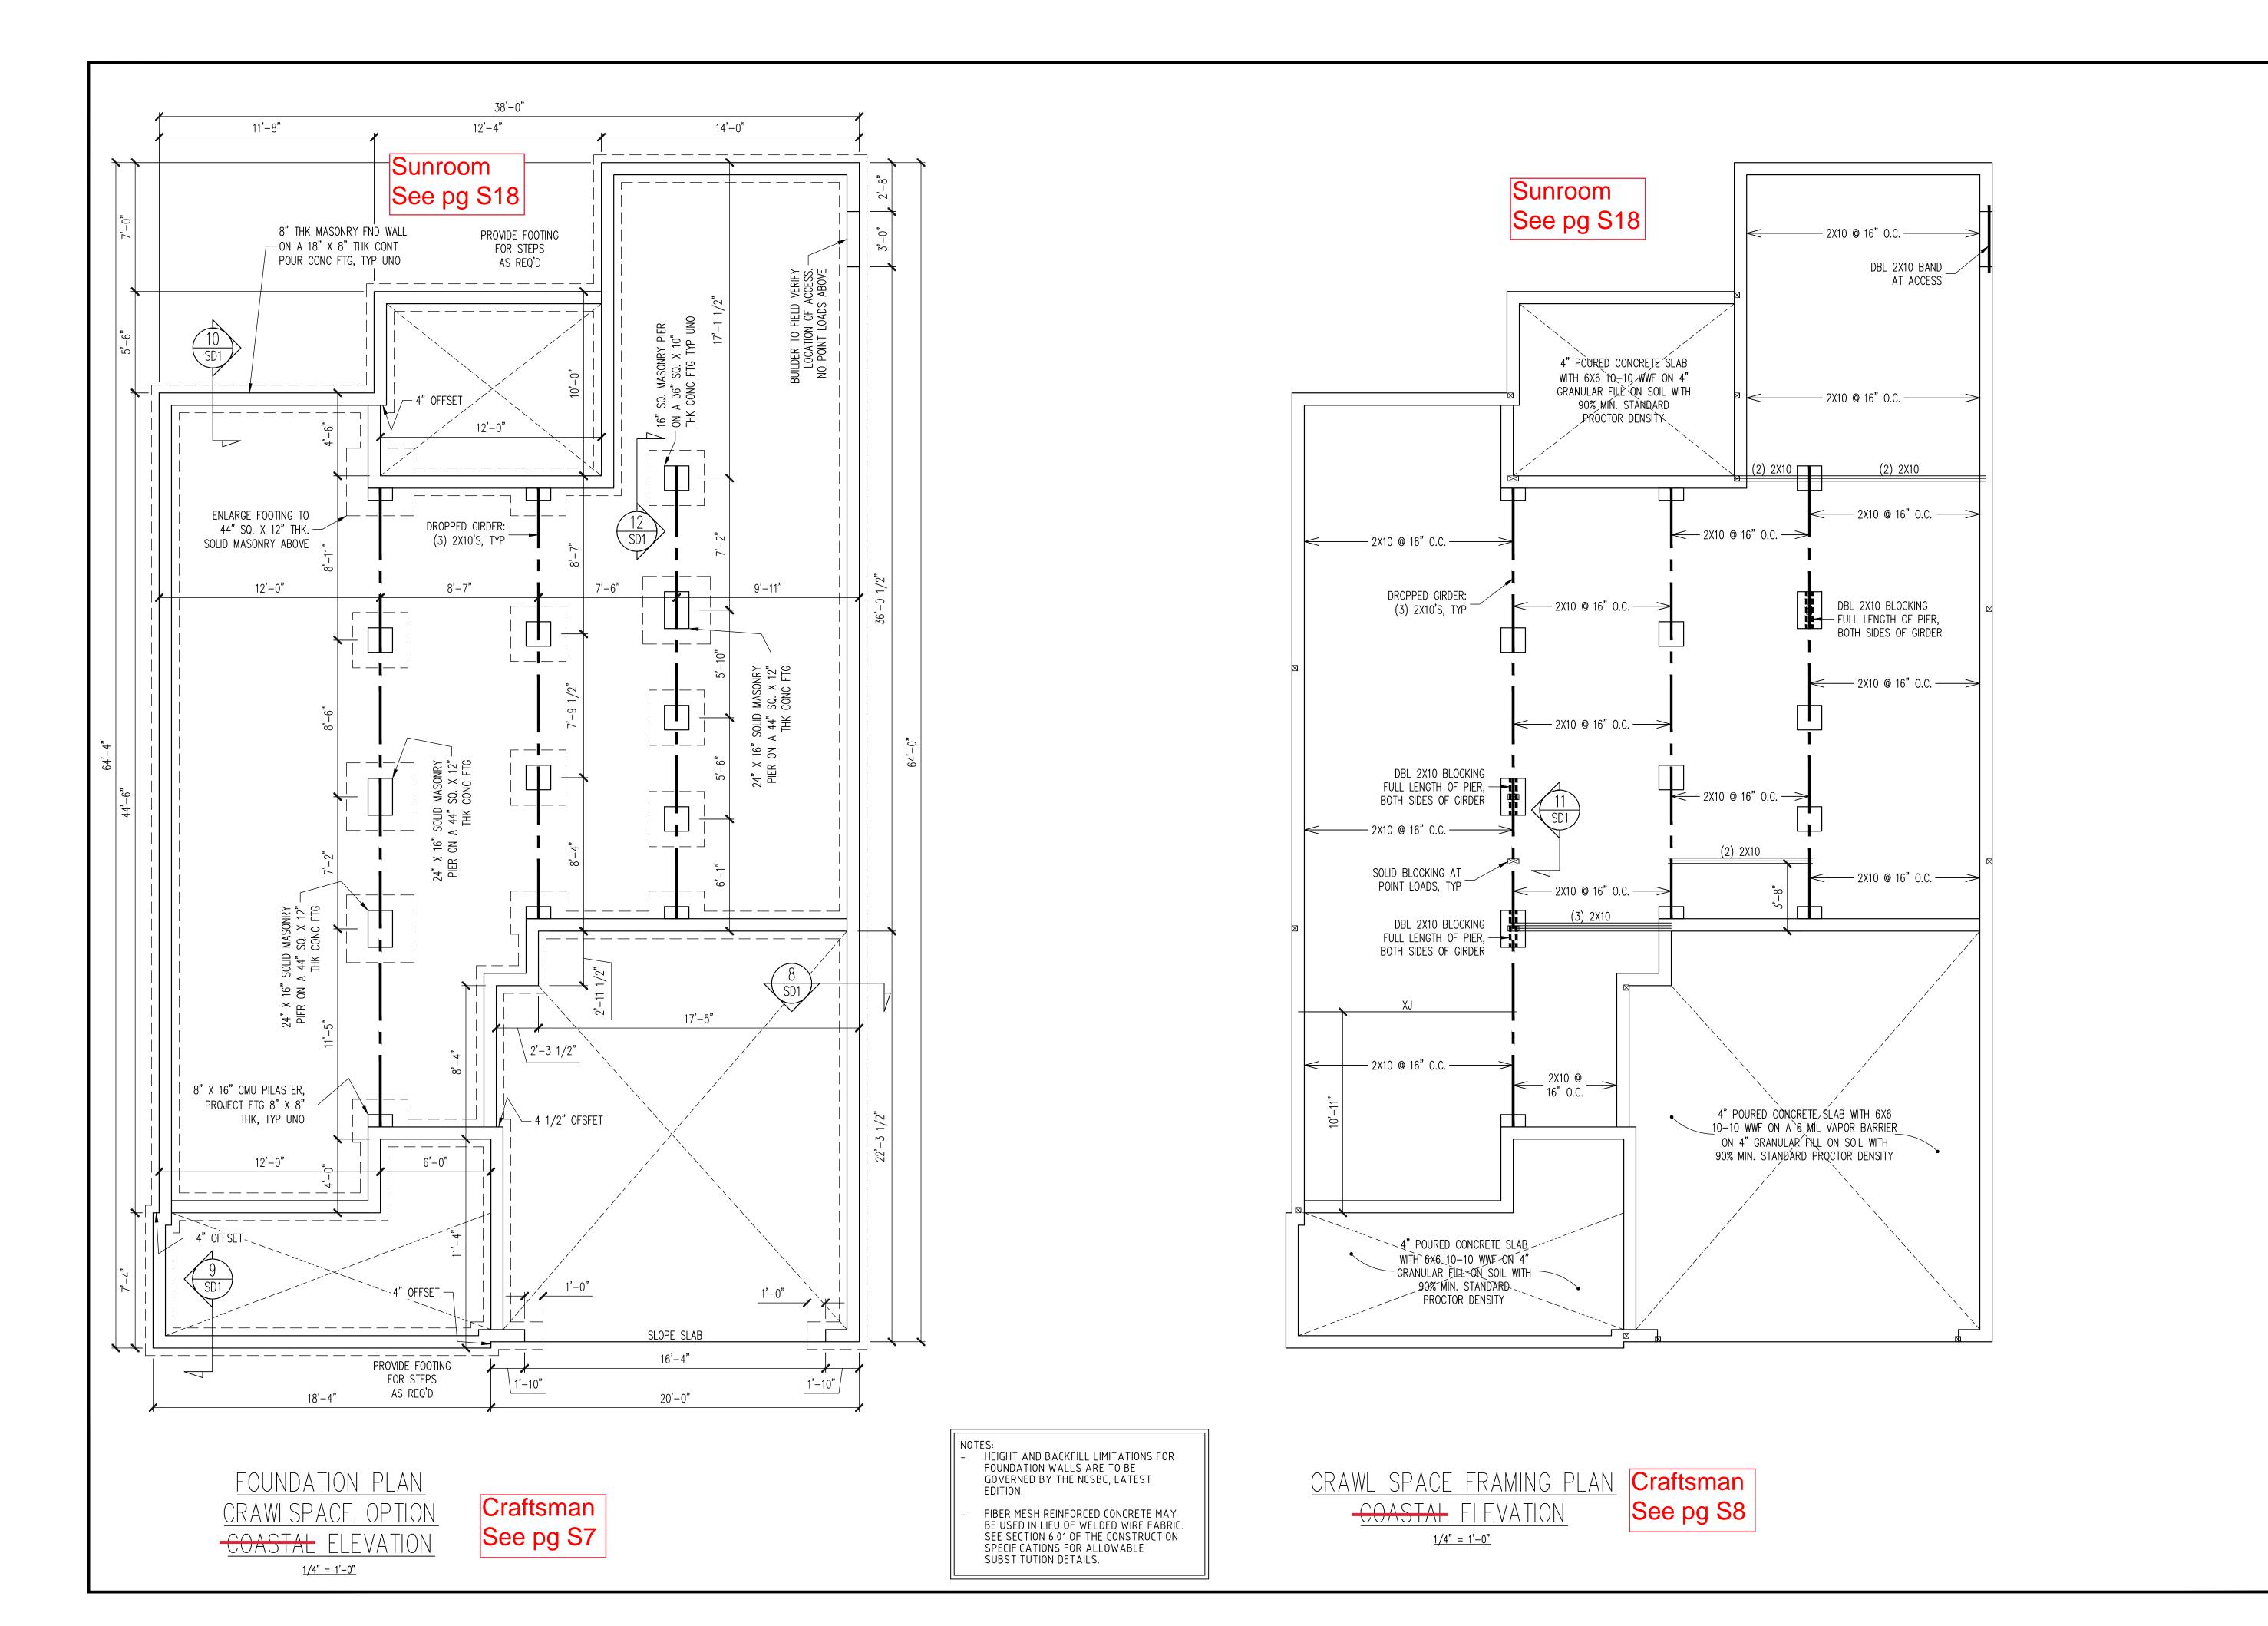
		ENG: KWT/DTN		DATE 11-16-2017
. 3	MN	ENG	REV:	DATE
MCKEE HOMES, INC.	STRUCTURAL ADDENDUM			
CLIENT:	SCOPE	LOT #:		

PLAN NO.
WINSTON RH

PROJECT NO. 17-29-113R

SHEET NO.

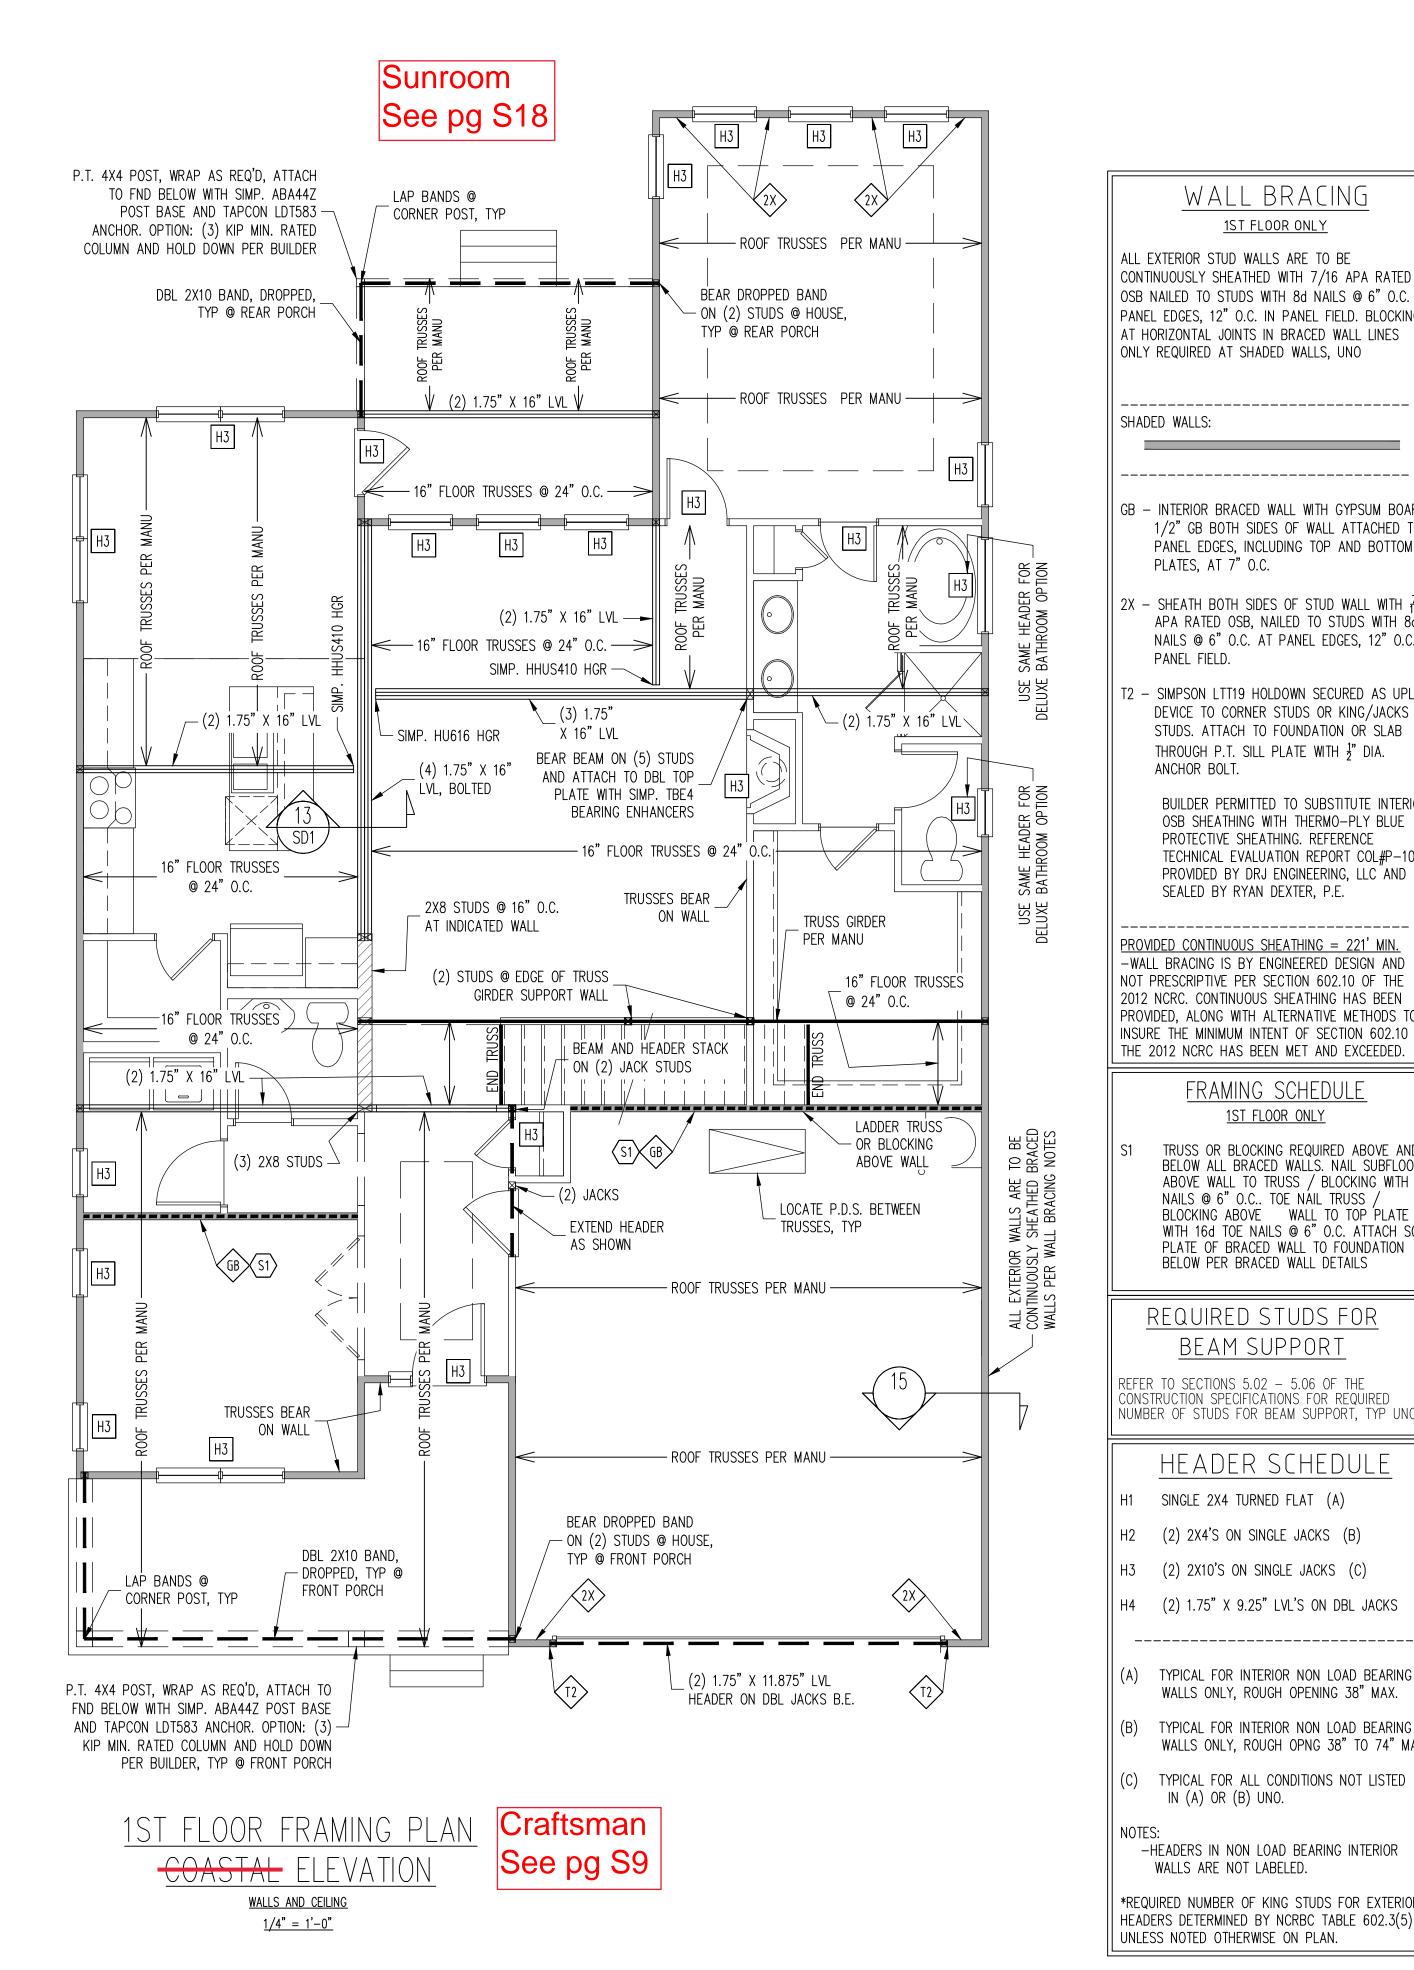2 of 23



WALL BRACING

ALL EXTERIOR STUD WALLS ARE TO BE CONTINUOUSLY SHEATHED WITH 7/16 APA RATED OSB NAILED TO STUDS WITH 8d NAILS @ 6" O.C. AT PANEL EDGES, 12" O.C. IN PANEL FIELD. BLOCKING AT HORIZONTAL JOINTS IN BRACED WALL LINES ONLY REQUIRED AT SHADED WALLS, UNO

1ST FLOOR ONLY

SHADED WALLS:

- GB INTERIOR BRACED WALL WITH GYPSUM BOARD. 1/2" GB BOTH SIDES OF WALL ATTACHED TO PANEL EDGES, INCLUDING TOP AND BOTTOM PLATES, AT 7" O.C.
- 2X SHEATH BOTH SIDES OF STUD WALL WITH 16 APA RATED OSB, NAILED TO STUDS WITH 8d NAILS @ 6" O.C. AT PANEL EDGES, 12" O.C. IN PANEL FIELD.
- T2 SIMPSON LTT19 HOLDOWN SECURED AS UPLIFT DEVICE TO CORNER STUDS OR KING/JACKS STUDS. ATTACH TO FOUNDATION OR SLAB THROUGH P.T. SILL PLATE WITH $\frac{1}{2}$ " DIA. ANCHOR BOLT.

BUILDER PERMITTED TO SUBSTITUTE INTERIOR OSB SHEATHING WITH THERMO-PLY BLUE PROTECTIVE SHEATHING. REFERENCE TECHNICAL EVALUATION REPORT COL#P-1038 PROVIDED BY DRJ ENGINEERING, LLC AND SEALED BY RYAN DEXTER, P.E.

PROVIDED CONTINUOUS SHEATHING = 221' MIN. -WALL BRACING IS BY ENGINEERED DESIGN AND NOT PRESCRIPTIVE PER SECTION 602.10 OF THE 2012 NCRC. CONTINUOUS SHEATHING HAS BEEN PROVIDED, ALONG WITH ALTERNATIVE METHODS TO INSURE THE MINIMUM INTENT OF SECTION 602.10 OF THE 2012 NCRC HAS BEEN MET AND EXCEEDED.

FRAMING SCHEDULE <u>1ST FLOOR ONLY</u>

TRUSS OR BLOCKING REQUIRED ABOVE AND BELOW ALL BRACED WALLS. NAIL SUBFLOOR ABOVE WALL TO TRUSS / BLOCKING WITH 8d NAILS @ 6" O.C.. TOE NAIL TRUSS / BLOCKING ABOVE WALL TO TOP PLATE WITH 16d TOE NAILS @ 6" O.C. ATTACH SOLE PLATE OF BRACED WALL TO FOUNDATION BELOW PER BRACED WALL DETAILS

REQUIRED STUDS FOR BEAM SUPPORT

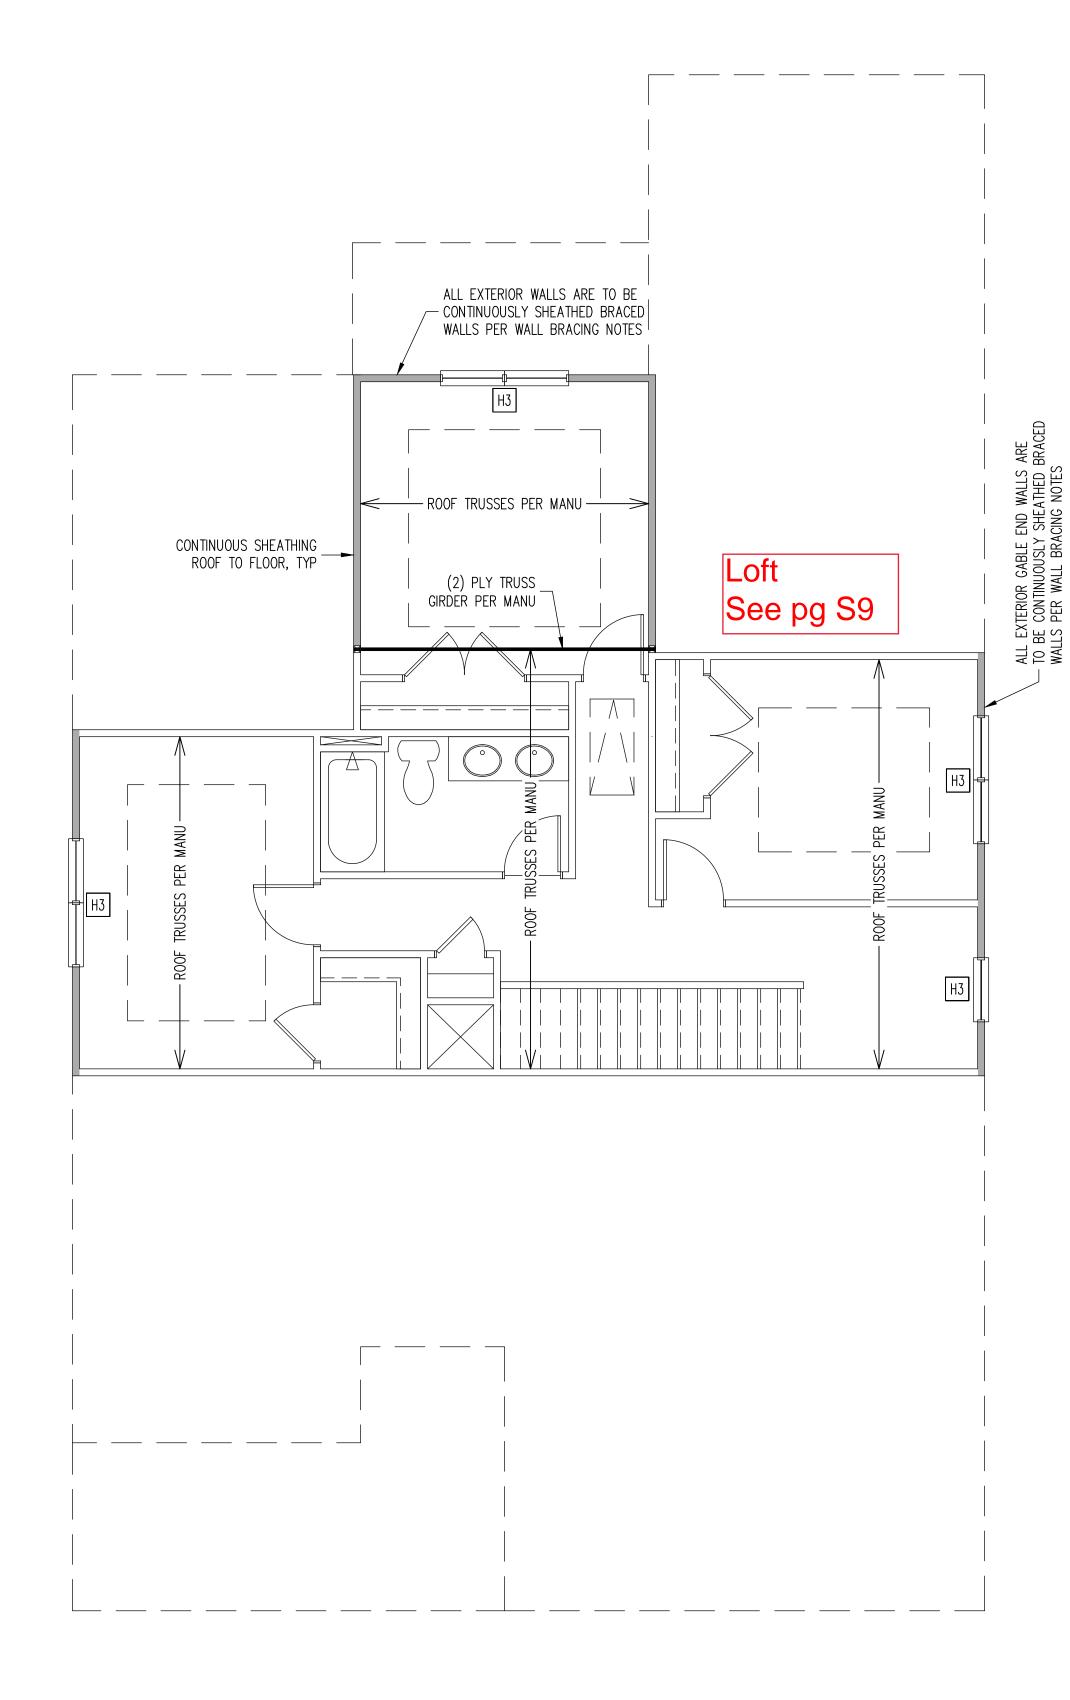
REFER TO SECTIONS 5.02 - 5.06 OF THE CONSTRUCTION SPECIFICATIONS FOR REQUIRED NUMBER OF STUDS FOR BEAM SUPPORT, TYP UNO.

HEADER SCHEDULE

- H1 SINGLE 2X4 TURNED FLAT (A)
- H2 (2) 2X4'S ON SINGLE JACKS (B)
- H3 (2) 2X10'S ON SINGLE JACKS (C)
- H4 (2) 1.75" X 9.25" LVL'S ON DBL JACKS
- (A) TYPICAL FOR INTERIOR NON LOAD BEARING WALLS ONLY, ROUGH OPENING 38" MAX.
- (B) TYPICAL FOR INTERIOR NON LOAD BEARING WALLS ONLY, ROUGH OPNG 38" TO 74" MAX.
- (C) TYPICAL FOR ALL CONDITIONS NOT LISTED IN (A) OR (B) UNO.

NOTES: -HEADERS IN NON LOAD BEARING INTERIOR WALLS ARE NOT LABELED.

*REQUIRED NUMBER OF KING STUDS FOR EXTERIOR HEADERS DETERMINED BY NCRBC TABLE 602.3(5) UNLESS NOTED OTHERWISE ON PLAN.



2ND FLOOR FRAMING PLAN ALL ELEVATIONS

WALLS AND CEILING 1/4" = 1'-0"

WALL BRACING

ALL EXTERIOR STUD WALLS ARE TO BE CONTINUOUSLY SHEATHED WITH 7/16 APA RATED OSB NAILED TO STUDS WITH 8d NAILS @ 6" O.C. AT PANEL EDGES, 12" O.C. IN PANEL FIELD.

<u>2ND FLOOR ONLY</u>

TRUSS OR BLOCKING REQUIRED ABOVE AND BELOW ALL BRACED WALLS. NAIL SUBFLOOR ABOVE WALL TO BLOCKING WITH 8d NAILS @ 6" O.C.. TOE NAIL TRUSS / BLOCKING ABOVE WALL TO TOP PLATE WITH 16d TOE NAILS @ 6" O.C. NAIL SOLE PLATE OF BRACED WALL TO TRUSS / BLOCKING BELOW WALL WITH (3) 16d NAILS @ 16" O.C. BLOCKING AT HORIZONTAL JOINTS IN BRACED WALL LINES ONLY REQUIRED AT SHADED WALLS, UNO

-----SHADED WALLS:

-PROVIDED CONTINUOUS SHEATHING = 67' MIN. -WALL BRACING IS BY ENGINEERED DESIGN AND NOT PRESCRIPTIVE PER SECTION 602.10 OF THE 2012 NCRC. CONTINUOUS SHEATHING HAS BEEN PROVIDED, ALONG WITH ALTERNATIVE METHODS TO INSURE THE MINIMUM INTENT OF SECTION 602.10 OF THE 2012 NCRC HAS BEEN MET AND EXCEEDED.

REQUIRED STUDS FOR BEAM SUPPORT

REFER TO SECTIONS 5.02 - 5.06 OF THE CONSTRUCTION SPECIFICATIONS FOR REQUIRED NUMBER OF STUDS FOR BEAM SUPPORT, TYP UNO.

HEADER SCHEDULE

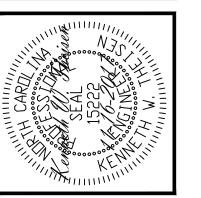
- H1 SINGLE 2X4 TURNED FLAT (A)
- H2 (2) 2X4'S ON SINGLE JACKS (B)
- H3 (2) 2X10'S ON SINGLE JACKS (C)
- H4 (2) 1.75" X 9.25" LVL'S ON DBL JACKS
- (A) TYPICAL FOR INTERIOR NON LOAD BEARING WALLS ONLY, ROUGH OPENING 38" MAX.
- (B) TYPICAL FOR INTERIOR NON LOAD BEARING WALLS ONLY, ROUGH OPNG 38" TO 74" MAX.
- (C) TYPICAL FOR ALL CONDITIONS NOT LISTED IN (A) OR (B) UNO.

NOTES:

-HEADERS IN NON LOAD BEARING INTERIOR WALLS ARE NOT LABELED.

*REQUIRED NUMBER OF KING STUDS FOR EXTERIOR HEADERS DETERMINED BY NCRBC TABLE 602.3(5) UNLESS NOTED OTHERWISE ON PLAN.






REV:	KWT/DTN	IDUM ENG REV:	MCKEE HOMES, IN STRUCTURAL ADDEN	CLIENT: SCOPE LOT #:
	DATE 11-16-2017	DATE		
	KWT/DTN	ENG		LOT #:
LOT #: ENG: KWT/DTN		MNG	STRUCTURAL ADDEN	SCOPE
STRUCTURAL ADDENDUA		IC.	MCKEE HOMES, IN	CLIENT:
MCKEE HOMES, INC. STRUCTURAL ADDENDUA				

PLAN NO. WINSTON RH

PROJECT NO. 17-29-113R

> SHEET NO. \$3

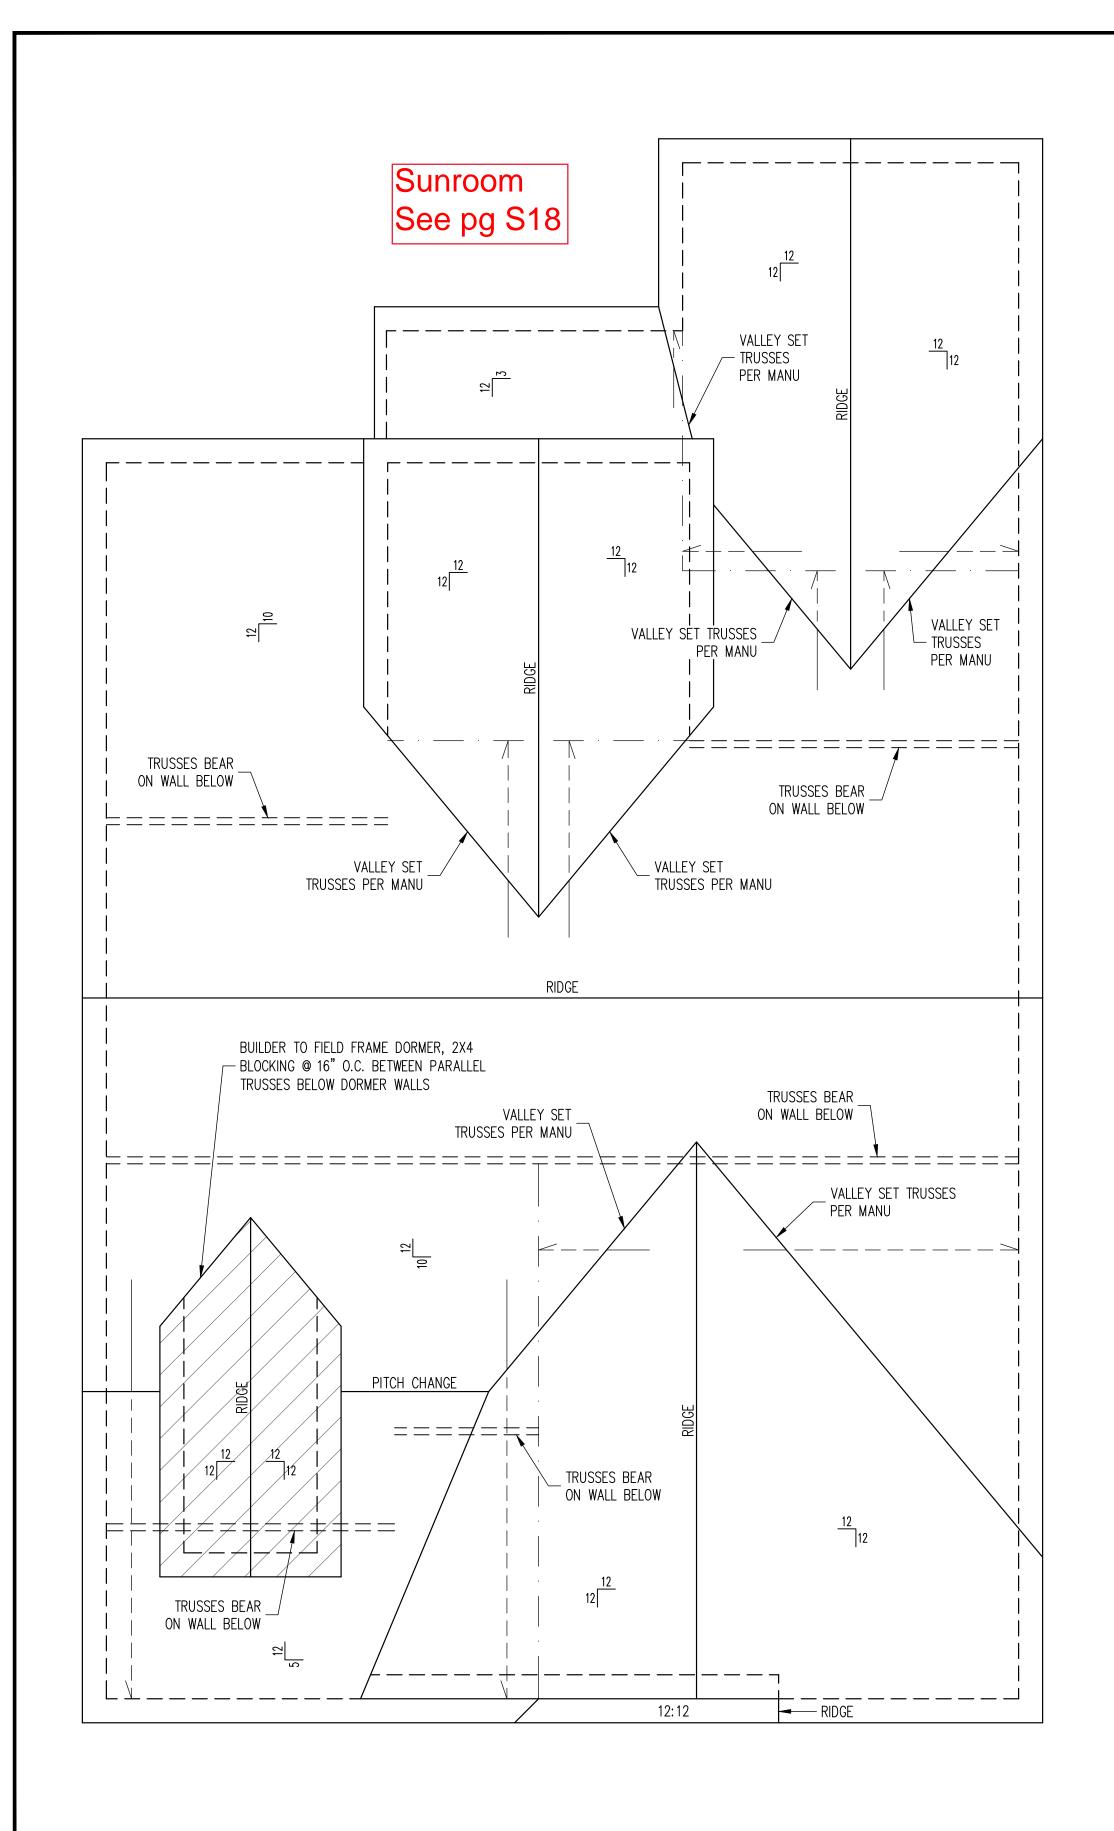
3 of 23



ROOF FRAMING PLAN CRAFTSMAN ELEVATION 1/4" = 1'-0"

ROOF ONLY -ROOF TRUSSES PER MANU TYPICAL UNO
-VERIFY ALL ARCHITECTURAL OVERHANGS, ROOF
PITCHES, AND KNEEWALL HEIGHTS PRIOR TO
CONSTRUCTION

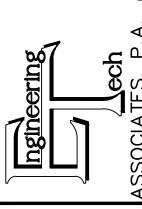FRAMING NOTES






		ENG. KWT/DTN		DATE: 11-16-2017
رئ	MNC	ENG	REV:	DATE
MCKEE HOMES, INC.	STRUCTURAL ADDENDUM			
CLIENT:	SCOPE	# 101		

PLAN NO. WINSTON RH

PROJECT NO. 17-29-113R
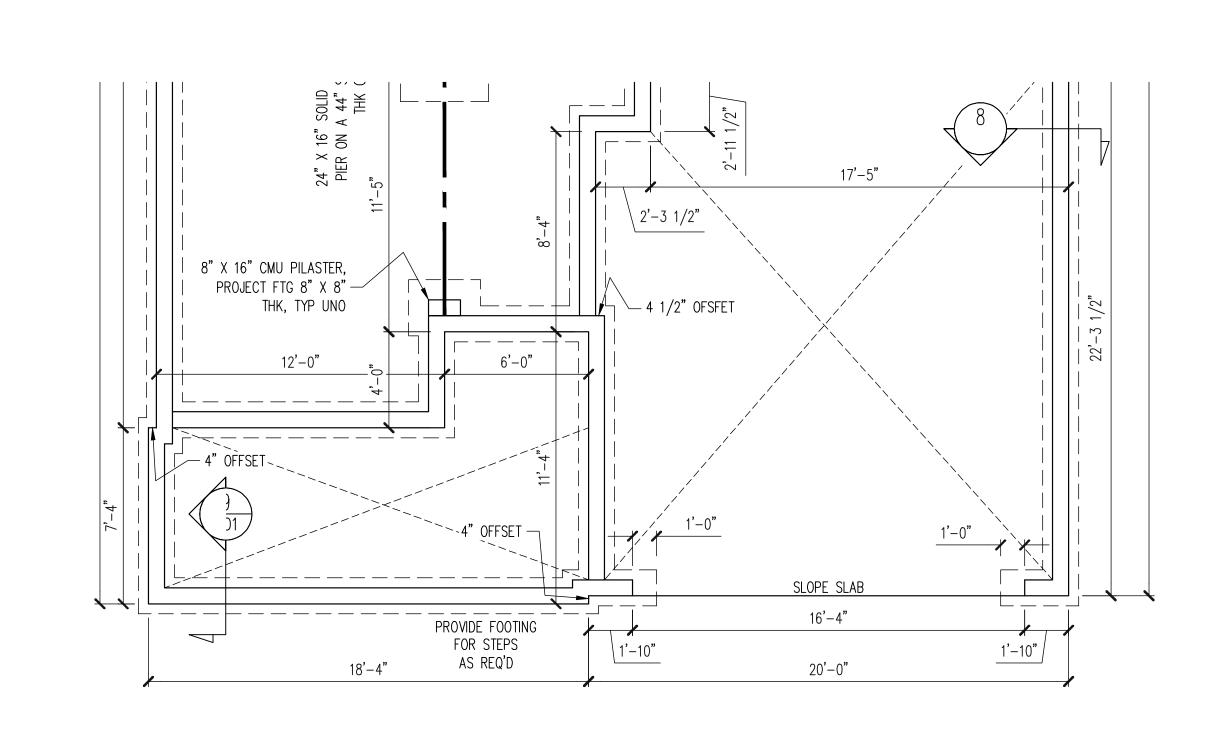
> SHEET NO. **S5** 5 of 23




FOUNDATION PLAN CRAWLSPACE OPTION CRAFTSMAN ELEVATION 1/4" = 1'-0"


REFER TO SHEET NO. S2 FOR ALL STRUCTURAL NOTES AND SCHEDULES

WINSTON RH PROJECT NO. 17-29-113R SHEET NO.


> **S7** 7 of 23

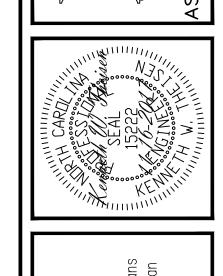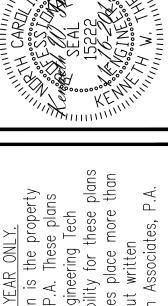PLAN NO.





D A II A G

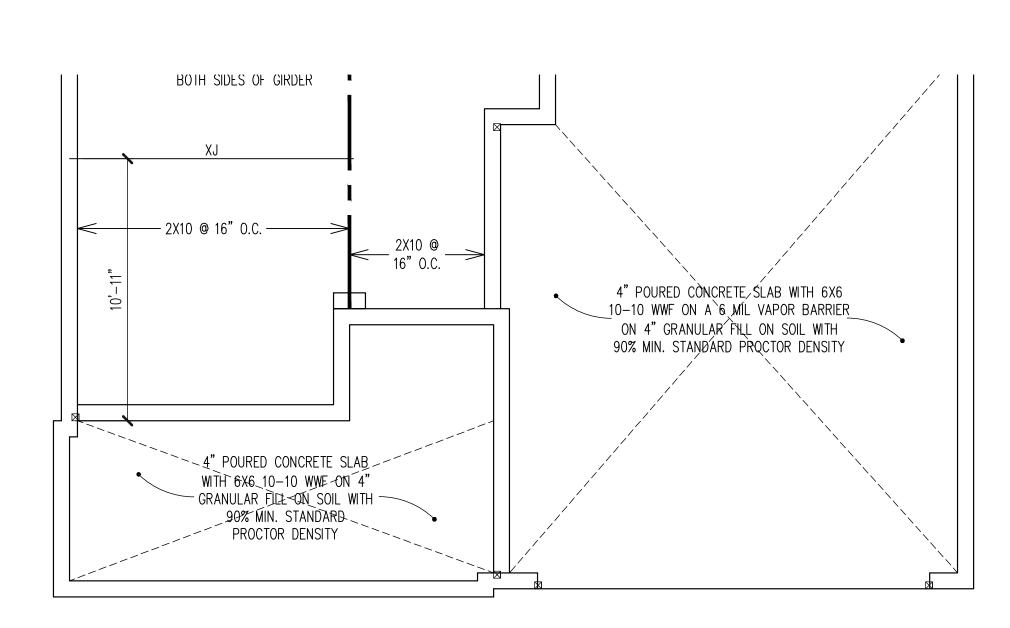

CRAWL SPACE FRAMING PLAN

CRAFTSMAN ELEVATION

1/4" = 1'-0"

REFER TO SHEET NO. S2 FOR ALL STRUCTURAL NOTES AND SCHEDULES IS222

ENGINEERING SEAL VALID FOR 1 YEAR ONLY.

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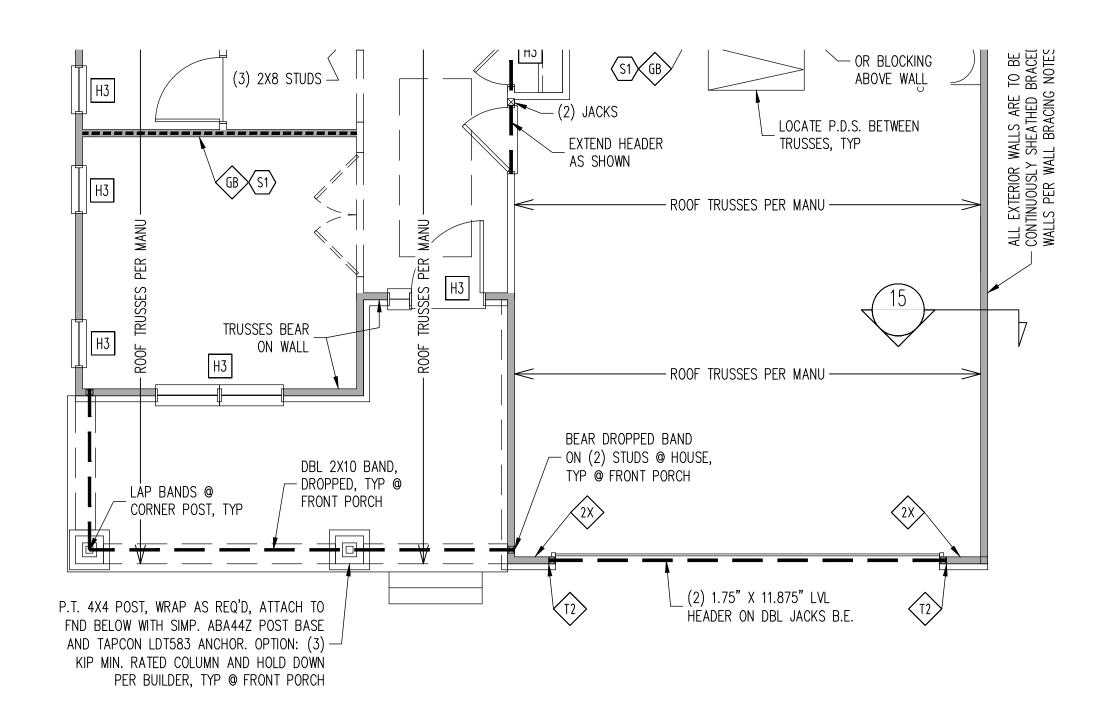
J	WNC	ENG: KWT/DTN	REV:	DATE: 11-16-2017
MCKEE HOMES, INC.	STRUCTURAL ADDENDUM			
CLIENT:	SCOPE	LOT #:		

PLAN NO.
WINSTON RH

PROJECT NO. 17-29-113R

SHEET NO.

8 of 23



1ST FLOOR FRAMING PLAN CRAFTSMAN ELEVATION WALLS AND CEILING 1/4" = 1'-0"

REFER TO SHEET NO. S3 FOR ALL STRUCTURAL NOTES AND SCHEDULES

S PER MANU	: PER MANU	ALL EXTERIOR GABLE END WALLS ARE TO BE CONTINUOUSLY SHEATHED BRACED WALLS PER WALL BRACING NOTES
ROOF TRUSSES PER MANU	ROOF TRUSSES PER MANU	ALL EXTERIOR GA TO BE CONTINUOL WALLS PER WALL

2ND	FLOOR FRAMING PLAN	
	LOFT OPTION	
	ALL ELEVATIONS	

WALLS AND CEILING $\frac{1/4" = 1'-0"}{}$

REFER TO SHEET NO. S3 FOR ALL STRUCTURAL

NOTES AND SCHEDULES

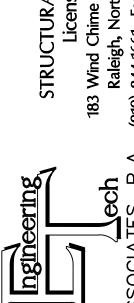
SHEET NO. 59 9 of 23

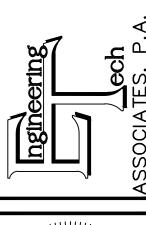
PLAN NO.

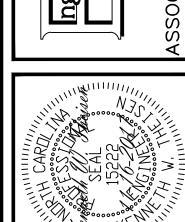
WINSTON RH

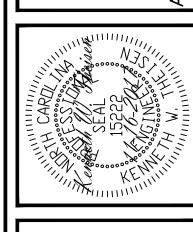
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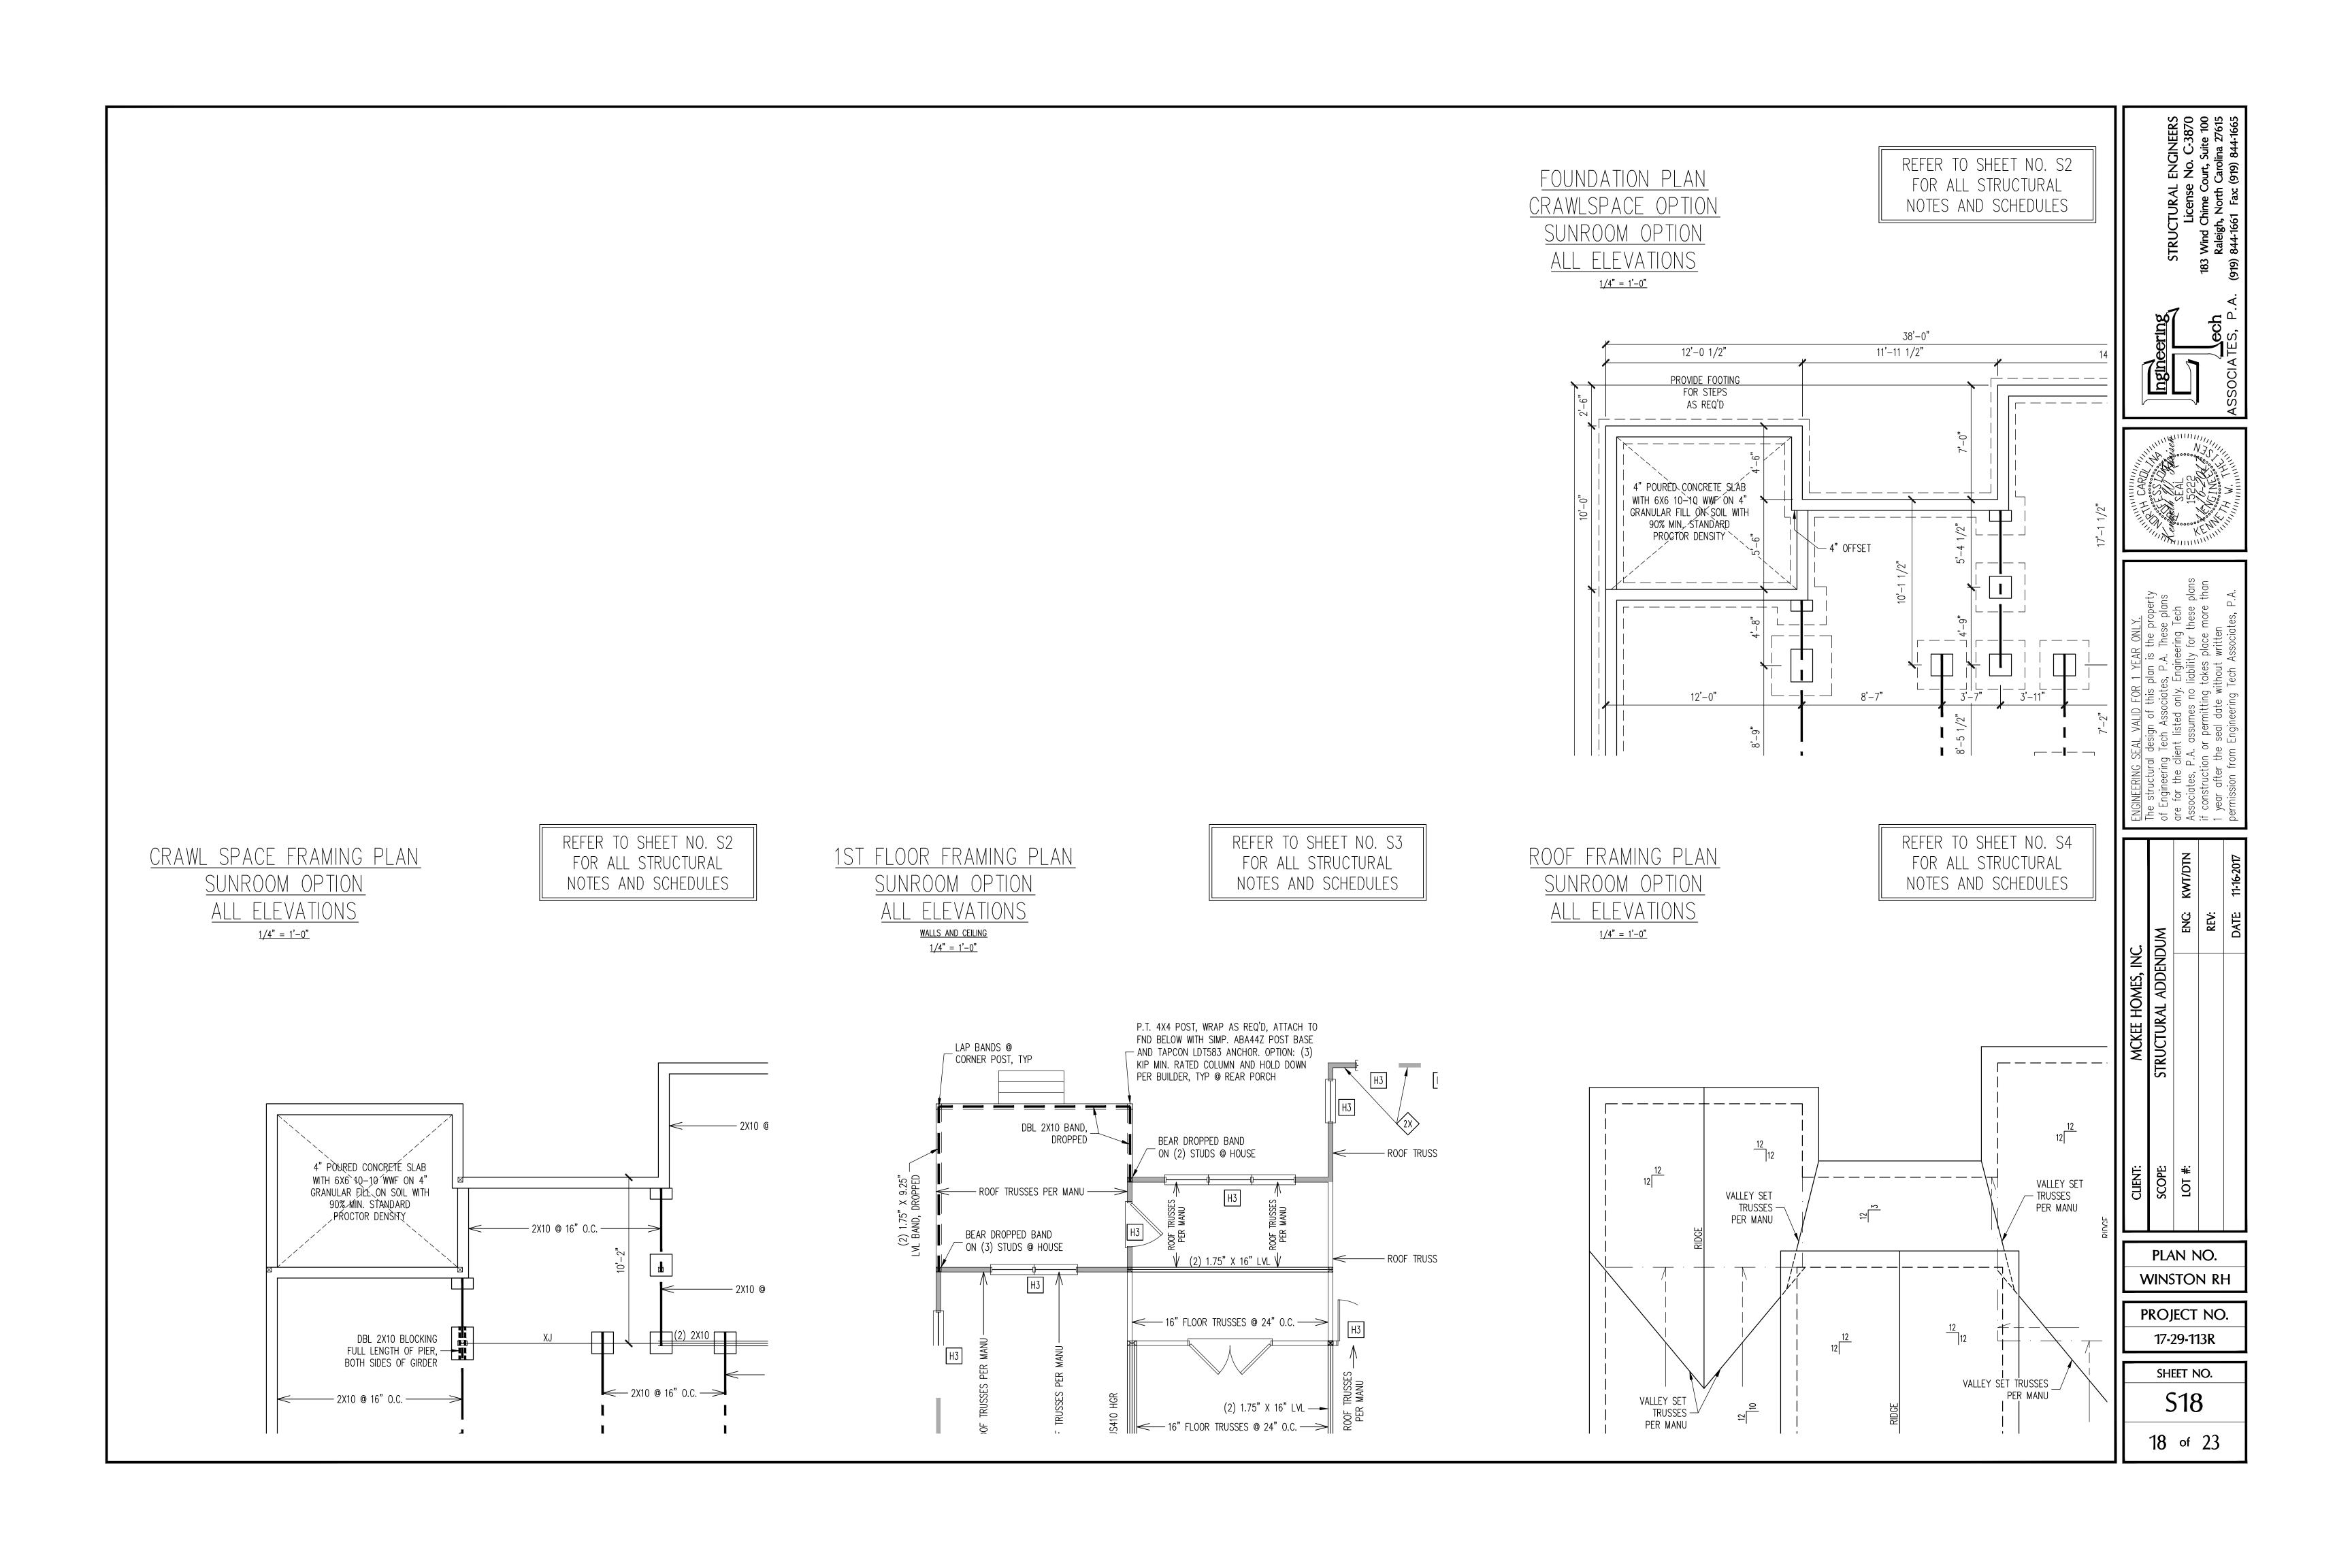
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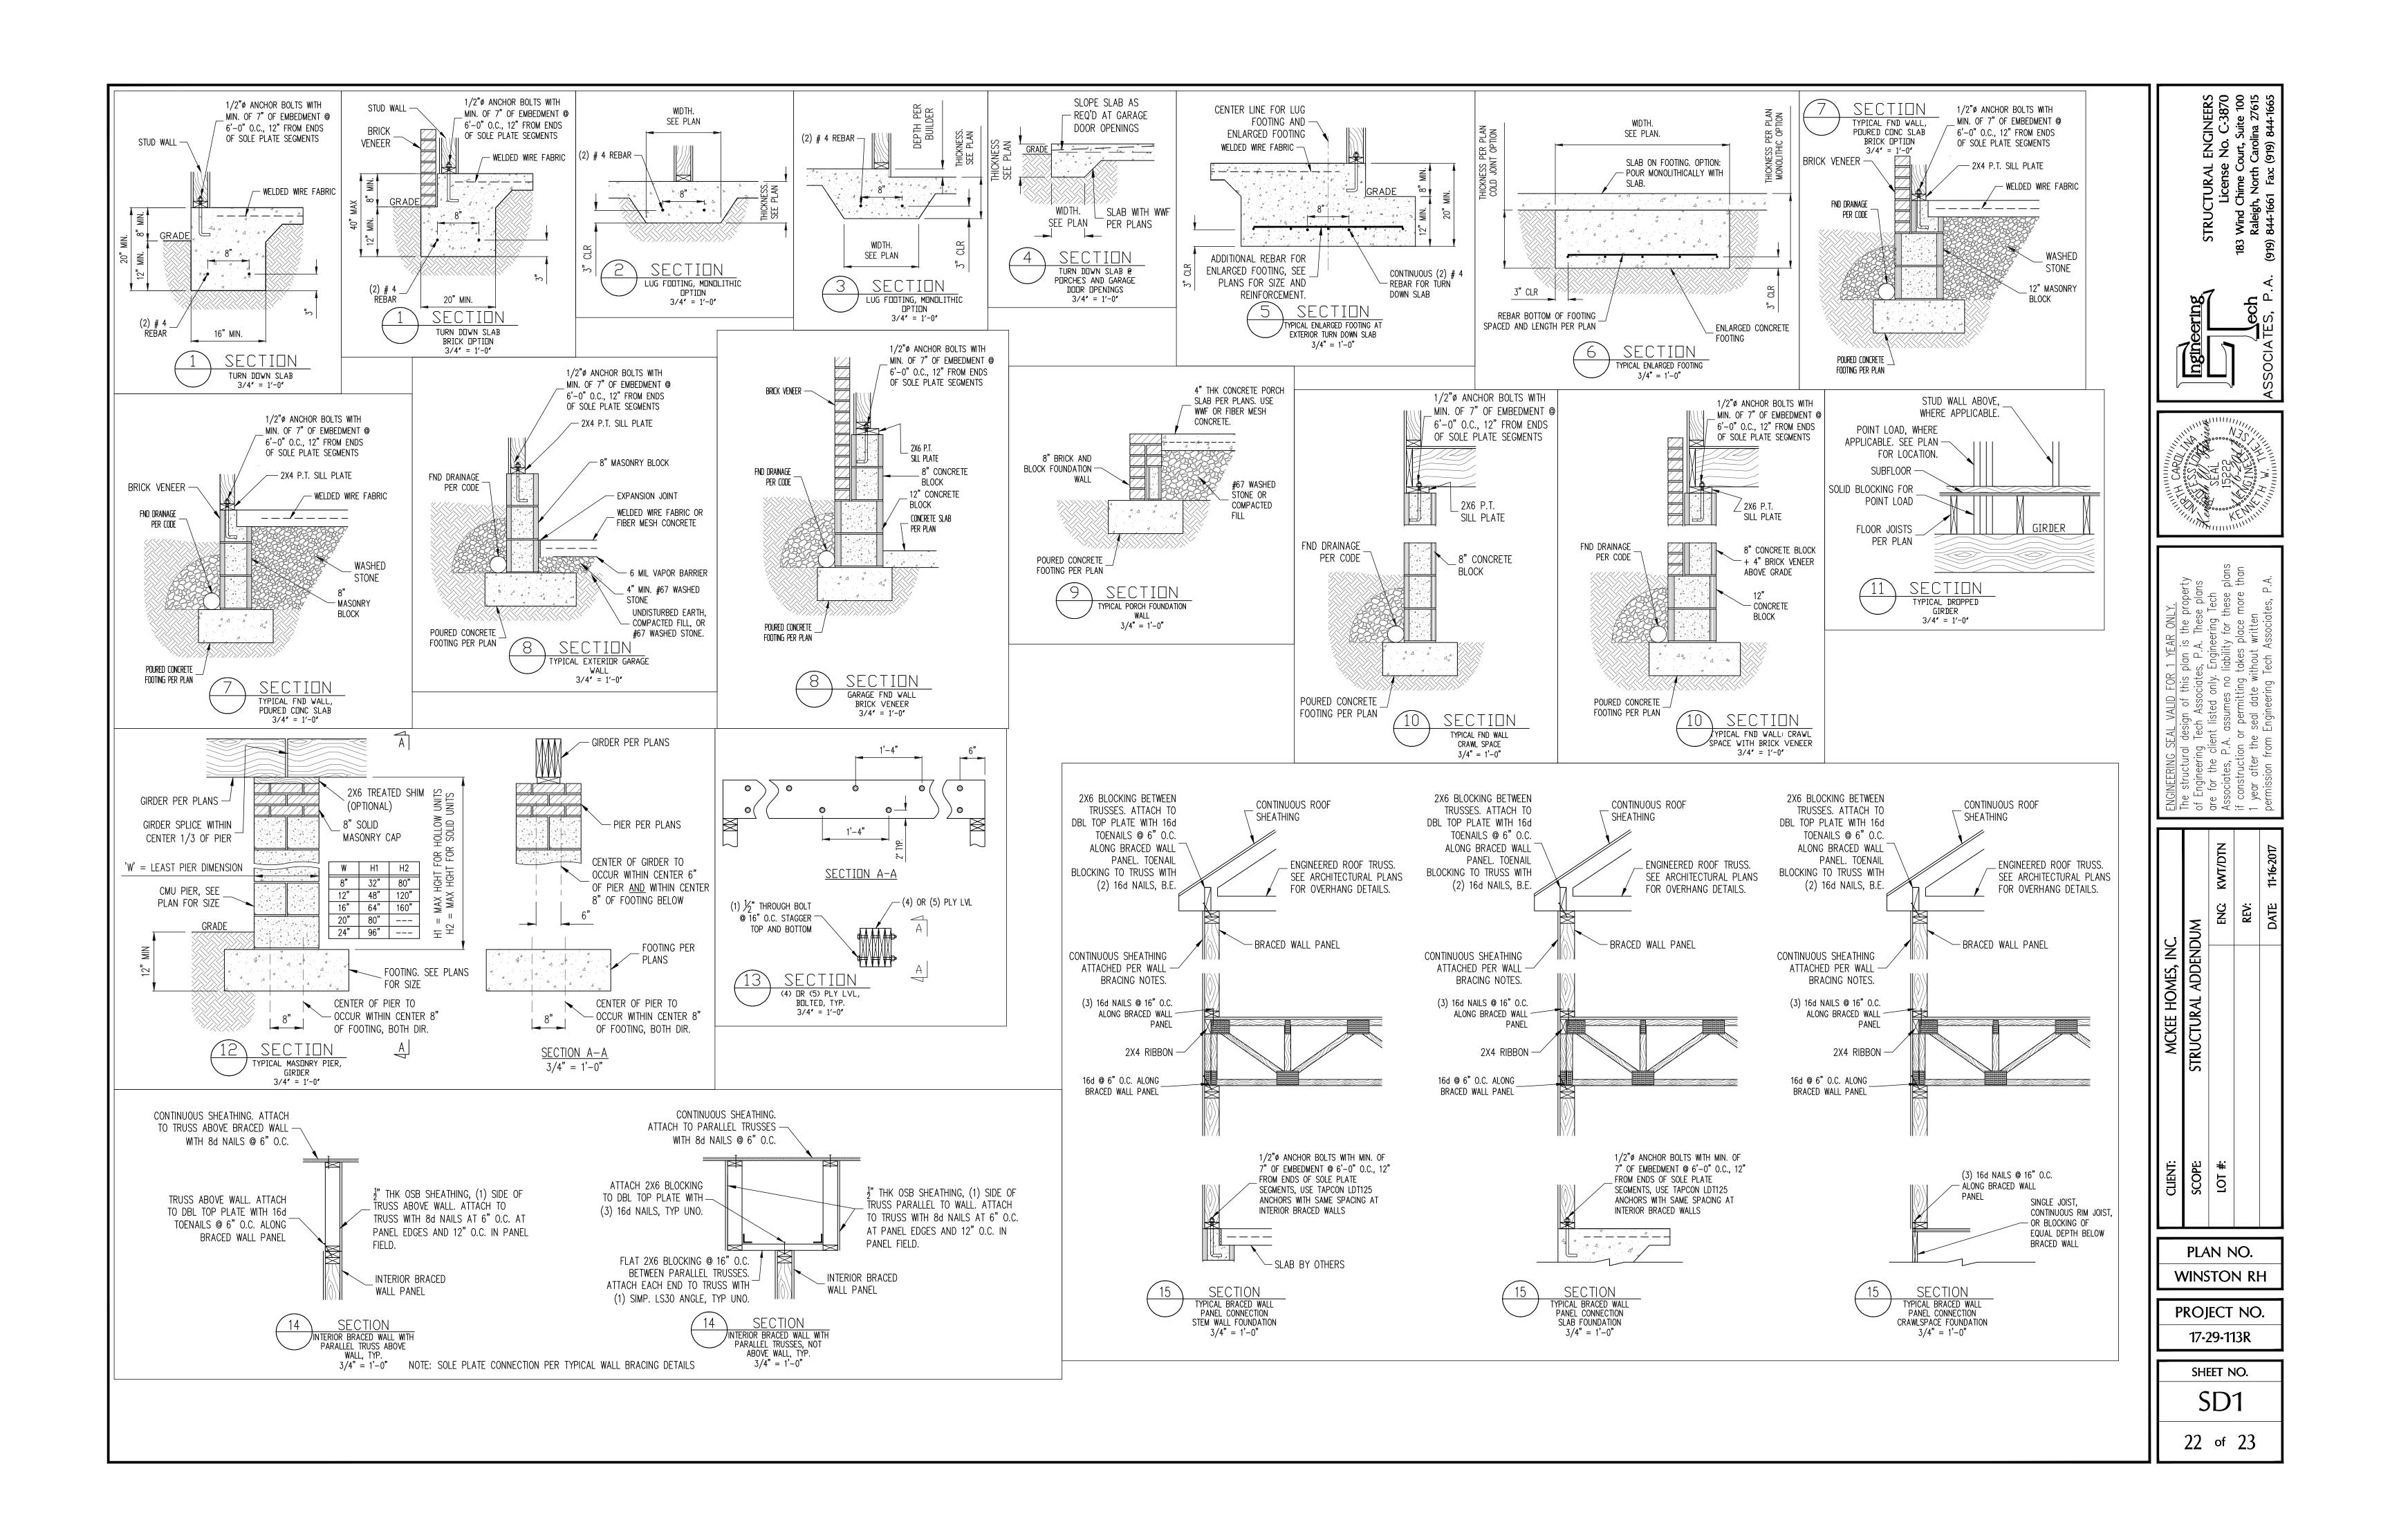















001101110011011	<u>SPECIFICATIONS</u>
PART 1: GENERAL ON CONSTRUCTION SHALL MEET THE REQUIREMENTS OF THE NORTH CAROLINA RESIDENTIAL CODE, 2012 EDITION.	4.09 CAST IN PLACE CONCRETE SHALL BE OF NORMAL WEIGHT AND SHALL HAVE A MINIMUL COMPRESSIVE STRENGTH OF 3000 PSI AT 28 DAYS TYP UNO. 4.10 CONCRETE MASONRY UNITS SHALL CONFORM TO ASTM C 90 OR ASTM C 55.
.02 STRUCTURAL STEEL SHALL MEET THE REQUIREMENTS OF THE AISC SPECIFICATION FOR THE DESIGN, FABRICATION AND ERECTION OF STRUCTURAL STEEL FOR BUILDINGS. .03 REINFORCED CAST IN PLACE CONCRETE SHALL BE PROPORTIONED, MIXED AND PLACED IN ACCORDANCE WITH THE SPECIFICATIONS OF ACI 318, LATEST EDITION. .04 MASONRY CONSTRUCTION SHALL CONFORM TO THE SPECIFICATIONS OF ACI 530–95.	 4.11 MORTAR SHALL BE TYPE S CONFORMING TO ASTM C 476. 4.12 NAILS SHALL BE COMMON WIRE NAILS TYP UNO. 4.13 LAG SCREWS SHALL CONFORM TO ANSI/ASME STANDARD B18.2.1-1981.
LATEST EDITION. .05 METHODS, PROCEDURES AND SEQUENCES OF CONSTRUCTION ARE THE RESPONSIBILITY OF THE CONTRACTOR. THE CONTRACTOR SHALL TAKE ALL NECESSARY PRECAUTIONS TO MAINTAIN AND INSURE THE INTEGRITY OF THE STRUCTURE AT ALL STAGES OF CONSTRUCTION.	PART 5: CONSTRUCTION 5.01 FLITCH PLATE BEAMS SHALL CONSIST OF A CONTINUOUS STEEL PLATE BOLTED BETWEE TWO PIECES OF CONTINUOUS LUMBER AS SIZED ON THE PLANS. BOLT PIECES TOGETH USING 1/2" Ø BOLTS SPACED AT 24" O.C. STAGGERED TOP TO BOTTOM OF THE BEAM MAINTAIN A 2" EDGE DISTANCE. PLACE TWO BOLTS, ONE ABOVE THE OTHER, 6" FROM
PART 2: DIMENSIONS 2.01 DIMENSIONS SHOWN SHALL GOVERN OVER SCALE ON THESE DRAWINGS. PART 3: DESIGN LOADS	EACH END OF THE BEAM. 5.02 STEEL, LVL AND FLITCH PLATE BEAMS BEARING ON A STUD WALL PERPENDICULAR TO BEAM SHALL BEAR FULL WIDTH ON THE SUPPORTING WALL INDICATED AND SHALL BE SUPPORTED BY A MINIMUM OF THREE GANGED STUDS, OR A GANGED STUD COLUMN IN A NUMBER OF STUDS SUCH THAT THE STUD COLUMN IS AT LEAST AS WIDE AS THE BEAM BEING SUPPORTED, WHICHEVER IS GREATER, TYP UNO.
.01 DESIGN LOADS SHALL CONFORM WITH THE TABLE BELOW: USE LIVE LOAD (PSF) DEAD LOAD (PSF)	5.03 STEEL, LVL AND FLITCH PLATE BEAMS BEARING ONTO THE END OF A STUD WALL PARALLEL TO THE BEAM SHALL BEAR A MINIMUM OF 4 1/2" ONTO THE WALL AND BE SUPPORTED BY A TRPL STUD GANGED COLUMN TYP UNO.
ALCONIES, DECKS, ATTICS WITH FIXED STAIR 40 10 CCESS, DWELLING UNITS (INCLUDUNG SLEEPING DOMS), ATTICS WITH FIXED STAIR ACCESS, TAIRS, FIRE ESCAPES	5.04 SOLID SAWN LUMBER GANGED BEAMS BEARING ON A STUD WALL PERPENDICULAR TO THE BEAM SHALL SHALL BEAR FULL WIDTH ON THE SUPPORTING WALL INDICATED (LET 1 1/2" TO ALLOW FOR A CONTINUOUS RIM JOIST) AND SHALL BE SUPPORTED BY A GANGED STUD COLUMN THE SAME WIDTH AS THE BEAM TYP UNO.
ARAGES (PASSENGER CARS ONLY) 50 TTICS (NO STORAGE, LESS THAN 5' HEADROOM) 10 10	5.05 SOLID SAWN LUMBER GANGED BEAMS BEARING ONTO THE END OF A STUD WALL PARALLEL TO THE BEAM SHALL BEAR A MINIMUM OF 3" ONTO THE WALL AND BE SUPPORTED BY A DBL STUD GANGED COLUMN TYP UNO.
TTICS (WITH STORAGE) 20 10 00F 20 10 (15 FOR VAULTS)	5.06 EXTRA JOISTS OR SINGLE LVL MEMBERS OF 1.75" OR LESS WIDTH, BEARING ON A STU WALL PERPENDICULAR TO THE BEAM SHALL BEAR ON THE WALL A MINIMUM OF 2" AN SHALL BE SUPPORTED BY ONE ADDITIONAL STUD.
OTES: — INDIVIDUAL STAIR TREADS ARE TO BE DESIGNED FOR THE UNIFORMLY DISTRIBUTED LIVE LOAD OR A 300 LB. CONCENTRATED LOAD ACTING OVER AN AREA OF 4 SQ. IN., WHICHEVER PRODUCES THE GREATER STRESS.	5.07 SOLID SAWN LUMBER JOISTS THAT ARE GANGED TO FORM A BEAM SHALL HAVE ADJACENT MEMBERS IN THE BEAM NAILED TOGETHER WITH THREE ROWS OF 10d NAILS @ 16" O.C.
 GUARD RAILS AND HAND RAILS ARE TO BE DESIGNED FOR A SINGLE CONCENTRATED LOAD OF 200 LB. APPLIED IN ANY DIRECTION AT ANY POINT ALONG THE TOP. BUILDER TO VERIFY DEAD LOAD DOES NOT EXCEED 10 PSF WHEN HEAVY FLOOR OR ROOF FINISHES SUCH AS TILE OR SLATE ARE UTILIZED 	5.08 LVL MEMBERS THAT ARE GANGED TO FORM A BEAM SHALL HAVE ADJACENT MEMBERS IN THE BEAM FASTENED TOGETHER PER MANUFACTURERS RECOMMENDATIONS, TYP UN
.02 INTERIOR WALLS: 5 PSF LATERAL03 BASIC WIND DESIGN VELOCITY OF 100 MPH04 LOAD DURATION FACTOR FOR ROOF STRUCTURAL MEMBERS IS 1.15.	5.09 STUDS THAT ARE GANGED TO FORM A COLUMN SHALL HAVE ADJACENT STUDS WITHIN COLUMN NAILED TOGETHER WITH ONE ROW OF 10d NAILS AT 8" O.C. (TWO ROWS OF NAILS @ 8" O.C., 3" APART, FOR 2X8 OR 2X10 STUDS) ALL COLUMNS SHALL BE CONTINUOUS DOWN TO THE FOUNDATION OR OTHER PROPERLY DESIGNED STRUCTURAL ELEMENT SUCH AS A BEAM. COLUMNS TRANSFERRING LOADS THROUGH FLOOR LEVELS SHALL BE SOLIDLY BLOCKED FOR THE FULL WIDTH OF THE STUD COLUMN WITHIN THE CAVITY FORMED BY THE FLOOR JOISTS.
PART 4: MATERIALS Soll Bearing Capacity 2000 PSF (Presumptive). PART 4: MATERIALS STRUCTURAL STEEL SQUARE AND RECTANGULAR TUBING SHALL CONFORM TO ASTM A500 GRADE B MINIMUM GRADE. ALL OTHER STRUCTURAL STEEL SHALL CONFORM TO	5.10 STUD WALLS SHALL CONSIST OF 2X4 STUDS SPACED AT 16" O.C. UNO. STUDS SHALL BE CONTINUOUS FROM SOLE PLATE AT FLOOR TO DOUBLE TOP PLATE AT THE CEILING OR ROOF. NO INTERMEDIATE BANDS OR PLATES SHALL CAUSE DISCONTINUITIES IN A STUD WALL EXCEPT AS REQUIRED FOR DOOR OR WINDOW OPENINGS. THE KING STUDS FOR SUCH OPENINGS SHALL BE CONTINUOUS.
ASTM A992 MINIMUM GRADE TYP UNO. 8.02 REBAR SHALL BE DEFORMED STEEL CONFORMING TO ASTM A615 GRADE 60 TYP UNO	5.11 PILOT HOLES SHALL BE USED FOR LAG SCREW INSTALLATION AND SHALL BE BORED ACCORDING TO NDS SPECIFICATIONS.
O3 SOLID SAWN WOOD FRAMING DESIGN IS BASED ON NO. 2 SPRUCE PINE FIR FOR JOISTS, RAFTERS, WOOD GIRDERS/BEAMS, STUDS, ETC. ALLOWANCE HAS BEEN MADE FOR SYP #2 SUBSTITUTION TYP UNO.	5.12 ALL WELDING SHALL BE PERFORMED BY AN AWS CERTIFIED WELDER 5.13 ALL CONCRETE, INCLUDING CONCRETE FOR FOOTINGS, IS TO BE CAST IN PLACE, TYP U
.04 LVL OR PSL MINIMUM ALLOWABLE DESIGN STRESSES ARE AS FOLLOWS: E= 1.9 X 10E6 PSI, Fb = 2600 PSI, Fv = 285 PSI, Fc = 750 PSI	5.14 BOLTS AND LAG SCREWS USED FOR BOLTING WOOD MEMBERS SHALL HAVE STANDARD WASHERS INSTALLED FOR THE NUTS AND BOLT / SCREW HEADS
.05 LSL MINIMUM ALLOWABLE DESIGN STRESSES ARE AS FOLLOWS: E= 1.3 X 10E6 PSI, Fb = 1700 PSI, Fv = 400 PSI, Fc = 680 PSI	PART 6: SUBSTITUTIONS 6.01 IN LIEU OF WELDED WIRE FABRIC IN SLABS: SYNTHETIC POLYPROPYLENE FIBRILLATED
.06 BOLTS SHALL CONFORM TO ASTM A307 MINIMUM GRADE TYP UNO .07 WELDING ELECTRODES SHALL BE E70XX .08 LUMBER IN CONTACT WITH THE GROUND, CONCRETE OR MASONRY SHALL BE PRESSURE TREATED IN ACCORDANCE WITH AWPA STANDARD C-15. ALL OTHER EXPOSED LUMBER SHALL BE TREATED IN ACCORDANCE WITH AWPA STANDARD C-2 OR BY ANY METHOD GIVING EQUAL PROTECTION. THE BUILDING CODE OFFICE MAY ALSO APPROVE A NATURAL DECAY RESISTANT WOOD PER SECTION 19-6(A)	MICRO FIBERS, FIBER LENGTH 1 1/2", DOSAGE RATE 1 1/2 LBS/CU YD. 6.02 OTHER MATERIAL OR MEMBER SIZE SUBSTITUTIONS REQUIRE THE WRITTEN AUTHORIZAT OF THE DESIGNERS. UNAUTHORIZED DEVIATIONS ARE THE SOLE RESPONSIBILITY OF TH CONTRACTOR.
<u>NOTES</u>	ABBREVIATIONS
ALL WORK IS TO BE DONE IN STRICT ACCORDANCE WITH STATE AND LOCAL CODES. THE BUILDER S RESPONSIBLE FOR REVIEWING PLANS PRIOR TO CONSTRUCTION. IF ENGINEERING SERVICES HAS BEEN PROVIDED THE BUILDER SHALL VERIFY THAT THE FOUNDATION AND STRUCTURAL PLANS HAVE BEEN SEALED BY AN ENGINEER REGISTERED BY THE STATE. IF THE PLANS HAVE NOT BEEN BEEN SEALED, THE BUILDER SHALL IMMEDIATELY CONTACT ENGINEERING TECH BEFORE PROCEEDING FURTHER. ANY ERRORS DUE TO A FAILURE TO FOLLOW THE ABOVE PROCEDURES SHALL NOT BE THE RESPONSIBILITY OF ENGINEERING TECH. ALL FINAL SETS OF THE SAME PLAN SSUED TO A BUILDER SHOULD BE REVIEWED FOR UNIFORMITY, ESPECIALLY IF PRIOR SETS OF PLANS HAVE BEEN ISSUED AS STUDY COPIES.	ABV ABOVE FND FOUNDATION TYP TYPICAL B. BOTH FTG FOOTING TYP TYPICAL TRPL TRIPLE STUD POCK CONC CONCRETE HGR HANGER CS CONTINUOUS SHEATHING LVL LAMINATED VENEER DIA DIAMETER LUMBER NOT TO SCALE DJ DOUBLE NTS NOT TO SCALE DJ DOUBLE JOIST O.C. ON CENTER DSP DBL STUD POCKET PSL PARALLEL STRAND EQ EQUAL LUMBER

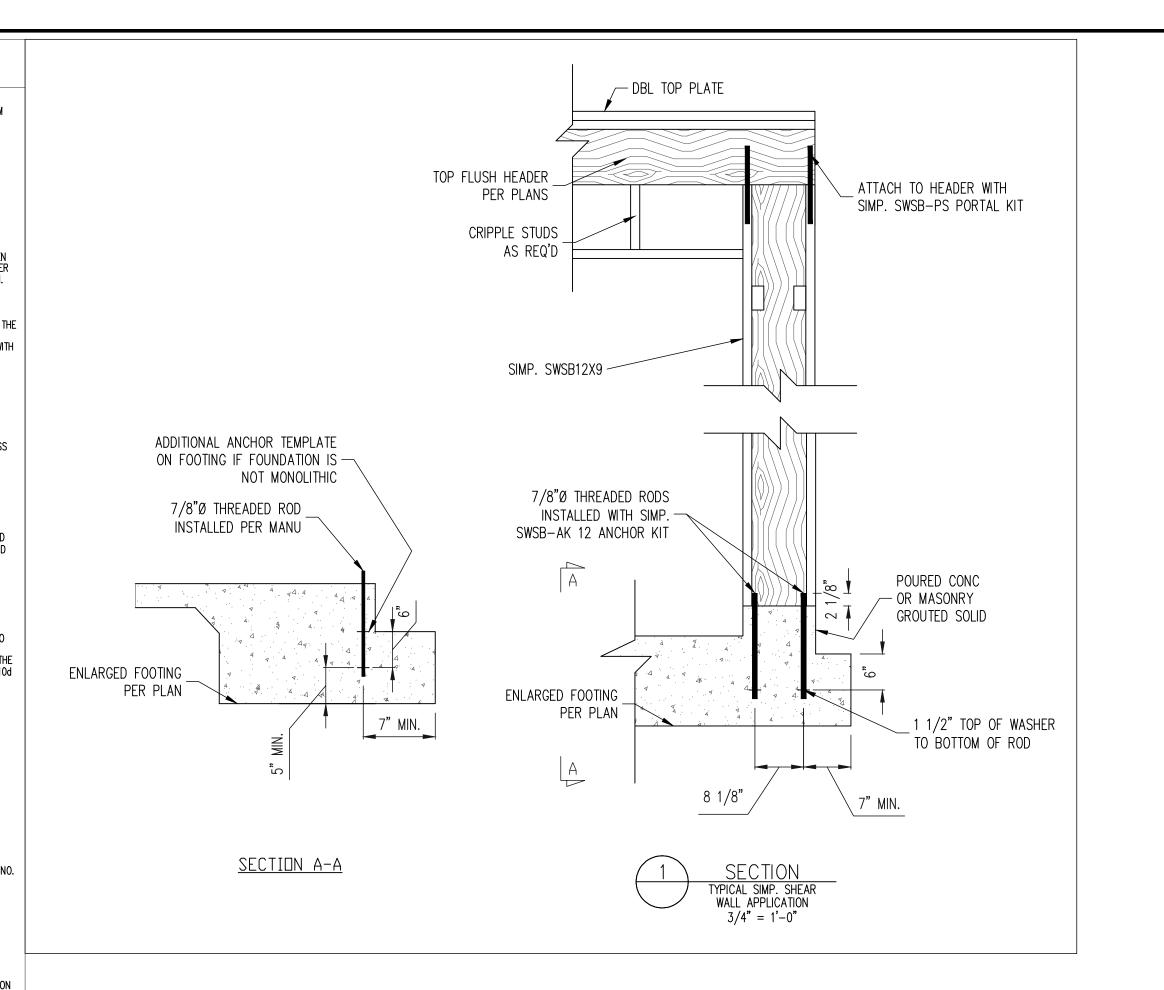
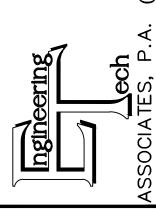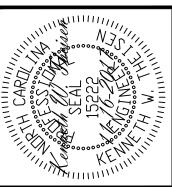
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