ABBREVIATIONS INDEX L LENGTH LA LAUNDRY LAV LAVATORY LVR LOUVER MAX MAXIMUM MECH MECHANICAL MFR. MANUFACTURER MIN MINIMUM MSC MISCELLANEOUS N NORTH A.D. AREA DRAIN ADJ ADJUSTABLE ALT ALTERNATE ALUM ALUMINUM FIRST FLOOR PLAN A1.1 ALUM ALUMINUM ARCH. ARCHITECTURAL BA BATHROOM BD BOARD BF BI-FOLD (DOOR) BLDG BUILDING BLK BLOCK (CMUs) RI W BFI OW BD BH-DILING BLOG BUILDING BLK BLOCK (CMUS) BLY BEOW BP BEPASS (DOOR) BOT BOTTOM BOTT BOTTOM CAB CABBLE C C.J. CONTROL JOINT OR CONSTRUCTION JOINT C.J. COSET OR CENTER LINE C.D. BOT BOTTOM GET BMSONRY UNIT A1.1.1 FIRST FLOOR PLAN MISC MISCELLANEOUS N NORTH N.T.S. NOT TO SCALE O.G.D. OVERHEAD GARAGE DOOR OFF OVERHEAD GARAGE DOOR OFF OVERHEAD PAR PARALLEL P.B. PUSH BUTTON PDR POWDER FIRST FLOOR OPTIONS A1.1.2 A1.2 SECOND FLOOR PLAN A1.2.1 SECOND FLOOR PLAN PRESSURE TREATED WOOD POLYVINYL CHLORIDE PIPE PAVEMENT PRE-WIRE PLYWOOD A1.4 **BUILDING SECTIONS** A1.5.0 **COASTAL ELEVATIONS** COL COLUMN CONC CONCRETE CARPET CARPET CONT. CERAMIC TILE RETURN AIR GRILL A1.5.1 COASTAL ELEVATIONS A1.5.2 COASTAL ELEVATION OPTIONS A1.5.3 COASTAL ROOF PLAN A1.6.0 TRADITIONAL ELEVATIONS TRADITIONAL ELEVATIONS A1.6.1 SYM SYMBOL SYM SYMBOL S4S SMOOTH FOUR SIDES T.B. TOWEL BAR ELEX ELEVATION A1.6.2 TRADITIONAL ELEVATION OPTIONS T TREAD (AT STAIRS) OF T.B. TOWEL BAR TEMP. TEMPERED (GLASS) T&G TONGUE & GROOVE T.O.C. TOP OF CURB EXTERIOR FORCED AIR UNIT FLOOR CHANGE FLOOR DRAIN FLOOR BANN FINISHED GRADE FLOORING FLOORING FLOORING FOOTING A1.6.3 TRADITIONAL ROOF PLAN TV TELEVISION TAS HARKSOLOW U.N.C. UNLESS NOTED OTHERWISE U.R. VAEPOL RAFRIER V.R. VENT THRU ROOF W. WASHING MACHINE W. W. WHAT AN GWITHELI **CRAFTSMAN ELEVATIONS** A1.7.0 A1.7.1 CRAFTSMAN ELEVATIONS A1.7.2 **CRAFTSMAN ELEVATION OPTIONS** GAR GARAGE GB. GYPSUM BOARD GD. GRADE OR GRADING GD. GARAGE DOOR OPENER GFI GROUND FAULT INTERRUPTER GL GLASS OR GLAZING (P BD. GYPSUM BOARD HD. HEAD OR HARD HD. HEAD OR HARD A1.7.3 **CRAFTSMAN ELEVATION OPTIONS** A1.7.4 CRAFTSMAN ELEVATION OPTIONS R PROPERTY LINE 0 ROUND / DIAMETER A1.7.5 CRAFTSMAN ROOF PLAN HD HEAD OR HARD HDR HEADEN HG HEGHING/VENTILATING/AIR COND. HWD HARDWOOD INT INTERIOR JST JOINT KIT KITCHEN & AND C CENTERLINE # POUND/NUMBER A1.8.0 **EUROPEAN ELEVATIONS** A1.8.1 **EUROPEAN ELEVATIONS EUROPEAN ELEVATION OPTIONS** A1.8.2 BUILDING CODE COMPLIANCE / A1.8.3 **EUROPEAN ROOF PLAN** PROJECT INFORMATION A1.9.0 **CLASSIC ELEVATIONS** ALL CONSTRUCTION TO COMPLY WITH LOCAL CODES AND ORDINANCES CURRENTLY IN USE WITH THE LOCAL JURISDICTION. CLASSIC ELEVATIONS A1.9.1 A1.9.2 CLASSIC ELEVATION OPTIONS CLASSIC ROOF PLAN A1.9.3 CONTRACTOR AND BUILDER SHALL REVIEW ENTIRE PLAN TO VERIEY E1.0 FIRST FLOOR UTILITY PLAN CONTINUALISM AND BUILDER SHALL HEVIEW ENTIRE PLAN TO VEHIFY CONFORMANCE WITH ALL CURRENT APPLICABLE CODES IN EFFECT AT TIME OF CONSTRUCTION. BY USING THESE DRAWINGS FOR CONSTRUCTION IT IS UNDERSTOOD THAT CONFORMANCE WITH ALL APPLICABLE CODES IS THE RESPONSIBILITY OF THE BUILDER AND CONTRACTOR. E2.0 SECOND FLOOR UTILITY PLAN SINGLE FAMILY RESIDENCE / 3 STORY TOWNHOMES OCCUPANCY CLASSIFICATION RESIDENTIAL R-3 ALL CONSULTANT DRAWINGS ACCOMPANYING THESE GMD DESIGN GROUP DRAWINGS HAVE NOT BEEN THEREFORE ASSUMES NO LIABILITY FOR THE COMPLETENESS OR CORRECTNESS OF THESE DRAWINGS. TYPE VB (2 HOUR DWELLING SEPARATION BETWEEN UNITS

THE SULLIVAN

Lot 1079 - Anderson Creek Academy

EUROPEAN AREA				
Name	Area			
FIRST FLOOR	851 SF			
SECOND FLOOR	1296 SF			
HEATED	2147 SF			
COVERED PORCH	42 SF			
GARAGE	437 SF			
UNHEATED	479 SF			

OPTIONS AREA

GENERAL NOTES:

THESE DOCUMENTS ARE THE PROPERTY OF THE DESIGNER AND SHALL NOT BE COPIED DUPLICATED, ALTERED, MODIFIED OR REVISED IN ANY WAY WITHOUT THE EXPRESSED WRITTEN APPOINAL OF THE DESIGNER.

CONTRACTOR SHALL VERIFY ALL CONDITIONS AND DIMENSIONS AT THE SITE AND

ALL INCONSISTENCES SHALL BE BROUGHT TO THE ATTENTION OF THE DEVELOPER AND THE DESIGNER BEFORE PROCEEDING WITH WORK. ANY ERRORS OR OMISSIONS FOUND IN THESE DRAWINGS SHALL BE BROUGHT TO

DEVELOPERS AND DESIGNERS ATTENTION IMMEDIATELY. DO NOT SCALE DRAWINGS. WRITTEN DIMENSIONS TAKE PRECEDENCE OVER SCALED

ALL DIMENSIONS ARE TO FACE OF STUD OR TO FACE OF FRAMING UNLESS OTHERWISE NOTED.

ALL TRUSS DRAWINGS TO BE REVIEWED AND APPROVED BY THE STRUCTURAL ENGINEER PRIOR TO ISSUANCE OF BUILDING PERMIT

ALL OR EQUAL SUBSTITUTIONS MUST BE SUBMITTED TO AND APPROVED BY CITY BUILDING OFFICIAL PRIOR TO INSTALLATION.

ALL ANGLED PARTITIONS ARE 45 DEGREES UNLESS OTHERWISE NOTED.

PROVIDE FIREBLOCKING. (PER LOCAL CODES.)

ALL ELECTRICAL AND MECHANICAL EQUIPMENT AND METERS ARE SUBJECT TO RELOCATION DUE TO FIELD CONDITIONS, CONTRACTOR TO VERIFY.

PROVIDE BLOCKING AND/OR BACKING AT ALL TOWEL BAR, TOWEL RING AND/OR TO/LET PAPER HOLDER LOCATIONS, AS SHOWN PER PLAN. TYPICAL AT ALL BATHROOMS AND POWDER ROOMS. VERIFY LOCATIONS AT FRAMING WALK.

ELASTOMERIC SHEET WATERPROOFING: FURNISH AND INSTALL ALL WATERPROOFING COMPLETE. A 40 MIL. SELF-ADHERING MEMBRANE OF RUBBERIZED ASPHALT INTEGRALLY BONDED TO POLYETHYLENE SHEETING, OR EQUAL. INSTALL PER MANUFACTURE'S AND TRADE ASSOCIATION'S PRINTED INSTALLATION INSTRUCTIONS, 6" MINIMUM LAP AT ALL ADJACENT WALL SURFACES.

TO THE BEST OF THE DESIGNER'S KNOWLEDGE THESE DOCUMENTS ARE IN CONFORMANCE WITH THE REQUIREMENTS OF THE BUILDING AUTHORITIES HAVING JURISDICTION OVER THIS TYPE OF CONSTRUCTION AND OCCUPANCY. SHOP DRAWING REVIEW AND DISTRIBUSTION, ALONG WITH PRODUCT SUBMITTALS,

SHOP DRAWING REVIEW AND US THIS DISTRICT, ALCOWS WITH PRODUCT SUDMITTALS RECURSTED IN THE CONSTRUCTION DOCUMENTS, SHALL BE THE SOLE RESPONSIBILITY OF THE GENERAL CONTRACTOR, UNLESS DIRECTED OTHERWISE UNDER A SEPARATE AGREEMENT.

DEVIATIONS FROM THESE DOCUMENTS IN THE CONSTRUCTION PHASE SHALL B REVIEWED BY THE DESIGNER AND THE OWNER PRIOR TO THE START OF WORK IN QUESTION. ANY DEVIATIONS FROM THESE DOCUMENTS WITHOUT PRIOR REVIEW, SHALL BE THE SOLE RESPONSIBILITY OF THE GENERAL CONTRACTOR.

THE GENERAL CONTRACTOR SHALL BE RESPONSIBLE FOR ALL WORK AND MATERIALS REPRESENTED ON THESE DOCUMENTS INCLUDING THE WORK AND MATERIALS FURNISHED BY SUBCONTRACTORS AND VENDORS. THE OWNER SHALL FURNISH ANY AND ALL REPORTS RECEIVED FROM THE GEOTECHNICAL ENGINEER (SOILS REPORT), ON THE STUDY OF THE PROPOSED SITS OF THE DESIGNER, STRUCTURAL ENGINEER, AND GENERAL CONTRACTOR. IN THE EVENT THE GEOTECHNICAL REPORTS DO NOT EXIST, THE SOILS CONDITION SHALL BE ASSUMED TO BE A MINIMUM DESIGN SOIL PRESSURE STATED BY THE STRUCTURAL ENGINEER OF RECORD FOR THE PURPOSE OF STRUCTURAL DESIGN. GENERAL CONTRACTOR SHALL ASSURE THE SOIL CONDITIONS MEET OR EXCEED

THE CRITERIA.
ALL WORK PERFORMED BY THE GENERAL CONTRACTOR SHALL COMPLY AND
CONFORM WITH LOCAL AND STATE BUILDING CODES, ORDINANCES AND
REGULATIONS, ALONG WITH ALL OTHER AUTHORITIES HAVING JURISDICTION. THE
GENERAL CONTRACTOR IS RESPONSIBLE TO BE AWARE OF THESE REQUIREMENTS
AND GOVERNING REGULATIONS.

PROVIDE AN APPROVED WASHER DRAIN PAN AT SECOND FLOOR ONLY THAT DRAINS TO EXTERIOR.

WINDOW SUPPLIER TO VERIFY AT LEAST ONE WINDOW IN ALL BEDROOMS TO HAVE A CLEAR OPENABLE AREA OF 4 0 SO FT. THE MINIMUM NET CLEAR OPENNG HEIGHT SHALL BE 22" AND THE MINIMUM NET CLEAR OPENING WIDTH SHALL BE 20", GLAZING TOTAL AREA OF NOT LESS THAN \$ 3 S G FT IN THE CASE, OF A GROUND WINDOW AND NOT LESS THAN \$ 7 S G FT IN THE CASE OF AN UPPER STORY WINDOW. (PER NCRC SECTION R310.1.1)

ALL HANDRAIL BALLUSTERS TO BE SPACED SUCH THAT A 4" SPHERE CANNOT PASS BETWEEN BALLUSTERS, (PER LOCAL CODES.) PROVIDE STAIR HANDRAILS AND GUARDRAILS PER LOCAL CODES.

BUILDER SET:

THE SCOPE OF THIS SET OF PLANS IS TO PROVIDE A "BUILDER'S SET" THE SCOPE OF THIS SET OF PLANS IS TO PROVIDE A "BUILDER'S SET" OF CONSTRUCTION DOCUMENTS AND GENERAL NOTES HEREINAFTER REFERRED TO AS "PLANS". THIS SET OF PLANS IS SUFFICIENT TO OBTAIN A BUILDING PERMIT; HOWEVER, ALL MATERIALS AND METHODS OF CONSTRUCTION IN NECESSARY TO COMPLETE THE PROJECT A REE NOT NECESSARILY DESCRIBED. THE PLANS DELINEAT EAD DESCRIBED CHY, LOCATIONS, DIMENSIONS, TYPES OF MATERIALS, AND GENERAL METHODS OF ASSEMBLING OR FASTENING. THEY ARE NOT INTENDED TO SPECIFY PARTICULAR PRODUCTS OR OTHER METHODS OF ANY SPECIFIC MATERIALS, PRODUCT OR METHOD. THE MIP LEMENTATION OF THE PLANS REQUIRES A CLIENT / CONTRACTOR THO ROUGHLY KNOWLEDGEABLE WITH THE APPLICABLE BUILDING CODES AND METHODS OF CONSTRUCTION SPECIFIC TO THIS PRODUCT TYPE AND TYPE OF CONSTRUCTION

CONSTRUCTION REQUIREMENTS AND QUALITY: PROVIDE WORK OF THE SPECIFIC QUALITY CONSTRUCTION REQUIREMENTS AND QUALITY: PHOVIDE WORK OF THE SPECIFIC QUALITY; WHERE QUALITY; LEVEL IS NOT INJCIATED, PROVIDE WORK OF QUALITY CUSTOMARY IN SIMILAR TYPES OF WORK WHERE THE PLANS AND SPECIFICATIONS, CODES, LAWS, REQULATIONS, MANUFACTURERS RECOMMENDATIONS OR INDUSTRY STANDARDS REQUIRE WORK OF HIGHER QUALITY OR PERFORMANCE, PROVIDE WORK COMPLYING WITH THOSE REQUIREMENTS AND QUALITY. WHERE TWO OR MORE QUALITY PROVISIONS OF THOSE REQUIREMENTS COPILICE WITH THE MOST STRINGENT REQUIREMENT; WHERE REQUIREMENTS AND CONTROL OF THE PROVISIONS OF THE REQUIREMENTS ARE DIFFERENT BUT APPARENTLY FOUND. EQUAL, AND WHERE IT IS UNCERTAIN WHICH REQUIREMENT IS MOST STRINGENT, OBTAIN CLARIFICATION FROM THE ARCHITECT BEFORE PROCEEDING.



NORTH CAROLINA OFFICE

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NO:	DATE:	REVISION:

PROFESSIONAL SEAL:

PROJECT TITLE:

THE SULLIVAN

SET CONSTRUCTION



PROJECT NO: GMD15022RAL SHEET TITLE:

TITLE SHEET

PRINT DATE: **DECEMBER 19, 2016**

T-1

- HOUSE TO GARAGE FIRE SEPARATION, GARAGE/HOUSE SEPARATION AT VERTICAL SURFACES SHALL BE PROTECTED WITH ONE (1) LAYER 1/2" GYPSUM BOARD, GARAGE/HOUSE SEPARATION AT HORIZONTAL SURFACES SHALL BE PROTECTED WITH ONE (1) LAYER 5/8" TYPE "X" GYPSUM BOARD HOUSE TO GARAGE DOOR SEPARATION. PROVIDE 1 3/9" SOLID CORE DOOR OR APPROVED 20 MINUTE RATED DOOR

 BENEATH STAIRS AND LANDINGS, 1/2" GYPSUM BOARD ON WALLS AND CEILING OF ENCLOSED ACCESSIBLE AREAS

 PRE-FABRICATED METAL FIREPLACE, INSTALL PER MANUFACTURER WRITTEN INSTRUCTIONS

 ATICA CCESS LARGE ENOUGH TO REMOVE LARGEST PIECE OF EQUIPMENT BUT NOT LESS THAN 30" X22". FIRE RATED ACCESS AN OTED. ATTICA CCESS LADDER, VERIFY LOCATION AND SIZE WITH TRUSSES (5) 1/2"X54" SIZE)

 TEMPERED SAFETY GLASS

 HAIF WALL HEIGHT AS NOTED.

- 14 TUB-SHOWER COMBO
 15 ACRYLIC TUB W/ PLATFORM, SIZE AS NOTED
- 17 GAS COOKTOP AND HOOD, VENT PER MANUFACTURER'S WRITTEN INSTRUCTIONS


WALL LEGEND

FULL HEIGHT FULL HEIGHT 2X4 WOOD STUD PARTITION 2X6 WOOD STUD PARTITION

STONE VENEER

BRICK VENEER

STUD WALL BELOW HEIGHT AND STUD SIZE AS NOTED

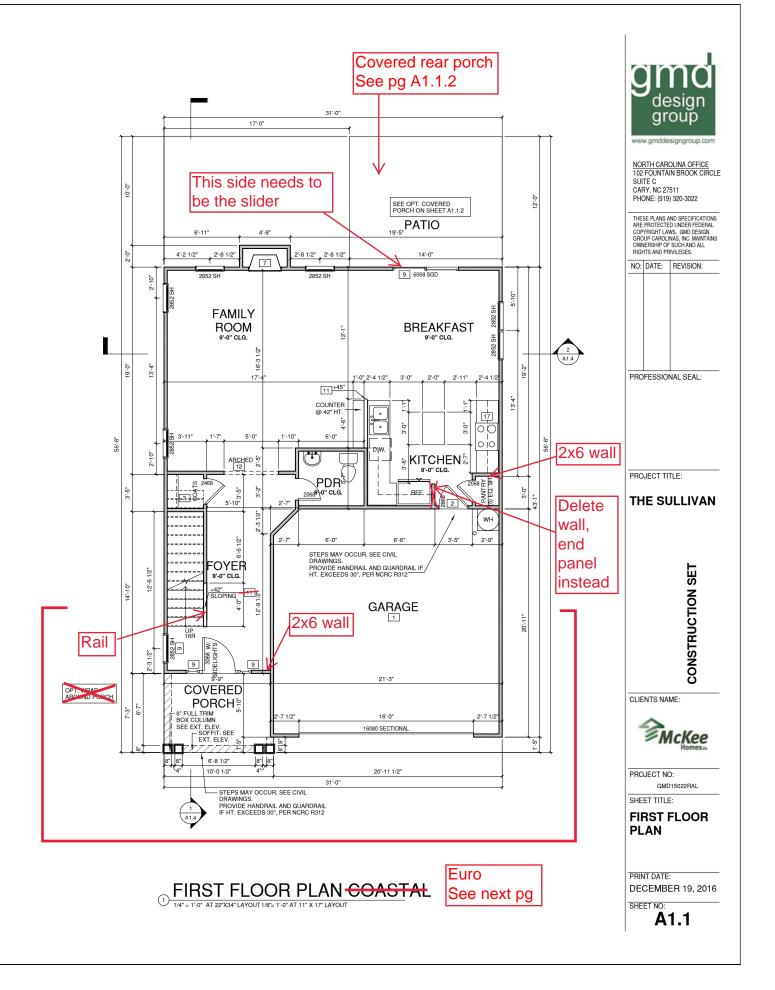

HOUSE TO GARAGE FIRE SEPARATION, GARAGE-HOUSE SEPARATION AT VERTICAL SURFACES SHALL BE PROTECTED WITH ONE (1) LAYER 1/2 GYPSUM BOARD, GARAGE-HOUSE SEPARATION AT HORIZONTAL SURFACES SHALL BE PROTECTED WITH ONE (1) LAYER 1/8" TYPE "X" GYPSUM BOARD HOUSE TO GARAGE DOOR SEPARATION, PROVIDE 1 3/8" SOLID CORE DOOR OR APPROVED 20 MINUTE RATED DOOR

RATED DOOR

BENEATH STAIRS AND LANDINGS. 1/2" GYPSUM BOARD ON WALLS AND CEILING OF ENCLOSED ACCESSIBLE AREAS

PRE-FABRICATED METAL FIREPLACE, INSTALL PER MANUFACTURER WRITTEN INSTRUCTIONS

ATTIC ACCESS LARGE ENOUGH TO REMOVE LARGEST PIECE OF EQUIPMENT BUT NOT LESS THAN 30'X22". FIRE RATED ACCESS AS NOTED. ATTIC ACCESS LADDER, VERIFY LOCATION AND SIZE WITH TRUSSES (25 1/2"X54" SIZE)

TEMPERED SAFETY GLASS

HALF WALL, HEIGHT AS NOTED

INTERIOR SOFFITS: FFL = 8-1" U.N.O. SFL = 7-6" U.N.O.

SHOWER TEMPERED GLASS ENCLOSURE

INTERIOR SUPPLIES, FFE 8-7 INNO. SEE 7-8 UND.

SHOWER, TEMPERED GLASS ENCLOSURE

TUB-SHOWER COMBO

ACRYLIC TUB W/ PLATFORM, SIZE AS NOTED

GAS COOKTOP AND HOOD, VENT PER MANUFACTURER'S WRITTEN INSTRUCTIONS

WALL LEGEND


FULL HEIGHT FULL HEIGHT 2X4 WOOD STUD PARTITION 2X6 WOOD STUD PARTITION

STONE VENEER

DRYWALL OPENING HEIGHT AS NOTED ON PLAN

BRICK VENEER

STUD WALL BELOW HEIGHT AND STUD SIZE AS NOTED

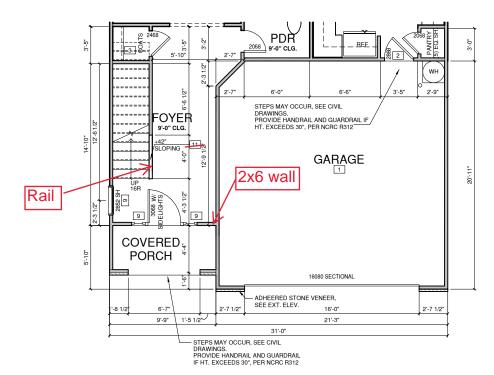

FIRST FLOOR PLAN EUROPEAN



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PROFESSIONAL SEAL:

PROJECT TITLE:

THE SULLIVAN

CONSTRUCTION SET

CLIENTS NAME:



PROJECT NO: GMD15022RAL

SHEET TITLE:

FIRST FLOOR **PLAN**

PRINT DATE: DECEMBER 19, 2016

SHEET NO:

A1.1.1

HOUSE TO GARAGE FIRE SEPARATION, GARAGE/HOUSE SEPARATION AT VERTICAL SURFACES SHAL BE PROTECTED WITH ONE (1) LAYER 1/2" GYPSUM BOARD. GARAGE/HOUSE SEPARATION AT HORIZONTAL SURFACES SHALL BE PROTECTED WITH ONE (1) LAYER 5/8" TYPE "X" GYPSUM BOARD
HOUSE TO GARAGE DOOR SEPARATION. PROVIDE 1 3/8" SOLID CORE DOOR OR APPROVED 20 MINUT RATED DOOR

PACTED DOOR

BENEATH STAIRS AND LANDINGS. 1/2" GYPSUM BOARD ON WALLS AND CEILING OF ENCLOSED ACCESSIBLE AREAS.

PRE-FABRICATED METAL FIREPLACE, INSTALL PER MANUFACTURER WRITTEN INSTRUCTIONS

ATITIC ACCESS LARGE ENOUGH TO REMOVE LARGEST PIECE OF EQUIPMENT BUT NOT LESS THAN 30"X22". FIRE RATED ACCESS AS NOTED. ATTIC ACCESS LADDER, VERIFY LOCATION AND SIZE WITH TRUSSES (25 12"X6" SIZE)

TEMPERED SAFETY GLASS

HALF WALL, HEIGHT AS NOTED

HALF WALL, HEIGHT AS NOTED

SHOWER, TEMPERED GLASS ENCLOSURE

TUSSHOWER, TEMPERED GLASS ENCLOSURE

ACRYLIC TUB W/ PLATFORM, SIZE AS NOTED

ACRYLIC TUB W/ PLATFORM, SIZE AS NOTED


WALL LEGEND

FULL HEIGHT FULL HEIGHT 2X4 WOOD STUD PARTITION 2X6 WOOD STUD PARTITION

DRYWALL OPENING HEIGHT AS NOTED ON PLAN STONE VENEER

BRICK VENEER


STUD WALL BELOW HEIGHT AND STUD SIZE AS NOTED

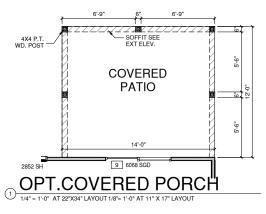



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PROJECT TITLE:

THE SULLIVAN

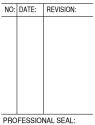CONSTRUCTION SET

CLIENTS NAME:



PROJECT NO: GMD15022RAL

SHEET TITLE:

FIRST FLOOR **OPTIONS**

PRINT DATE: DECEMBER 19, 2016

SHEET NO: A1.1.2

HOUSE TO GARAGE FIRE SEPARATION, GARAGE HOUSE SEPARATION AT VERTICAL SURFACES SHALBE PROTECTED WITH ONE (1) LAYER 1/2" GYPSUM BOARD, GARAGE/HOUSE SEPARATION AT HORIZONTAL SURFACES SHALBE PROTECTED WITH ONE (1) LAYER 5/2" GYPSUM BOARD HOUSE TO GARAGE DOOR OF SEPARATION, PROVIDE 1 3/8" SOLID CORE DOOR OR APPROVED 20 MINUTARTED DOOR

ACCESSIBLE AREAS

PRE-FABRICATED METAL FIREPLACE, INSTALL PER MANUFACTURER WRITTEN INSTRUCTIONS

ATTIC ACCESS LARGE ENOUGH TO REMOVE LARGEST PIECE OF EQUIPMENT BUT NOT LESS THAN
30°X2?*, FIRE RATED ACCESS AS NOTED. ATTIC ACCESS LADDER, VERIFY LOCATION AND SIZE WITH
TRUSSES (25 1/2°X54° SIZE)

TEMPERED SAFETY GLASS

HALF WALL, HEIGHT AS NOTED

INTERIOR SOFFITS: FFL = 8°-1" U.N.O. SFL = 7°-6" U.N.O.
SHOWER, TEMPERED GLASS ENCLOSURE

TIR. SHOWER COMEO

TUB-SHOWER COMBO

ACRYLIC TUB W/ PLATFORM, SIZE AS NOTED

GAS COOKTOP AND HOOD, VENT PER MANUFACTURER'S WRITTEN INSTRUCTIONS


WALL LEGEND

FULL HEIGHT 2X4 WOOD STUD PARTITION FULL HEIGHT 2X6 WOOD STUD PARTITION


DRYWALL OPENING HEIGHT AS NOTED ON PLAN STONE VENEER

BRICK VENEER

STUD WALL BELOW HEIGHT AND STUD SIZE AS NOTED

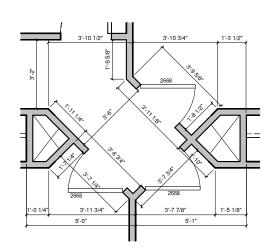

SECOND FLOOR PLAN DETAIL

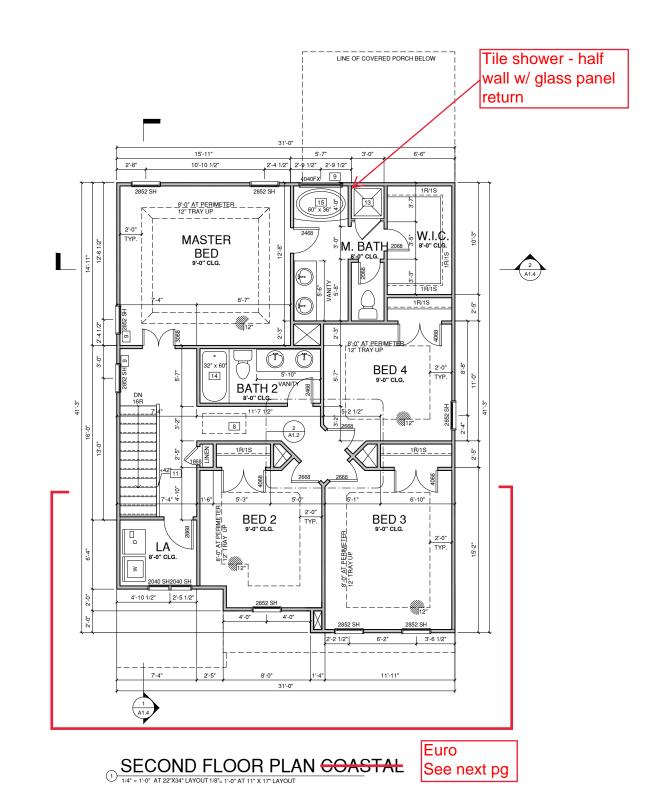



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PROFESSIONAL SEAL:

PROJECT TITLE:

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CLIENTS NAME:



PROJECT NO:

GMD15022RAL SHEET TITLE:

SECOND **FLOOR PLAN**

PRINT DATE: DECEMBER 19, 2016

SHEET NO: A1.2

1	HOUSE TO GARAGE FIRE SEPARATION, GARAGE/HOUSE SEPARATION AT VERTICAL SURFACES SHAL
	BE PROTECTED WITH ONE (1) LAYER 1/2" GYPSUM BOARD, GARAGE/HOUSE SEPARATION AT
	HORIZONTAL SURFACES SHALL BE PROTECTED WITH ONE (1) LAYER 5/8" TYPE "X" GYPSUM BOARD
2	HOUSE TO GARAGE DOOR SEPARATION. PROVIDE 1 3/8" SOLID CORE DOOR OR APPROVED 20 MINUT

POUSE TO GARAGE DOOR SEPARATION, PROVIDE 1 3/8" SOLID CORE DOOR OR APPROVED 20 MINUTE RATED DOOR

3 BENEATH STAIRS AND LANDINGS, 1/2" GYPSUM BOARD ON WALLS AND CEILING OF ENCLOSED ACCESSIBLE AREAS

4 PRE-PABRICATED METAL FIREPLACE, INSTALL PER MANUFACTURER WRITTEN INSTRUCTIONS

5 ATTIC ACCESS LARGE ENOUGH TO REMOVE LARGEST PIECE OF EQUIPMENT BUT NOT LESS THAN 30" X2". FIRER RATED ACCESS AS NOTED. ATTIC ACCESS LADDER, VERIFY LOCATION AND SIZE WITH TRUSSES (25 1/2"X54" SIZE)

17 EMPERED SAFETY GLASS

11 HALF WALL, HEIGHT AS NOTED

12 INTERIOR SOFFITS: FFL = 8"-1" U.N.O. SFL = 7"-6" U.N.O.

13 SHOWER, TEMPERED GLASS ENCLOSURE

14 TUB-SHOWER COMBO

15 ACRYLIC TUB W! PLATFORM. SIZE AS NOTED

17 CAS COOKTOP AND HOOD, VENT PER MANUFACTURERS WRITTEN INSTRUCTIONS


WALL LEGEND

FULL HEIGHT 2X4 WOOD STUD PARTITION 2X6 WOOD STUD PARTITION

DRYWALL OPENING HEIGHT AS NOTED ON PLAN STONE VENEER

BRICK VENEER

STUD WALL BELOW HEIGHT AND STUD SIZE AS NOTED

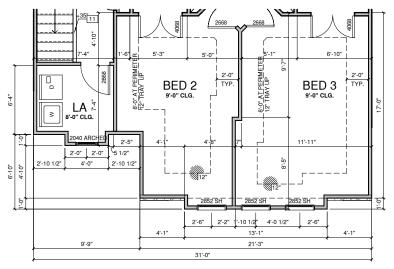

SECOND FLOOR PLAN ① EUROPEAN 1/4" = 1'-0" AT 22"X34" LAYOUT 1/8"= 1'-0" AT 11" X 17" LAYOUT



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PROFESSIONAL SEAL:

PROJECT TITLE:

THE SULLIVAN

CONSTRUCTION SET

CLIENTS NAME:




PROJECT NO: GMD15022RAL

SHEET TITLE:


SECOND **FLOOR PLAN**

PRINT DATE: DECEMBER 19, 2016

SHEET NO: A1.2.1

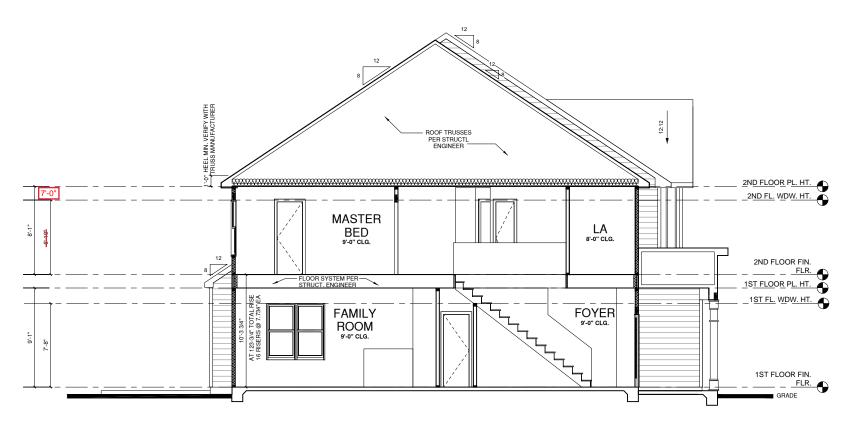

$) \frac{\text{BUILDING SECTION 1}}{^{1/4^*=1^{\circ}0^*\text{ AT 22"X34" LAYOUT }1/8^*=1^{\circ}0^*\text{ AT 11" X 17" LAYOUT}}$

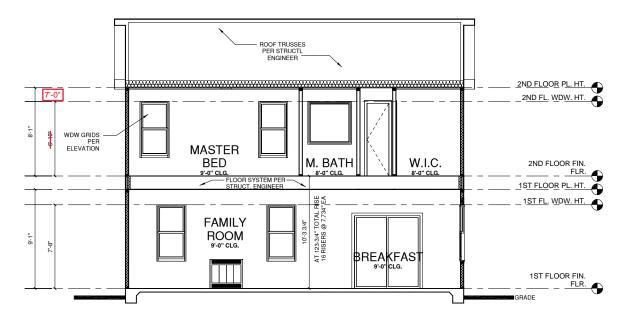

② BUILDING SECTION 2


1/4" = 1'-0" AT 22"X34" LAYOUT 1/8"= 1'-0" AT 11" X 17" LAYOUT



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PROJECT TITLE:

THE SULLIVAN

CONSTRUCTION SET

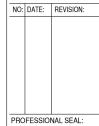CLIENTS NAME:



PROJECT NO: GMD15022RAL

SHEET TITLE:

BUILDING SECTIONS

PRINT DATE: DECEMBER 19, 2016

SHEET NO:

A1.4

- HOUSE TO GARAGE FIRE SEPARATION, GARAGE/HOUSE SEPARATION AT VERTICAL SURFACES SHALL BE PROTECTED WITH ONE (1) LAYER 1/2" GYPSUM BOARD, GARAGE/HOUSE SEPARATION AT HORIZONTAL SURFACES SHALL BE PROTECTED WITH ONE (1) LAYER 5/8" TYPE "X" GYPSUM BOARD HOUSE TO GARAGE DOOR SEPARATION. PROVIDE 1 3/8" SOLID CORE DOOR OR APPROVED 20 MINUT
- HOUSE TO GARMAGE DOOR SEPARATION. FROM THE 13th SOCIED SOFTE SOFT THE THE RATED DOOR

 BENEATH STAIRS AND LANDINGS, 1/2" GYPSUM BOARD ON WALLS AND CEILING OF ENCLOSED ACCESSIBLE AREAS

 PRE-FABRICATED METAL FIREPLACE, INSTALL PER MANUFACTURER WRITTEN INSTRUCTIONS
- ATTIC ACCESS LARGE ENOUGH TO REMOVE LARGEST PIECE OF EQUIPMENT BUT NOT LESS THAN 30°X22°. FIRE RATED ACCESS AS NOTED, ATTIC ACCESS LADDER, VERIFY LOCATION AND SIZE WITH TRUSSES (26 12°X254° SIZE).
- TRUSSES (25 1/27/54" SIZE)
 9 TEMPERED SAFETY GLASS
 11 HALF WALL, HEIGHT AS NOTED
 12 INTERIOR SOFFITS: FFL = 8".1" U.N.O. SFL = 7"6" U.N.O.
 13 SHOWER, TEMPERED GLASS ENCLOSURE
 14 TUB-SHOWER COMBO

- TUB-SHOWER COMBO
 ACRYLIC TUB W/ PLATFORM, SIZE AS NOTED
 GAS COOKTOP AND HOOD, VENT PER MANUFACTURER'S WRITTEN INSTRUCTIONS

ALL WINDOWS WHOSE OPENING IS LESS THAN 24" ABOVE THE FINISH FLOOR AND WHOSE OPENING IS GREATER THAN 72" ABOVE THE OUTSIDE WALKIMS SURFACE MUST HAVE WINDOW OPENING LIMITING DEVICES COMPLYING WITH THE 2012 IRG SECTION R312.2.

NOTES:

-GRADE CONDITIONS MAY VARY FOR INDIVIDUAL SITE FROM THAT SHOWN. BUILDER SHALL VERIFY AND COORDINATE PER ACTUAL SITE CONDITIONS.


-WINDOW HEAD HEIGHTS: 1ST FLOOR = 8'-0" U.N.O. ON ELEVATIONS 2ND FLOOR = 7'-0" U.N.O. ON ELEVATIONS 3RD FLOOR = 7'-0" U.N.O. ON ELEVATIONS.

ROOFING: PITCHED SHINGLES PER BUILDER. -WINDOWS: MANUFACTURER PER BUILDER. DIVIDED LITES AS SHOWN ON THE EXTERIOR ELEVATIONS

-ENTRY DOOR: AS SELECTED BY BUILDER

-CHIMNEY AS OCCURS: TOP OF CHIMNEYS TO BE A MINIMUM OF 24" ABOVE ANY ROOF WITHIN 10'-0" OF CHIMNEY.


-ALL EXTERIOR MATERIALS TO BE INSTALLED PER MANUFACTURER'S WRITTEN INSTRUCTIONS.

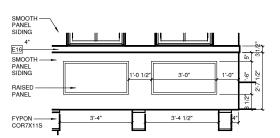





EUROPEAN FRONT ELEVATION

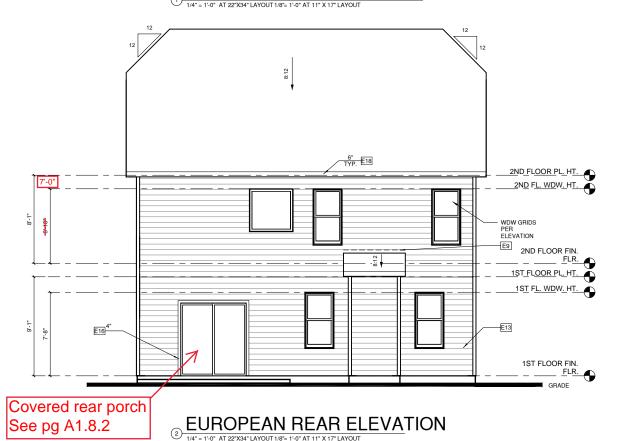



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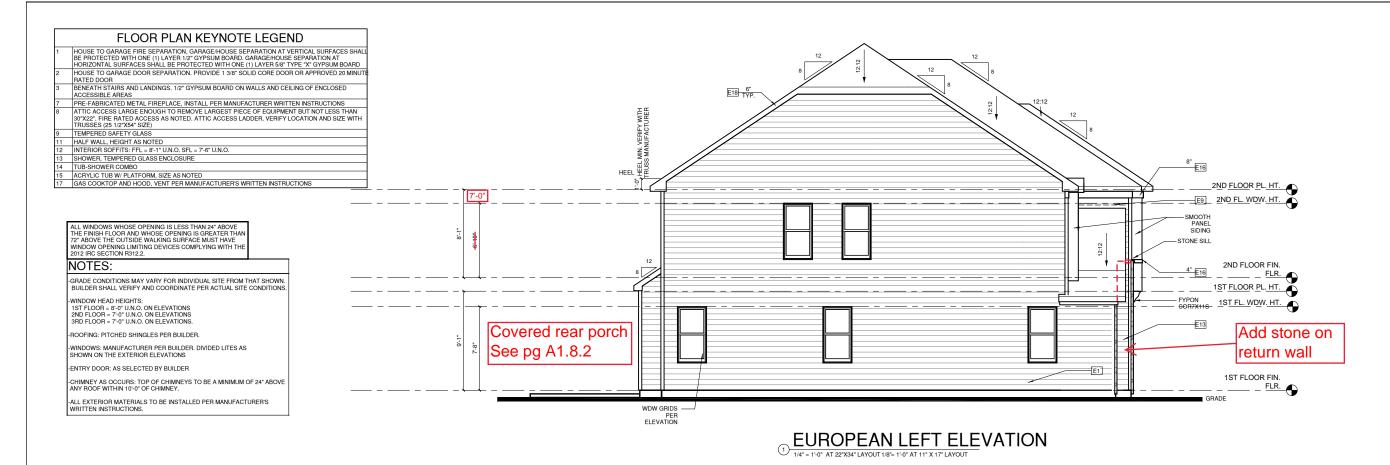
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EUROPEAN **ELEVATIONS**

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EUROPEAN
ELEVATIONS

PRINT DATE:
DECEMBER 19, 2016

SHEET NO: **A1.8.1**

(2) EUROPEAN RIGHT ELEVATION

- HOUSE TO GARAGE FIRE SEPARATION, GARAGE-HOUSE SEPARATION AT VERTICAL SURFACES SHALL BE PROTECTED WITH ONE (1) LAYER 172 GYPSUM BOARD, GARAGE-HOUSE SEPARATION AT HORIZONTAL SURFACES SHALL BE PROTECTED WITH ONE (1) LAYER 5/8" TYPE "X" GYPSUM BOARD HOUSE TO GARAGE DOOR SEPARATION. PROVIDE 1 3/8" SOLID CORE DOOR OR APPROVED 20 MINUT RATED DOOR
- PRI-ED DOON
 BENEATH STAIRS AND LANDINGS. 1/2" GYPSUM BOARD ON WALLS AND CEILING OF ENCLOSED ACCESSIBLE AREAS
 PRE-FABRICATED METAL FIREPLACE, INSTALL PER MANUFACTURER WRITTEN INSTRUCTIONS
- ATTIC ACCESS LARGE ENOUGH TO REMOVE LARGEST PIECE OF EQUIPMENT BUT NOT LESS THAN 30"X22". FIRE RATED ACCESS AS NOTED. ATTIC ACCESS LADDER, VERIFY LOCATION AND SIZE WITH
- TRUSSES (25 1/2"X54" SIZE)
 TEMPERED SAFETY GLASS
- TEMPERED SAPE IT GLASS
 HALF WALL, HEIGHT AS NOTED
 INTERIOR SOFFITS: FFL = 8-1" U.N.O. SFL = 7-6" U.N.O.
 SHOWER, TEMPERED GLASS ENCLOSURE
 TUB-SHOWER COMBO

- TIUB-SHOWER COMBO AGRYLIC TUB W PLATFORM, SIZE AS NOTED GAS COOKTOP AND HOOD, VENT PER MANUFACTURER'S WRITTEN INSTRUCTIONS

ALL WINDOWS WHOSE OPENING IS LESS THAN 24" ABOVE THE FINISH FLOOR AND WHOSE OPENING IS GREATER THAN THE FINISH FLOOR AND WHOSE OPENING IS GREATER THAY. 72° ABOVE THE OUTSIDE WALKING SURFACE MUST HAVE WINDOW OPENING LIMITING DEVICES COMPLYING WITH THE 2012 IRC SECTION R312.2.

NOTES:

-GRADE CONDITIONS MAY VARY FOR INDIVIDUAL SITE FROM THAT SHOWN BUILDER SHALL VERIFY AND COORDINATE PER ACTUAL SITE CONDITIONS

-WINDOW HEAD HEIGHTS: 1ST FLOOR = 8'-0' U.N.O. ON ELEVATIONS 2ND FLOOR = 7'-0" U.N.O. ON ELEVATIONS 3RD FLOOR = 7'-0" U.N.O. ON ELEVATIONS.


ROOFING: PITCHED SHINGLES PER BUILDER.

-WINDOWS: MANUFACTURER PER BUILDER. DIVIDED LITES AS SHOWN ON THE EXTERIOR ELEVATIONS

ENTRY DOOR: AS SELECTED BY BUILDER


-CHIMNEY AS OCCURS: TOP OF CHIMNEYS TO BE A MINIMUM OF 24" ABOVE ANY ROOF WITHIN 10'-0" OF CHIMNEY.

-ALL EXTERIOR MATERIALS TO BE INSTALLED PER MANUFACTURER'S WRITTEN INSTRUCTIONS.

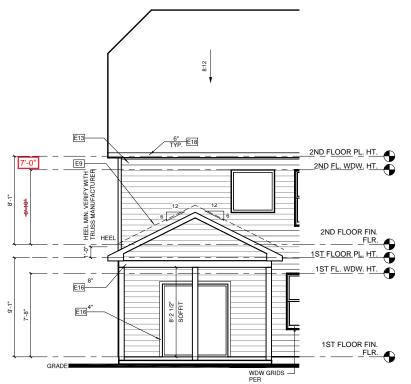


EUROPEAN REAR ELEVATION W/ ① OPT. COVERED PORCH

1/4" = 1'-0" AT 22"X34" LAYOUT 1/8"= 1'-0" AT 11" X 17" LAYOUT

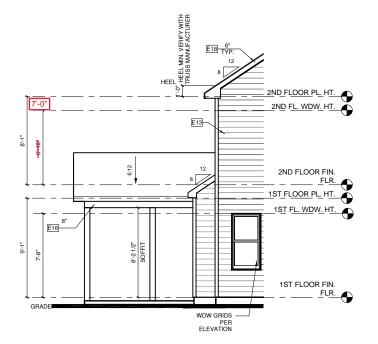

EUROPEAN LEFT ELEVATION W/ ② OPT. COVERED PORCH 1/4" = 1'-0" AT 22"X34" LAYOUT 1/8" = 1'-0" AT 11" X 17" LAYOUT

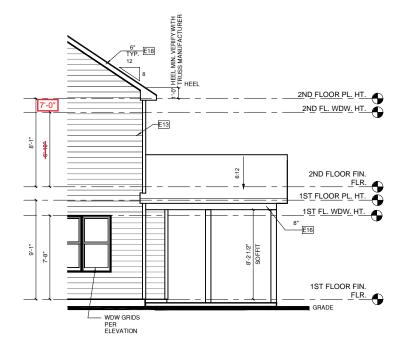

EUROPEAN RIGHT ELEVATION (3) W/ OPT. COVERED PORCH



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PROJECT NO:

GMD15022RAL SHEET TITLE:

EUROPEAN ELEVATION OPTIONS

PRINT DATE: DECEMBER 19, 2016

SHEET NO: A1.8.2

1/150 RATIO:

GENERAL CONTRACTOR SHALL VERIFY THE NET FREE VENTILATION OF THE VENT PRODUCT SELECTED BY OWNER, VERIFY WITH MANUFACTURER OF HIGH AND LOW VENTS TO BE USED FOR MINIMUM CAL CULLATED VENTS REQUIRED. THE REQUIRED VENTILATION SHALL BE MAINTAINED, PROVIDE INSULATION STOP SUCH THAT INSULATION DOES NOT OBSTRUCT FREE AIR MOVEMENT AS REQUIRED BY THE BUILDING OFFICIAL.

ALL OVERLAP FRAMED ROOF AREAS SHALL HAVE OPENINGS BETWEEN THE ADJACENT ATTICS IN THE ROOF SHEATHING AS ALLOWED BY THE STRUCTURAL ENGINEER TO ALLOW PASSAGE AND ATTIC VENTULATION BETWEEN THE TWO OR ISOLATED ATTIC SPACES SHALL BE VENTED INDEPENDENTLY TO GBC REQUIREMENTS.

PER DEVELOPER, AT ALL CANTILEVERED FLOORS, CANTILEVERED ARCHITECTURAL POP-OUTS, AND ANY DOUBLE FRAMING PROJECTIONS THAT ARE SEPARATED FROM THE VENTING CALCULATIONS SHOWN ABOVE, PROVIDE A CONTINUOUS 2" CORROSION RESISTANT SOFFIT VENT AT UNDERSIDE OF FRAMED ELEMENT.

1/300 RATIO:

AS AN ALTERNATE TO THE 1/150 RATIO LISTED, THE NET FREE CROSS-VENTILATION AREA MAY BE REDUCED TO 1/300 WHEN A VAPOR BARRIER IS HAVING A TRANSMISSION RATE NOT EXCEEDING I-PERM INSTALLED ON THE WARM-IN-WINTER SIDE OF THE CEILING.

GENERAL CONTRACTOR SHALL VERIFY THE NET FREE VENTILATION OF THE VENT PRODUCT SELECTED BY OWNER. VERIFY WITH MANUFACTURER OF HIGH AND LOW VENTS TO BE USED FOR MINIMUM CALCULATED VENTS REQUIRED. THE REQUIRED VENTILATION SHALL BE MAINTAINED. PROVIDE INSULATION STOP SUCH THAT INSULATION DOES NOT DESTRUCT FREE AIR MOVEMENT AS REQUIRED BY THE BUILDING OFFICIAL.

ALL OVERLAP FRAMED ROOF AREAS SHALL HAVE OPENINGS BETWEEN THE ADJACENT ATTICS IN THE ROOF SHEATHING (AS ALLOWED BY THE STRUCTURAL ENGINEER) TO ALLOW PASSAGE AND ATTIC VENTILATION BETWEEN THE TWO OR ISOLATED ATTIC SPACES SHALL BE VENTED INDEPENDENTLY TO CBC REQUIREMENTS.

PER DEVELOPER, AT ALL CANTILEVERED FLOORS, CANTILEVERED RACHITECTURAL POP-OUTS, AND ANY DOUBLE FRAMING PROJECTIONS THAT ARE SEPARATED FROM THE VENTING CALCULATIONS SHOWN ABOVE, PROVIDE A CONTINUOUS 2° CORROSION RESISTANT SOFFIT VENT AT UNDERSIDE OF FRAMED ELEMENT.

NOTES:

- ALL ROOF DRAINAGE SHALL BE PIPED TO STREET OR APPROVED DRAINAGE FACILITY.
 DASHED LINES INDICATE WALL BELOW.
 LOCATE GUTTER AND DOWNSPOUTS PER BUILDER.
 PITCHED ROOFS AS NOTED.

- TRUSS MANUFACTURER SHALL SUBMIT STRUCTURAL CALCS AND SHOP DRAWING TO THE BUILDER'S GENERAL CONTRACTOR AND BUILDING DEPARTMENT FOR REVIEW PRIOR TO FABRICATIONS.
 ALL PLUMBING YENTS SHALL BE COMBINED INTO A MINIMUM AMOUNT OF ROOF PENETRATIONS. ALL ROOF PENETRATIONS SHALL OCCUR TO THE REAR OF THE MAIN

EUROPEAN ROOF VENT CALC.					
Name	Area	1/300 RATIO AT HIGH & LOW	1/150 RATIO AT HIGH & LOW		
AREA 1	1277 SF	306.57 in ²	613.14 in ²		
AREA 2	42 SF	10.14 in ²	20.28 in ²		
OPT. AREA 3	168 SF	40.32 in ²	80.64 in ²		

Add covered rear porch AREA 3 AREA 1 12:12 12:12 EAVE THITCH CHANGE



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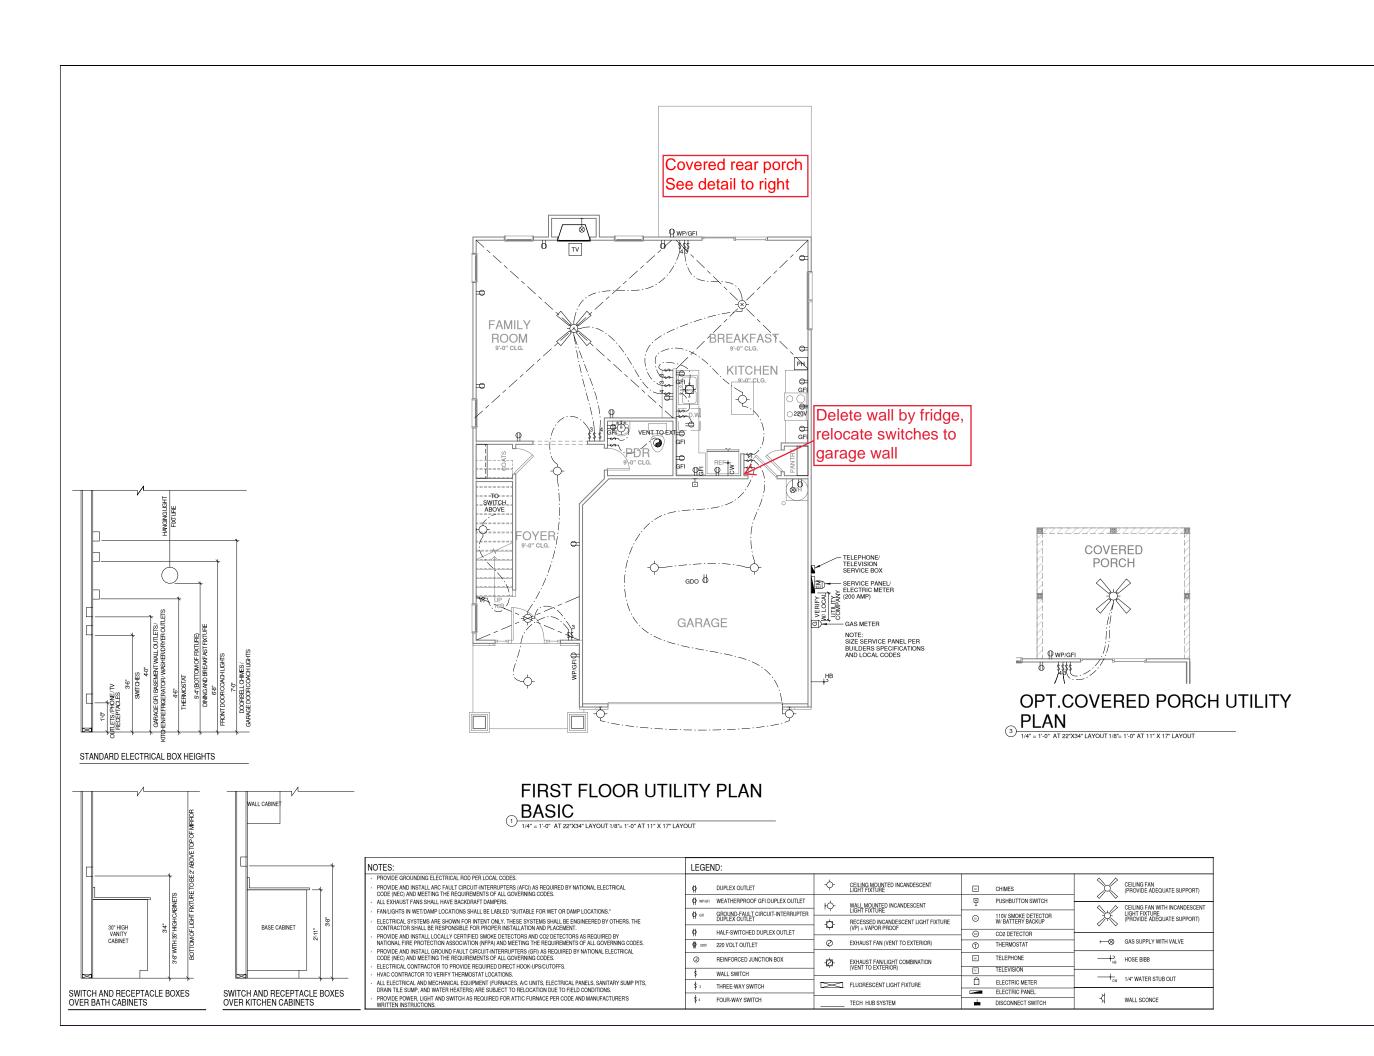
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EUROPEAN ROOF PLAN

PRINT DATE: DECEMBER 19, 2016

SHEET NO: A1.8.3

1) ROOF PLAN EUROPEAN





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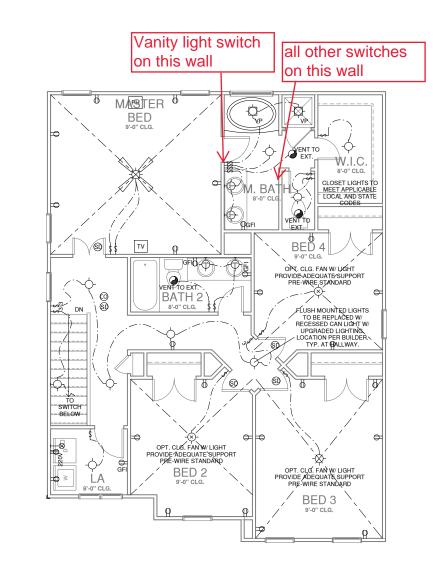
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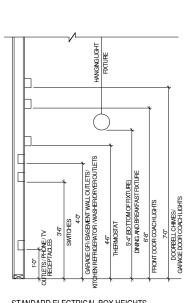
FIRST FLOOR UTILITY PLAN

PRINT DATE:
DECEMBER 19, 2016


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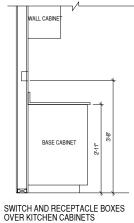


SECOND FLOOR UTILITY PLAN ① BASIC 11-14" = 1"-0" AT 22"X34" LAYOUT 1/8"= 1"-0" AT 11" X 17" LAYOUT



STANDARD ELECTRICAL BOX HEIGHTS



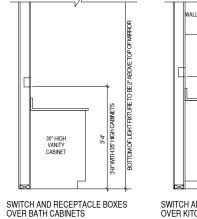


	_			
NOTES:	LEGEND:			
PROVIDE GROUNDING ELECTRICAL ROD PER LOCAL CODES: PROVIDE AND INSTALL ARC FAULT CIRCUIT-INTERRUPTERS (AFCI) AS REQUIRED BY NATIONAL ELECTRICAL COOE INEC), AND MEETING THE REQUIREMENTS OF ALL GOVERNING CODES.		- CEILING MOUNTED INCANDESCENT LIGHT FIXTURE	☐ CHIMES	CEILING FAN (PROVIDE ADEQUATE SUPPORT)
ALL EXHAUST FANS SHALL HAVE BACKDRAFT DAMPERS.		- WALL MOUNTED INCANDESCENT	PUSHBUTTON SWITCH	CEILING FAN WITH INCANDESCENT
FANILIGHTS IN WET/DAMP LOCATIONS SHALL BE LABLED "SUITABLE FOR WET OR DAMP LOCATIONS." ELECTRICAL SYSTEMS ARE SHOWN FOR INTENT ONLY, THESE SYSTEMS SHALL BE ENGINEERED BY OTHERS. THE	GROUND-FAULT CIRCUIT-INTERRUPTER DUPLEX OUTLET	LIGHT FIXTURE RECESSED INCANDESCENT LIGHT FIXTURE	110V SMOKE DETECTOR W/BATTERY BACKUP	LIGHT FIXTURE (PROVIDE ADEQUATE SUPPORT)
CONTRACTOR SHALL BE RESPONSIBLE FOR PROPER INSTALLATION AND PLACEMENT PROVIDE AND INSTALL LOCALLY CERTIFIED SMOKE DETECTORS AND CO2 DETECTORS AS REQUIRED BY		(VP) = VAPOR PROOF	© CO2 DETECTOR	·
NATIONAL FIRE PROTECTION ASSOCIATION (NFPA) AND MEETING THE REQUIREMENTS OF ALL GOVERNING CODES. - PROVIDE AND INSTALL GROUND FAULT CIRCUIT-INTERRUPTERS (GFI) AS REQUIRED BY NATIONAL ELECTRICAL	220V 220 VOLT OUTLET	EXHAUST FAN (VENT TO EXTERIOR)	① THERMOSTAT	⊗ GAS SUPPLY WITH VALVE
CODE (NEC) AND MEETING THE REQUIREMENTS OF ALL GOVERNING CODES. - ELECTRICAL CONTRACTOR TO PROVIDE REQUIRED DIRECT HOOK-UPSIGUTOFFS.	REINFORCED JUNCTION BOX	-ZI- EXHAUST FAN/LIGHT COMBINATION (VENT TO EXTERIOR)	™ TELEPHONE	HOSE BIBB
HVAC CONTRACTOR TO VERIFY THERMOSTAT LOCATIONS.	\$ WALL SWITCH	(VENT TO EXTERIOR)	TELEVISION	T _{CW} 1/4" WATER STUB OUT
ALL ELECTRICAL AND MECHANICAL EQUIPMENT (FURNACES, A/C UNITS, ELECTRICAL PANELS, SANITARY SUMP PITS, DRAIN TILE SUMP, AND WATER HEATERS) ARE SUBJECT TO RELOCATION DUE TO FIELD CONDITIONS.	\$ 3 THREE-WAY SWITCH	FLUORESCENT LIGHT FIXTURE	ELECTRIC METER ELECTRIC PANEL	- CW 1/4 WATER STOR OUT
PROVIDE POWER, LIGHT AND SWITCH AS REQUIRED FOR ATTIC FURNACE PER CODE AND MANUFACTURER'S WRITTEN INSTRUCTIONS.	\$ 4 FOUR-WAY SWITCH	TECH HUB SYSTEM	■ DISCONNECT SWITCH	→ WALL SCONCE



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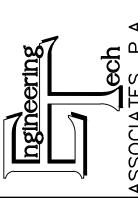
SHEET TITLE:

SECOND FLOOR UTILITY PLAN

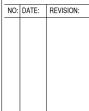PRINT DATE: DECEMBER 19, 2016

E2.0

1/4" = 1'-0"






		ENG: KWT/DTN		DATE 4-27-2018
	WNG	ENG	REV:	DATE
MCKEE HOMES	STRUCTURAL ADDENDUM			
CLIENT:	SCOPE	:# IOI		


PLAN NO. SULLIVAN RH

PROJECT NO. 18-29-016R

SHEET NO.

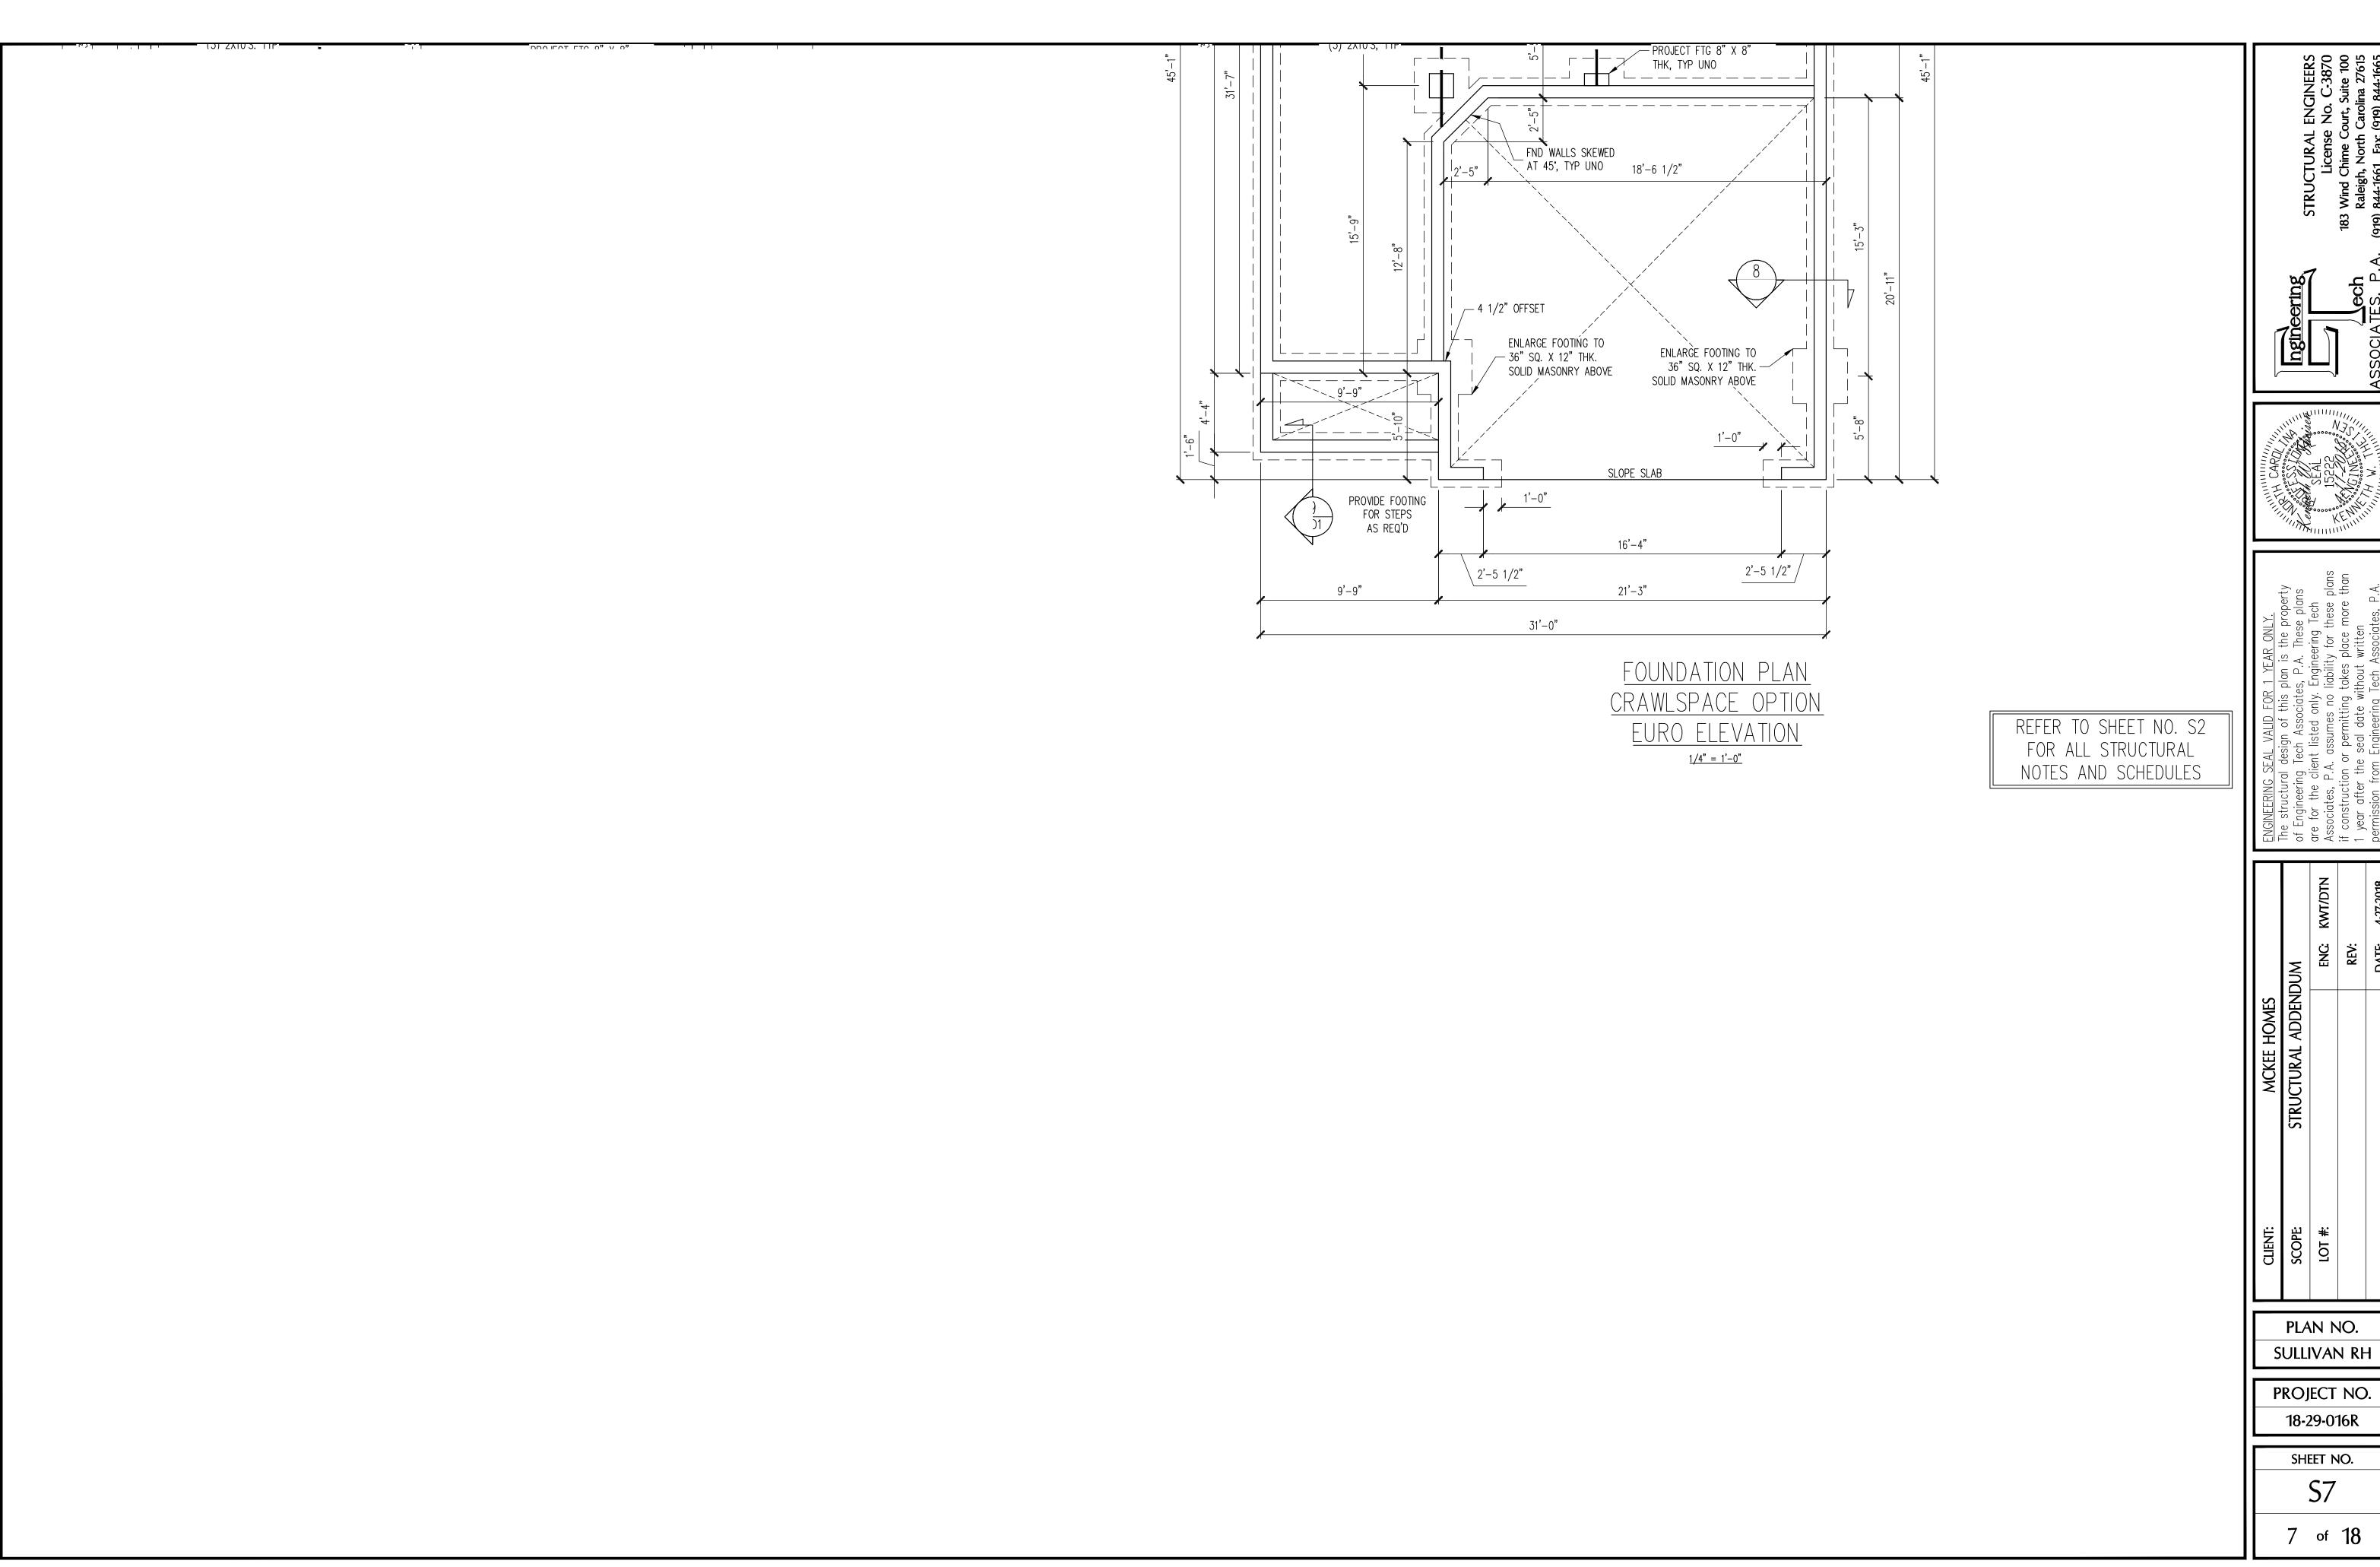




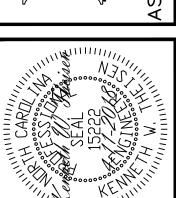

PLAN NO.

18-29-016R

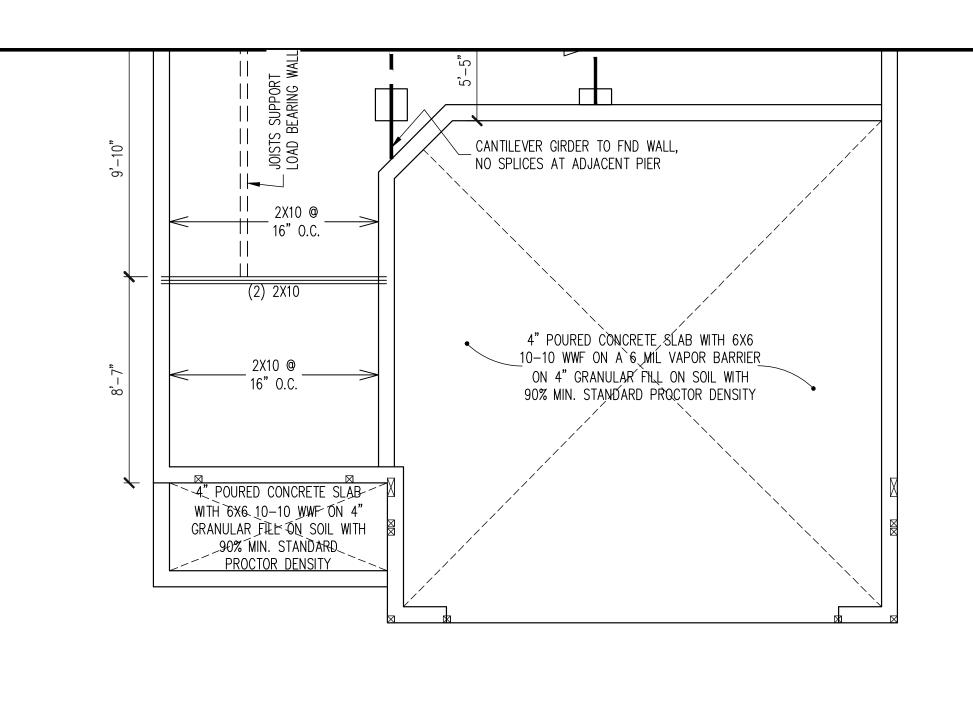


CRAWL SPACE FRAMING PLAN

EURO ELEVATION

1/4" = 1'-0"

REFER TO SHEET NO. S2 FOR ALL STRUCTURAL NOTES AND SCHEDULES Ingineering STRU
STRU

ASSOCIATES, P.A. (919) 844-1

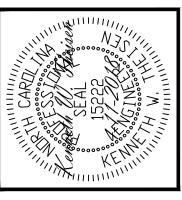

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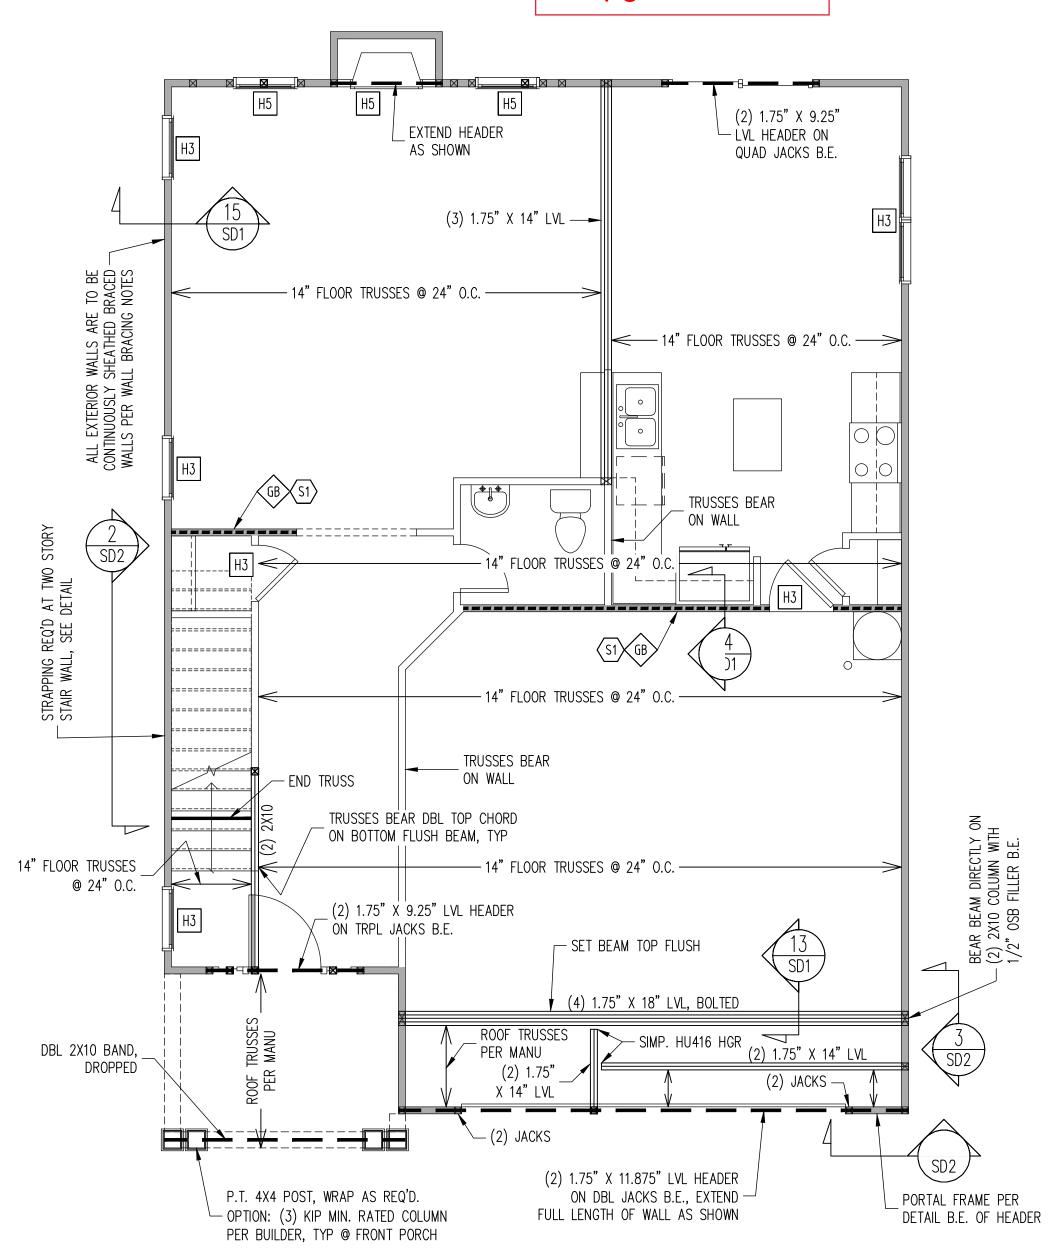
		ENG: KWT/DTN		DATE 4-27-2018
	MNC	ENG	REV:	DATE
MCKEE HOMES STRUCTURAL ADDENDUM				
CLIENT:	SCOPE	FOT #:		

PLAN NO. SULLIVAN RH

PROJECT NO. 18-29-016R

S8 8 of 18

Covered rear porch See pg S13



Euro See pg S9 1ST FLOOR FRAMING PLAN

COASTAL ELEVATION WALLS AND CEILING

1/4" = 1'-0"

WALL BRACING 1ST FLOOR ONLY

ALL EXTERIOR STUD WALLS ARE TO BE CONTINUOUSLY SHEATHED WITH 7/16 APA RATED OSB NAILED TO STUDS WITH 8d NAILS @ 6" O.C. AT PANEL EDGES, 12" O.C. IN PANEL FIELD. BLOCKING AT HORIZONTAL JOINTS IN BRACED WALL LINES ONLY REQUIRED AT SHADED WALLS, UNO

______ SHADED WALLS:

GB - INTERIOR BRACED WALL WITH GYPSUM BOARD. 1/2" GB BOTH SIDES OF WALL ATTACHED TO PANEL EDGES, INCLUDING TOP AND BOTTOM PLATES, AT 7" O.C.

BUILDER PERMITTED TO SUBSTITUTE INTERIOR OSB SHEATHING WITH THERMO-PLY BLUE PROTECTIVE SHEATHING. REFERENCE TECHNICAL EVALUATION REPORT COL#P-1038 PROVIDED BY DRJ ENGINEERING, LLC AND SEALED BY RYAN DEXTER, P.E.

PROVIDED CONTINUOUS SHEATHING = 152' MIN. -WALL BRACING IS BY ENGINEERED DESIGN AND NOT PRESCRIPTIVE PER SECTION 602.10 OF THE 2012 NCRC. CONTINUOUS SHEATHING HAS BEEN PROVIDED, ALONG WITH ALTERNATIVE METHODS TO INSURE THE MINIMUM INTENT OF SECTION 602.10 OF THE 2012 NCRC HAS BEEN MET AND EXCEEDED.

> FRAMING SCHEDULE 1ST FLOOR ONLY

TRUSS OR 2X6 BLOCKING REQUIRED ABOVE ALL BRACED WALLS. NAIL SUBFLOOR ABOVE WALL TO TRUSS / BLOCKING WITH 8d NAILS @ 6" O.C.. TOE NAIL TRUSS / BLOCKING ABOVE WALL TO TOP PLATE WITH 16d TOE NAILS @ 6" O.C. ATTACH SOLE PLATE OF BRACED WALL TO FOUNDATION BELOW PER TYPICAL BRACED WALL DETAILS

REQUIRED STUDS FOR BEAM SUPPORT

REFER TO SECTIONS 5.02 - 5.06 OF THE CONSTRUCTION SPECIFICATIONS FOR REQUIRED NUMBER OF STUDS FOR BEAM SUPPORT, TYP UNO.

HEADER SCHEDULE

H1 SINGLE 2X4 TURNED FLAT (A)

H2 (2) 2X4'S ON SINGLE JACKS (B)

H3 (2) 2X10'S ON SINGLE JACKS (C)

H4 (2) 1.75" X 9.25" LVL'S ON DBL JACKS

H5 (2) 2X10'S ON DBL JACKS

(A) TYPICAL FOR INTERIOR NON LOAD BEARING WALLS ONLY, ROUGH OPENING 38" MAX.


(B) TYPICAL FOR INTERIOR NON LOAD BEARING WALLS ONLY, ROUGH OPNG 38" TO 74" MAX.


(C) TYPICAL FOR ALL CONDITIONS NOT LISTED

IN (A) OR (B) UNO.

-HEADERS IN NON LOAD BEARING INTERIOR WALLS ARE NOT LABELED.

*REQUIRED NUMBER OF KING STUDS FOR EXTERIOR HEADERS DETERMINED BY NCRBC TABLE 602.3(5) UNLESS NOTED OTHERWISE ON PLAN.

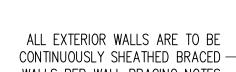

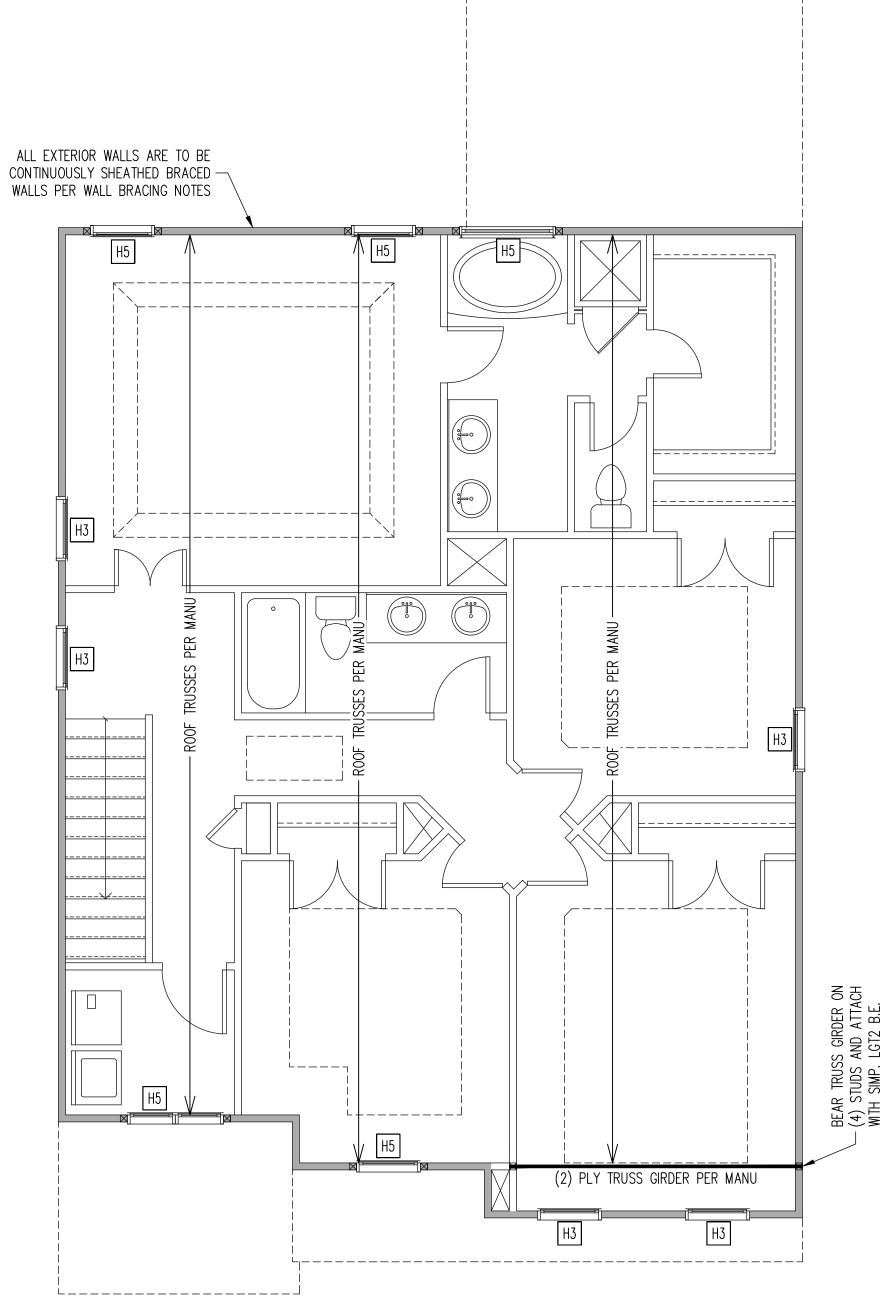

Euro |See pg S10 2ND FLOOR FRAMING PLAN COASTAL ELEVATION

WALLS AND CEILING 1/4" = 1'-0"

WALL BRACING 2ND FLOOR ONLY

ALL EXTERIOR STUD WALLS ARE TO BE CONTINUOUSLY SHEATHED WITH 7/16 APA RATED OSB NAILED TO STUDS WITH 8d NAILS @ 6" O.C. AT PANEL EDGES, 12" O.C. IN PANEL FIELD.

TRUSS OR 2X6 BLOCKING REQUIRED ABOVE AND BELOW ALL BRACED WALLS. NAIL SHEATHING ABOVE WALL TO BLOCKING WITH 8d NAILS @ 6" O.C.. TOE NAIL TRUSS / BLOCKING ABOVE WALL TO TOP PLATE WITH 8d TOE NAILS @ 6" O.C. NAIL SOLE PLATE OF BRACED WALL TO TRUSS / BLOCKING BELOW WALL WITH (3) 16d NAILS @ 16" O.C. BLOCKING AT HORIZONTAL JOINTS IN BRACED WALL LINES ONLY REQUIRED AT SHADED WALLS, UNO

SHADED WALLS:

-<u>PROVIDED CONTINUOUS SHEATHING = 144' MIN.</u> -WALL BRACING IS BY ENGINEERED DESIGN AND NOT PRESCRIPTIVE PER SECTION 602.10 OF THE 2012 NCRC. CONTINUOUS SHEATHING HAS BEEN PROVIDED, ALONG WITH ALTERNATIVE METHODS TO INSURE THE MINIMUM INTENT OF SECTION 602.10 OF THE 2012 NCRC HAS BEEN MET AND EXCEEDED.

REQUIRED STUDS FOR BEAM SUPPORT


REFER TO SECTIONS 5.02 - 5.06 OF THE CONSTRUCTION SPECIFICATIONS FOR REQUIRED NUMBER OF STUDS FOR BEAM SUPPORT, TYP UNO.


HEADER SCHEDULE

- H1 SINGLE 2X4 TURNED FLAT (A)
- H2 (2) 2X4'S ON SINGLE JACKS (B)
- H3 (2) 2X10'S ON SINGLE JACKS (C) H4 (2) 1.75" X 9.25" LVL'S ON DBL JACKS
- H5 (2) 2X10'S ON DBL JACKS
- (A) TYPICAL FOR INTERIOR NON LOAD BEARING WALLS ONLY, ROUGH OPENING 38" MAX.
- (B) TYPICAL FOR INTERIOR NON LOAD BEARING WALLS ONLY, ROUGH OPNG 38" TO 74" MAX.
- (C) TYPICAL FOR ALL CONDITIONS NOT LISTED IN (A) OR (B) UNO.

-HEADERS IN NON LOAD BEARING INTERIOR WALLS ARE NOT LABELED.

*REQUIRED NUMBER OF KING STUDS FOR EXTERIOR HEADERS DETERMINED BY NCRBC TABLE 602.3(5) UNLESS NOTED OTHERWISE ON PLAN.

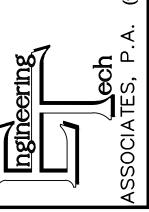


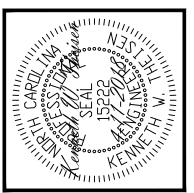


PLAN NO. SULLIVAN RH

PROJECT NO. 18-29-016R

> SHEET NO. \$3

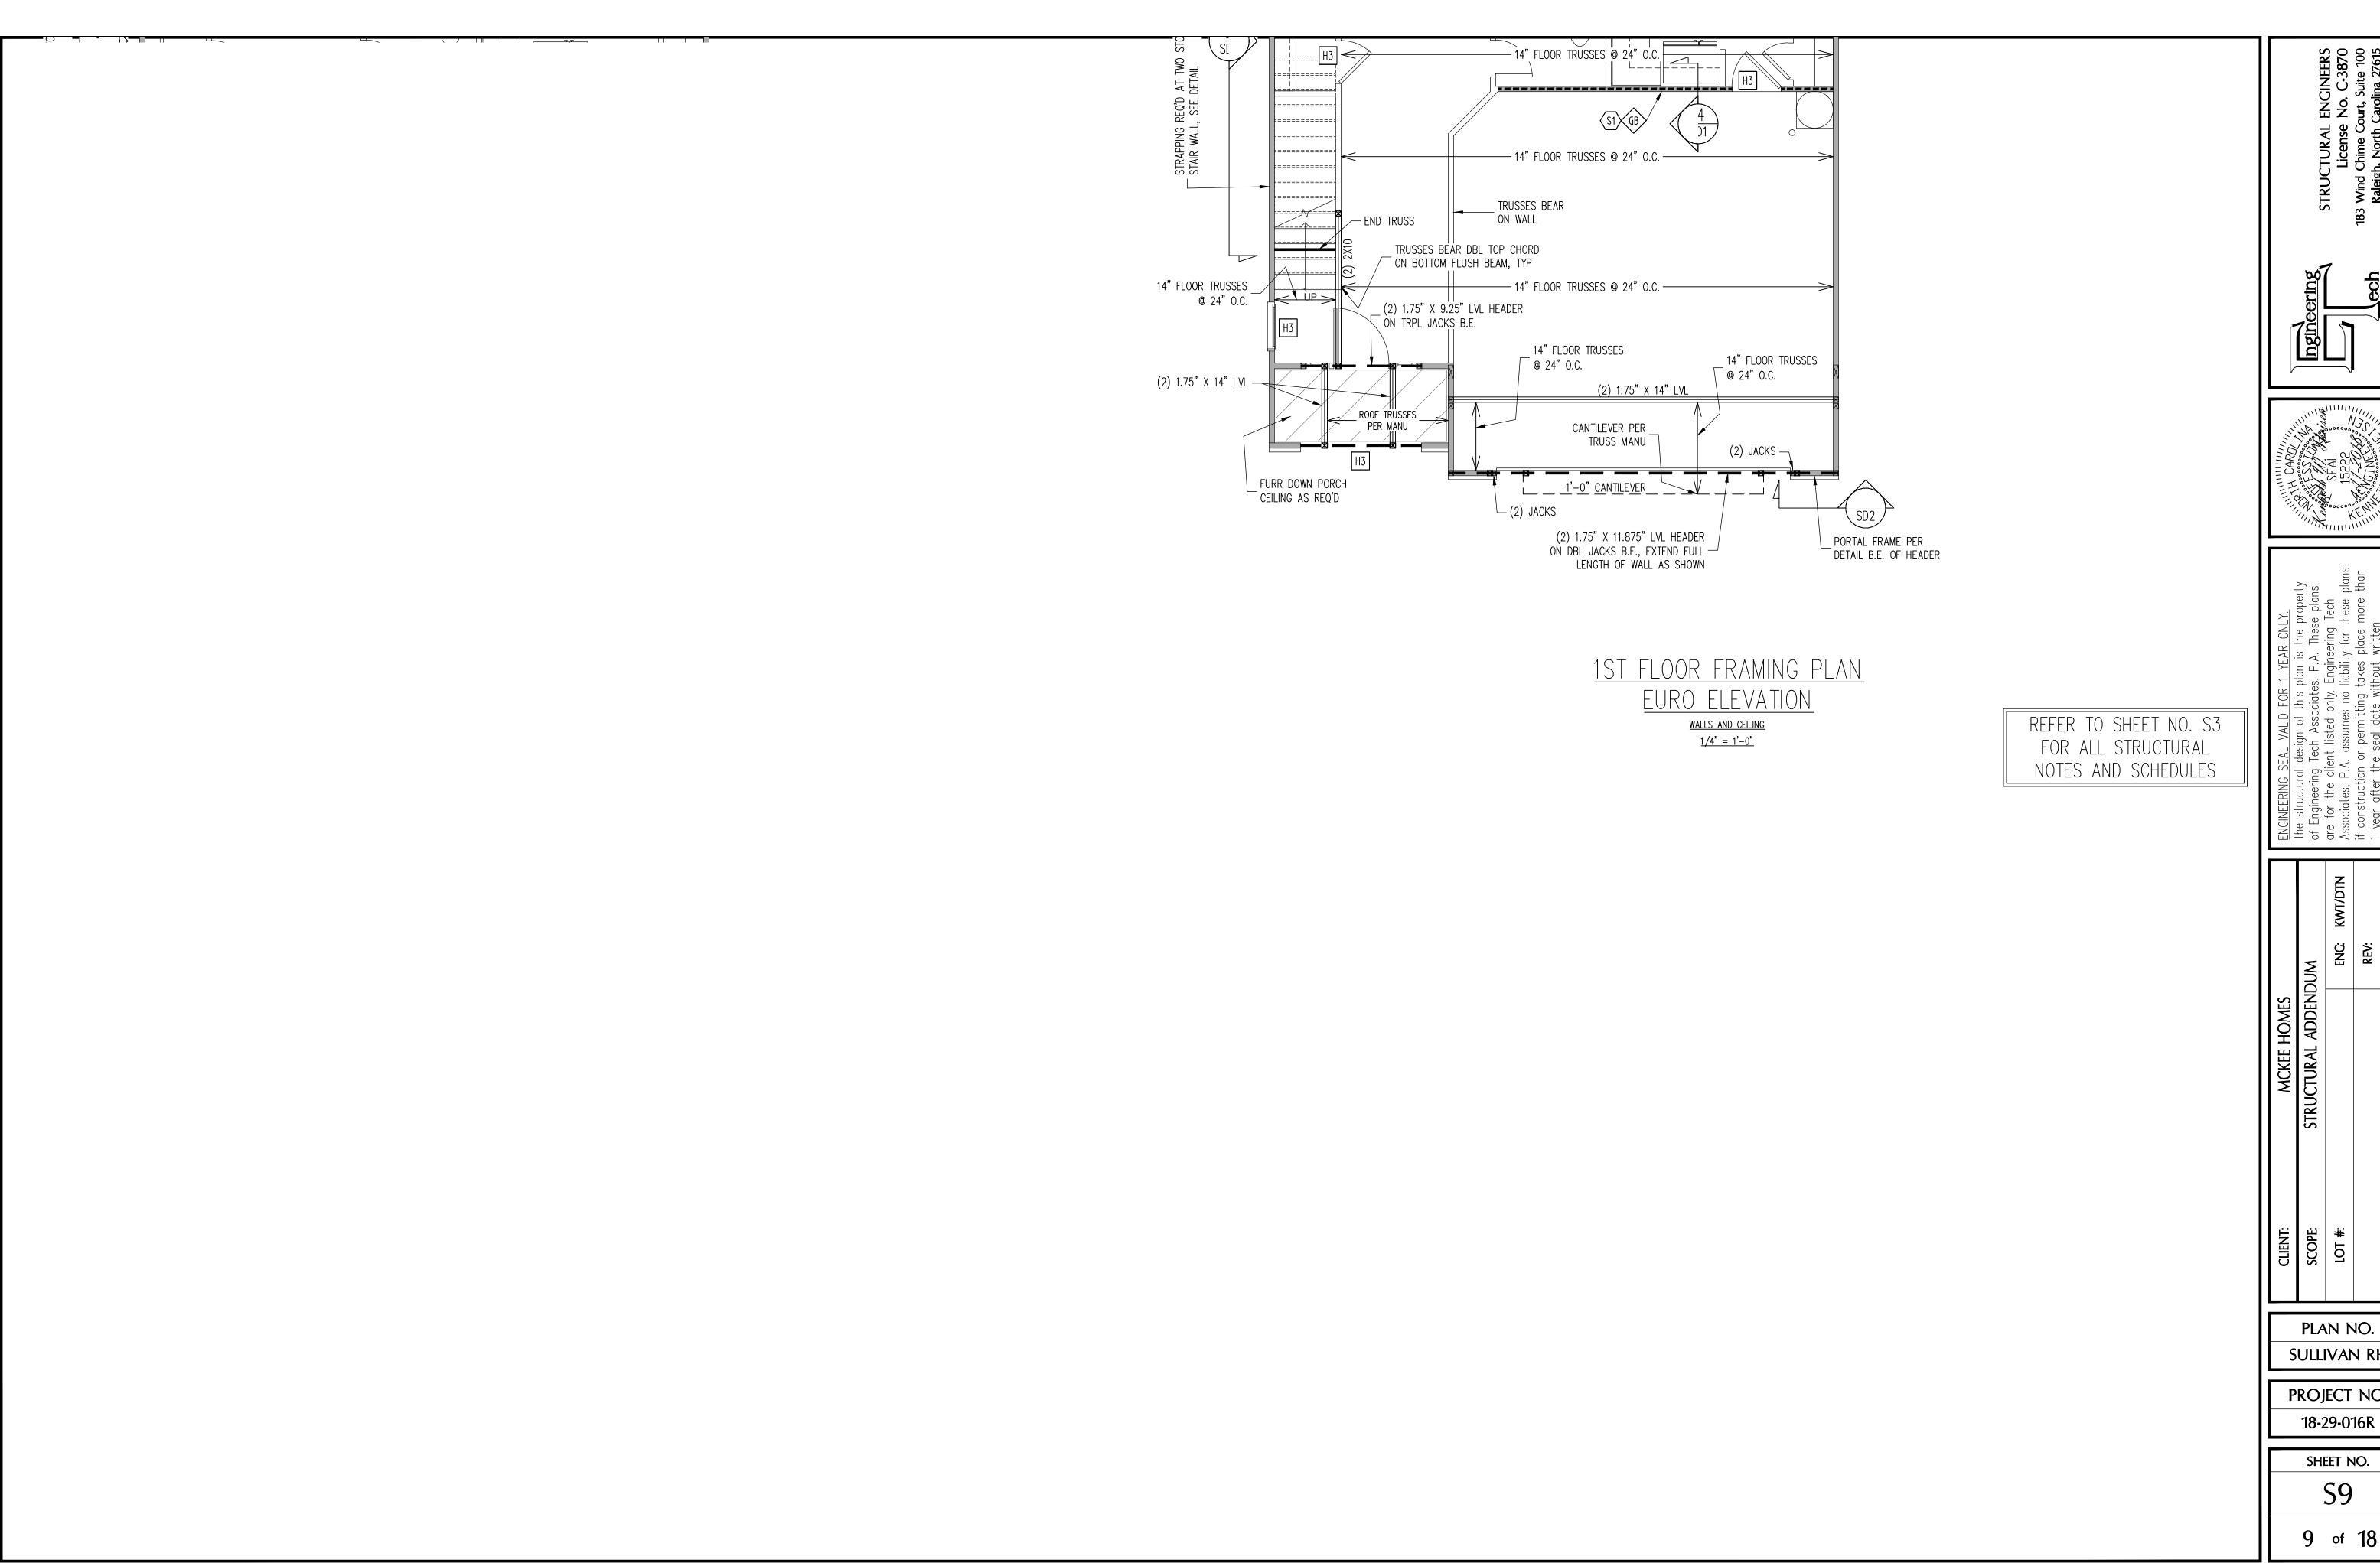




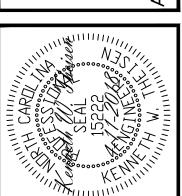



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	MNC	ENG	REV:	DATE
CLIENT: MCKEE HOMES	SCOPE STRUCTURAL ADDENDUM	# 107		


PLAN NO. SULLIVAN RH

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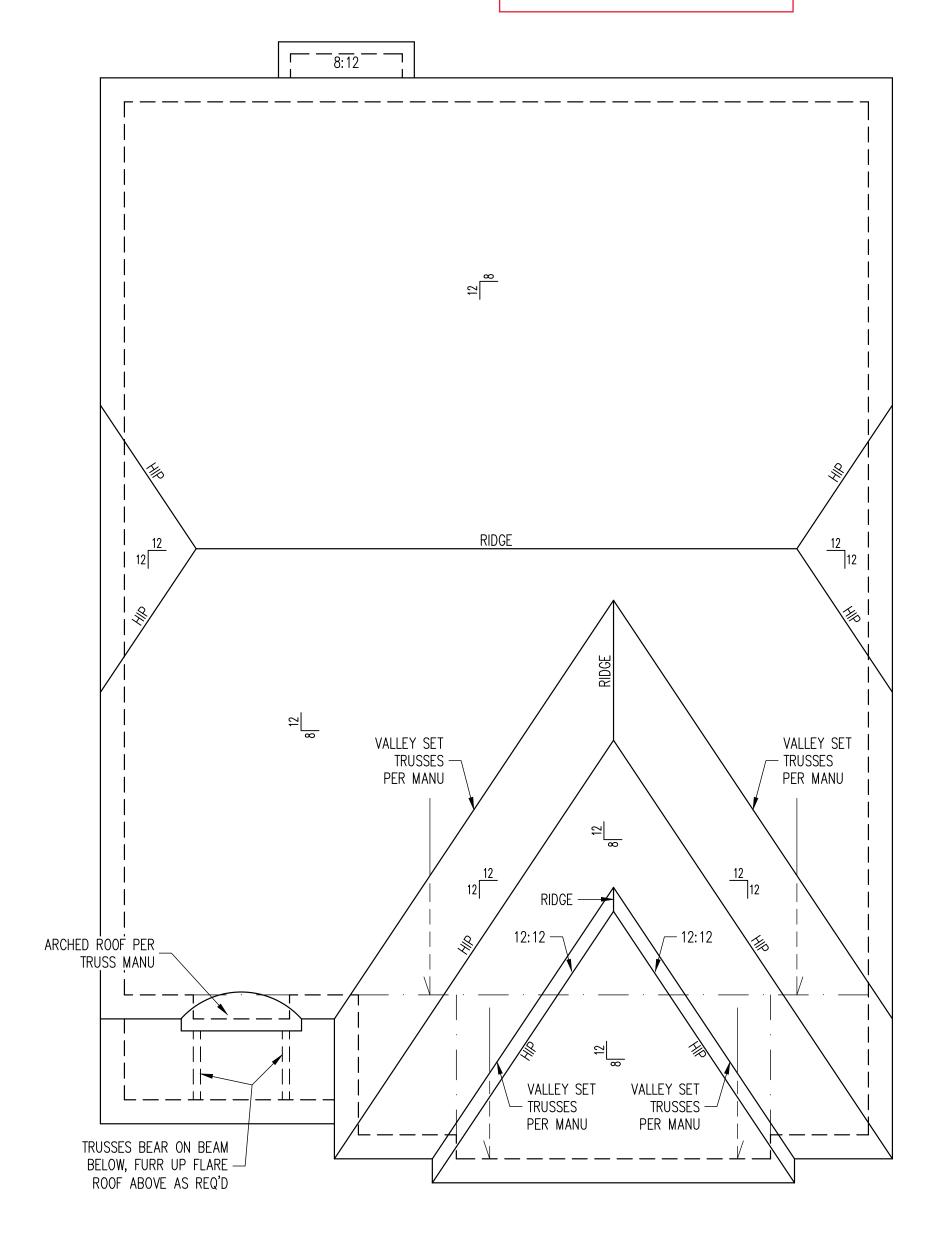


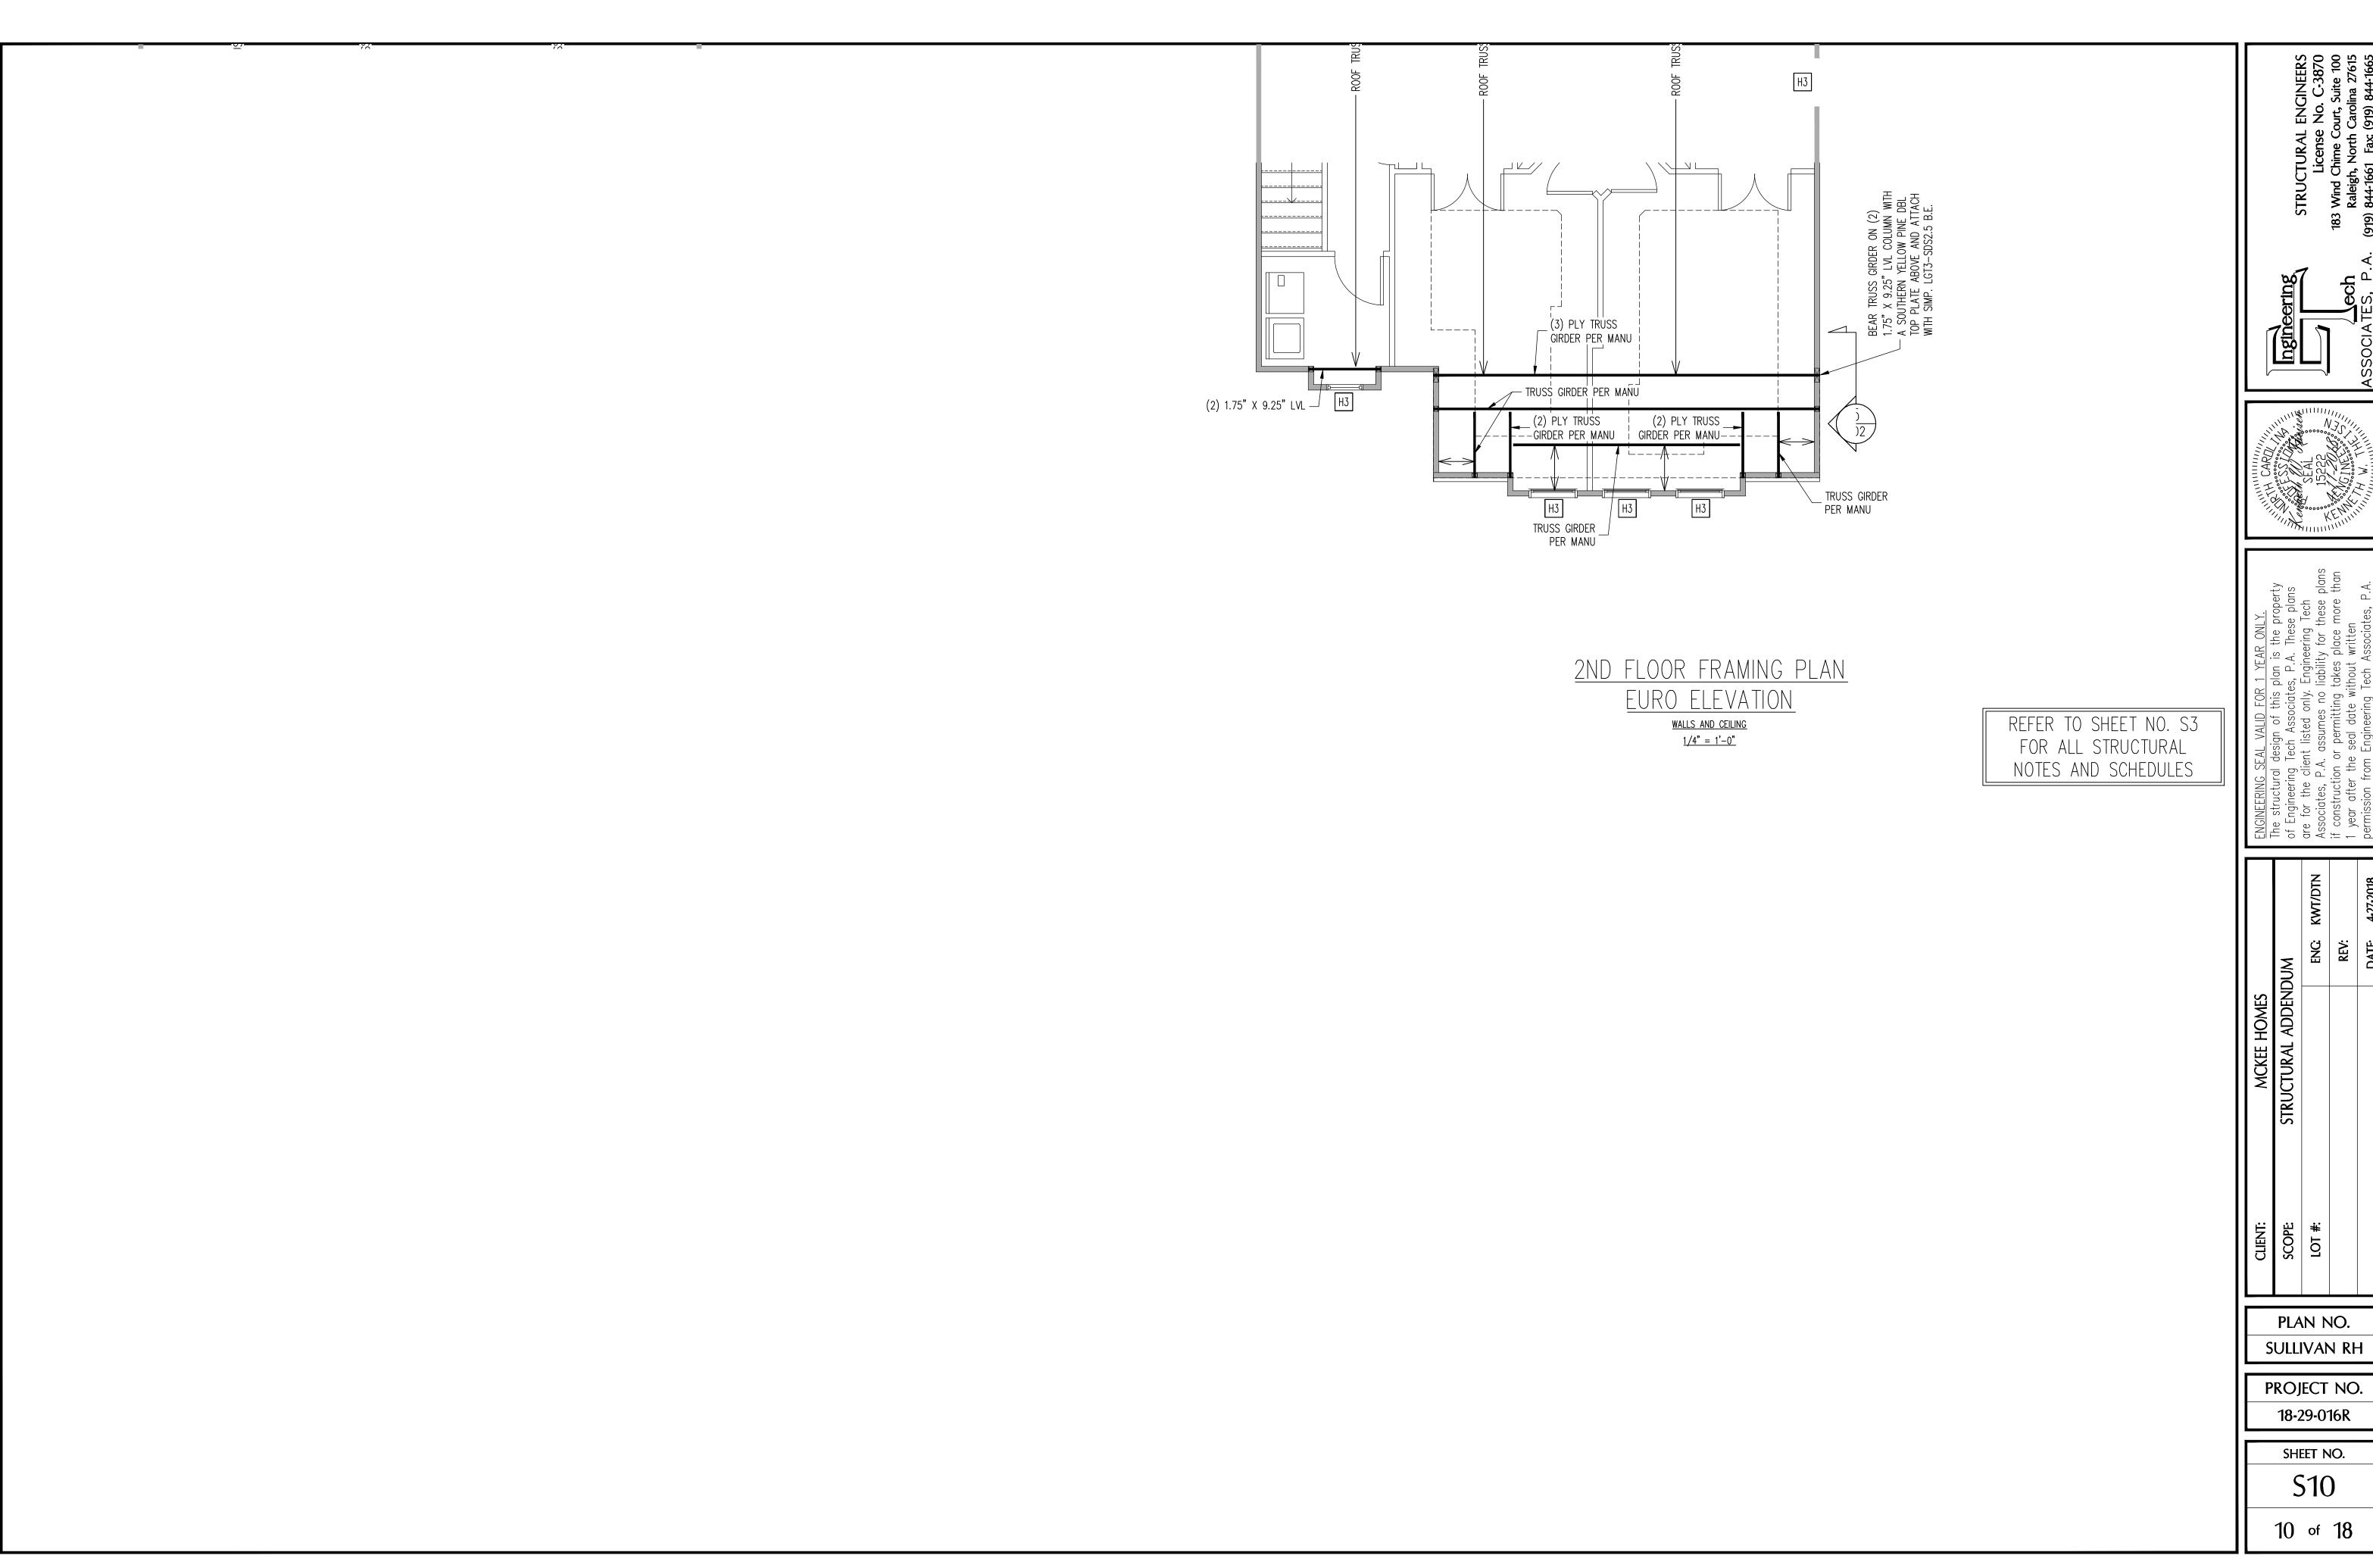

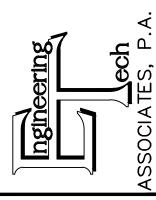PLAN NO.
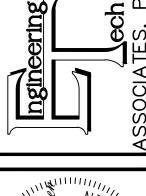
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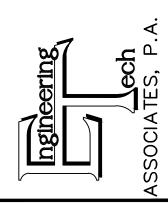
Covered rear porch See pg S13

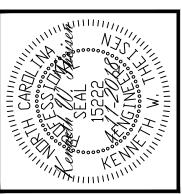


ROOF FRAMING PLAN EURO ELEVATION 1/4" = 1'-0"

Framing Notes
Roof only

-Roof trusses per manu typical UNO
-Verify all architectural overhangs,
roof pitches, and kneewall heights prior to construction



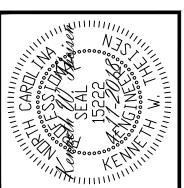


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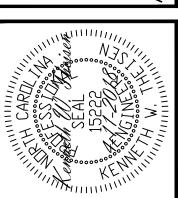
PROJECT NO. 18-29-016R

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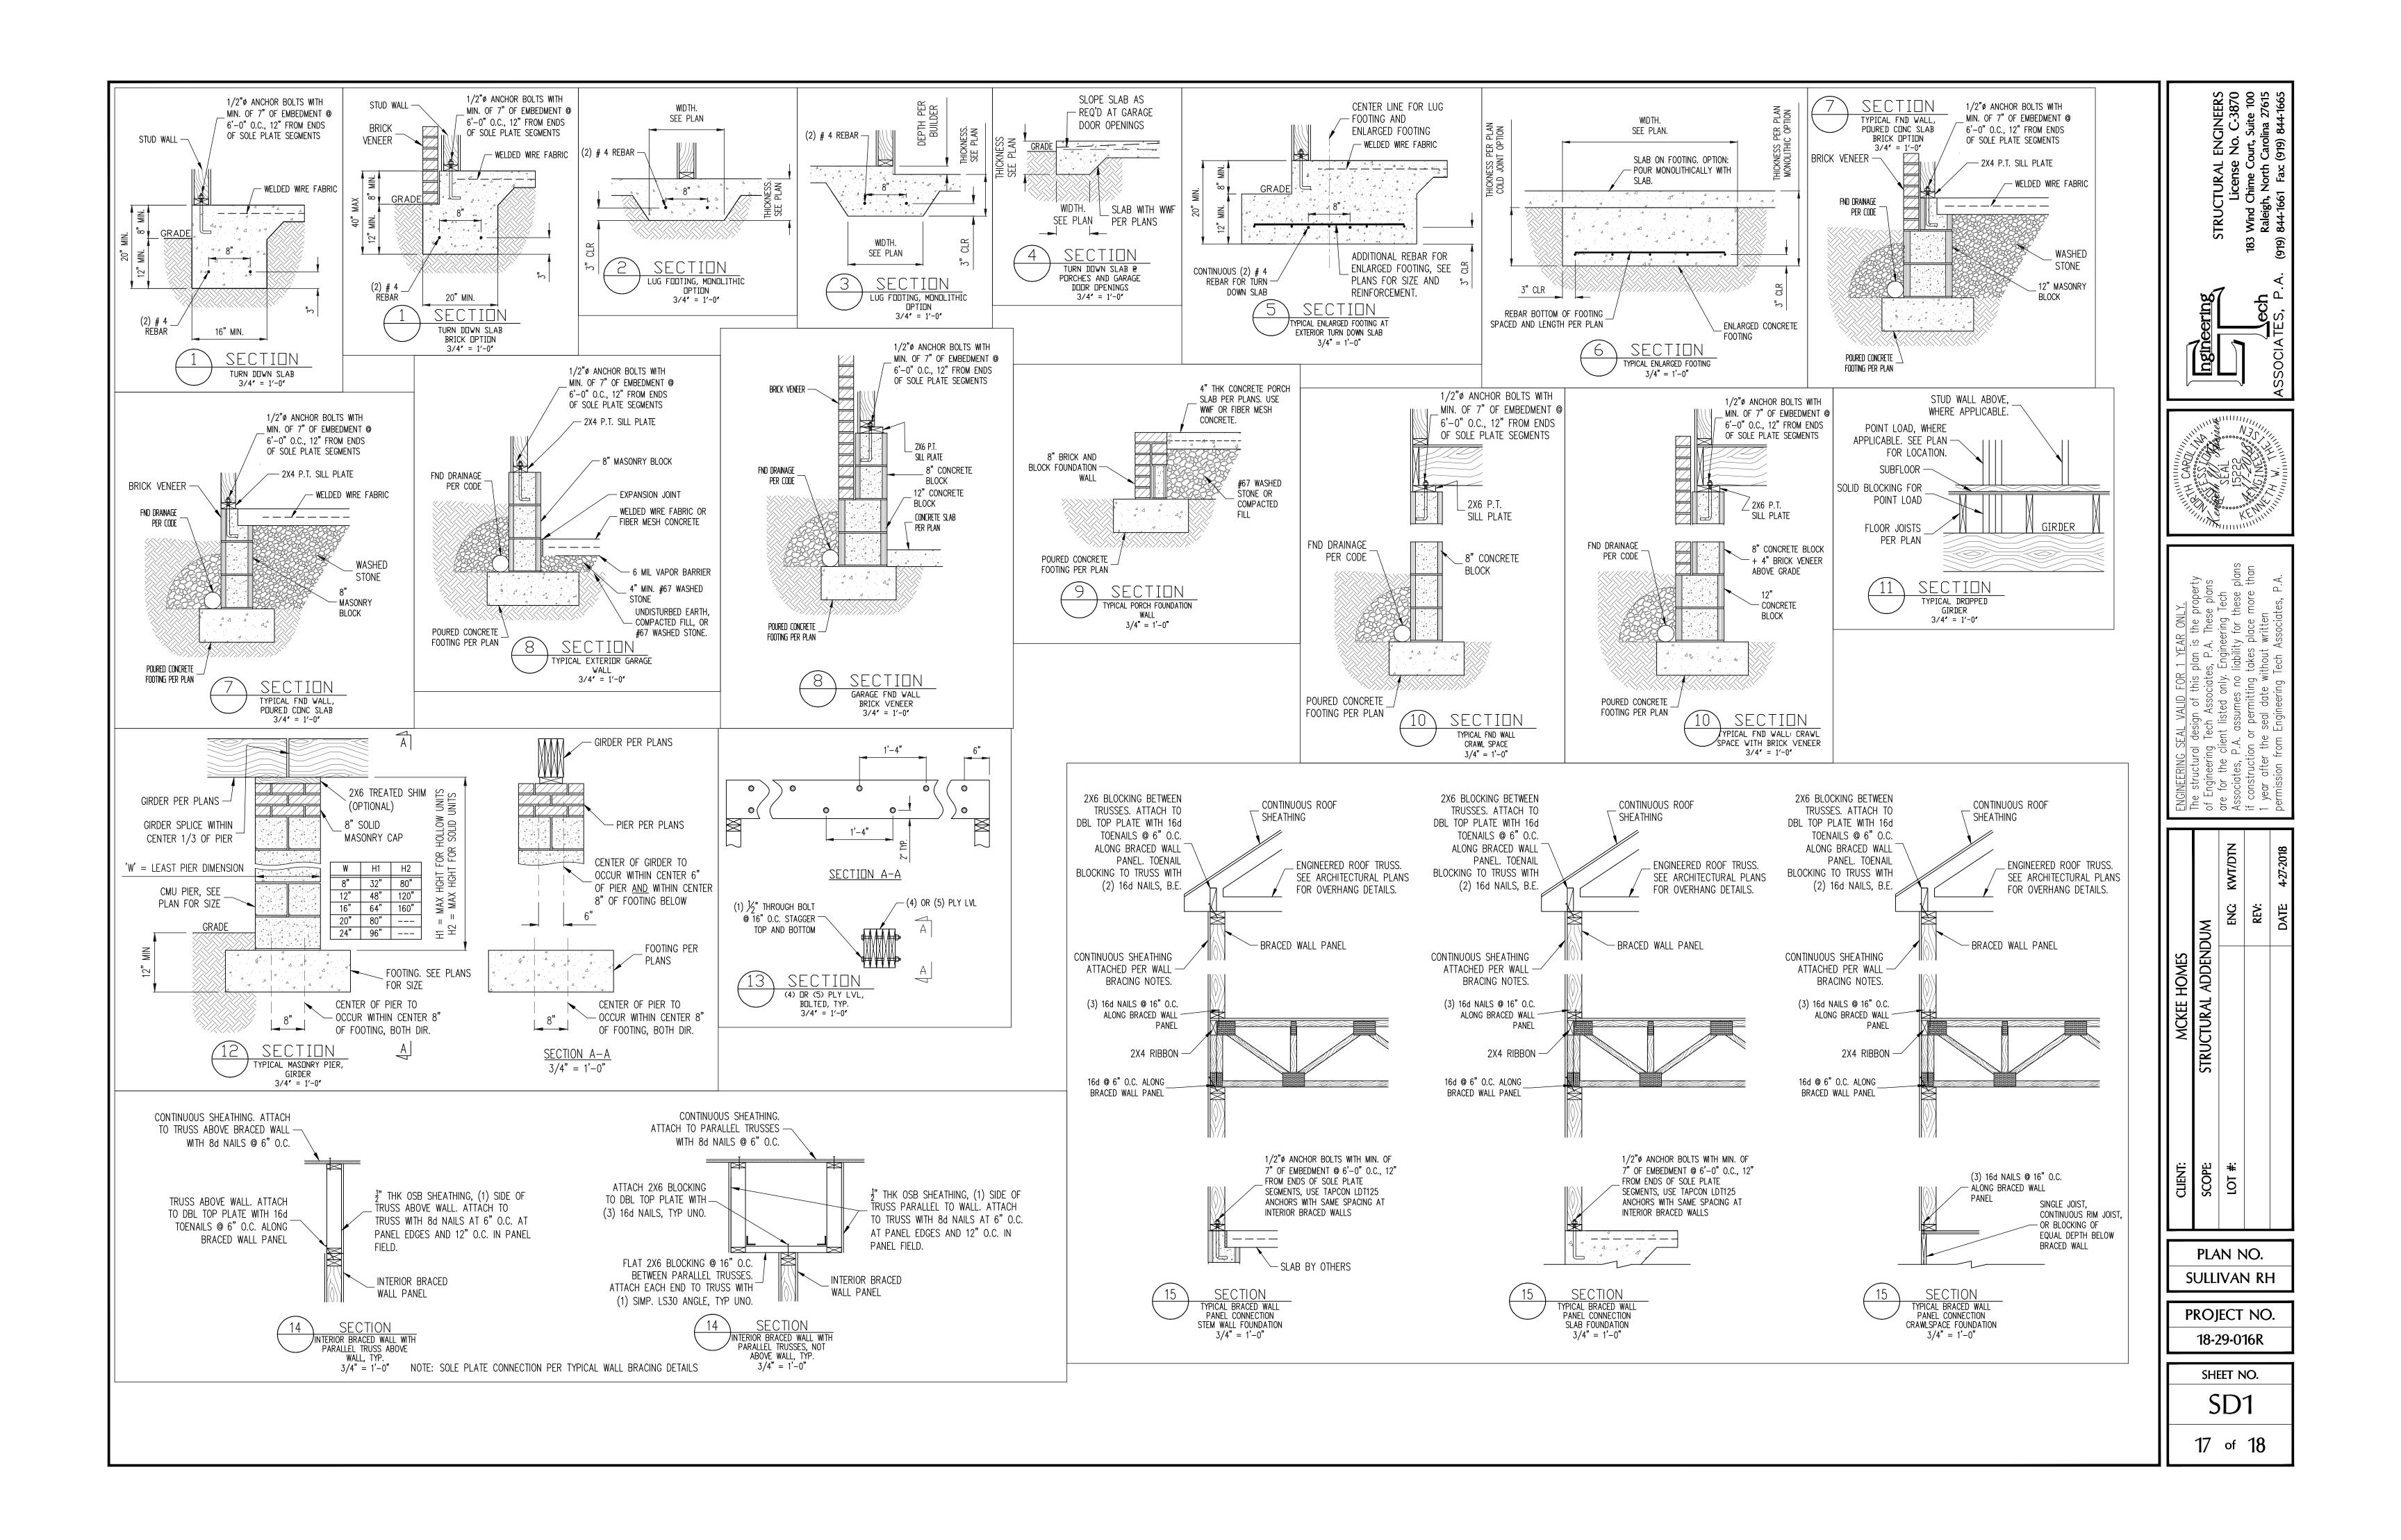
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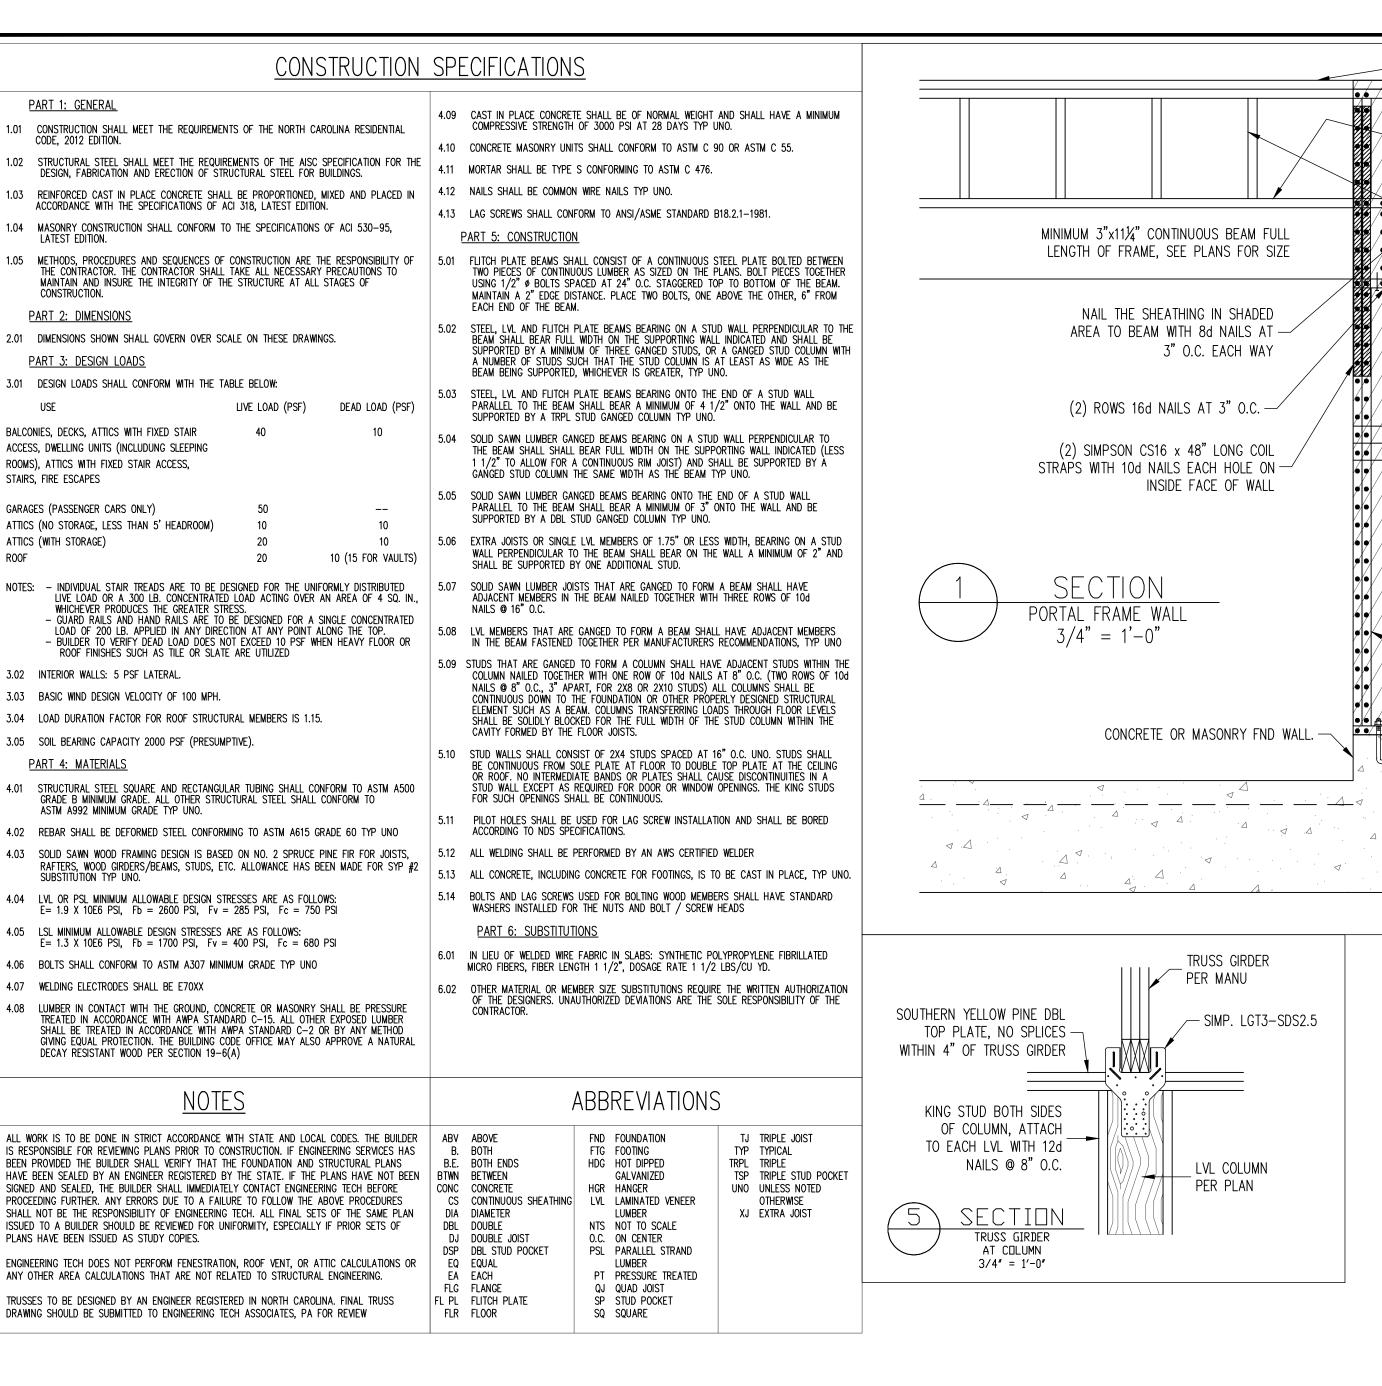
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RUN SIMP. CS16 STRAPS 12" MIN. ONTO STUDS (2) CONT. 2X TOP PLATES, EXTEND EACH END ABOVE AND BELOW @ -— INTO ADJACENT WALL. NAIL SPLICES WITH TWO STORY STAIR WALL, 8-16d NAILS PER SPLICE/LAP. BOTH SIDES OF WALL CONT. 2X PLATE WITH 10d NAILS AT 16" O.C. INTO HEADER/BEAM 2X4 BLOCKING, ALIGN WITH STUDS -7/16" O.S.B. OR 15/32" PLYWOOD EXTERIOR WALL ABOVE AND BELOW SHEATHING AT UNSHADED AREAS (BEAM, INFILL 9/ /o /o/ o/ o/ /o/ WALL ABOVE BEAM, AND CENTER WALL). NAIL (•/.•/ *)*• /.•/. •/. /• SHEATHING TO ALL SUPPORTS (STUDS, PLATES, BLOCKING, ETC.) WITH 8d NAILS AT 6" O.C. AT SHEET EDGES AND 12" O.C. IN THE FIELD. WALL HINGE REINFORCEMENT @ STAIR WALL OPENING 3/4'' = 1'-0''WHERE FULL HEIGHT PANEL WIDTH EXCEEDS 16", - PROVIDE ADDITIONAL STUDS AT 16" O.C. NAIL |**|•||•|| •/| |•|| •/| •/| •||•||•||** SHEATHING TO ALL STUDS WITH 8d NAILS AT 3" O.C. TOP FLUSH BEAM DBL TOP PLATE, PER PLAN CUT AT LVL COLUMN FOR A PANEL SPLICE (IF NEEDED), PANEL EDGES SHALL OCCUR OVER AND BE NAILED - TO COMMON BLOCKING AND OCCUR WITHIN 24" OF WALL HEIGHT. ONE ROW OF 3" O.C. (2) 36" LONG SIMP. CS16 STRAPS NAILING IS REQUIRED IN EACH PANEL EDGE. DBL 2X10 COLUMN

7/16" O.S.B. OR 15/32" PLYWOOD

NAILS AT 3" O.C.

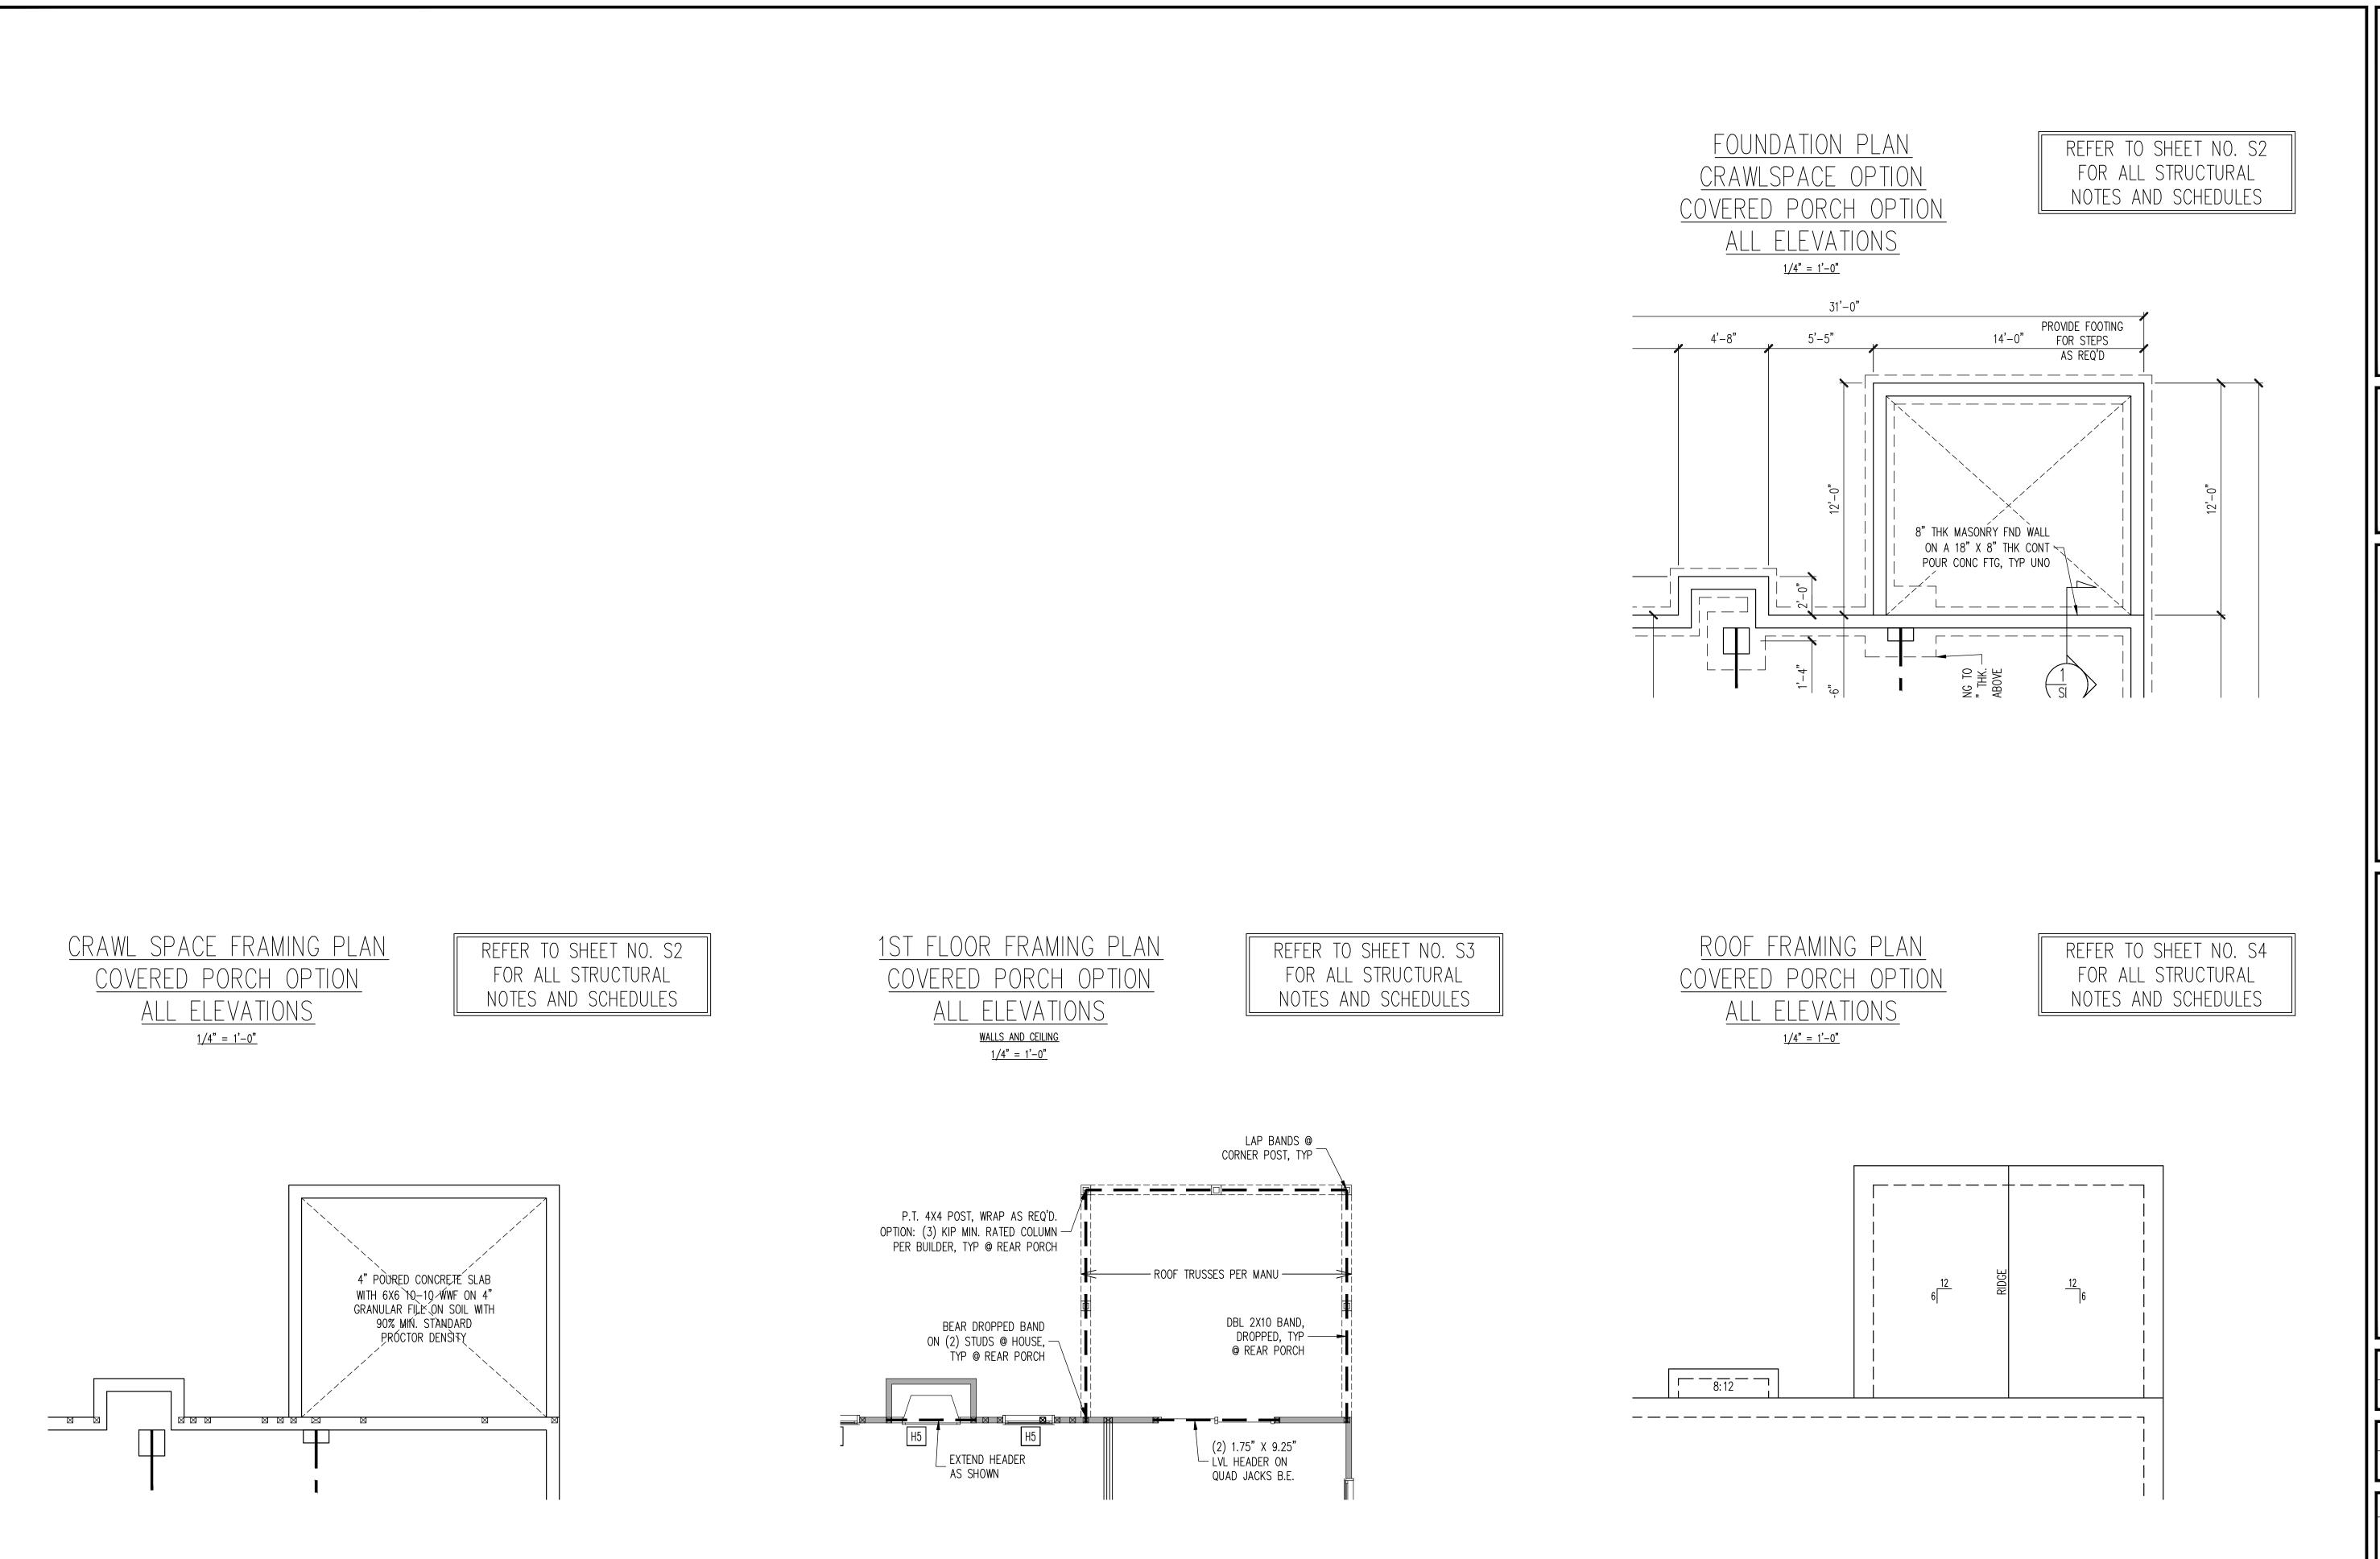EXTERIOR WALL SHEATHING. AT SHADED

- AREAS NAIL SHEATHING TO ALL SUPPORTS

(STUDS, PLATES, BLOCKING, ETC.) WITH 8d

(2)2x STUD MIN. AT START AND END OF


- WALL SEGMENTS EACH SIDE OF OPENING.

2x4 P.T. PLATE WITH TWO 1/2" DIA x 7" EMBED

WASHERS OR ADDITIONAL HOLDOWN PER PLANS


SEE PLANS FOR ADDITIONAL STUDS

- ANCHOR BOLTS WITH A 3/16"x2"x2" PLATE

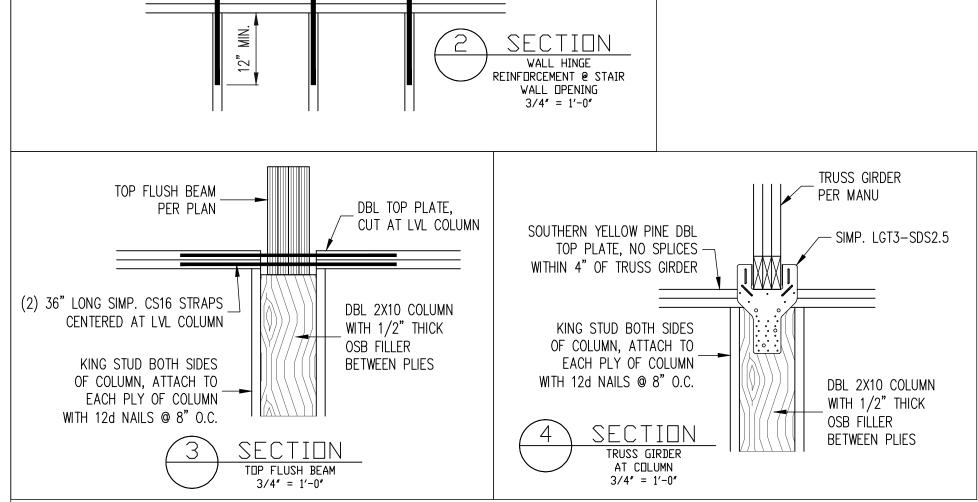

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		ENG: KWT/DTN	``````````````````````````````````````	DATE 4-27-2018
MCKEE HOMES	STRUCTURAL ADDENDUM	ENG	REV:	DATE
CLIENT:	SCOPE	# 101		

PLAN NO.
SULLIVAN RH

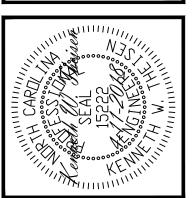PROJECT NO. 18-29-016R

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