THE MINSTON

Lot 199 - Oakmont Valley View



GMD DESIGN GROUP CAROLINAS, INC. IO2 FOUNTAIN BROOK CIRCLE SUITE C CARY, NC. 27511 PHONE: (919) 320-3022

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NO:	DATE:	REVISION:
$\overline{\mathbb{A}}$	xx-xx-xx	

PROFESSIONAL SEAL.

PROJECT TITLE:

The Winston

CONSULTANTS:

LOCAL JURISDICTION: NAME STREET ADDRESS CITY, STATE ZIP CODE PHONE: (XXX)XXX-XXXX CONTACT: XXXX XXXXX EMAIL: XXXXXXXX	BUILDER: MCKEE HOMES 120 NANDINA COURT FAYETTEVILLE, NC 28311	DESIGNER: GMD DESIGN GROUP IOB 5, SALEM ST. SUITE 203 APEX, NC 27502 PHONE: (414) 320-3022 CONTACT: SCOTT GARDENER EMAIL: SCOTT@GMDDESIGNGROUP.COM
MEP ENGINEERS: NAME STREET ADDRESS CITY, STATE ZIP CODE PHONE: (XXXX)XXX-XXXX CONTAGT: XXXX XXXXX EMAIL: XXXXXXXX	CIVIL ENGINEER: NAME STREET ADDRESS CITY, STATE ZIP CODE PHONE: (XXXXXXXXXXXXXXXXXXXXXXXXXXXXXXXXXXXX	STRUCTURAL ENGINEER: NAME STREET ADDRESS CITY, STATE ZIP CODE PHONE: (XXX)XXX-XXXX CONTACT: XXXX XXXXX EMAIL: XXXXXXX

THESE DOCUMENTS ARE THE PROPERTY OF THE DESIGNER AND SHALL NOT BE COPIED, DUPLICATED, ALTERED, MODIFIED OR REVISED IN ANY WAY WITHOUT THE EXPRESSED WRITTEN APPROVAL OF THE DESIGNER.

CONTRACTOR SHALL VERIFY ALL CONDITIONS AND DIMENSIONS AT THE SITE AND ALL INCONSISTENCES SHALL BE BROUGHT TO THE ATTENTION OF THE DEVELOPER AND THE DESIGNER BEFORE PROCEEDING WITH WORK.

ANY ERRORS OR OMISSIONS FOUND IN THESE DRAWINGS SHALL BE BROUGHT TO DO NOT SCALE DRAWINGS. WRITTEN DIMENSIONS TAKE PRECEDENCE OVER SCALED

ALL DIMENSIONS ARE TO FACE OF STUD OR TO FACE OF FRAMING UNLESS

ALL TRUSS DRAWINGS TO BE REVIEWED AND APPROVED BY THE STRUCTURAL ENGINEER PRIOR TO ISSUANCE OF BUILDING PERMIT.

ALL OR EQUAL SUBSTITUTIONS MUST BE SUBMITTED TO AND APPROVED BY CITY

ALL ANGLED PARTITIONS ARE 45 DEGREES UNLESS OTHERWISE NOTED.

PROVIDE FIREBLOCKING, (PER LOCAL CODES.) ALL ELECTRICAL AND MECHANICAL EQUIPMENT AND METERS ARE SUBJECT TO RELOCATION DUE TO FIELD CONDITIONS, CONTRACTOR TO VERIFY. PROVIDE BLOCKING AND/OR BACKING AT ALL TOWEL BAR, TOWEL RING AND/OR TOILET PAPER HOLDER LOCATIONS, AS SHOWN PER PLAN. TYPICAL AT ALL BATHROOMS AND POWDER ROOMS. VERIFY LOCATIONS AT FRAMING WALK.

ELASTOMERIC SHEET WATERPROOFING: FURNISH AND INSTALL ALL WATERPROOFING COMPLETE. A 40 MIL. SELF-ADHERING MEMBRANE OF RUBBERIZED ASPHALT INTEGRALLY BONDED TO POLYETHYLENE SHEETING, OR EQUAL. INSTALL PER MANUFACTURE'S AND TRADE ASSOCIATION'S PRINTED
INSTALLATION INSTRUCTIONS, 6" MINIMUM LAP AT ALL ADJACENT WALL SURFACES.

TO THE BEST OF THE DESIGNER'S KNOWLEDGE THESE DOCUMENTS ARE IN CONFORMANCE WITH THE REQUIREMENTS OF THE BUILDING AUTHORITIES HAVING JURISDICTION OVER THIS TYPE OF CONSTRUCTION AND OCCUPANCY.

SHOP DRAWING REVIEW AND DISTRIBUSTION, ALONG WITH PRODUCT SUBMITTALS, REQUESTED IN THE CONSTRUCTION DOCUMENTS, SHALL BE THE SOLE RESPONSIBILITY OF THE GENERAL CONTRACTOR, UNLESS DIRECTED OTHERWISE UNDER A SEPARATE AGREEMENT.

DEVIATIONS FROM THESE DOCUMENTS IN THE CONSTRUCTION PHASE SHALL BE REVIEWED BY THE DESIGNER AND THE OWNER PRIOR TO THE START OF MORK IN QUESTION. ANY DEVIATIONS FROM THESE DOCUMENTS WITHOUT PRIOR REVIEW, SHALL BE THE SOLE RESPONSIBILITY OF THE GENERAL CONTRACTOR.

THE GENERAL CONTRACTOR SHALL BE RESPONSIBLE FOR ALL WORK AND MATERIALS REPRESENTED ON THESE DOCUMENTS INCLUDING THE WORK AND MATERIALS FURNISHED BY SUBCONTRACTORS AND VENDORS. THE BUILDER SHALL FURNISH ANY AND ALL REPORTS RECEIVED FROM THE

GEOTECHNICAL ENGINEER (SOLES REPORT), ON THE STUDY OF THE PROPOSED SITE, TO THE DESIGNER, STRUCTURAL ENGINEER, AND GENERAL CONTRACTOR. IN THE EVENT THE GEOTECHNICAL REPORTS DO NOT EXIST, THE SOLES CONDITION SHALL BE ASSUMED TO BE A MINIMUM DESIGN SOIL PRESSURE STATED BY THE STRUCTURAL ENGINEER OF RECORD FOR THE PURPOSE OF STRUCTURAL DESIGN. GENERAL CONTRACTOR SHALL ASSURE THE SOIL CONDITIONS MEET OR EXCEED

ALL WORK PERFORMED BY THE GENERAL CONTRACTOR SHALL COMPLY AND CONFORM WITH LOCAL AND STATE BUILDING CODES, ORDINANCES AND REGULATIONS, ALONG MITH ALL OTHER AUTHORITIES HAVING JURISDICTION. THE GENERAL CONTROLATOR IS RESPONSIBLE TO BE AWARE OF THESE REGUIREMENTS AND GOVERNING REGULATIONS

PROVIDE AN APPROVED WASHER DRAIN PAN AT SECOND FLOOR ONLY

WINDOW SUPPLIER TO VERIFY AT LEAST ONE WINDOW IN ALL BEDROOMS TO HAVE A CLEAR OPENABLE AREA OF 4.0 50 FT. THE MINIMUM NET CLEAR OPENING HEIGHT SHALL BE 22" AND THE MINIMUM NET CLEAR OPENING HIDTH SHALL BE 20", GLAZING TOTAL AREA OF NOT LESS THAN 5.0 50 FT IN THE CASE OF A GROUND WINDOW AND NOT LESS THAN 5.75 SQ FT IN THE CASE OF AN UPPER STORY WINDOW (PER NORG SECTION R3IO.L.)

ALL HANDRAIL BALLIGHTERS TO BE SPACED SUCH THAT A 4" SPHERE CANNOT PASS BETHEEN BALLIGHTERS. (PER LOCAL CODES) PROVIDE STAIR HANDRAILS AND GUARDRAILS PER

BUILDER SET:

THE SCOPE OF THIS SET OF PLANS IS TO PROVIDE A "BUILDER'S SET"
OF CONSTRUCTION DOCUMENTS AND GENERAL NOTES HEREINAFTER REFERRED TO AS "PLANS"
THIS SET OF PLANS IS SUFFICIENT TO OBTAIN A BUILDING PERMIT, HOWEVER, ALL MATERIALS THIS SET OF PLANS IS SUFFICIENT TO OBTAIN A BUILDING PERMIT, HOWEVER, ALL MATERIALS AND METHODS OF CONSTRUCTION NECESSARY TO COMPLETE THE PROJECT ARE NOT NECESSARILY DESCRIBED. THE PLANS DELINEATE AND DESCRIBE ONLY LOCATIONS, DIMENSIONS, TYPES OF MATERIALS, AND GENERAL METHODS OF ASSEMBLING OR FASTENING. THEY ARE NOT INTENDED TO SPECIFY PARTICULAR PRODUCTS OR OTHER METHODS OF ANY SPECIFIC MATERIALS, PRODUCT OR METHOD. THE IMPLEMENTATION OF THE PLANS REQUIRES A CLIENT / CONTRACTOR THROPOIGHLY KNOWLEDGEABLE WITH THE APPLICABLE BUILDING CODES AND METHODS OF CONSTRUCTION SPECIFIC TO THIS PRODUCT TYPE AND TYPE OF CONSTRUCTION

CONSTRUCTION REQUIREMENTS AND QUALITY: PROVIDE WORK OF THE SPECIFIC QUALITY CONSTRUCTION REQUIREMENTS AND QUALITY: PROVIDE MORK OF THE SPECIFIC QUALITY; WHERE QUALITY LEVEL IS NOT INDICATED, PROVIDE WORK OF QUALITY CUSTOMARY IN SIMILAR TYPES OF WORK, WHERE THE PLANS AND SPECIFICATIONS, CODES, LAVE, REQULATIONS, MANUFACTURER'S RECOMMENDATIONS OR INDUSTRY STANDARDS REQUIRE WORK OF HIGHER QUALITY OR PERFORMANCE, PROVIDE WORK COMPLYING WITH THOSE REQUIREMENTS AND QUALITY. WHERE TWO OR MORE QUALITY PROVISIONS OF THOSE REQUIREMENTS CONFLICT WITH THE TWO ST STRINGENT REQUIREMENT, WHERE REQUIREMENTS ARE DIFFERENT BUT APPARENTLY EQUILA, AND WHERE IT IS INCERTAIN WHICH REQUIREMENT IS MOST STRINGENT, OBTAIN CLASSIFICATION OF THE PROVISION OF THE CLARIFICATION FROM THE GMD DESIGN GROUP BEFORE PROCEEDING

AREA CALCULATIONS:

13036RAL

SHEET TITLE:

CLIENTS NAME

TITLE SHEET

November 28, 2016

FOR CONSTRUCTION



 ATTIC ACCESS LARGE ENOUGH TO REMOVE LARGEST PIECE OF EQUIPMENT BUT NOT LESS THAN 30'x20'. FIRE RATED ACCESS AS NOTED. (FIRE NCRC SECTION RROTT) ATTIC ACCESS LADDER, VERIFY LOCATION AND SIZE WITH TRUSSES. (25 I/2" X 54" SIZE.) TYPICALS: 1 TEMPERED SAFETY GLASS. (PER NCRC SECTION 308.4) 10 PLYWOOD SHELF ABOVE WITH DRYWALL FINISH OVER. HEIGHT AS NOTED. III HALF WALL, HEIGHT AS NOTED. [2] INTERIOR SOFFITS: FFL = 8'-1" U.N.O. SFL = 7'-6" U.N.O.

[3] SHOWER, TEMPERED GLASS ENCLOSURE. [4] TUB-SHOWER COMBO. TEMPERED GLASS ENCLOSURE.

[5] CERAMIC TILE SHOWER AND FLOOR, TEMPERED GLASS ENCLOSURE.

6 42"x60" ACRYLIC TUB W CERAMIC PLATFORM


KITCHEN:

30" SLIDE-IN ELECTRICAL RANGE W HOOD AND MICRO ABV. VENT PER MANUFACTURER'S WRITTEN INSTRUCTIONS.

[18] 36" GAS COOKTOP AND HOOD. VENT PER MANUFACTURER'S WRITTEN INSTRUCTIONS.

[19] ELECTRIC OVEN WITH MICROWAVE OVEN.

9'-1" STAIR NOTE:
(USE 14" T.J.I WITH 3/4" PLYWOOD SUBFLOOR)
IS TREADS AT 10" EACH VERIFY
IT RISERS AT 1/- 1.28" = 123 3/4" TOTAL
PIEC VERIFY RISE VERIFY

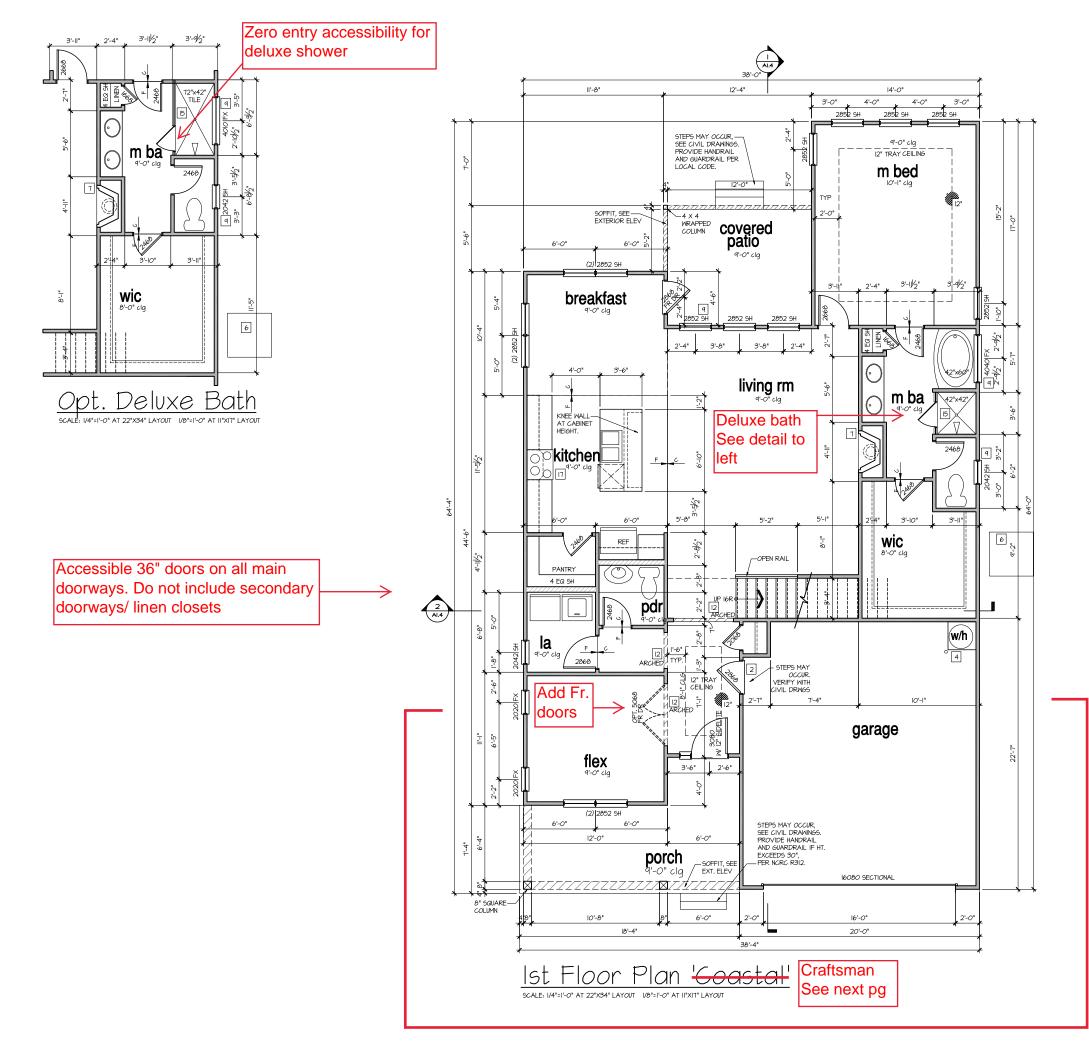



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FOR CONSTRUCTION



13036RAL

1st FLOOR PLAN

November 28, 2016

A1.1

FOR ADDITIONAL NOTES SEE GENERAL NOTES ON TITLE SHEET AND DETAILS. MINDOW HEAD HEIGHTS: IST FLOOR = 7'-8" U.N.O. ON ELEVATIONS. 2ND FLOOR = 6'-10" U.N.O. ON ELEVATIONS.

ALL DIMENSIONS TO WINDOWS AND DOORS ARE TO CENTERLINE.

WALL LEGEND:

FULL HEIGHT 2X4 WOOD STUD PARTITION

FULL HEIGHT 2X6 WOOD STUD PARTITION

STUD WALL BELOW HEIGHT AND STUD SIZE AS NOTED BRICK / STONE VENEER

LOW GYPSUM BOARD WALL HEIGHT AND STUD SIZE AS NOTED DRYWALL OPENING. HEIGHT AS NOTED ON PLAN.

KEY NOTES FOR NORTH CAROLINA:

FIRE PROTECTION:


- | HOUSE TO GARAGE FIRE SEPARATION, GARAGE/HOUSE SEPARATION AT VERTICAL SURFACES SHALL BE PROTECTED WITH ONE (1) LAYER 1/2" GYPSUM BOARD, (PER NCRC TABLE R302.6.) GARAGE/HOUSE SEPARATION AT HORIZONTIAL SURFACES SHALL BE PROTECTED WITH ONE (I) LAYER 5/8" TYPE 'X' GYPSUM BOARD. (PER NCRC TABLE R302.6.)
- | HOUSE TO GARAGE DOOR SEPARATION, PROVIDE I-3/6" SOLID CORE DOOR OR APPROVED 20 MINUTE RATED DOOR. (PER NORG SECTION R302.5.I.)
- 3 BENEATH STAIRS AND LANDINGS. I/2" GYPSIM BOARD ON WALLS AND CEILING OF ENCLOSED ACCESSIBLE AREAS. (PER NORC SECTION RSO2.T.) IN CONCEALED SPACES BETWEEN STAIR STRINGERS PROVIDE FIREBLOCKING PER R302.I.
- GAS WATER HEATER ON 18" HIGH PLATFORM. (PER CHAPTER 5 NCRC-PLUMBING)
- 5 FAU 8'XI2' PLATFORM. VERIFY WITH TRUSS MANUFACTURER.
- 6 A/C CONDENSER PAD. (VERIFY)
- T PRE-FABRICATED METAL FIREPLACE.
 INSTALL PER MANUFACTURER'S WRITTEN INSTRUCTIONS.
- ATTIC ACCESS LARGE ENOUGH TO REMOVE LARGEST PIECE OF EQUIPMENT BUT NOT LESS THAN 30'x20'. FIRE RATED ACCESS AS NOTED. (FER NCRC SECTION R80T)
 ATTIC ACCESS LADDER, VERIFY LOCATION AND SIZE WITH TRUSSES. (25 1/2" x 54" SIZE.)
- TYPICALS:
- TEMPERED SAFETY GLASS. (PER NCRC SECTION 308.4)
- 10 PLYWOOD SHELF ABOVE WITH DRYWALL FINISH OVER. HEIGHT AS NOTED.
- III HALF WALL, HEIGHT AS NOTED.
- 12 INTERIOR SOFFITS: FFL = 8'-I" U.N.O. SFL = 7'-6" U.N.O. BATHS:
- [3] SHOWER, TEMPERED GLASS ENCLOSURE.
- 14 TUB-SHOWER COMBO. TEMPERED GLASS ENCLOSURE.
- 15 CERAMIC TILE SHOWER AND FLOOR. TEMPERED GLASS ENCLOSURE.
- 16 42"x60" ACRYLIC TUB W CERAMIC PLATFORM

KITCHEN:

- IT 30" SLIDE-IN ELECTRICAL RANGE W HOOD AND MICRO ABV. VENT PER MANUFACTURER'S WRITTEN INSTRUCTIONS.
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- 19 ELECTRIC OVEN WITH MICROWAVE OVEN.

9'-1" STAIR NOTE:
(USE 14" TJI WITH 3/4" PLYWOOD SUBFLOOR)
16 TREADS AT 10" EACH VERIFY
17 RISERS AT 4/- 7.26" = 123 3/4" TOTAL
RISER VERIFY RISE VERIFY

'THE WINSTON' - CRAF	TSMAN SF
AREA	ELEV
Ist FLOOR	1492 SF
2nd FLOOR	733 SF
TOTAL LIVING	2225 SF
GARAGE	436 SF
PORCH	150 SF
COLUEDED DATIO	120.65

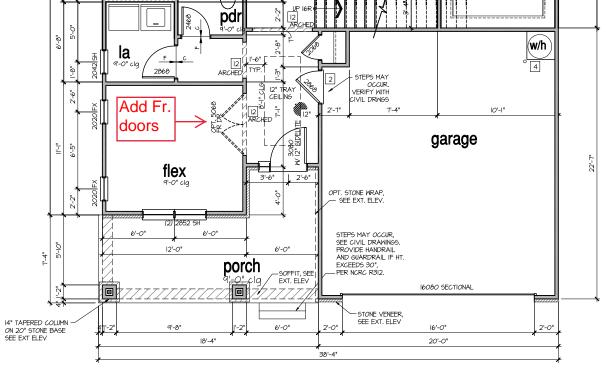

Ist Floor Plan 'Craftsman

SCALE: I/4"=I'-0" AT 22"X34" LAYOUT I/8"=I'-0" AT II"XI7" LAYOUT



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The Winston

FOR CONSTRUCTION

CLIENTS NAME



13036RAL

SHEET TITLE:

1st FLOOR PLAN

PRINT DATE: November 28, 2016

A1.1.1

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FULL HEIGHT 2X4 WOOD STUD PARTITION

FULL HEIGHT 2X6 WOOD STUD PARTITION

STUD WALL BELOW HEIGHT AND STUD SIZE AS NOTED BRICK / STONE VENEER

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KEY NOTES FOR NORTH CAROLINA:

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- HIRE PROTECTION:

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 [3] BENEATH CALLER AND LANDINGE, (2")" GYPSUM BOARD.
- BENEATH STAIRS AND LANDINGS, I/2" GYPSUM BOARD ON WALLS AND CEILING OF ENCLOSED ACCESSIBLE AREAS. (PER NORC SECTION R302.1) IN CONCEALED SPACES BETWEEN STAIR STRINGERS PROVIDE FIREBLOCKING PER R302.I.
- GAS WATER HEATER ON 18" HIGH PLATFORM. (PER CHAPTER 5 NCRC-PLUMBING)
- 5 FAU 8'XI2' PLATFORM. VERIFY WITH TRUSS MANUFACTURER.
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 ATTIC ACCESS LADDER, VERIFY LOCATION AND SIZE WITH TRUSSES. (25 1/2' x 54" SIZE.)

TYPICALS:

- TEMPERED SAFETY GLASS. (PER NCRC SECTION 308.4)
- O PLYWOOD SHELF ABOVE WITH DRYWALL FINISH OVER, HEIGHT AS NOTED.
- II HALF WALL, HEIGHT AS NOTED.
- BATHS:
- [3] SHOWER. TEMPERED GLASS ENCLOSURE.
- [14] TUB-SHOWER COMBO. TEMPERED GLASS ENCLOSURE.
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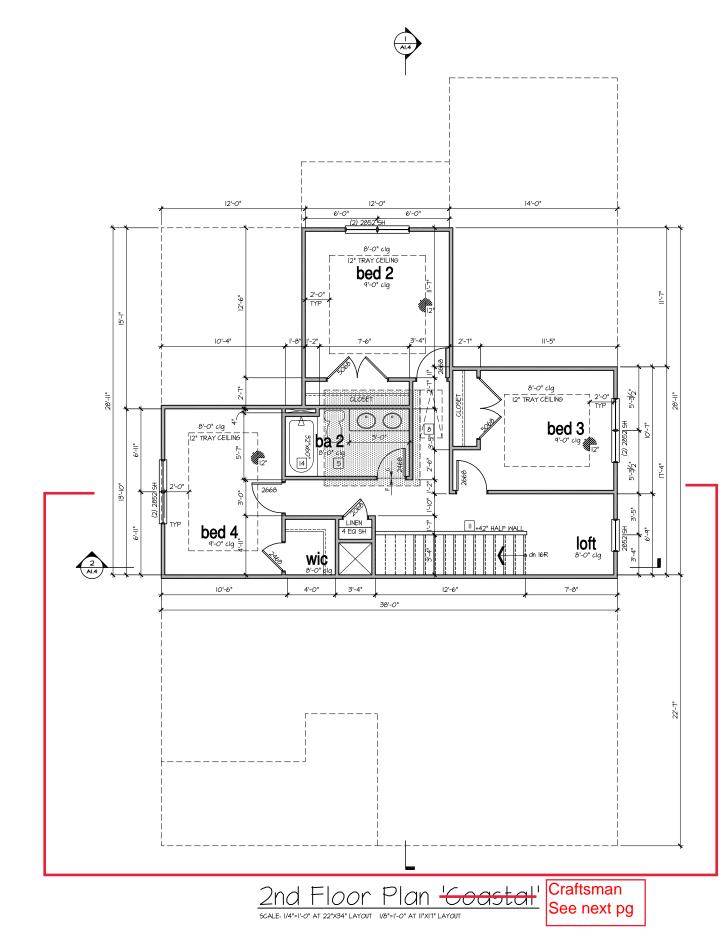
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17 RISERS AT +/- 1.26" = 123 3/4" TOTAL
RISE VERIFY

'THE WINSTON' - COASTAL SF		
AREA	ELEV	
Ist FLOOR	1492 SF	
2nd FLOOR	733 SF	
TOTAL LIVING	2225 SF	
GARAGE	436 SF	
PORCH	150 SF	
COVERED PATIO	120 SF	





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PROFESSIONAL SEAL:

PROJECT TITLE:

The Winston

FOR CONSTRUCTION



13036RAL

2nd FLOOR PLAN

November 28, 2016

A1.2

FOR ADDITIONAL NOTES SEE GENERAL NOTES ON TITLE SHEET AND DETAILS. - MINDOM HEAD HEIGHTS: IST FLOOR = 7'-8' UN.O. ON ELEVATIONS. 2ND FLOOR = 6'-10" U.N.O. ON ELEVATIONS. ALL DIMENSIONS TO WINDOWS AND DOORS ARE TO CENTERLINE.

WALL LEGEND:

FULL HEIGHT 2X4 WOOD STUD PARTITION

FULL HEIGHT 2X6 WOOD STUD PARTITION

VIIIIIIIIII BRICK / STONE VENEER

STUD WALL BELOW HEIGHT AND STUD SIZE AS NOTED

LOW GYPSUM BOARD WALL HEIGHT AND STUD SIZE AS NOTED

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KEY NOTES FOR NORTH CAROLINA:

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TYPICALS:


- TEMPERED SAFETY GLASS. (PER NCRC SECTION 308.4)
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9'-1" STAIR NOTE: (USE 14" TJI WITH 3/4" PLYMOOD SUBFLOOR) 16 TREADS AT 10" EACH VERIFY 17 RISERS AT 4/- 1.28" = 123 3/4" TOTAL RISE VERIFY

'THE WINSTON' - CRAF	TSMAN SF
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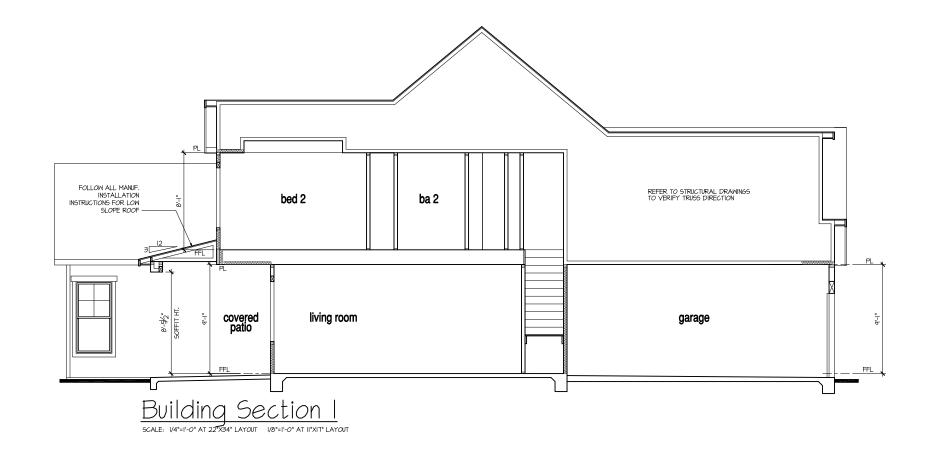
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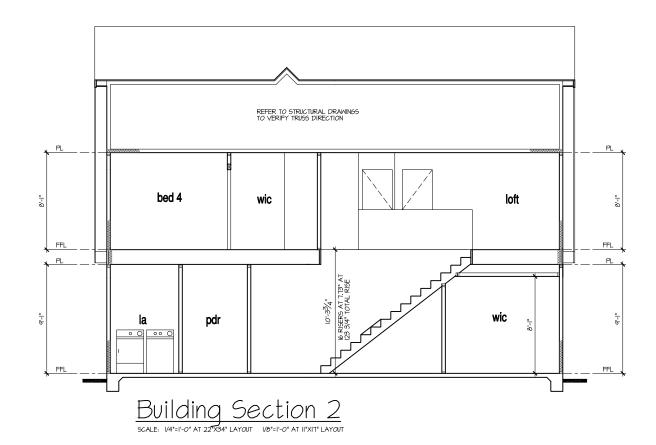
2nd FLOOR PLAN

PRINT DATE:

November 28, 2016

A1.2.1

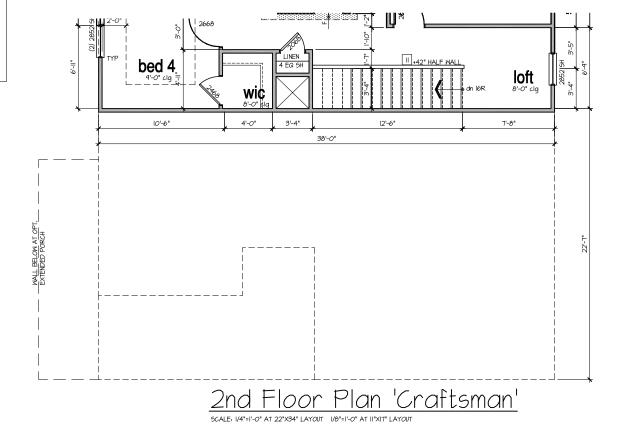





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CLIENTS NAME:



PROJECT NO:

BUILDING SECTIONS

PRINT DATE:

November 28, 2016

A1.4



- REFER TO FLOOR PLAN NOTES FOR TYPICAL FIRE PROTECTION NOTES AND LOCATIONS.
- REFER TO FLOOR PLAN NOTES FOR TYPICAL FIRE PROTECTION NOTES AND LOCATIONS.

 THESE BUILDING SECTIONS MAY VARY AT ALTERNATE ELEVATION STYLES AND AT *PLAN OPTION*
 CONDITIONS. REFER TO MAIN FLOOR PLAN AND ALTERNATE FLOOR PLANS FOR INFORMATION NOT SHOWN HERE.

 BUILDING SECTIONS SHOWN HERE DEPICT VOLUMS SPACES WITHIN THE STRUCTURE. REFER TO STRUCTURAL
 DRAWINGS, TRUSS DRAWINGS, STRUCTURAL DETAILS AND CALCULATIONS BY OTHER FOR ALL STRUCTURAL INFO.

 ROOFING: PITCHED SHINGLE ROOF, REFER TO ROOF PLAN FOR TYPICALS.


- WOOD FLOORS: FLOOR SHEATHING OVER FLOOR JOIST. REFER TO STRUCTURAL AND TRUGS DRAWINGS BY OTHERS.
- VERIFY STAIRS MINIMUM AND MAXIMUM REQUIREMENTS FOR CONSTRUCTION CLEARANCES WITH LOCAL CODES.

INSULATION:
EXTERIOR WALLS ZONE 3:
EXTERIOR WALLS ZONE 4:
R-I3 BATTS MINIMUM, VERIFY
R-I5 BATTS MINIMUM, VERIFY

CEILING WITH ATTIC ABOVE COMPRESSED INSULATION:
R-30 BATTS MINIMUM, VERIFY
CEILING WITH ATTIC ABOVE UNCOMPRESSED INSULATION (HEELS IN TRUSSES).
R-30 BATTS MINIMUM, VERIFY

FLOOR OVER GARAGE: R-I9 BATTS MINIMUM. VERIFY R-I9 BATTS MINIMUM. VERIFY ATTIC KNEEWALL:

PER STATE RESIDENTIAL CODE COMPLIANCE METHOD TO BE DETERMINED BY BUILDER.

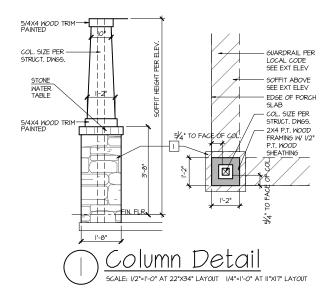

SLOPED SOFFIT SMOOTH PANELSIDING

2040 SH — (OBSCURED)

9-

DORMER DETAIL



- GRADE CONDITIONS MAY VARY FOR INDIVIDUAL SITE FROM THAT SHOWN,
 BUILDER SHALL VERIFY AND COORDINATE PER ACTUAL SITE CONDITIONS.
- WINDOW HEAD HEIGHTS: IST FLOOR = 7'-8" U.N.O. ON ELEVATIONS. 2ND FLOOR = 6'-IO" U.N.O. ON ELEVATIONS.
- ROOFING: PITCHED SHINGLES PER DEVELOPER.
- WINDOWS: MANUFACTURER PER DEVELOPER. DIVIDED LITES AS SHOWN ON THE EXTERIOR ELEVATIONS
- ENTRY DOOR: AS SELECTED BY DEVELOPER.
- GARAGE DOORS: AS SELECTED BY DEVELOPER, RAISED PANEL AS SHOWN.
- CHIMNEY AS OCCURS: TOP OF CHIMNEYS TO BE A MINIMUM OF 24" ABOVE ANY ROOF WITHIN 10'-0" OF CHIMNEY.
- ALL EXTERIOR MATERIALS TO BE INSTALLED PER MANUFACTURER'S WRITTEN INSTRUCTIONS.
- PROTECTION AGAINST DECAY: PER NCRC R3IT.I
 (ALL PORTIONS OF A PORCH, SCREEN PORCH OR DECK FROM THE BOTTOM OF
 THE HEADER DOWN, INCLUDING POST, RAILS, PICKETS, STEPS AND FLOOR STRUCTURE.)

KEY NOTES:


MASONRY:

- ADHERED STONE VENEER AS SELECTED BY DEVELOPER. HEIGHT AS NOTED.
- 2 MASONRY FULL BRICK AS SELECTED BY DEVELOPER, HEIGHT AS NOTED.
- 3 MASONRY FULL STONE AS SELECTED BY DEVELOPER, HEIGHT AS NOTED.
- 4 8" SOLDIER COURSE.
- 5 ROWLOCK COURSE 6 DECORATIVE KEY, SEE DETAIL.
- TYPICALS: 7 CORROSION RESISTANT SCREEN LOUVERED VENTS, SIZE AS NOTED.
- 8 CODE APPROVED TERMINATION CHIMNEY CAP.
- CORROSION RESISTANT ROOF TO WALL FLASHING. CODE COMPLIANT FLASHING MIST BE INSTALLED AT ALL ROOF/WALL INTERSECTIONS. (SIDE WALL-STEP FLASHING IS REQUIRED IN NC R405.2.8.3)
- O STANDING SEAM METAL ROOF, INSTALL PER MANUFCATURER'S WRITTEN INSTRUCTIONS.
- III DECORATIVE WROUGHT IRON, SEE DETAILS.

- 12 FIBER CEMENT SHAKE SIDING PER DEVELOPER
- W 5/4x4 CORNER TRIM BOARDS OR VINYL EQUIVALENT W VINYL CORNER TRIM.

 3 FIBER CEMENT LAP SIDING PER DEVELOPER
 W 5/4x4 CORNER TRIM BOARDS OR VINYL EQUIVALENT W VINYL CORNER TRIM.

- [5] FIBER CEMENT PANEL SIDING W IX3 BATTS AT 12" O.C. (VINYL BOARD AND BATT SIDING) 16 5/4X FIBER CEMENT TRIM OR 5/4X WOOD TRIM W VINYL CAP OR COIL STOCK, SIZE AS NOTED
- (SIZES SHOWN ARE NOMINAL WIDTHS)
- FALSE WOOD SHUTTERS, TYPE AS SHOWN. SIZE AS NOTED.
- 18 IX6 FIBER CEMENT BOARD FACIA OVER 2X4 SUB-FACIA
- OR 2X6 FACIA W VINYL CAP OR COIL STOCK.
- ALL MINDOWS WHOSE OPENING IS LESS THAN 24" ABOVE THE FINISH FLOOR AND WHOSE OPENING IS GREATER THAN 12" ABOVE THE OVISIDE MALKING SURFACE MUST HAVE MINDOWN OPENING LIMITING DEVICES COMPLYING MITH THE 2012 NCRC SECTION R612.3 AND 612.4.

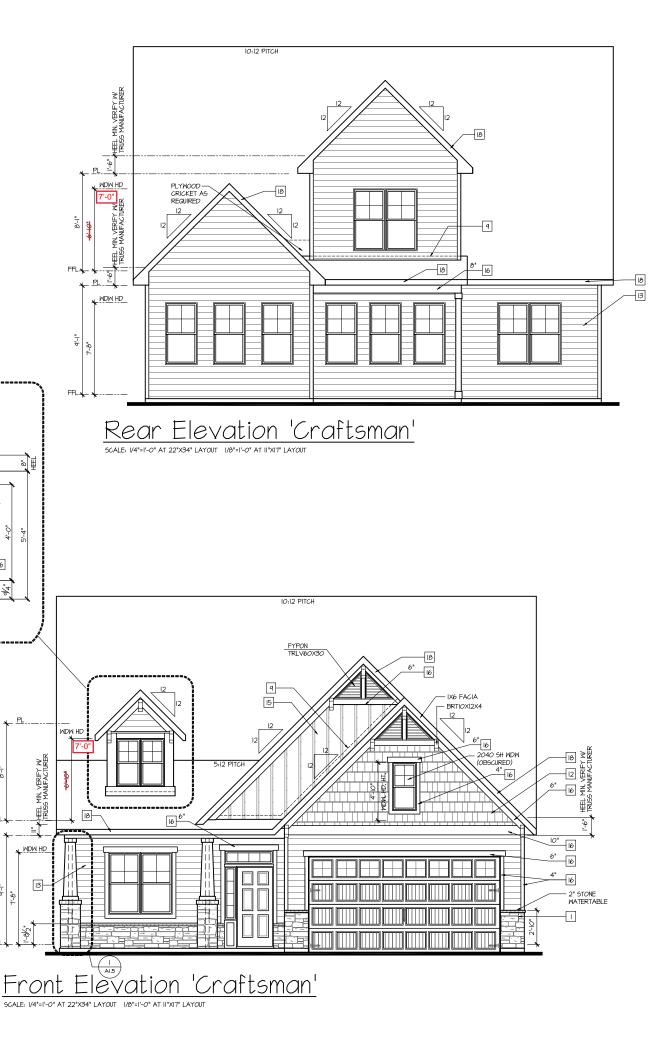



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PROJECT TITLE:

The Winston

FOR CONSTRUCTION

CLIENTS NAME



CRAFTSMAN

EXTERIOR ELEVATIONS

November 28, 2016

A1.7.0

<u>_eft Elevation 'Craftsman'</u>

SCALE: I/4"=I'-0" AT 22"X34" LAYOUT I/8"=I'-0" AT II"XI7" LAYOUT



Right Elevation 'Craftsman' scale: 174°=11-0° at 22°x34° LAYOUT 1/8°=11-0° at 11°x11° LAYOUT

NOTES:

- GRADE CONDITIONS MAY VARY FOR INDIVIDUAL SITE FROM THAT SHOWN,
 BUILDER SHALL VERIFY AND COORDINATE PER ACTUAL SITE CONDITIONS.
- WINDOW HEAD HEIGHTS: IST FLOOR = 7'-8" U.N.O. ON ELEVATIONS.
- 2ND FLOOR = 6'-IO" U.N.O. ON ELEVATIONS. ROOFING: PITCHED SHINGLES PER DEVELOPER.
- WINDOWS: MANUFACTURER PER DEVELOPER. DIVIDED LITES AS SHOWN ON THE EXTERIOR ELEVATIONS
- ENTRY DOOR: AS SELECTED BY DEVELOPER.
- GARAGE DOORS: AS SELECTED BY DEVELOPER, RAISED PANEL AS SHOWN.
- CHIMNEY AS OCCURS: TOP OF CHIMNEYS TO BE A MINIMUM OF 24" ABOVE ANY ROOF WITHIN 10'-0" OF CHIMNEY.
- ALL EXTERIOR MATERIALS TO BE INSTALLED PER MANUFACTURER'S WRITTEN INSTRUCTIONS.
- PROTECTION AGAINST DECAY: PER NCRC R3IT.I
 (ALL PORTIONS OF A PORCH, SCREEN PORCH OR DECK FROM THE BOTTOM OF
 THE HEADER DOWN, INCLUDING POST, RAILS, PICKETS, STEPS AND FLOOR STRUCTURE.)

KEY NOTES:

MASONRY:

- ADHERED STONE VENEER AS SELECTED BY DEVELOPER, HEIGHT AS NOTED.
- 2 MASONRY FULL BRICK AS SELECTED BY DEVELOPER. HEIGHT AS NOTED.
- 3 MASONRY FULL STONE AS SELECTED BY DEVELOPER. HEIGHT AS NOTED.
- 4 8" SOLDIER COURSE.
- 5 ROWLOCK COURSE 6 DECORATIVE KEY, SEE DETAIL.
- TYPICALS:
- OCRROSION RESISTANT SCREEN LOUVERED VENTS, SIZE AS NOTED. 8 CODE APPROVED TERMINATION CHIMNEY CAP.
- CORROSION RESISTANT ROOF TO MALL FLASHING, CODE COMPLIANT FLASHING MIST BE INSTALLED AT ALL ROOF/MALL INTERSECTIONS.
 (SIDE WALL-STEP FLASHING IS REQUIRED IN NC R405.2.8.3)
- O STANDING SEAM METAL ROOF, INSTALL PER MANUFCATURER'S WRITTEN INSTRUCTIONS. II DECORATIVE WROUGHT IRON. SEE DETAILS.
- SIDING:
- 12 FIBER CEMENT SHAKE SIDING PER DEVELOPER
- W 5/4x4 CORNER TRIM BOARDS OR VINYL EQUIVALENT W VINYL CORNER TRIM.

 3 FIBER CEMENT LAP SIDING PER DEVELOPER
 W 5/4x4 CORNER TRIM BOARDS OR VINYL EQUIVALENT W VINYL CORNER TRIM.
- [5] FIBER CEMENT PANEL SIDING W IX3 BATTS AT 12" O.C. (VINYL BOARD AND BATT SIDING)
- 6 5/4X FIBER CEMENT TRIM OR 5/4X WOOD TRIM W VINYL CAP OR COIL STOCK, SIZE AS NOTED
- (SIZES SHOWN ARE NOMINAL WIDTHS) FALSE WOOD SHUTTERS, TYPE AS SHOWN. SIZE AS NOTED.
- (6) IX6 FIBER CEMENT BOARD FACIA OVER 2X4 SUB-FACIA
- OR 2X6 FACIA W VINYL CAP OR COIL STOCK.
- ALL MINDOWS WHOSE OPENING IS LESS THAN 24" ABOVE THE FINISH FLOOR AND WHOSE OPENING IS GREATER THAN 12" ABOVE THE PINISH SHALKING SURFACE MIST HAVE WINDOWN OPENING LIMITING DEVICES COMPLYING MITH THE 2012 NCRC SECTION R612.3 AND 612.4.



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PROJECT NO:

SHEET TITLE: **CRAFTSMAN EXTERIOR**

ELEVATIONS

PRINT DATE:

November 28, 2016

A1.7.1

N.C ATTIC VENT CALC. FOR WINSTON 'CRAFTSMAN': 1:150 RATIO.

THE NET FREE VENTILATING AREA SHALL NOT BE LESS THAN I/150 OF THE AREA OF THE SPACE VENTILATED, PROVIDED THAT AT LEAST 50 PERCENT AND NOT MORE THAN 80 PERCENT OF THE REQUIRED VENTILATING AREA IS PROVIDED BY VENTILATORS LOCATED IN THE UPPER PORTION OF THE SPACE TO BE VENTILATED AT LEAST 3 FEET ABOVE THE EAVE OR ORNICE VENTS WITH THE BALANCE OF THE REQUIRED VENTILATION PROVIDED BY EAVE OR CORNICE VENTS.

EXCEPTIONS:

EXCEPTIONS:

EXCLOSED ATTIC/RAFTER SPACES REQUIRING LESS THAN

I SQ FT OF VENTILATION MAY BE VENTED WITH CONTINUOUS

SOFFIT VENTILATION ONLY.

2. ENCLOSED ATTIC/RAFTER SPACES OVER UNCONDITIONED SPACE MAY BE VENTED WITH CONTINUOUS SOFFIT VENT ONLY

GENERAL CONTRACTOR SHALL VERIFY THE NET FREE VENTILATION OF THE VENT PRODUCT SELECTED BY OWNER. VERIFY WITH MANUFACTURER OF HIGH AND LOW VENTS TO BE USED FOR MINIMUM CALCULATED VENTS REQUIRED, THE REQUIRED VENTILATION SHALL BE MAINTAINED. PROVIDE INSULATION STOP SUCH THAT INSULATION DOES NOT OBSTRUCT FREE AIR MOVEMENT AS REQUIRED BY THE BILL DIMA CASELOR. BY THE BUILDING OFFICIAL.

BY THE BUILDING OFFICIAL.
ALL OVERLIAPS FRAMED ROOF AREAS SHALL HAVE
OPENINGS BETWEEN THE ADJACENT ATTICS IN THE ROOF
SHEATHING AS ALLOWED BY THE STRUCTURAL ENGINEER)
TO ALLOW PASSAGE AND ATTIC VENTILATION
BETWEEN THE TWO OR ISOLATED ATTIC SPACES SHALL
BE VENTED INDEPENDENTLY TO CBC REQUIREMENTS.

PER DEVELOPER, AT ALL CANTILEVERED FLOORS, CANTILEVERED ARCHITECTURAL POP-OUTS, AND ANY DOUBLE FRAMING PRO-JECTIONS THAT ARE SEPARATED FROM THE VENTING CALCULATIONS SHOWN ABOVE, PROVIDE A CONTINUOUS 2º CORROSION RESISTANT SOFFIT VENT AT UNDERSIDE OF FRAMED ELEMENT.

(PER 2012 NCRC SECTION R806.2)

I SQUARE INCH VENT FOR EVERY 150 SQUARE INCHES OF CEILING *144 SQ. IN. = 1 SQ. FT. BLDG. CEILING (SF) X 144 = BLDG (SQ. IN.)

BLDG. (5Q. IN.) / I5O = 5Q. IN. OF VENT REQUIRED SQ. IN. OF VENT REQUIRED / 2 = 50% AT HIGH & 50% AT LOW.

ROOF AREA I: = 2200 SF

2200 SQ. FT. X 144 = 316800 SQ. IN. 316800 SQ. IN. / 150 = 2112 SQ. IN. OF VENT REQ'D 2112 SQ. IN. / 2 = 1056 SQ. IN

1056 SQ. IN. OF VENT AT HIGH & 1056 SQ. IN. OF VENT AT LOW REQUIRED.

ROOF AREA 2: = 249 SF

249 SQ. FT. X 144 = 35856 SQ. IN. 35856 SQ. IN. / 150 = 239.04 SQ. IN. OF VENT REQ'D 239.04 SQ. IN. / 2 = 119.52 SQ. IN

119.52 SQ. IN. OF VENT AT HIGH & 119.52 SQ. IN. OF VENT AT LOW REQUIRED.

118 SQ. FT. X 144 = 16992 SQ. IN. 16992 SQ, IN, / 150 = 113,28 SQ, IN, OF VENT REQ'D

113.28 SQ. IN. / 2 = 56.64 SQ. IN

56.64 SQ. IN. OF VENT AT HIGH & 56.64 SQ. IN. OF VENT AT LOW REQUIRED.

NOTES:

- ALL ROOF DRAINAGE SHALL BE PIPED TO STREET OR APPROVED DRAINAGE FACILITY.

- DASHED LINES INDICATE WALL BELOW.

LOCATE GUTTER AND DOWNSPOUTS PER BUILDER.

- PITCHED ROOFS AS NOTED

- TRUSS MANUFACTURER SHALL SUBMIT STRUCTURAL CALCS AND SHOP DRAWINGS TO THE BUILDER'S GENERAL CONTRACTOR AND BUILDING DEPARTMENT FOR REVIEW PRIOR TO FABRICATIONS.

- ALL PLUMBING VENTS SHALL BE COMBINED INTO A MINIMUM AMOUNT OF ROOF PENETRATIONS, ALL ROOF PENETRATIONS SHALL OCCUR TO THE REAR OF THE MAIN RIDGE.

N.C. ATTIC VENT CALC. FOR WINSTON 'CRAFTSMAN': 1:300 RATIC

AS AN ALTERNATE TO THE 1/150 RATIO LISTED ABOVE, THE NET FREE CROSS-VENTILATION AREA MAY BE REDUCED TO 1/300 WHEN A CLASS I OR II VAPOR RETARDER IS INSTALLEI ON THE WARM - IN - WINTER SIDE OF THE CELLING.

GENERAL CONTRACTOR SHALL VERIEY THE NET FREE GENERAL CONTRACTOR SHALL VERIET THE NET FREE VENTLATION OF THE VENT PRODUCT SELECTED BY OWNER. VERIETY WITH MANUFACTURER OF HIGH AND LOM VENTS TO BE USED FOR MINIMUM CALCULATED VENTS REQUIRED. THE REQUIRED VENTLATION SHALL BE MAINTAINED. PROVIDE INSULATION STOP SICH THAT INSULATION DOES NOT OBSTRUCT FREE AIR MOVEMENT AS REQUIRED BY THE BUILDING OFFICIAL.

OF THE BUILDING OFFICIAL.
ALL OVERLAP FRAMED ROOF AREAS SHALL HAVE
OPENINGS BETWEEN THE ADJACENT ATTICS IN THE ROOF
SHEATHING IGS ALLOWED BY THE STRUCTURAL ENGINEER)
TO ALLOW PASSAGE AND ATTIC VENTILATION
BETWEEN THE TWO OR BOLATED ATTIC SPACES SHALL
BE VENTED INDEPENDENTLY TO GBC REQUIREMENTS.

PER DEVELOPER, AT ALL CANTILEVERED FLOORS, CANTILEVERED ARCHITECTURAL POP-OUTS, AND ANY DOUBLE PRAMING PROJECTIONS THAT ARE SEPARATED FROM THE VENTING CALCULATIONS SHOWN ABOVE, PROVIDE A CONTINUIS 2° CORRESION RESISTANT SOFFIT VENT AT UNDERSIDE OF FRAMED ELEMENT.

(PER 2012 NCRC SECTION R806.2)

I SQUARE INCH VENT FOR EVERY 300 SQUARE INCHES OF CEILING *144 SQ. IN. = 1 SQ. FT. BLDG. CEILING (SF) X 144 = BLDG (SQ. IN.) BLDG. (SQ. IN.) / 300 = SQ. IN. OF VENT REQUIRED SQ. IN. OF VENT REQUIRED / 2 = 50% AT HIGH & 50% AT LOW.

ROOF AREA I: = 2200 SF

2200 SQ FT X 144 = 316800 SQ IN 316800 SQ. IN. / 300 = 1056 SQ. IN. OF VENT REQ'D 1056 SQ. IN. / 2 = 528 SQ. IN

528 SQ. IN. OF VENT AT HIGH & 528 SQ. IN. OF VENT AT LOW REQUIRED.

ROOF AREA 2: = 249 SF

249 SQ, FT, X 144 = 35856 SQ, IN, 35856 SQ, IN, / 300 = 119,52 SQ, IN, OF VENT REQ'D 119,52 SQ, IN, / 2 = 59,76 SQ, IN


59.76 SQ. IN. OF VENT AT HIGH & 59.76 SQ. IN. OF VENT AT LOW REQUIRED.

ROOF AREA 3. = 118 SE

| 18 50. Ft. x | 44 = 16992 50. | N. | 16992 50. | N. | 700 = 56.64 50. | N. | 700 = 56.64 50. | N. | 700 | 700 |

28.32 SQ. IN. OF VENT AT HIGH \$ 28.32 SQ. IN. OF VENT AT LOW REQUIRED.

AT SINGLE FAMILY DETACHED PLANS: PREFINISHED VENTED SOFFIT AT EAVE PER MANUFACTURER. (VERITY FIRE SEPARATION DISTANCE FOR SOFFIT PROTECTION PER 2012 NCRC SECTION R703.11.3 AND TABLE R302.1)

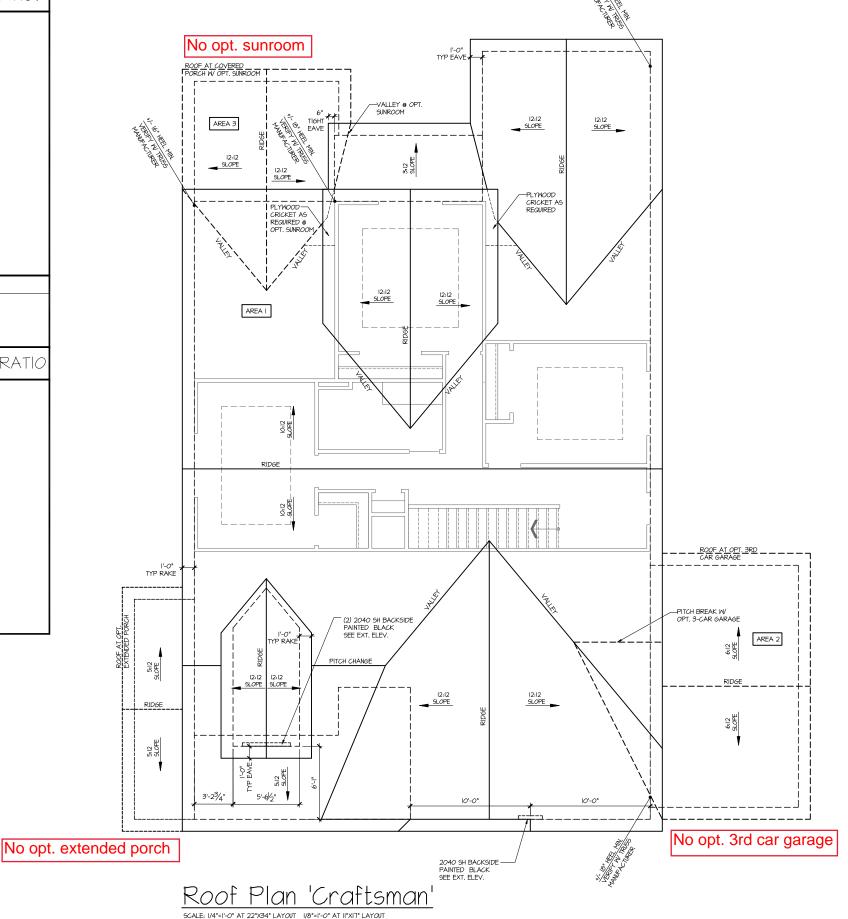



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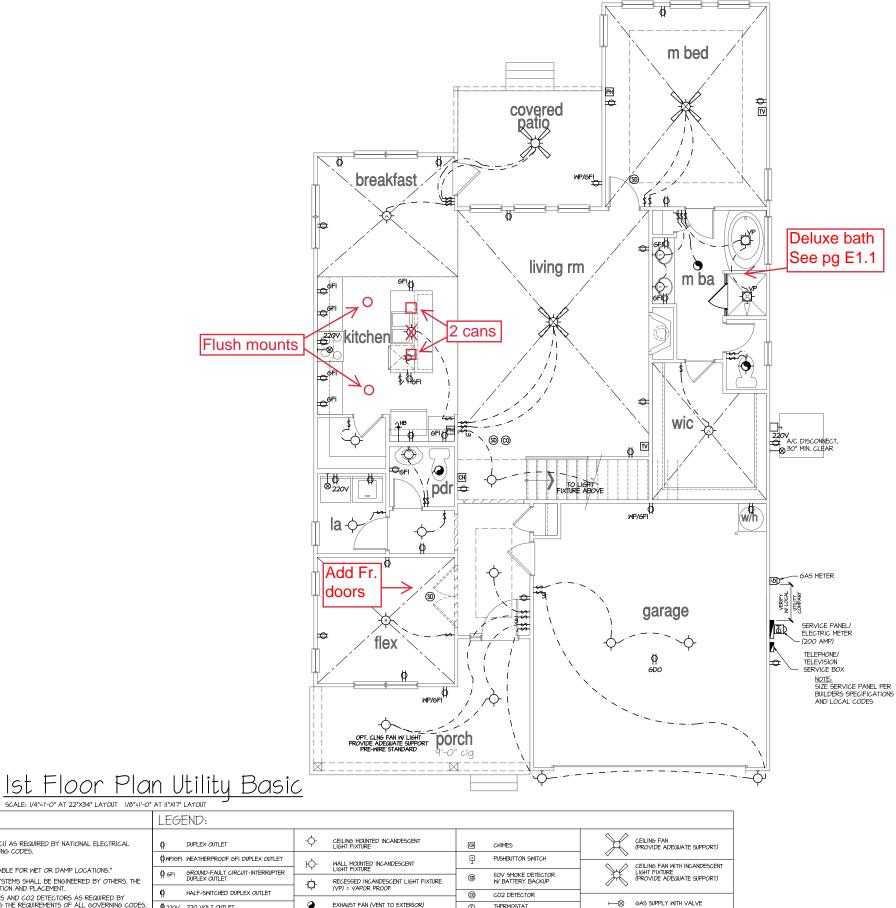
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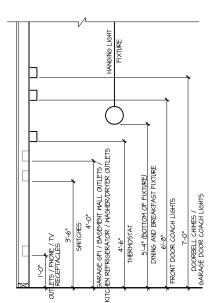


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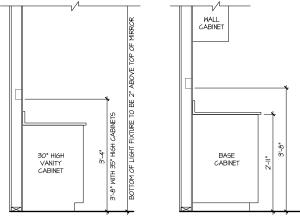
CRAFTSMAN ROOF PLAN

November 28, 2016






STANDARD ELECTRICAL BOX HEIGHTS



SWITCH AND RECEPTACLE BOXES OVER BATH CABINETS SWITCH AND RECEPTACLE BOXES OVER KITCHEN CABINETS

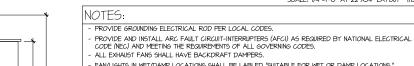

FAN/LIGHTS IN WET/DAMP LOCATIONS SHALL BE LABLED "SUITABLE FOR WET OR DAMP LOCATIONS."

- ELECTRICAL SYSTEMS ARE SHOWN FOR INTENT ONLY, THESE SYSTEMS SHALL BE ENGINEERED BY OTHERS. THE CONTRACTOR SHALL BE RESPONSIBLE FOR PROPER INSTALLATION AND PLACEMENT.

- PROVIDE AND INSTALL LOCALLY CERTIFIED SHOKE DETECTORS AND CO2 DETECTORS AS REQUIRED BY NATIONAL FIRE PROTECTION ASSOCIATION (NFPA) AND MEETING THE REQUIREMENTS OF ALL GOVERNING CODES.

- PROVIDE AND INSTALL GROUND FAULT CIRCUIT-INTERRIPTERS (GFI) AS REQUIRED BY NATIONAL ELECTRICAL CODE (NEC) AND MEETING THE REQUIREMENTS OF ALL GOVERNING CODES.

ELECTRICAL CONTRACTOR TO PROVIDE REQUIRED DIRECT HOOK-UPS/CUTOFFS.

HVAC CONTRACTOR TO VERIFY THERMOSTAT LOCATIONS.

PROVIDE GROUNDING ELECTRICAL ROD PER LOCAL CODES.

ALL EXHAUST FANS SHALL HAVE BACKDRAFT DAMPERS.

- ALL ELECTRICAL AND MECHANICAL EQUIPMENT (FURNACES, A/C UNITS, ELECTRICAL PANELS, SANITARY SUMP PI' DRAIN TILE SWMP, AND MATER HEATERS) ARE SUBJECT TO RELOCATION DUE TO FIELD CONDITIONS. PROVIDE POWER, LIGHT AND SMITCH AS REQUIRED FOR ATTIC FURNACE PER CODE AND MANUFACTURER'S WRITTEN INSTRUCTIONS.

ØWP/GFI WEATHERPROOF GFI DUPLEX OUTLET GFOUND-FAULT CIRCUIT-INTERRUPTER DUPLEX OUTLET EXHAUST FAN (VENT TO EXTERIOR) 220V 220 VOLT OUTLET PH TELEPHONE REINFORCED JUNCTION BOX —→ HOSE BIBB EXHAUST FAN/LIGHT COMBINATION (VENT TO EXTERIOR) TELEVISION \$ WALL SWITCH CM 1/4" WATER STUB OUT ☐ ELECTRIC METER FLUORESCENT LIGHT FIXTURE \$3 THREE-WAY SWITCH ELECTRIC PANEL WALL SCONCE \$4 FOUR-WAY SWITCH TECH HUB SYSTEM DISCONNECT SWITCH



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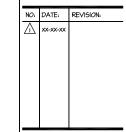
1st FLOOR **UTILITY PLAN**

PRINT DATE: November 28, 2016

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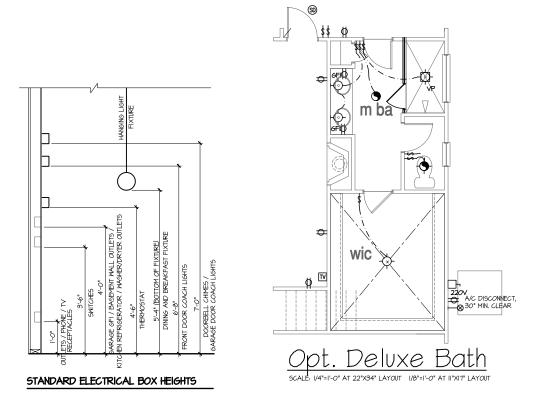





1st FLOOR **UTILITY PLAN**

November 28, 2016

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SWITCH AND RECEPTACLE BOXES OVER BATH CABINETS SWITCH AND RECEPTACLE BOXES OVER KITCHEN CABINETS

NOTES: PROVIDE GROUNDING ELECTRICAL ROD PER LOCAL CODES PROVIDE MODIFIANT ACE FAULT CIRCUIT-INTERRIPTERS (AFCI) AS REQUIRED BY NATIONAL ELECTRICAL CODE (NEC) AND MEETING THE REQUIREMENTS OF ALL GOVERNING CODES. ALL EXHAUST FANS SHALL HAVE BACKDRAFT DAMPERS. FAN/LIGHTS IN WET/DAMP LOCATIONS SHALL BE LABLED "SUITABLE FOR WET OR DAMP LOCATIONS." - ELECTRICAL SYSTEMS ARE SHOWN FOR INTENT ONLY, THESE SYSTEMS SHALL BE ENGINEERED BY OTHERS. THE CONTRACTOR SHALL BE RESPONSIBLE FOR PROPER INSTALLATION AND PLACEMENT.

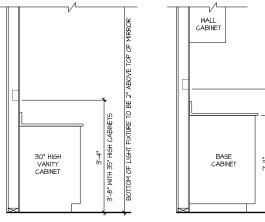- PROVIDE AND INSTALL LOCALLY CERTIFIED SHOKE DETECTORS AND CO2 DETECTORS AS REQUIRED BY NATIONAL FIRE PROTECTION ASSOCIATION (MFPA) AND MEETING THE REQUIREMENTS OF ALL GOVERNING CODES.

- PROVIDE AND INSTALL GROUND FAULT CIRCUIT-INTERRIPTERS (GFI) AS REQUIRED BY NATIONAL ELECTRICAL CODE (NEC) AND MEETING THE REQUIREMENTS OF ALL GOVERNING CODES. ELECTRICAL CONTRACTOR TO PROVIDE REQUIRED DIRECT HOOK-UPS/CUTOFFS. HVAC CONTRACTOR TO VERIFY THERMOSTAT LOCATIONS. - ALL ELECTRICAL AND MECHANICAL EQUIPMENT (FURNACES, A/C UNITS, ELECTRICAL PANELS, SANITARY SUMP PIT DRAIN TILE SUMP, AND MATER HEATERS) ARE SUBJECT TO RELOCATION DUE TO FIELD CONDITIONS.

WP/GFI WEATHERPROOF GFI DUPLEX OUTLET GROUND-FAULT CIRCUIT-INTERRUPTER DUPLEX OUTLET

220V 220 VOLT OUTLET \$3

REINFORCED JUNCTION BOX

LEGEND:

DUPLEX OUTLET

HALF-SWITCHED DUPLEX OUTLET

EXHAUST FAN/LIGHT COMBINATION (VENT TO EXTERIOR) FLUORESCENT LIGHT FIXTURE

Ю-

WALL MOUNTED INCANDESCENT LIGHT FIXTURE

RECESSED INCANDESCENT LIGHT FIXTURE (VP) = VAPOR PROOF

EXHAUST FAN (VENT TO EXTERIOR)

THREE-WAY SWITCH

\$ WALL SWITCH \$4 FOUR-WAY SWITCH

PROVIDE POWER, LIGHT AND SMITCH AS REQUIRED FOR ATTIC FURNACE PER CODE AND MANUFACTURER'S WRITTEN INSTRUCTIONS.

-+CM 1/4" WATER STUB OUT ☐ ELECTRIC METER ELECTRIC PANEL WALL SCONCE TECH HUB SYSTEM DISCONNECT SWITCH

PH TELEPHONE

CHIMES

PUSHBUTTON SWITCH

(9) IIOV SMOKE DETECTOR W BATTERY BACKUP

CO2 DETECTOR


TELEVISION

CEILING FAN (PROVIDE ADEQUATE SUPPORT)


CEILING FAN WITH INCANDESCENT LIGHT FIXTURE (PROVIDE ADEQUATE SUPPORT)

----- GAS SUPPLY WITH VALVE

—→ HOSE BIBB

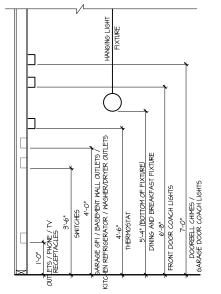


STANDARD ELECTRICAL BOX HEIGHTS

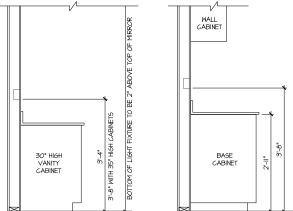

SWITCH AND RECEPTACLE BOXES OVER BATH CABINETS

SWITCH AND RECEPTACLE BOXES OVER KITCHEN CABINETS

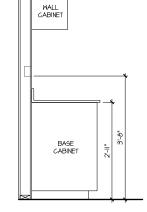

NOTES:

PROVIDE GROUNDING ELECTRICAL ROD PER LOCAL CODES.

PROVIDE MODIFIANT ACE FAULT CIRCUIT-INTERRIPTERS (AFCI) AS REQUIRED BY NATIONAL ELECTRICAL CODE (NEC) AND MEETING THE REQUIREMENTS OF ALL GOVERNING CODES. ALL EXHAUST FANS SHALL HAVE BACKDRAFT DAMPERS. FAN/LIGHTS IN WET/DAMP LOCATIONS SHALL BE LABLED "SUITABLE FOR WET OR DAMP LOCATIONS." - ELECTRICAL SYSTEMS ARE SHOWN FOR INTENT ONLY, THESE SYSTEMS SHALL BE ENGINEERED BY OTHERS. THE CONTRACTOR SHALL BE RESPONSIBLE FOR PROPER INSTALLATION AND PLACEMENT.

- PROVIDE AND INSTALL LOCALLY CERTIFIED SHOKE DETECTORS AND CO2 DETECTORS AS REQUIRED BY NATIONAL FIRE PROTECTION ASSOCIATION (NFPA) AND MEETING THE REQUIREMENTS OF ALL GOVERNING CODES.

- PROVIDE AND INSTALL GROUND FAULT CIRCUIT-INTERRIPTERS (GFI) AS REQUIRED BY NATIONAL ELECTRICAL CODE (NEC) AND MEETING THE REQUIREMENTS OF ALL GOVERNING CODES. ELECTRICAL CONTRACTOR TO PROVIDE REQUIRED DIRECT HOOK-UPS/CUTOFFS.

HVAC CONTRACTOR TO VERIFY THERMOSTAT LOCATIONS. - ALL ELECTRICAL AND MECHANICAL EQUIPMENT (FURNACES, A/C UNITS, ELECTRICAL PANELS, SANITARY SUMP PIT DRAIN TILE SUMP, AND MATER HEATERS) ARE SUBJECT TO RELOCATION DUE TO FIELD CONDITIONS. PROVIDE POWER, LIGHT AND SMITCH AS REQUIRED FOR ATTIC FURNACE PER CODE AND MANUFACTURER'S WRITTEN INSTRUCTIONS.

2nd Floor Plan Utility Basic LEGEND: CEILING FAN (PROVIDE ADEQUATE SUPPORT) DUPLEX OUTLET CHIMES ØWP/GFI WEATHERPROOF GFI DUPLEX OUTLET PUSHBUTTON SWITCH Ю-WALL MOUNTED INCANDESCENT LIGHT FIXTURE CEILING FAN WITH INCANDESCENT LIGHT FIXTURE (PROVIDE ADEQUATE SUPPORT) GROUND-FAULT CIRCUIT-INTERRUPTER DUPLEX OUTLET IIOV SMOKE DETECTOR
W BATTERY BACKUP RECESSED INCANDESCENT LIGHT FIXTURE (VP) = VAPOR PROOF HALF-SWITCHED DUPLEX OUTLET CO2 DETECTOR ----- GAS SUPPLY WITH VALVE EXHAUST FAN (VENT TO EXTERIOR) 220V 220 VOLT OUTLET PH TELEPHONE REINFORCED JUNCTION BOX —→ HOSE BIBB EXHAUST FAN/LIGHT COMBINATION (VENT TO EXTERIOR) TELEVISION \$ WALL SWITCH -+CM I/4" WATER STUB OUT ☐ ELECTRIC METER \$3 THREE-WAY SWITCH FLUORESCENT LIGHT FIXTURE ELECTRIC PANEL WALL SCONCE \$4 FOUR-WAY SWITCH TECH HUB SYSTEM DISCONNECT SWITCH

bed 4

bed 2

wic.

CLOSET LIGHTS TO MEET APPLICABLE LOCAL AND STATE CODES



GMD DESIGN GROUP CAROLINAS, INC. IO2 FOUNTAIN BROOK CIRCLE SUITE C CARY, NC. 275II PHONE: (919) 320-3022

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FLUSH MOUNTED LIGHTS TO BE REPLACED W RECESSED CAN LIGHT WITH UPGRADED LIGHTING. LOCATION PER BUILDER.

bed 3

PROJECT TITLE:

The Winston


FOR CONSTRUCTION





2nd FLOOR **UTILITY PLAN**

November 28, 2016

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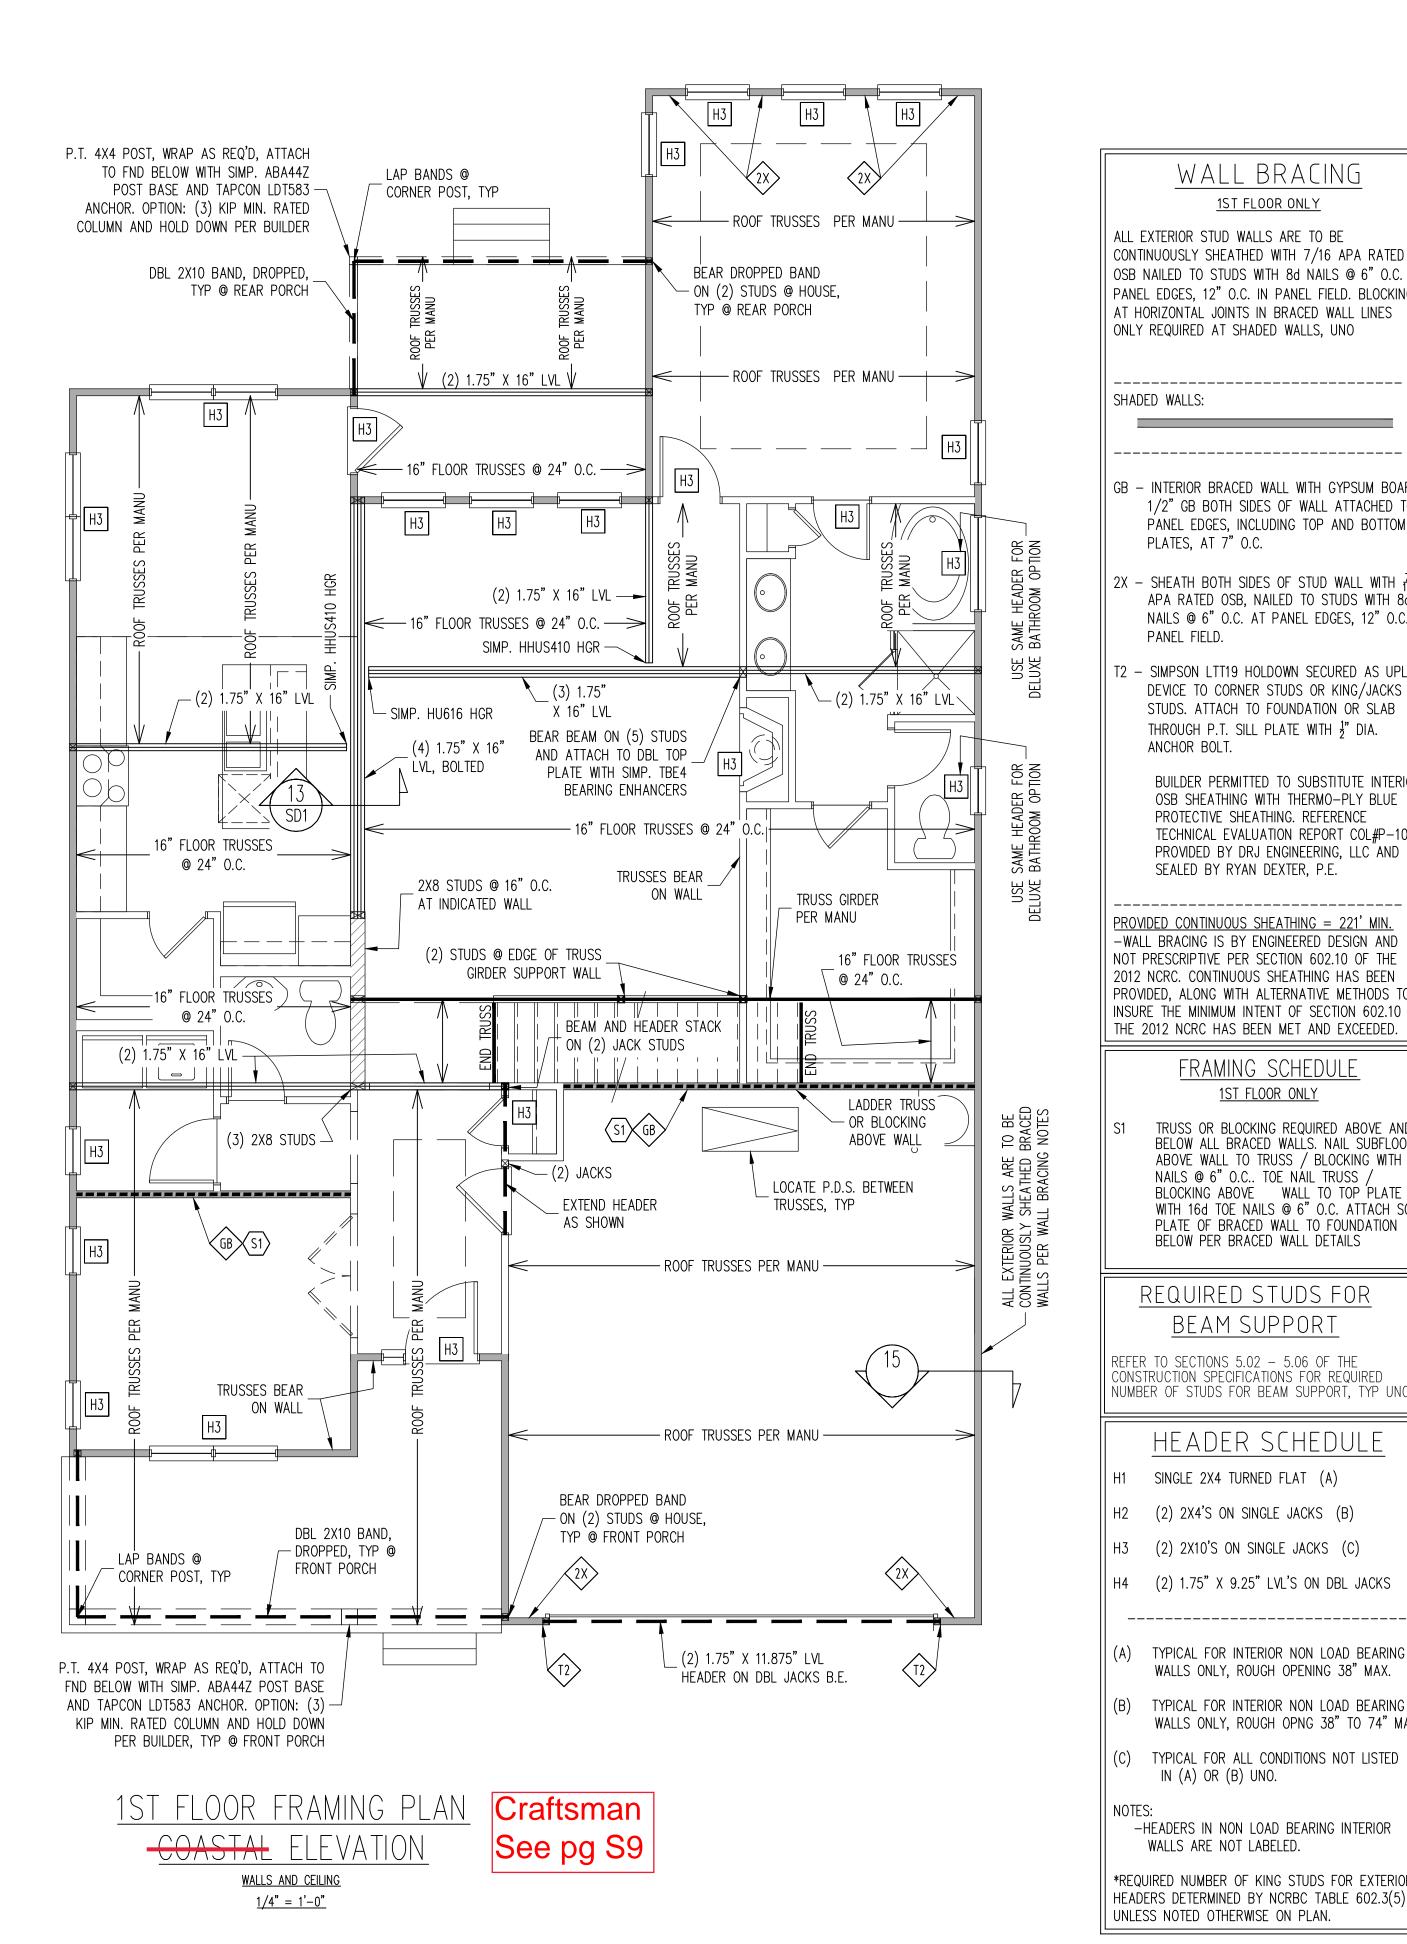


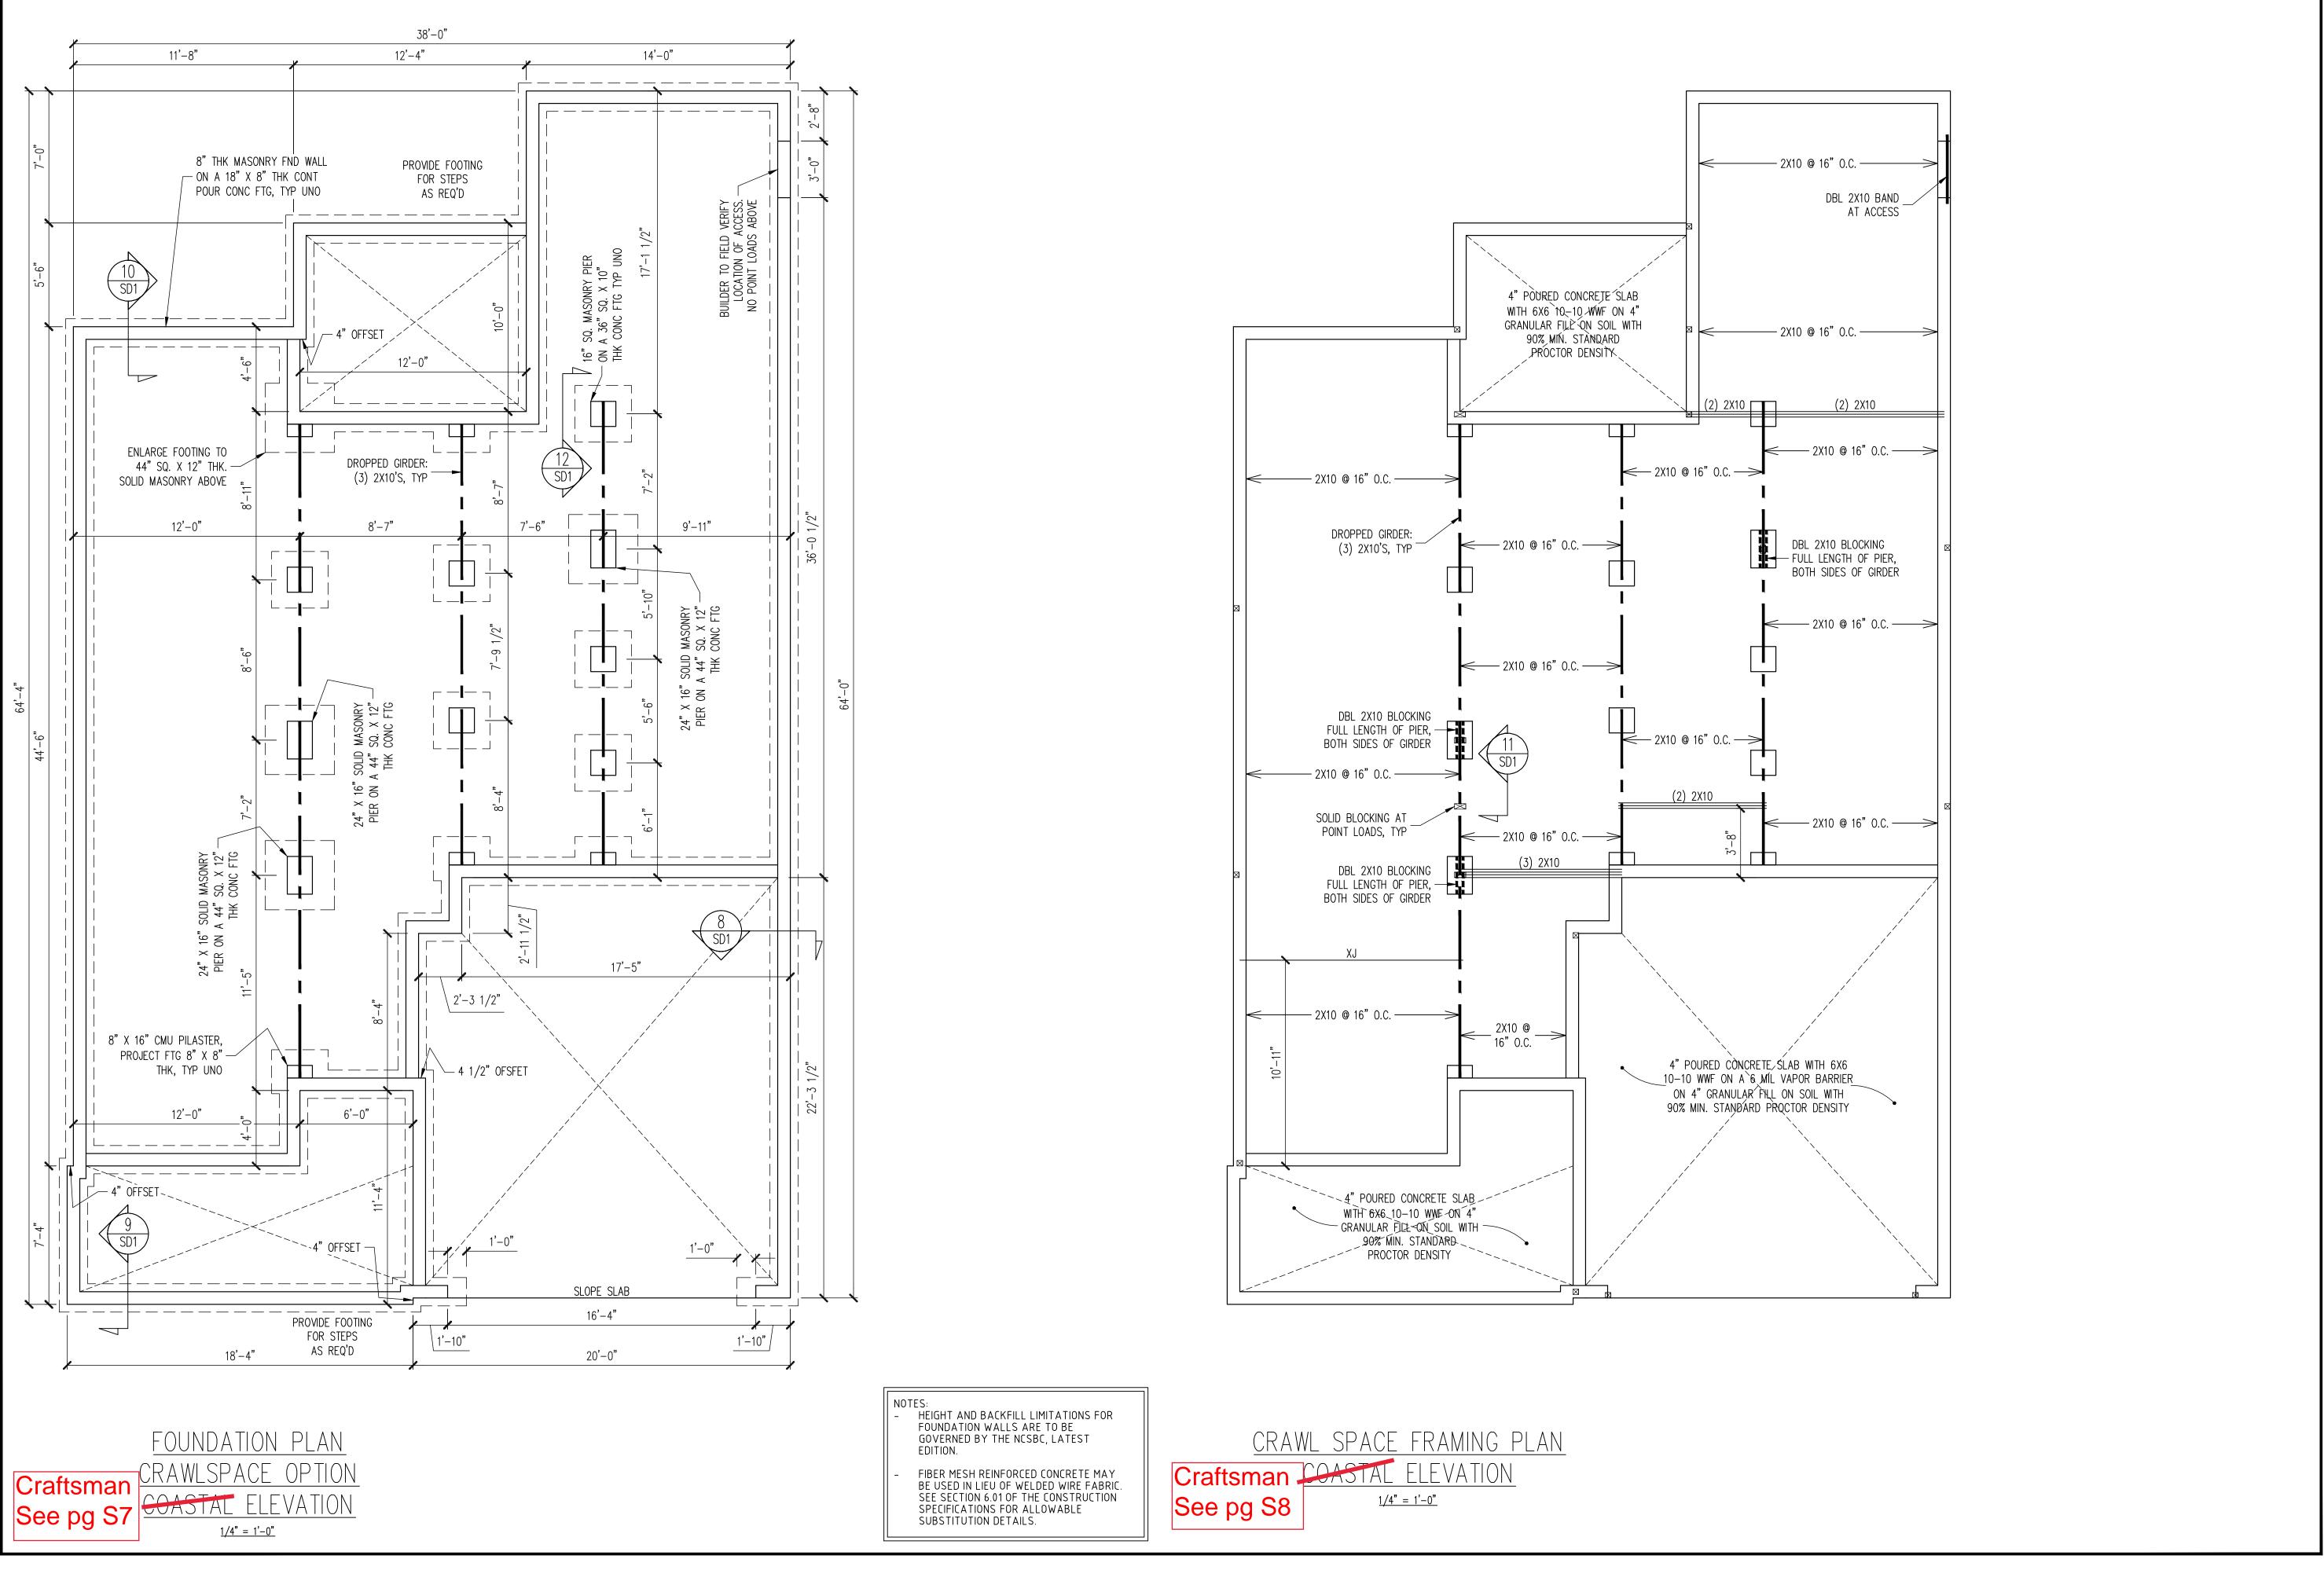CLIENT:	MCKEE HOMES, INC.	()	
SCOPE	STRUCTURAL ADDENDUM	WNC	
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		REV:	
		DATE	DATE 11-16-2017

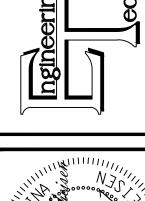PLAN NO. WINSTON RH

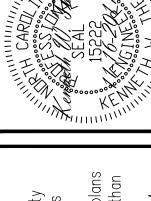PROJECT NO. 17-29-113R

> SHEET NO. 2 of 23



WALL BRACING

1ST FLOOR ONLY

ALL EXTERIOR STUD WALLS ARE TO BE CONTINUOUSLY SHEATHED WITH 7/16 APA RATED OSB NAILED TO STUDS WITH 8d NAILS @ 6" O.C. AT PANEL EDGES, 12" O.C. IN PANEL FIELD. BLOCKING AT HORIZONTAL JOINTS IN BRACED WALL LINES ONLY REQUIRED AT SHADED WALLS, UNO

SHADED WALLS:

- GB INTERIOR BRACED WALL WITH GYPSUM BOARD. 1/2" GB BOTH SIDES OF WALL ATTACHED TO PANEL EDGES, INCLUDING TOP AND BOTTOM PLATES, AT 7" O.C.
- 2X SHEATH BOTH SIDES OF STUD WALL WITH 16 APA RATED OSB, NAILED TO STUDS WITH 8d NAILS @ 6" O.C. AT PANEL EDGES, 12" O.C. IN PANEL FIELD.
- T2 SIMPSON LTT19 HOLDOWN SECURED AS UPLIFT DEVICE TO CORNER STUDS OR KING/JACKS STUDS. ATTACH TO FOUNDATION OR SLAB THROUGH P.T. SILL PLATE WITH $\frac{1}{2}$ " DIA. ANCHOR BOLT.

BUILDER PERMITTED TO SUBSTITUTE INTERIOR OSB SHEATHING WITH THERMO-PLY BLUE PROTECTIVE SHEATHING. REFERENCE TECHNICAL EVALUATION REPORT COL#P-1038 PROVIDED BY DRJ ENGINEERING, LLC AND SEALED BY RYAN DEXTER, P.E.

PROVIDED CONTINUOUS SHEATHING = 221' MIN. -WALL BRACING IS BY ENGINEERED DESIGN AND NOT PRESCRIPTIVE PER SECTION 602.10 OF THE 2012 NCRC. CONTINUOUS SHEATHING HAS BEEN PROVIDED, ALONG WITH ALTERNATIVE METHODS TO INSURE THE MINIMUM INTENT OF SECTION 602.10 OF THE 2012 NCRC HAS BEEN MET AND EXCEEDED.

FRAMING SCHEDULE <u>1ST FLOOR ONLY</u>

TRUSS OR BLOCKING REQUIRED ABOVE AND BELOW ALL BRACED WALLS. NAIL SUBFLOOR ABOVE WALL TO TRUSS / BLOCKING WITH 8d NAILS @ 6" O.C.. TOE NAIL TRUSS / BLOCKING ABOVE WALL TO TOP PLATE WITH 16d TOE NAILS @ 6" O.C. ATTACH SOLE PLATE OF BRACED WALL TO FOUNDATION BELOW PER BRACED WALL DETAILS

REQUIRED STUDS FOR BEAM SUPPORT


REFER TO SECTIONS 5.02 - 5.06 OF THE CONSTRUCTION SPECIFICATIONS FOR REQUIRED NUMBER OF STUDS FOR BEAM SUPPORT, TYP UNO.

HEADER SCHEDULE

- H1 SINGLE 2X4 TURNED FLAT (A)
- H2 (2) 2X4'S ON SINGLE JACKS (B)
- H3 (2) 2X10'S ON SINGLE JACKS (C)
- H4 (2) 1.75" X 9.25" LVL'S ON DBL JACKS
- (A) TYPICAL FOR INTERIOR NON LOAD BEARING WALLS ONLY, ROUGH OPENING 38" MAX.
- (B) TYPICAL FOR INTERIOR NON LOAD BEARING WALLS ONLY, ROUGH OPNG 38" TO 74" MAX.
- (C) TYPICAL FOR ALL CONDITIONS NOT LISTED IN (A) OR (B) UNO.

NOTES: -HEADERS IN NON LOAD BEARING INTERIOR WALLS ARE NOT LABELED.

*REQUIRED NUMBER OF KING STUDS FOR EXTERIOR HEADERS DETERMINED BY NCRBC TABLE 602.3(5) UNLESS NOTED OTHERWISE ON PLAN.

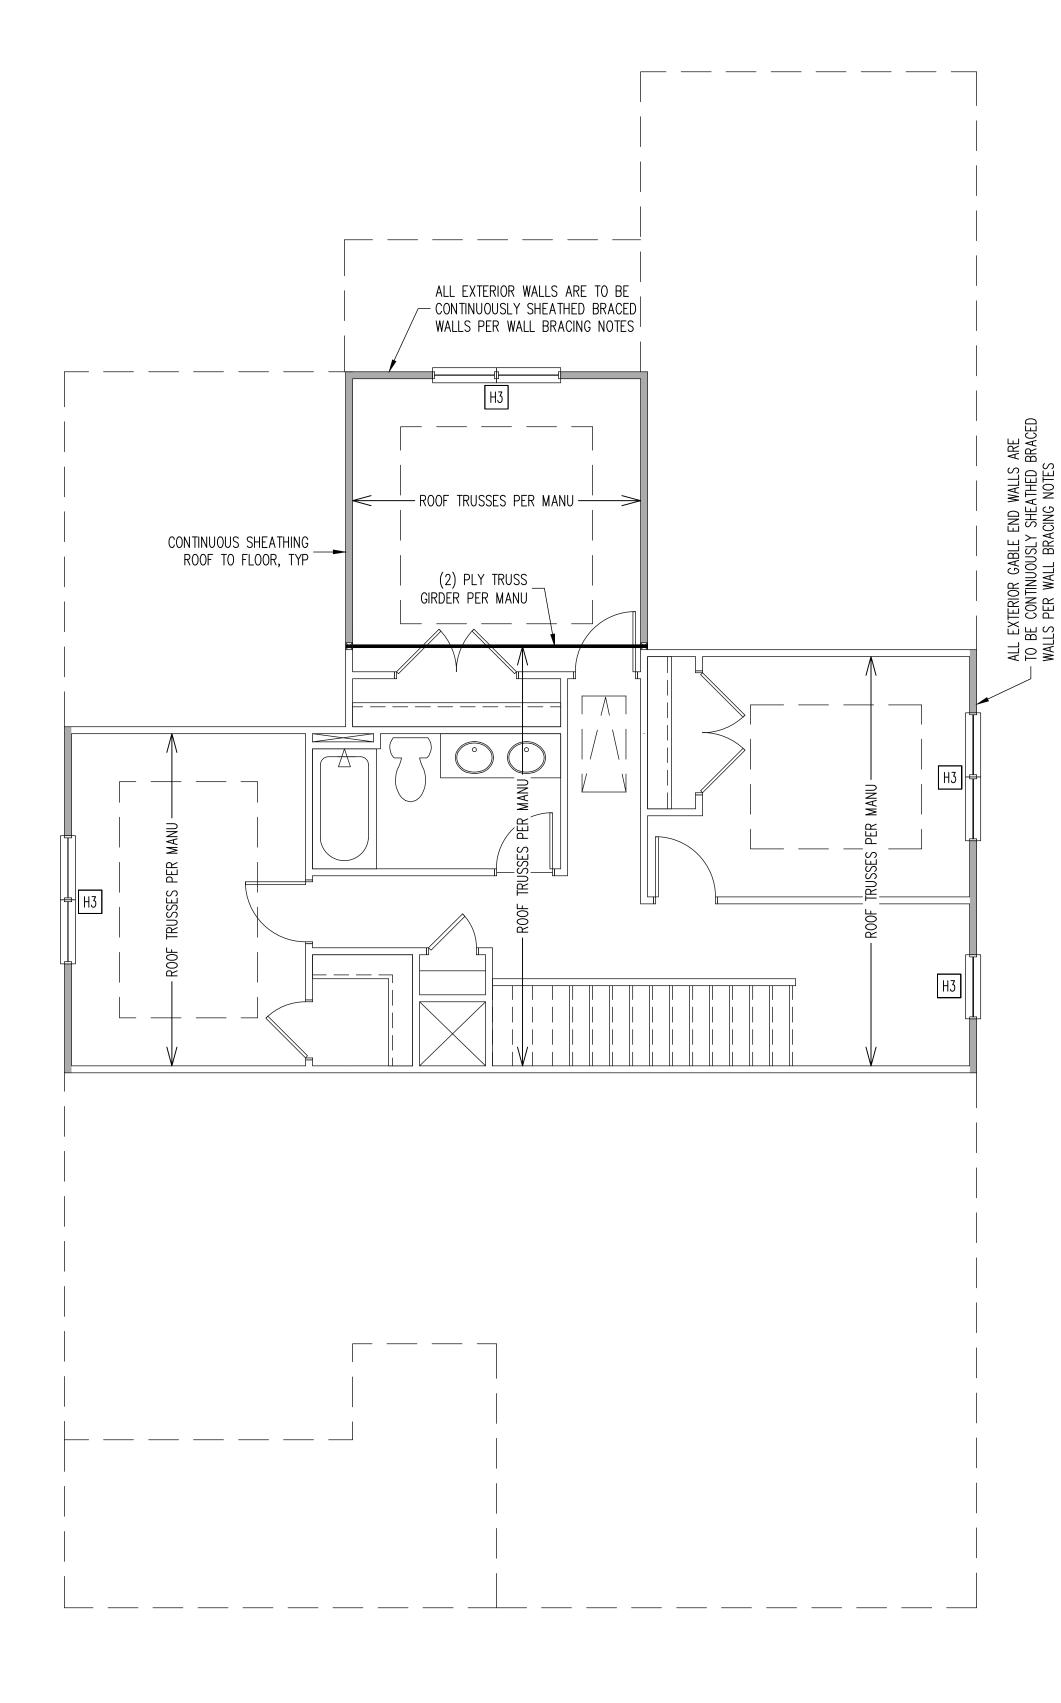

2ND FLOOR FRAMING PLAN ALL ELEVATIONS

> WALLS AND CEILING 1/4" = 1'-0"

WALL BRACING <u>2ND FLOOR ONLY</u>

ALL EXTERIOR STUD WALLS ARE TO BE CONTINUOUSLY SHEATHED WITH 7/16 APA RATED OSB NAILED TO STUDS WITH 8d NAILS @ 6" O.C. AT PANEL EDGES, 12" O.C. IN PANEL FIELD.

TRUSS OR BLOCKING REQUIRED ABOVE AND BELOW ALL BRACED WALLS. NAIL SUBFLOOR ABOVE WALL TO BLOCKING WITH 8d NAILS @ 6" O.C.. TOE NAIL TRUSS / BLOCKING ABOVE WALL TO TOP PLATE WITH 16d TOE NAILS @ 6" O.C. NAIL SOLE PLATE OF BRACED WALL TO TRUSS / BLOCKING BELOW WALL WITH (3) 16d NAILS @ 16" O.C. BLOCKING AT HORIZONTAL JOINTS IN BRACED WALL LINES ONLY REQUIRED AT SHADED WALLS, UNO

______ SHADED WALLS:

-PROVIDED CONTINUOUS SHEATHING = 67' MIN. -WALL BRACING IS BY ENGINEERED DESIGN AND NOT PRESCRIPTIVE PER SECTION 602.10 OF THE 2012 NCRC. CONTINUOUS SHEATHING HAS BEEN PROVIDED, ALONG WITH ALTERNATIVE METHODS TO INSURE THE MINIMUM INTENT OF SECTION 602.10 OF

REQUIRED STUDS FOR BEAM SUPPORT

THE 2012 NCRC HAS BEEN MET AND EXCEEDED.

REFER TO SECTIONS 5.02 - 5.06 OF THE CONSTRUCTION SPECIFICATIONS FOR REQUIRED NUMBER OF STUDS FOR BEAM SUPPORT, TYP UNO.

HEADER SCHEDULE


- H1 SINGLE 2X4 TURNED FLAT (A)
- H2 (2) 2X4'S ON SINGLE JACKS (B)
- H3 (2) 2X10'S ON SINGLE JACKS (C)
- H4 (2) 1.75" X 9.25" LVL'S ON DBL JACKS
- (A) TYPICAL FOR INTERIOR NON LOAD BEARING WALLS ONLY, ROUGH OPENING 38" MAX.
- (B) TYPICAL FOR INTERIOR NON LOAD BEARING WALLS ONLY, ROUGH OPNG 38" TO 74" MAX.
- (C) TYPICAL FOR ALL CONDITIONS NOT LISTED IN (A) OR (B) UNO.

NOTES: -HEADERS IN NON LOAD BEARING INTERIOR

WALLS ARE NOT LABELED. *REQUIRED NUMBER OF KING STUDS FOR EXTERIOR

HEADERS DETERMINED BY NCRBC TABLE 602.3(5) UNLESS NOTED OTHERWISE ON PLAN.



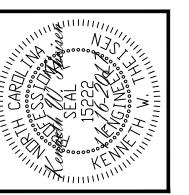

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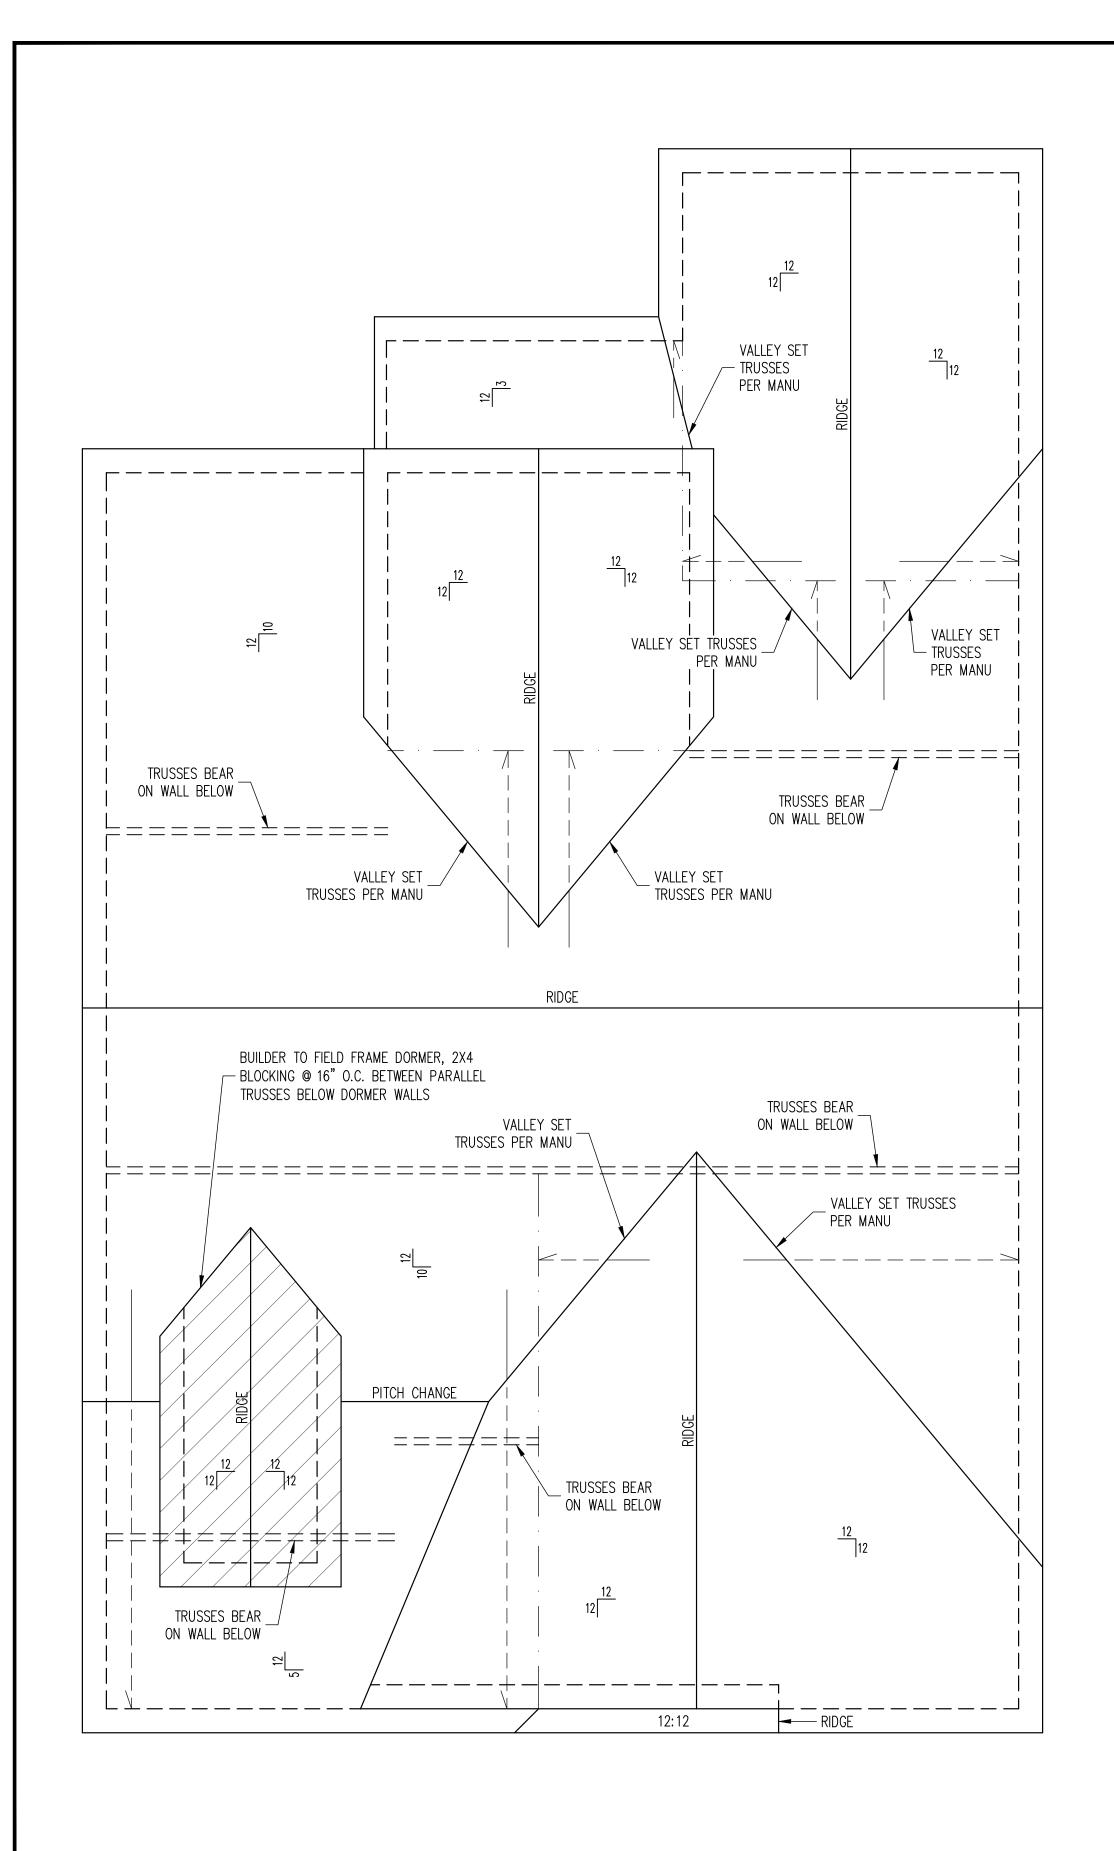
PLAN NO.

WINSTON RH

PROJECT NO. 17-29-113R

> SHEET NO. \$3

3 of 23




ROOF FRAMING PLAN
CRAFTSMAN ELEVATION
1/4" = 1'-0"


FRAMING NOTES

ROOF ONLY

-ROOF TRUSSES PER MANU TYPICAL UNO
-VERIFY ALL ARCHITECTURAL OVERHANGS, ROOF
PITCHES, AND KNEEWALL HEIGHTS PRIOR TO
CONSTRUCTION

STRUCTURAL ENGINEERS
License No. C-3870
183 Wind Chime Court, Suite 100
Raleigh, North Carolina 27615

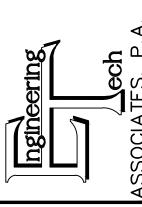

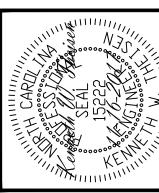

ENGINEERING SEAL VALID FOR 1 YEAR ONLY.

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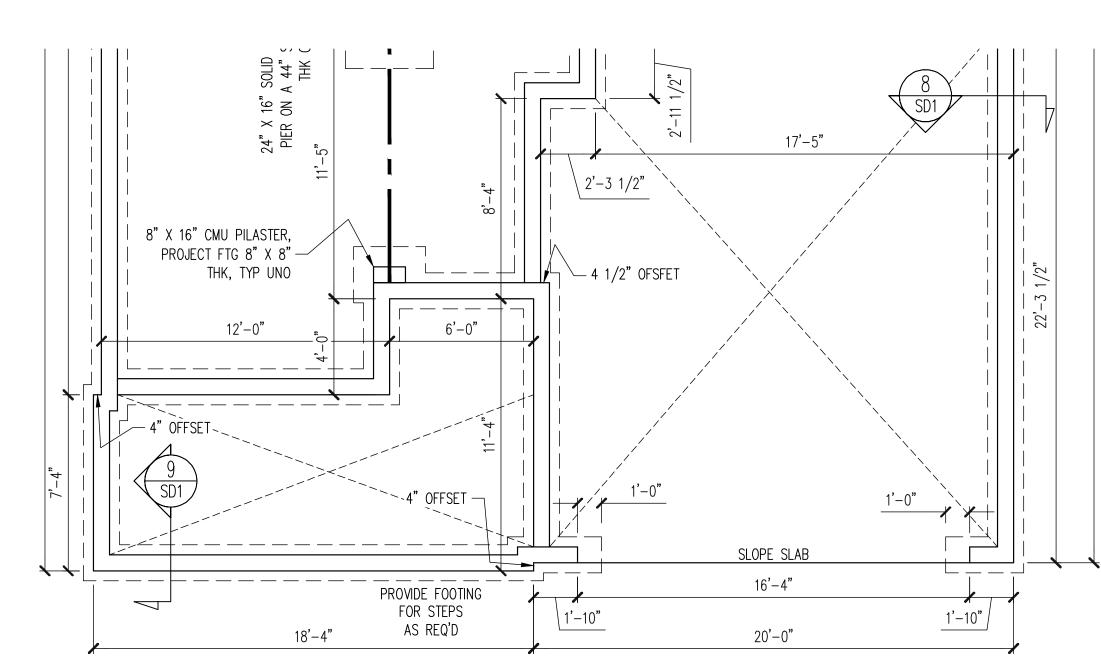
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PLAN NO. WINSTON RH

PROJECT NO. 17-29-113R

SHEET NO.

5 of 23



FOUNDATION PLAN CRAWLSPACE OPTION CRAFTSMAN ELEVATION 1/4" = 1'-0"

REFER TO SHEET NO. S2 FOR ALL STRUCTURAL NOTES AND SCHEDULES


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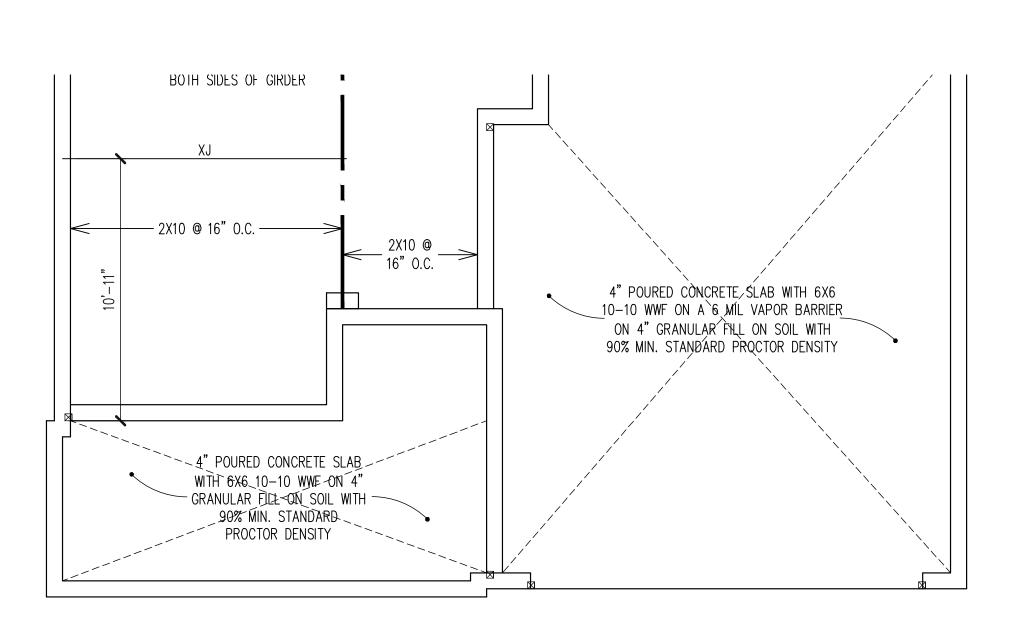
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PLAN NO. WINSTON RH

PROJECT NO. 17-29-113R


S7 7 of 23




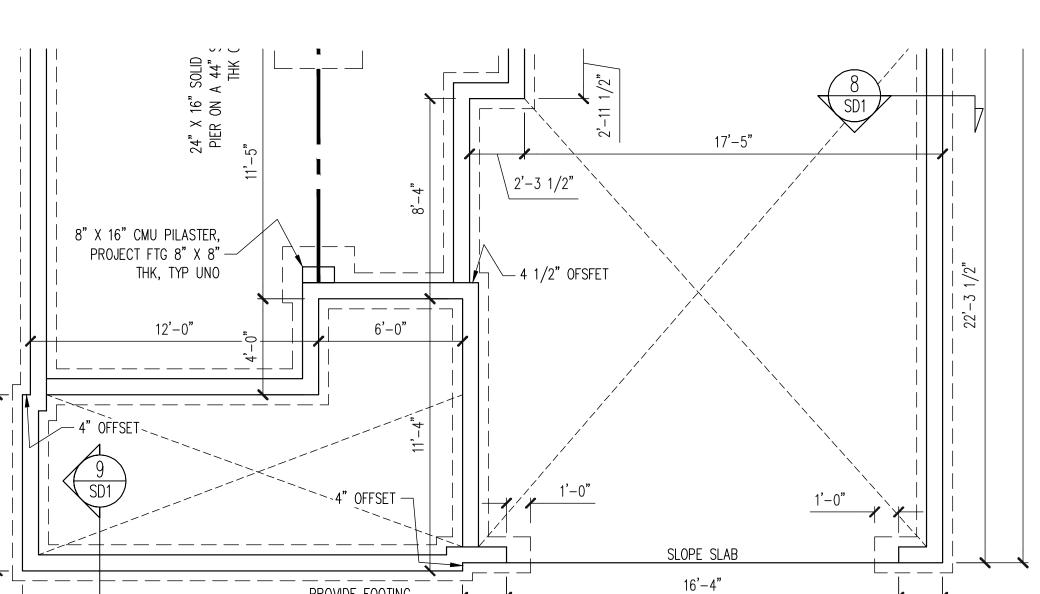

CRAWL SPACE FRAMING PLAN CRAFTSMAN ELEVATION 1/4" = 1'-0"

REFER TO SHEET NO. S2 FOR ALL STRUCTURAL NOTES AND SCHEDULES

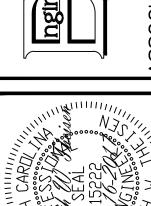

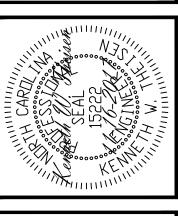


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PLAN NO. WINSTON RH

PROJECT NO. 17-29-113R

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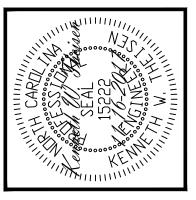


1ST FLOOR FRAMING PLAN
CRAFTSMAN ELEVATION

 $\frac{\text{WALLS AND CEILING}}{1/4" = 1'-0"}$

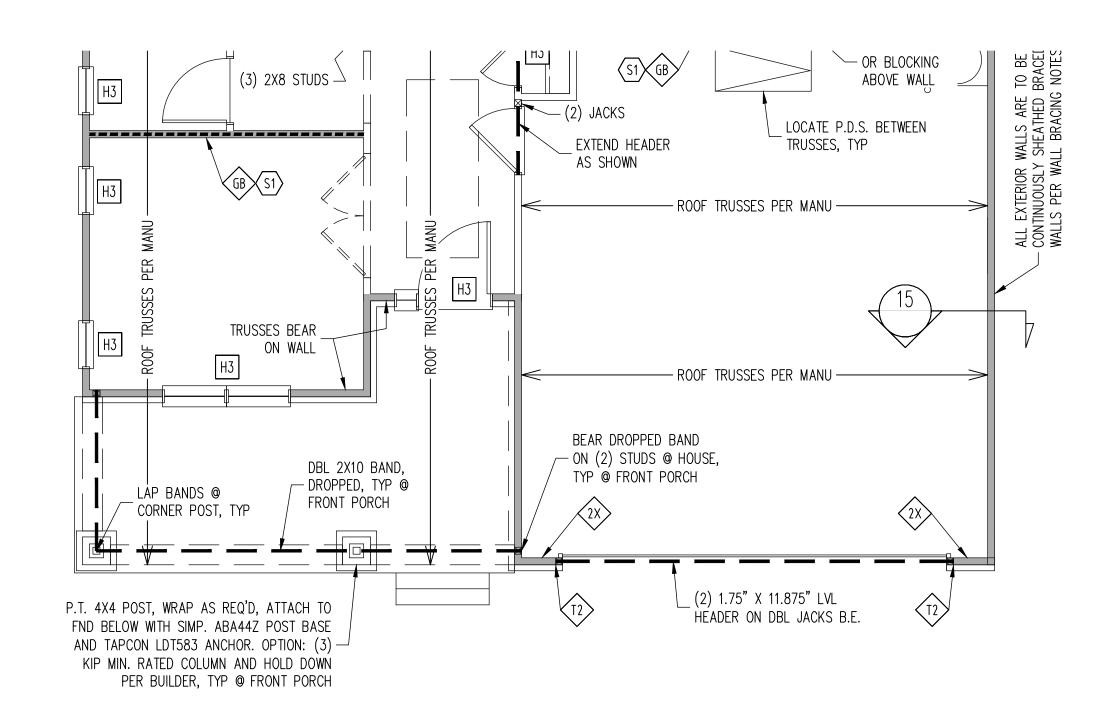REFER TO SHEET NO. S3 FOR ALL STRUCTURAL NOTES AND SCHEDULES Ingineering

ASSOCIATES, P.A.



ENGINEERING SEAL VALID FOR 1 YEAR ONLY.


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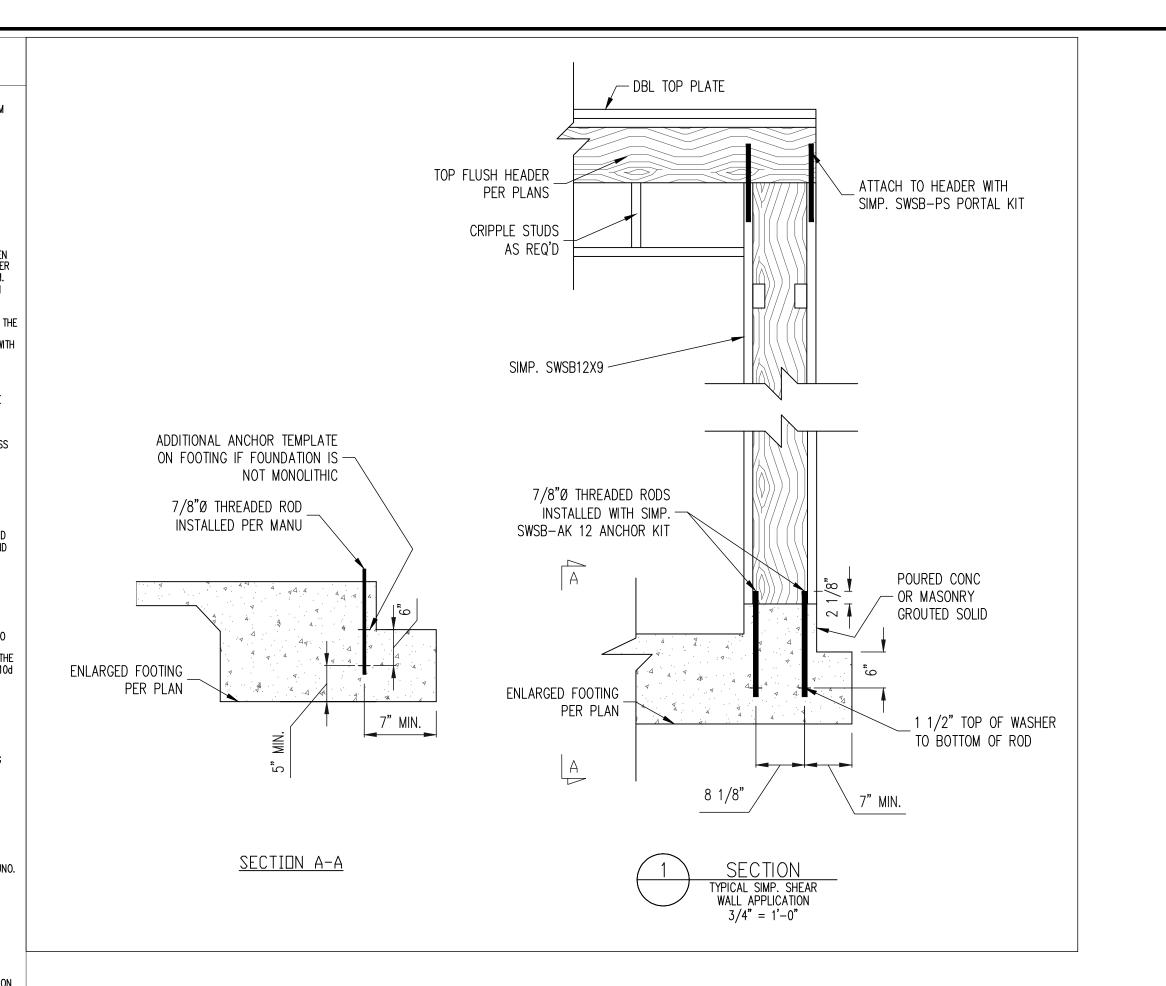
PLAN NO.
WINSTON RH

PROJECT NO. 17-29-113R

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9 of 23




<u>CONSTRUCTION</u>	<u>SPE</u>	<u>ECIFICATIONS</u>
PART 1: GENERAL O1 CONSTRUCTION SHALL MEET THE REQUIREMENTS OF THE NORTH CAROLINA RESIDENTIAL	4.09	CAST IN PLACE CONCRETE SHALL BE OF NORMAL WEIGHT AND SHALL HAVE A MINIMUM COMPRESSIVE STRENGTH OF 3000 PSI AT 28 DAYS TYP UNO.
CODE, 2012 EDITION.	4.10	CONCRETE MASONRY UNITS SHALL CONFORM TO ASTM C 90 OR ASTM C 55.
STRUCTURAL STEEL SHALL MEET THE REQUIREMENTS OF THE AISC SPECIFICATION FOR THE DESIGN, FABRICATION AND ERECTION OF STRUCTURAL STEEL FOR BUILDINGS.	4.11	MORTAR SHALL BE TYPE S CONFORMING TO ASTM C 476.
3 REINFORCED CAST IN PLACE CONCRETE SHALL BE PROPORTIONED, MIXED AND PLACED IN ACCORDANCE WITH THE SPECIFICATIONS OF ACI 318, LATEST EDITION.	4.12	NAILS SHALL BE COMMON WIRE NAILS TYP UNO. LAG SCREWS SHALL CONFORM TO ANSI/ASME STANDARD B18.2.1—1981.
MASONRY CONSTRUCTION SHALL CONFORM TO THE SPECIFICATIONS OF ACI 530-95, LATEST EDITION.		PART 5: CONSTRUCTION
METHODS, PROCEDURES AND SEQUENCES OF CONSTRUCTION ARE THE RESPONSIBILITY OF THE CONTRACTOR. THE CONTRACTOR SHALL TAKE ALL NECESSARY PRECAUTIONS TO MAINTAIN AND INSURE THE INTEGRITY OF THE STRUCTURE AT ALL STAGES OF CONSTRUCTION.	5.01	FLITCH PLATE BEAMS SHALL CONSIST OF A CONTINUOUS STEEL PLATE BOLTED BETWEEN TWO PIECES OF CONTINUOUS LUMBER AS SIZED ON THE PLANS. BOLT PIECES TOGETHE USING 1/2" Ø BOLTS SPACED AT 24" O.C. STAGGERED TOP TO BOTTOM OF THE BEAM. MAINTAIN A 2" EDGE DISTANCE. PLACE TWO BOLTS, ONE ABOVE THE OTHER, 6" FROM
PART 2: DIMENSIONS	F 00	EACH END OF THE BEAM.
DI DIMENSIONS SHOWN SHALL GOVERN OVER SCALE ON THESE DRAWINGS.	5.02	STEEL, LVL AND FLITCH PLATE BEAMS BEARING ON A STUD WALL PERPENDICULAR TO BEAM SHALL BEAR FULL WIDTH ON THE SUPPORTING WALL INDICATED AND SHALL BE SUPPORTED BY A MINIMUM OF THREE GANGED STUDS, OR A GANGED STUD COLUMN WI
PART 3: DESIGN LOADS		A NUMBER OF STUDS SUCH THAT THE STUD COLUMN IS AT LEAST AS WIDE AS THE BEAM BEING SUPPORTED, WHICHEVER IS GREATER, TYP UNO.
DESIGN LOADS SHALL CONFORM WITH THE TABLE BELOW: USE LIVE LOAD (PSF) DEAD LOAD (PSF) CONIES. DECKS. ATTICS WITH FIXED STAIR 40 10	5.03	STEEL, LVL AND FLITCH PLATE BEAMS BEARING ONTO THE END OF A STUD WALL PARALLEL TO THE BEAM SHALL BEAR A MINIMUM OF 4 $1/2$ " ONTO THE WALL AND BE SUPPORTED BY A TRPL STUD GANGED COLUMN TYP UNO.
CONIES, DECKS, ATTICS WITH FIXED STAIR 40 10 ESS, DWELLING UNITS (INCLUDUNG SLEEPING MS), ATTICS WITH FIXED STAIR ACCESS, RS, FIRE ESCAPES	5.04	SOLID SAWN LUMBER GANGED BEAMS BEARING ON A STUD WALL PERPENDICULAR TO THE BEAM SHALL SHALL BEAR FULL WIDTH ON THE SUPPORTING WALL INDICATED (LES: 1 1/2" TO ALLOW FOR A CONTINUOUS RIM JOIST) AND SHALL BE SUPPORTED BY A GANGED STUD COLUMN THE SAME WIDTH AS THE BEAM TYP UNO.
RAGES (PASSENGER CARS ONLY) 50 ICS (NO STORAGE, LESS THAN 5' HEADROOM) 10 10	5.05	SOLID SAWN LUMBER GANGED BEAMS BEARING ONTO THE END OF A STUD WALL PARALLEL TO THE BEAM SHALL BEAR A MINIMUM OF 3" ONTO THE WALL AND BE SUPPORTED BY A DBL STUD GANGED COLUMN TYP UNO.
ICS (WITH STORAGE) 20 10 OF 20 10 (15 FOR VAULTS)	5.06	EXTRA JOISTS OR SINGLE LVL MEMBERS OF 1.75" OR LESS WIDTH, BEARING ON A STUD WALL PERPENDICULAR TO THE BEAM SHALL BEAR ON THE WALL A MINIMUM OF 2" AND SHALL BE SUPPORTED BY ONE ADDITIONAL STUD.
TES: — INDIVIDUAL STAIR TREADS ARE TO BE DESIGNED FOR THE UNIFORMLY DISTRIBUTED LIVE LOAD OR A 300 LB. CONCENTRATED LOAD ACTING OVER AN AREA OF 4 SQ. IN.,	5.07	SOLID SAWN LUMBER JOISTS THAT ARE GANGED TO FORM A BEAM SHALL HAVE ADJACENT MEMBERS IN THE BEAM NAILED TOGETHER WITH THREE ROWS OF 10d
WHICHEVER PRODUCES THE GREATER STRESS. - GUARD RAILS AND HAND RAILS ARE TO BE DESIGNED FOR A SINGLE CONCENTRATED LOAD OF 200 LB. APPLIED IN ANY DIRECTION AT ANY POINT ALONG THE TOP. - BUILDER TO VERIFY DEAD LOAD DOES NOT EXCEED 10 PSF WHEN HEAVY FLOOR OR ROOF FINISHES SUCH AS TILE OR SLATE ARE UTILIZED	5.08	NAILS @ 16" O.C. LVL MEMBERS THAT ARE GANGED TO FORM A BEAM SHALL HAVE ADJACENT MEMBERS IN THE BEAM FASTENED TOGETHER PER MANUFACTURERS RECOMMENDATIONS, TYP UNO
2 INTERIOR WALLS: 5 PSF LATERAL.	5.09	STUDS THAT ARE GANGED TO FORM A COLUMN SHALL HAVE ADJACENT STUDS WITHIN TI COLUMN NAILED TOGETHER WITH ONE ROW OF 10d NAILS AT 8" O.C. (TWO ROWS OF 10
BASIC WIND DESIGN VELOCITY OF 100 MPH.		NAILS @ 8" O.C., 3" APART, FOR 2X8 OR 2X10 STUDS) ALL COLUMNS SHALL BE CONTINUOUS DOWN TO THE FOUNDATION OR OTHER PROPERLY DESIGNED STRUCTURAL FLEMENT SLICH AS A BEAM COLUMNS TRANSFERRING LOADS THROUGH FLOOR LEVELS
LOAD DURATION FACTOR FOR ROOF STRUCTURAL MEMBERS IS 1.15.		ELEMENT SUCH AS A BEAM. COLUMNS TRANSFERRING LOADS THROUGH FLOOR LEVELS SHALL BE SOLIDLY BLOCKED FOR THE FULL WIDTH OF THE STUD COLUMN WITHIN THE CAVITY FORMED BY THE FLOOR JOISTS.
SOIL BEARING CAPACITY 2000 PSF (PRESUMPTIVE). PART 4: MATERIALS	5.10	STUD WALLS SHALL CONSIST OF 2X4 STUDS SPACED AT 16" O.C. UNO. STUDS SHALL BE CONTINUOUS FROM SOLE PLATE AT FLOOR TO DOUBLE TOP PLATE AT THE CELLING
STRUCTURAL STEEL SQUARE AND RECTANGULAR TUBING SHALL CONFORM TO ASTM A500		BE CONTINUOUS FROM SOLE PLATE AT FLOOR TO DOUBLE TOP PLATE AT THE CEILING OR ROOF. NO INTERMEDIATE BANDS OR PLATES SHALL CAUSE DISCONTINUITIES IN A STUD WALL EXCEPT AS REQUIRED FOR DOOR OR WINDOW OPENINGS. THE KING STUDS
GRADE B MINIMUM GRADE. ALL OTHER STRUCTURAL STEEL SHALL CONFORM TO ASTM A992 MINIMUM GRADE TYP UNO.	5.11	FOR SUCH OPENINGS SHALL BE CONTINUOUS. PILOT HOLES SHALL BE USED FOR LAG SCREW INSTALLATION AND SHALL BE BORED
REBAR SHALL BE DEFORMED STEEL CONFORMING TO ASTM A615 GRADE 60 TYP UNO SOLID SAWN WOOD FRAMING DESIGN IS BASED ON NO. 2 SPRUCE PINE FIR FOR JOISTS.		ACCORDING TO NDS SPECIFICATIONS.
SOLID SAWN WOOD FRAMING DESIGN IS BASED ON NO. 2 SPRUCE PINE FIR FOR JOISTS, RAFTERS, WOOD GIRDERS/BEAMS, STUDS, ETC. ALLOWANCE HAS BEEN MADE FOR SYP #2 SUBSTITUTION TYP UNO.	5.12	ALL WELDING SHALL BE PERFORMED BY AN AWS CERTIFIED WELDER ALL CONCRETE, INCLUDING CONCRETE FOR FOOTINGS, IS TO BE CAST IN PLACE, TYP UN
LVL OR PSL MINIMUM ALLOWABLE DESIGN STRESSES ARE AS FOLLOWS: E= 1.9 X 10E6 PSI, Fb = 2600 PSI, Fv = 285 PSI, Fc = 750 PSI	5.14	BOLTS AND LAG SCREWS USED FOR BOLTING WOOD MEMBERS SHALL HAVE STANDARD WASHERS INSTALLED FOR THE NUTS AND BOLT / SCREW HEADS
LSL MINIMUM ALLOWABLE DESIGN STRESSES ARE AS FOLLOWS:		PART 6: SUBSTITUTIONS
E= 1.3 X 10E6 PSI, Fb = 1700 PSI, Fv = 400 PSI, Fc = 680 PSI BOLTS SHALL CONFORM TO ASTM A307 MINIMUM GRADE TYP UNO	6.01	IN LIEU OF WELDED WIRE FABRIC IN SLABS: SYNTHETIC POLYPROPYLENE FIBRILLATED
WELDING ELECTRODES SHALL BE E70XX	6.02	MICRO FIBERS, FIBER LENGTH 1 1/2", DOSAGE RATE 1 1/2 LBS/CU YD. OTHER MATERIAL OR MEMBER SIZE SUBSTITUTIONS REQUIRE THE WRITTEN AUTHORIZATION.
LUMBER IN CONTACT WITH THE GROUND, CONCRETE OR MASONRY SHALL BE PRESSURE TREATED IN ACCORDANCE WITH AWPA STANDARD C-15. ALL OTHER EXPOSED LUMBER SHALL BE TREATED IN ACCORDANCE WITH AWPA STANDARD C-2 OR BY ANY METHOD GIVING EQUAL PROTECTION. THE BUILDING CODE OFFICE MAY ALSO APPROVE A NATURAL DECAY RESISTANT WOOD PER SECTION 19-6(A)		OF THE DESIGNERS. UNAUTHORIZED DEVIATIONS ARE THE SOLE RESPONSIBILITY OF THE CONTRACTOR.
<u>NOTES</u>		ABBREVIATIONS
L WORK IS TO BE DONE IN STRICT ACCORDANCE WITH STATE AND LOCAL CODES. THE BUILDER RESPONSIBLE FOR REVIEWING PLANS PRIOR TO CONSTRUCTION. IF ENGINEERING SERVICES HAS	ABV	ABOVE FND FOUNDATION TJ TRIPLE JOIST BOTH FTG FOOTING TYP TYPICAL
IN PROVIDED THE BUILDER SHALL VERIFY THAT THE FOUNDATION AND STRUCTURAL PLANS /E BEEN SEALED BY AN ENGINEER REGISTERED BY THE STATE. IF THE PLANS HAVE NOT BEEN	B.E. BTWN	BOTH ENDS HDG HOT DIPPED TRPL TRIPLE BETWEEN GALVANIZED TSP TRIPLE STUD POCKE
ED AND SEALED, THE BUILDER SHALL IMMEDIATELY CONTACT ENGINEERING TECH BEFORE CEEDING FURTHER. ANY ERRORS DUE TO A FAILURE TO FOLLOW THE ABOVE PROCEDURES	CONC	CONCRETE HGR HANGER UNO UNLESS NOTED CONTINUOUS SHEATHING LVL LAMINATED VENEER OTHERWISE
ILL NOT BE THE RESPONSIBILITY OF ENGINEERING TECH. ALL FINAL SETS OF THE SAME PLAN JED TO A BUILDER SHOULD BE REVIEWED FOR UNIFORMITY, ESPECIALLY IF PRIOR SETS OF	DBL	DIAMETER LUMBER XJ EXTRA JOIST DOUBLE NTS NOT TO SCALE DOUBLE FORCE OF SENTER
INS HAVE BEEN ISSUED AS STUDY COPIES.	DSP	DOUBLE JOIST O.C. ON CENTER DBL STUD POCKET PSL PARALLEL STRAND LIMBER
GINEERING TECH DOES NOT PERFORM FENESTRATION, ROOF VENT, OR ATTIC CALCULATIONS OR YOTHER AREA CALCULATIONS THAT ARE NOT RELATED TO STRUCTURAL ENGINEERING.	EQ EA	EACH PT PRESSURE TREATED
	FIG	FLANGE QJ QUAD JOIST

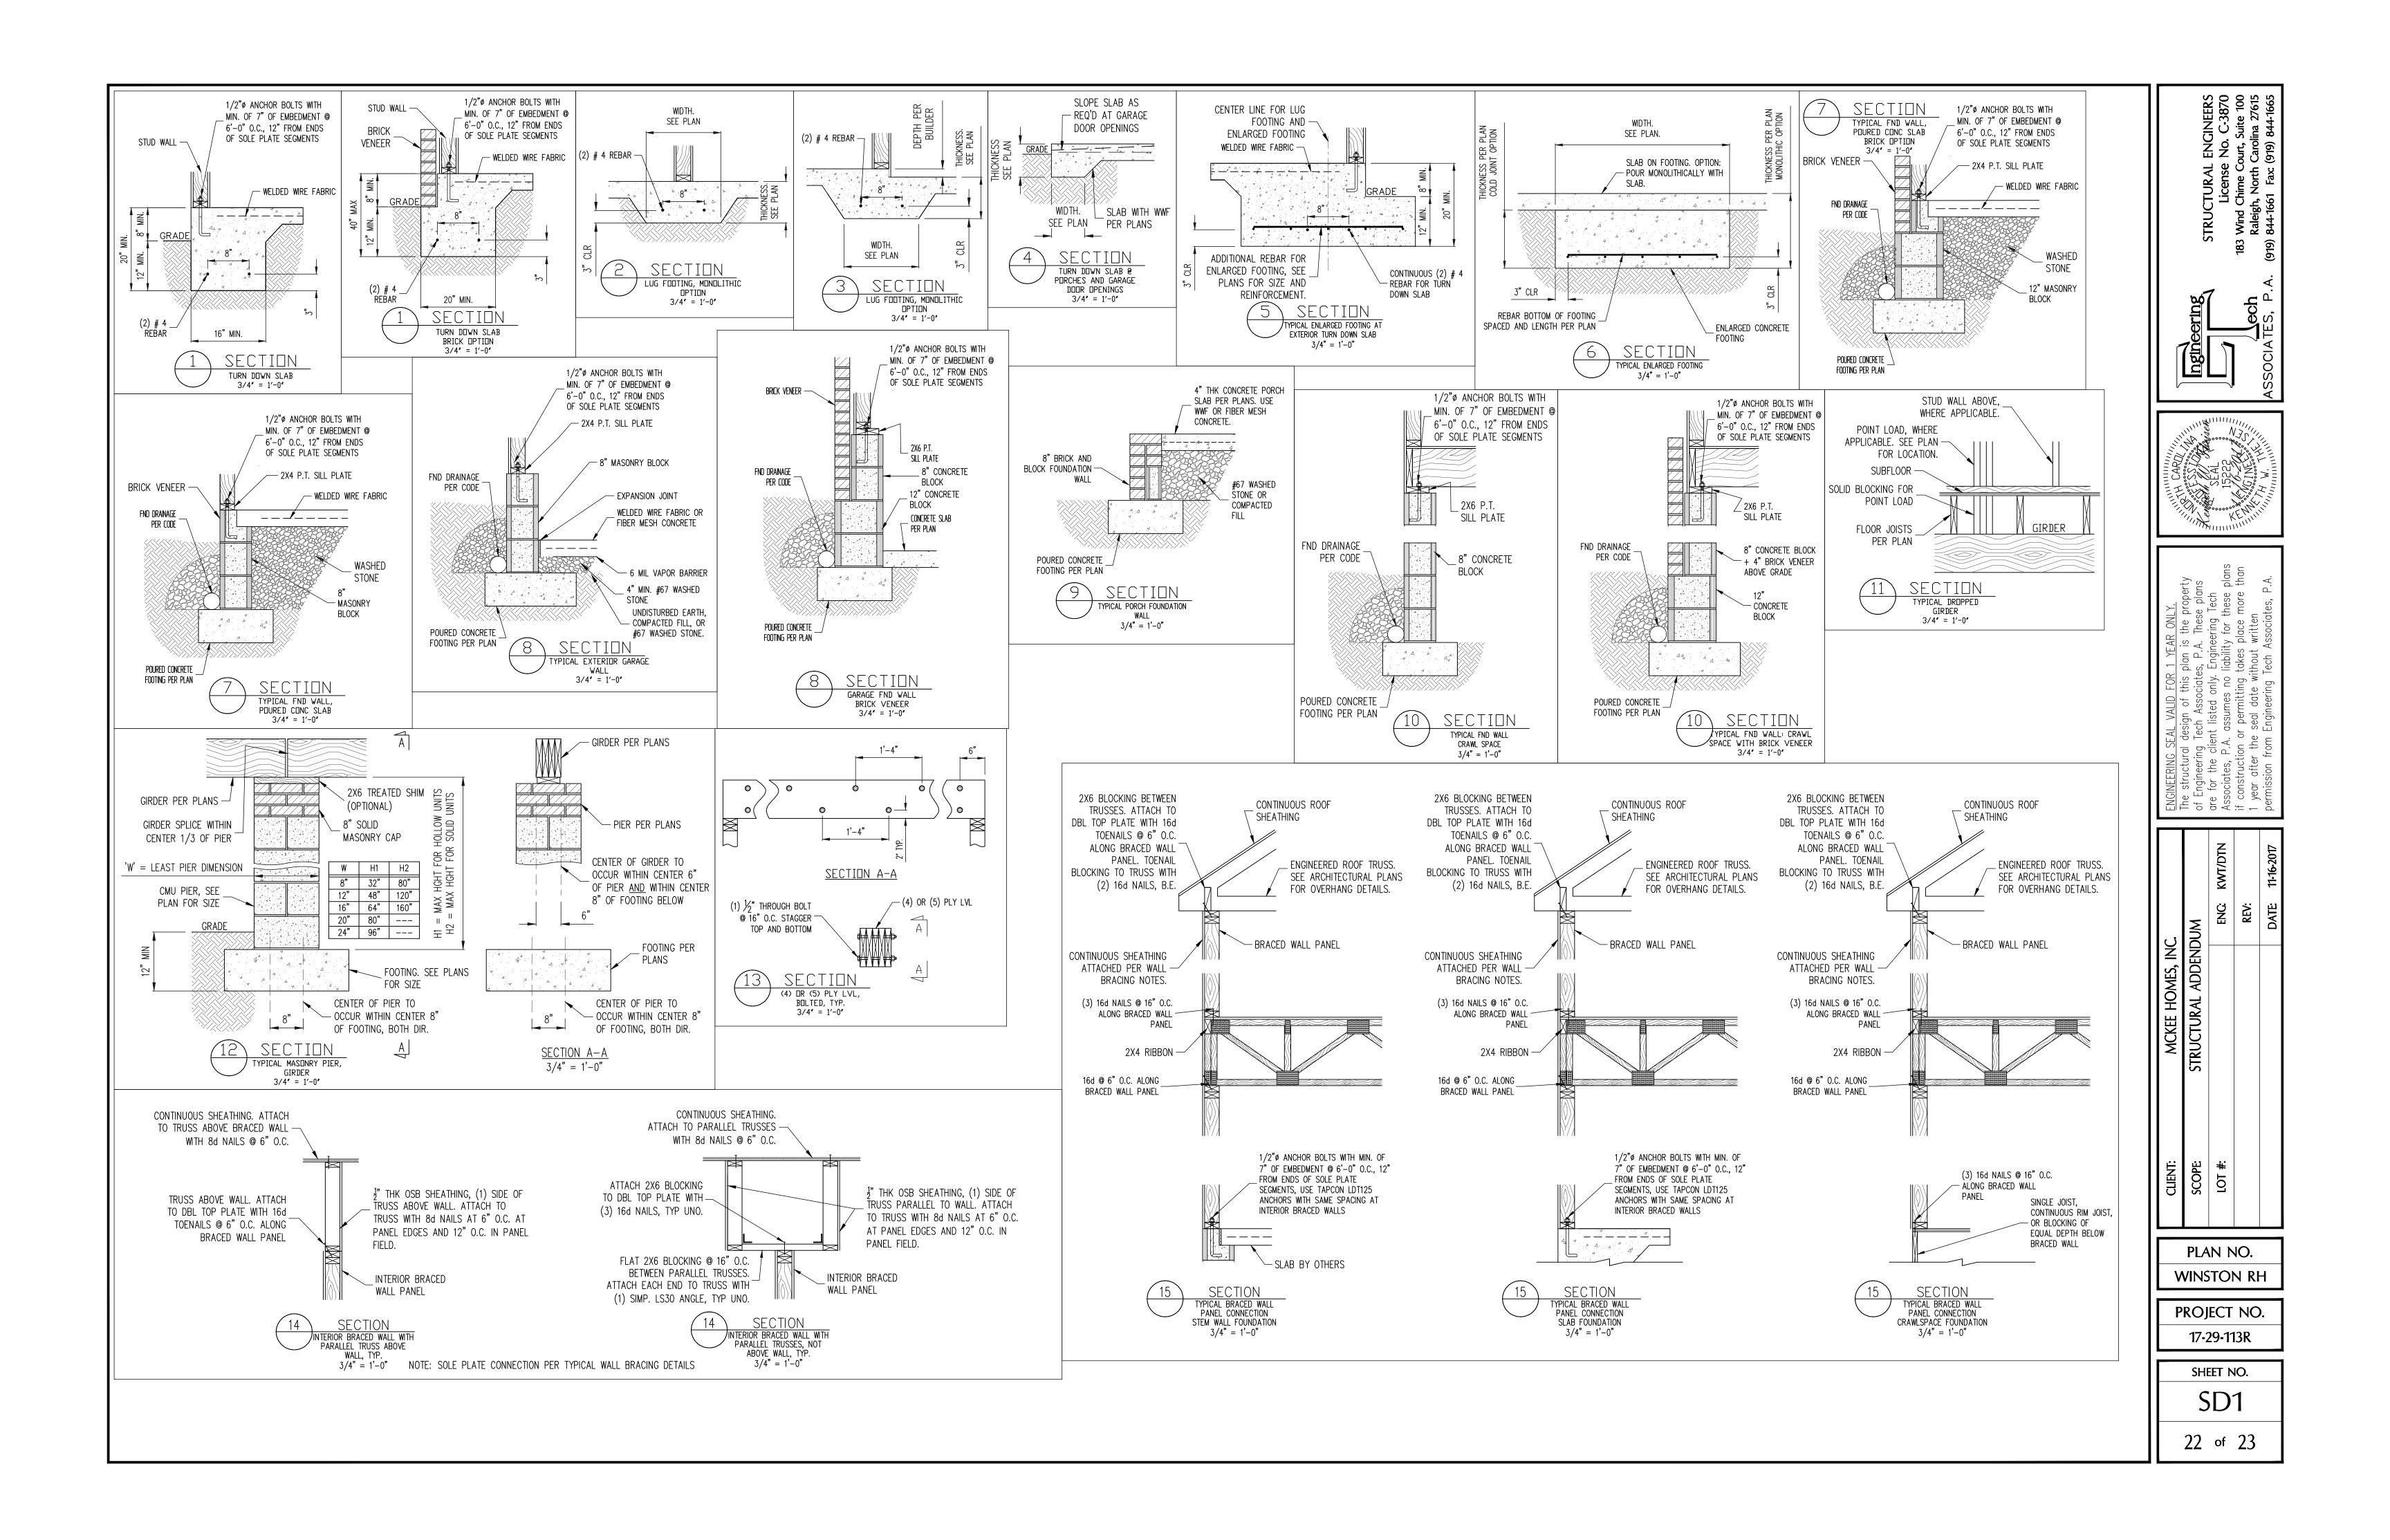

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ENGINEERING SEAL VALID FOR 1 YEAR ONLY.

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		ENG: KWT/DTN		DATE 11-16-2017
ا ر	MUC	ENG	REV:	DATE
CLIENT: MCKEE HOMES, INC.	STRUCTURAL ADDENDUM	;# 1O1		

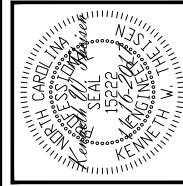PLAN NO. WINSTON RH

PROJECT NO. 17-29-113R

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