PRELIMINARY SITE PLAN REVIEW WIMBERLY AMENITY

TOWN OF ANGIER, NORTH CAROLINA WAKE COUNTY SP-XX-XX

OWNER:

D. CLUGSTON, INC. PULTE GROUP 2506 RELIANCE AVE. 1225 CRESCENT GREEN DRIVE, SUIT 250 APEX, NC 27529 CARY, NC 27518 PHONE: 919-629-7290 PHONE: 919-448-6308

WIMBERLY AMENITY

1225 CRESCENT GREEN DRIVE, SUIT 250

ANGIER, NC 27592

47 SPACES, 2 VAN ACCESSIBILITY SPACES

SITE DATA TABLE

EMAIL: ROBERT.RUDLOFF@PULTEGROUP.COM

PROJECT:

DEVELOPER:

PROJECT ADDRESS

ARCHITECT:

PULTE GROUP 1225 CRESCENT GREEN DRIVE, SUIT 250 CARY, NC 27518 PHONE: 919-448-6308

DEVELOPER:

EMAIL: ROBERT.RUDLOFF@PULTEGROUP.COM

ATTENTION CONTRACTORS

contacting the **Public Works Department** at (919) 996-2409, and

The *Construction Contractor* responsible for the extension of water,

sewer, and/or reuse, as approved in these plans, is responsible for

Failure to notify both City Departments in advance of beginning

construction, will result in the issuance of monetary fines, and require

reinstallation of any water or sewer facilities not inspected as a result

Failure to call for Inspection, Install a Downstream Plug, have

Raleigh Standards will result in a Fine and Possible Exclusion from

Permitted Plans on the Jobsite, or any other Violation of City of

the **Public Utilities Department** at (919) 996-4540 at least

twenty four hours prior to beginning any of their construction.

of this notification failure.

future work in the City of Raleigh.


CIVIL ENGINEER:

TIMMONS GROUP 5410 TRINITY ROAD SUITE 102

RALEIGH, NC 27607

ENGINEER OF RECORD: JIM CHANDLER P.E. PHONE: 919-859-5663 EMAIL: JIM.CHANDLER@TIMMONS.COM

TIMOTHY HESS, RLA PHONE: 984-255-2367 EMAIL: TIM.HESS@TIMMONS.COM

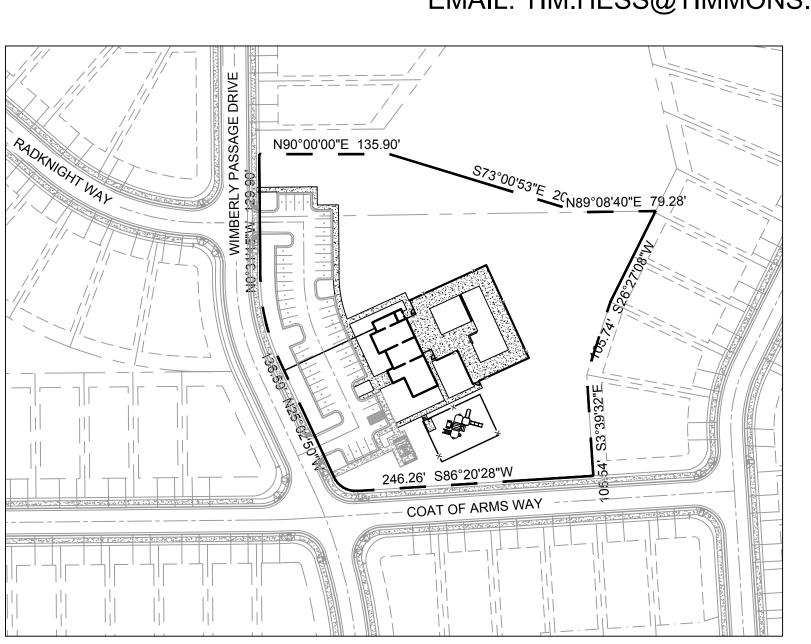

VICINITY MAP 1" = 100'

PRIOR TO ANY LAND DISTURBANCE OR IMPROVEMENTS, CONTRACTOR TO NOTIFY AND COORDINATE WITH ALL UTILITY PROVIDERS FOR LOCATION OF UTILITIES, REQUIRED IMPROVEMENTS, OR REMEDIATION IN AFFECTED WORK AREAS. CONTRACTOR IS TO NOTIFY PROJECT ENGINEER OF ANY REQUIRED ADJUSTMENTS TO THE PLANS BASED ON ANY UTILITY PROVIDER'S REQUIREMENTS AND IS TO REMEDIATE OR UNDERTAKE WORK ONLY AFTER CONSULTATION WITH THE UTILITY PROVIDER, OWNER, AND PROJECT

Type I-A Type II-A and 🖯

0-22,7000 0-12,700

BUILDING TYPE V-B

TOTAL SF

ENCLOSED SF

CONTRACTOR IS TO NOTIFY THE ENGINEER OF ANY CHANGES TO THE PLANS REQUIRED DUE TO APPLICABLE CODES, STANDARDS, AND OR PRACTICES WHICH MIGHT TAKE PRECEDENCE OVER THE DRAWING PLANS PRIOR TO DISTURBANCE AND INSTALLATION OF IMPROVEMENTS. CONTRACTOR WILL BE HELD LIABLE AND WILL INCUR ALL COST ASSOCIATED WITH CORRECTING INSTALLED IMPROVEMENTS IF CONTRACTOR PROCEEDS WITHOUT WITH NOTIFICATION AND/OR IN VIOLATION OF KNOWN CODES, STANDARDS, OR PRACTICES.

CONTRACTOR IS TO NOTIFY THE PROJECT ENGINEER IF CONFLICTS ARE FOUND WITHIN RECTIFYING IMPROVEMENTS IF CONTRACTOR PROCEEDS WITHOUT WITH NOTIFICATION.

SHEET LIST TABLE

Sheet Number	Sheet Title				
C0.0	COVER SHEET				
C1.0	EXISTING CONDITIONS AND DEMOLITION PLAN				
C2.0	OVERALL SITE PLAN				
C3.0	OVERALL UTILITY PLAN				
C4.0	OVERALL GRADING PLAN				
C4.1	DETAILED GRADING PLAN (SHEET 1 OF 2)				
C4.2	DETAILED GRADING PLAN (SHEET 2 OF 2)				
C5.0	EROSION AND SEDIMENT CONTROL PLAN				
C6.0	PLANTING PLAN				
C7.0	LIGHTING PLAN				
C8.0	NOTES AND DETAILS				
C8.1	NOTES AND DETAILS				
C8.2	NOTES AND DETAILS				
C8.3	NOTES AND DETAILS				
A1.0	MAIL KIOSK PLANS				
A1.1	MAIL KIOSK PLANS				
A2.0	CLUBHOUSE & POOL EXTERIOR ELEVATIONS				
A2.1	CLUBHOUSE & POOL EXTERIOR ELEVATIONS				

VICINITY MAP

PART OF PIN 0684-67-2079 DB: 2399 PG: 483 ZONING: ANGIER R-6 CONDITIONAL **EXISTING USE: VACANT** PROPOSED USE: RESIDENTIAL /AMENITY ZONE AE, ZONE X FLOOD ZONE: MAP PANEL NO. 3720068400L. EFFECTIVE DATE 07/19/2022 TOTAL EXISTING TRACT 145.98 AC AREA: PROPOSED TRACT 2.51 AC AREA: 93,930 SF = 2.16 AC **DISTURBED AREA:** EXISTING IMPERVIOUS 17,294 SF = 0.40 AC SURFACE AREA: PROPOSED 0.36 AC (14.3%) IMPERVIOUS SURFACE RECREATIONAL COMMUNITY AREA REQUIRED: POOL CAPACITY **VEHICLE PARKING** 200/4 - 50 SPACES REQUIRED SUMMARY: REQUIRED REQUEST REDUCTION OF 3 TO 47 SPACES

GENERAL NOTES

- CONTACT THE NORTH CAROLINA ONE CALL CENTER PRIOR TO DOING ANY DIGGING 1 -800-532-4949. 2. PLEASE CONTACT TOWN OF ANGIER ENGINEERING INSPECTOR TO SCHEDULE A PRE CONSTRUCTION MEETING PRIOR TO OBTAINING BUILDING PERMITS FOR THIS PLAN.
- 3. CONTACT THE TOWN OF ANGIER ENGINEERING DEPARTMENT PRIOR TO CONVERSION OF ANY ASSOCIATED
- SCM FROM AN EROSION CONTROL DEVICE TO A STORMWATER CONTROL MEASURE. 4. A NEIGHBORHOOD RECREATION AMENITY AREA IS PROPOSED WITHIN THE DEVELOPMENT TO INCLUDE A CABANA AND POOL. THE CABANA SHALL INCLUDE A MINIMUM OF 500 SQUARE FOOT COVERED AREA AND
- BATHROOMS FOR A MINIMUM 3,000 SQUARE FOOT POOL. 5. FOLLOWING THE RECORDATION OF THE FIRST FINAL PLAT THE NEIGHBORHOOD RECREATION AMENITY AREA SHALL BE COMPLETED WITHIN 18 MONTHS.

IMPERVIOUS SURFACE

ORIGINAL IMPERVIOUS PROPOSED

IMPERVIOUS ASPHALT PAVEMENT =

AMENITY AREAS/MAIL KIOSK IMPERVIOUS AREA = 2.0 AC

VEHICLE PARKING

SUMMARY: PROVIDED

EXISTING PARKING LOT PRIOR TO BUILDING AND POOL CONSTRUCTION

15,984 SF

IMPERVIOUS SIDEWALK =	1,310 SF
TOTAL EXISTING SURFACE =	17,294 SF
PROPOSED CONSTRUCTION	
IMPERVIOUS ASPHALT PAVEMENT =	0 SF
IMPERVIOUS SIDEWALK =	3,650 SF
BUILDING SURFACE =	3,138 SF
POOL DECK =	5,748 SF
POOL =	2,953 SF
TOTAL PROPOSED SURFACE =	15,489 SF

INIERASTRI ICTI IRE DATA

6" SEWER SERVICE

FIRE HYDRANTS

NFRASTRUCTURE DATA	
F OF PUBLIC STREETS	0 LF
F OF PUBLIC SIDEWALK	0 LF
F OF PUBLIC CURB AND GUTTER	0 LF
NUMBER OF SCM'S	0
F 8" SDR 35 PVC SANITARY SEWER	0 LF
F 6" SDR 35 PVC SANITARY SEWER SERVICE	1 LF
F 6" DIP WATERMAIN	0 LF
F 8" DIP WATERMAIN	0 LF
" DOMESTIC WATER SERVICE	1
2" DOMESTIC WATER SERVICE	0
B" DOMESTIC WATER SERVICE	0
S" FIRE SERVICE	0


CONTRACTOR NOTES

THE PLAN SET PRIOR TO ANY DISTURBANCE AND INSTALLATION OF IMPROVEMENTS. CONTRACTOR WILL BE HELD LIABLE AND WILL INCUR ALL COST ASSOCIATED WITH

	ı		WIMBERI CALCULATI		ITY V construction				
FIRE	FLOW CALCULA	TION ARE ((Square Fe	et)	FIRE-FLOW	FLOW DURATION		Town of Angier	
I-A	Type II-A and	Type IV	Type II-B					Engineering Department	
В	III-A	and V-A	and III-B	Type V-B	(Gallons per minute)	(Hours)	Λ [PPROVED	
7000	0-12,700	0-8,200	0-5,900	0-3,600	1,500	2			
ING T	YPE V-B								
L SF		3,130	INCLUDES	EXTERIOR	PORCH				
OSED S	SF	1,936	HEATED		1,500		SIGNED	Е	ATE

ALL CONSTRUCTION TO BE IN ACCORDANCE WITH ALL TOWN OF ANGIER STANDARDS, SPECIFICATIONS, AND DETAILS.



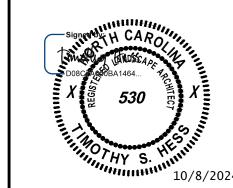


10/08/2024

DRAWN BY 331 DESIGNED BY

331 CHECKED BY T. HESS

49578 SHEET NO. C0.0

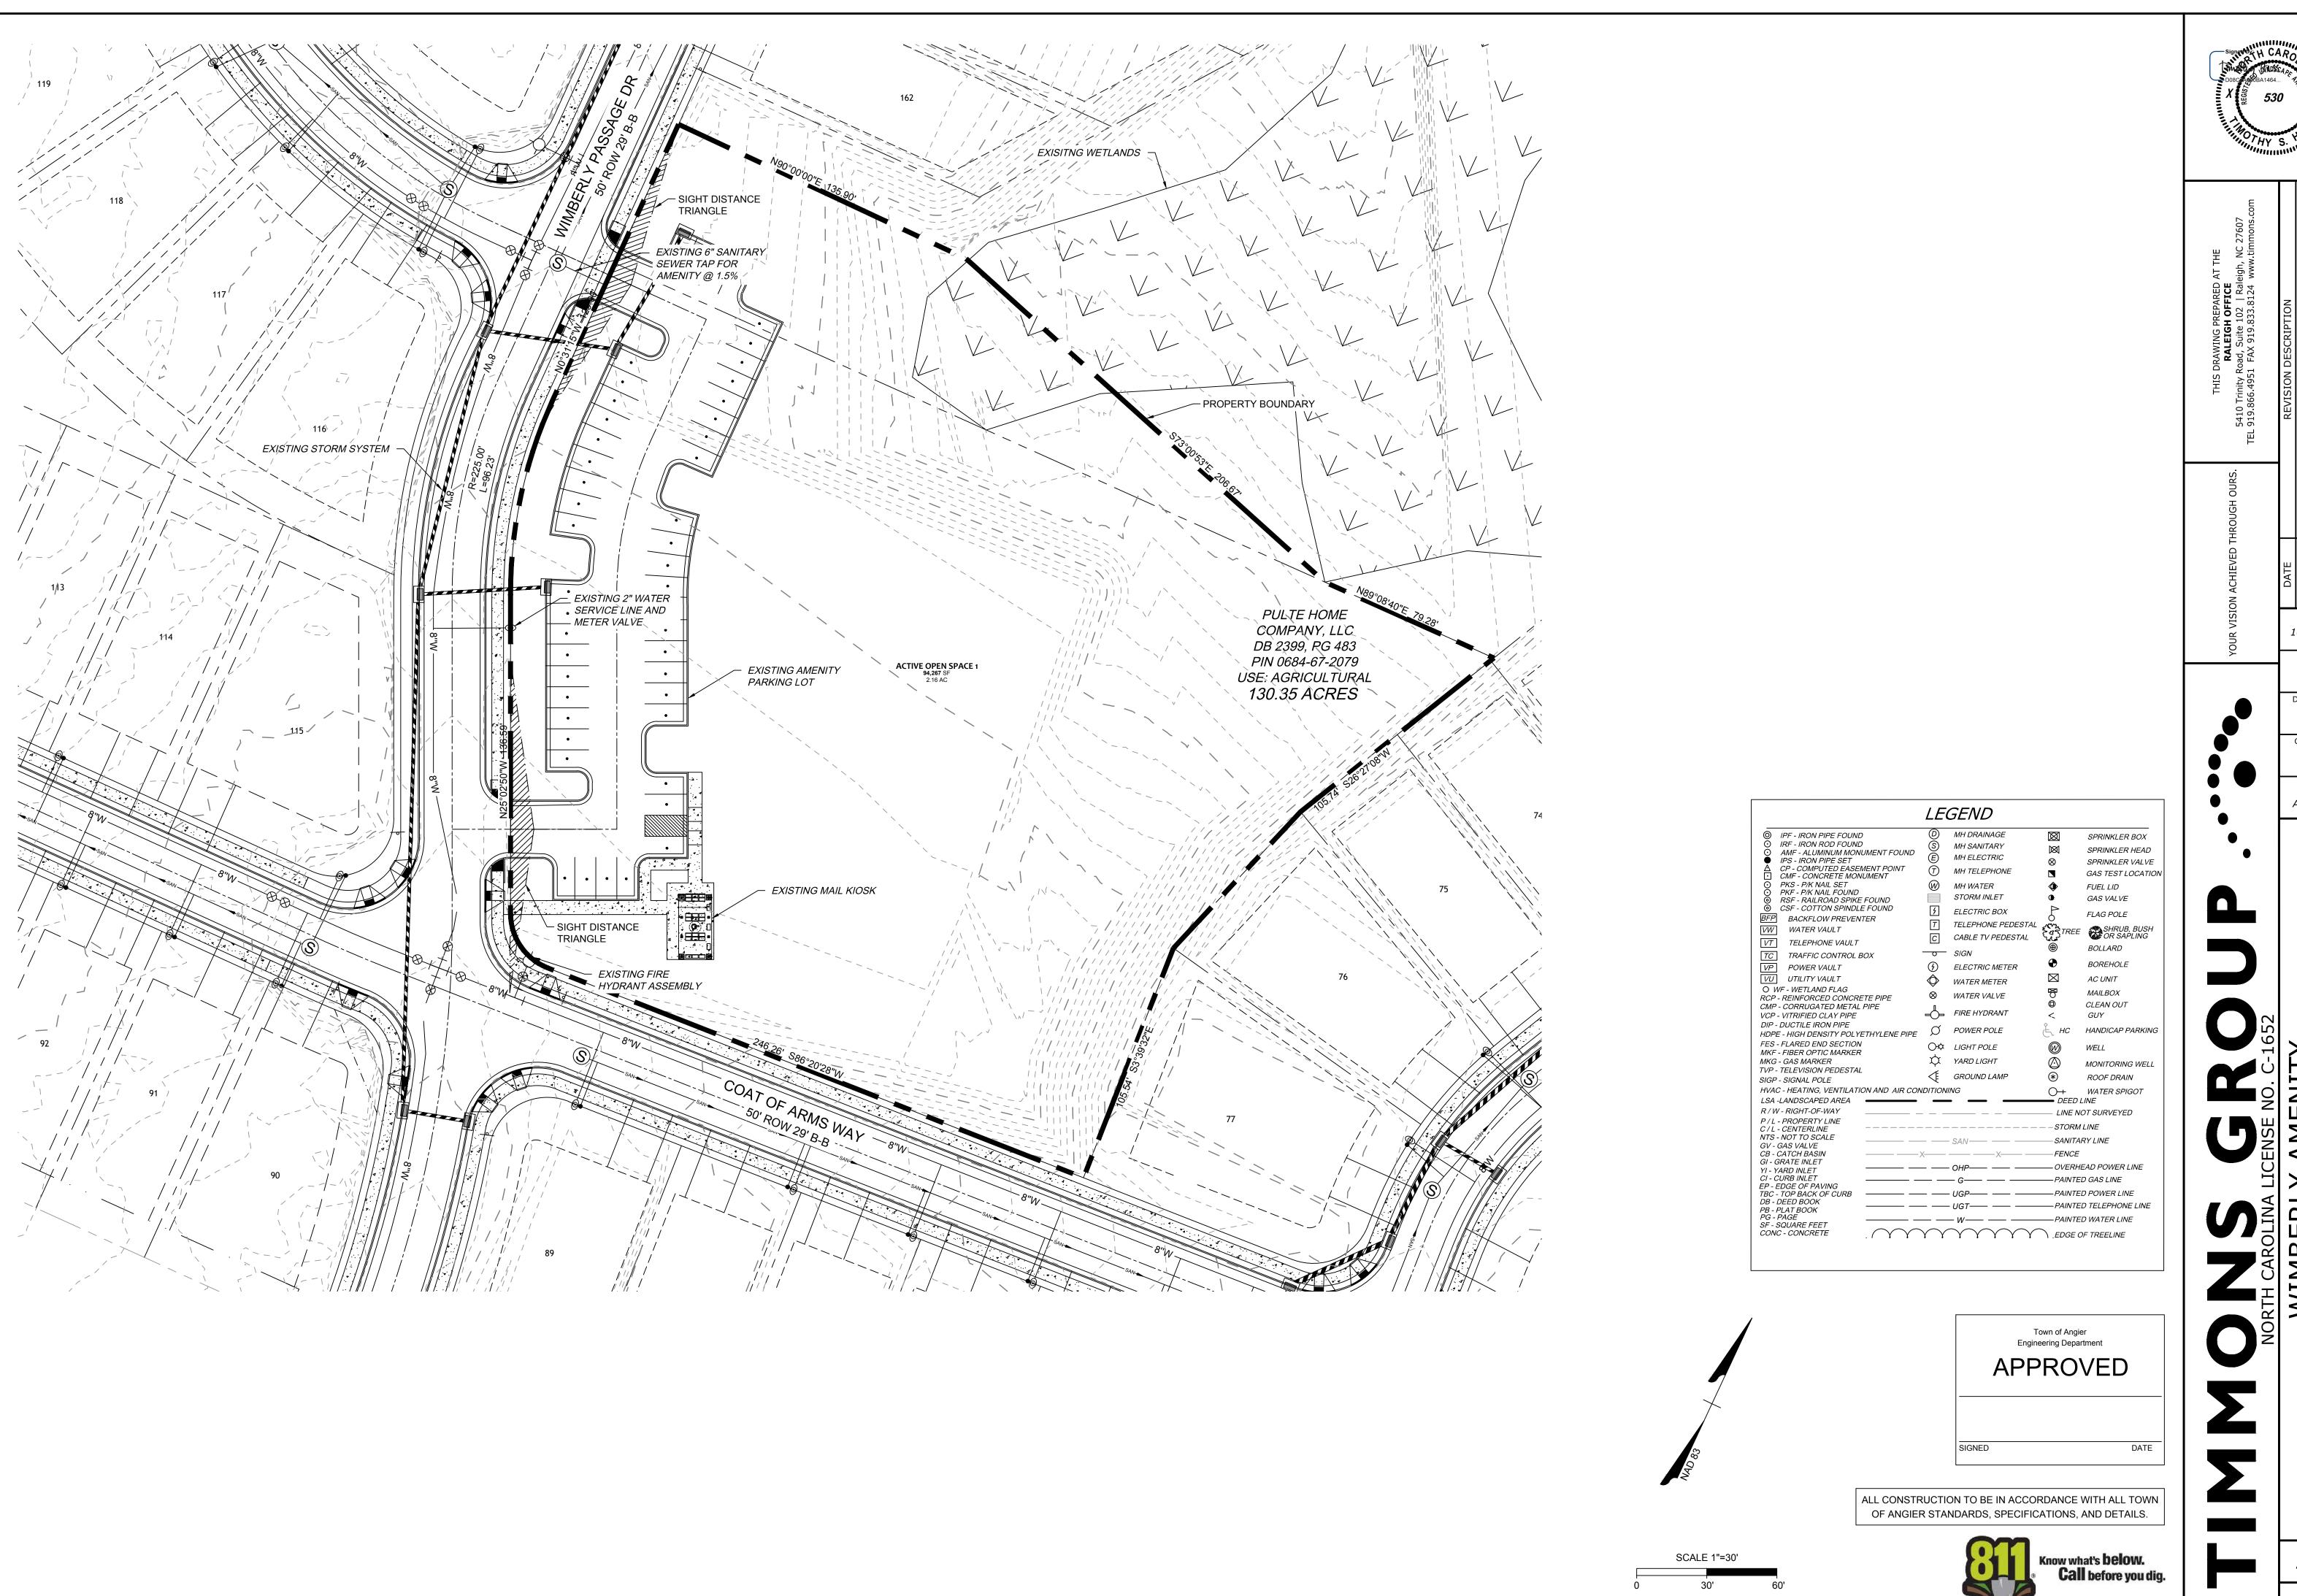


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COORDINATE WITH ALL UTILITY PROVIDERS FOR LOCATION OF UTILITIES, REQUIRED IMPROVEMENTS, OR REMEDIATION IN AFFECTED WORK AREAS. CONTRACTOR IS TO NOTIFY PROJECT ENGINEER OF ANY REQUIRED ADJUSTMENTS TO THE PLANS BASED ON ANY UTILITY PROVIDER'S REQUIREMENTS AND IS TO REMEDIATE OR UNDERTAKE WORK ONLY AFTER

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CONSULTATION WITH THE UTILITY PROVIDER, OWNER, AND PROJECT ENGINEER.

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SET PRIOR TO ANY DISTURBANCE AND INSTALLATION OF IMPROVEMENTS. CONTRACTOR WILL BE HELD LIABLE AND WILL INCUR ALL COST ASSOCIATED WITH RECTIFYING IMPROVEMENTS IF



10/08/2024

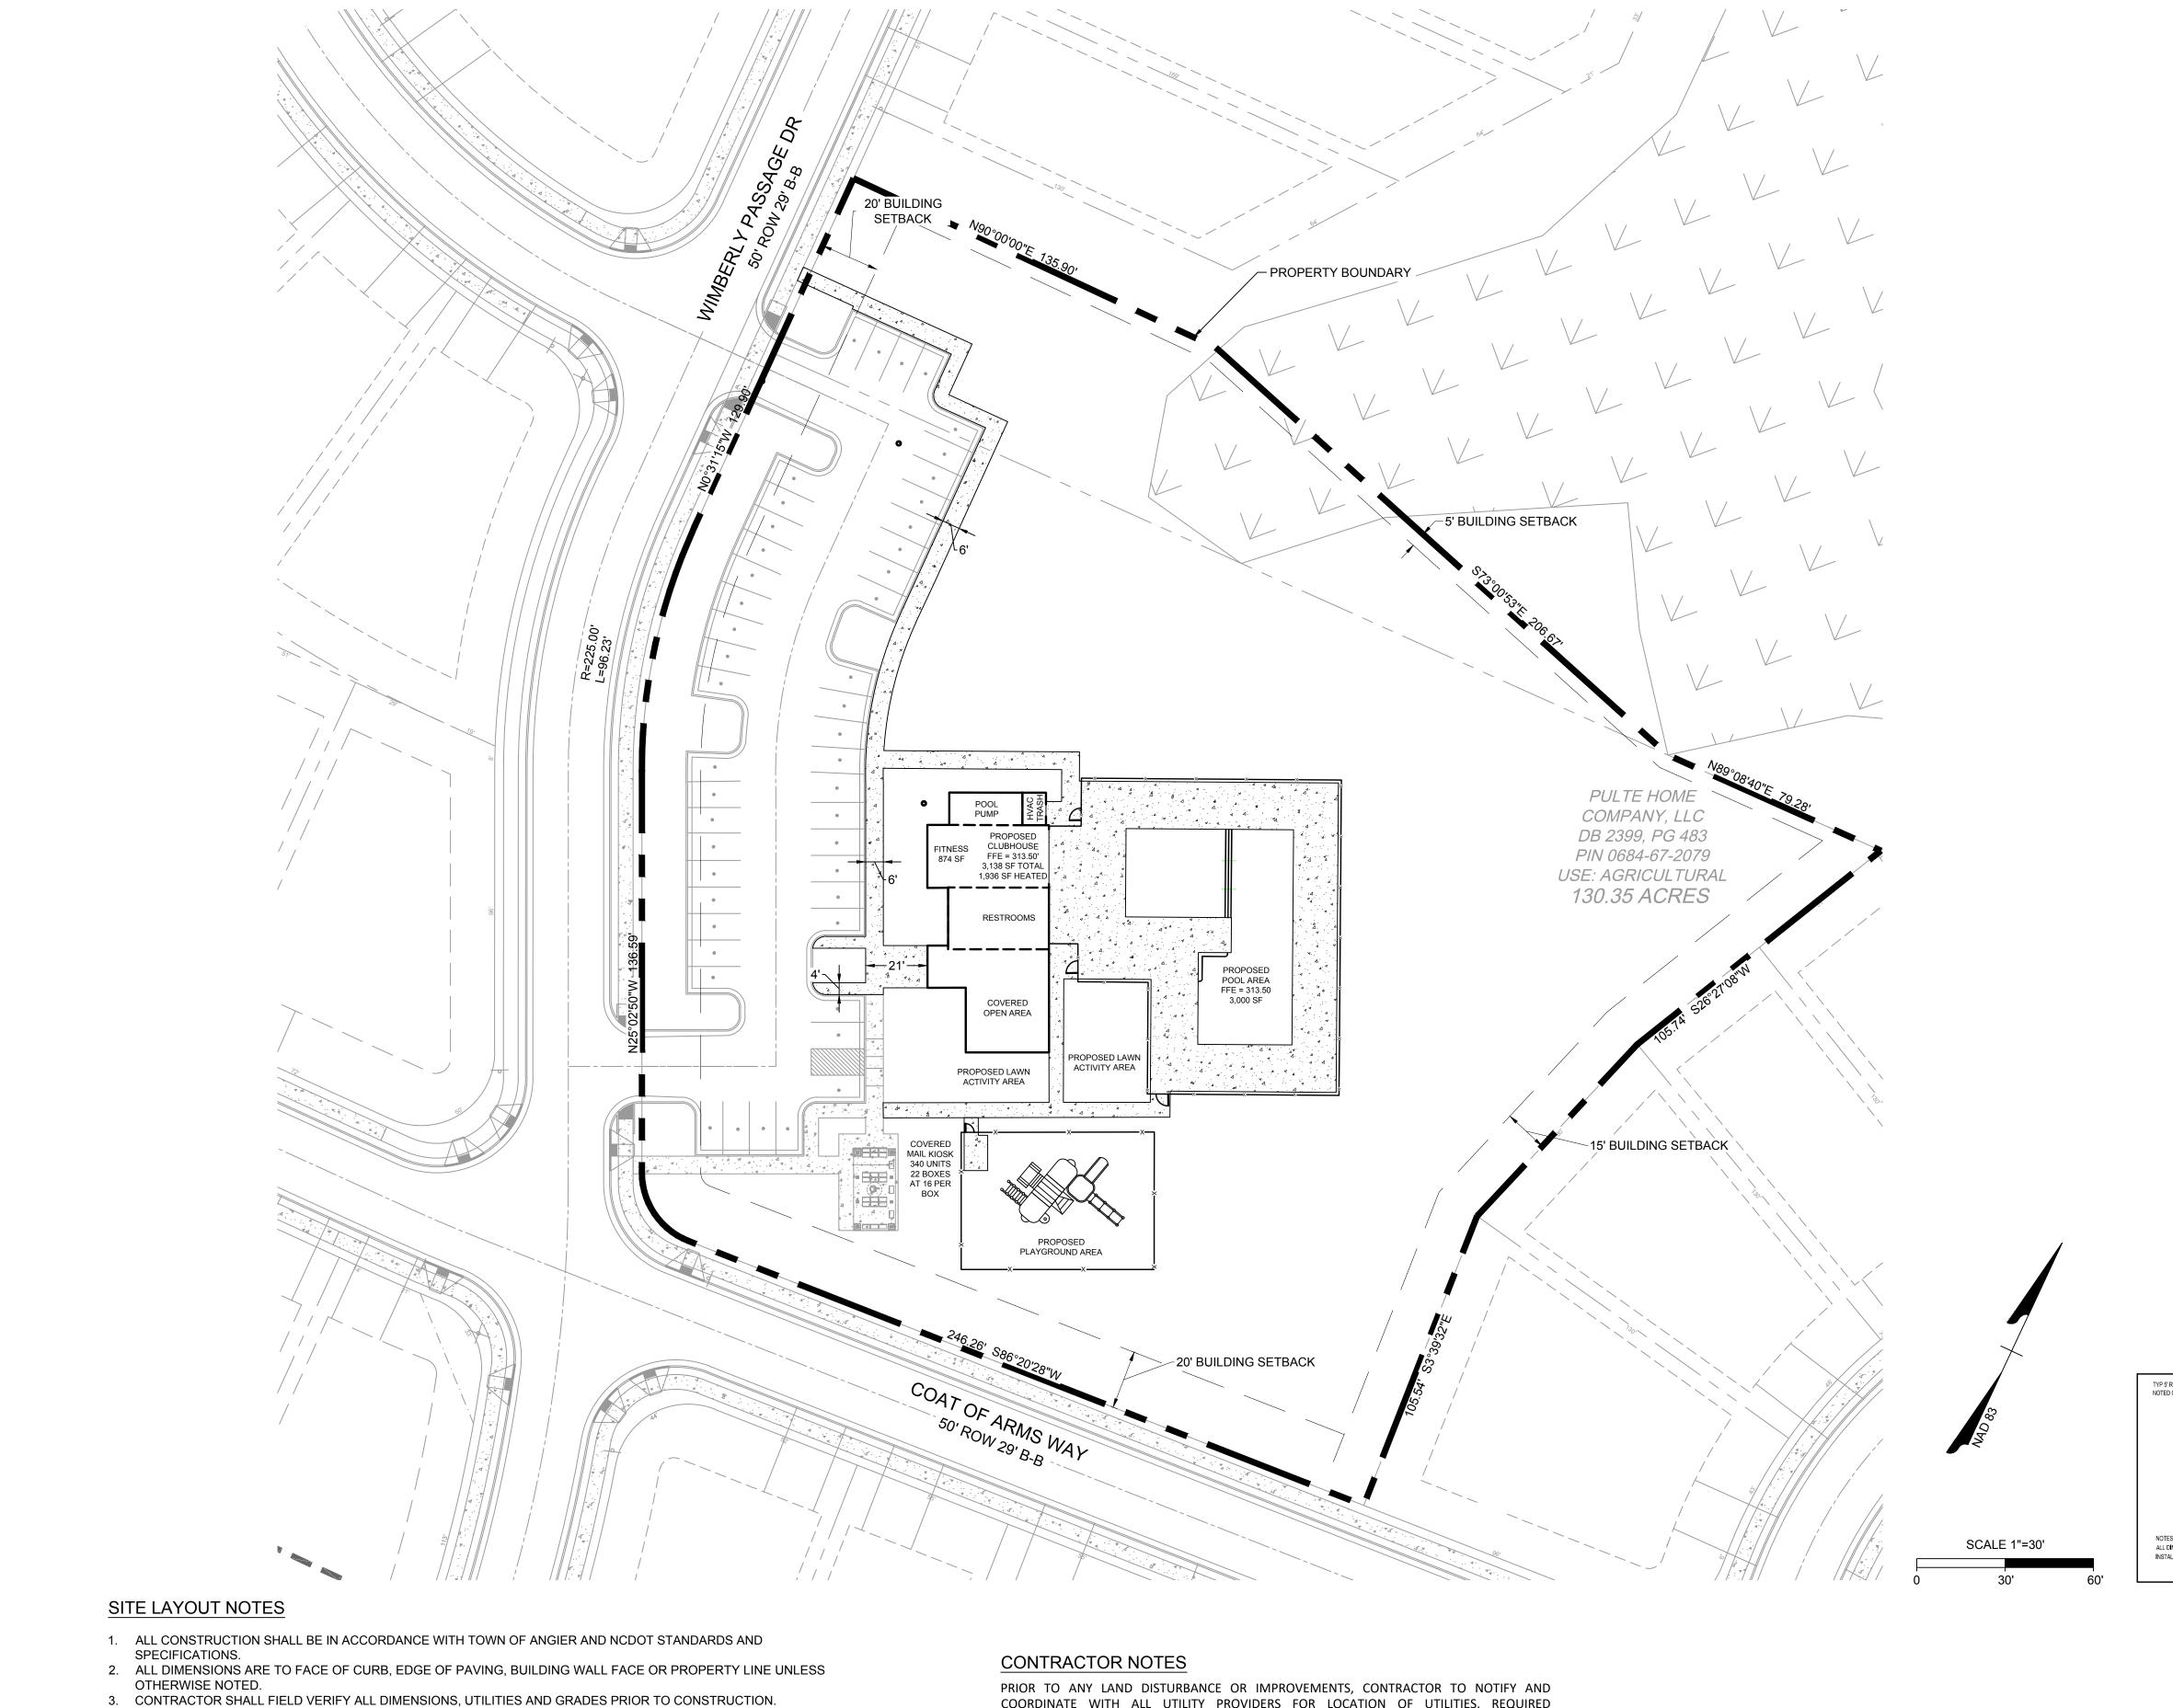DESIGNED BY

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AS SHOWN

ALL SIGNS SHALL BE MOUNTED WITH 5-FT MIN. VERTICAL CLEARANCE TO THE BOTTOM OF THE SIGN ON 2-LB. GALV. STEEL U-CHANNEL POST SET IN 18-IN DEEP \times 8-IN DIA. CONCRETE FOOTING. SIGNS MOUNTED ADJACENT TO SIDEWALKS MUST BE MOUNTED WITH 7-FT MIN. VERTICAL CLEARANCE

ALL PAVMENT MARKINGS SHALL BE IN ACCORDANCE WITH THE MUTCD AND PARKING SPACE NO PARKING - FIRE LANE * CROSSWALK


TRAFFIC CONTROL NOTES

ACCESSIBLE PARKING

TO THE BOTTOM OF SIGN.

ALL SITE SIGNAGE SHALL BE IN ACCORDANCE WITH THE MANUAL ON UNIFORM TRAFFIC CONTROL DEVICES (MUTCD) AND NCDOT STANDARDS.


* NO PARKING - FIRE LANE MARKING SHALL CONSIST OF A 4" SOLID YELLOW STRIPE AND 8" HIGH YELLOW TEXT "NO PARKING - FIRE LANE" AT 40' INTERVALS. STRIPING SHALL BE PLACED AS INDICATED BY THE FOLLOWING LINETYPE ALL PAVMENT MARKINGS SHALL BE RESIN TYPE PAINT AS REQUIRED BY THE COUNTY.

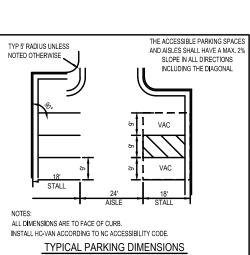

PROPERTY LINE EXISTING RIGHT-OF-WAY EXISTING ROAD CENTERLINE ADJACENT PROPERTY LINE PROPOSED RIGHT-OF-WAY — - — PROPOSED CENTERLINE PROPOSED EOP — — — BUILDING SETBACK PROPOSED LOT LINE PERIMETER BUFFER ----- DRAINAGE EASEMENT SANITARY SEWER EASEMENT PHASE LINE

● ● ● ● · PROPOSED 100 YR FLOODPLAIN EXISTING WETLANDS NEUSE RIPARIAN BUFFER CIVIC SPACE

Town of Angier

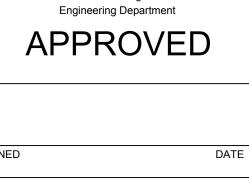

ALL CONSTRUCTION TO BE IN ACCORDANCE WITH ALL TOWN OF ANGIER STANDARDS, SPECIFICATIONS, AND DETAILS.



JOB NO. 49578 SHEET NO.

C2.0

CONTRACTOR SHALL NOTIFY THE ENGINEER OF ANY EXISTING DISCREPANCIES PRIOR TO COMMENCING ANY

7. CONTRACTOR SHALL NOTIFY THE ENGINEER OF ANY DIMENSIONAL CONFLICTS PRIOR TO THE BEGINNING OF

10. ALL DRIVEWAY DESIGN AND CONSTRUCTION MUST COMPLY WITH TOWN OF ANGIER. DRIVEWAYS SHALL BE

9. ALL DISTURBED CURB & GUTTER AND ASPHALT SHALL BE REPLACED PER TOWN OF ANGIER OR NCDOT STANDARDS

11. NO SIGHT OBSTRUCTING OR PARTIALLY OBSTRUCTING WALL, FENCE, FOLIAGE, BERMING, PARKED VEHICLES OR SIGN

BETWEEN THE HEIGHTS OF TWENTY-FOUR (24) INCHES AND EIGHT (8) FEET ABOVE THE CURB LINE ELEVATION, OR

THE NEAREST TRAVELED WAY IF NO CURBING EXISTS, SHALL BE PLACED WITHIN A SIGHT TRIANGLE OF A PUBLIC STREET, PRIVATE STREET OR DRIVEWAY CONTAINED EITHER ON THE PROPERTY OR ON AN ADJOINING PROPERTY.

CAROLINA ONE CALL" (811) OR (1-800-632-4949) TO HAVE EXISTING UTILITIES LOCATED.

PARKING SPACES ARE 9' WIDE X 18' LONG STANDARD ACCESS AISLES.

8. ALL CURB AND GUTTER ONSITE SHALL BE 24" WIDE.

12. ALL PAVEMENT MARKINGS TO BE THERMOPLASTIC PAINT.

6. REFER TO ARCHITECTURAL DRAWINGS FOR DIMENSIONS OF THE BUILDING.


4. AT LEAST 3-12 BUSINESS DAYS PRIOR TO CONSTRUCTION OR EXCAVATION THE CONTRACTOR SHALL NOTIFY "NORTH

RELATED CONSTRUCTION.

CONSTRUCTION.

AND SPECIFICATIONS.

PERMITTED SEPARATELY.

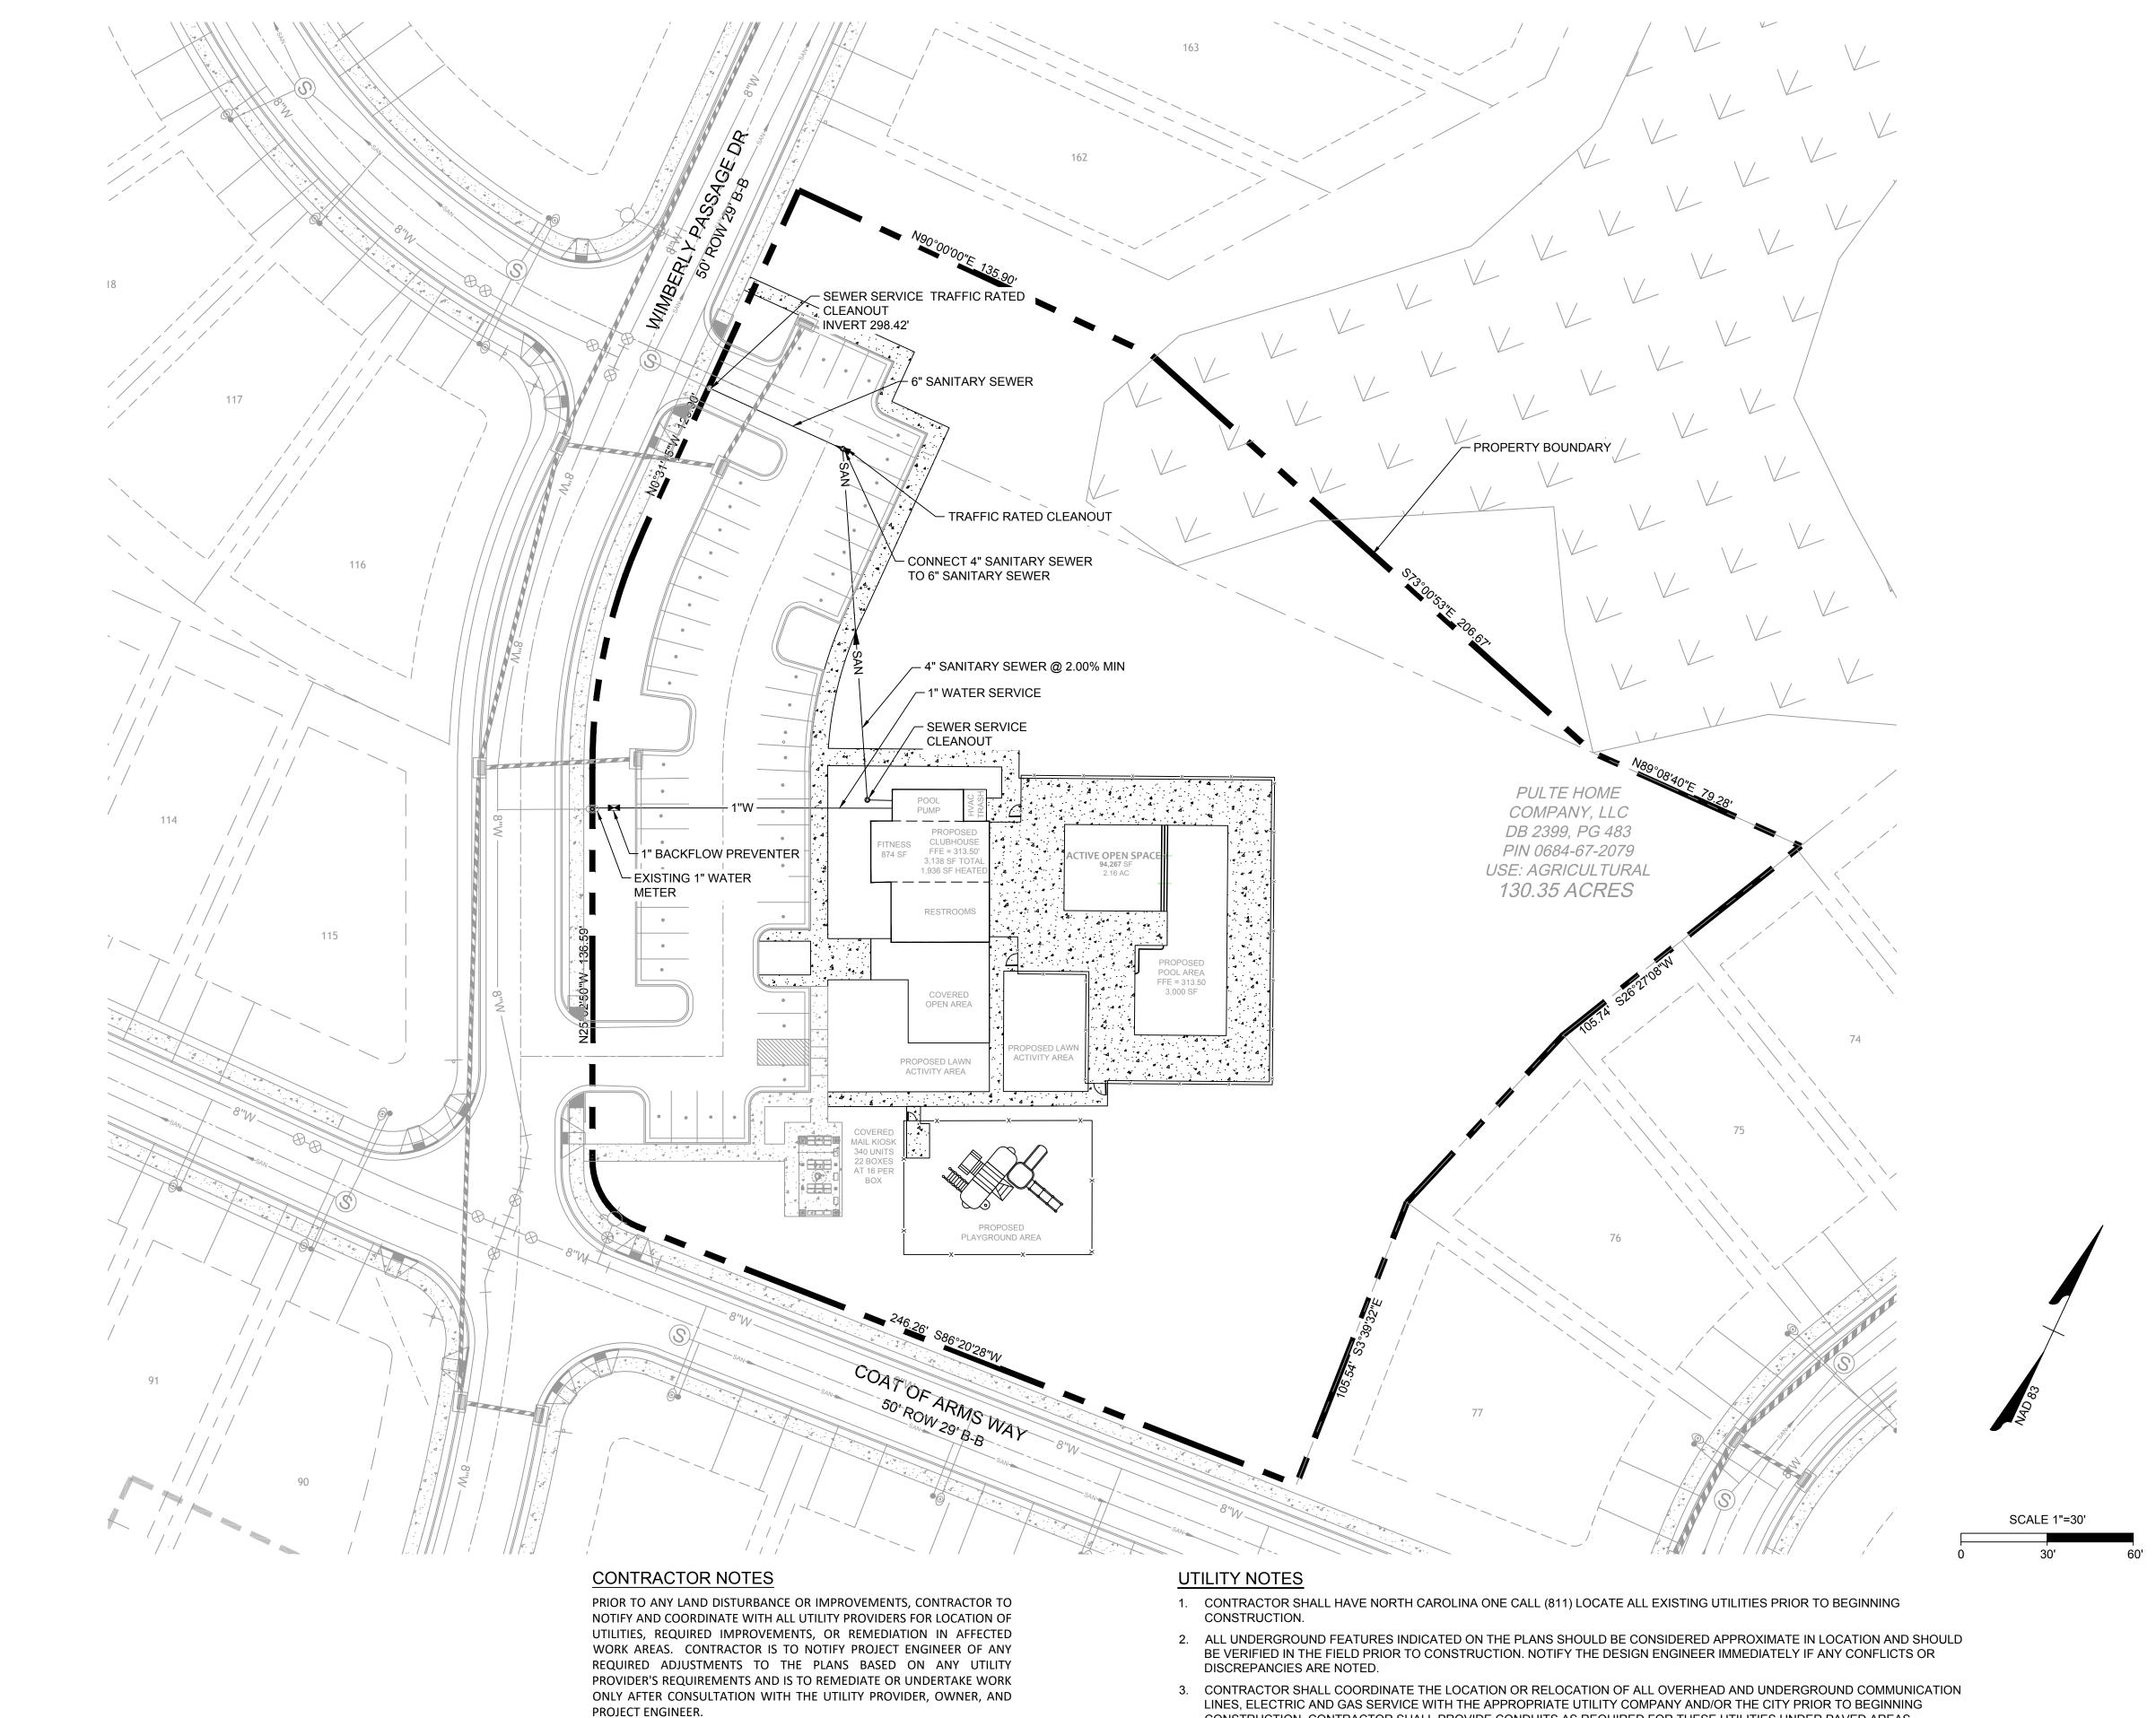

CONTRACTOR IS TO NOTIFY THE ENGINEER OF ANY CHANGES TO THE

PLANS REQUIRED DUE TO APPLICABLE CODES, STANDARDS, AND OR

PRACTICES WHICH MIGHT TAKE PRECEDENCE OVER THE DRAWING PLANS

PRIOR TO DISTURBANCE AND INSTALLATION OF IMPROVEMENTS.

CONTRACTOR WILL BE HELD LIABLE AND WILL INCUR ALL COST

ASSOCIATED WITH CORRECTING INSTALLED IMPROVEMENTS IF

CONTRACTOR PROCEEDS WITHOUT WITH NOTIFICATION AND/OR IN

CONTRACTOR IS TO NOTIFY THE PROJECT ENGINEER IF CONFLICTS ARE

FOUND WITHIN THE PLAN SET PRIOR TO ANY DISTURBANCE AND

INSTALLATION OF IMPROVEMENTS. CONTRACTOR WILL BE HELD LIABLE AND WILL INCUR ALL COST ASSOCIATED WITH RECTIFYING IMPROVEMENTS

VIOLATION OF KNOWN CODES, STANDARDS, OR PRACTICES.

IF CONTRACTOR PROCEEDS WITHOUT WITH NOTIFICATION.

- CONSTRUCTION. CONTRACTOR SHALL PROVIDE CONDUITS AS REQUIRED FOR THESE UTILITIES UNDER PAVED AREAS.
- 4. ALL ILLUSTRATED UTILITY INFRASTRUCTURE IS DIAGRAMMATIC AND MAY NOT REPRESENT THE ACTUAL SIZE OF INFRASTRUCTURE. NOTIFY THE DESIGN ENGINEER IMMEDIATELY IF ANY CONFLICTS OR DISCREPANCIES ARE NOTED.
- 5. ALL MATERIALS AND METHODS OF CONSTRUCTION SHALL BE IN ACCORDANCE WITH THE TOWN OF ANGIER AND THE STATE OF NORTH CAROLINA STANDARDS AND SPECIFICATIONS.
- 6. ALL WATER METERS SHALL BE PROVIDED AND INSTALLED BY THE TOWN OF ANGIER PUBLIC UTILITIES DEPARTMENT METERS
- 7. METERS WILL BE THE SAME SIZE IN DIAMETER AS THE SERVICE.
- 8. A 3' CLEAR SPACE SHALL BE MAINTAINED AROUND ALL WATER METERS.
- 9. ALL 6" SANITARY SEWER SERVICES CONNECTIONS SHALL BE MADE INTO MANHOLES ONLY.
- 10. ALL DISTURBED HARDSCAPE AND LANDSCAPING (CONCRETE, ASPHALT, BRICK, TREES, SHRUBS, ETC) SHALL BE REPLACED ACCORDING TO TOWN OF ANGIER AND NCDOT STANDARDS AND SPECIFICATIONS.

EWER		LEGEN	<u>ID</u>
	— SAN-		EXISTING SANITARY SEWER
	— SAN-		SANITARY SEWER
	S		SANITARY MANHOLE
VATER			
	W		EXISTING WATER LINE
	W		PROPOSED WATER LINE
	8		WATER VALVE
	-Ф-		FIRE HYDRANT

Town of Angie Engineering Depar	
APPRO'	VED
SIGNED	DATE

BLOWOFF ASSEMBLY

ALL CONSTRUCTION TO BE IN ACCORDANCE WITH ALL TOWN OF ANGIER STANDARDS, SPECIFICATIONS, AND DETAILS.



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THIS DRAWING PREPARED AT THE RALEIGH OFFICE 5410 Trinity Road, Suite 102 Raleigh, NC 27607 TEL 919.866.4951 FAX 919.833.8124 www.timmons.com	REVISION DESCRIPTION					
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1 MORTH CAROLINA LICENSE NO. C-1652				WIMBERLY RD, IOWN OF ANGIER, WAKE COUNTY, NORTH CAROLINA	OVEDALL LITTLI TAV DLAN	OVERALE ULILLI FEAIN

SHEET NO.

C3.0

17,294 SF

0 SF

3,377 SF

3.138 SF

6,692 SF

3,017 SF

16,224 SF

TOTAL EXISTING SURFACE =

IMPERVIOUS SIDEWALK =


TOTAL PROPOSED SURFACE =

BUILDING SURFACE =

POOL DECK =

PROPOSED CONSTRUCTION

IMPERVIOUS ASPHALT PAVEMENT =

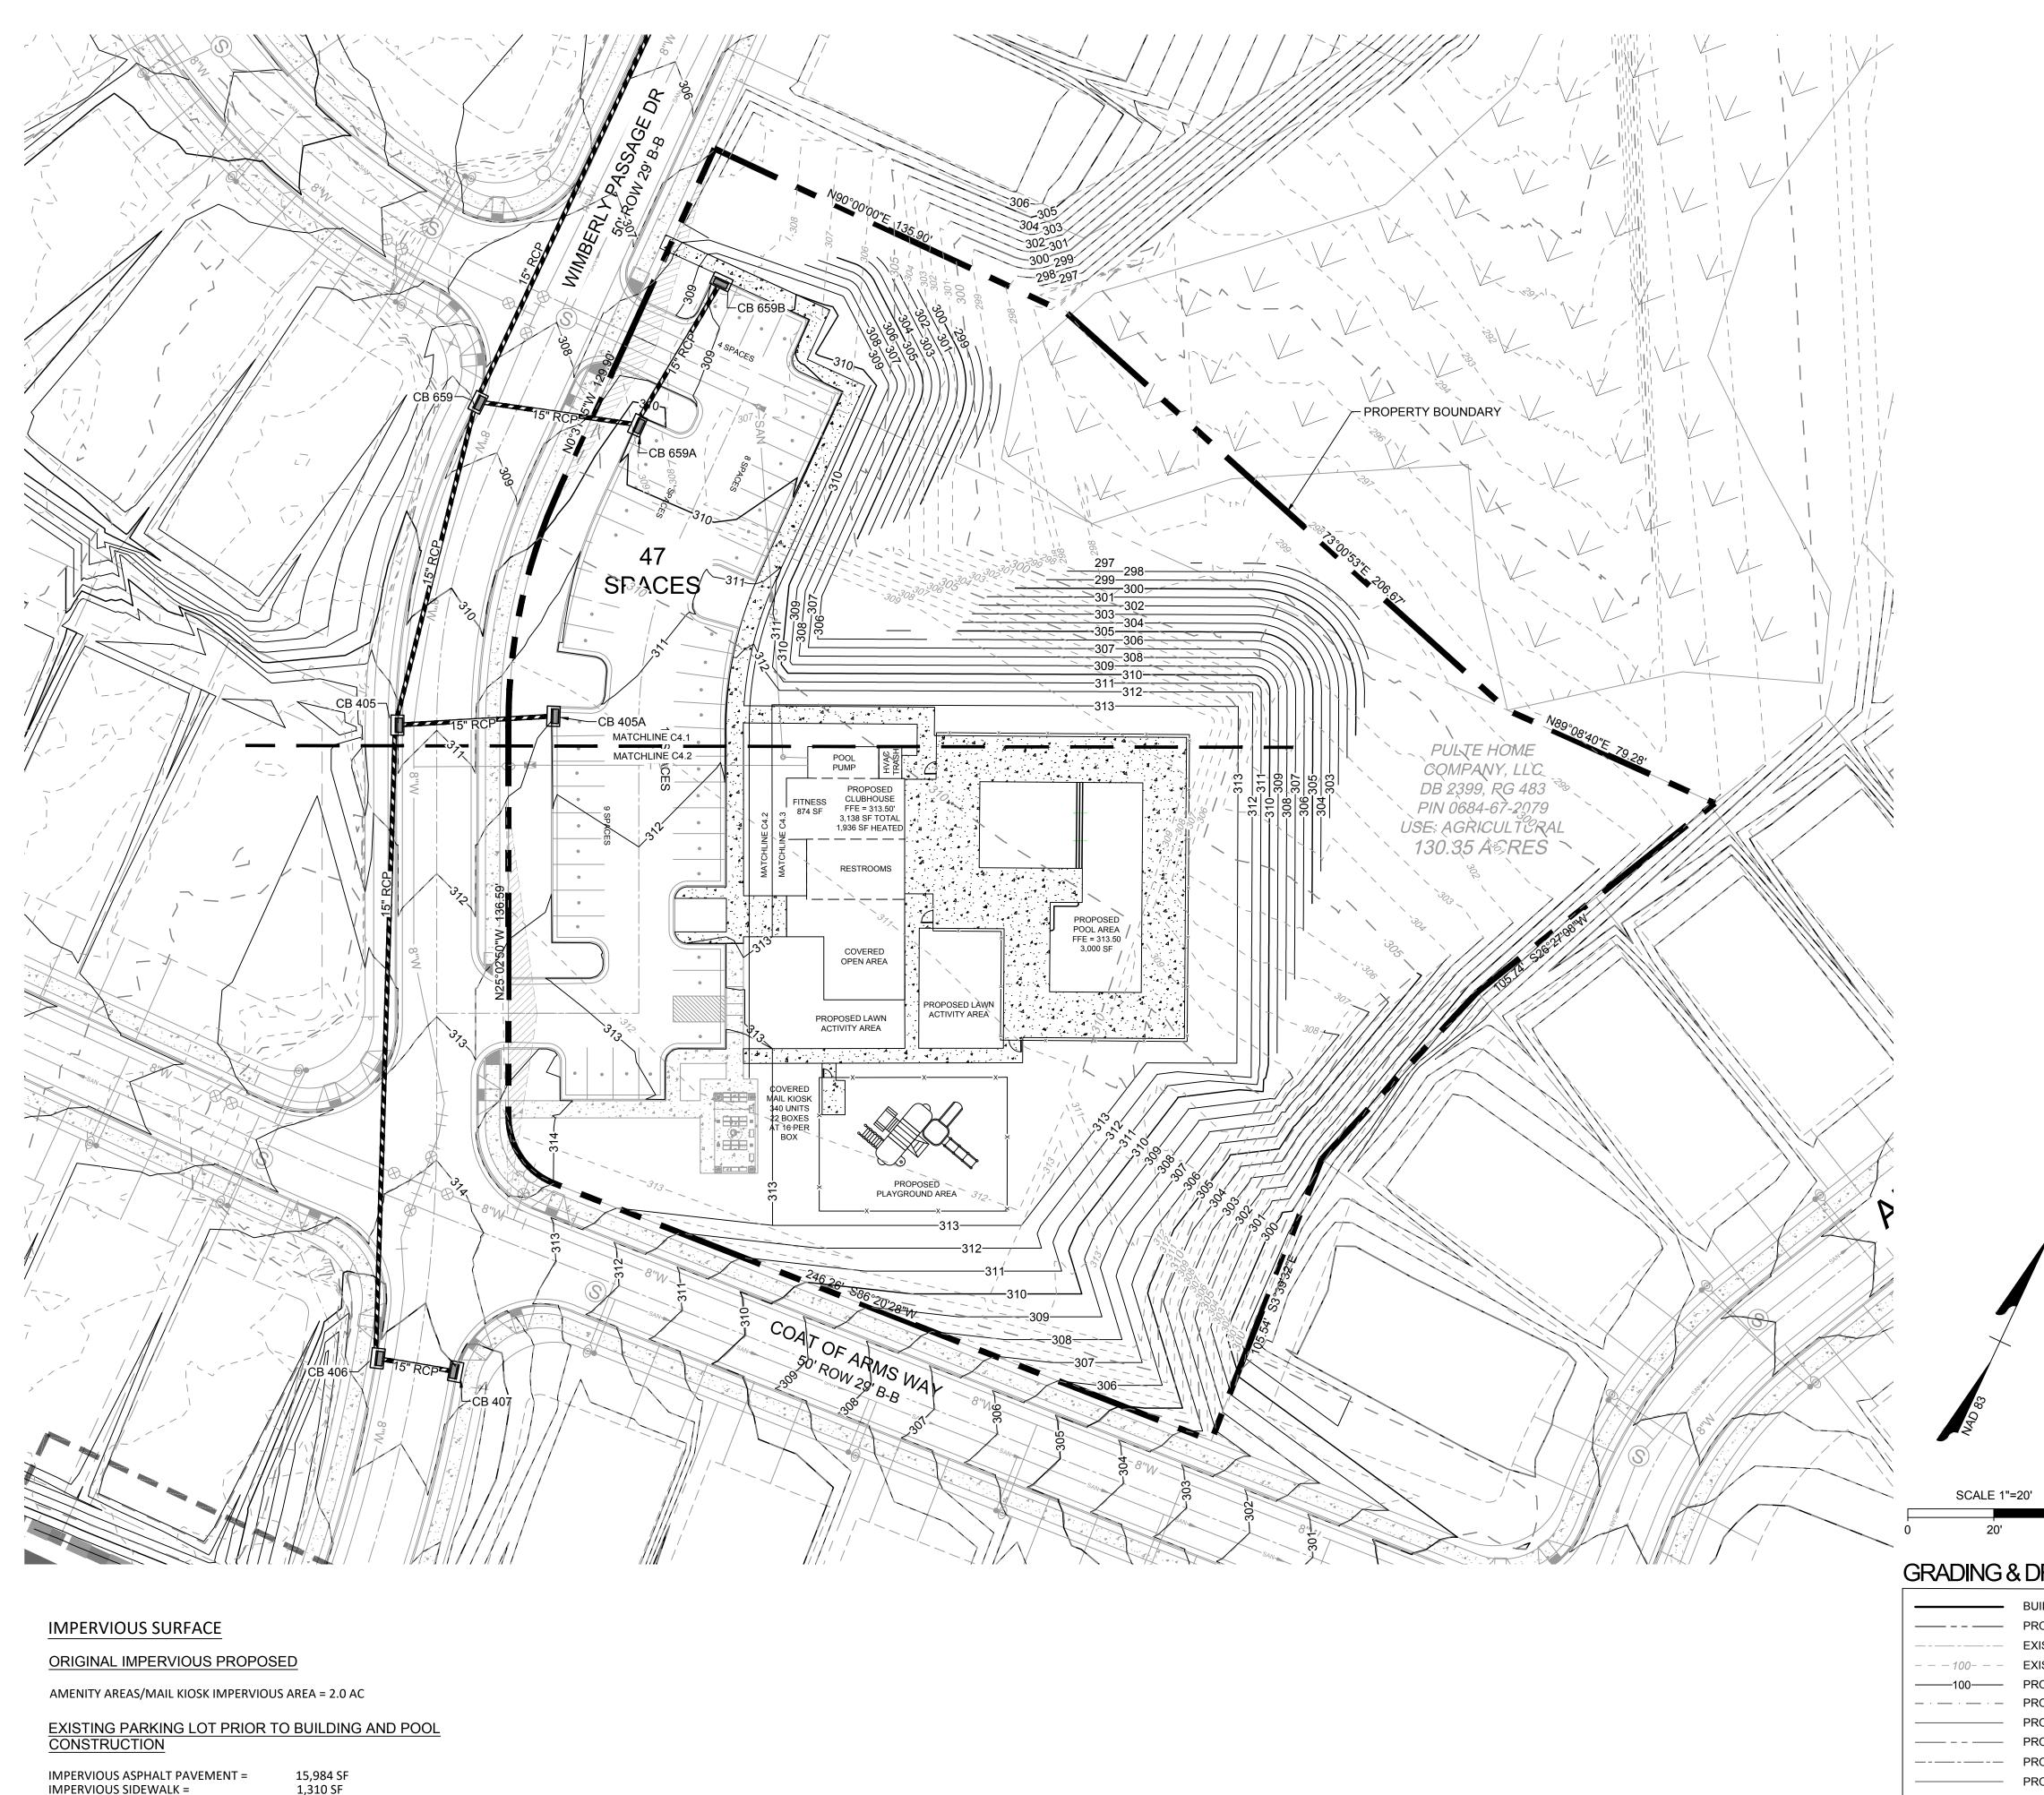

GRADING AND STORM DRAINAGE NOTES

- 1. CONTRACTOR SHALL CALL "NORTH CAROLINA ONE CALL" (811) AT LEAST 3 DAYS PRIOR TO DIGGING TO HAVE EXISTING UTILITIES LOCATED. REPORT ANY DISCREPANCIES TO THE
- CONTRACTOR TO COORDINATE ACTIVITIES WITH UTILITY COMPANIES INVOLVED IN ANY RELATED RELOCATION (I.E. POWER POLES, TELEPHONE PEDESTALS, WATER METERS,
- EXISTING UTILITIES SHOWN ARE BASED ON FIELD SURVEYS AND THE BEST AVAILABLE RECORD DRAWINGS. THE CONTRACTOR SHALL VERIFY CONDITIONS PRIOR TO BEGINNING CONSTRUCTION. ANY DISCREPANCIES BETWEEN ACTUAL FIELD CONDITIONS AND THE PLANS SHALL BE REPORTED TO THE ENGINEER IMMEDIATELY.
- THE CATCH BASINS AND YARD INLETS SHALL BE CONSTRUCTED IN THE LOCATIONS SHOWN UNLESS OTHERWISE DIRECTED BY THE ENGINEER. THE CONTRACTOR IS RESPONSIBLE FOR REPORTING ANY DISCREPANCIES IN THE CATCH BASIN ELEVATIONS OR THE PROPOSED PIPE SLOPES TO THE ENGINEER. THE CONTRACTOR IS ALSO RESPONSIBLE TO REPORT ANY CONFLICTS BETWEEN ANY UTILITY, STORM DRAIN LINE, WATER LINE, SEWER
- LINE OR ANY OTHER PROPOSED OR EXISTING STRUCTURE TO THE ENGINEER A LAND DISTURBING PERMIT WILL BE REQUIRED PRIOR TO THE COMMENCEMENT OF ANY LAND-DISTURBING ACTIVITIES.
- ALL EXISTING VAULTS, MANHOLES, STORM DRAIN STRUCTURES, VALVE BOXES, CLEANOUTS, ETC. SHALL BE ADJUSTED AS NEEDED TO MATCH FINISHED GRADE.
- ALL BACKFILL, COMPACTION, SOILS TESTING, ETC. SHALL BE PERFORMED BY THE OWNER'S INDEPENDENT TESTING LABORATORY.
- ALL SPOT ELEVATIONS INDICATED ARE AT TOP OF CURB UNLESS NOTED OTHERWISE. ALL ELEVATIONS ARE BASED ON VERTICAL DATUM NAVD88.
- A PRE-CONSTRUCTION MEETING MUST BE SCHEDULED PRIOR TO ANY WORK, GRADING OR INSTALLATION OF EROSION CONTROL MEASURES.
- 10. ALL HANDICAP PARKING SPACES AND STRIPED ACCESSIBILITY AISLES ARE TO HAVE NO MORE THAN A 1:50 (2.0%) SLOPE IN ALL DIRECTIONS. ALL SIDEWALKS ARE TO HAVE NO MORE THAN A 1:20 (5.0%) SLOPE FOR THE LENGTH OF THE SIDEWALK AND NO MORE THAN A 1:50 (2.0%) SLOPE FOR THE WIDTH OF THE SIDEWALK.
- 11. CONTRACTOR TO IDENTIFY ALL NECESSARY SPILL CURB SECTION LOCATIONS AND INSTALL TO ENSURE POSITIVE DRAINAGE TO STORM STRUCTURES.
- 12. IF CONTRACTOR NOTICES ANY DISCREPANCIES IN ANY OF THESE SLOPE REQUIREMENTS, IT IS THE CONTRACTOR'S RESPONSIBILITY TO CONTACT THE OWNER PRIOR TO POURING ANY CONCRETE SO THAT A SOLUTION CAN BE FOUND.
- 13. SPOT ELEVATIONS ARE GIVEN AT THE MAJORITY OF THE MAJOR BREAK POINTS BUT IT SHOULD NOT BE ASSUMED THAT ALL NECESSARY SPOT ELEVATIONS ARE SHOWN. DUE TO SPACE LIMITATIONS, THERE MAY BE OTHER CRITICAL SPOTS NOT LABELED THAT SHOULD BE TAKEN INTO CONSIDERATION. THE CONTRACTOR SHALL REVIEW THE GRADING PLAN IN DETAIL AND SHALL ENSURE THAT ALL CRITICAL GRADE POINTS ARE STAKED AND FOLLOWED TO PROVIDE POSITIVE DRAINAGE
- 14. EXISTING VEGETATION WITHIN TREE PROTECTIVE AREAS SHALL REMAIN UNDISTURBED. ANY AND ALL LANDSCAPING AND EXISTING TREES AND SHRUBS TO REMAIN WHICH ARE DAMAGED DURING DEMOLITION OR CONSTRUCTION SHALL BE REPLACED BY THE CONTRACTOR USING A LICENSED LANDSCAPE CONTRACTOR AT NO ADDITIONAL COST TO
- 15. THE GRADING CONTRACTOR SHALL COMPLY WITH ALL STATE CODES IN OBSERVING EROSION CONTROL MEASURES BOTH ON AND OFF-SITE. THE GRADING CONTRACTOR SHALL MAINTAIN ALL EROSION CONTROL DEVICES AFTER EACH RAINFALL EVENT OR AS DIRECTED BY THE EROSION CONTROL INSPECTOR OR THE ENGINEER.
- THE GRADING CONTRACTOR SHALL BE RESPONSIBLE FOR OFF-SITE DISPOSAL OF ALL CLEARING AND GRADING WASTE MATERIALS GENERATED DURING CONSTRUCTION AND FOR OBTAINING ALL APPLICABLE PERMITS FOR OFF-SITE STOCKPILES AND/OR WASTE AREAS. NONE EXPECTED DO TO EXISTING SITE HAS BEEN CLEARED TO L.O.D.
- ALL CATCH BASINS MUST BE MARKED "DUMP NO WASTE DRAINS TO STREAM" OR
- 18. ALL SLOPES TO BE VEGETATED WITH GRASS SHALL BE A MAXIMUM 3:1 SLOPE. 19. ALL ROOF DRAINS SHALL BE DIRECTED TO THE STORM DRAIN SYSTEM (INTO EXISITNG
- 20. NO LAND DISURBING ACTIVITIES ARE PERMITTED IN BUFFERS CONTAINING EXISITNG TREES WITH A MINIMUM CALIPER DBH OF 4. NO LAND DISTURBING ACTIVITIES SHALL BE WITHIN CRITICAL ROOT ZONE OF A RETAINED SIGNIFICANT OR SPECIMEN TREES.
- THERE SHALL BE NO SOIL DISTURBANCE OR RE-COMPACTION WITHIN AREAS DESIGNATED FOR THE TREE PRESERVATION AND PROTECTION FENCING, ICLUDING NO STOCKPILING OF CONSTRUCTION OR OTHER MATERIAL, TRAFFIC, OR BORING SAMPLE.

RETAINING WALLS (BY OTHERS)

AT TOWN BUILDING PERMIT REQUIRED WHEN 1) WHEN ADJACENT TO A STRUCTURE, ANY RETAINING WALL LESS THAN 5' IN CUMULATIVE VERTICAL RELIEF AND LOCATED CLOSER TO STRUCTURE THAN THE VERTICAL RELIEF, OR 2) ANY RETAINING WALLS PROVIDEING CUMULATIVE VERTICAL RELIEF GREATER THAN5' WITH IN HORIZONTAL SEPARATION OF 50' OR LESS. WALLS REQUIRING A BUILDING PERMIT SHALL BE DESIGNED UNDER THE RESPONSIBLE CHARGE OF A REGISTERED DESIGNED PROFESSIONAL PER THE NORTH CAROLINA BUILDING CODE, SECTION 1807.2.


CONTRACTOR NOTES


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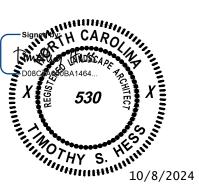
GRADING & DRAINAGE LEGEND





ALL CONSTRUCTION TO BE IN ACCORDANCE WITH ALL TOWN OF ANGIER STANDARDS, SPECIFICATIONS, AND DETAILS.

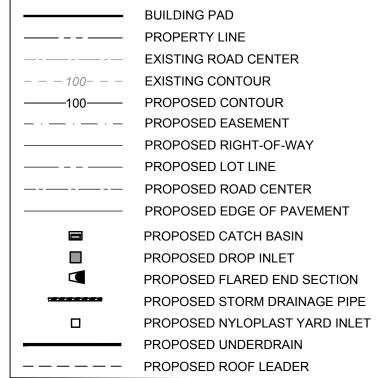

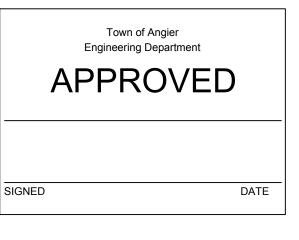

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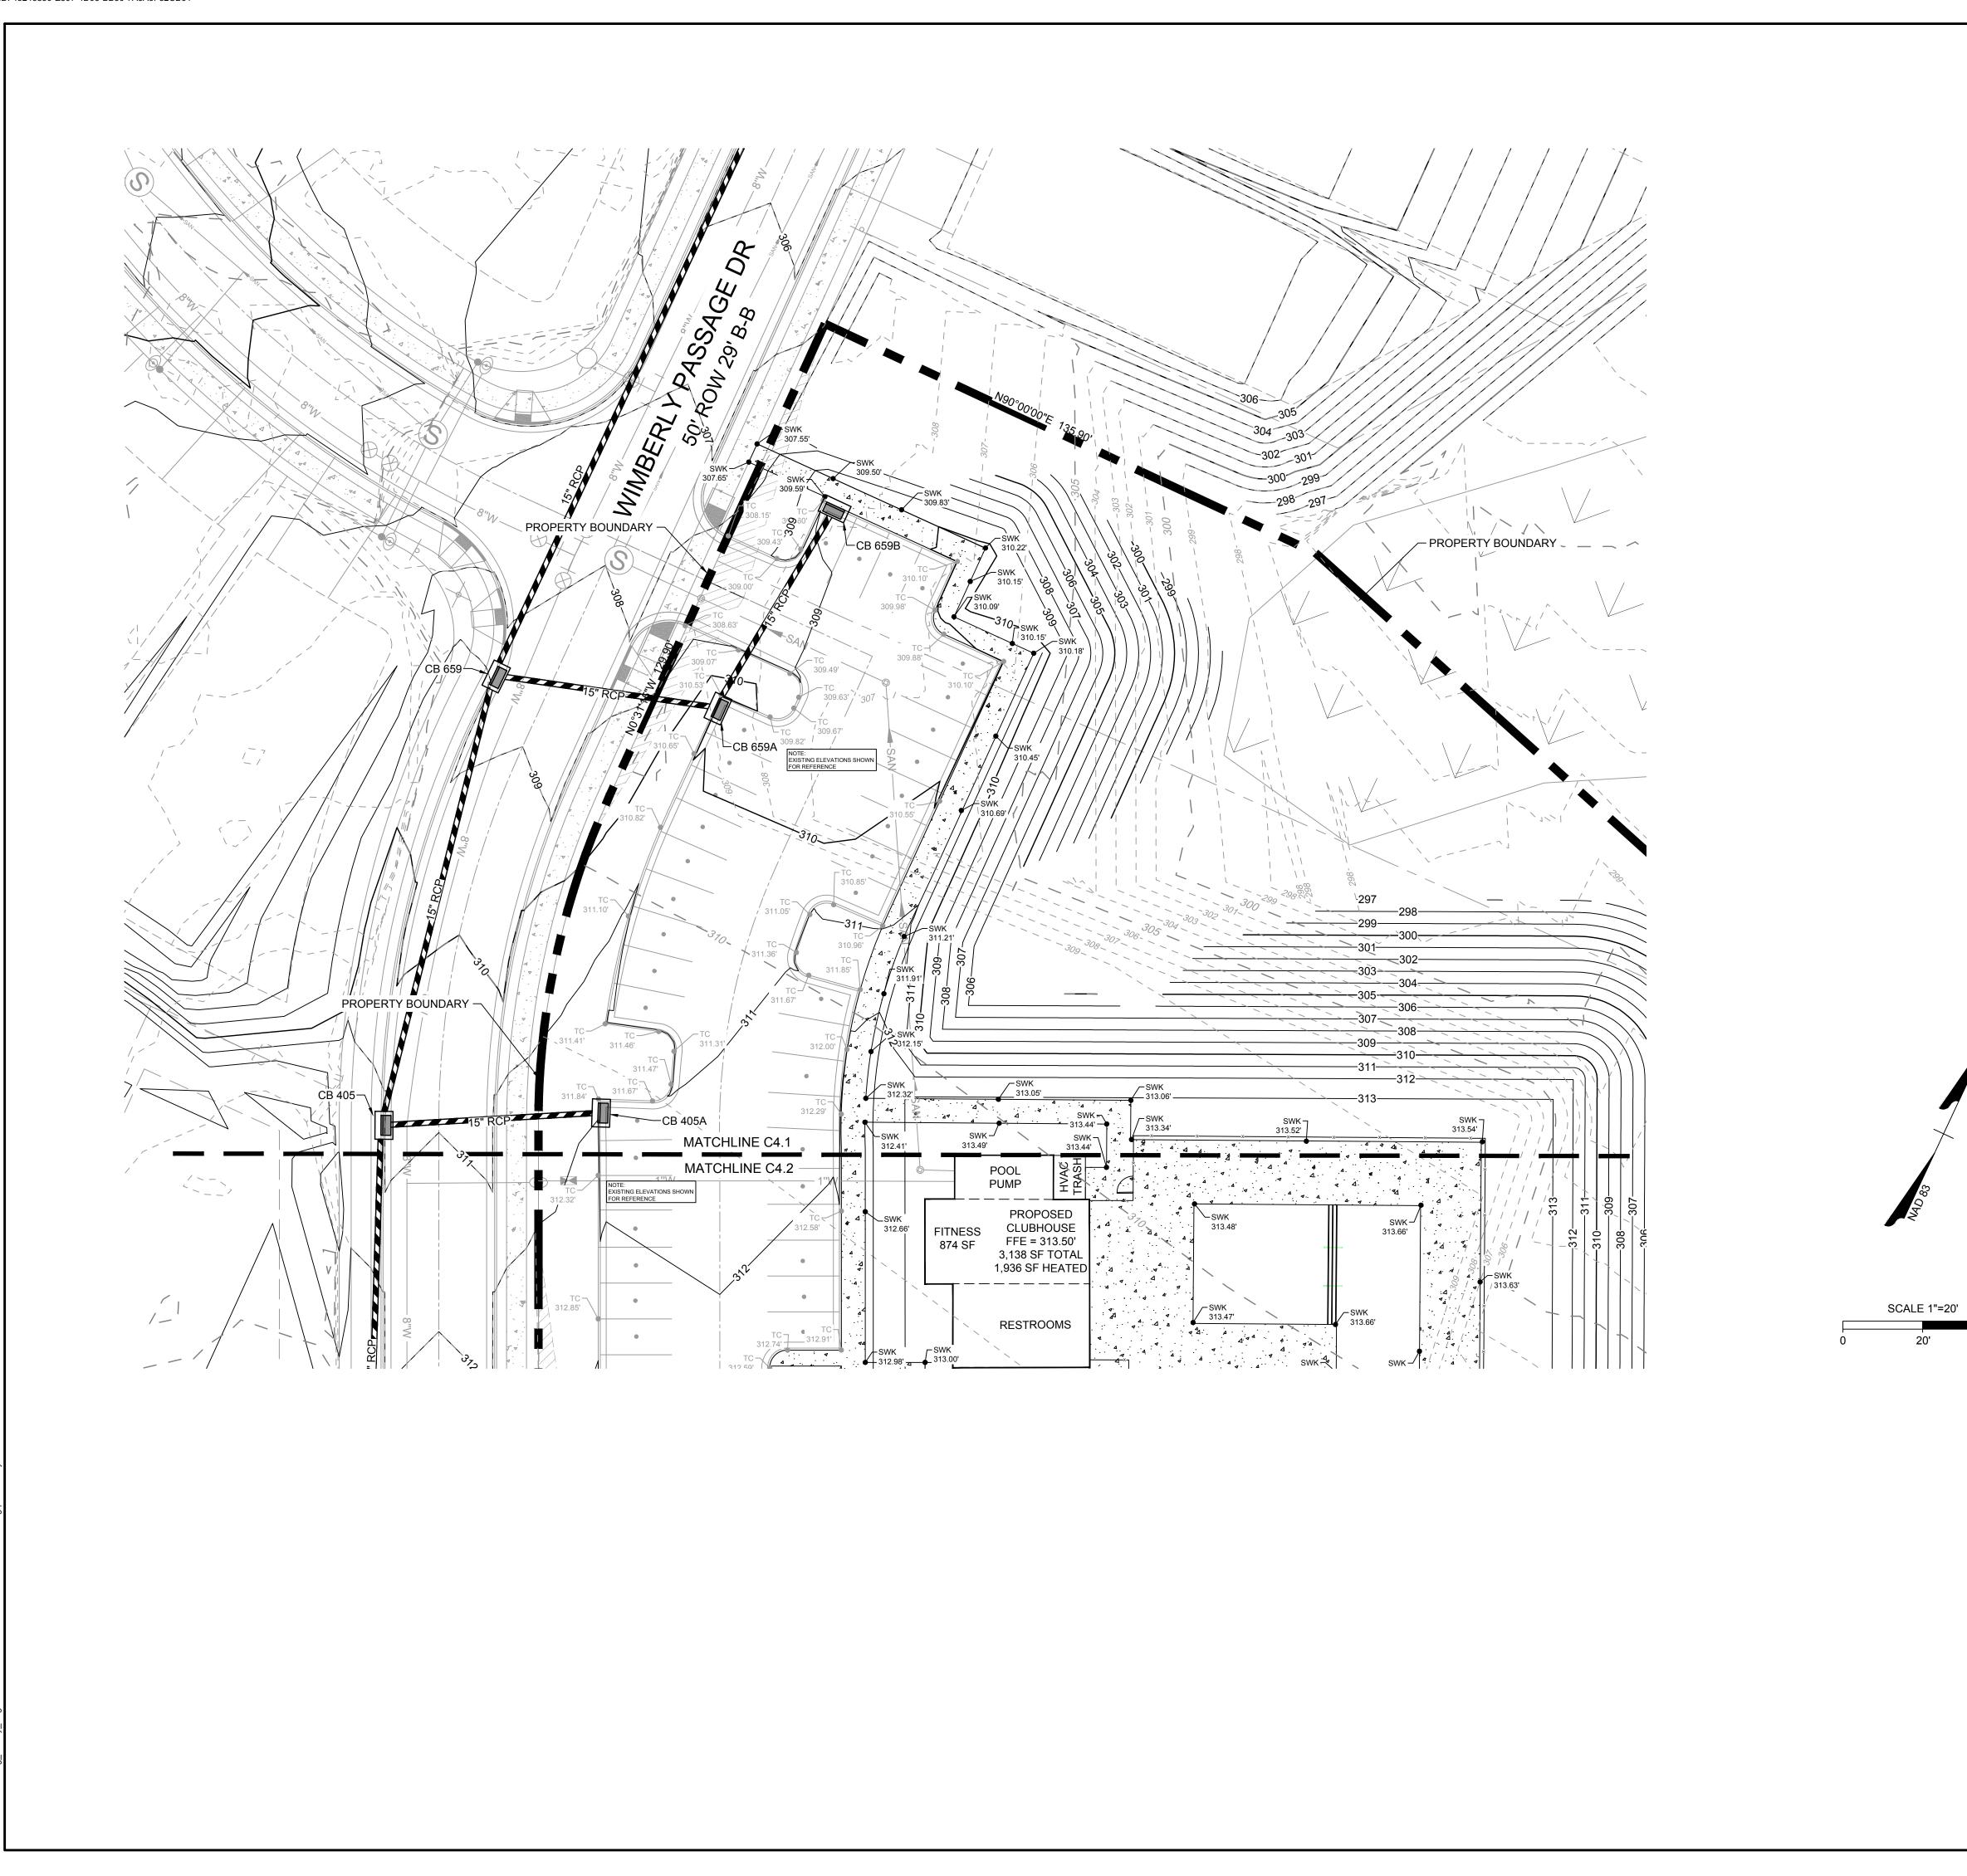
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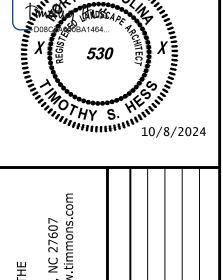
T. HESS

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49578

SHEET NO. C4.0





10/08/2024 DESIGNED BY

CHECKED BY AS SHOWN

JOB NO. 49578 SHEET NO. C4.1

---- PROPOSED ROOF LEADER Town of Angier Engineering Department

GRADING & DRAINAGE LEGEND

BUILDING PAD

EXISTING ROAD CENTER

PROPOSED EASEMENT

PROPOSED LOT LINE

PROPOSED ROAD CENTER

PROPOSED CATCH BASIN

PROPOSED DROP INLET

PROPOSED UNDERDRAIN

PROPOSED EDGE OF PAVEMENT

PROPOSED FLARED END SECTION PROPOSED STORM DRAINAGE PIPE PROPOSED NYLOPLAST YARD INLET

------ PROPERTY LINE

EXISTING CONTOUR


——100—— PROPOSED CONTOUR

PROPOSED RIGHT-OF-WAY


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ALL CONSTRUCTION TO BE IN ACCORDANCE WITH ALL TOWN OF ANGIER STANDARDS, SPECIFICATIONS, AND DETAILS.



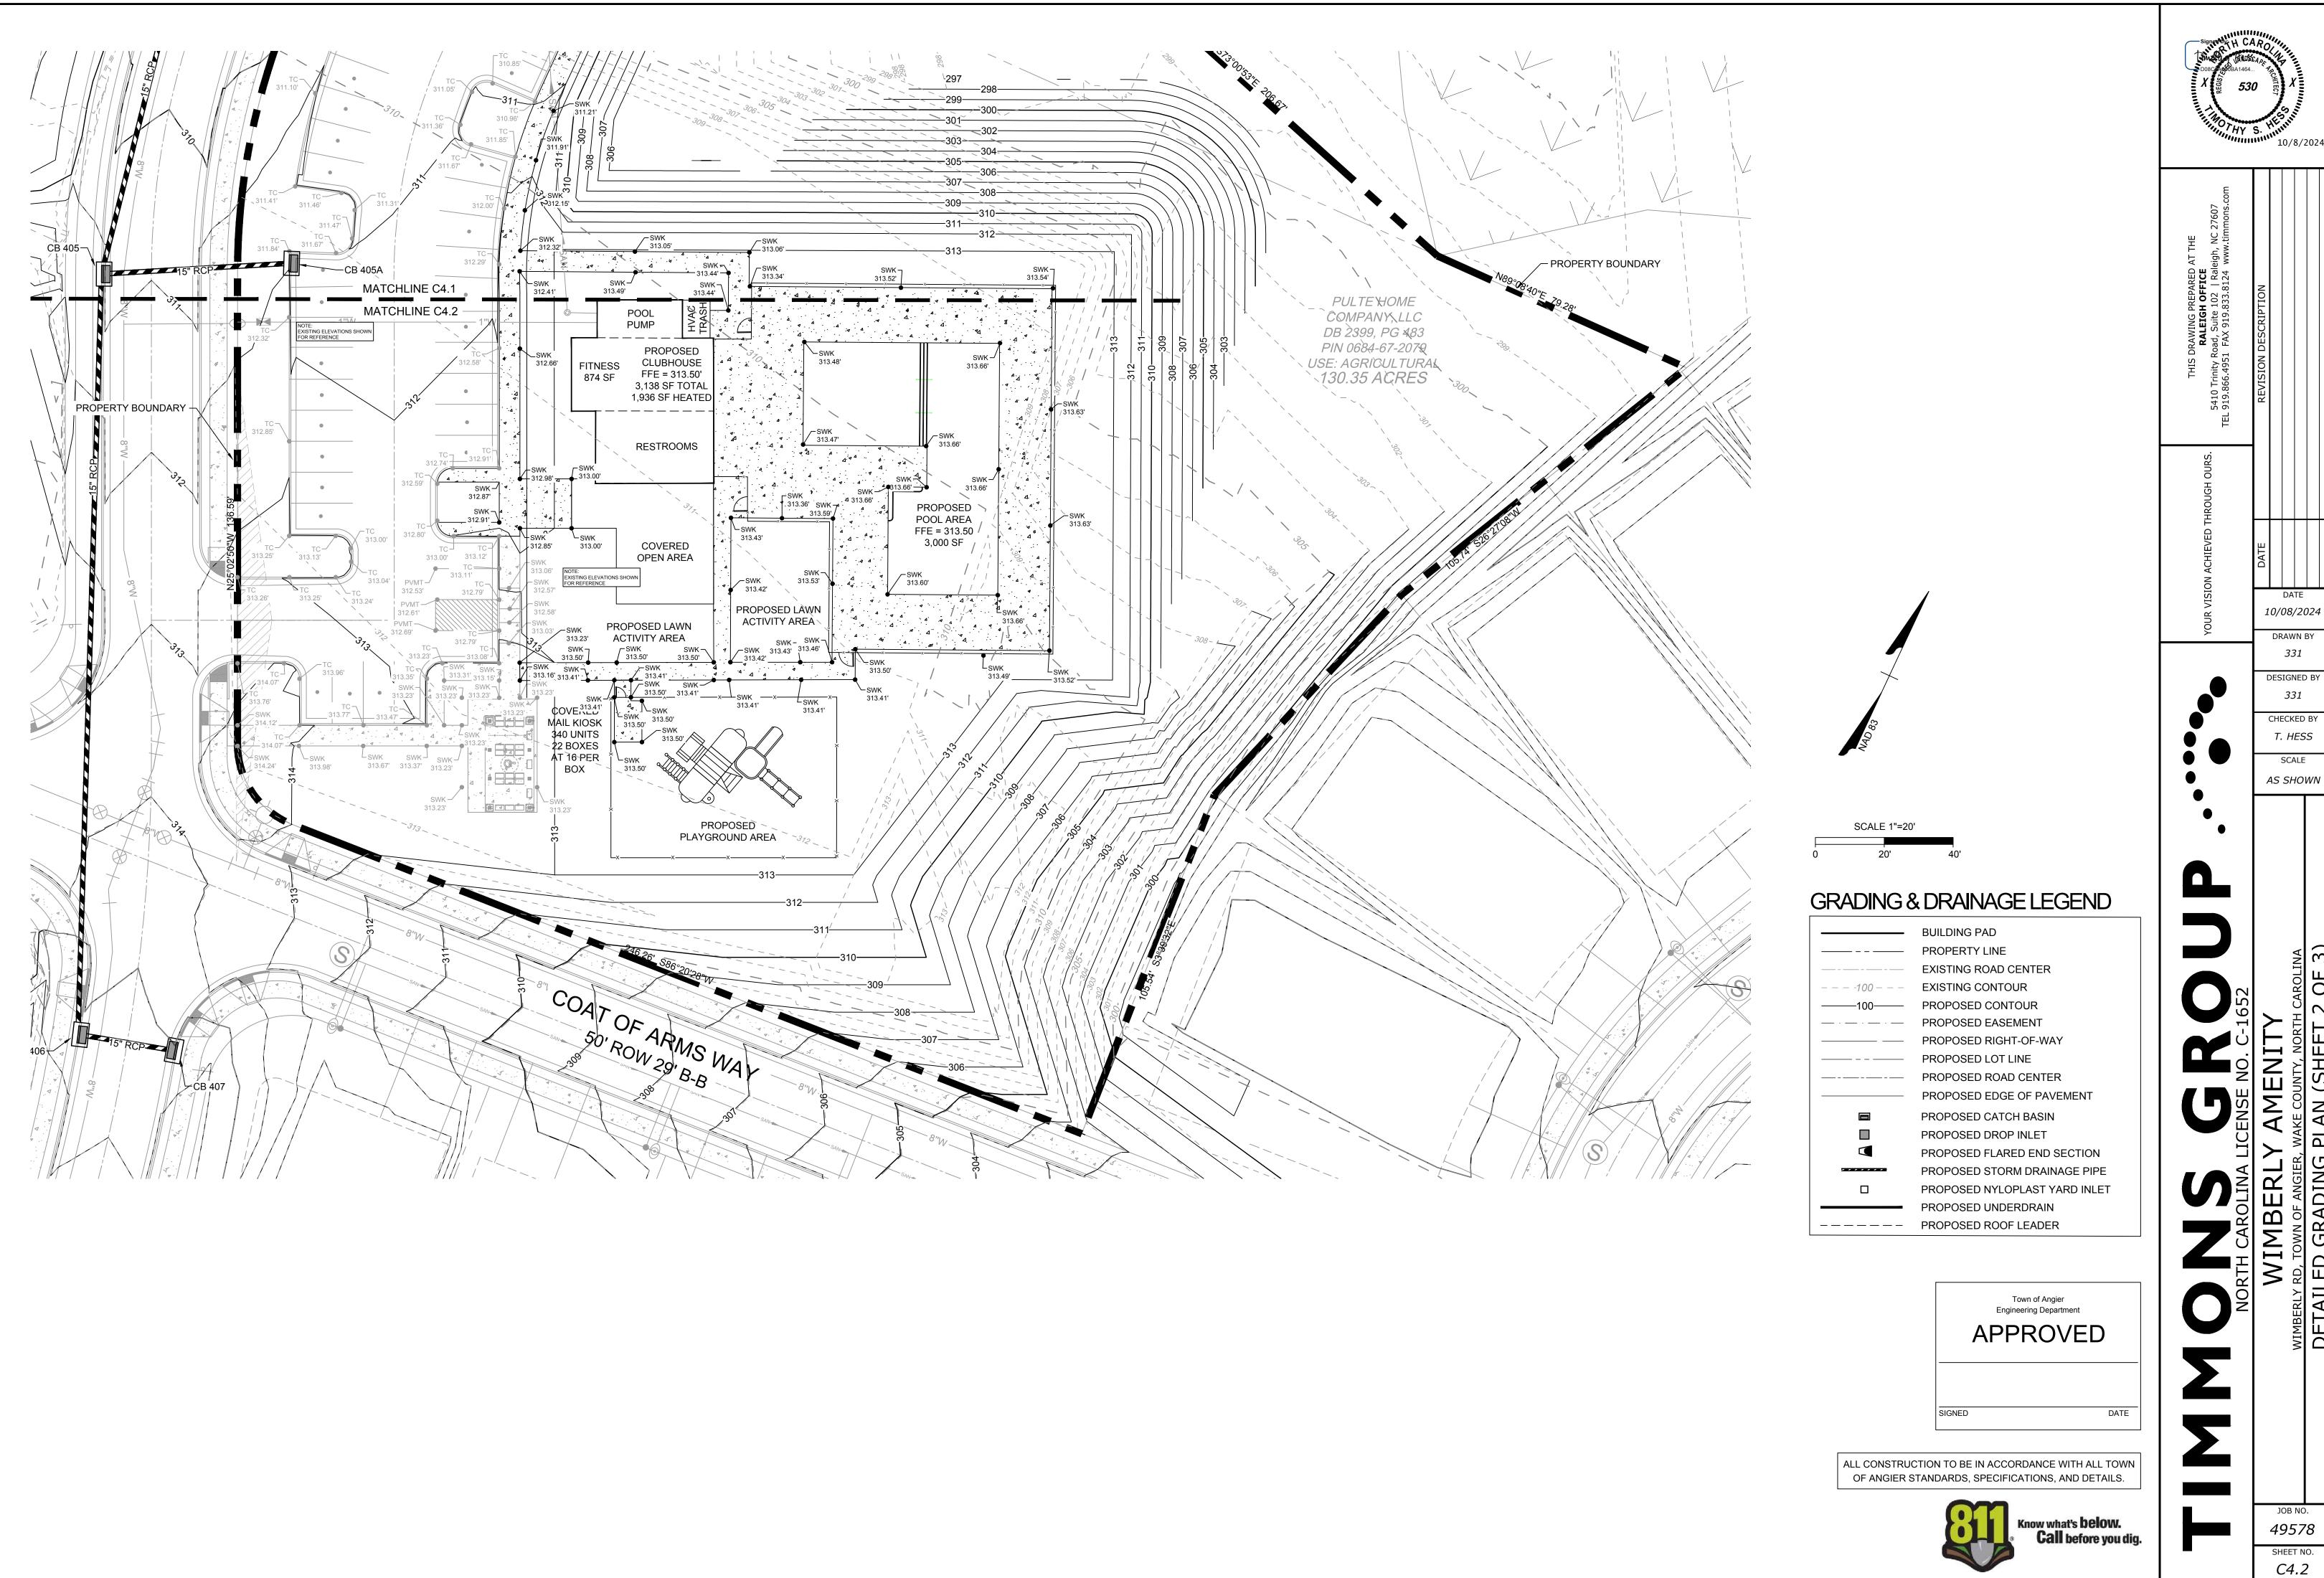

AS SHOWN

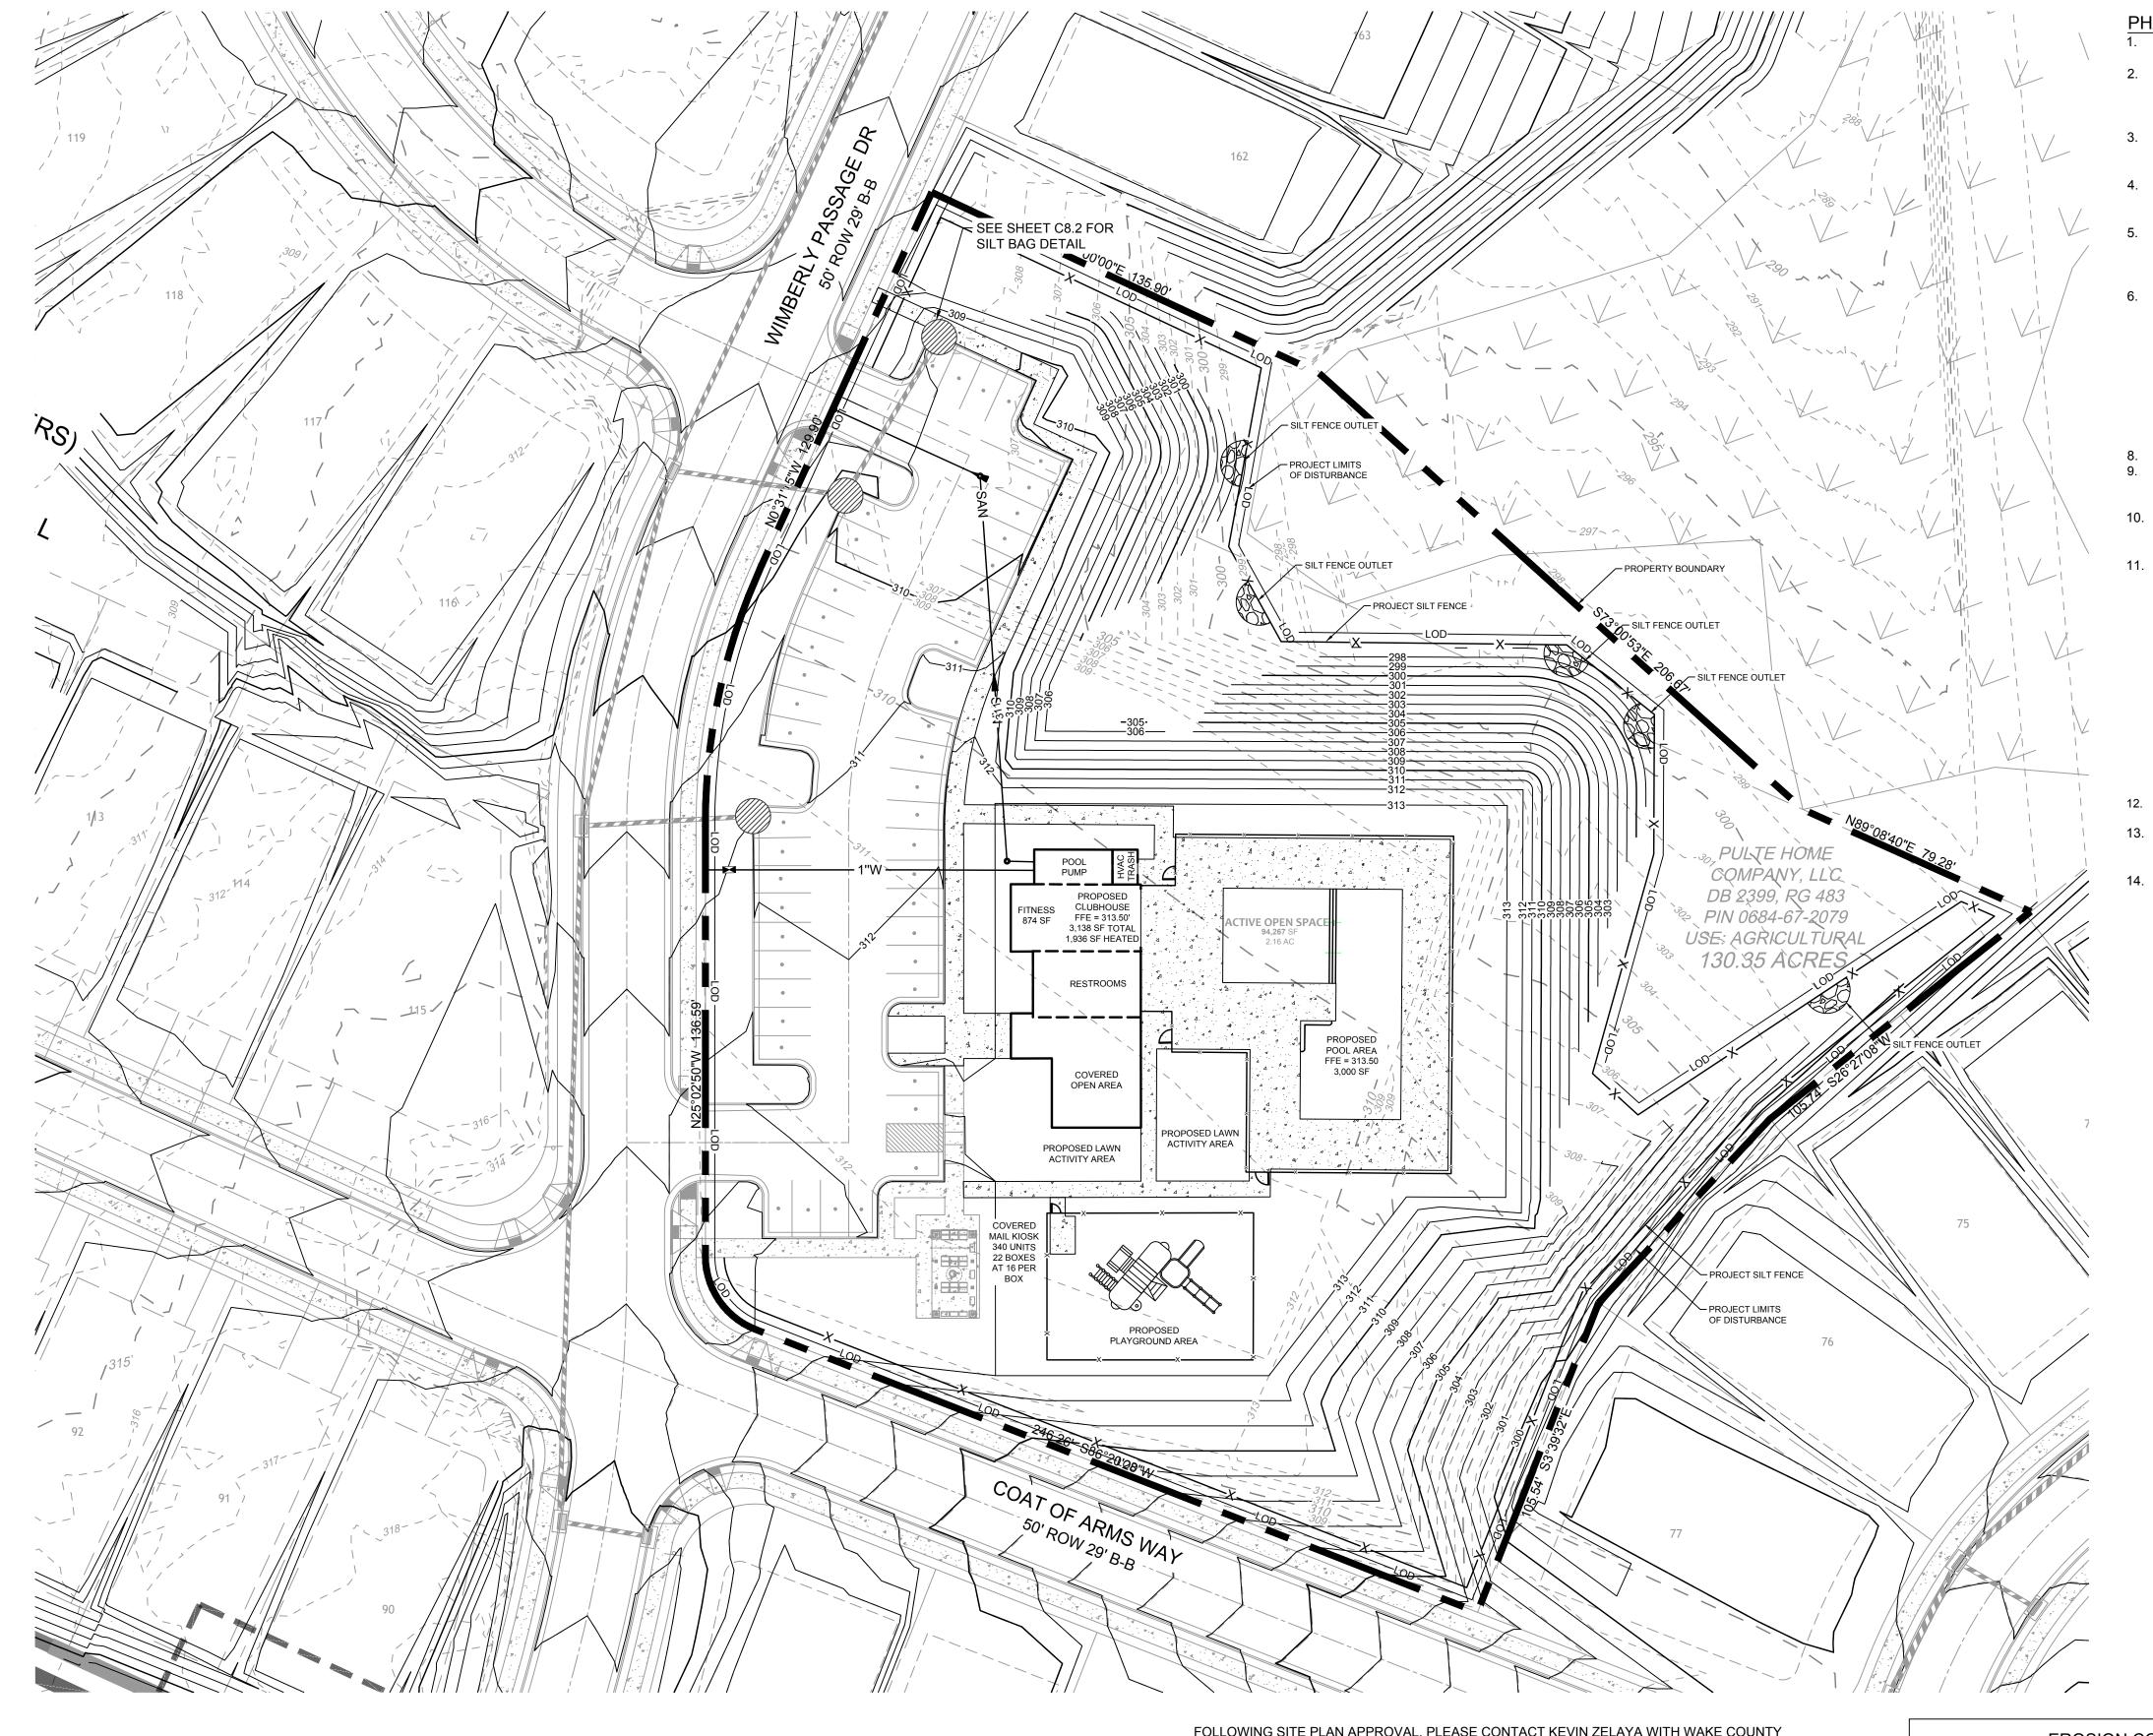

PHASE II EROSION CONTROL CONSTRUCTION SEQUENCE:

- MAINTAIN ALL EXISTING EROSION CONTROL FEATURES PREVIOUSLY CONSTRUCTED AND ASSOCIATED WITH PHASE
- 2. CONTINUE BRINGING FILL INTO THE SITE. IMPORTED MATERIAL WILL REQUIRE A PERMITTED SITE APPROVAL BEFORE THIS PROCESS BEGINS. ALL FILL SHALL BE BROUGHT INTO THE SITE AND EVENLY SPREAD OUT THROUGH THE SITE AS SHOWN IN LIFTS OF NO MORE THAT 1.0' AT A TIME. FILL SHALL BE ROLL COMPACTED BY A DOZER OR EQUIVALENT
- CONTINUE INSTALLING STORM DRAINAGE SYSTEM FROM OUTLET POINT (LOW END) AND WORK UPSTREAM. PIPE INLET PROTECTION SHALL BE UTILIZED AT THE END OF EACH WORK DAY TO ASSURE PIPE NETWORK IS NOT INUNDATED WITH SEDIMENT.
- INSTALL SITE IMPROVEMENTS, STORMWATER DRAINAGE SYSTEM, UTILITY SERVICES, SIDEWALKS AND DRIVES AS SHOWN ON THE APPROVED PLANS. ALL OPEN TRENCHES FOR UTILITY AND STORMWATER INSTALLATION SHALL BE
- PROTECTED FROM SEDIMENTATION BY PILING EXCAVATED MATERIAL ON THE UPHILL SIDE OF EXCAVATION. INSTALL ADEQUATE EROSION AND SEDIMENT CONTROL MEASURES AND/OR INCREASE MAINTENANCE FREQUENCY WHERE APPROVED MEASURES FAIL TO PREVENT ACCELERATED EROSION, OFF-SITE SEDIMENTATION, OR REPETITIVE NON-COMPLIANCE ISSUES. ALL MEASURES MUST BE INSTALLED PER PLAN DETAIL. ENSURE
- CONSTRUCTION TRAFFIC IS LIMITED TO THE CONSTRUCTION ENTRANCE ONLY. GROUND COVER SHALL BE PROVIDED AS FOLLOWS:
- FOR ALL AREAS OF MODERATE AND/OR STEEP SLOPES, PROVIDE TEMPORARY GROUND COVER IF THE SLOPE HAS NOT BEEN DISTURBED FOR A PERIOD OF FOURTEEN (14) DAYS. SLOPES GREATER THAN 3:1 REQUIRE GROUND COVER IN 7 DAYS.
- PROVIDE GROUND COVER SUFFICIENT TO RESTRAIN EROSION ON ANY PORTION OF THE SITE UPON WHICH FURTHER LAND-DISTURBING ACTIVITY IS NOT BEING UNDERTAKEN WITHIN FOURTEEN (14) CALENDAR DAYS OF TEMPORARILY OR PERMANENTLY SUSPENDING LAND DISTURBING ACTIVITY.
- ESTABLISH PERMANENT GROUND COVER SUFFICIENT TO RESTRAIN EROSION WITHIN FOURTEEN (14) CALENDAR DAYS FOLLOWING COMPLETION OF CONSTRUCTION OR DEVELOPMENT AND/OR PRIOR TO FINAL
- 8. INSTALL CURB & GUTTER AND GRAVEL BASE.
- 9. MODIFICATIONS TO THE APPROVED AND PERMITTED PLANS SHALL BE APPROVED BY EROSION CONTROL INSPECTIONS PRIOR TO REMOVAL OR INSTALLATION. CONTACT THE EROSION CONTROL INSPECTOR TO OBTAIN SIGN-OFF ON THE
- 10. MAINTAIN ALL EROSION AND SEDIMENT CONTROL MEASURES IN GOOD WORKING ORDER. SILT FENCE, INLET PROTECTION, AND OTHER SIMILAR MEASURES MUST BE CLEANED OUT BEFORE THEY ARE HALF FULL. CLOGGED STONE FILTERS MUST BE REFRESHED/REPLACED. SILT FENCE CAN NOT HAVE HOLES OR TEARS.
- 11. ONCE GRADING IS COMPLETE, ALL UTILITIES, AND ALL STORM SYSTEMS ARE INSTALLED AND THE SITE IS COMPLETELY STABILIZED PER THE NPDES PLAN AND ABOVE, CONVERT THE SEDIMENT BASIN TO A STORMWATER **INFILTRATION BASIN AS FOLLOWS:**
- CONSULT WITH THE EROSION AND SEDIMENT CONTROL INSPECTOR PRIOR TO BEGINNING THE CONVERSION FROM SEDIMENT BASIN TO INFILTRATION BASIN.
- PUMP DOWN BASIN USE APPROVED DEWATERING MEASURES. EFFLUENT MUST BE FILTERED.
- REMOVE ACCUMULATED SEDIMENT (AS NEEDED) TO ESTABLISH THE FINAL GRADE OF THE POND. SEDIMENT MUST BE DISPOSED OF IN AN APPROVED AREA.
- REMOVE TEMPORARY SKIMMER AND BAFFLES.
- REMOVE TEMPORARY ORIFICE PLUGS FROM RISER AND CLOSE RISER DRAIN.
- INSTALL PERFORATION IN DRAIN PIPE PER DETAIL. ACCURATELY FINE GRADE BASIN TO DESIGN CONTOURS. CONTRACTOR TO SURVEY TO VERIFY ALL GRADES.
- INSTALL SAND LAYER AND OBSERVATION PORT. INSTALL FOREBAY BERMS AND RIPRAP.
- INSTALL PLANTINGS, SOD, MULCH, ETC. AS SHOWN ON APPROVED PLAN.
- CONTRACTOR TO HAVE A LICENSED SOIL SCIENTIST PERFORM AN INFILTRATION TEST AT THE BOTTOM ELEVATION OF THE SCM AND IMMEDIATELY REPORT THE INFILTRATION RATE TO THE ENGINEER.
- AT A MINIMUM OF SEVEN (7) DAYS PRIOR TO SCHEDULING THE STORMWATER FINAL INSPECTION, SUBMIT ANY REQUIRED PAPERWORK TO THE EROSION CONTROL INSPECTORS FOR APPROVAL. FAILURE TO DO SO WILL PREVENT A CERTIFICATE OF OCCUPANCY FROM BEING ISSUED.
- 14. ONCE THE STORMWATER FINAL INSPECTION IS APPROVED, CLOSE THE GRADING PERMIT AND OBTAIN A CERTIFICATE OF COMPLETION.

GENERAL EROSION AND SEDIMENT CONTROL NOTES:

- ALL CONSTRUCTION SHALL COMPLY WITH WAKE COUNTY STANDARDS AND SPECIFICATIONS. A COPY OF THE APPROVED EROSION CONTROL PLAN MUST BE ON FILE AT THE JOB SITE AT ALL TIMES.
- FAILURE TO FOLLOW THE APPROVED PLAN SEQUENCE AND DETAILS COULD SUBJECT THE CONTRACTOR TO FINES AND
- PENALTIES ISSUED BY DEQ. 4. FIELD VERIFY ALL DIMENSIONS AND GRADES ON THESE PLANS PRIOR TO CONSTRUCTION. FAILURE TO NOTIFY THE
- OWNER OF ANY DISCREPANCIES PRIOR TO PROCEEDING WITH PLAN OR GRADE CHANGES, MAY RESULT IN NO EXTRA COMPENSATION PAID TO THE CONTRACTOR FOR ANY WORK DONE DUE TO DIMENSIONS OR GRADES SHOWN
- 5. EXCAVATION AND EARTH MOVING OPERATIONS SHALL BE CONDUCTED UNDER THE SUPERVISION OF THE GEOTECHNICAL
- 6. VERIFY THE LOCATION OF ALL EXISTING UTILITIES PRIOR TO CONSTRUCTION. EXISTING UTILITIES SHOWN ARE FROM THE BEST AVAILABLE RECORDS AND FROM A SURVEY OF ABOVE GROUND FEATURES. NO WARRANTY IS GIVEN OR IMPLIED AS TO THE ACCURACY OF THE INFORMATION. ALL EXISTING UTILITIES SHOULD BE CONSIDERED APPROXIMATE IN LOCATION
- AND VERIFIED PRIOR TO COMMENCING ACTIVITY ON SITE. 7. ALL ADJACENT ROADS TO THE SITE ARE TO BE SWEPT AND WASHED AT THE END OF EACH WORK DAY TO ENSURE NO SEDIMENT COLLECTS ON THE ROADWAYS.
- INSPECT AND PROPERLY MAINTAIN ALL EROSION AND SEDIMENT CONTROL MEASURES WEEKLY AND AFTER EVERY
- 9. INSTALL ANY ADDITIONAL EROSION CONTROL MEASURES AS NECESSARY TO PREVENT SEDIMENT RUNOFF.
- 10. PROVIDE NCDEQ WITH THE LOCATION OF OFFSITE STOCKPILES USED TO STORE EXCAVATED SOIL FROM THE SITE. THE LOCATION OF OFFSITE STOCKPILES MUST BE AN UPLAND AREA. IF AN OFFSITE BORROW OR SPOIL SITE IS UTILIZED, THEN THE DISTURBED AREA FOR THE BORROW/SPOIL SITE MUST BE INCLUDED IN THE LAND DISTURBANCE PERMIT. THE CONTRACTOR WILL PROVIDE THE LOCATION OF ALL EXCAVATED SOILS USED FOR THIS PROJECT TO NCDEQ. THIS AREA MUST ALSO BE AN UPLAND AREA.
- 11. CONCRETE WASHOUT TO BE LOCATED A MINIMUM OF 50' FROM ANY DRAINAGE STRUCTURE.
- 12. THE EROSION CONTROL MEASURES INDICATED ON THE PLANS ARE THE MINIMUM REQUIREMENTS.
- 13. ADDITIONAL MEASURES MAY BE REQUIRED, AS DIRECTED BY THE ENGINEER, ENFORCEMENT OFFICER, OR OTHER

EROSION CONTROL LEGEND

LIMITS OF DISTURBANCE TREE PROTECTION FENCE SILT FENCE STONE OUTLET

CONSTRUCTION ENTRANCE TEMPORARY INLET PROTECTION TEMPORARY DOUBLE INLET PROTECTION


CONCRETE WASHOUT SILT FENCE OUTLET

ALL CONSTRUCTION TO BE IN ACCORDANCE WITH ALL TOWN

Town of Angier

Engineering Department

APPROVED

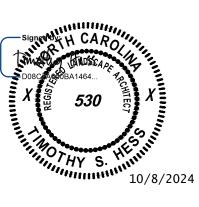

10/08/2024 DRAWN BY

DESIGNED BY

CHECKED BY T. HESS

AS SHOWN

49578 SHEET NO. C5.0

OF ANGIER STANDARDS, SPECIFICATIONS, AND DETAILS.

SCALE 1"=30'

FOLLOWING SITE PLAN APPROVAL, PLEASE CONTACT KEVIN ZELAYA WITH WAKE COUNTY ENVIRONMENTAL HEALTH DIVISION AT (919)868-6414 FOR REVIEW AND APPROVAL OF THE SOIL EROSION AND SEDIMENTATION PLAN. PRIOR TO ANY TIMBERING, CLEARING AND/OR GRUBBING ON SITE, AND IF YOUR PROJECT IS DISTURBING ONE ACRE OF LAND OR MORE YOU MUST SUBMIT AN EROSION AND SEDIMENTATION CONTROL PLAN TO THE WAKE COUNTY DEPARTMENT OF ENVIRONMENTAL SERVICES / WATER QUALITY. IN ORDER TO RECEIVE APPROVAL FROM

WAKE COUNTY YOU MUST HAVE: A. (1) INSTALLED YOUR TREE PROTECTION FENCING,


B. (2) HAVE THE LOCATION CERTIFIED BY A LICENSED ENGINEER OR SURVEYOR ON THEIR FIRMS LETTERHEAD USING THE FOLLOWING CERTIFICATION LANGUAGE: I. TREE PROTECTION FENCE INSTALLATION CERTIFICATION

HEREBY CERTIFY THAT THE REQUIRED TREE PROTECTION FENCE INSTALLED IN ACCORDANCE THE REGULATIONS OF THE GARNER UNIFIED DEVELOPMENT

ORDINANCE AND WITH THE APPROVED LANDSCAPING PLAN AS INCLUDED WITHIN THE APPROVED PRELIMINARY PLAN SET TITLED

, REFERENCED AS TOWN OF GARNER PLANNING CASE NUMBER AND STAMPED AND DATED FOR APPROVAL ON _____

III. SIGNATURE C. (3) AND CONTACTED THE TOWN OF GARNER PLANNER COORDINATING YOUR PROJECT FOR A SITE VISIT TO ENSURE OTHER REGULATIONS REGARDING TPF ARE FOLLOWED. I. ONCE THOSE THREE ITEMS ARE SATISFIED, THE PLANNER WILL NOTIFY WAKE COUNTY.

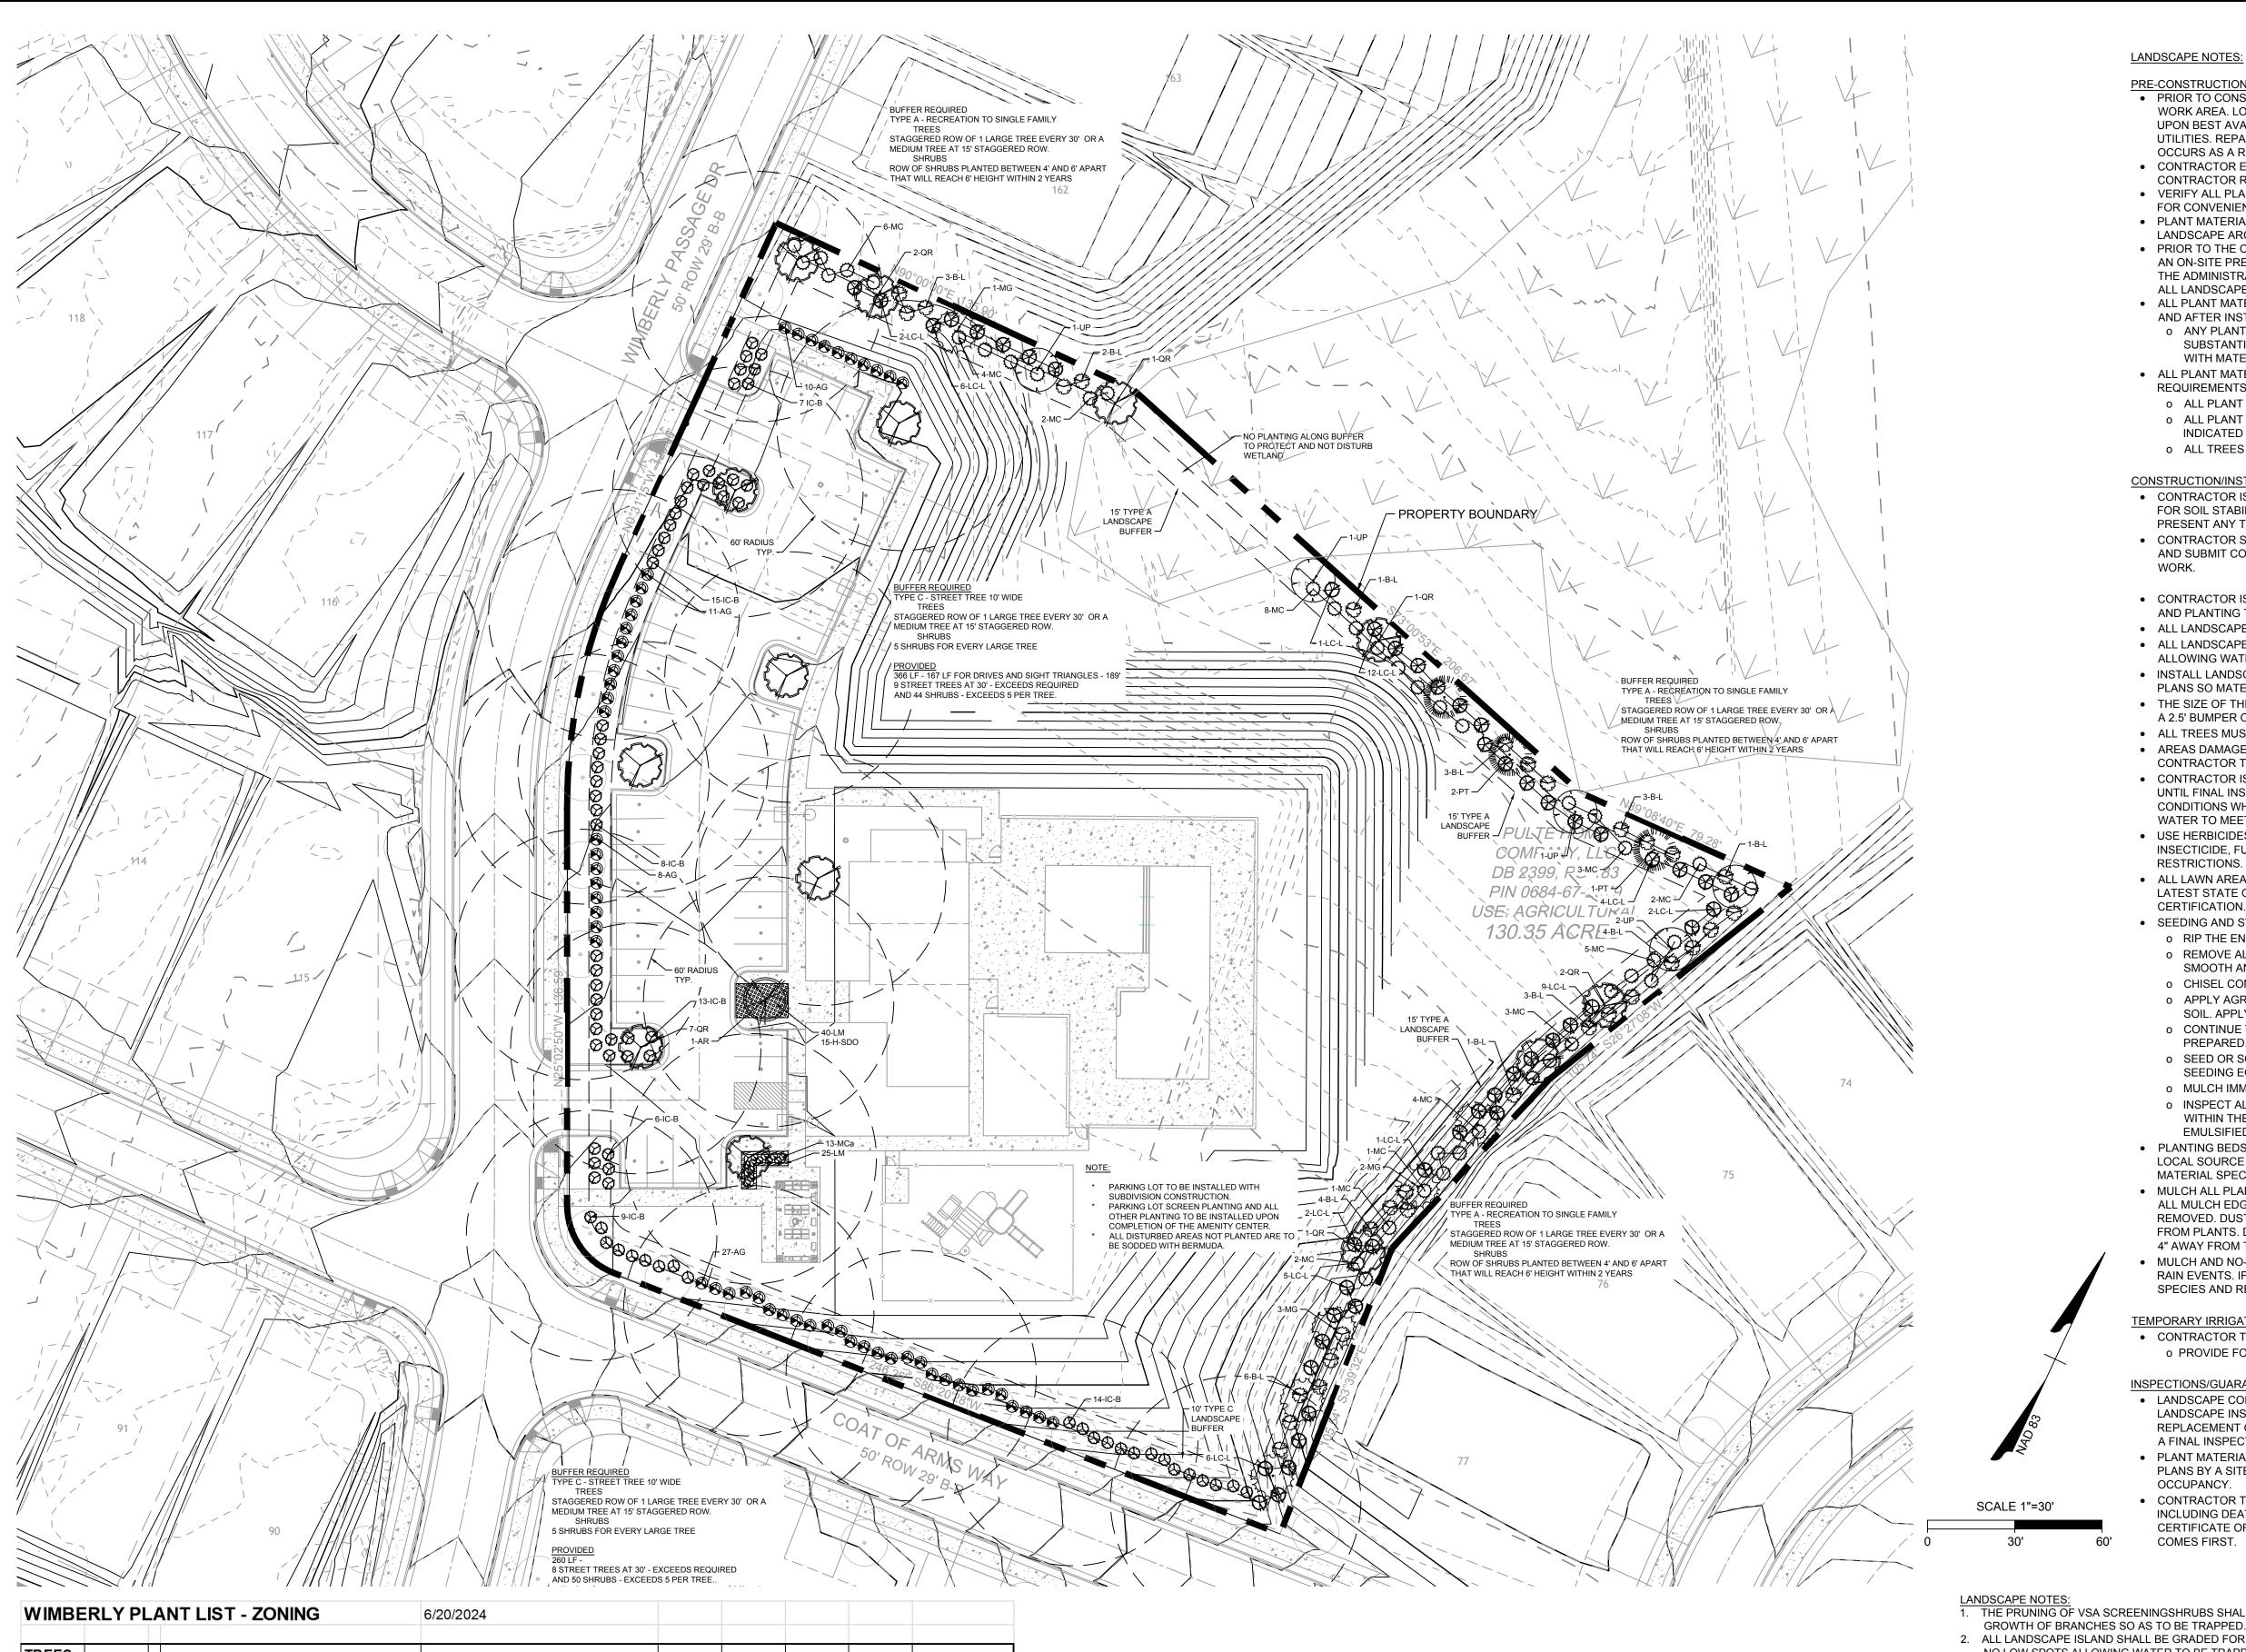

TREES CODE QUANT SCIENTIFIC NAME COMMON NAME CAL CONT SP NOTES HT RED MAPLE ACER RUBRUM B&B 10'12' 6'-8' B&B MG MAGNOLIA GRANDIFLORA SOUTHERN MAGNOLIA 10'12' 6'-8' B&B PT PINUS TAEDA WHITE PINE 10'12' 6'-8' NORTHERN RED OAK QR QUERCUS RUBRUM B&B 10'12' 6'-8' 14 UP ULMUS PARVIFOLIA LACEBARK ELM B&B 10'12' 6'-8' SUB-TOTAL SHRUBS 18"-24" 18"-24" AG ABELIA GRANDIFLORA GLOSSY ABELIA 56 24"-36" 24"-36" BUDDLEIA - LARGE BUTTERFLY BUSH - LARGE VARIETY **ICB** ILEX CORNUTA BURFORDII - NANA DWARF BURFORD HOLLY 18"-24" 18"-24" LC-L LOROPETALUM CHINSENSE LARGE LARGE VARIETY- LOROPETALUM CONT 24"-36" 24"-36" MCa CONT 13 MIUHLENBERGIA CAPILLARIS 18"-24" 18"-24" PINK MUHLY GRASS MC CONT 24"-36" 24"-36" 41 MYRICA CERIFERA WAX MYRTLE

SUB-TOTAL

GROUND	COVER						
LM	25	LIRIOPE MUSCARI	BIG BLUE LIRIOPE		6 BIBB C	LUMP	
				SUB-TC	TAL		
	SF						
GRASS		BERMUDA SOD ALL DISTURBED	AREAS THAT ARE NOT PLANTED				
MULCH		INCLUDED IN PLANT PRICING					
				TOTAL			

LANDSCAPE NOTES:

- PRIOR TO CONSTRUCTION LOCATE ALL UNDERGROUND UTILITIES WITHIN AND ADJACENT TO THE WORK AREA. LOCATIONS OF EXISTING BURIED UTILITY LINES SHOWN ON THE PLANS ARE BASED UPON BEST AVAILABLE INFORMATION AND ARE TO BE CONSIDERED APPROXIMATE. PROTECT ALL UTILITIES. REPAIR ALL DAMAGE TO UTILITIES, STRUCTURES, SITE APPURTENANCES, ETC. WHICH OCCURS AS A RESULT OF CONSTRUCTION.
- CONTRACTOR ENGAGED IN LANDSCAPE IMPLEMENTATION SHALL BE A LANDSCAPE CONTRACTOR REGISTERED IN THE STATE OF NORTH CAROLINA.
- VERIFY ALL PLANT MATERIAL QUANTITIES ON PLANS PRIOR TO BIDDING. PLANT LIST TOTALS ARE FOR CONVENIENCE ONLY AND MUST BE VERIFIED.
- PLANT MATERIAL SUBSTITUTIONS CAN ONLY OCCUR WITH PRIOR WRITTEN APPROVAL BY
- LANDSCAPE ARCHITECT. PRIOR TO THE COMMENCEMENT OF ANY ACTIVITIES REQUIRING A BUILDING OR ZONING PERMIT
- AN ON-SITE PRE-CONSTRUCTION CONFERENCE SHALL TAKE PLACE WITH THE DEVELOPER AND THE ADMINISTRATOR TO REVIEW PROCEDURES FOR THE PROTECTION AND MANAGEMENT OF ALL LANDSCAPE ELEMENTS TO REMAIN.
- ALL PLANT MATERIALS ARE SUBJECT TO LANDSCAPE ARCHITECT APPROVAL BEFORE, DURING, AND AFTER INSTALLATION.
- o ANY PLANT MATERIAL WHICH IS DISEASED, DISTRESSED, DEAD, OR REJECTED (PRIOR TO SUBSTANTIAL COMPLETION) SHALL BE PROMPTLY REMOVED FROM THE SITE AND REPLACED WITH MATERIAL OF THE SAME SPECIES, QUANTITY, AND SIZE.
- ALL PLANT MATERIALS AND INSTALLATION SHALL COMPLY WITH RECOMMENDATIONS AND
- REQUIREMENTS OF ANSI Z60.1 "AMERICAN STANDARD FOR NURSERY STOCK". ALL PLANT MATERIAL SHALL BE HEALTHY, VIGOROUS, AND FREE OF PESTS AND DISEASE.
- o ALL PLANT MATERIAL SHALL BE CONTAINER GROWN OR BALLED AND BURLAPPED AS INDICATED IN THE PLANT LIST.
- o ALL TREES SHALL HAVE A STRAIGHT TRUNK AND FULL HEAD.

CONSTRUCTION/INSTALLATION

- CONTRACTOR IS ENCOURAGED TO COMPLETE TEMPORARY OR PERMANENT SEEDING IN STAGES. FOR SOIL STABILIZATION AS AREAS ARE COMPLETED AFTER GRADING. THIS PLAN DOES NOT PRESENT ANY TEMPORARY STABILIZATION REQUIRED AS PART OF SWPPP PLAN.
- CONTRACTOR SHALL TAKE 3 REPRESENTATIVE SOIL SAMPLES OF EACH PROPOSED PLANT BED AND SUBMIT COPIES OF THE RESULTS TO THE LANDSCAPE ARCHITECT PRIOR TO BEGINNING
- CONTRACTOR IS RESPONSIBLE FOR DELIVERY SCHEDULE AND PROTECTION BETWEEN DELIVERY AND PLANTING TO MAINTAIN HEALTHY PLANT CONDITIONS.
- ALL LANDSCAPED AND LAWN AREAS ARE TO RECEIVE A MINIMUM OF 4" OF TOPSOIL
- ALL LANDSCAPE ISLANDS SHALL BE GRADED FOR POSITIVE DRAINAGE WITH NO LOW SPOTS
- ALLOWING WATER TO BE TRAPPED. INSTALL LANDSCAPE PLANTINGS AT ENTRANCES/EXITS AND PARKING AREAS ACCORDING TO
- PLANS SO MATERIAL WILL NOT INTERFERE WITH SIGHT DISTANCES.
- THE SIZE OF THE PLANTING AREA AND SIZE OF PLANT MATERIAL AT MATURITY SHALL ALLOW FOR
- A 2.5' BUMPER OVERHANG FROM THE BACK OF CURB
- ALL TREES MUST BE GUYED OR STAKED AS DETAILED.
- AREAS DAMAGED FROM PLANT RELOCATION OR OTHER ACTIVITIES OF LANDSCAPE
- CONTRACTOR TO BE RESEEDED AND ESTABLISHED AT NO ADDITIONAL COST TO THE OWNER. CONTRACTOR IS RESPONSIBLE FOR WATERING ALL PLANT MATERIAL DURING INSTALLATION AND UNTIL FINAL INSPECTION AND ACCEPTANCE BY OWNER. CONTRACTOR SHALL NOTIFY OWNER OF
- CONDITIONS WHICH AFFECTS THE GUARANTEE. IT MAY BE NECESSARY TO TRUCK IN NON-CITY WATER TO MEET PLANT NEEDS.
- USE HERBICIDES, PESTICIDES, AND FERTILIZER IN A MANNER CONSISTENT WITH THE FEDERAL INSECTICIDE, FUNGICIDE, AND RODENTICIDE ACT AND IN ACCORDANCE WITH LABEL
- ALL LAWN AREAS TO BE SEEDED SHALL USE A LOCALLY GROWN COMMERCIAL MIX MEETING LATEST STATE OF NORTH CAROLINA AGRICULTURE STANDARDS FOR SEED AND PLANT
- CERTIFICATION.
- SEEDING AND STRAW NOTES FOR LAWN AREAS:
- o RIP THE ENTIRE AREA TO DEPTH OF NOT LESS THAN 6".
- o REMOVE ALL LOOSE ROCKS, ROOTS, AND OTHER OBSTRUCTIONS LEAVING SURFACE SMOOTH AND UNIFORM. DISPOSE OF WASTE MATERIAL OFF-SITE.
- CHISEL COMPACTED AREAS AND SPREAD TOPSOIL TO SPECIFIED DEPTH.
- o APPLY AGRICULTURAL LIME, FERTILIZER, AND SUPER PHOSPHATE UNIFORMLY AND MIX WITH
- SOIL. APPLY SOIL AMENDMENTS PER REQUIRED SOIL ANALYSIS RECOMMENDATIONS. o CONTINUE TILAGE UNTIL A WELL PULVERIZED, FIRM, REASONABLY UNIFORM SEEDBED IS
- o SEED OR SOD ON A FRESHLY PREPARED SEEDBED AND COVER SEED LIGHTLY WITH
- SEEDING EQUIPMENT OR CULTIPACK AFTER SEEDING.
- MULCH IMMEDIATELY AFTER SEEDING AND ANCHOR MULCH. o INSPECT ALL SEEDED AREAS AND IF POSSIBLE, MAKE NECESSARY REPAIRS OR RESEEDINGS WITHIN THE PLANTING SEASON. ANCHOR TACK WITH LIQUID ASPHALT AT 400 GAL/ACRE OR EMULSIFIED ASPHALT AT 300 GAL/ACRE.
- PLANTING BEDS TO BE COMPLETELY COVERED WITH A MINIMUM 4" DEPTH OF MATERIAL FROM A LOCAL SOURCE HARVESTED IN A SUSTAINABLE MANNER. REFER TO LANDSCAPE SCHEME FOR
- MATERIAL SPECIFICATIONS. MULCH ALL PLANT BEDS AND TREE RINGS WITH FRESH, CLEAN MATERIAL PER SPECIFICATIONS. ALL MULCH EDGES SHALL BE NEATLY TUCKED. ALL STRING AND/OR BAILING WIRE SHALL BE REMOVED. DUST SHRUBS AND GROUND COVER AFTER MULCHING TO REMOVE LOOSE MATERIAL
- FROM PLANTS. DO NOT PLACE MULCH IN CONTACT WITH THE TREE TRUNK: KEEP A MINIMUM OF 4" AWAY FROM TREE TRUNK OR BASE OF PLANT. MULCH AND NO-MOW MIXES SHALL BE REPLENISHED AS NEEDED, ESPECIALLY AFTER HEAVY RAIN EVENTS. IF NO-MOW MIX GERMINATES AT A RATE OF LESS THAN 90%, THEN REMOVE OTHER

TEMPORARY IRRIGATION

CONTRACTOR TO PROVIDE AND MAINTAIN TEMPORARY IRRIGATION FOR SOD:

o PROVIDE FOR ONE (1) YEAR

INSPECTIONS/GUARANTEE

- LANDSCAPE CONTRACTOR SHALL NOTIFY GENERAL CONTRACTOR UPON COMPLETION OF LANDSCAPE INSTALLATION. CONTRACTOR WILL VERIFY COMPLETENESS INCLUDING THE REPLACEMENT OF ALL DEAD PLANT MATERIAL. CONTRACTOR IS RESPONSIBLE FOR SCHEDULING A FINAL INSPECTION BY LANDSCAPE ARCHITECT.
- PLANT MATERIAL QUANTITIES AND SIZES WILL BE INSPECTED FOR COMPLIANCE WITH APPROVED PLANS BY A SITE PLAN REVIEW AGENT PRIOR TO THE RELEASE OF THE CERTIFICATE OF
- CONTRACTOR TO GUARANTEE ALL PLANT MATERIALS FOR ONE FULL YEAR AGAINST DEFECTS INCLUDING DEATH AND UNSATISFACTORY GROWTH. WARRANTY PERIOD SHALL BEGIN UPON CERTIFICATE OF OCCUPANCY OR WHEN THE OWNER TAKES OVER MAINTENANCE, WHICHEVER COMES FIRST.

THE PRUNING OF VSA SCREENINGSHRUBS SHALL ALLOW FOR LATERAL

- 2. ALL LANDSCAPE ISLAND SHALL BE GRADED FOR POSITIVE DRAINAGE WITH NO LOW SPOTS ALLOWING WATER TO BE TRAPPED.
- 3. ALL PLANT MATERIALS INSTALLED MUST MEET STANDARDS SET BY
- AMERICAN ASSOCIATION OF NURSERYMEN, INC. " STANDARD FOR
- 4. ALL BARE EARTH OR DISTURBED AREAS SHALL BE STABILIZED FROM SOIL EROSION IMMEDIATELY UPON PLANTING AND SHALL BE PERMANENTLY


APPROVED 5. NO STREET TREES MAY BE PLANTED WITHIN 5 FEET OF SIDEWALKS. WHEEL STOPS ARE REQUIRED IF LANDSCAPING CANNOT BE SET BACK 5.

> ALL CONSTRUCTION TO BE IN ACCORDANCE WITH ALL TOWN OF ANGIER STANDARDS, SPECIFICATIONS, AND DETAILS.



Town of Angier

Engineering Department

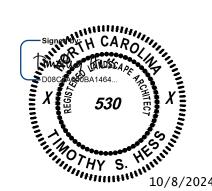


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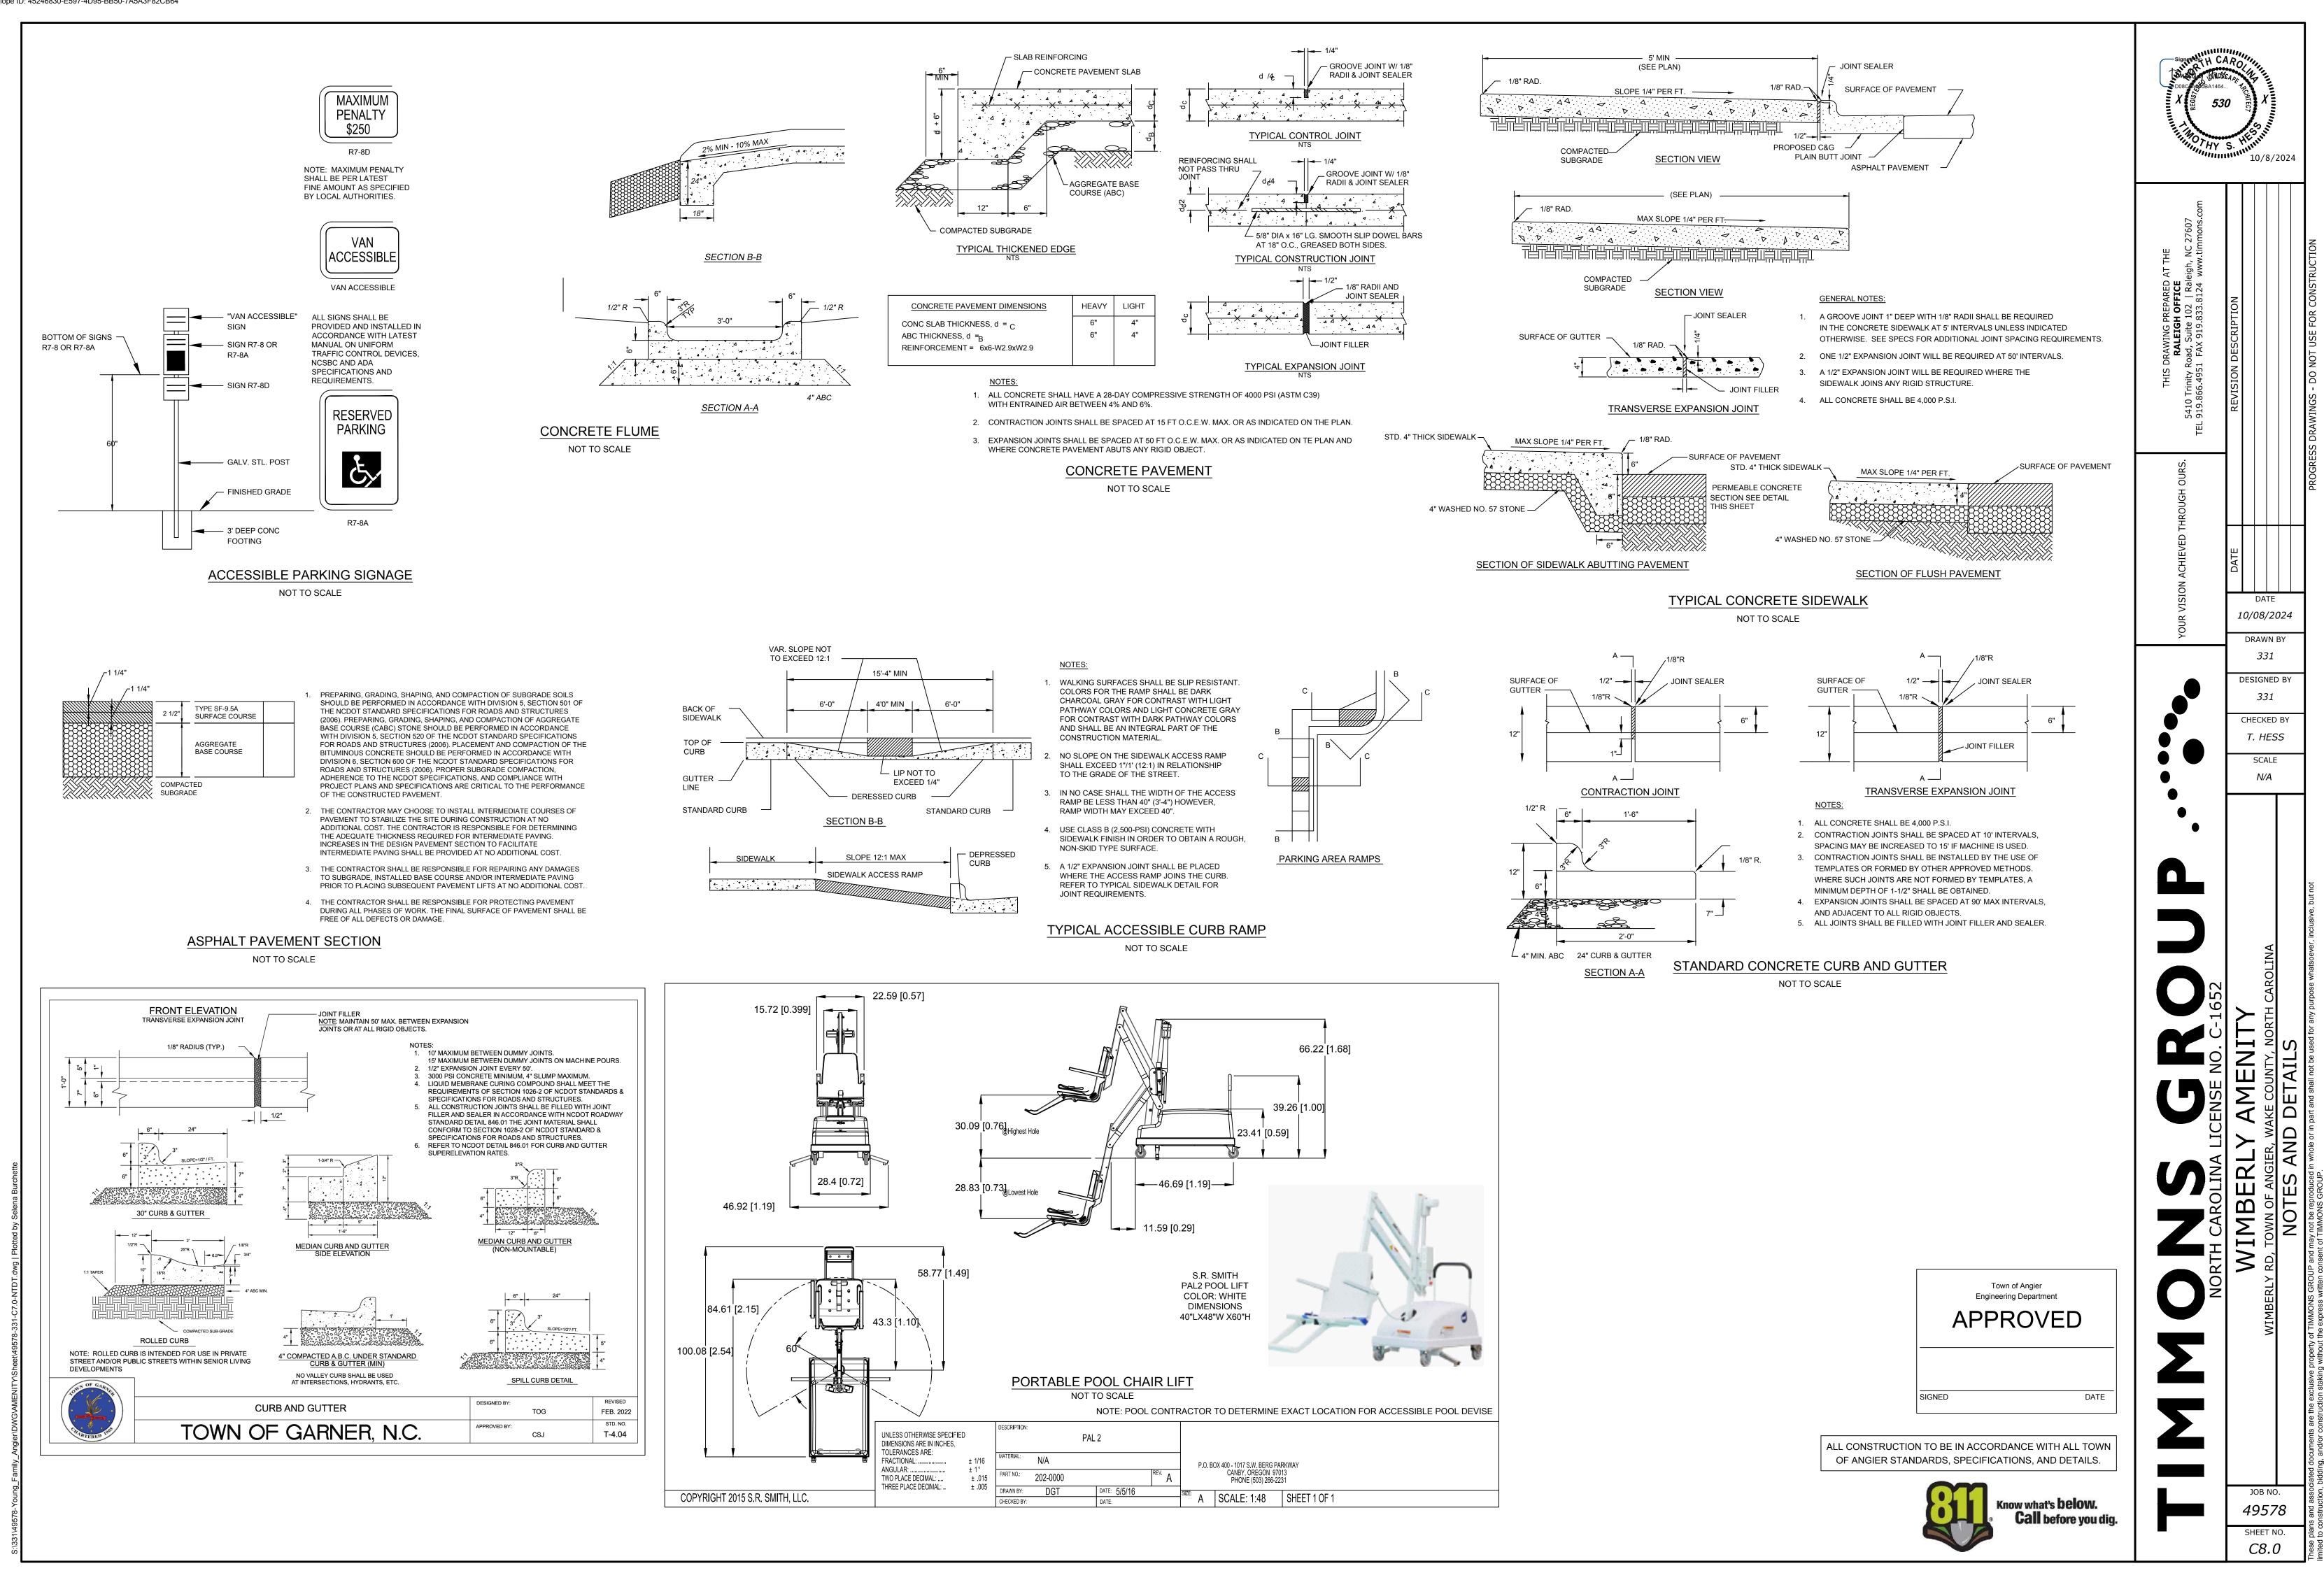
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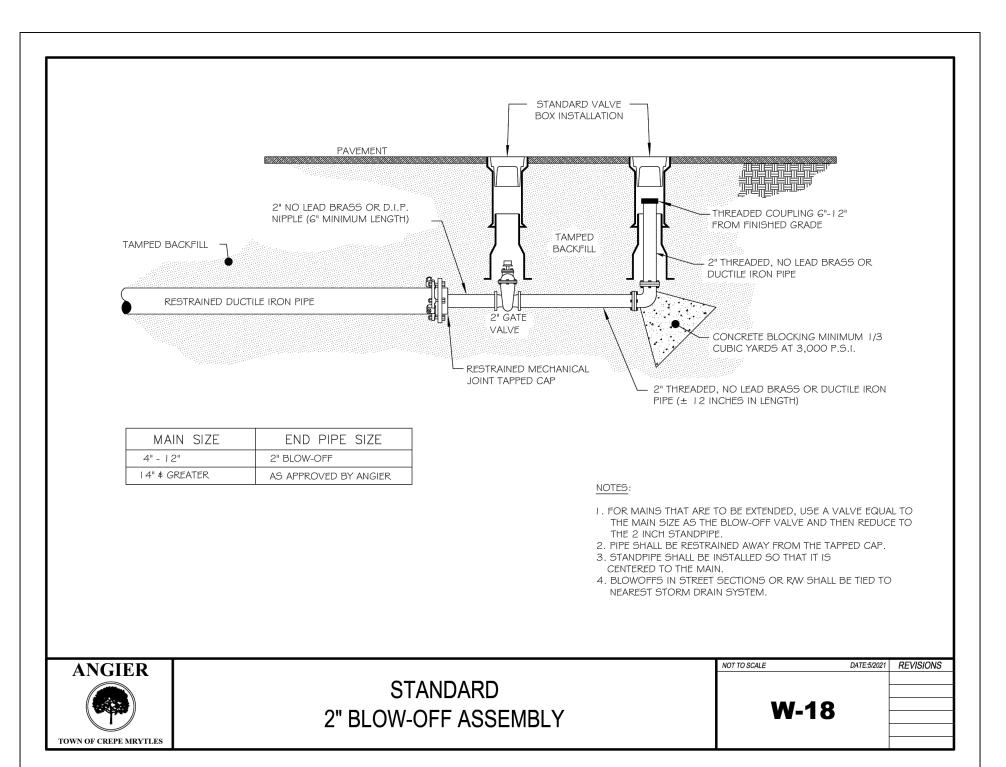
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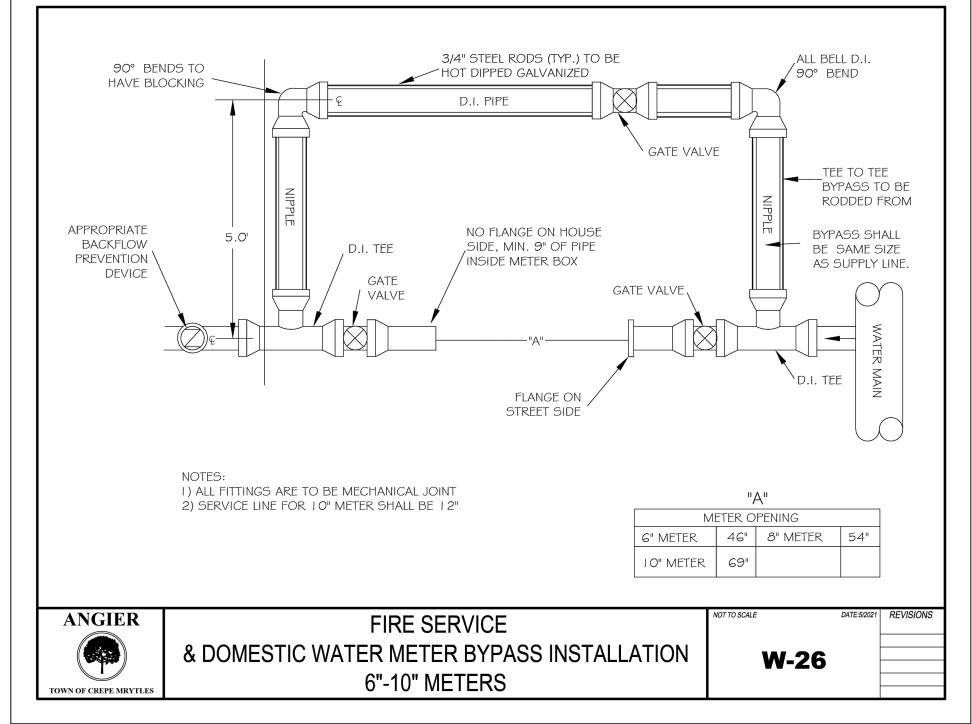
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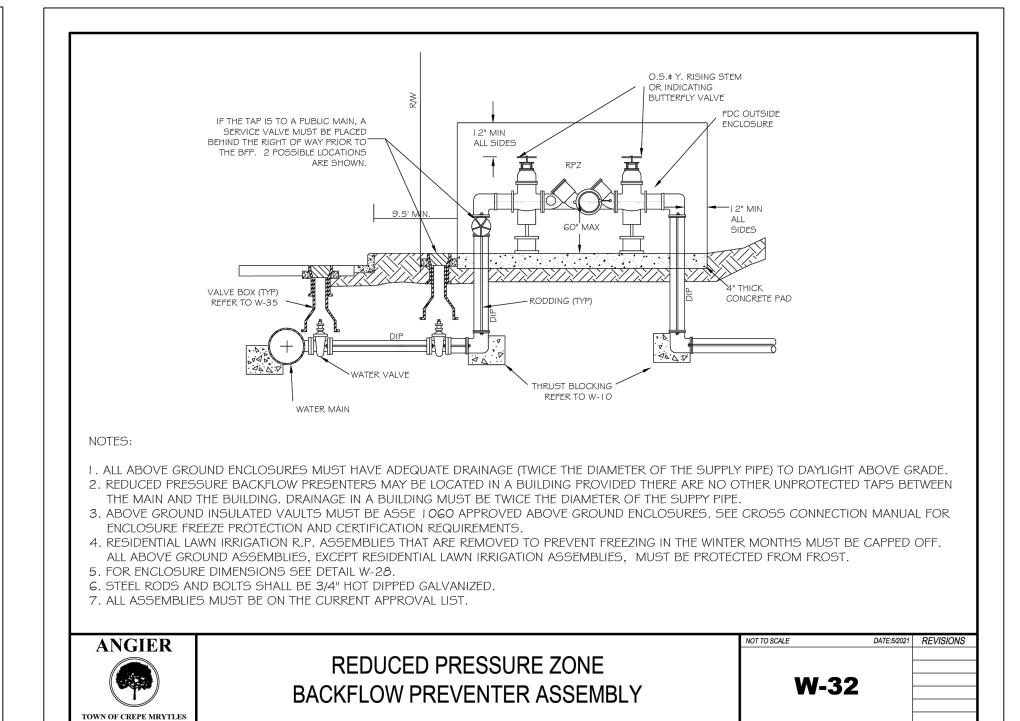






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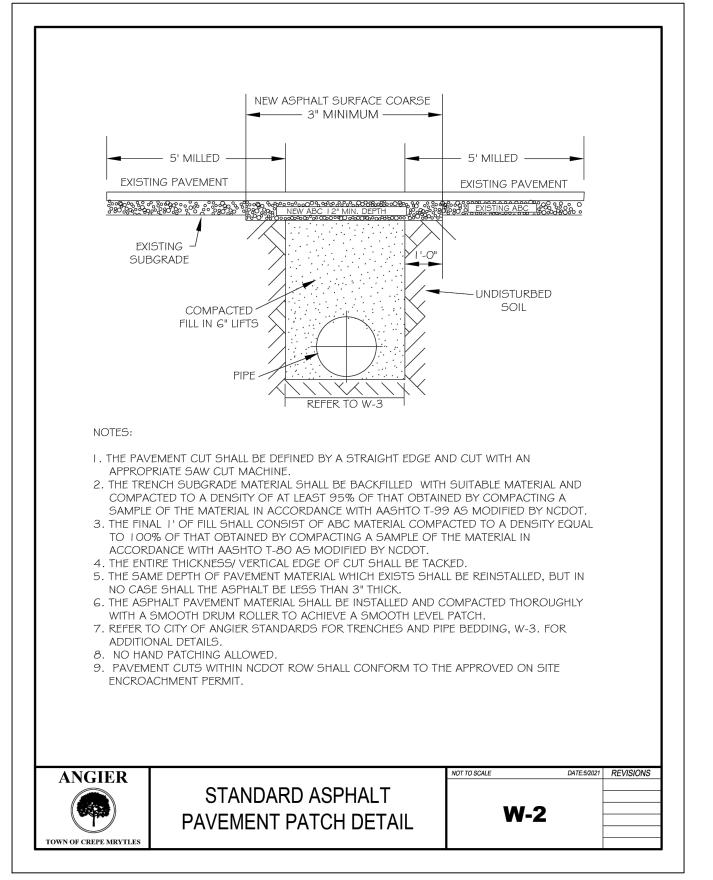








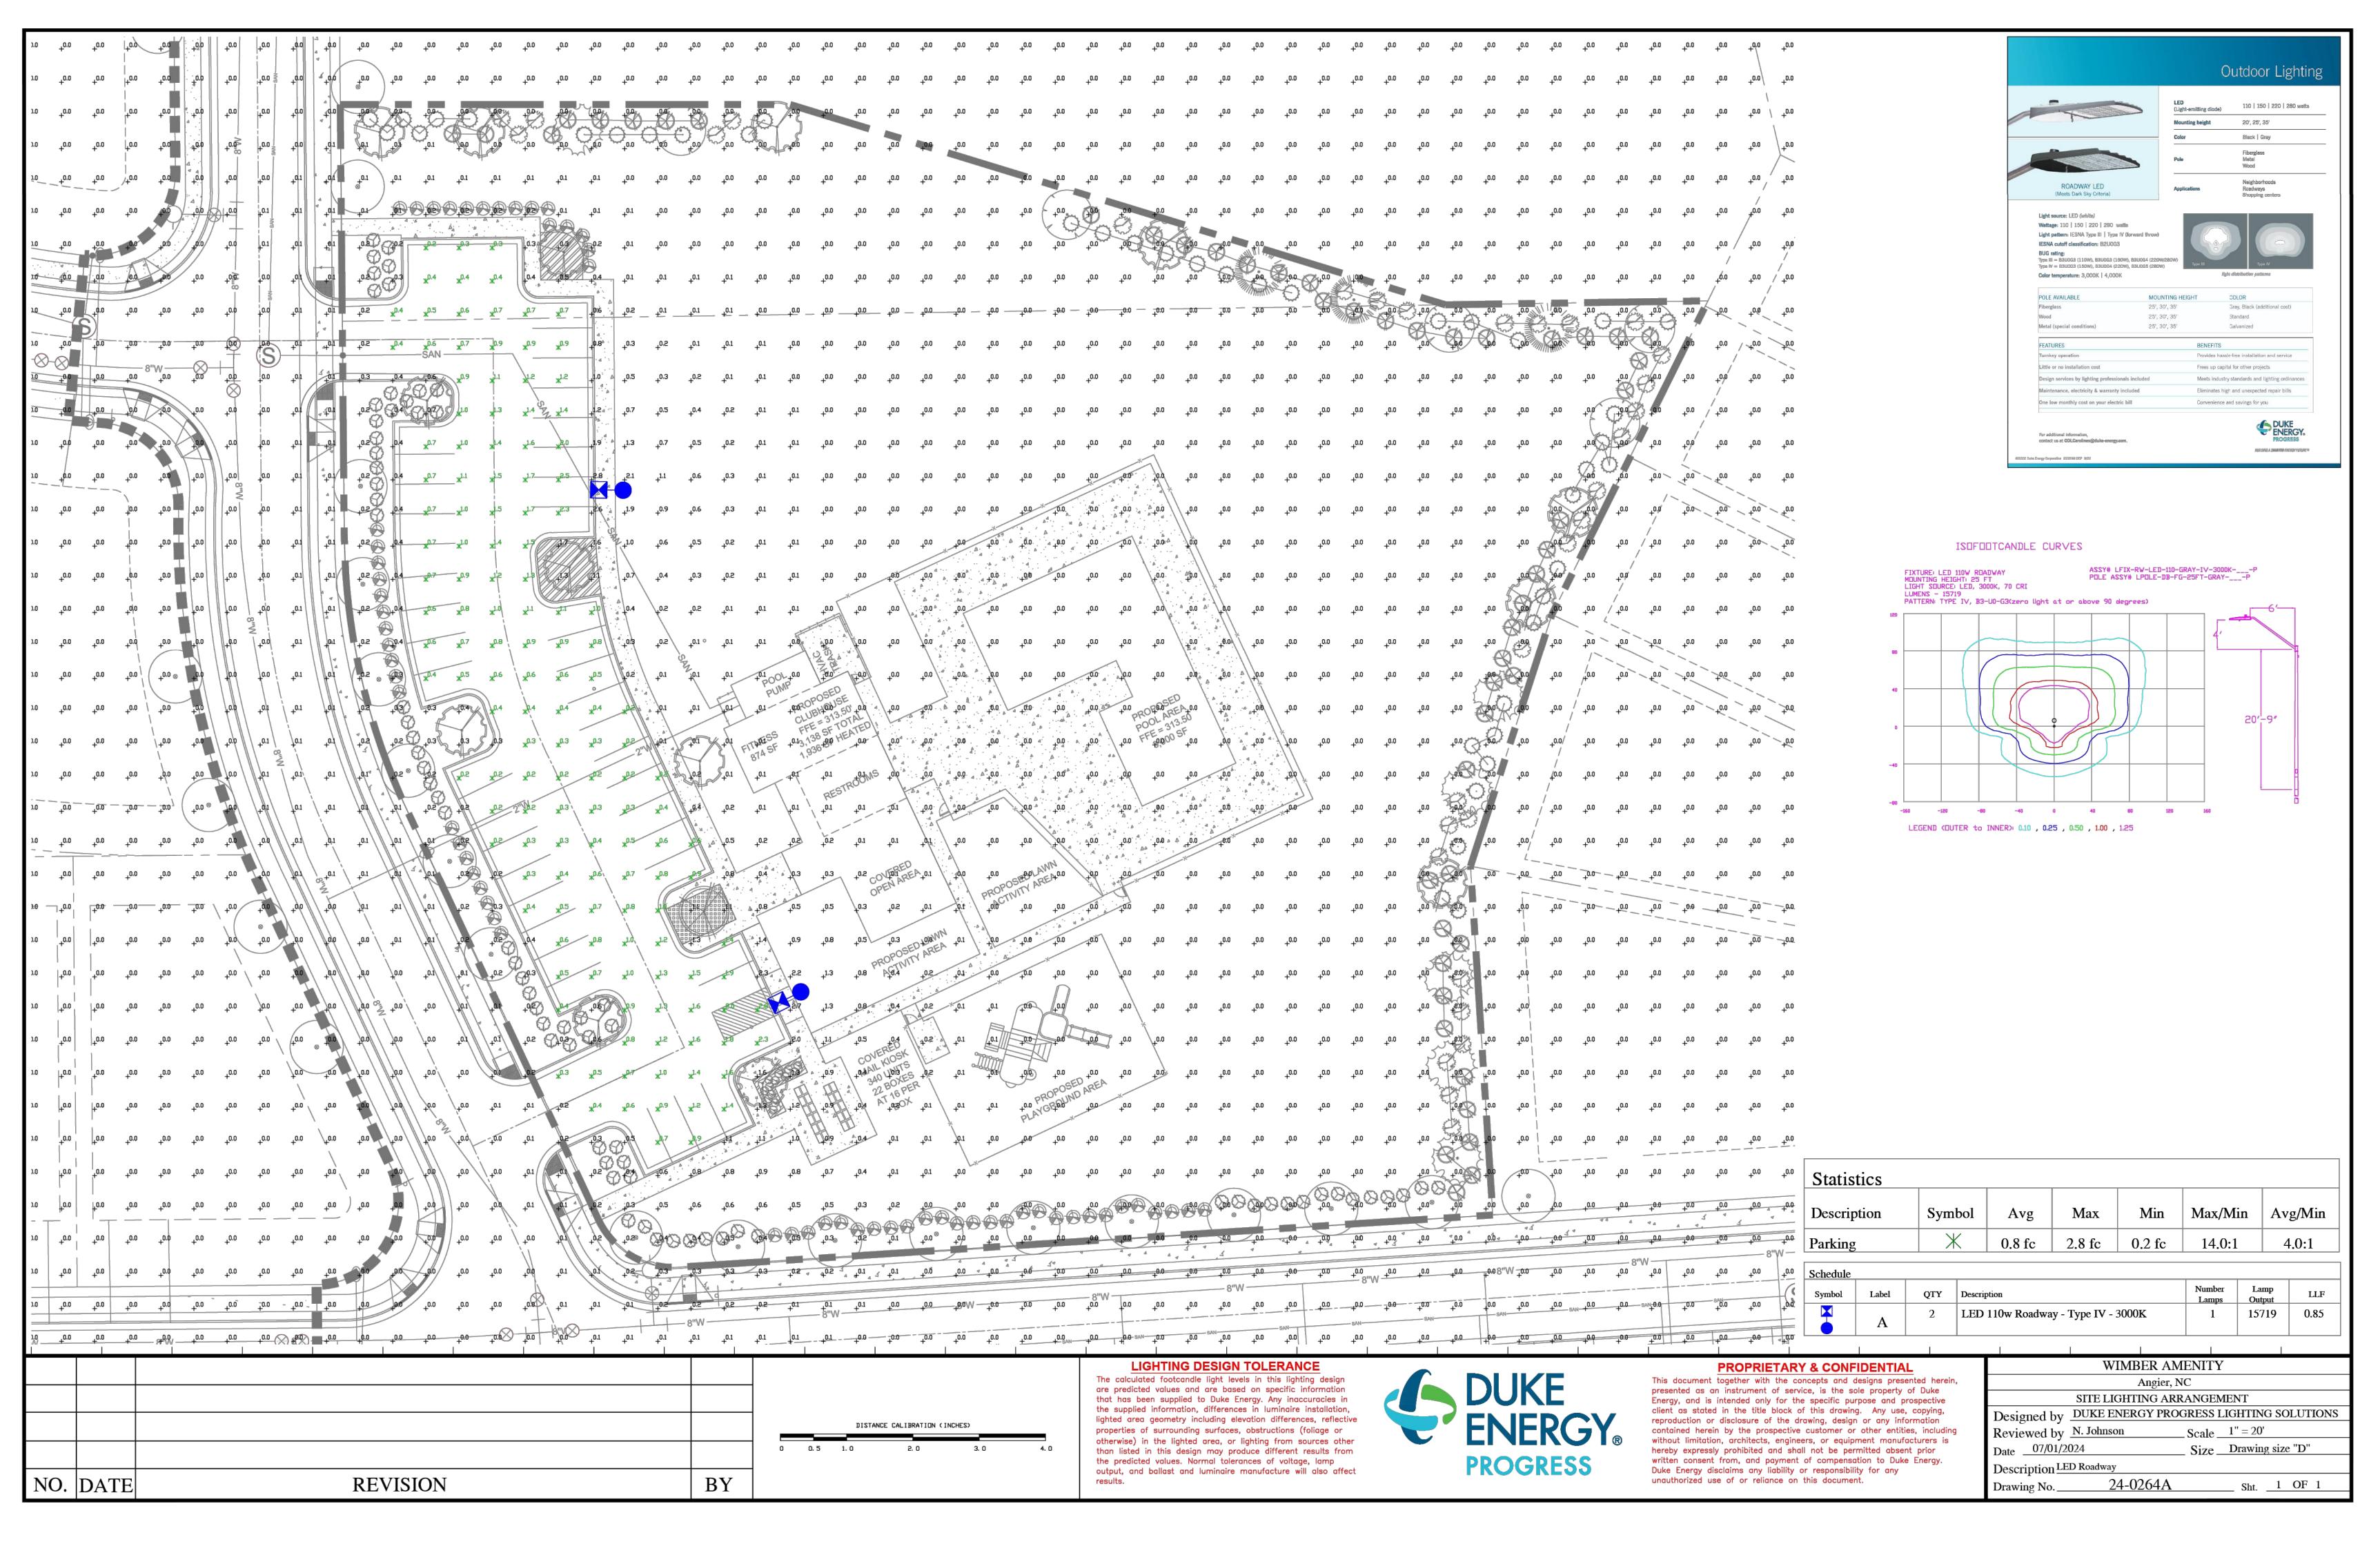

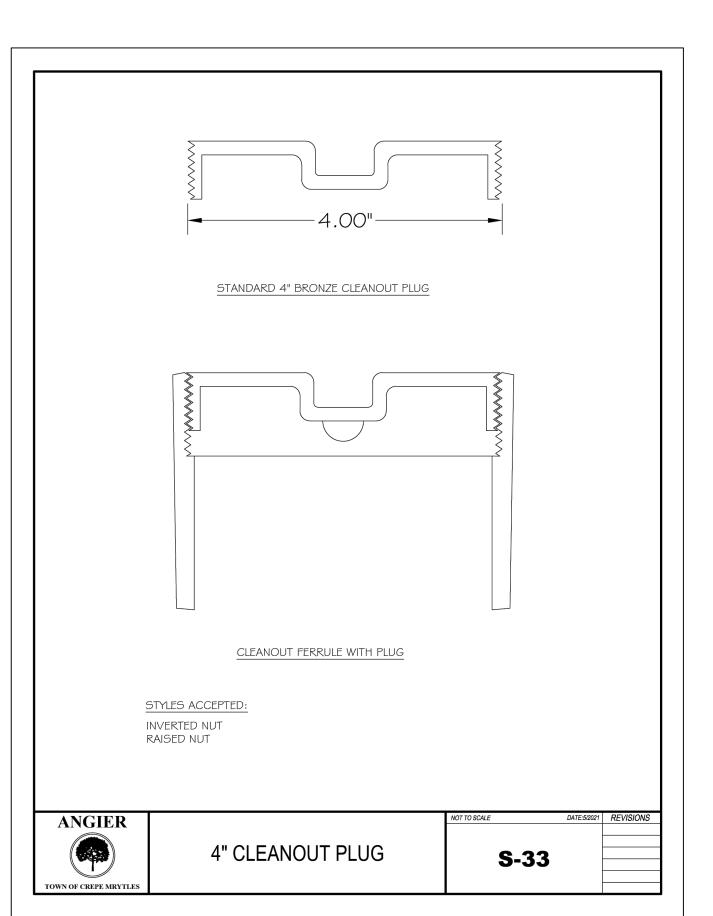

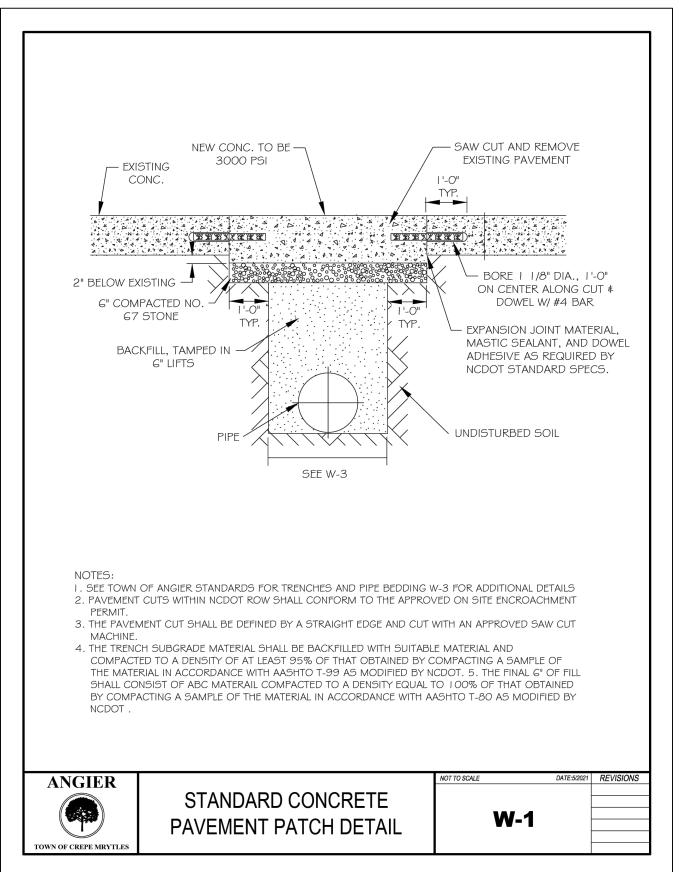

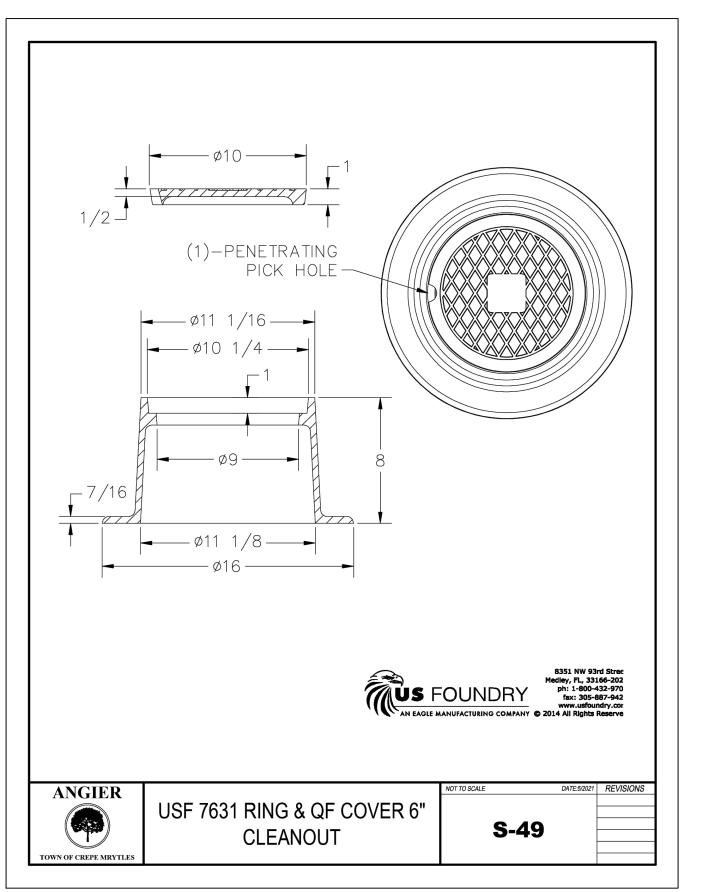

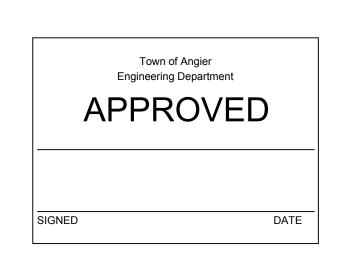

ALL CONSTRUCTION TO BE IN ACCORDANCE WITH ALL TOWN OF ANGIER STANDARDS, SPECIFICATIONS, AND DETAILS.




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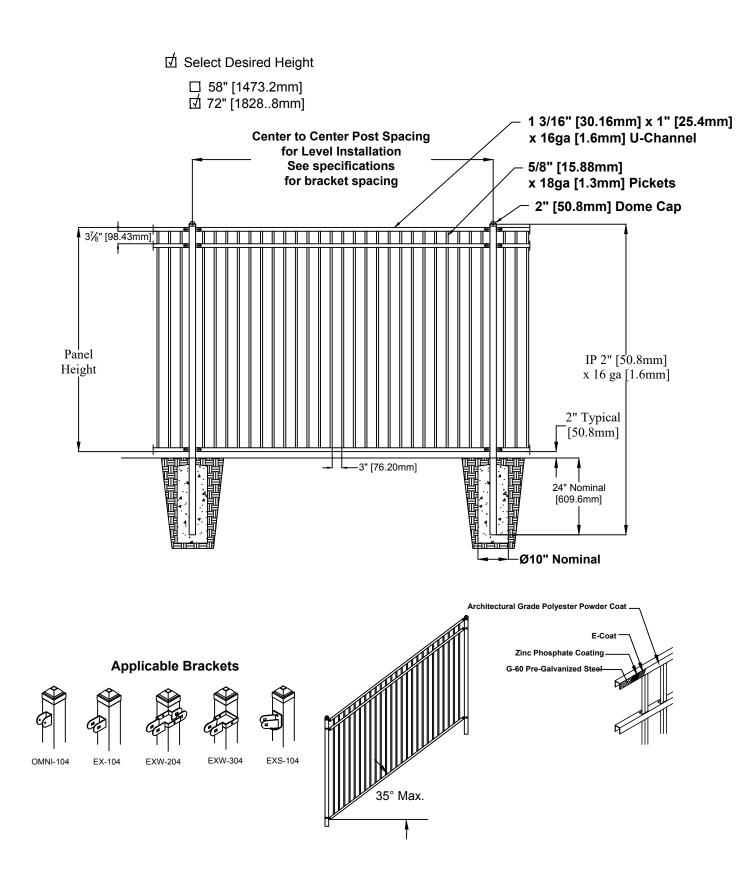
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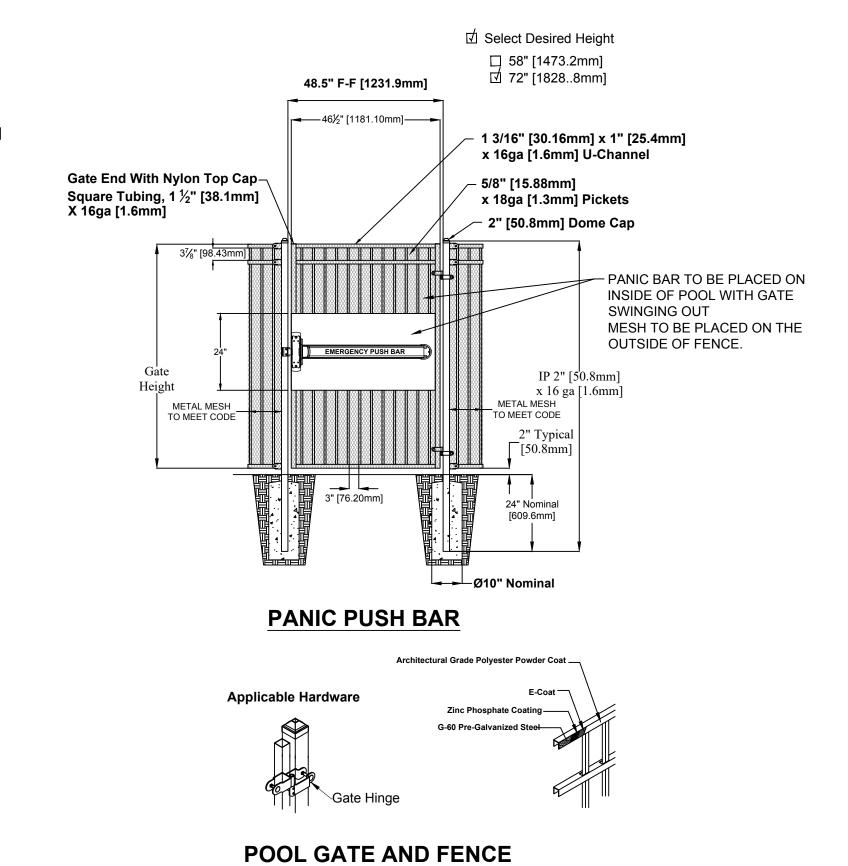
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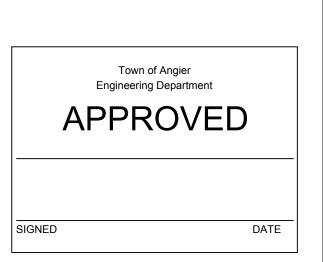








WILLYGOAT - HONOLULU PLAYGROUND (SKU: PKP155)

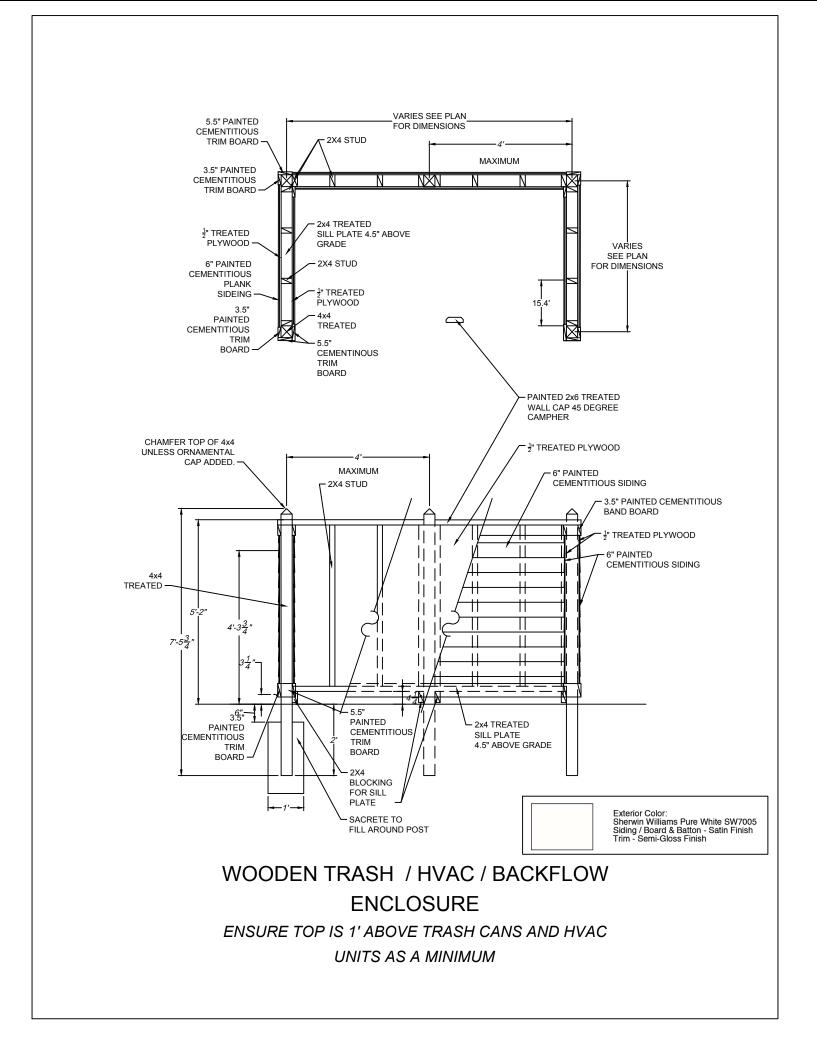

ALL CONSTRUCTION TO BE IN ACCORDANCE WITH ALL TOWN
OF ANGIER STANDARDS, SPECIFICATIONS, AND DETAILS.





DATE

10/08/2024


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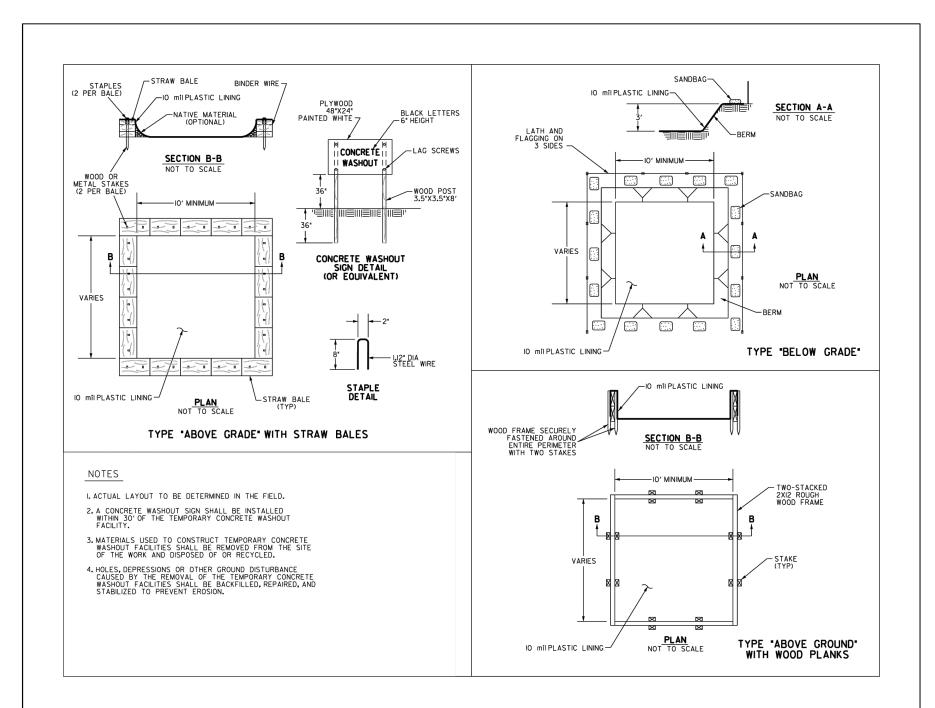
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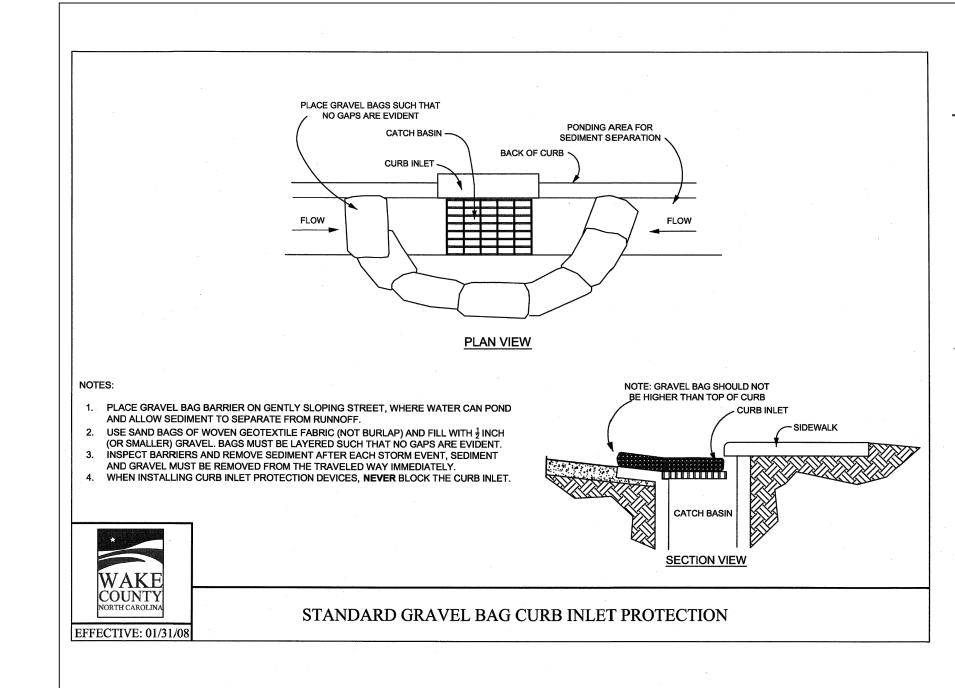
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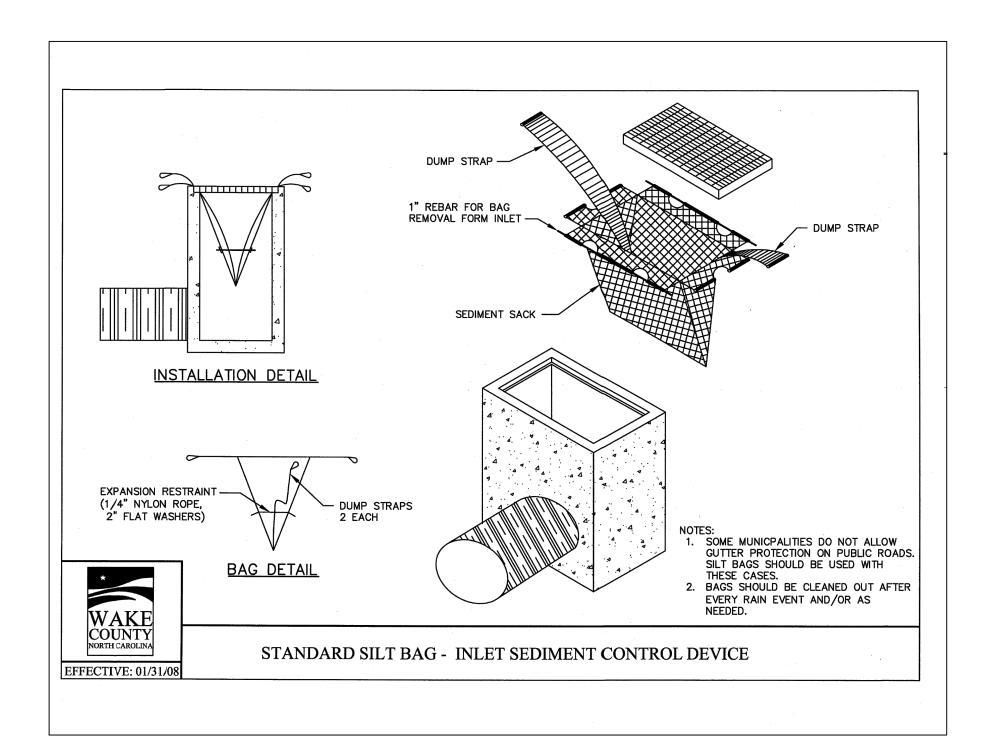
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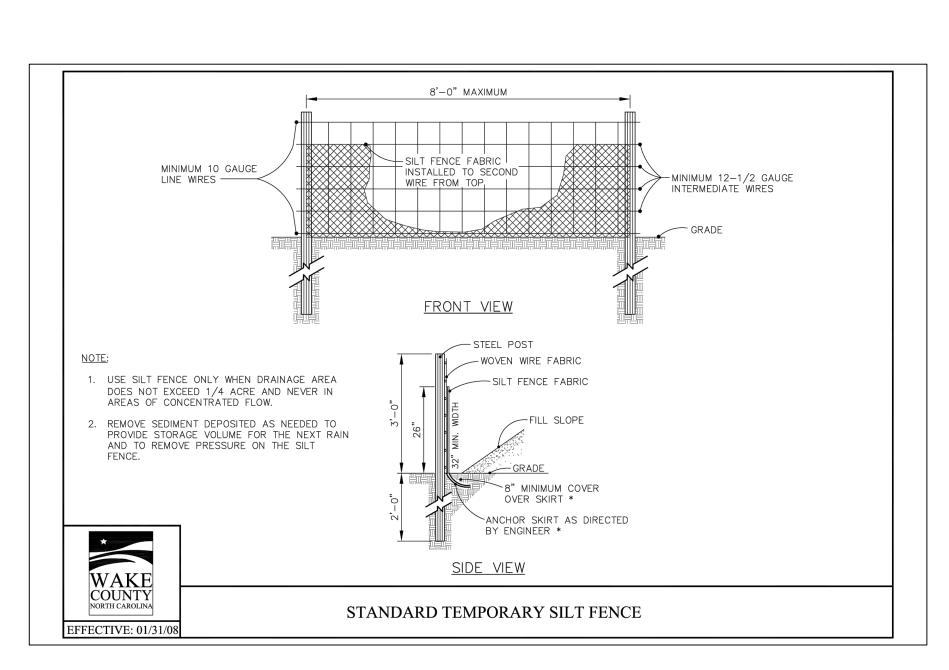
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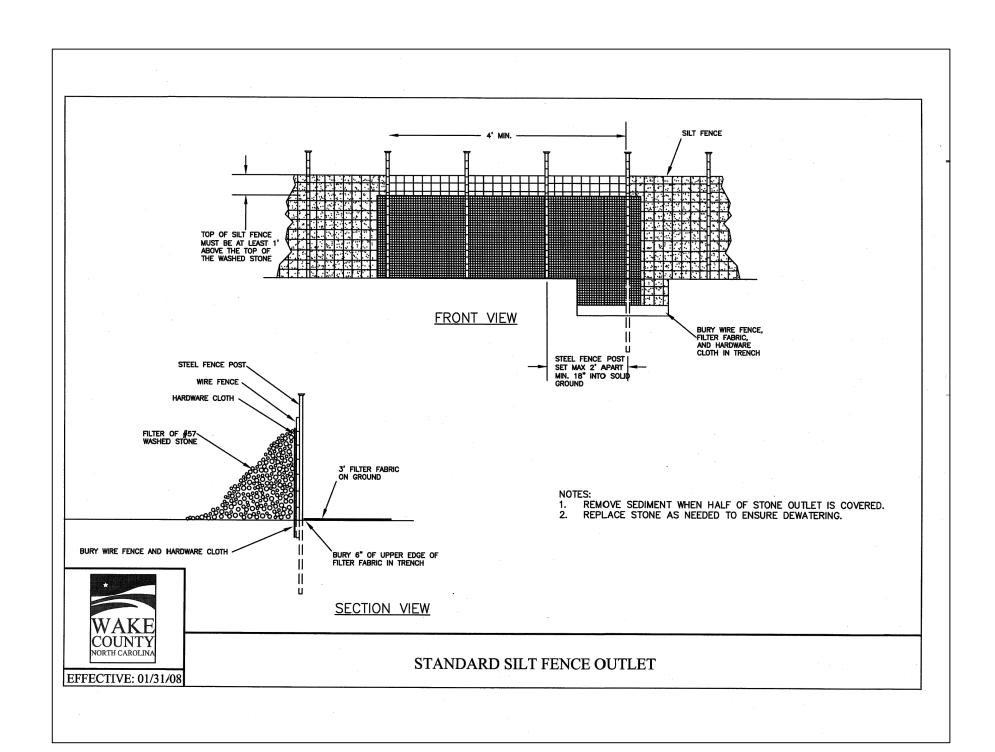











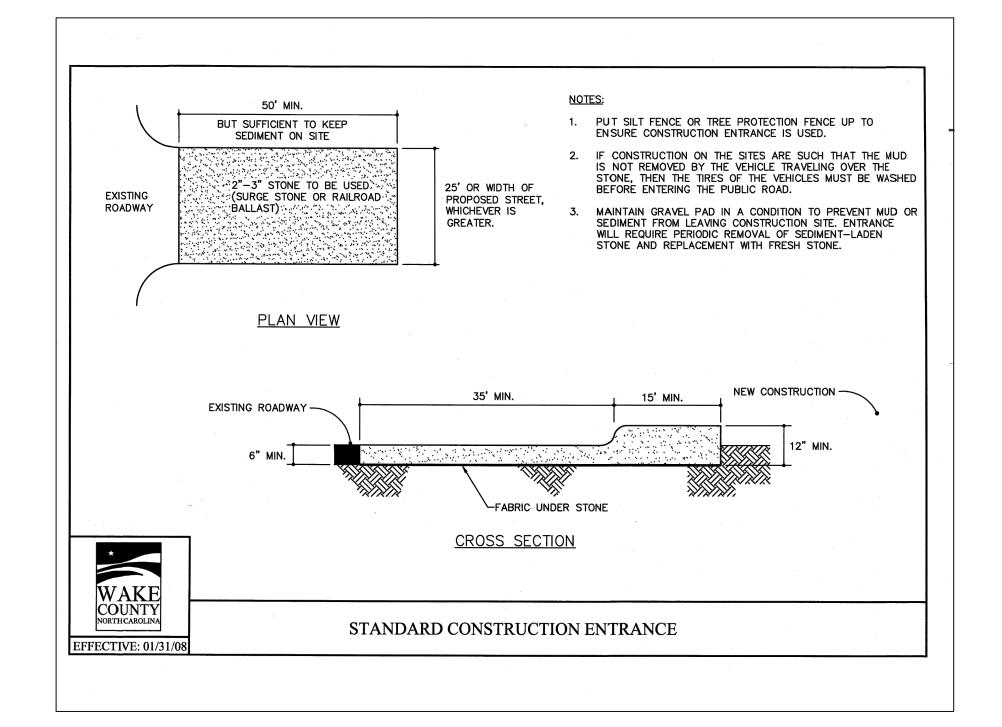

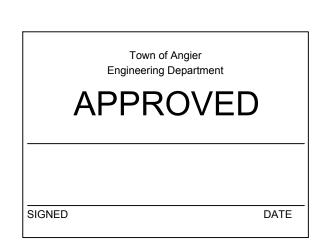

ALL CONSTRUCTION TO BE IN ACCORDANCE WITH ALL TOWN OF ANGIER STANDARDS, SPECIFICATIONS, AND DETAILS.



DATE 10/08/2024 DRAWN BY DESIGNED BY CHECKED BY

T. HESS SCALE

JOB NO. 49578 SHEET NO. C8.3

GENERAL LIFE SAFETY NOTES

USE: U (MISCELLANEOUS) NCSBC 303.1.1
BUILDING AREA: 380 SF
PRIMARY LOAD FACTOR: BUSINESS (100 SF)
OCCUPANT LOAD: 4 PPL

CONSTRUCTION TYPE: V-B
SPRINKLERS: NO

REQUIRED EXITS:

PROVIDED EXITS: N/A - OPEN AIR STRUCTURE

DIAGONAL DISTANCE:

REQUIRED EXIT SEPARATION:

PROVIDED EXIT SEPARATION:

N/A - ONE EXIT REQUIRED

N/A - ONE EXIT REQUIRED

REQUIRED EGRESS WIDTH:

PROVIDED EGRESS WIDTH:

N/A - OPEN AIR STRUCTURE


N/A - OPEN AIR STRUCTURE

MAXIMUM COMMON PATH OF TRAVEL: 75'-0"
MAXIMUM ALLOWABLE TRAVEL DISTANCE: 200'-0"
ACTUAL MAX TRAVEL DISTANCE: 12' - 0"

ROOF NOTES


- Roof decks shall be covered with approved roof coverings secured to the building or structure in accordance with the NCSBC. Roof coverings shall be designed and installed in accordance with the building code and the approved manufacturer's instructions.
- 2. Crickets or saddles shall be installed on the ridge side of any chimney or penetration greater than 30 inches wide as measured perpendicular to the slope. Cricket or saddle coverings shall be sheet metal or of the same material as the roof covering.
- 3. Asphalt shingles shall only be used on roof slopes of 2:12 or greater.
- 4. Roof slopes from 2:12 to 4:12, underlayment shall be two layers applied in the following manner. Apply a minimum 19" wide strip of underlayment felt parallel with and starting at the eaves, fastened sufficiently to hold in place. Starting at the eave, apply 36-inch-wide sheets of underlayment overlapping successive sheets 19 inches minimum and fasten in place.
- 5. Roof slopes from 4:12 or greater, underlayment shall be a minimum of one layer.
- 6. Flashing shall be installed at the wall and roof intersections, at gutters, and wherever there is a change in roof slope or direction and around roof openings. Where flashing is of metal, the metal shall be corrosion resistant with a thickness of not less than 0.019in (No. 26 galvanized sheet)
- Areas prone to ice formation along eaves causing a backup of water shall have an ice barrier that consists of at least (2) two layers of underlayment cemented together or of a self-adhering polymer-modified bitumen sheet. Extend ice barrier min. 18" each side of valleys and other ice prone areas.
- 8. Overhangs: Truss manufacturer to provide shorter gable end trusses where overhangs exceed 1'-0" to allow for outriggers to be framed over the top cord of the end truss and attached to the top cord of the secondary truss towards the interior of the gable. GC to verify prior to manufacturing of trusses.
- 9. Light Location: Truss manufacturere to cooridinate truss layout with reflected ceiling plans, electrical plans, and mechical plans to avoid conflicts



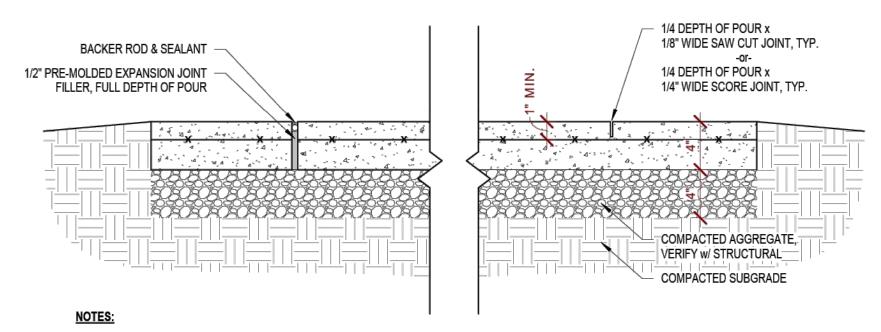


- ALL JOINTS TO BE CUT w/ WET WALK BEHIND SAW TO ENSURE ALL CUTS ARE PERPENDICULAR W/ FACE OF CONCRETE
- MAXIMUM CONTROL JOINT SPACING SHALL BE 10 FT. IN EACH DIRECTION UNLESS SHOWN OTHERWISE ON PLAN, SEE STRUCT. PROVIDE EXPANSION JOINT WHERE SLABS ARE POURED AGAINST VERTICAL SURFACES AND/OR DIFFERENT PAVING MATERIALS AND AS SPECIFIED ON PLANS OR 25'-0" MAX O.C.



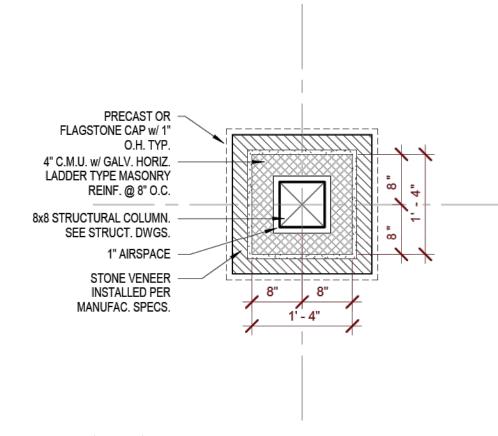


Detail - Typ. Pedestal


3/4" = 1'-0"

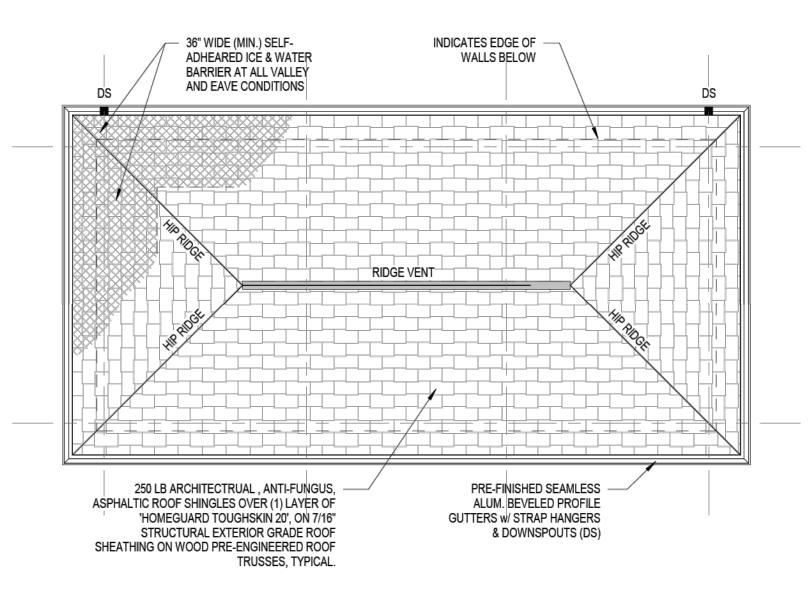




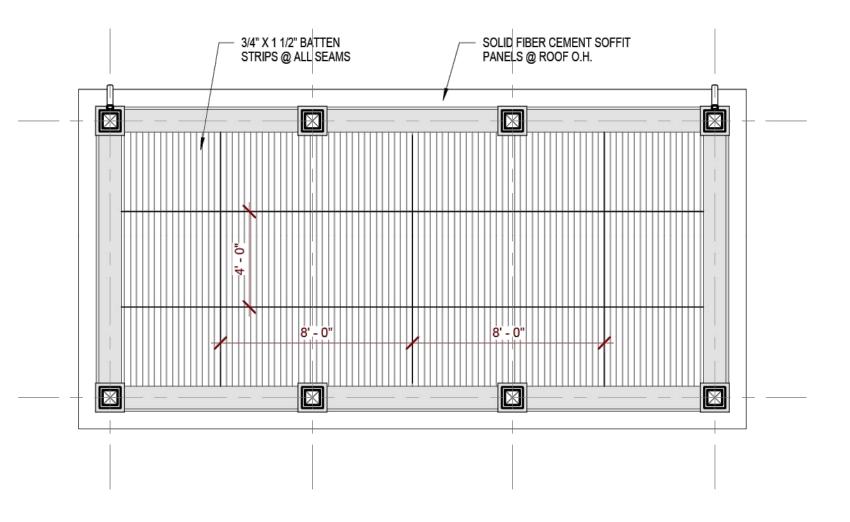




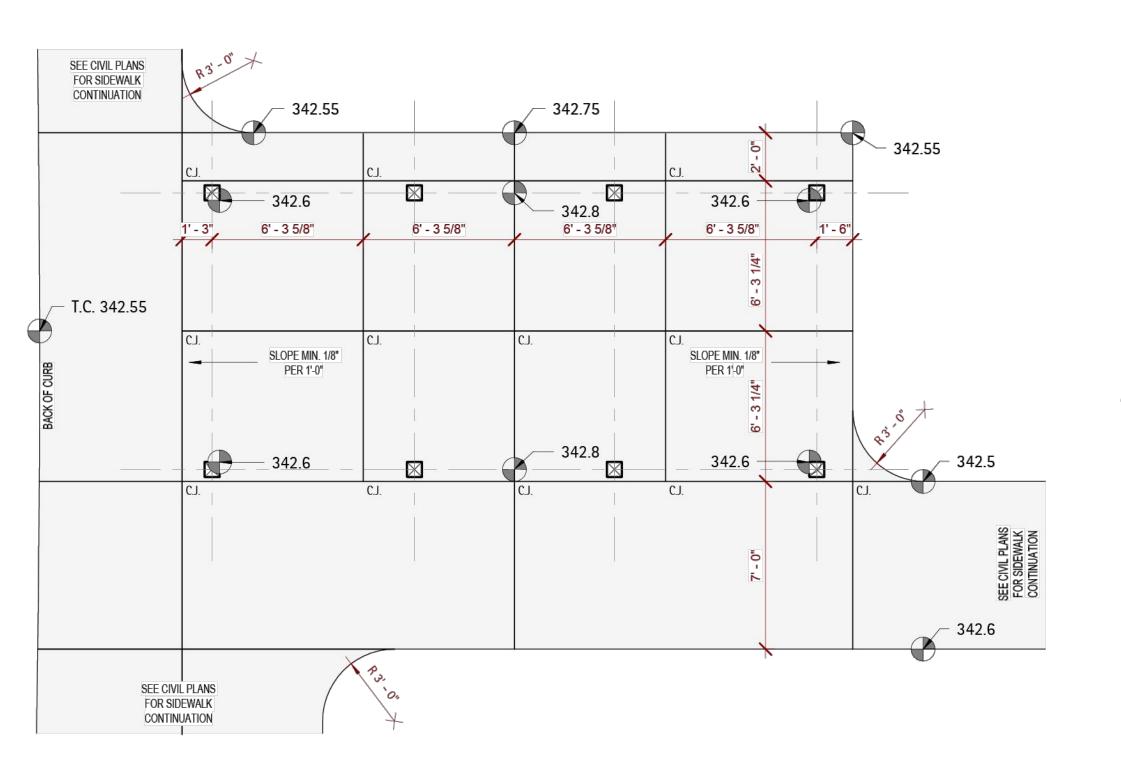


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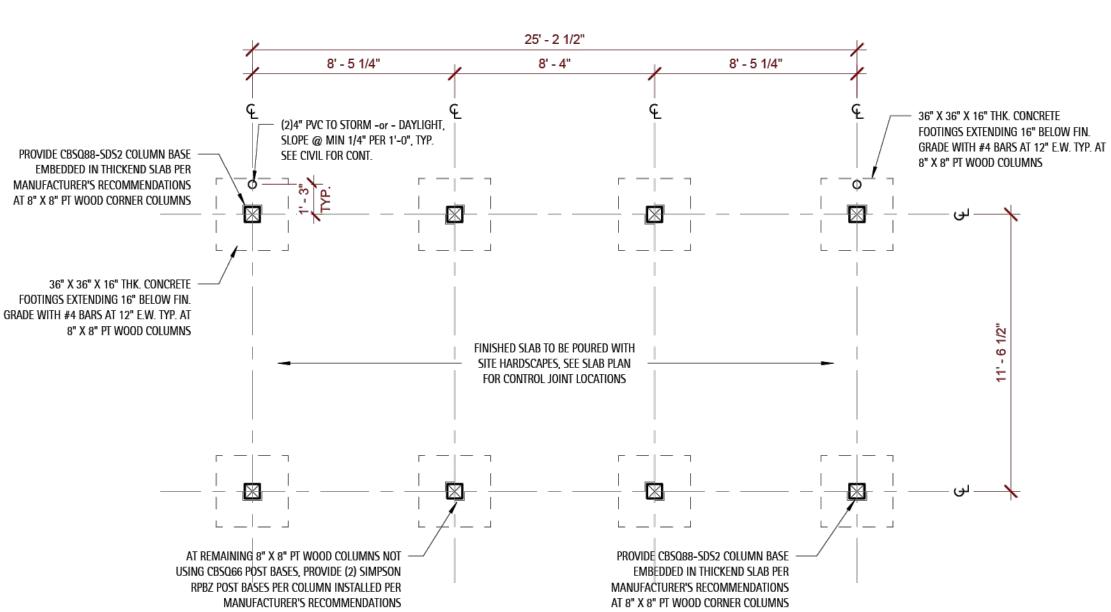


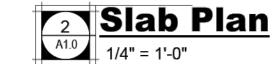

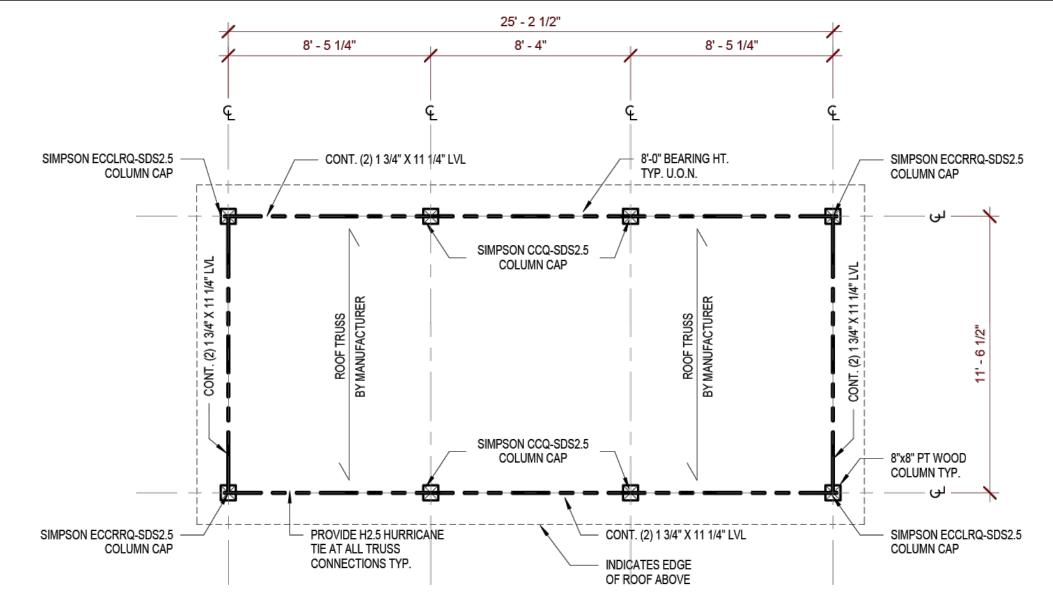Ceiling Framing Plan 1/4" = 1'-0"



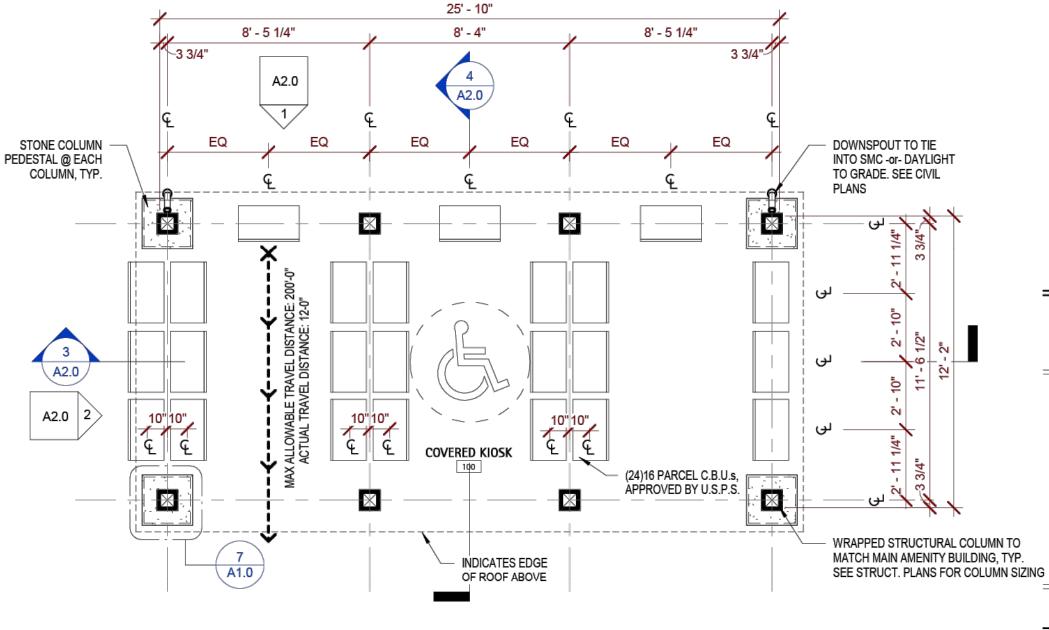



Foundation Plan

1/4" = 1'-0"





PRELIMINARY NOT OR CONSTRUCTIC

RAL COLUMN TO Y BUILDING, TYP. FOR COLUMN SIZING

SHEET DISCRIPTION

KIOSK PLANS

PROJECT #: 2021062

DATE ISSUED: 09/18/2023

DRAWING BY: JGM

CHECKED BY: BMR / BSJ

WIMBERLY AMENITY
PULTE GROUP
MAIL KIOSK
ANGIER, NC

<u>1</u> Δ1

I. GENERAL

1. DESIGN CODES

NORTH CAROLINA BUILDING CODE, 2018 EDITION (AMENDED 2015 INTERNATIONAL BUILDING CODE)

ACI BUILDING CODE REQUIREMENTS FOR STRUCTURAL CONCRETE (ACI 318-14)

ASCE 7-10 MINIMUM DESIGN LOADS FOR BUILDINGS AND OTHER STRUCTURES

DESIGN LOADS

LIVE LOADS: FLOOR: 100 PSF ROOF: 20 PSF

ULTIMATE DESIGN WIND SPEED: 115 MPH

GROUND SNOW LOAD 15 PSF

SEISMIC DESIGN CATEGORY B SITE CLASS D Ss = 0.157

3. ALL ELEVATIONS ARE REFERENCED FROM FINISHED FLOOR ELEVATION OF 0'-0". SEE ARCHITECTURAL DRAWINGS FOR ADDITIONAL INFORMATION.

II. CONCRETE

S1 = 0.077

1. UNLESS OTHERWISE NOTED, ALL CONCRETE SHALL HAVE THE FOLLOWING STRENGTH AND SLUMP REQUIREMENTS:

3,500 PSI 28-DAY COMPRESSIVE STRENGTH, MAX. 5" SLUMP.

ALL CONCRETE SHALL BE MOIST CURED PER ACI 301 OR CURED WITH AN APPROVED CURING COMPOUND. CONTRACTOR SHALL VERIFY THAT THE CURING COMPOUND IS COMPATIBLE WITH FLOOR COVERING ADHESIVES, COATINGS, OR TOPPINGS TO BE USED CONCRETE SHALL BE CURED FOR A MINIMUM OF 7 DAYS.

3. UNLESS OTHERWISE NOTED, ALL REINFORCING STEEL SHALL BE NEW BILLET STEEL, CONFORMING TO ASTM A-615, GRADE 60, DEFORMED.

4. UNLESS OTHERWISE NOTED, ALL DETAILING, FABRICATION, AND PLACING OF REINFORCING STEEL SHALL CONFORM TO THE MANUAL OF STANDARD PRACTICE FOR DETAILING REINFORCED CONCRETE STRUCTURES. (ACI 315)

5. ALL BAR SPLICES SHALL BE CLASS "B" TENSION SPLICES PER ACI 318-14, UNLESS OTHERWISE SHOWN.

6. CONTRACTOR SHALL REFER TO DRAWINGS OF OTHER TRADES AND VENDOR DRAWINGS FOR EMBEDDED ITEMS AND RECESSES NOT SHOWN ON THE STRUCTURAL DRAWINGS.

7. ALL SPREAD FOOTINGS BEARING ON NATIVE SOIL OR STRUCTURAL FILL ARE DESIGNED FOR AN ALLOWABLE BEARING PRESSURE OF 2.500 PSF. A GEOTECHNICAL REPRESENTATIVE SHALL INSPECT ALL FOOTING EXCAVATIONS TO CONFIRM ALLOWABLE BEARING PRESSURES.

8. CONTRACTOR SHALL BE RESPONSIBLE FOR LOCATING, PROTECTING, AND RELOCATING AS REQUIRED ALL SERVICE AND UTILITY LINES IN VICINITY OF THE WORK

9. ALL DOWELS WHICH ARE TO BE DRILLED AND GROUTED INTO EXISTING CONCRETE SHALL BE DONE WITH AN EPOXY GROUT. DRILL HOLE WITH DIAMETER 1/8" LARGER THAN DOWEL OR AS RECOMMENDED BY GROUT SUPPLIER. USE HIT-RE 500 V3 BY HILTI OR APPROVED EQUAL

III. WOOD

1. FRAMING LUMBER SHALL BE #2 SOUTHERN YELLOW PINE (SYP) WITH THE FOLLOWING DESIGN PROPERTIES:

Fb = 800 PSI Fv = 175 PSI E = 1.4E6 PSI

FRAMING LUMBER EXPOSED TO WEATHER OR IN CONTACT WITH THE GROUND, CONCRETE OR MASONRY SHALL BE #2 SOUTHERN YELLOW PINE (SYP) TREATED IN ACCORDANCE WITH AWPA C22 WITH THE FOLLOWING DESIGN PROPERTIES: Fb = 800 PSI Fv = 175 PSI E = 1.4E6 PSI

3. ENGINEERED WOOD BEAMS SHALL BE LAMINATED VENEER LUMBER (LVL) OR PARALLEL STRAND LUMBER (PSL) WITH THE FOLLOWING MINIMUM DESIGN PROPERTIES: Fb = 2600 PSI Fv = 285 PSI E = 1.9E6 PSI

4. ENGINEERED WOOD BEAMS SHALL BE INSTALLED WITH ALL CONNECTIONS PER MANUFACTURER'S INSTRUCTIONS.


IV. WOOD TRUSSES


1. ENGINEERED ROOF TRUSS SYSTEMS SHALL BE PROVIDED FOR REVIEW AND COORDINATED WITH THE ENGINEER OF RECORD. INSTALLATION SHALL BE IN ACCORDANCE WITH THE MANUFACTURER'S INSTRUCTIONS. ROOF TRUSS DRAWINGS SHALL BE SIGNED AND SEALED BY THE MANUFACTURER AND REVIEWED BY THE ENGINEER OF RECORD PRIOR TO CONSTRUCTION.

2. ALL TRUSSES SHALL BE DESIGNED AND INSTALLED IN ACCORDANCE WITH BCSI 1-03 "GUIDE TO GOOD PRACTICE FOR HANDLING, INSTALLING & BRACING OF METAL PLATE CONNECTED WOOD TRUSSES."


3. THE TOP CHORD OF ALL ROOF TRUSSES SHALL BE SHEATHED WITH MINIMUM 7/16" WOOD STRUCTURAL SHEATHING (PLYWOOD -or- OSB). PROVIDE PLYWOOD EDGE CLIPS BETWEEN PANELS.

4. PROVIDE PERMANENT BOTTOM CHORD TRUSS BRACING AND WEB MEMBER PLANE BRACING IN ACCORDANCE WITH BCSI-B2 "TRUSS INSTALLATION AND TEMPORARY BRACING" AND BCSI-B3 "WEB MEMBER PERMANENT BRACING/WEB REINFORCEMENT."

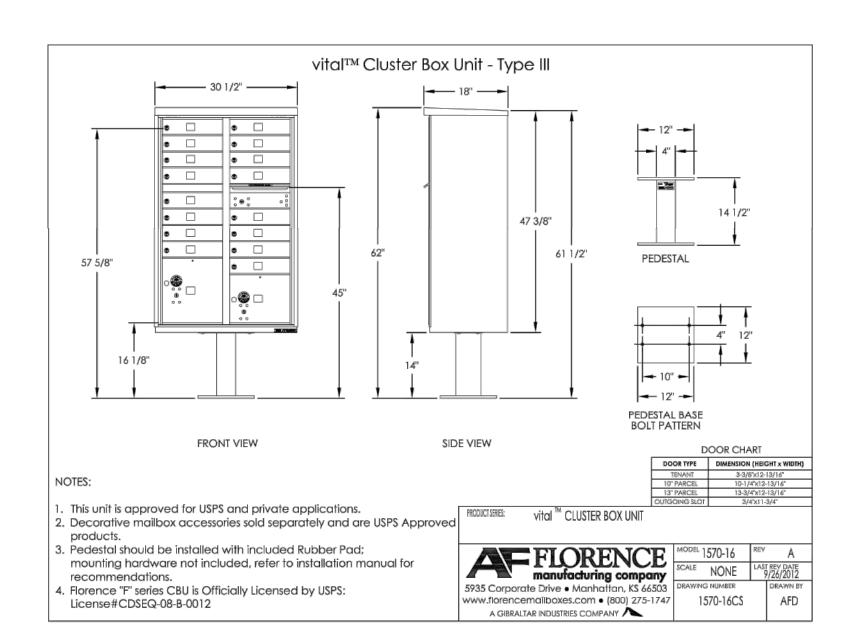


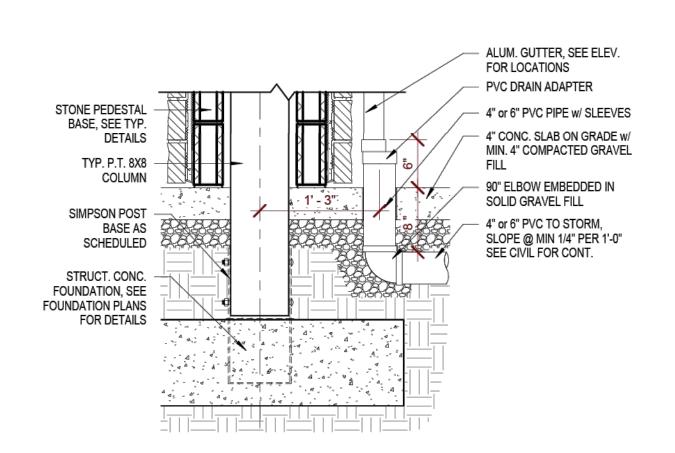




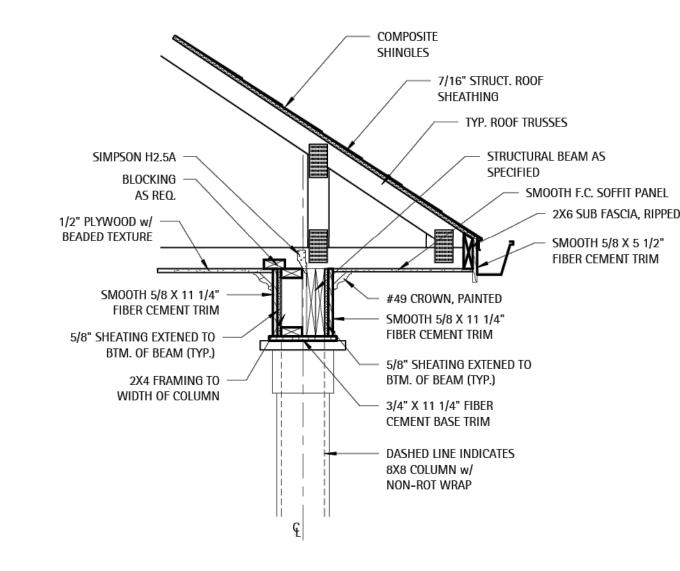




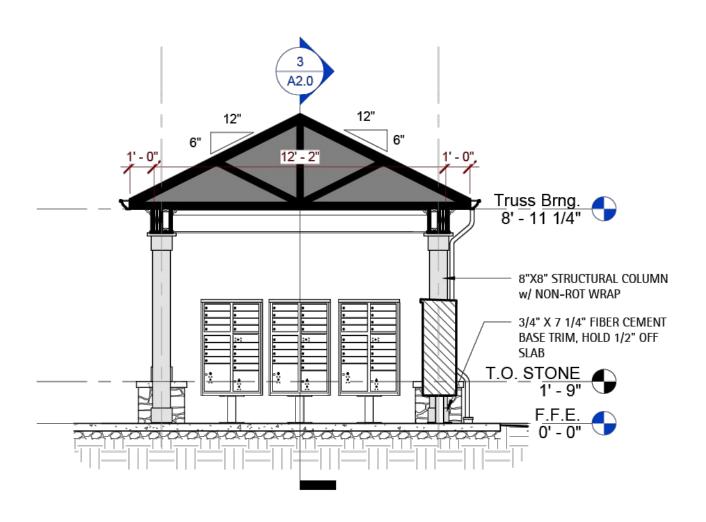



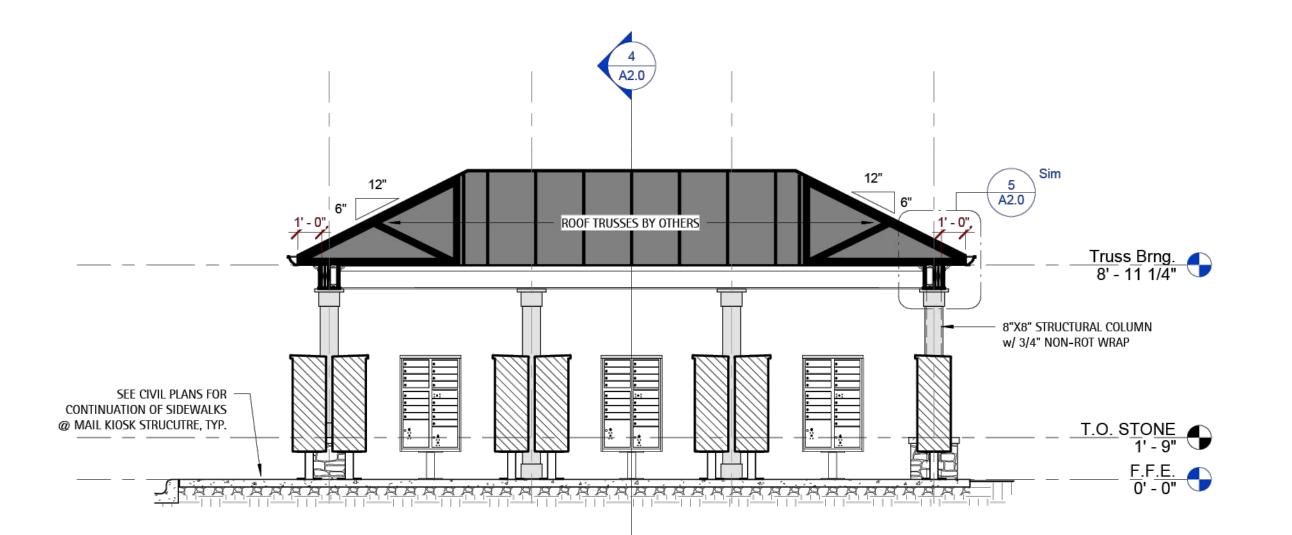




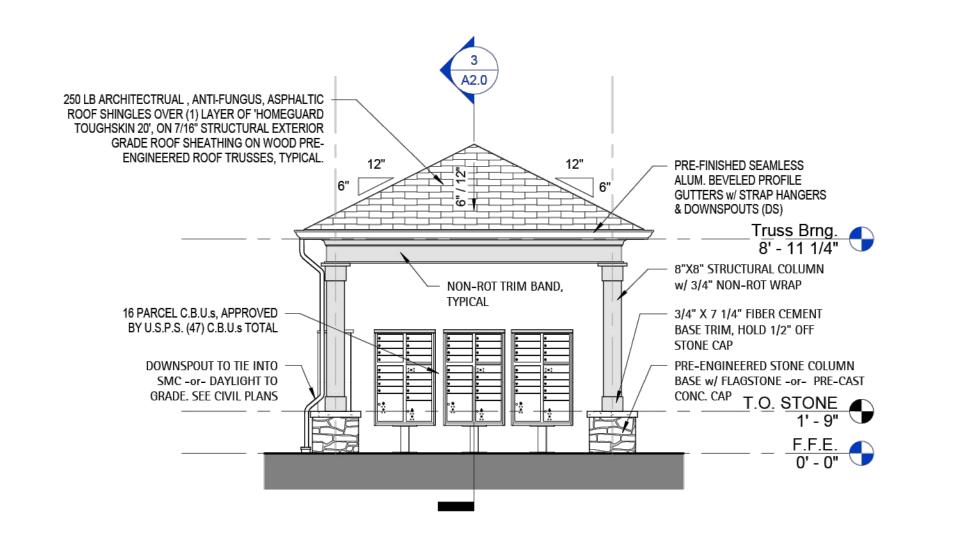



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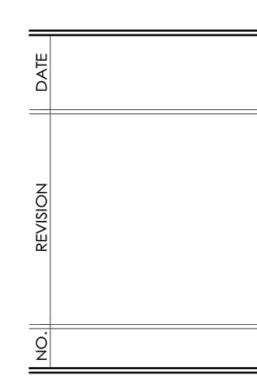


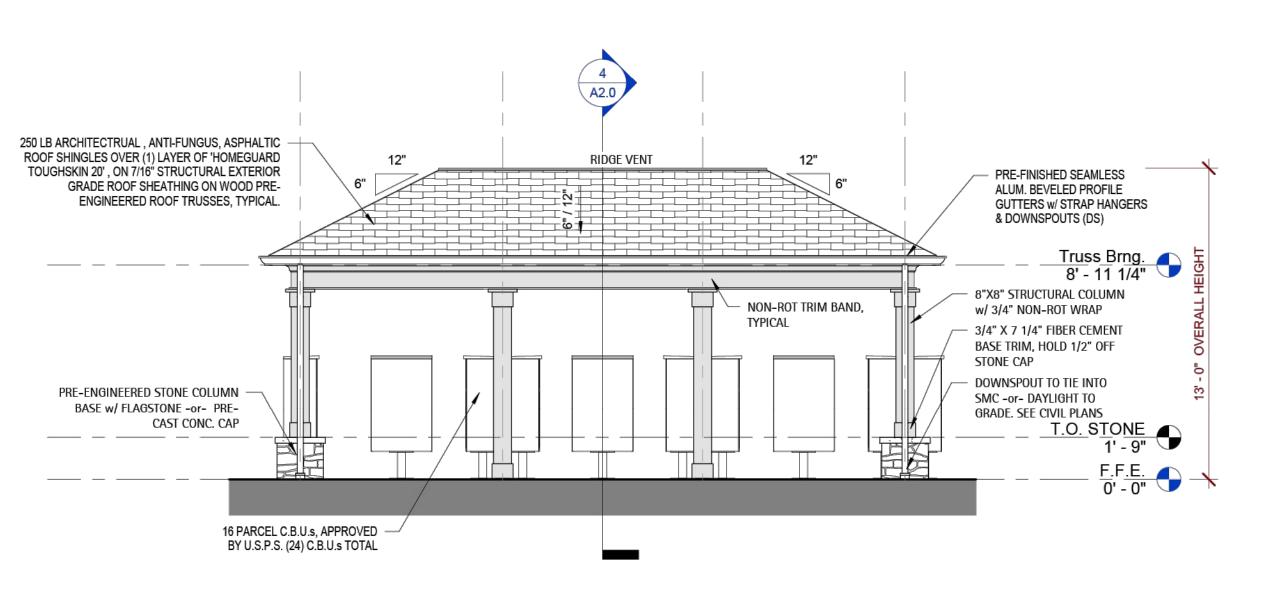









SHEET DISCRIPTION ELEVATIONS, SECTIONS, & **DETAILS**

PROJECT #:	2021062
DATE ISSUED:	09/18/2023
DRAWING BY:	JGM
CHECKED BY:	BMR / BSJ

WIMBERLEY AMENITY GROUF KIOSK S ANGIER, PULTE

MATERIAL LEGEND



ALUM GUTTER COLOR: WHITE

ASPHALT ROOF SHINGLES -GAF/TIMBERLINE NATURAL



PRE-ENGINEERED STONE VENEER


SEAT WALL w/ FLAGSTONE OR CONC. WALL CAP

PRE-ENGINEERED STONE VENEER -STYLE: PROVIA CUT: STERLING CHISEL CUT

FIBER CEMENT LAP SIDING -

Elevation - Front



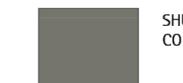

SHUTTERS -

NICHIHA FIBER CEMENT

MIN. 7" REVEAL

HORIZONTAL LAP SIDING W/

MIRATEC OR EQ. TRIMBOARDS @

WINDOWS. 5/4" X 3 1/2" TRIM @

@ TOP w/ CROWN PEDIMENTS

SIDES & BOTTOM, 5/4" X 5 1/2" TRIM

— 5/4" X 3 1/2" CORNER TRIM EQ.

TO MIRATEC, SMOOTH FINISH

1'-4" X 5'-2" FAUX BATTEN

SHUTTERS APPLIED TO E.S. OF







PRELIMINAR FOR CONSTR

Perry Cox architect, p.a.

124 Salem Towne Court, Apex, NC 27502 P: 919.363.5411 www.pcoxdesign.com

SHEET DISCRIPTION **EXTERIOR ELEVATIONS**

PROJECT #: 2023047 DATE ISSUED: 01/09/2024 DRAWING BY: CHECKED BY: DSC/PGC

> & POOL ANGIER,

WIMBERLY AMENITY PULTE GROUP CLUBHOUSE



STRUCTURAL COLUMNS w/

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NON-ROT WRAP (TYP.) FRONT(2)

COLUMNS TO SET ON STONE BASE

MATERIAL LEGEND

ASPHALT ROOF SHINGLES -GAF/TIMBERLINE NATURAL COLOR: CHARCOAL GRAY


@ TOP w/ CROWN PEDIMENT

STYLE: PROVIA CUT: STERLING CHISEL CUT COLOR: BREAKWATER


PAINTED TRIM, COLUMN & DROP BEAM-COLOR: SNOWBOUND (SW 7004)



FIBER CEMENT LAP SIDING -COLOR: GRAY CLOUDS (SW 7658)

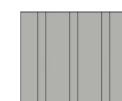

FIBER CEMENT BOARD & BATTEN -COLOR: GRAY CLOUDS (SW 7658)

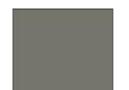





D.CLUGSTON

architect, p.a.

124 Salem Towne Court, Apex, NC 27502 P: 919.363.5411 www.pcoxdesign.com

SHEET DISCRIPTION **EXTERIOR ELEVATIONS**


PROJECT #: 2023047 DATE ISSUED: 01/09/2024 DRAWING BY: CHECKED BY: DSC/PGC


POOL WIMBERLY AMENITY PULTE GROUP CLUBHOUSE & ANGIER, NC

PRE-ENGINEERED STONE VENEER -

SHUTTERS -COLOR: GAUNTLET GRAY (SW 7019)

EXTERIOR DOORS

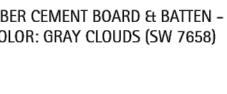

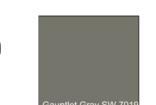

COLOR: GAUNTLET GRAY (SW 7019)



PRE-FINISHED SEAMLESS ALUM GUTTER COLOR: WHITE

FIBER CEMENT TRIM BOARD

COLOR: SNOWBOUND (SW 7004) Snowbound SW 7004

