

LILLINGTON-SHAWTOWN ELEMENTARY GYMNASIUM ADDITION

855 Old US Highway 421, Lillington NC 27546

RENDERING

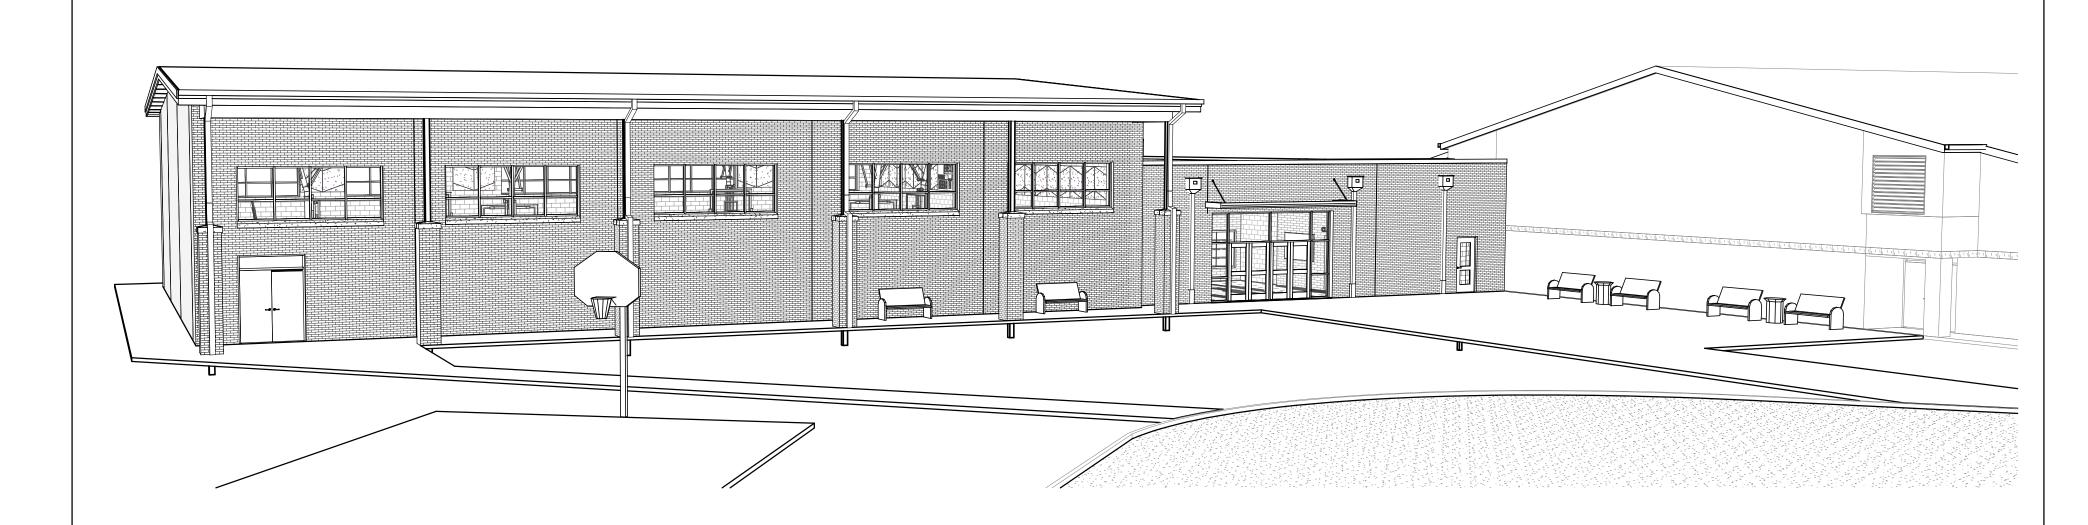

OVICINITY MAP

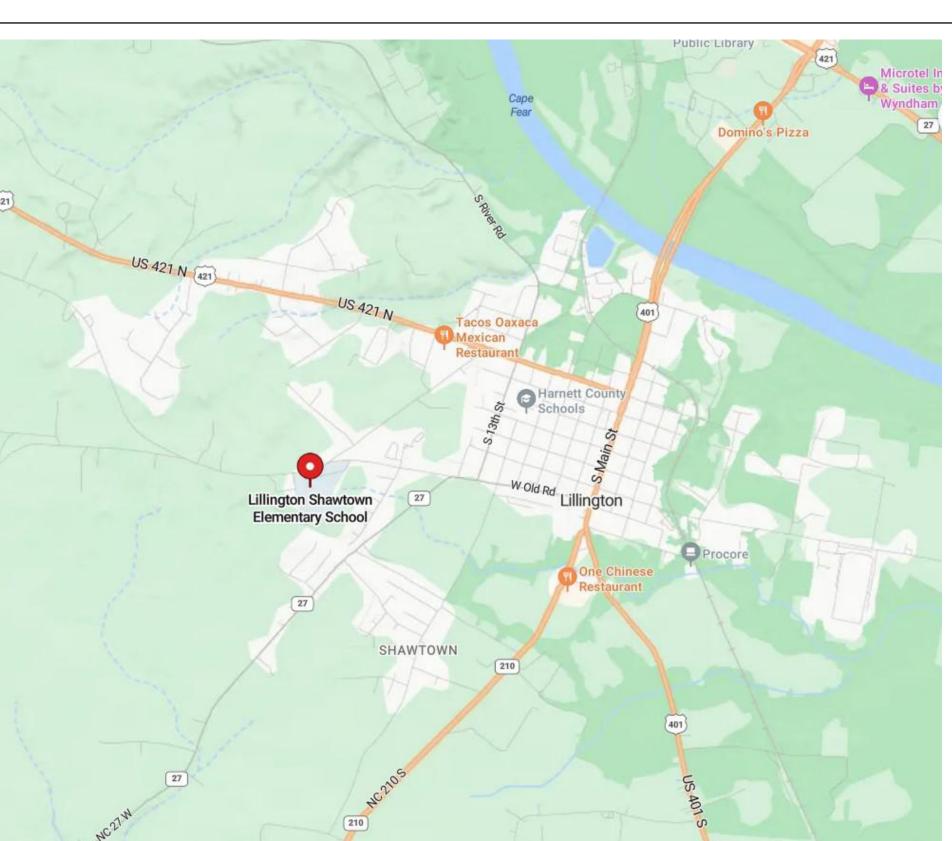

SHEET INDEX

* SHEETS PREFIXED WITH 1*1 (ASTERISK) REQUIRE COLOR REPRODUCTION FOR PROPER INFORMATION DISPLAY.

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...Becoming the **Leading Designer of High Performance Facilities** in the Nation with a **Specialty in Alternative Delivery Methods**



CONSULTANTS

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TIMMONS GROUP 5410 TRINITY ROAD, SUITE 102 RALEIGH, NC 27607 PHONE: 919-866-4938

STRUCTURAL ENGINEER:

BENNETT & PLESS 5430 WADE PARK BLVD, SUITE 400 RALEIGH, NC 27607 PHONE: 919-832-5587


PLUMBING/MECHANICAL/ ELECTRICAL/FIRE PROTECTION ENGINEER:

OPTIMA ENGINEERING 150 FAYETTEVILLE STREET, SUITE 520 RALEIGH, NC 27601 PHONE: 919-926-2200

CONSTRUCTION DOCUMENTS

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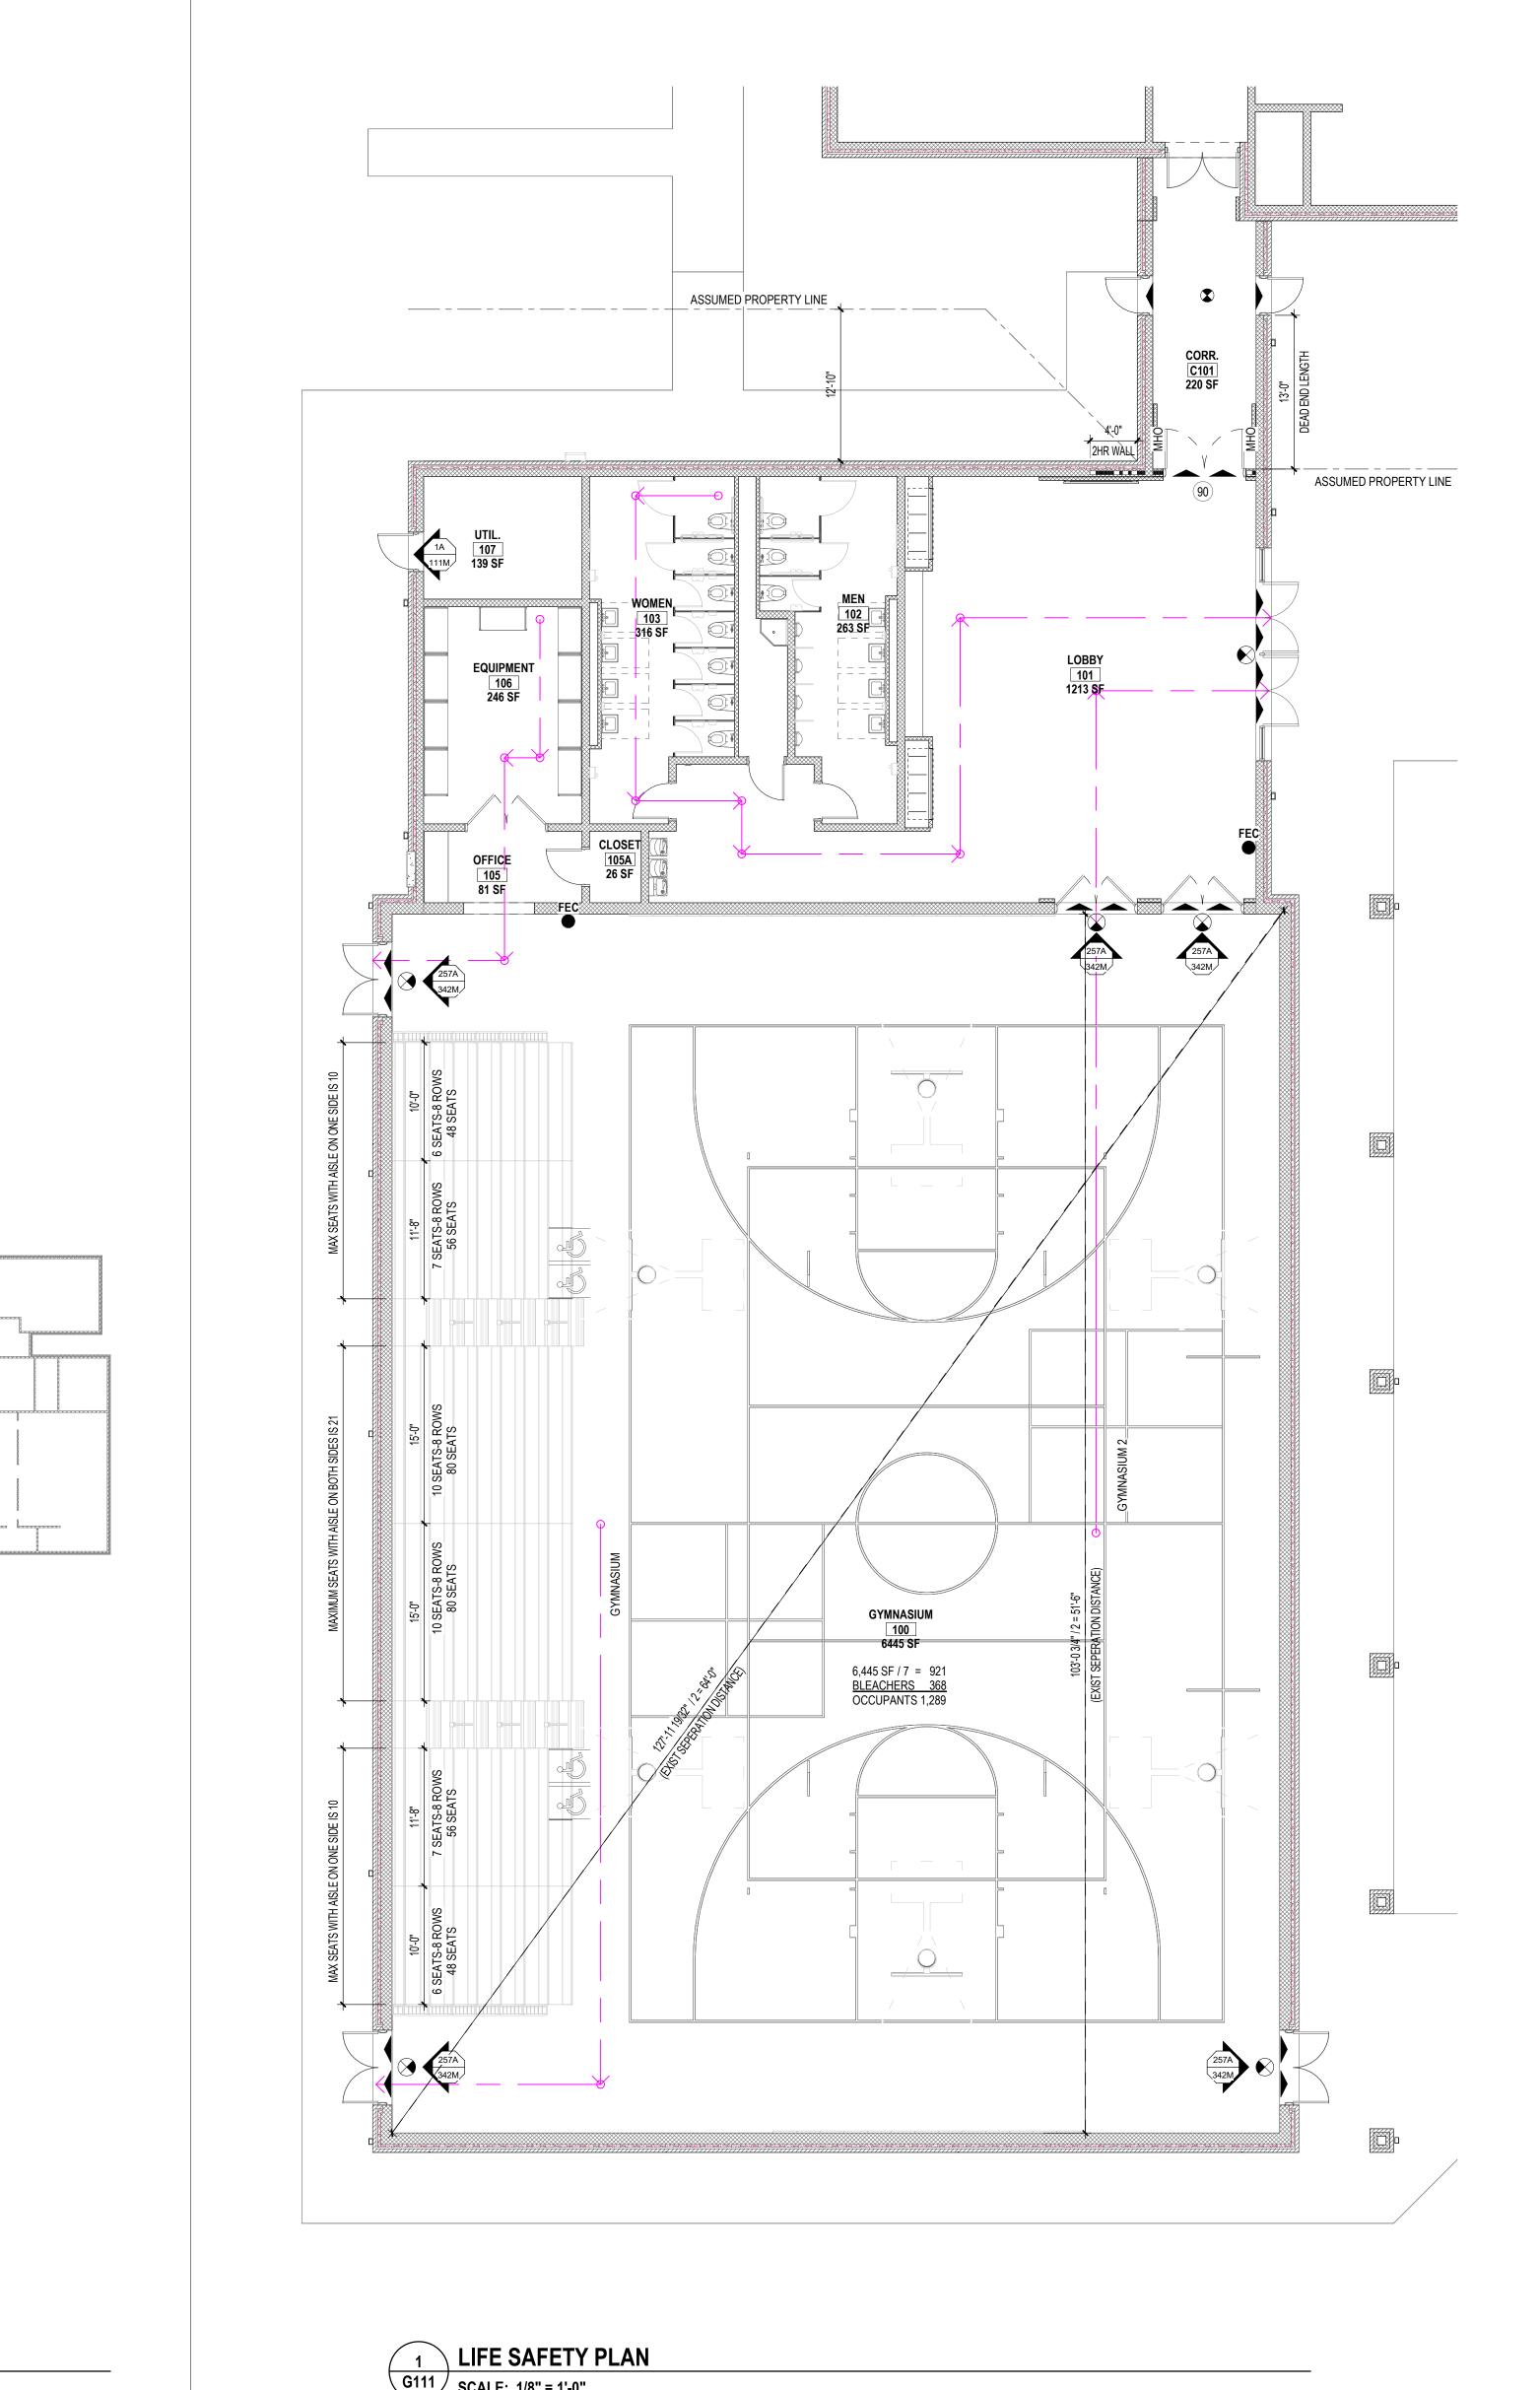
G001

ISSUE DATE: 07-26-24 02110.300 PROJECT #: DRAWN BY: JK CF CHECKED BY: Checker © 2024 SfL+a Architects, PA All Rights Reserved **BUILDING CODE**

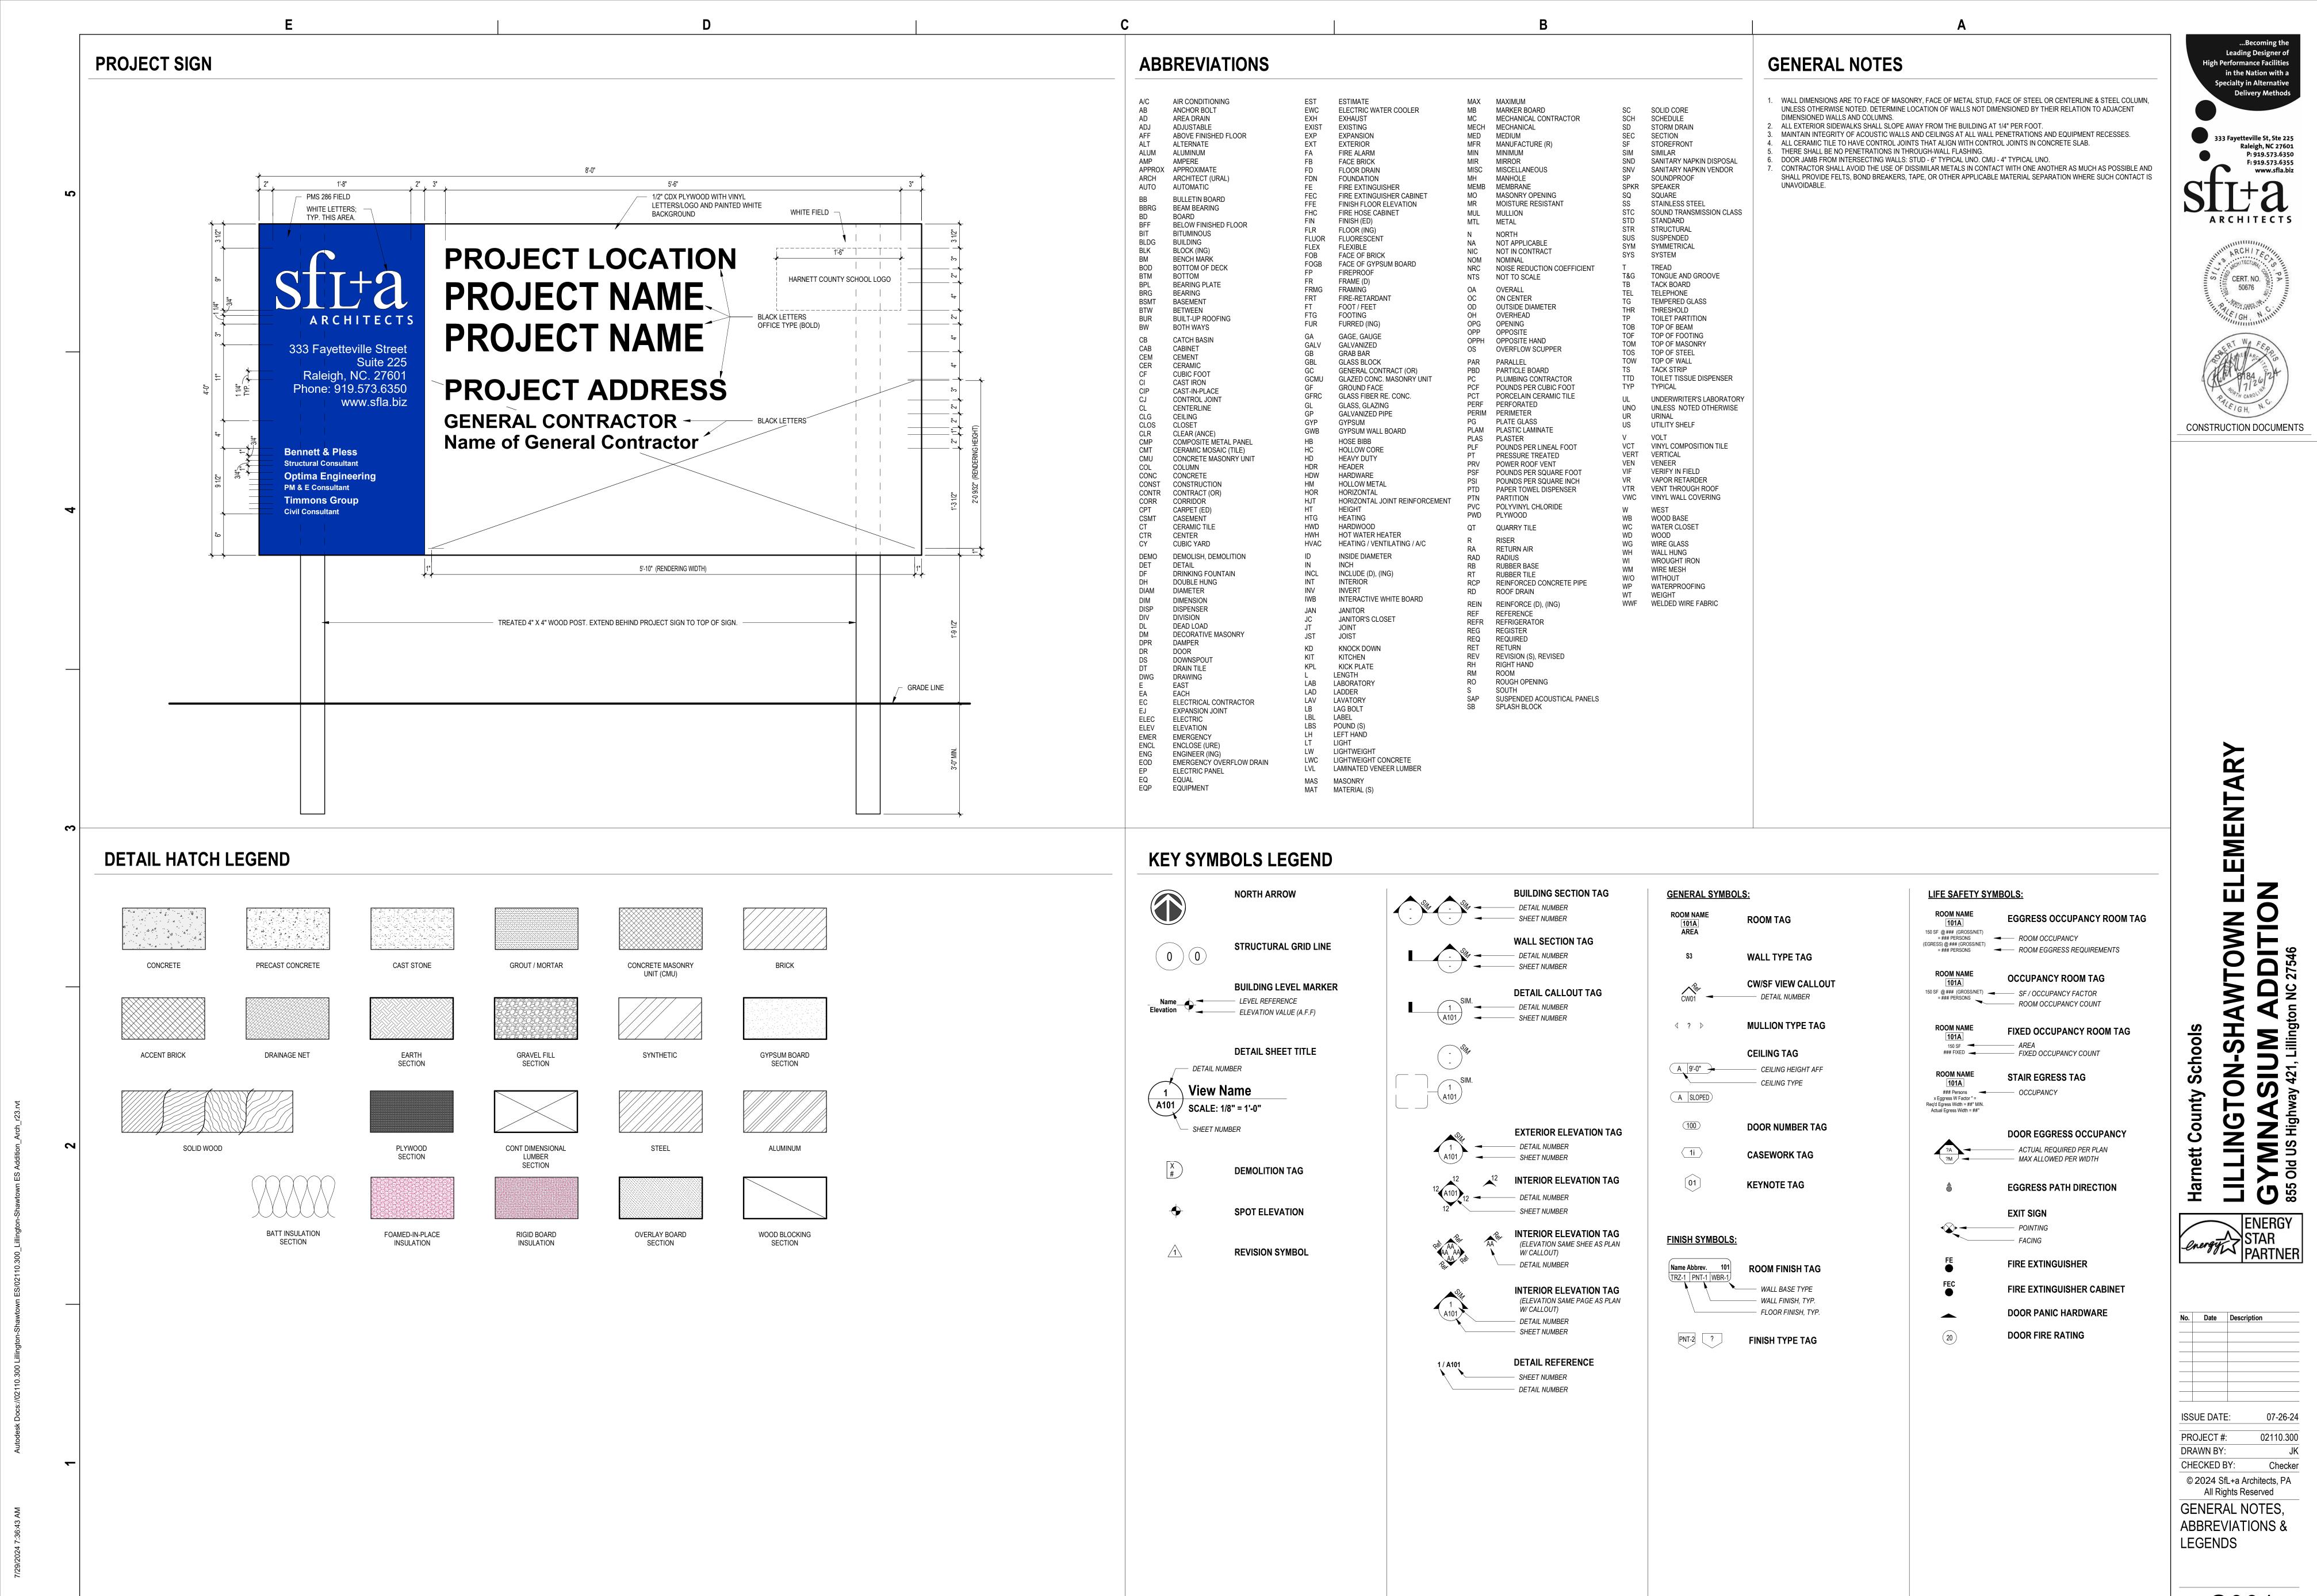SUMMARY

Design No. U905 June 10, 2019 Bearing Wall Rating — 2 HR.

Nonbearing Wall Rating — 2 HR




93,520 SQFT EXISTING SCHOOL BLDG FOOTPRINT

OVERALL BUILDING PLAN

G111 | SCALE: 1" = 40'-0"

EXISTING BUS PARKING

BASKETBALL COURT

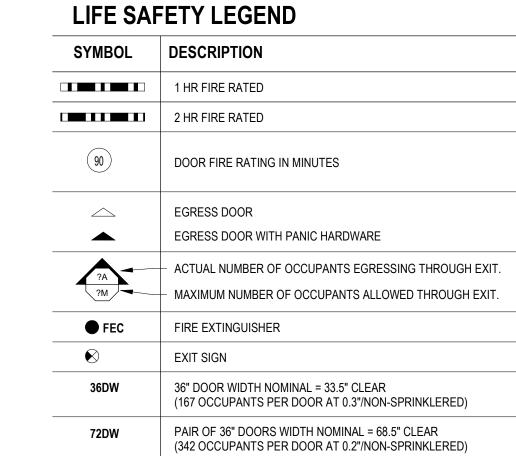

LIFE SAFETY GENERAL NOTES:

1. SEE SHEET G002 FOR UL DESIGNS

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ROOM NAME	TRAVEL DISTANCE
EQUIPMENT	43' - 0"
GYMNASIUM	66' - 4"
GYMNASIUM 2	85' - 10"
WOMEN	111' - 0"



CONSTRUCTION DOCUMENTS

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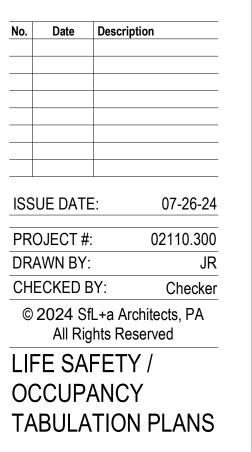
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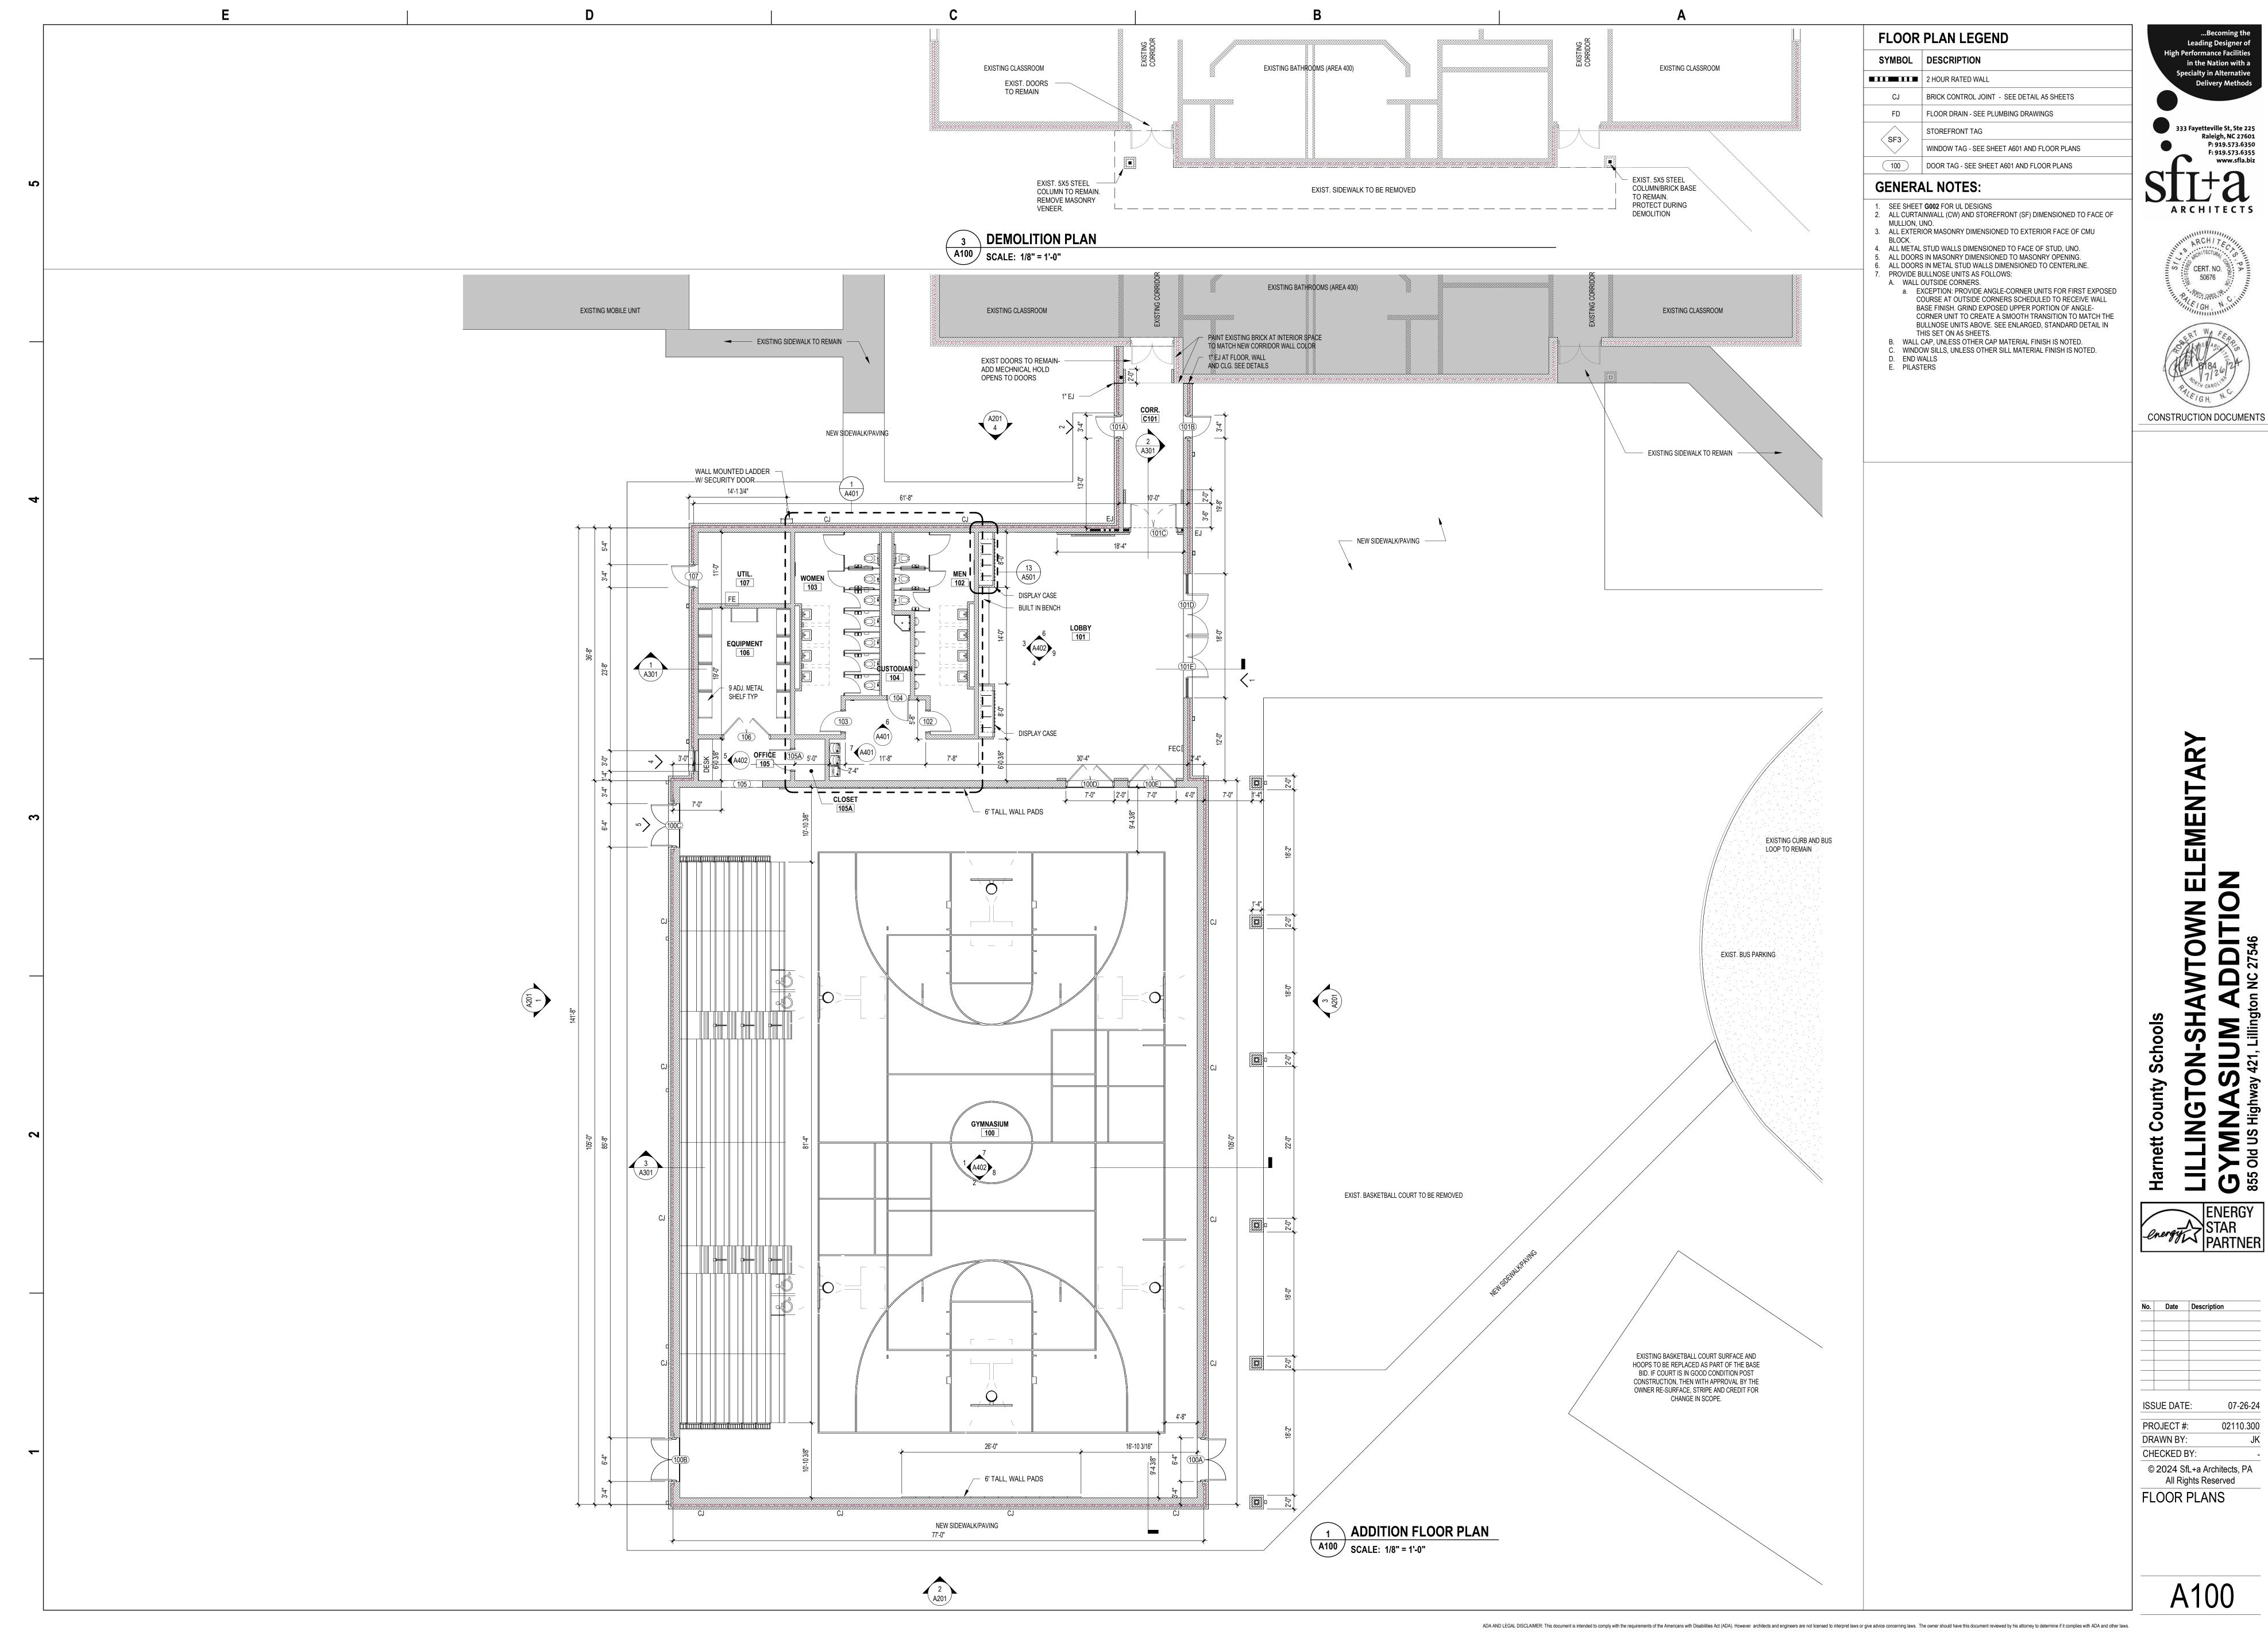
ILLINGTON-SHAWTOWN ELEMENTA

SYMNASIUM ADDITION


55 Old US Highway 421, Lillington NC 27546

ENERGY STAR PARTNER








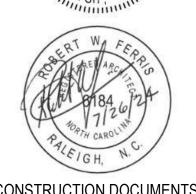

STANDARD ASSEMBLIES (CEILING) A121 | SCALE: 1 1/2" = 1'-0"

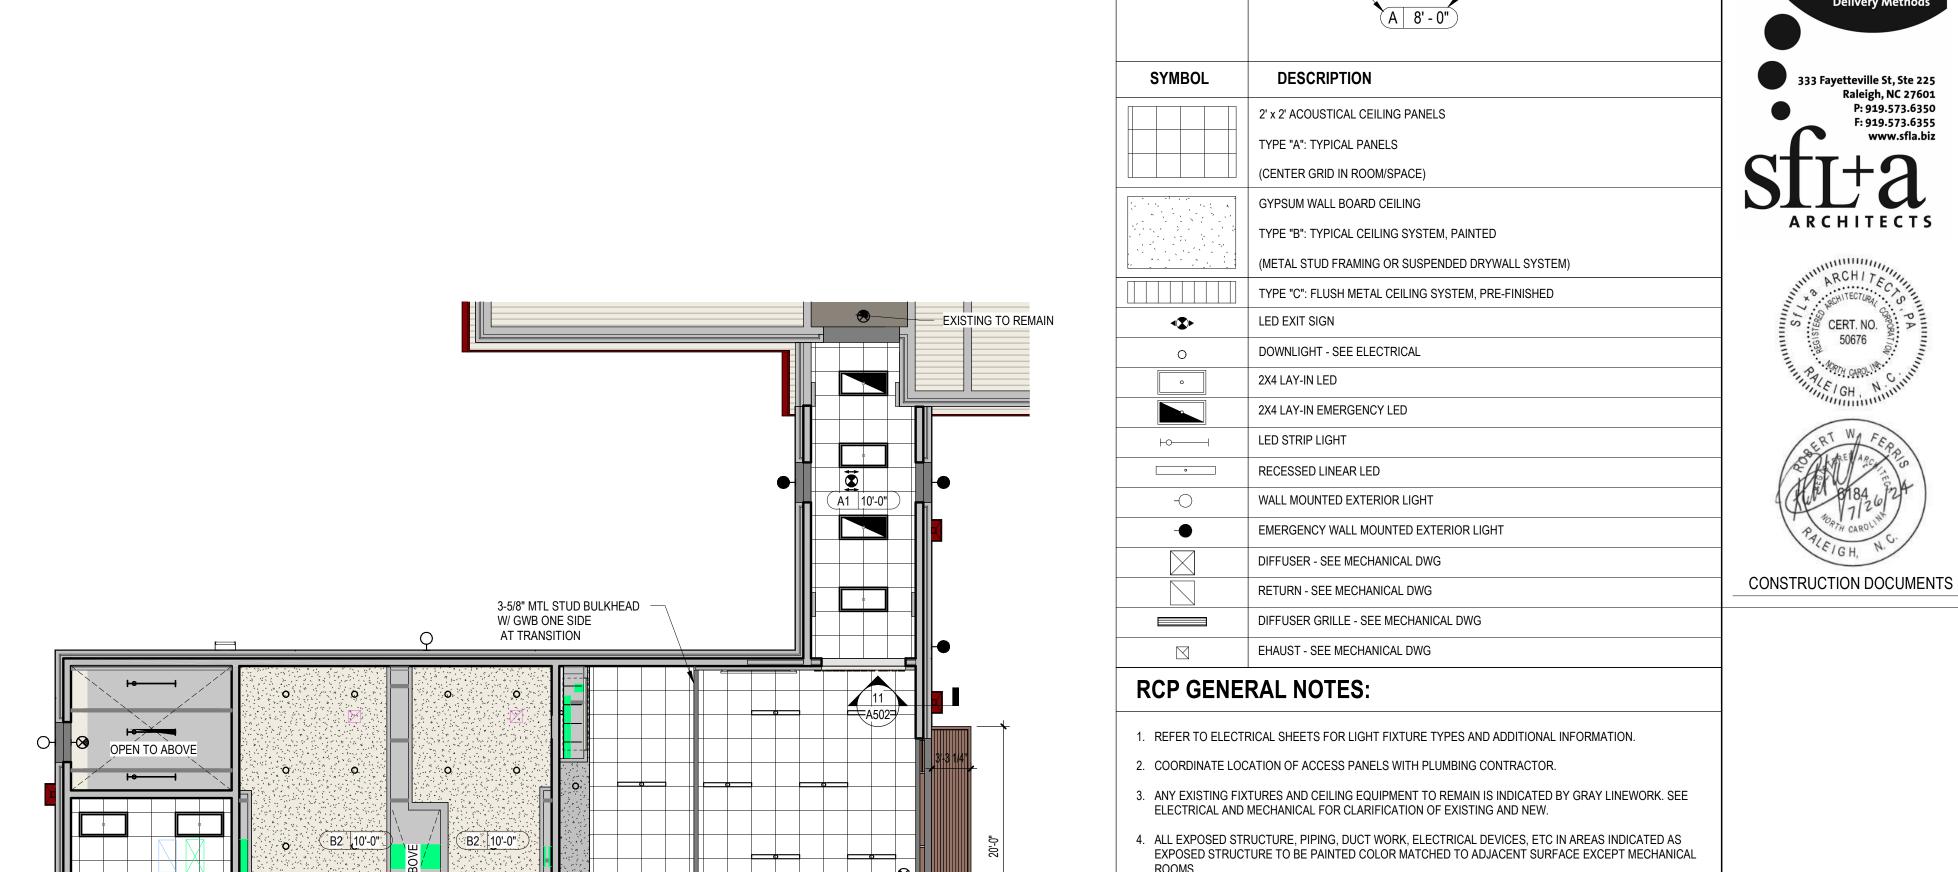

P4/"SCHOOL RED" DUCTWORK TYP AT EXPOSED DUCTWORK

SCOREBOARD

STRUCTURE AND ROOF DECK

SEE ELECTRICAL DRAWINGS

SEE MECHANICAL DRAWINGS

PAINTED P1

BULKHEAD 2" _

PROUD OF WALL

PAINT NOTES

LOUVER IS INSTALLED IN.

1. PAINT P1 STANDARD WALL FIELD IN ALL LOCATIONS U.N.O.

9. ALL LAY IN CEILING GRID TO BE WHITE UNO.

2. EPOXY PAINT TYPICAL AT ALL RESTROOMS, JANITOR CLOSETS, AND KITCHEN / SERVING AREAS.

6. EAVE AND CANOPY SOFFITS TO BE 7" FLUSH METAL PANEL SYSTEM.

7. CONTROL JOINTS ARE NOTED IN GYPSUM CEILINGS AS 'CJ'

REFLECTED CEILING PLAN LEGEND

CEILING HEIGHT

CEILING TYPE —

3. SEMIGLOSS PAINT TYPICAL AT ALL CONCRETE MASONRY WALLS AND HOLLOW METAL DOOR FRAMES, U.N.O.

5. INTERIOR LOUVERS TO BE PAINTED TO MATCH THE WALL, SURFACE OR BULKHEAD COLOR THAT THE

8. PER OSHA, ALL TOILET ROOMS MUST HAVE A SCRUBBABLE AND CLEANABLE FLOOR, WALL AND CEILING.

4. EGGSHELL PAINT TYPICAL AT ALL GYPSUM BOARD WALLS U.N.O.

5. FLAT PAINT TYPICAL AT ALL CEILING & BULKHEAD CONDITIONS, U.N.O.

6. PAINT COLORS DESIGNATED AT COLUMN SURROUNDS TO BE APPLIED TO ALL SIDES OF COLUMN UP TO CEILING.

7. PAINT COLORS DESIGNATED AT BULKHEADS TO BE APPLIED TO ENTIRE VERTICAL AND HORIZONTAL FACES, UNLESS NOTED OTHERWISE IN RCP AND ELEVATIONS.

P1 WHITE SW6070-HERON PLUME P2 GREY SW7674-PEPPERCORN P3 GOLD SW6905-GOLDFINCH

P4 MAROON SW6300-BURGUNDY

ALUMINUM SOFFIT PER SECTION

EMENTARY

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Delivery Methods

33 Fayetteville St, Ste 225 Raleigh, NC 27601

S E CERT. NO.

50676


P: 919.573.6350

F: 919.573.6355

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FIRST FLOOR REFLECTED CEILING PLAN



ROOF PLAN LEGEND

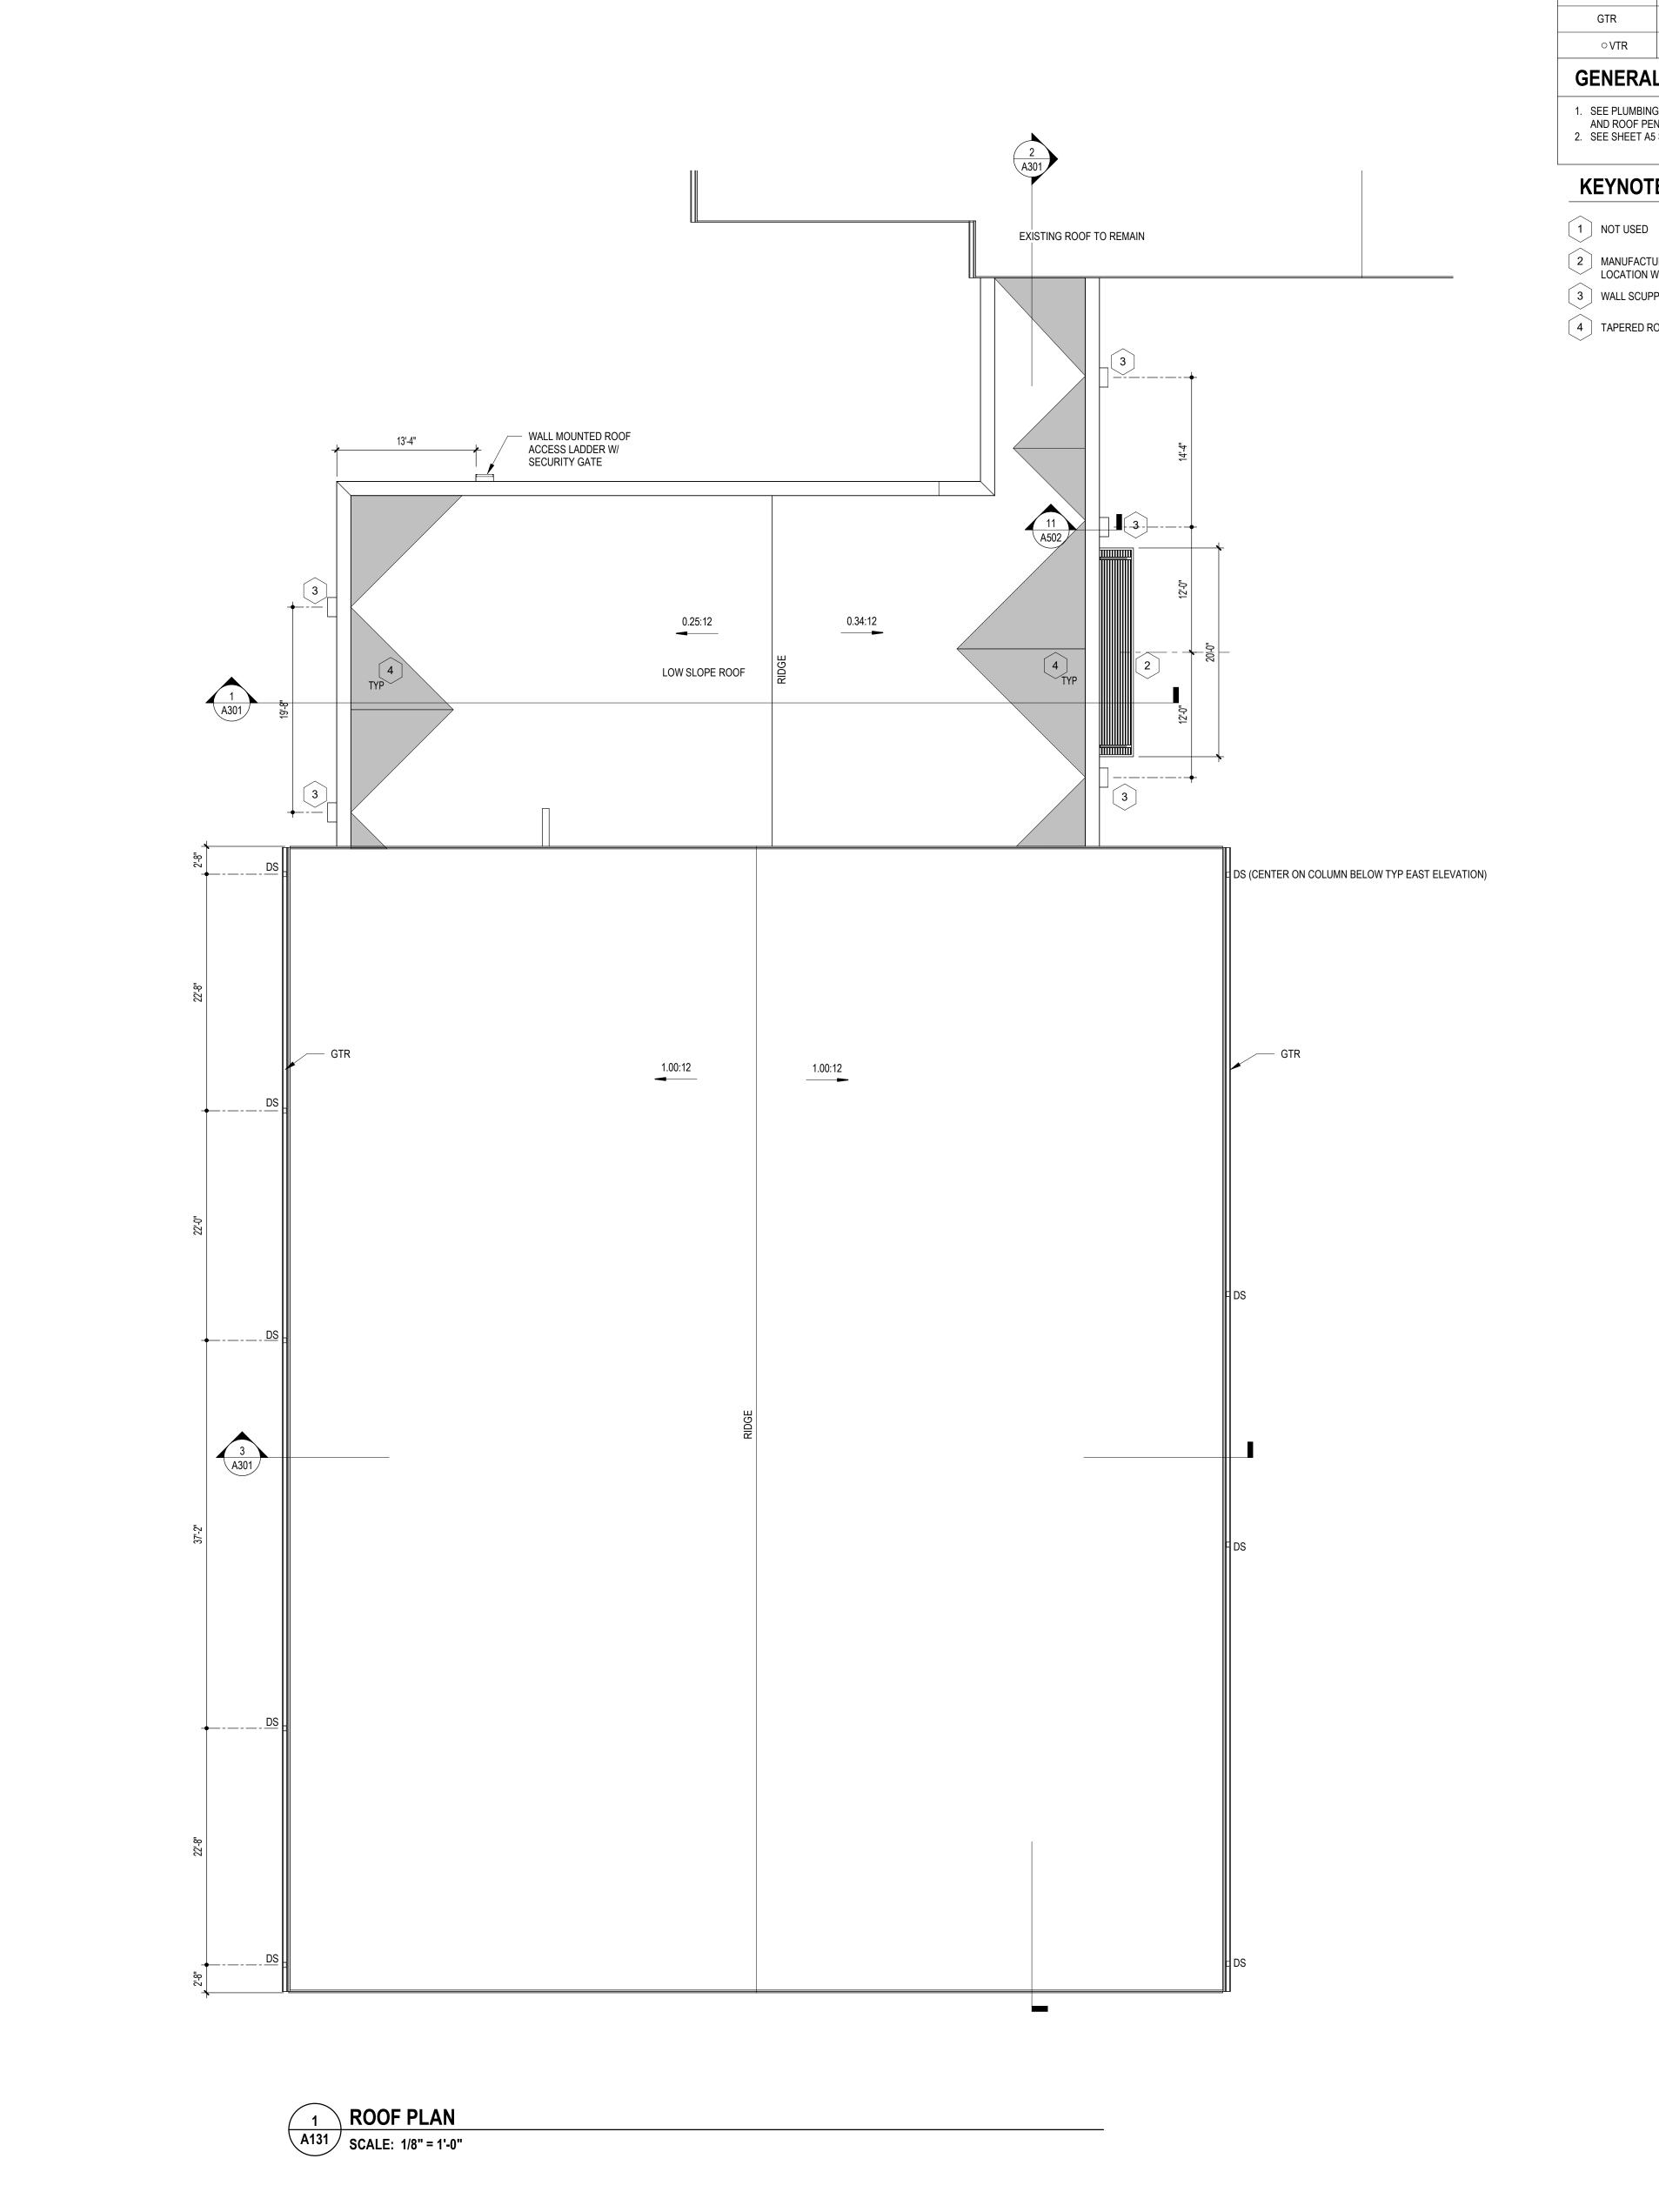
SYMBOL	DESCRIPTION
DS	4" x 6" DOWNSPOUT
GTR	CONTINUOUS 6" x 6" GUTTER
∘VTR	VENT PIPE ROOF PENETRATION - SEE SHEET A504

GENERAL NOTES:

SEE PLUMBING AND MECHANICAL DRAWINGS FOR ROOF MOUNTED EQUIPMENT AND ROOF PENETRATIONS.
 SEE SHEET A5 SHEET SERIES FOR ROOF & CANOPY DETAILS.

KEYNOTE LEGEND (ROOF PLAN)

- 2 MANUFACTURED ALUMINUM CANOPY BELOW. COORDINATE DRAIN LOCATION WITH RAMP BELOW
- 3 WALL SCUPPER AND COLLECTOR HEAD WITH DOWNSPOUT
- 4 TAPERED ROOF INSULATION CRICKETS FOR DRAINAGE 1/2":12" SLOPE

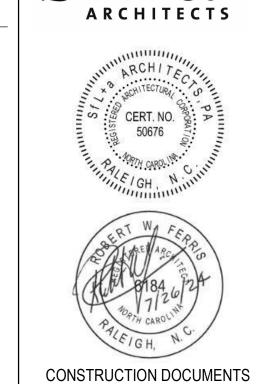

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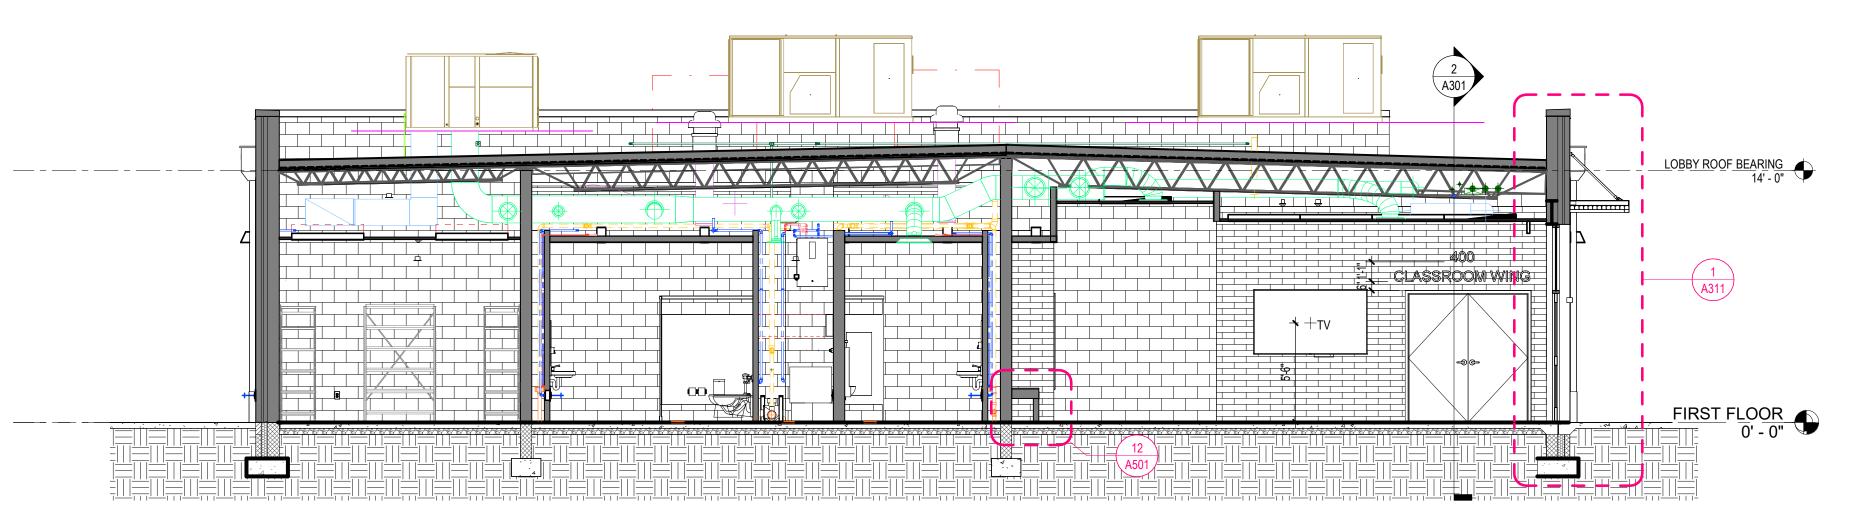
333 Fayetteville St, Ste 225 Raleigh, NC 27601 P: 919.573.6350 F: 919.573.6355 www.sfla.biz

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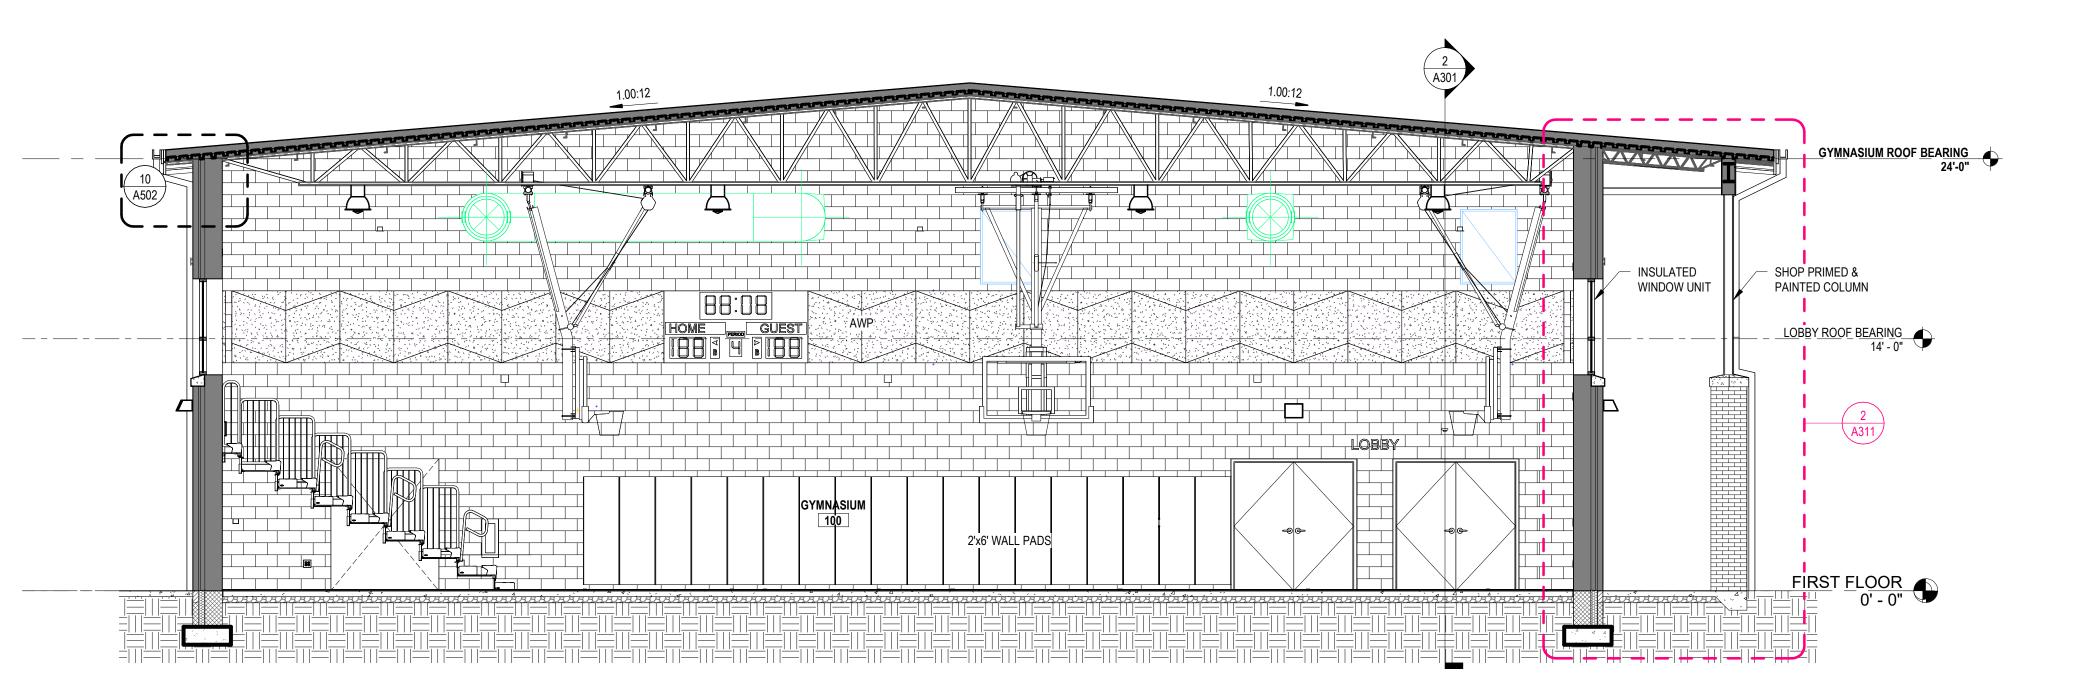


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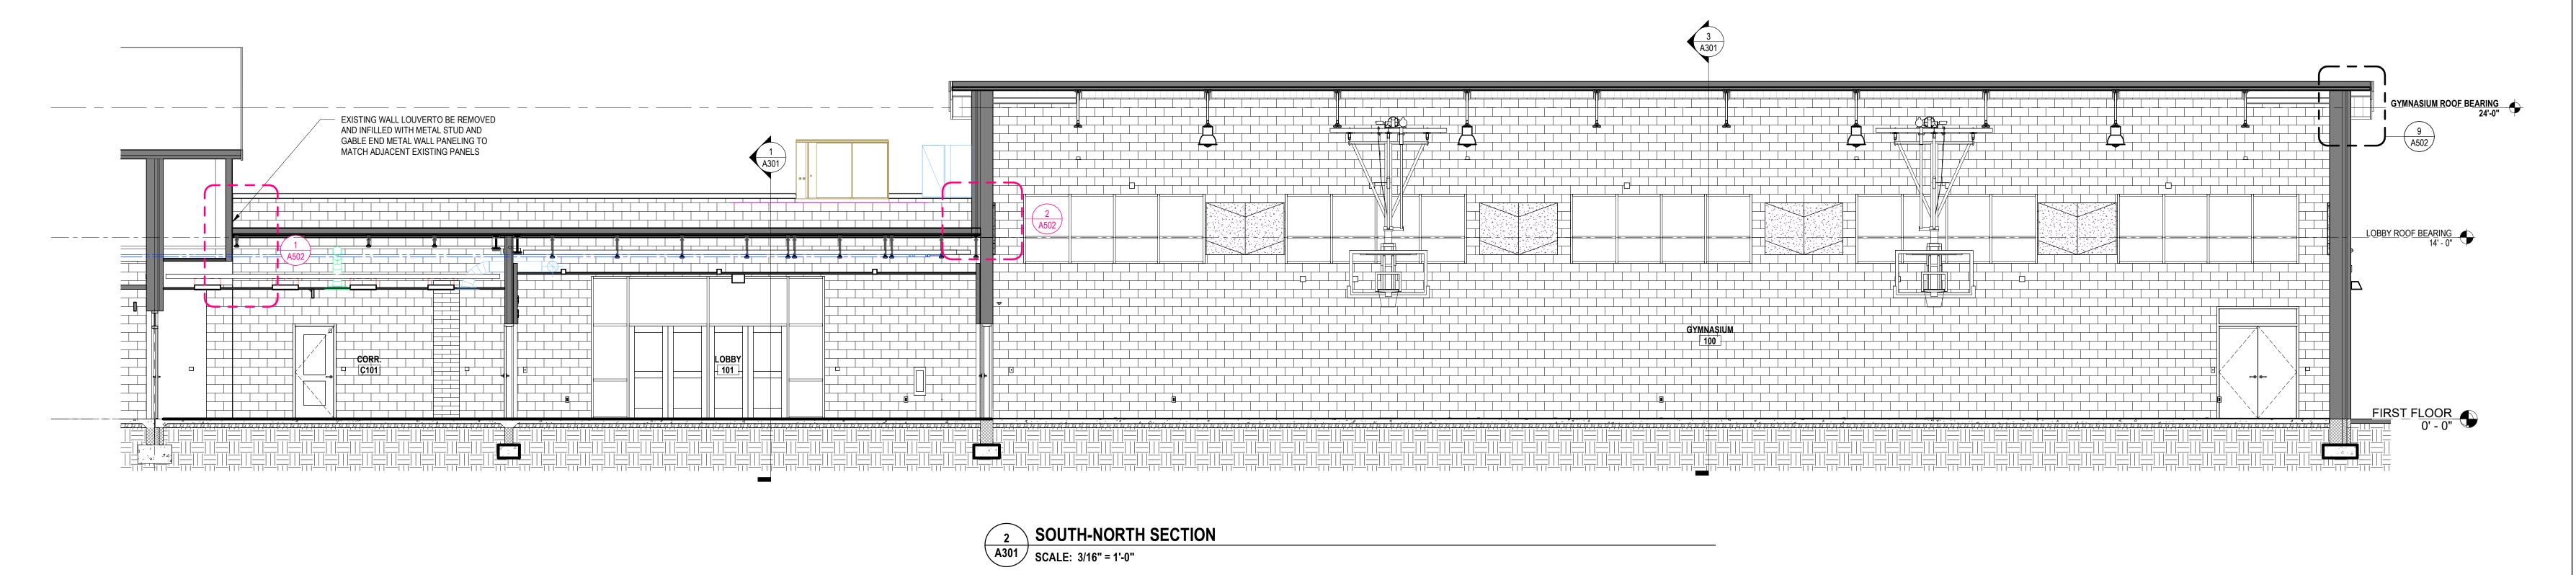
- 1. WALL DIMENSIONS ARE TO FACE OF MASONRY, FACE OF METAL STUD, FACE OF STEEL OR CENTERLINE & STEEL COLUMN, UNLESS OTHERWISE NOTED.
 DETERMINE LOCATION OF WALLS NOT DIMENSIONED BY THEIR RELATION TO ADJACENT DIMENSIONED WALLS AND COLUMNS.
 - 2. ALL EXTERIOR SIDEWALKS SHALL SLOPE AWAY FROM THE BUILDING AT 1/4" PER MAINTAIN INTEGRITY OF ACOUSTIC WALLS AND CEILINGS AT ALL WALL PENETRATIONS AND EQUIPMENT RECESSES.
 - 4. THERE SHALL BE NO PENETRATIONS IN THROUGH-WALL FLASHING. 5. CONTRACTOR SHALL AVOID THE USE OF DISSIMILAR METALS IN CONTACT WITH ONE ANOTHER AS MUCH AS POSSIBLE AND SHALL PROVIDE FELTS, BOND BREAKERS, TAPE, OR OTHER APPLICABLE MATERIAL SEPARATION WHERE SUCH CONTACT IS UNAVOIDABLE.








GYMNASIUM CROSS SECTION A301 SCALE: 3/16" = 1'-0"



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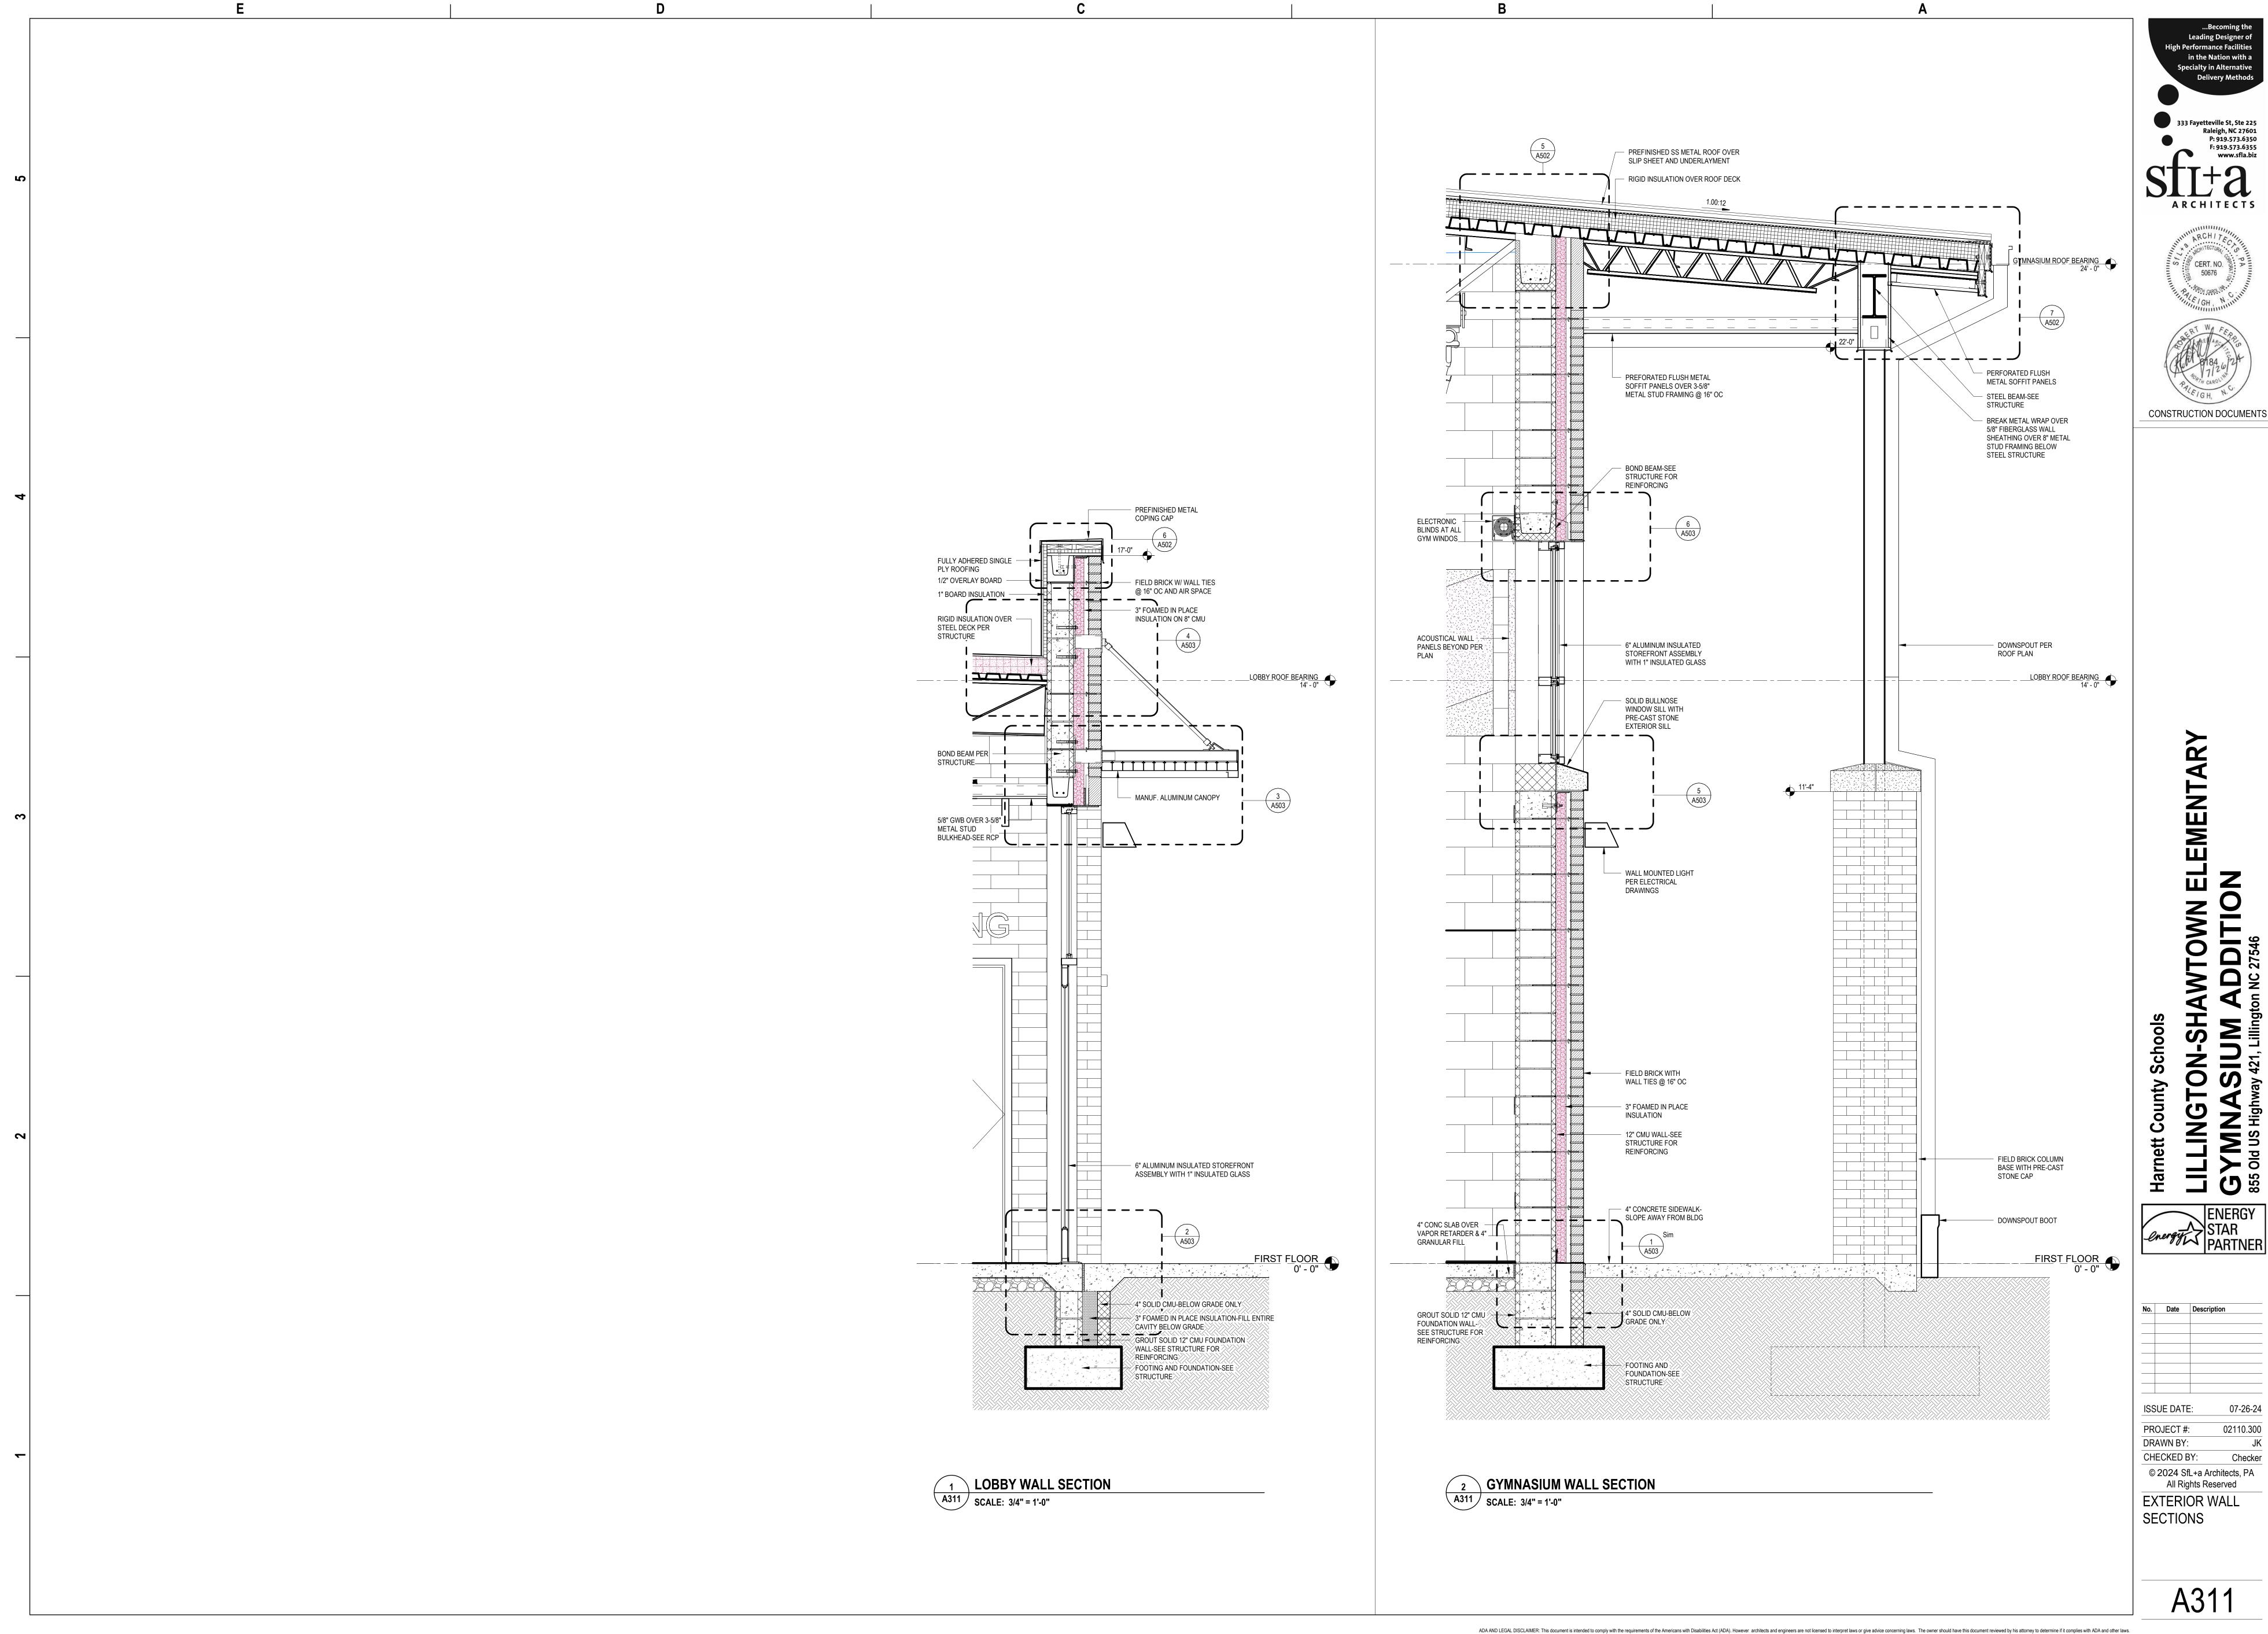


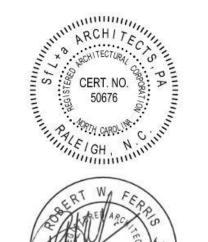CONSTRUCTION DOCUMENTS

WTOWN ELEMENTARY


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BUILDING SECTIONS




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CONSTRUCTION DOCUMENTS





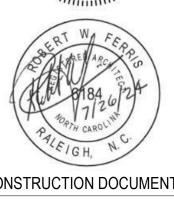

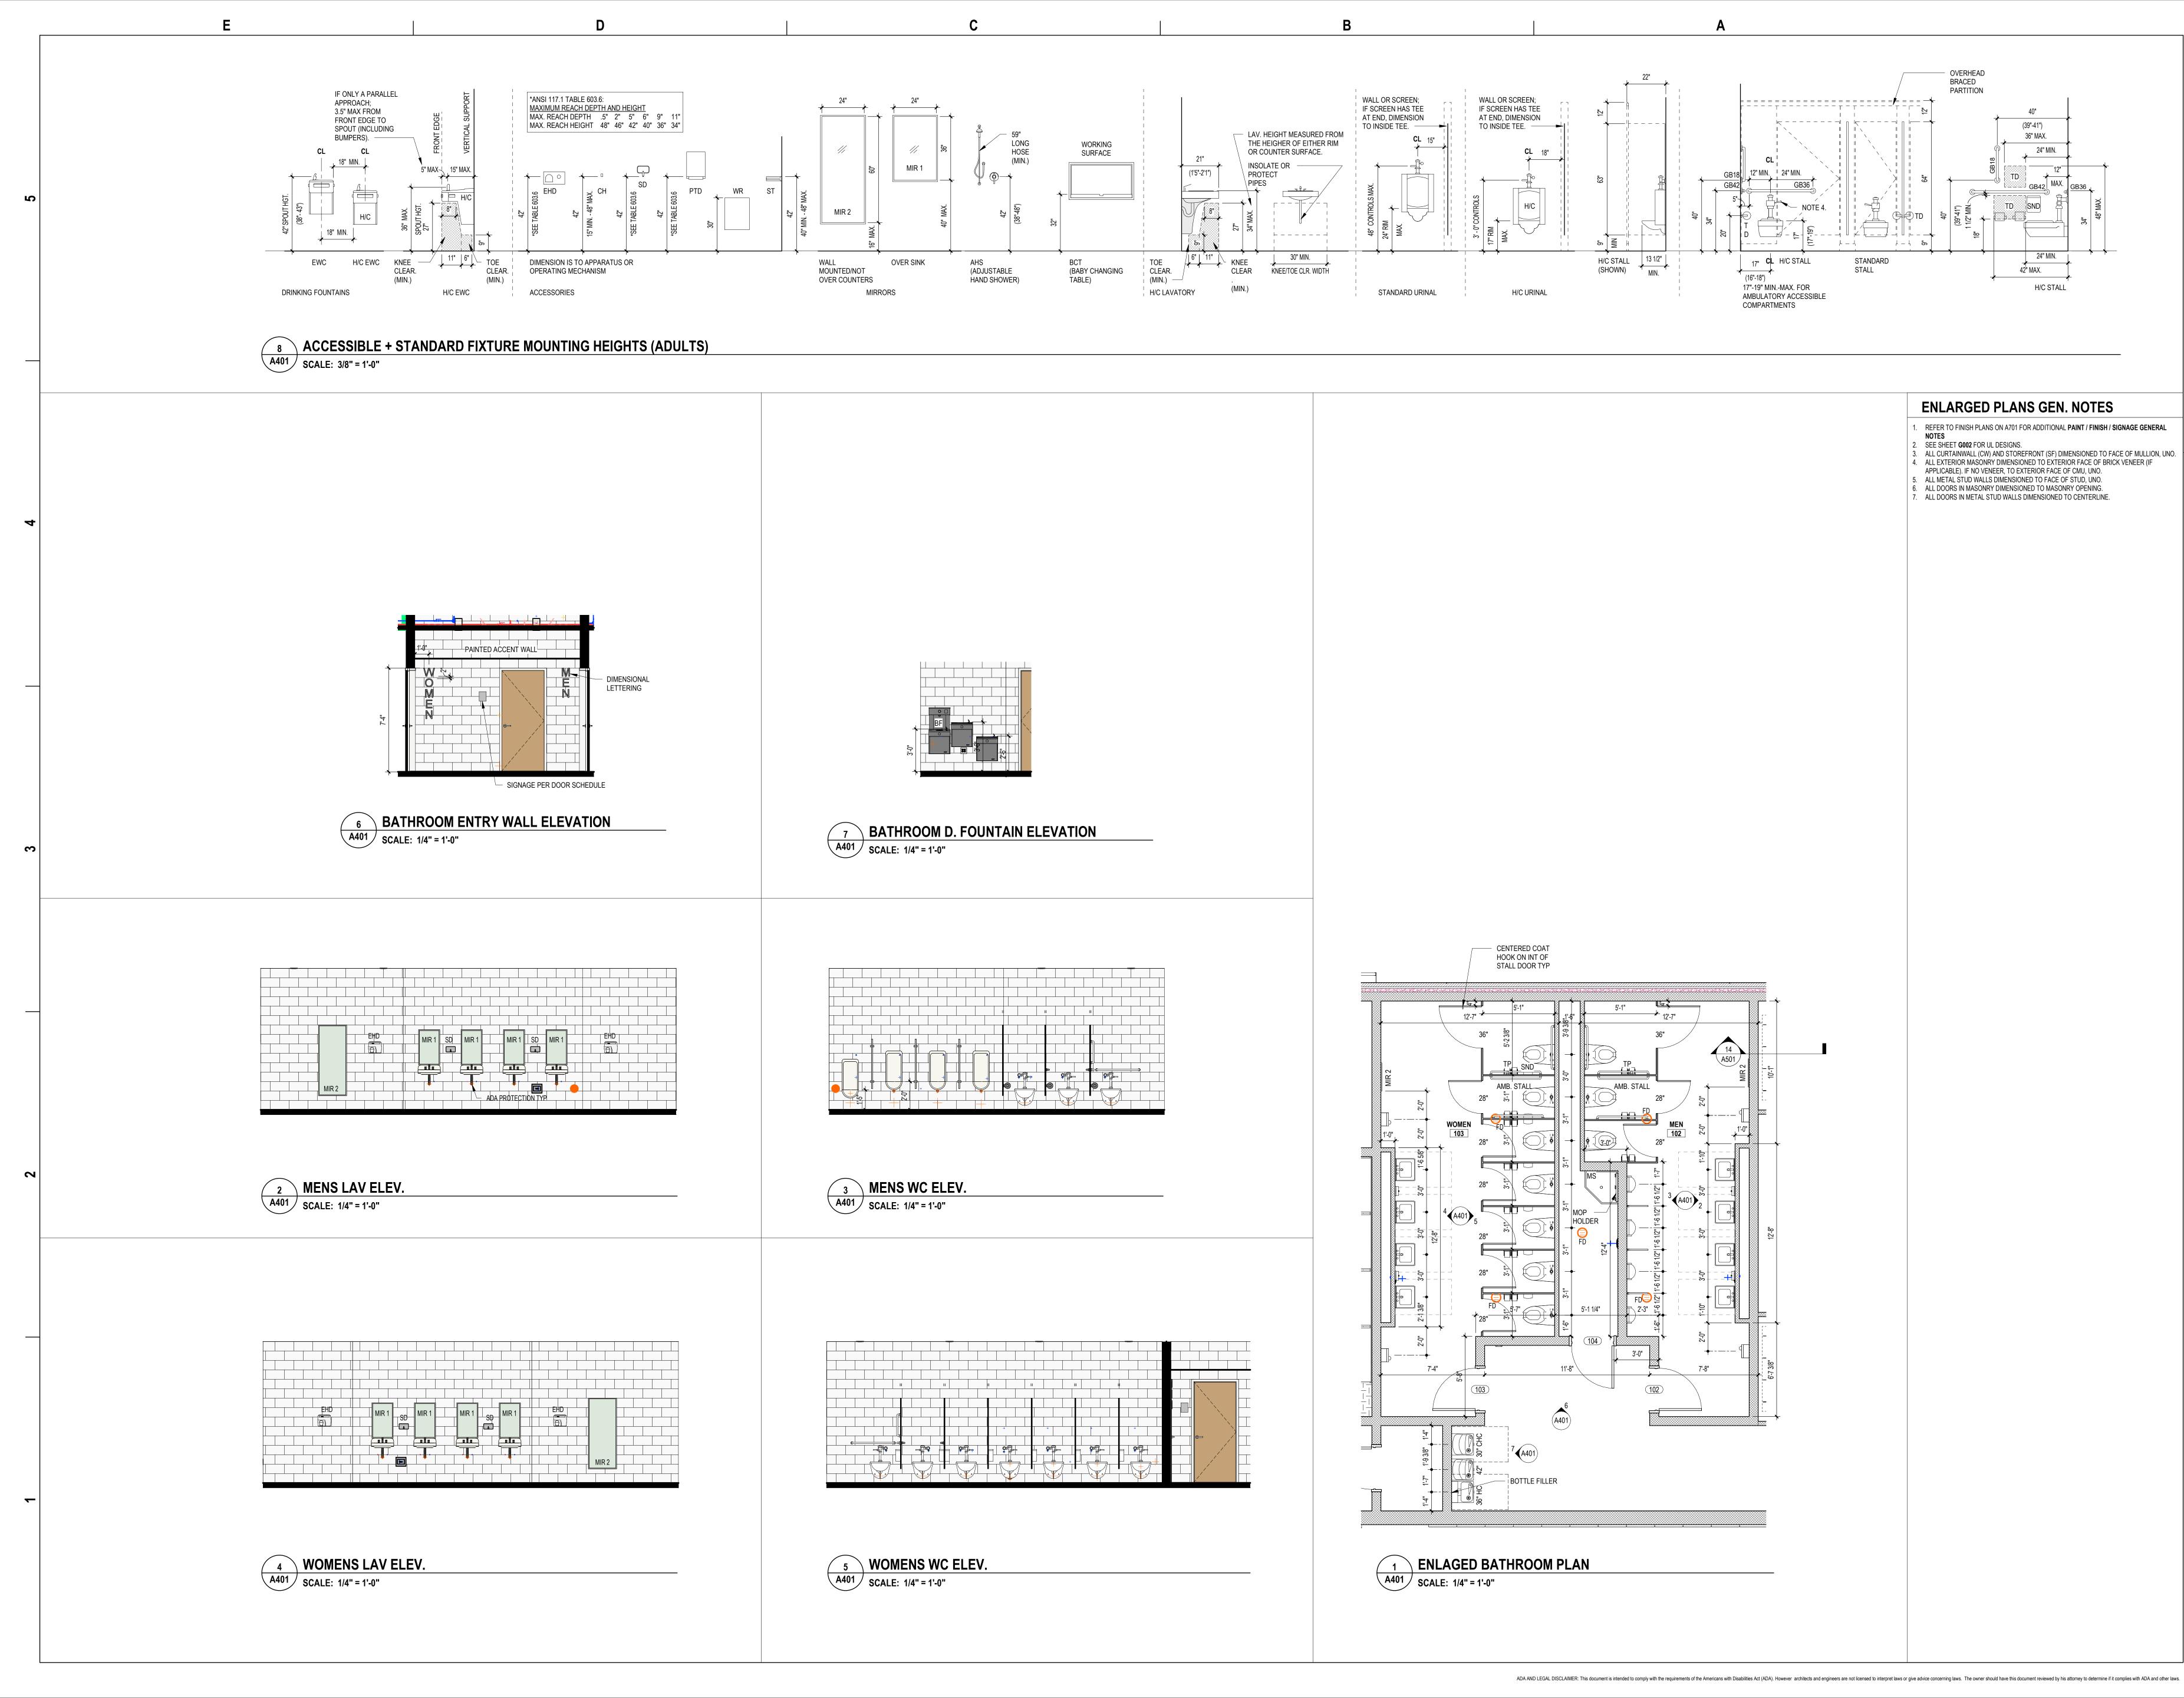

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STATE STATE COUNTY SCHOOLS

LILLINGTON-SHAW
STATE STATE

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Date Description

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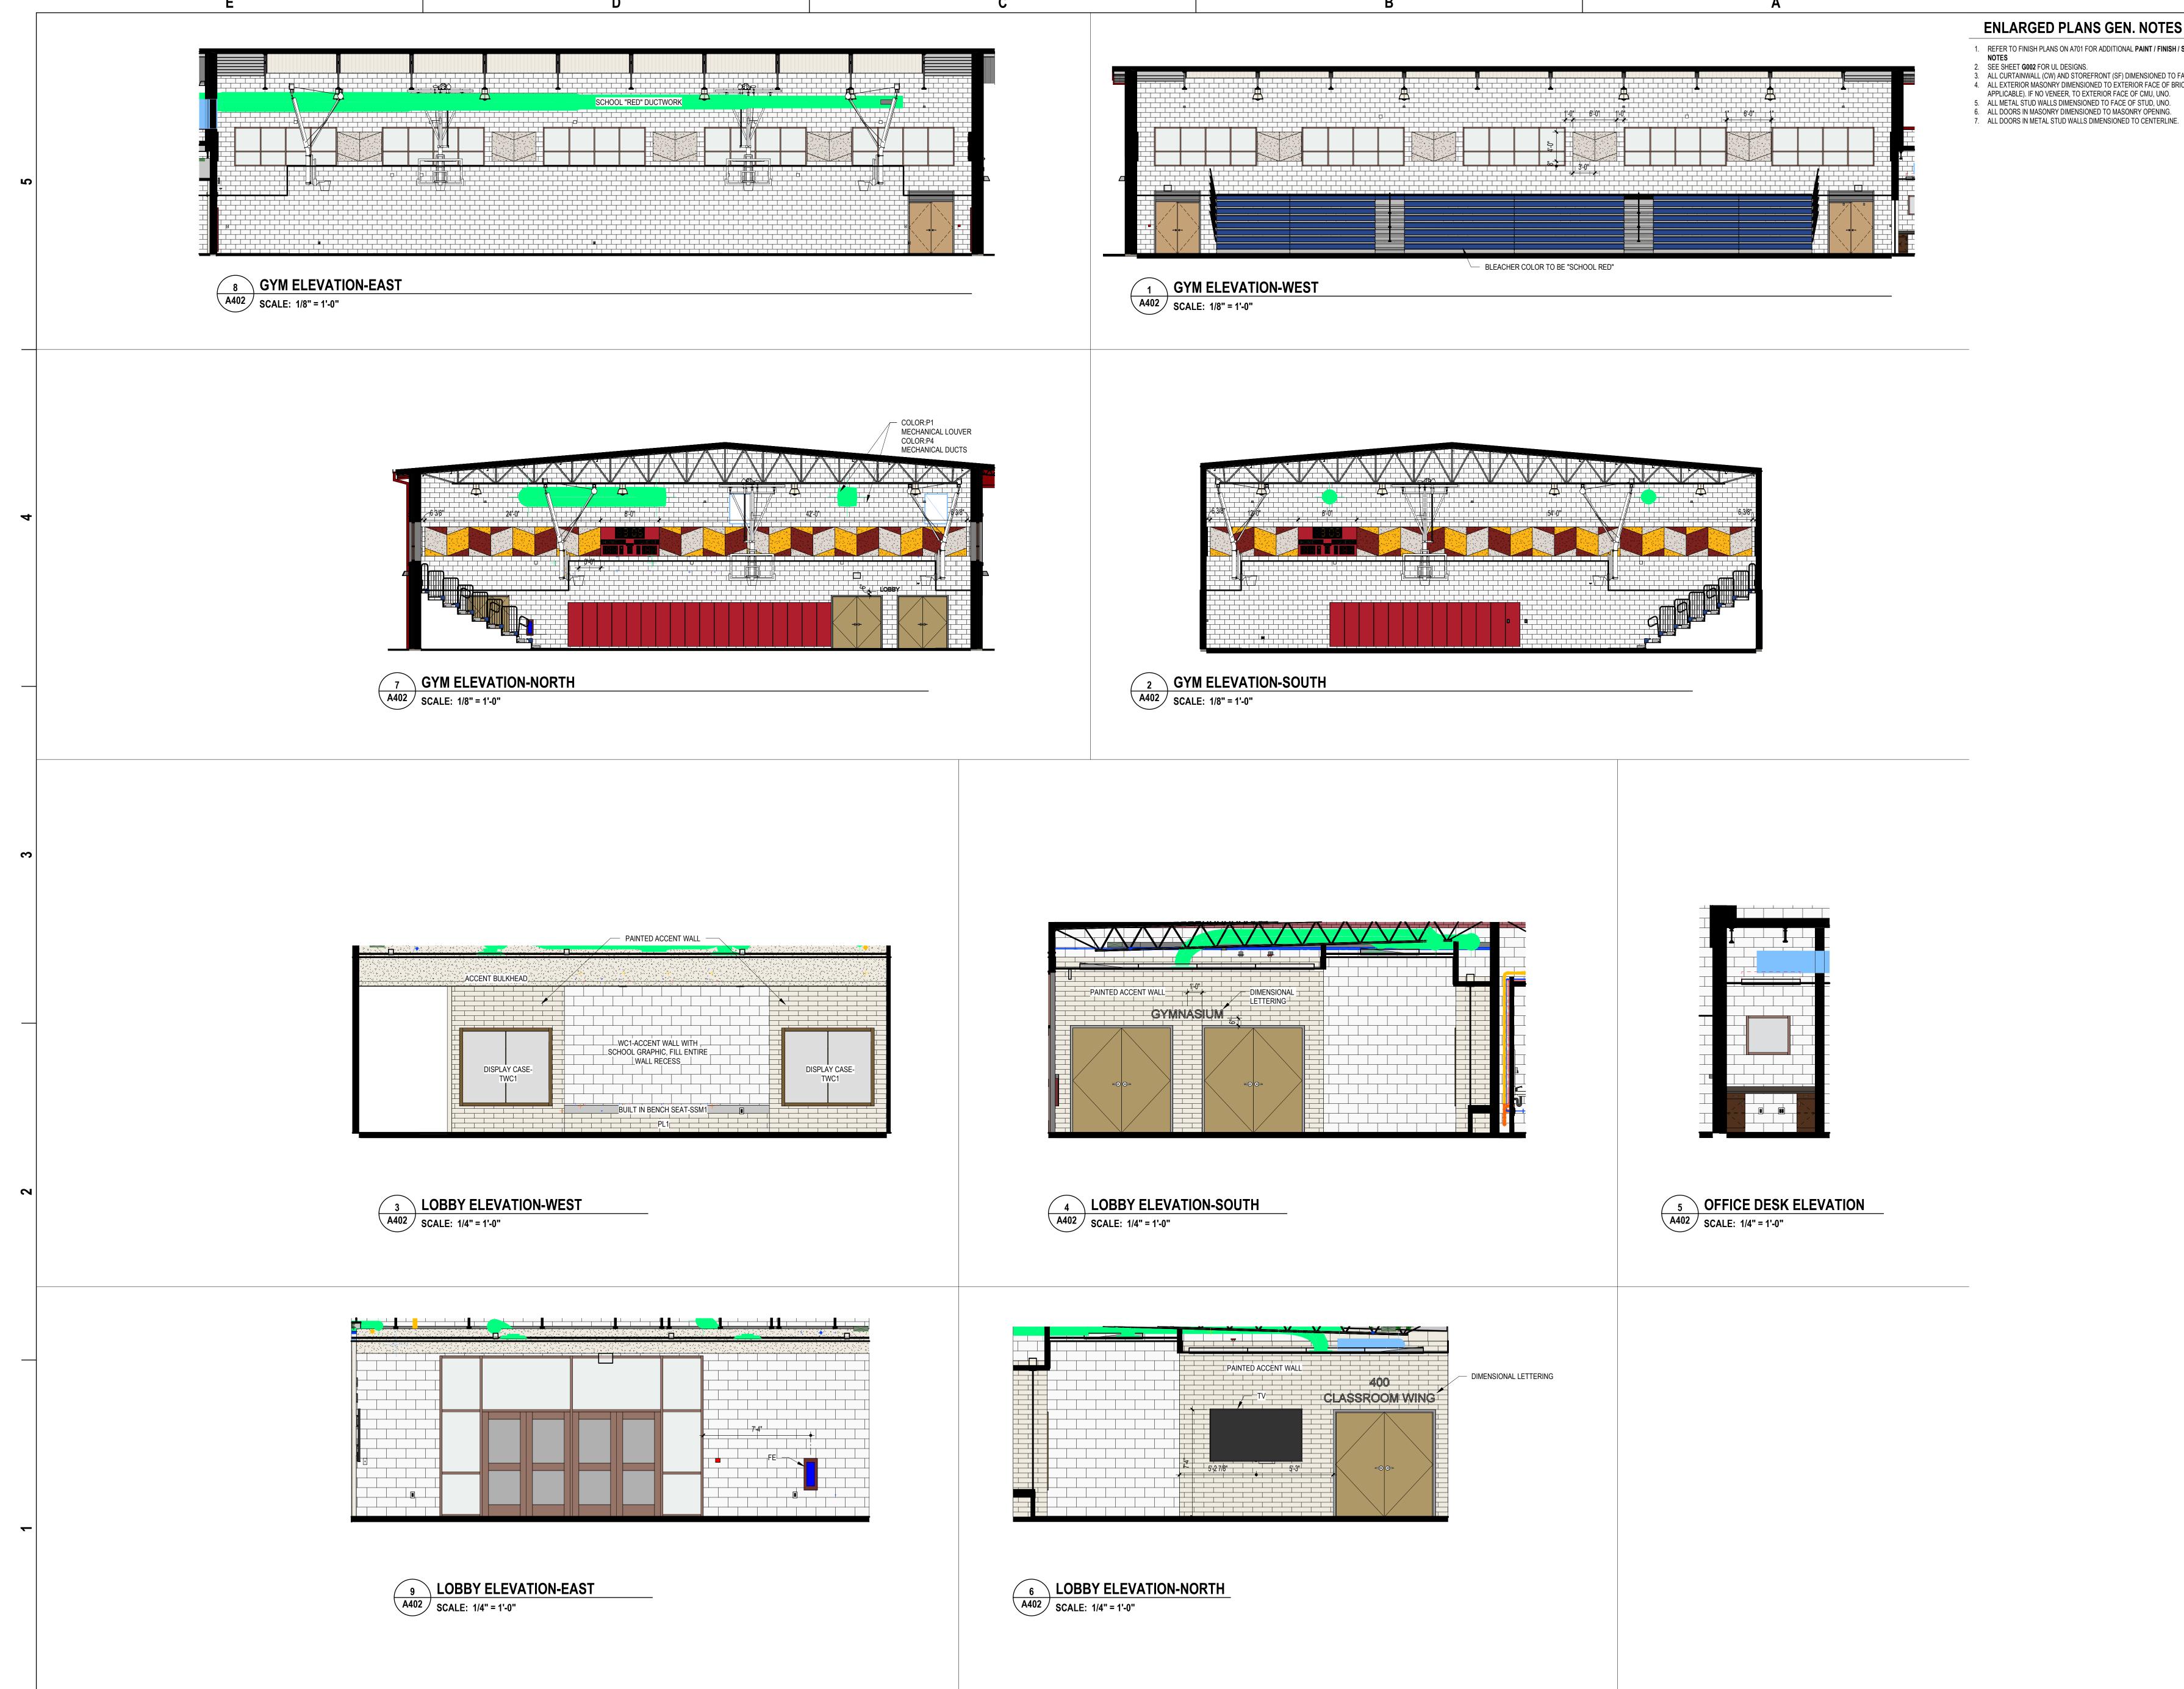
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BATHROOM PLAN &

A401

INT ELEVATIONS



ENLARGED PLANS GEN. NOTES

1. REFER TO FINISH PLANS ON A701 FOR ADDITIONAL PAINT / FINISH / SIGNAGE GENERAL

SEE SHEET G002 FOR UL DESIGNS.
 ALL CURTAINWALL (CW) AND STOREFRONT (SF) DIMENSIONED TO FACE OF MULLION, UNO.

4. ALL EXTERIOR MASONRY DIMENSIONED TO EXTERIOR FACE OF BRICK VENEER (IF


APPLICABLE). IF NO VENEER, TO EXTERIOR FACE OF CMU, UNO.

5. ALL METAL STUD WALLS DIMENSIONED TO FACE OF STUD, UNO.

6. ALL DOORS IN MASONRY DIMENSIONED TO MASONRY OPENING.

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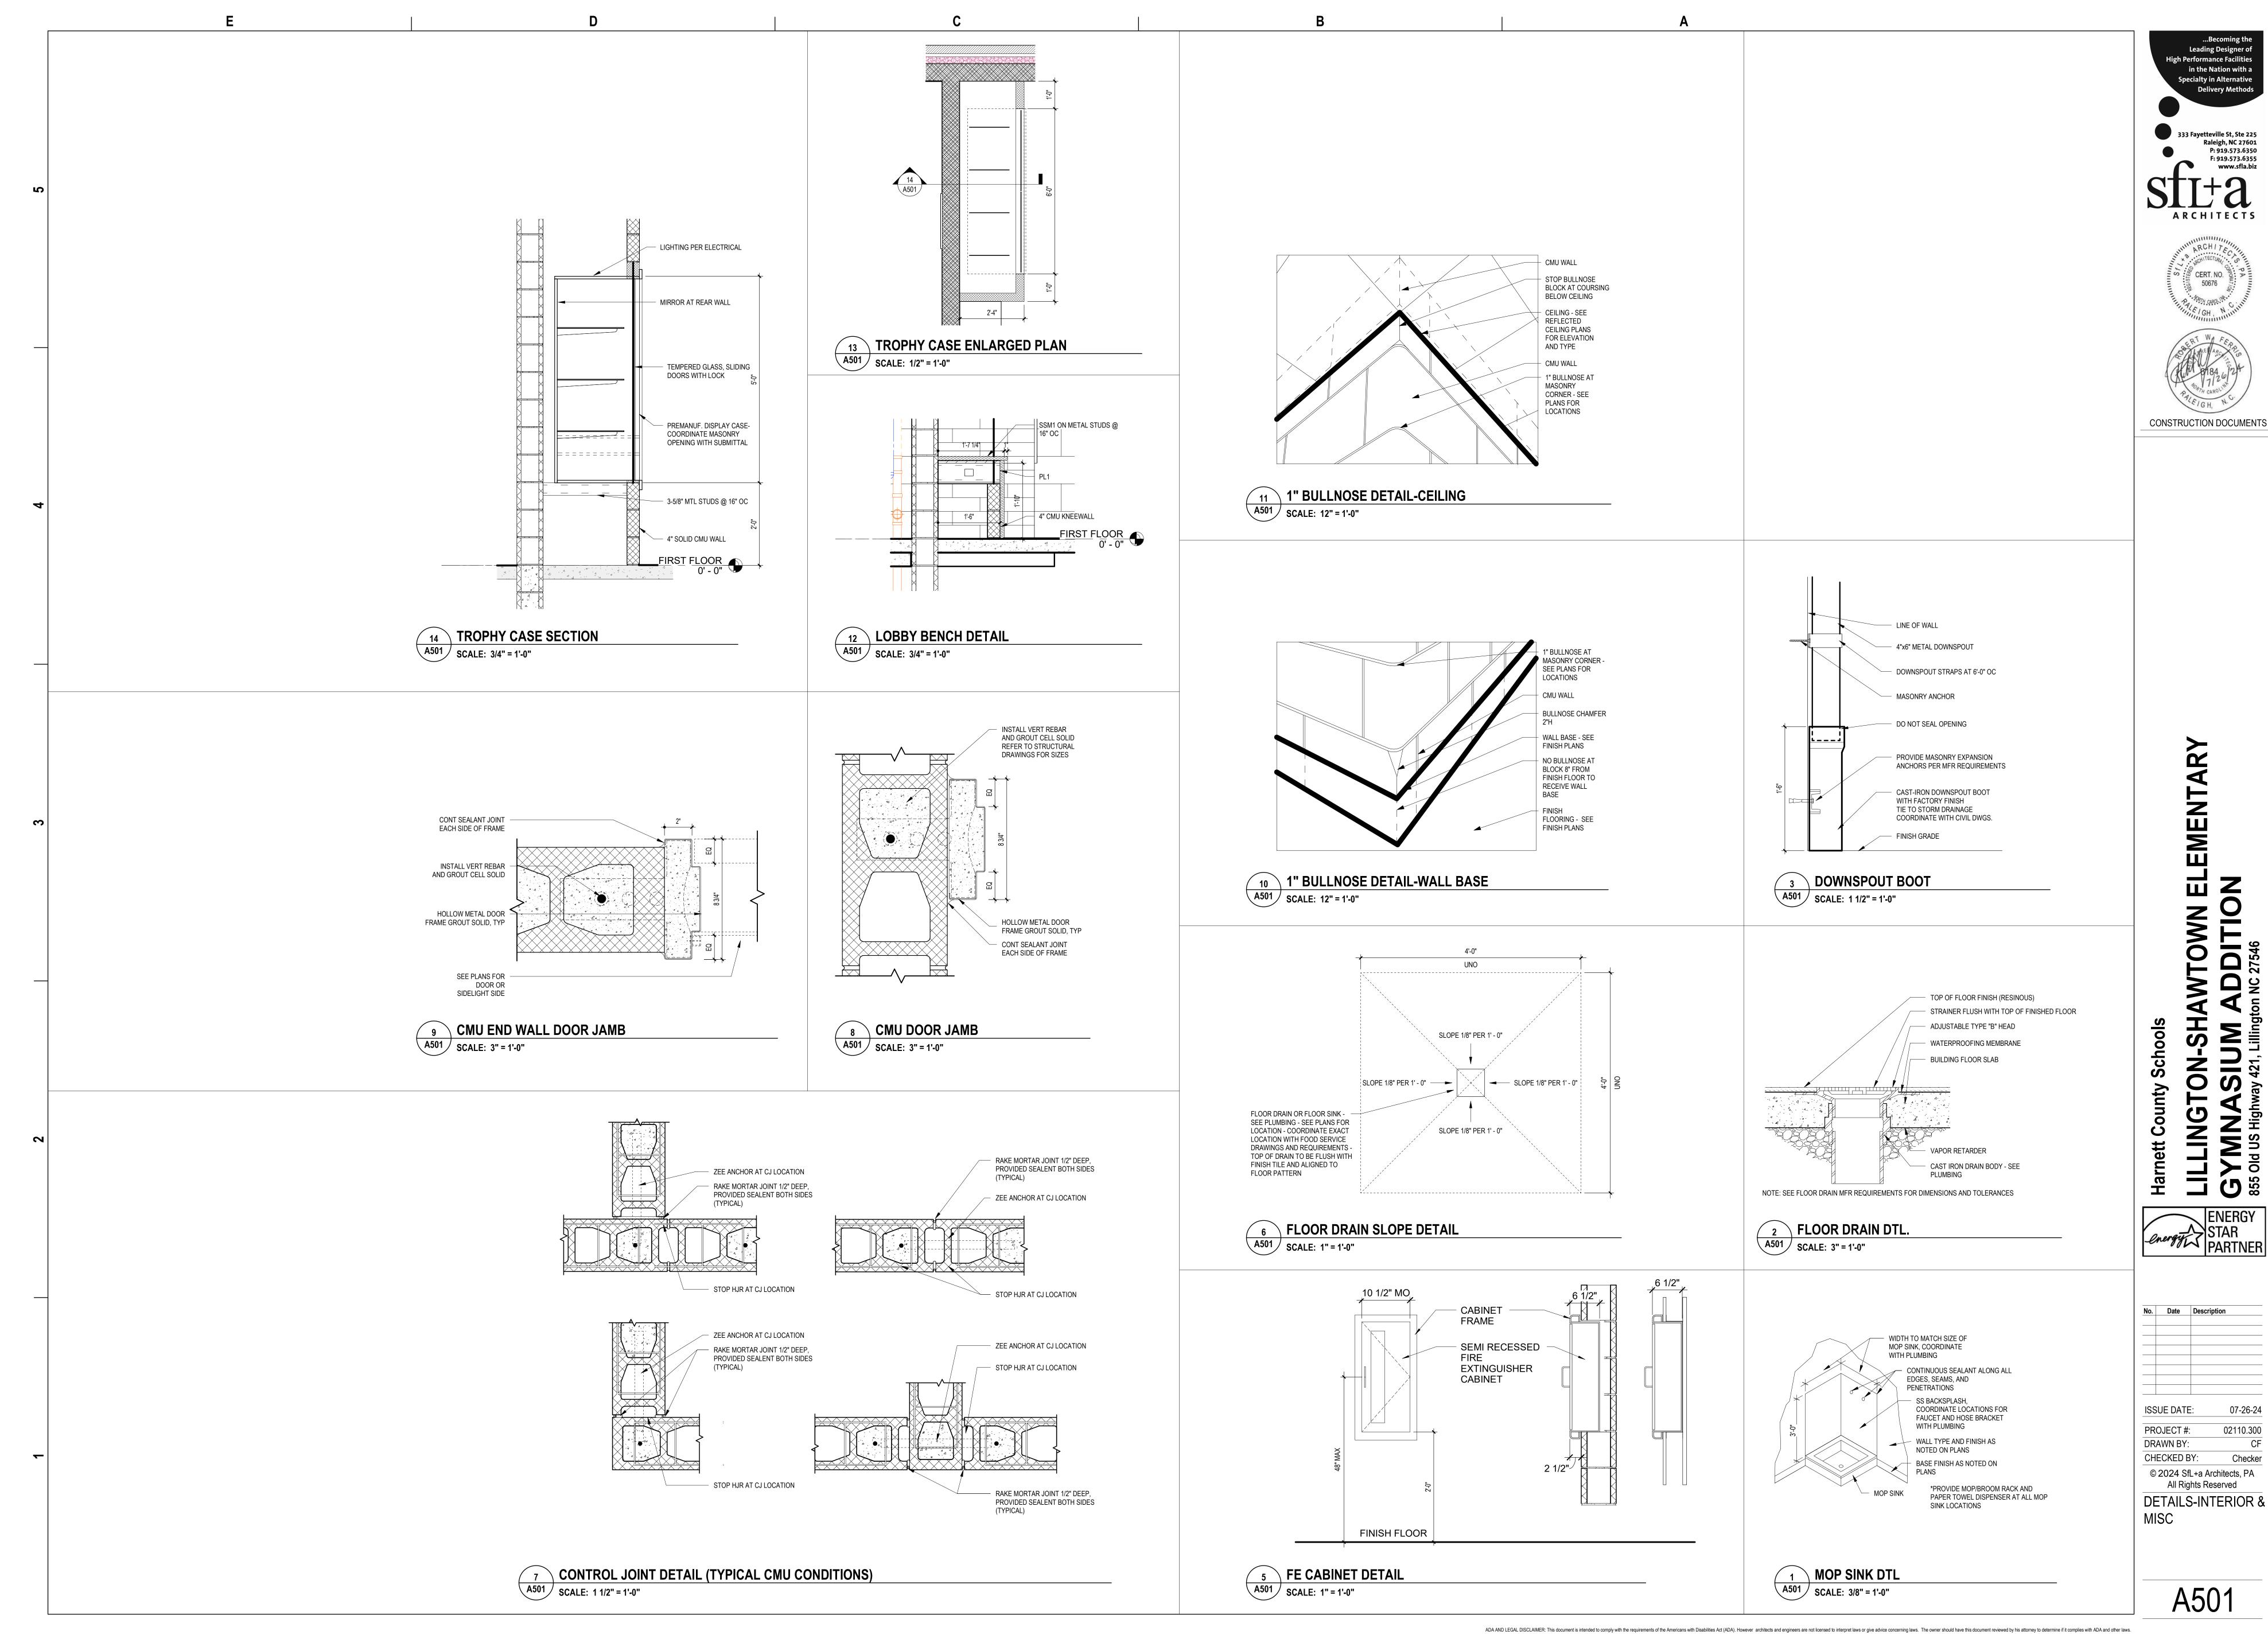


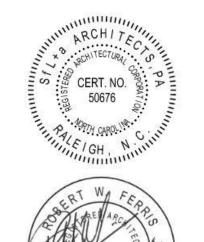

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ELEVATIONS




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> **ELEMENTARY** WOLM

ENERGY STAR PARTNER

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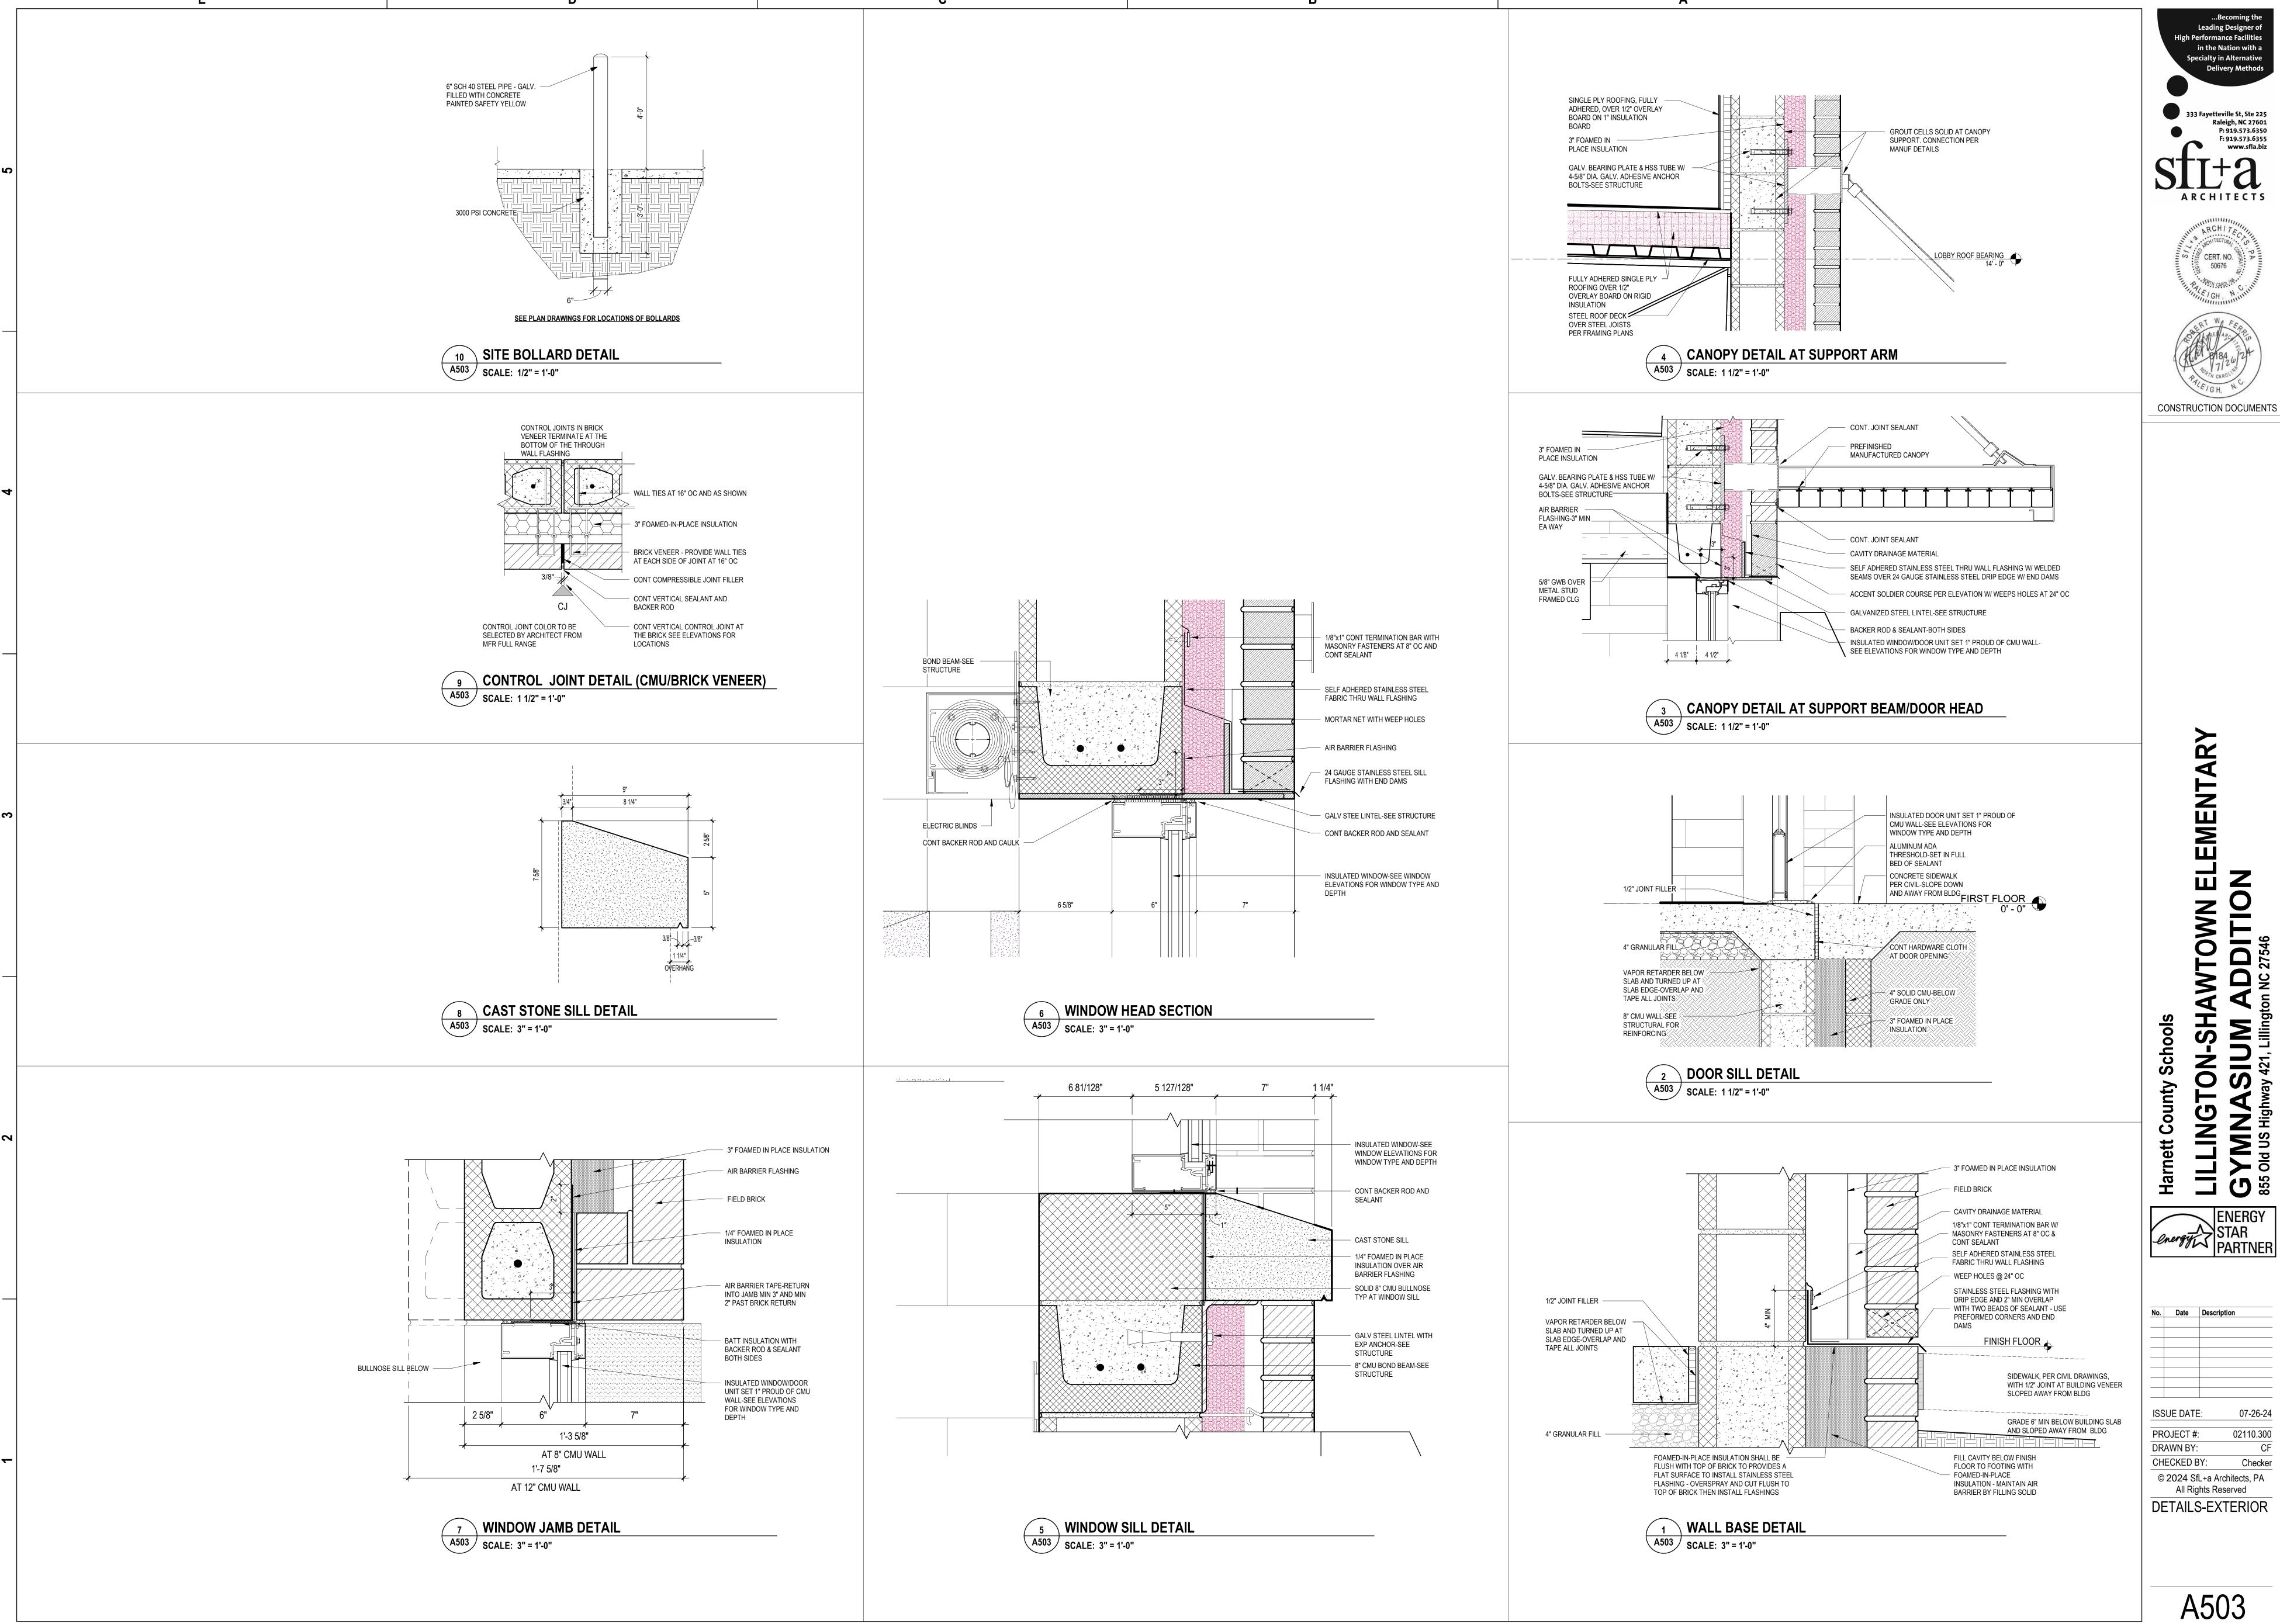
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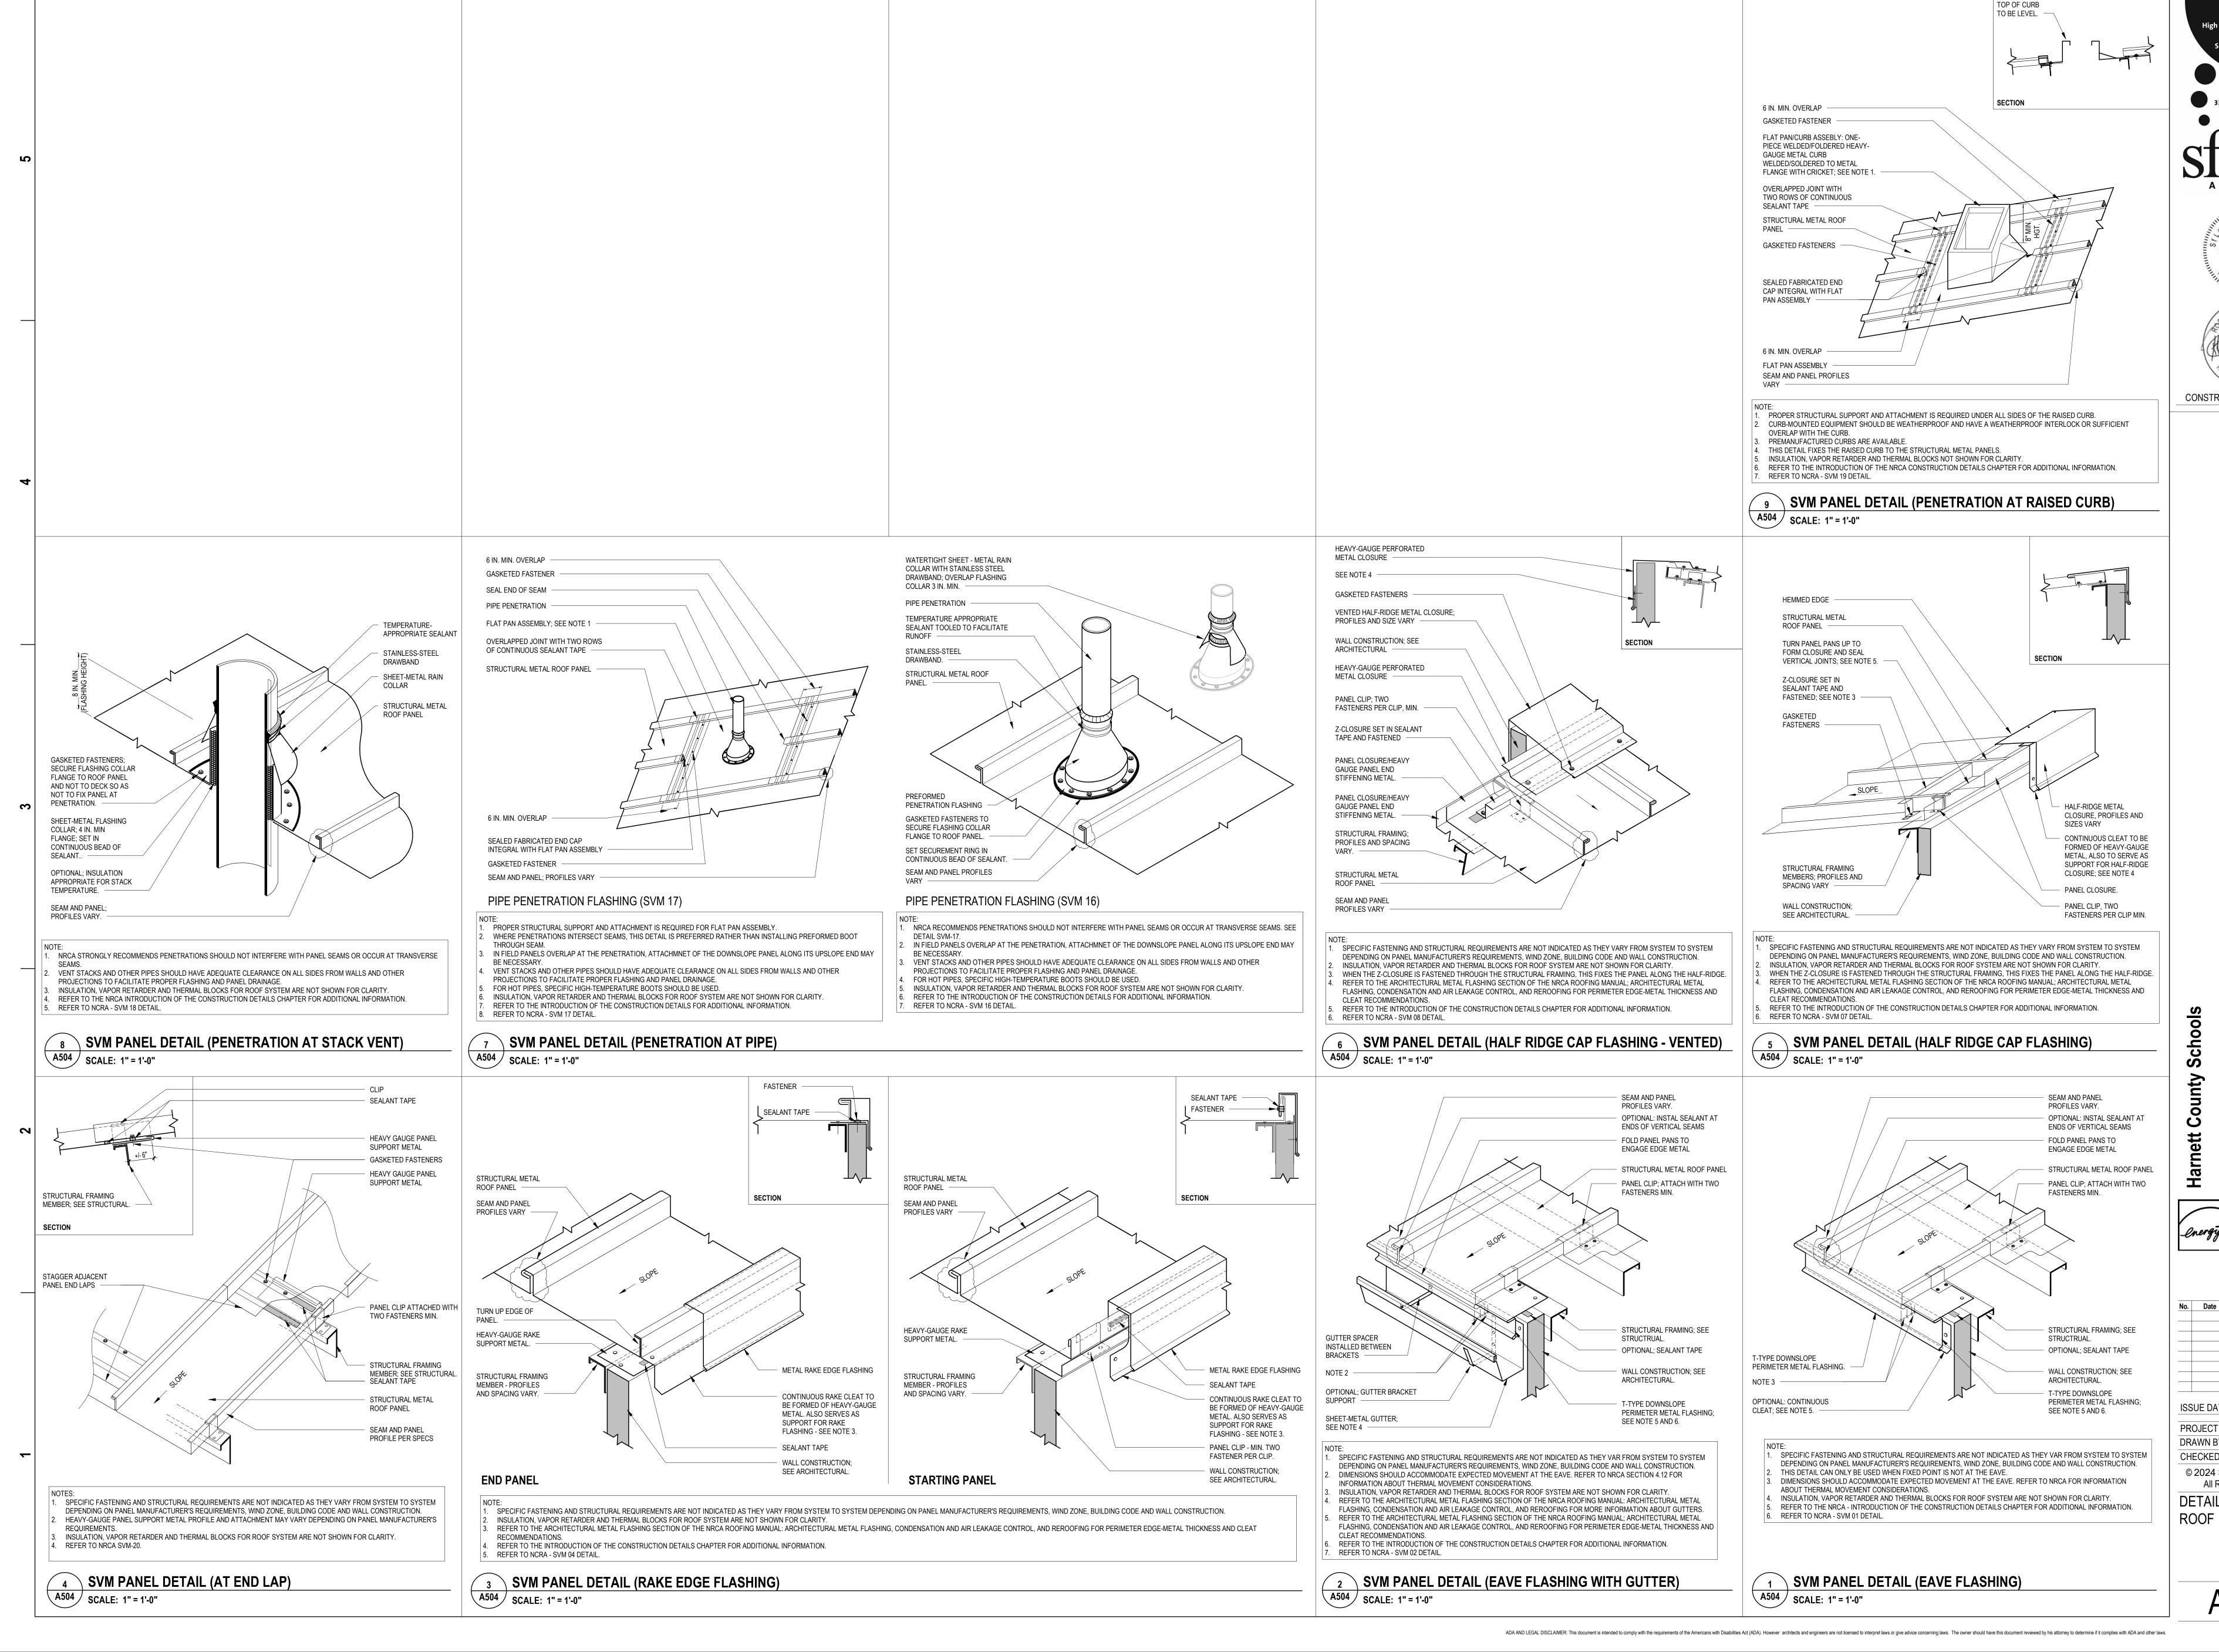
> **ELEMENTARY** WTOWN

energy STAR PARTNER

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A503
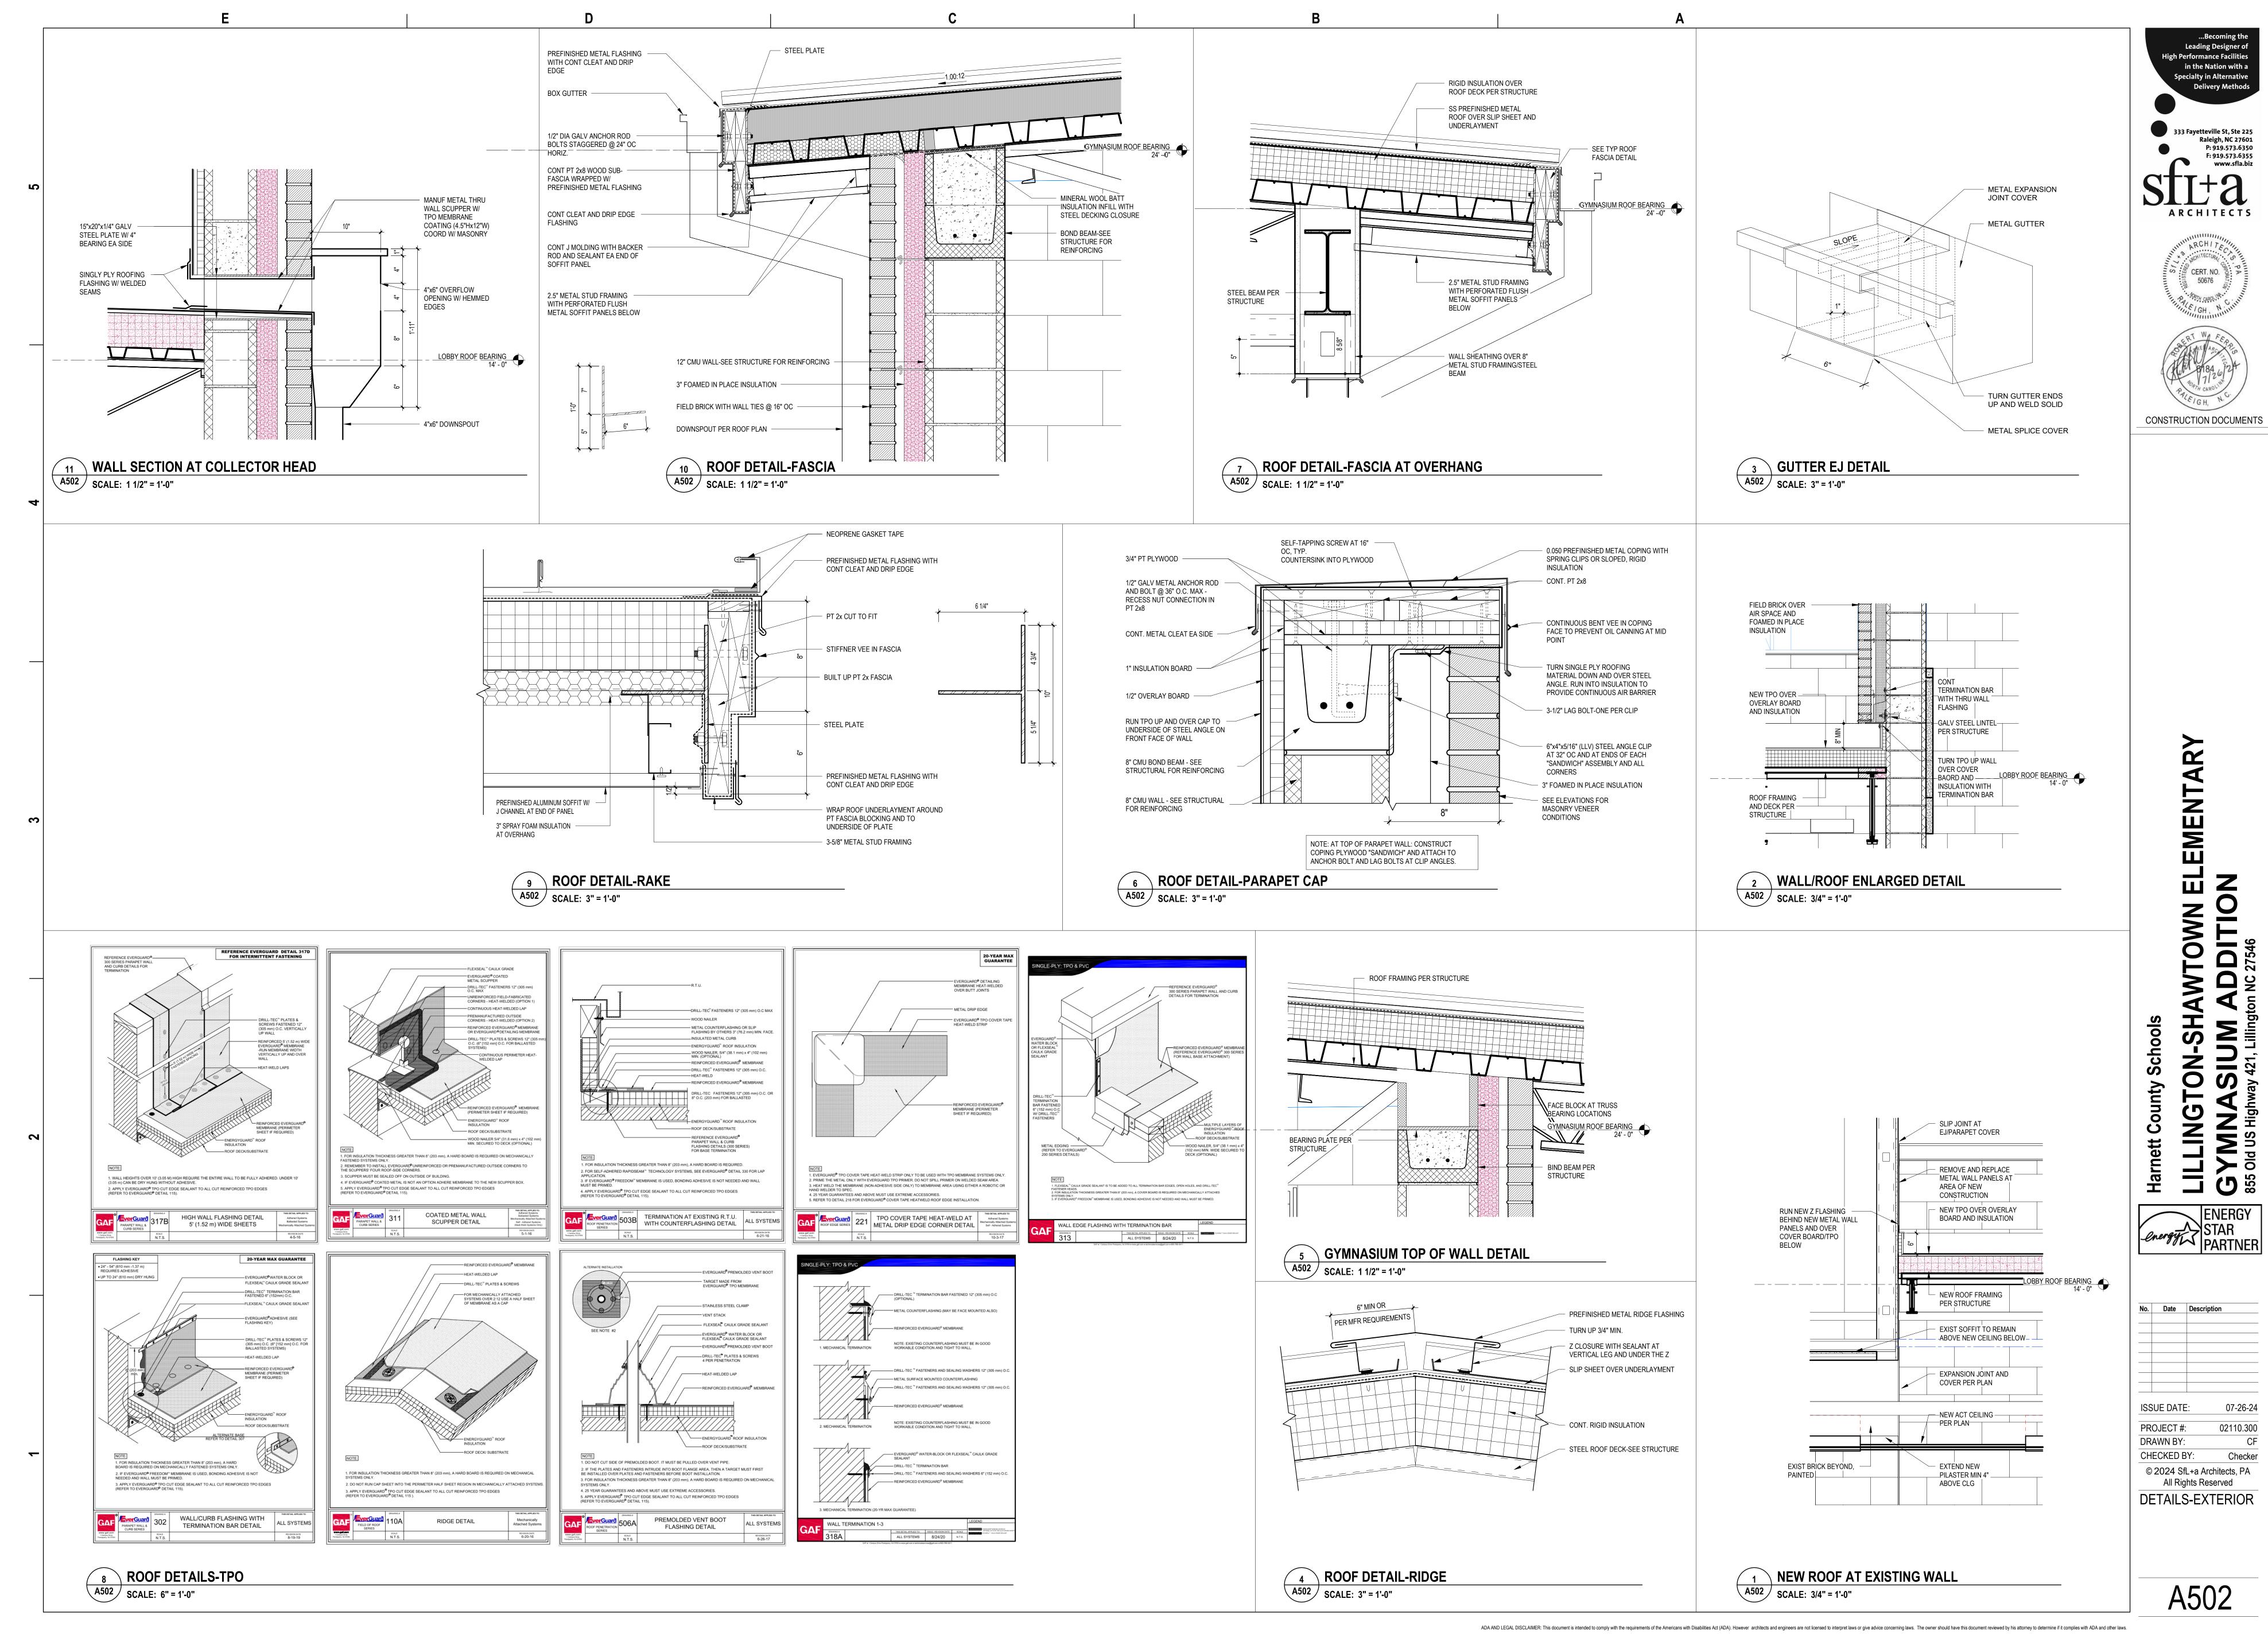
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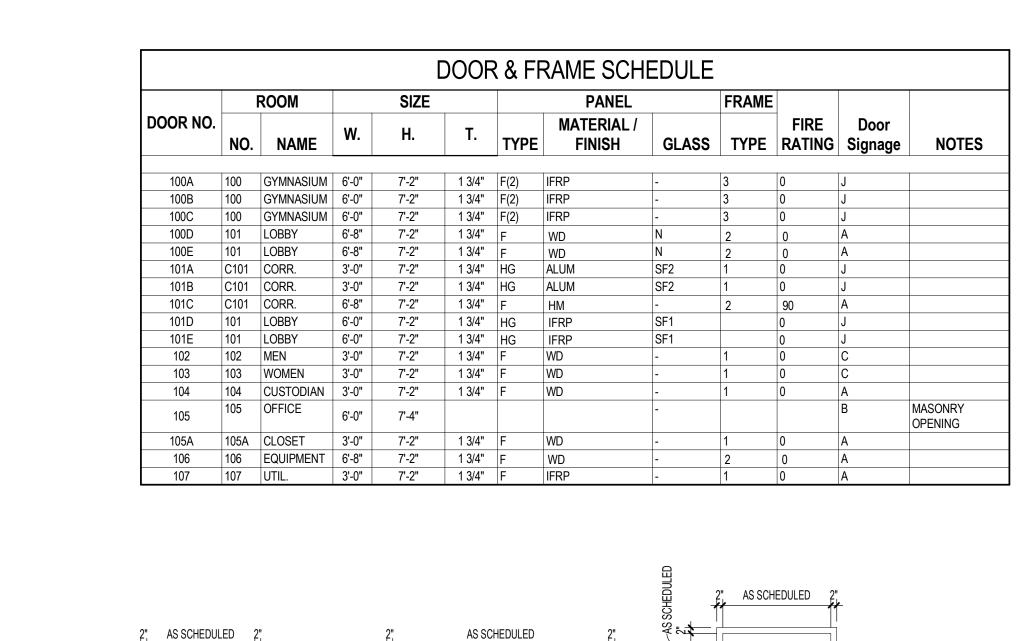
ARCHITECTS CONSTRUCTION DOCUMENTS

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ISSUE DATE: 07-26-24 02110.300 PROJECT #: DRAWN BY: CHECKED BY: Checker © 2024 SfL+a Architects, PA All Rights Reserved **DETAILS-SS METAL**



DOOR LOCKSET FUNCTION LEGEND

<u>HARDWARE NOTES:</u> **ENTRY DEADLOCK FUNCTION:** DEADBOLT BY KEY OUTSIDE, THUMBTURN INSIDE BOTH SIDES LOCK FUNCTION: THE INSIDE LEVER IS UNLOCKED BY A KEY AND THE OUTSIDE

LEVER IS UNLOCKED BY A KEY. CAN REMAIN UNLOCKED.

STOREROOM FUNCTION: THE INSIDE LEVER IS ALWAYS OPERABLE, THE OUTSIDE LEVER IS ALWAYS LOCKED. ONE MUST ALWAYS HAVE A KEY TO OPEN THE DOOR FROM THE OUTSIDE. OFFICE FUNCTION: THE INSIDE LEVER IS ALWAYS OPERABLE. THE OUTSIDE LEVER IS LOCKED BY DEPRESSING A BUTTON ON THE INSIDE LEVER. A KEY IS USED TO UNLOCK THE

OUTSIDE LEVER FROM THE OUTSIDE WHEN LOCKED. PRIVACY FUNCTION: THE OUTSIDE LEVER IS LOCKED BY USE OF A PUSH BUTTON ON THE INSIDE LEVER. THE OUTSIDE LEVER CAN BE UNLOCKED (NOT BY A KEY) BY THE USE OF

PASSAGE FUNCTION: THE INSIDE AND OUTSIDE LEVERS ARE FREE TO OPERATE AT ALL


HARDWARE ABBREVIATIONS: AST ASTRAGAL

- CLSR CLOSER **DIA** DIAMETER
- FB FLUSH BOLT **KP** KICK PLATE OHS OVERHEAD STOP
- SS STAINLESS STEEL WMS WALL MOUNTED STOP
- WS WEATHER STRIPPING

GENERAL DOOR NOTES

1. PROVIDE AND INSTALL WEATHERSTRIPPING AT ALL EXTERIOR DOORS.

- 2. PROVIDE AND INSTALL SILENCERS AT ALL H.M. FRAMES.
- 3. ALL DOUBLE DOORS TO RECEIVE KEYED MULLIONS.
- 4. ALL HM DOOR FRAMES TO BE PAINTED SW7674-PEPPERCORN.
- 5. ALL HM DOOR FRAMES TO BE WRAP AROUND. COORDINATE WITH WALL THICKNESS.

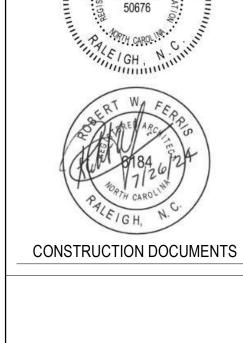

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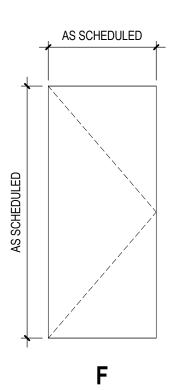
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DOOR PANEL LEGEND

IG3

IFRP


SCALE: 3/8" = 1'-0"

IG3

IG3

IFRP

IFRP

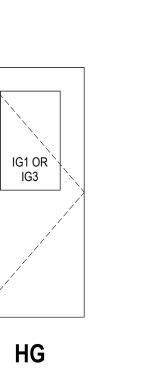

6'-1"

IG3


IFRP


IFRP

IG3


IG3


IFRP

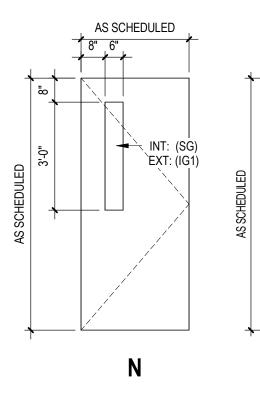


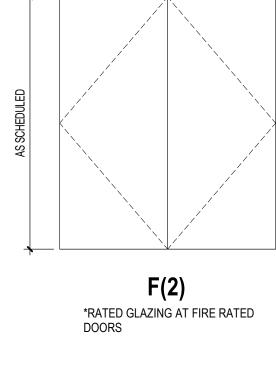


AS SCHEDULED

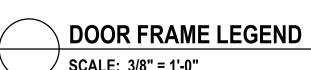

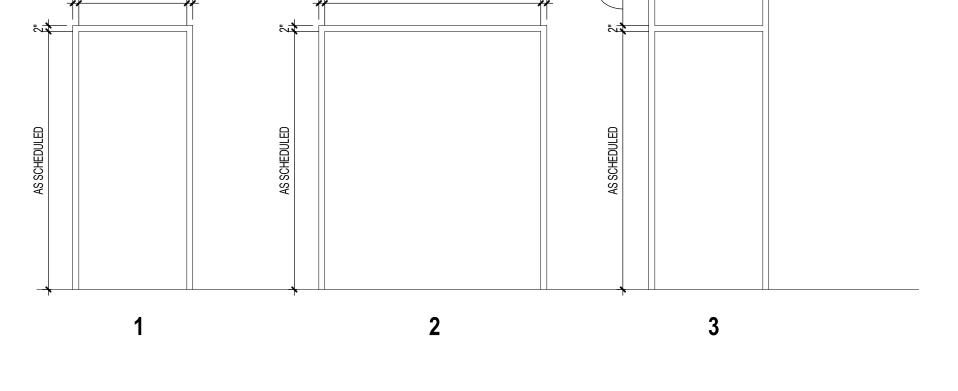

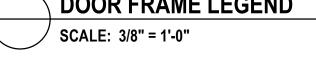

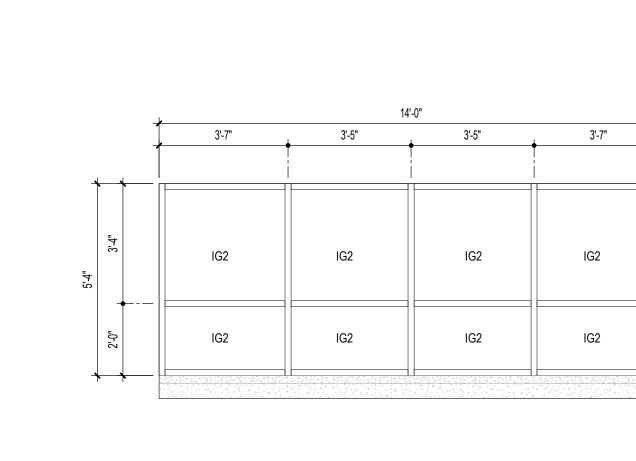

GLAZING UNIT TYPES

*COLOR TO BE SELECTED BY ARCHITECT FROM FULL RANGE OF MFR'S COLORS.

TYPE DESCRIPTION

(NON-INSULATED GLASS)
FG ANNEALED FLOAT GLASS, 1/4" THICK SINGLE PANE, CLEAR.

SAFETY GLASS - FULLY TEMPERED, 1/4" THICK SINGLE PANE, MATCH ADJACENT GLASS TINT. LAMINATED SAFETY GLASS, 1/4" THICK SINGLE PANE, CLEAR


MIRROR GLASS - FULLY TEMPERED, 1/4" THICK SINGLE PANE

(INSULATED GLASS UNITS) - ALL INSULATED GLASS UNITS TO BE TEMPERED IG2 DOUBLE PANE INSULATED, TRANSLUCENT LAMINATED GLASS UNITS, DIFFUSED (SOUTH, EAST & WEST FACING GLAZING-HIGH GLASS)

SEE PARTIAL ELEVATIONS FOR LAMINATE IG3 DOUBLE PANE INSULATED GLASS UNITS, TINTED AND TEMPERED (SOUTH, EAST & WEST FACING GLAZING-LOW GLASS)


GENERAL WINDOW NOTES

1. IFRP=IFRP INFILL PANEL. COLOR TO MATCH THE DOOR FRAME.

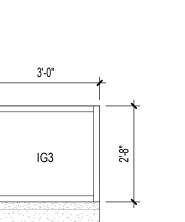







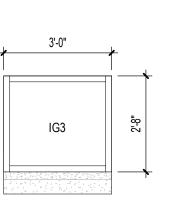


∕ IG3




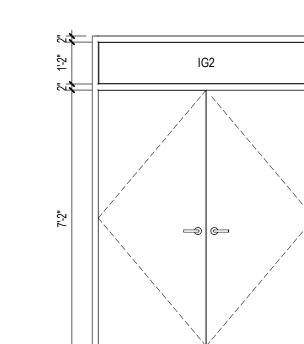

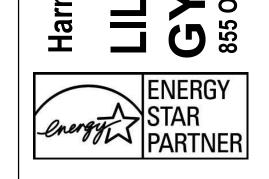

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1 LOBBY PERSPECTIVE
A801 SCALE:

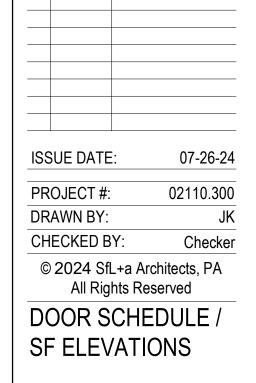

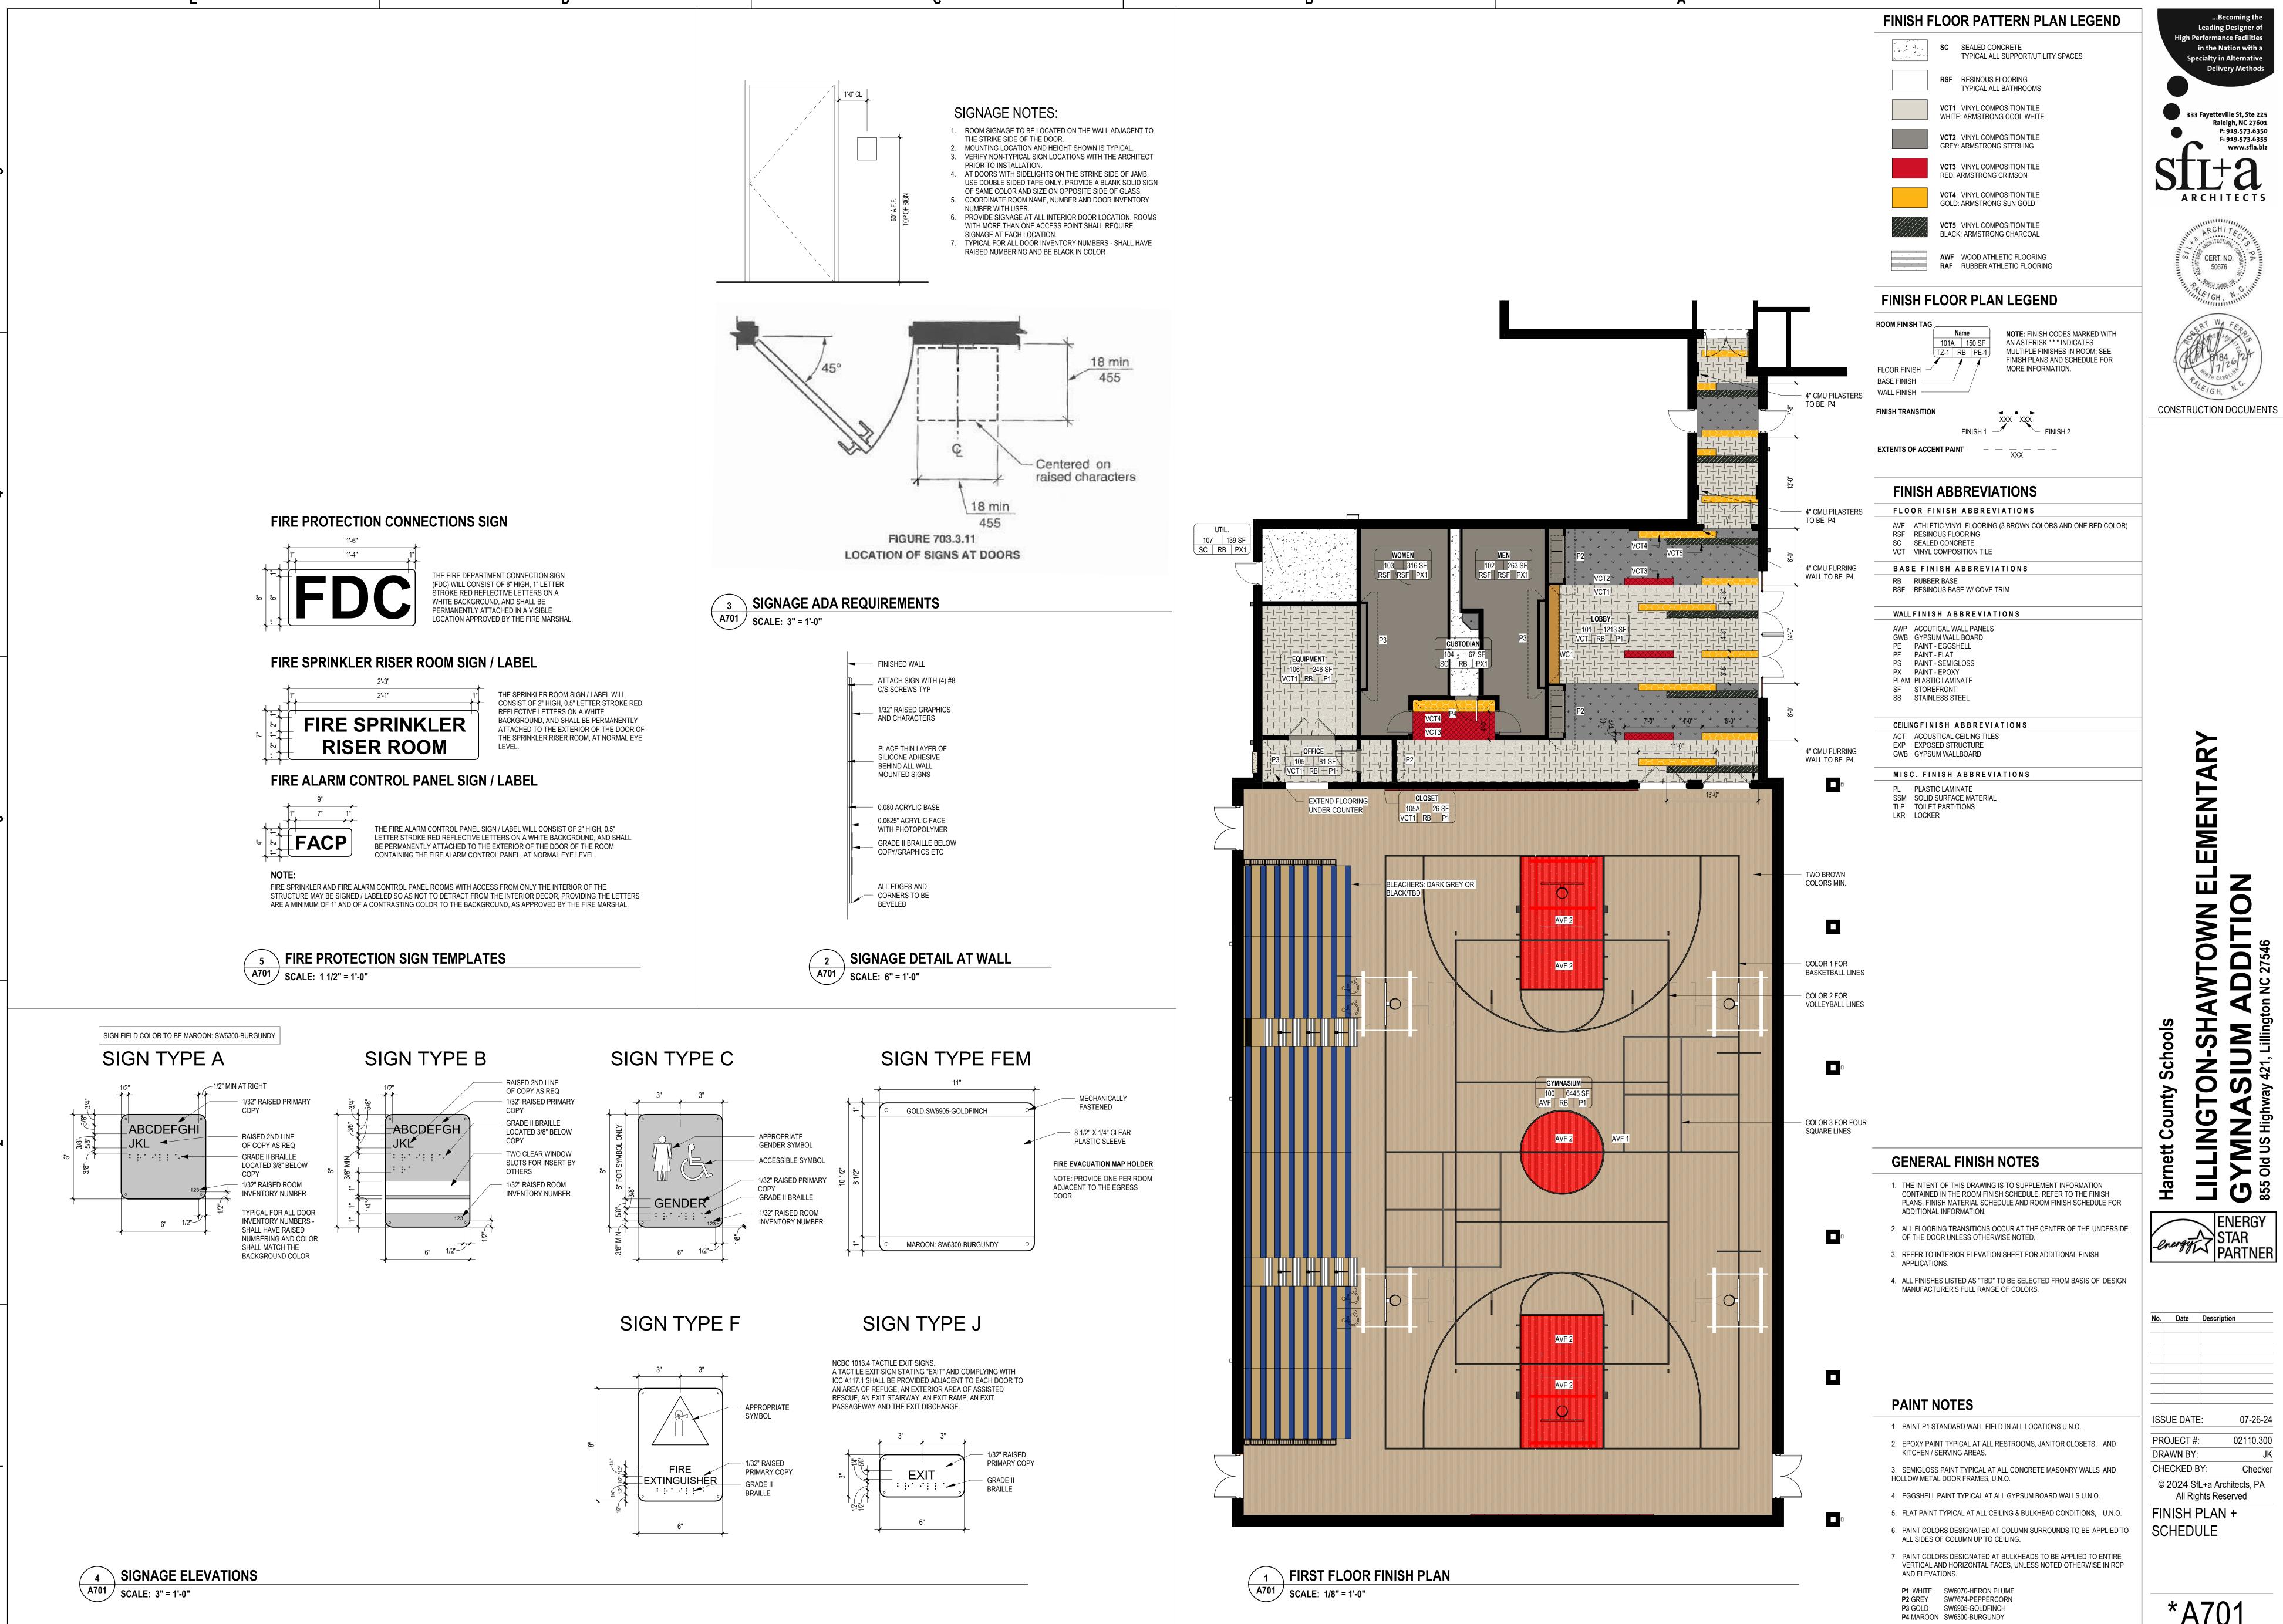2 GYM PERSPECTIVE SCALE:



EXTERIOR PERSPECTIVE





CONSTRUCTION DOCUMENTS

AWTOWN ELEMENTARY
ADDITION
on NC 27546

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