

# A Tenant Alteration for HARVEY JOHNS STEAKHOUSE

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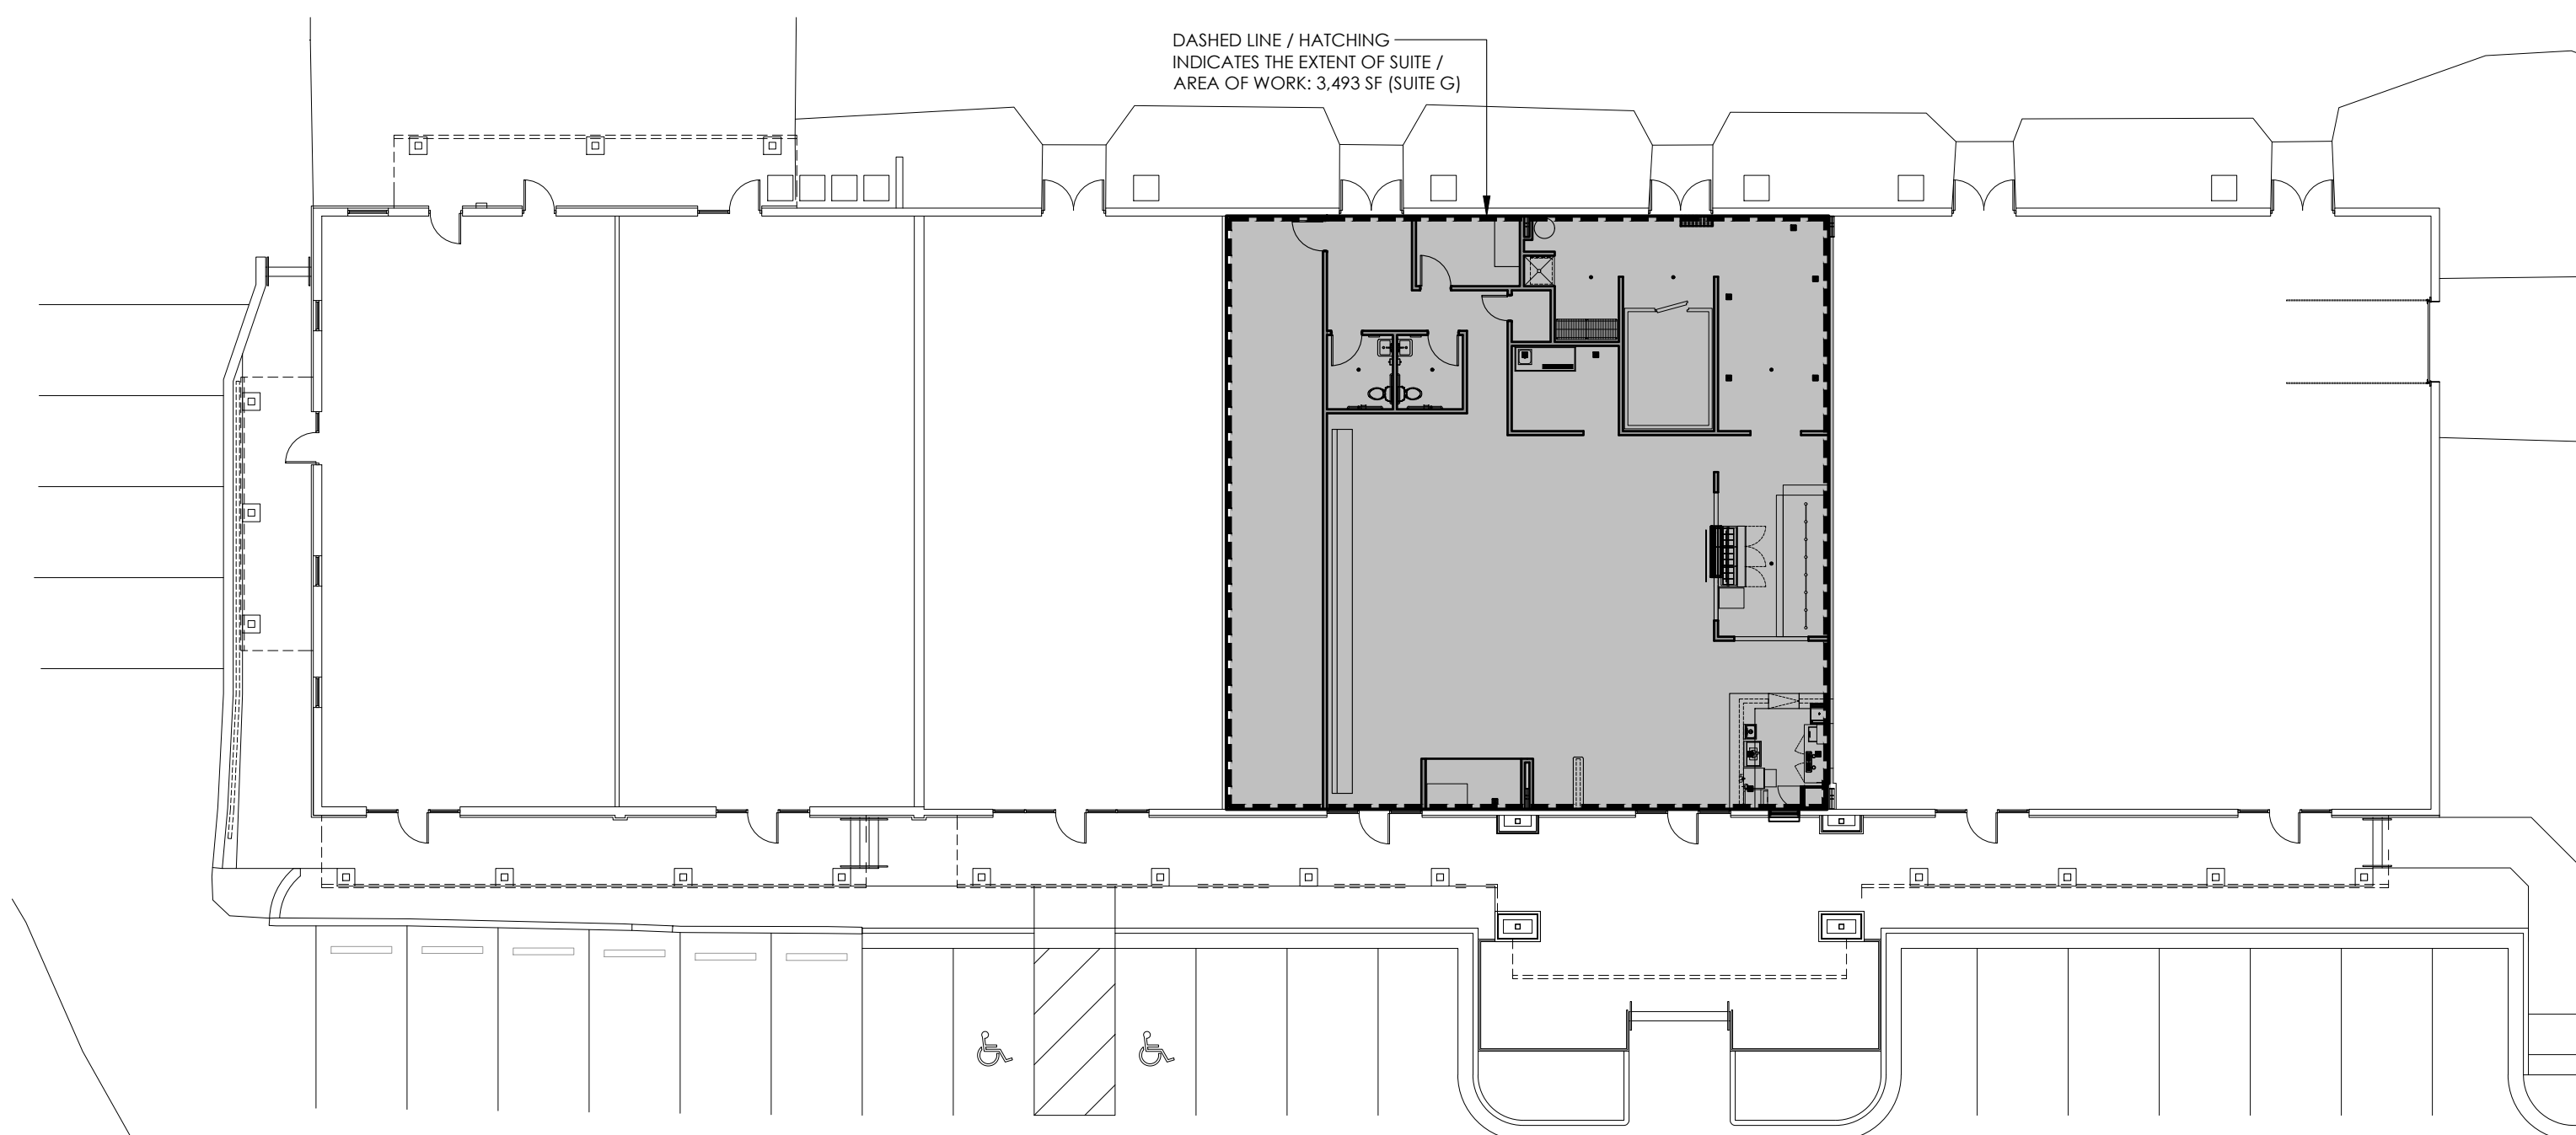
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## FOOD SERVICE


- FS-100 FOOD SERVICE EQUIPMENT PLAN

1501 N. Raleigh Street, Suite G  
Angier, North Carolina



**1** KEY PLAN  
G-1 SCALE: NOT TO SCALE

OCCUPANCY PLAN LEGEND	
	OCCUPANCY TYPE: ASSEMBLY (A-2) USE: DINING & KITCHEN KITCHEN LOAD: 2.87 (FACTOR OF 200 SF/PERSON) 574 SF
	DINING/BAR SEATING LOAD: 68.53 (FACTOR OF 15 SF/PERSON) 1,028 SF
	ADMIN / STAFF: 3.71 (FACTOR OF 100 SF/PERSON) 371 SF
	OCCUPANCY TYPE: STORAGE (S-2) USE: COOLER/FREEZER, DRY STORAGE LOAD: .82 (FACTOR OF 300 SF/PERSON) 246 SF USE: STORAGE ROOMS LOAD: 1.9 (FACTOR OF 300 SF/PERSON) 580 SF TOTAL OCCUPANTS: 78 (77.83)

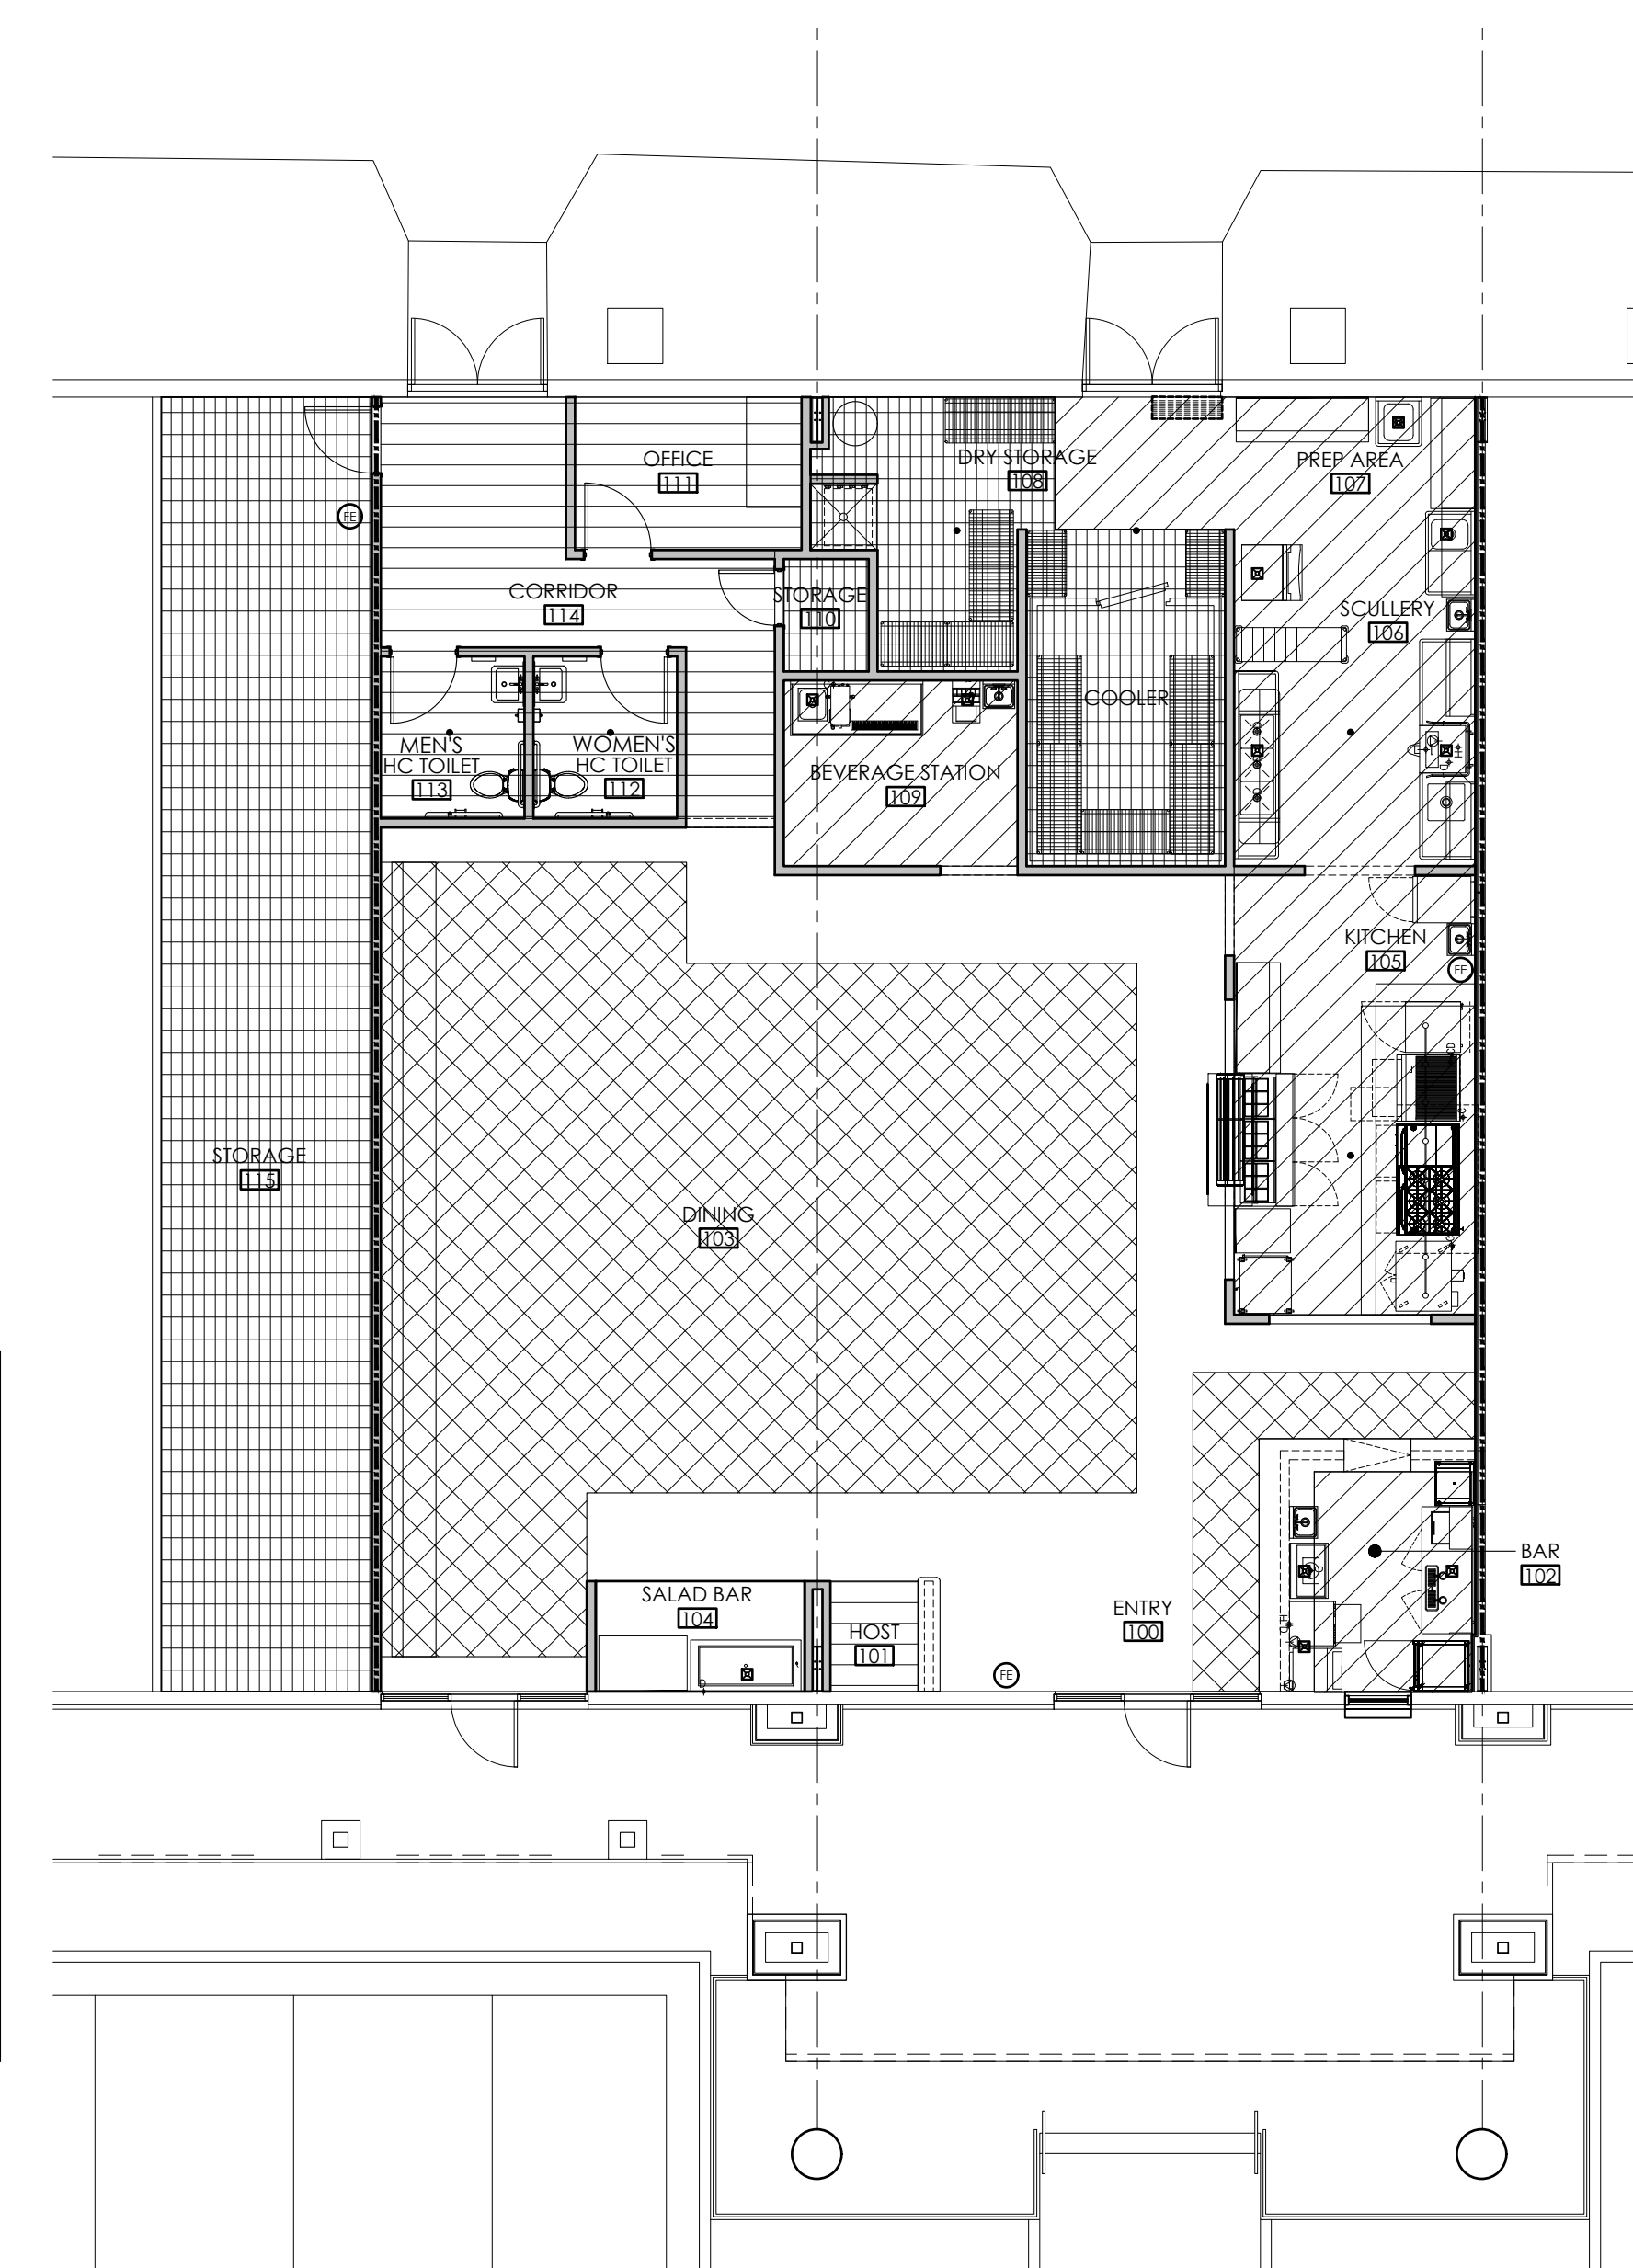

**2** OCCUPANCY PLAN  
G-1 SCALE: 1/8"=1'-0"

## Architecture & Interiors


iS design PLLC  
1111 Haynes Street, Suite 103  
Raleigh, North Carolina 27604  
Phone (919) 833-5400

## Plumbing, Mechanical & Electrical

ALIGN engineering  
PO Box 28313  
Raleigh, North Carolina 27611  
Phone (919) 275-1935

## Food Service Consultant


MSH Consultant Group  
300 Wendover Court  
Durham, North Carolina 27713  
Robert Herman - Principal Consultant  
Phone (919) 768-3250

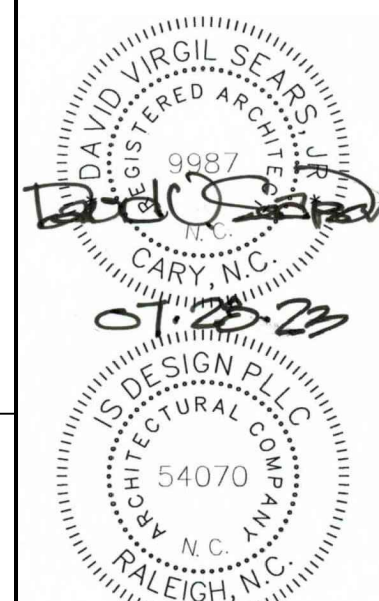

A Tenant Alteration for  
**HARVEY JOHNS STEAKHOUSE**  
 1501 N. Raleigh Street, Suite G  
 Angler, NC

JOB #:  
 23C1C1HARVEYJOHNS

DWG BY: DVS
CHK BY: DVS
DATE: 07/28/23
REV NO DATE

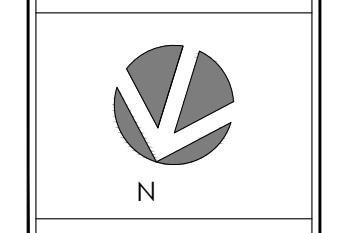

SHEET NUMBER

**G-2**

SUITE G


EXIT A		EXIT B	
66"	CLR. EXIT WIDTH	33"	CLR. EXIT WIDTH
330	MAX. CALC. OCCUPANT LOAD	165	MAX. CALC. OCCUPANT LOAD
35	ACTUAL OCCUPANT LOAD	35	ACTUAL OCCUPANT LOAD

EXIT C		EXIT D	
66"	CLR. EXIT WIDTH	66"	CLR. EXIT WIDTH
330	MAX. CALC. OCCUPANT LOAD	330	MAX. CALC. OCCUPANT LOAD
4	ACTUAL OCCUPANT LOAD	4	ACTUAL OCCUPANT LOAD

TOTAL OCCUPANTS: 78

- ⊗ = INDICATES EXIT SIGN LOCATION
- ⊕ = INDICATES LOCATION OF FIRE EXTINGUISHERS. GC TO VERIFY FINAL LOCATIONS W/ FIRE MARSHAL
- = EXIT ACCESS TRAVEL DISTANCE
- ↔ = COMMON PATH OF TRAVEL TO POINT OF DECISION
- = INDICATES EXISTING NON-RATED PARTITIONS
- = INDICATES NEW 1 HOUR-RATED FIRE BARRIERS

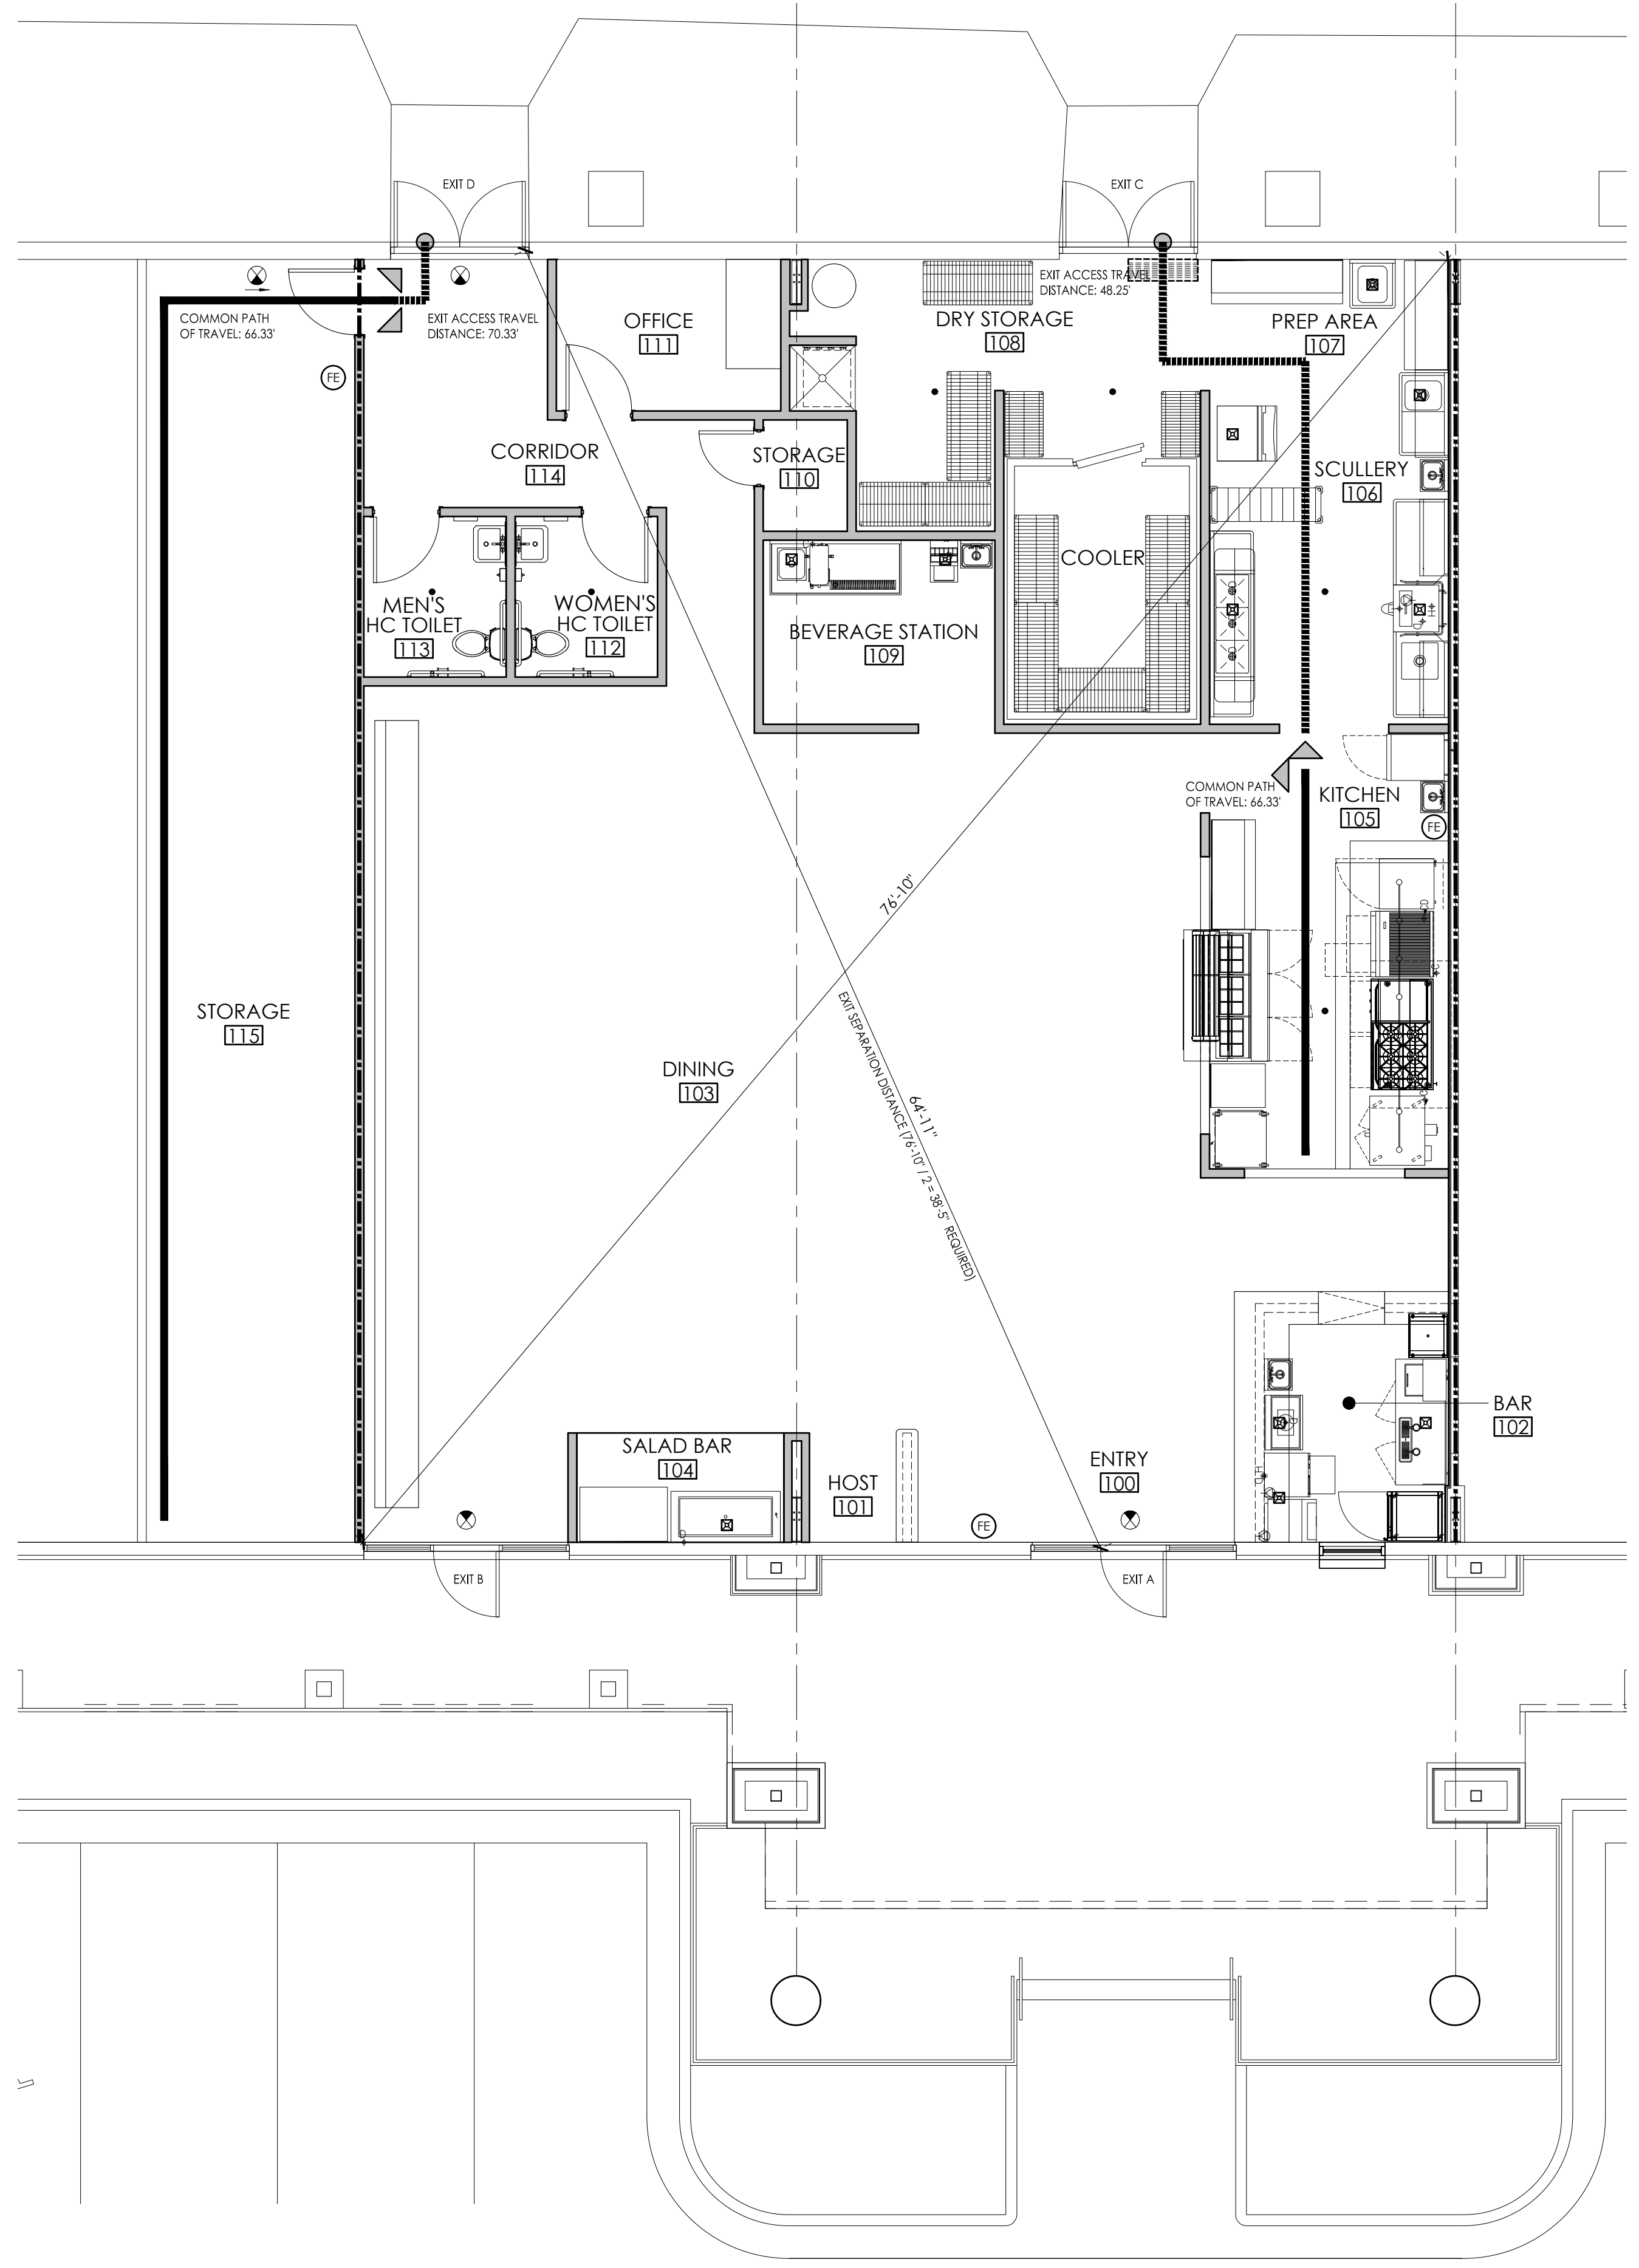

**1** LIFE SAFETY PLAN  
 G-2 SCALE: 3/16"=1'-0"



**2018 APPENDIX B**  
**BUILDING CODE SUMMARY FOR ALL COMMERCIAL PROJECTS**  
 (EXCEPT 1 AND 2-FAMILY DWELLINGS AND TOWNHOUSES)  
 (Reproduce the following data on the building plans sheet 1 or 2)

Name of Project: A Tenant Alteration for Harvey Johns Steakhouse  
 Address: 1501 N. Raleigh Street, Suite G, Angier, NC Zip Code: 27501  
 Owner/Authorized Agent: David Sears, AIA Phone # ( 919 ) 833-5400  
 E-Mail: mark@isdesignpllc.com  
 Owned By: \_\_\_\_\_  
 Code Enforcement Jurisdiction: Wake County

CONTACT: \_\_\_\_\_  
 DESIGNER: FIRM NAME LICENSE # TELEPHONE # E-MAIL  
 Architectural IS design PLLC David Sears, AIA 9987 (919)833.5400 david@isdesignpllc.com  
 Civil \_\_\_\_\_  
 Electrical Align Engineering Rick Copeland, Jr., PE 36841 (919) 275.1935 rick@ae-nc.com  
 Fire Alarm \_\_\_\_\_  
 Plumbing Align Engineering Rick Copeland, Jr., PE 36841 (919) 275.1935 rick@ae-nc.com  
 Mechanical Align Engineering Nathan Romblad, PE 37491 (919) 275.1935 nathan@ae-nc.com  
 Sprinkler-Standpipe \_\_\_\_\_  
 Structural \_\_\_\_\_  
 Retaining Walls >5' High \_\_\_\_\_  
 Other \_\_\_\_\_  
 (\*Other\* should include firms and individuals such as truss, precast, pre-engineered, interior designers, etc.)

**2018 NC BUILDING CODE:**

New Building  Addition  Phased Construction Shell/Core  
 Shell/ Core  1st Time Interior Completion

**2018 NC EXISTING BUILDING CODE:**

Prescriptive  Repair  Chapter 14  Alteration Level I  Alteration Level II  
 Alteration Level III  Historic Property  Change of Use

CONSTRUCTED: (date) 1977 CURRENT OCCUPANCY(S) (Ch. 3): MERCANTILE & BUSINESS  
 RENOVATED: (date) 2021 PROPOSED OCCUPANCY(S) (Ch. 3): MERCANTILE, BUSINESS & ASSEMBLY (A-2)

OCCUPANCY CATEGORY (Table 1604.5):

Current:  I  II  III  IV  
 Proposed:  I  II  III  IV

**BASIC BUILDING DATA**

Construction Type:  I-A  I-B  II-A  II-B  III-A  III-B  IV  V-A  V-B  
 Sprinklers:  YES  NO  PARTIAL  NFPA 13  NFPA 13R  NFPA 13D

Standpipes:  NO  YES CLASS:  I  II  III  Wet  Dry

Primary Fire District:  YES  NO Flood Hazard Area:  YES  NO

Special Inspections Required:  YES (CONTACT THE LOCAL INSPECTION JURISDICTION FOR REQUIREMENTS AND PROCEDURES)  
 NO

**Gross Building Area Table**

FLOOR	EXISTING (SQ FT)	NEW (SQ FT)	SUB-TOTAL
4th Floor			
3rd Floor			
2nd Floor			
Mezzanine			
1st Floor			
Ground Floor	12,567	0	12,567
Basement			
TOTAL	12,567	0	12,567

Area of Work 3,493 SF (TOTAL INCLUDING ALL DISCIPLINES)

**ALLOWABLE AREA**

Primary Occupancy Classification(s):

Assembly:  A-1  A-2  A-3  A-4  A-5

Business  Educational  Factory-Industrial  F-1  F-2

Mercantile  Residential  R-1  R-2  R-3  R-4

High Hazard:  H-1  H-2  H-3  H-4  H-5

Institutional:  I-1  I-2  I-3  I-4

I-3 USE CONDITION:  1  2  3  4  5

Storage:  S-1  S-2  High-piled

S-1 SPECIAL CONDITIONS:  Repair Garage

S-2 SPECIAL CONDITIONS--Parking Garage:  Open  Enclosed

Utility and Miscellaneous

Accessory Occupancy Classification(s): Storage: 580 sf = 4.4%

Incidental Uses (Table 509): \_\_\_\_\_

Special Uses (Chapter 4 - List Code Sections): \_\_\_\_\_

Special Provisions: (Chapter 5 - List Code Sections): \_\_\_\_\_

Mixed Occupancy:  YES  NO Separation: 1 HR (for A-2 only) Exception: \_\_\_\_\_

NON-SEPARATED USE (508.3)  SEPARATED USE (508.4)

Actual Area of Occupancy A + Actual Area of Occupancy B < 1

Allowable Area of Occupancy A Allowable Area of Occupancy B

+ ..... = ..... < 100

STORY NO.	DESCRIPTION AND USE	(A) BLDG AREA PER STORY (ACTUAL)	(B) TABLE 506.2* AREA	(C) AREA FOR FRONTAGE INCREASE <sup>1)</sup>	(D) ALLOWABLE AREA PER STORY OR UNLIMITED <sup>2)</sup>

- 1) Frontage area increases from Section 506.2 are computed thus:  
 a. Perimeter which fronts a public way or open space having 20 feet minimum width = \_\_\_\_\_ (F)  
 b. Total Building Perimeter = \_\_\_\_\_ (P)  
 c. Ratio (F/P) = \_\_\_\_\_ (F/P)  
 d. W = Minimum width of public way = \_\_\_\_\_ (W)  
 e. Percent of frontage increase If = 100 [F/P - 0.25] x W/30 = \_\_\_\_\_ (%)  
 2) Unlimited area applicable under conditions of Section 507.  
 3) Maximum Building Area = total number of stories in the building x D (maximum 3 stories) (506.2).  
 4) The maximum area of open parking garages must comply with Table 406.5.4. The maximum area of air traffic control towers must comply with Table 412.3.1.  
 5) Frontage increase is based on the unspinklered area value in Table 506.2.

**ALLOWABLE HEIGHT**

ALLOWABLE HEIGHT	SHOWN ON PLANS	CODE REFERENCE
Building Height in Feet (Table 504.3)		
Building Height in Stories (Table 504.4)		

1) Provide code reference if the "Shown on Plans" is based on Table 504.3 or 504.4.

**FIRE PROTECTION REQUIREMENTS**

BUILDING ELEMENT	FIRE SEPARATION DISTANCE (FEET)	REGD	RATING PROVIDED (W/ REDUCTION)	DETAIL # AND SHEET #	DESIGN # FOR RATED ASSEMBLY	SHEET # FOR RATED PENETRATION	SHEET # FOR RATED JOINTS
Structural Frame, including columns, girders, trusses		0	0				
Bearing Walls							
Exterior							
North	N/A						
East	N/A						
West	N/A						
South	N/A						
Interior							
Nonbearing Walls and Partitions							
Exterior walls							
North	>30'	0	0				
East	>30'	N/A					
West	>30'	N/A					
South	>30'	0	0				
Interior walls and partitions		0	0				
Floor Construction							
Including supporting beams and joists		N/A					
Floor Ceiling Assembly		0	0				
Columns Supporting Floors		N/A					
Roof Construction, including supporting beams and joists		0	0				
Roof Ceiling Assembly		0	0				
Columns Supporting Roof		0	0				
Shaft Enclosures - Exit		N/A					
Shaft Enclosures - Other		N/A					
Corridor Separation		0	0				
Occupancy/Fire Barrier Separation	1	1	G-5,6,7 U419,V497 & G-8 C,J-D-0006				
Party/Fire Wall Separation		N/A					
Smoke Barrier Separation		N/A					
Smoke Partition		N/A					
Tenant/Dwelling Unit/ Sleeping Unit Separation		0	0				
Incidental Use Separation		N/A					

\* Indicate section number permitting reduction

**PERCENTAGE OF WALL OPENING CALCULATIONS**

FIRE SEPARATION DISTANCE (FEET) FROM PROPERTY LINES	DEGREE OF OPENINGS PROTECTION (TABLE 705.8)	ALLOWABLE AREA	ACTUAL SHOWN ON PLANS (%)

**LIFE SAFETY SYSTEM REQUIREMENTS**

Emergency Lighting:  YES  NO  
 Exit Signs:  YES  NO  
 Fire Alarm:  YES  NO  
 Smoke Detection Systems:  YES  NO  
 Carbon Monoxide Detection:  YES  NO

**LIFE SAFETY PLAN REQUIREMENTS**

- Life Safety Plan Sheet #: G-2
- Fire and/or smoke rated wall locations (Chapter 7)
  - Assumed and real property line locations (if not on the site plan)
  - Exterior wall opening area with respect to distance to assumed property lines (705.8)
  - Occupancy Use for each area as it relates to occupant load calculation (Table 1004.1.2)
  - Occupant loads for each area
  - Exit access travel distances (1017)
  - Exit Sign locations (1013)
  - Common path of travel distances (Tables 1006.2.1 & 1006.3.2(1))
  - Dead end lengths (1020.4)
  - Clear exit widths for each exit door
  - Maximum calculated occupant load capacity each exit door can accommodate based on egress width (1005.3)
  - Actual occupant load for each exit door
  - A separate schematic plan indicating where fire rated floor/ceiling and/or roof structure is provided for purposes of occupancy separation
  - Location of doors with panic hardware (1010.1.10)
  - Location of doors with delayed egress locks and the amount of delay (1010.1.9.7)
  - Location of doors with electromagnetic egress locks (1010.1.9.9)
  - Location of doors equipped with hold-open devices
  - Location of emergency escape windows (1030)
  - The square footage of each fire area (202)
  - The square footage of each smoke compartment for Occupancy Classification I-2 (407.5)
  - Note any code exceptions or table notes that may have been utilized regarding the items above

**ACCESSIBLE DWELLING UNITS (SECTION 1107)**

TOTAL UNITS	ACCESSIBLE UNITS REQUIRED	ACCESSIBLE UNITS PROVIDED	TYPE A UNITS REQUIRED	TYPE A UNITS PROVIDED	TYPE B UNITS REQUIRED	TYPE B UNITS PROVIDED	TOTAL ACCESSIBLE UNITS PROVIDED

**ACCESSIBLE PARKING (SECTION 1106)**

LOT OR PARKING AREA	TOTAL # OF PARKING SPACES REQUIRED	TOTAL # OF ACCESSIBLE SPACES PROVIDED	# OF ACCESSIBLE SPACES PROVIDED		TOTAL # ACCESSIBLE PROVIDED
			REGULAR WITH 5' ACCESS AISLE	8' ACCESS AISLE	
TOTAL					

**PLUMBING FIXTURE REQUIREMENTS (TABLE 2902.1)**

SPACE	EXISTG	WATERCLOSETS			URINALS			LAVATORIES			SHOWERS		DRINKING FOUNTAINS	
		MALE	FEMALE	UNSEX	MALE	FEMALE	UNSEX	MALE	FEMALE	UNSEX	TUBS	REGULAR	ACCESSIBLE	
NEW	1	1			0	1	1						0	0
REGD	1	1			0	1	1							

**SPECIAL APPROVALS**

Special approval: (Local Jurisdiction, Department of Insurance, OSC, DPI, DHHS, etc., describe below)

**2018 APPENDIX B**  
**BUILDING CODE SUMMARY FOR ALL COMMERCIAL PROJECTS**  
 STRUCTURAL DESIGN  
 (PROVIDE ON THE STRUCTURAL SHEETS IF APPLICABLE)

**DESIGN LOADS:**

Importance Factors: Wind (IW)  1.0  
 Snow (IS)  0.8  1.0  1.1  1.2  
 Seismic (IE)  1.0  1.25  1.5

Live Loads: Roof \_\_\_\_\_ psf  
 Mezzanine \_\_\_\_\_ psf  
 Floor \_\_\_\_\_ psf

Ground Snow Load: \_\_\_\_\_ psf

Wind Load: Basic Wind Speed \_\_\_\_\_ mph (ASCE-7)  
 Exposure Category  B  C  D

**SEISMIC DESIGN CATEGORY:**  A  B  C  D

Provide the following Seismic Design Parameters:

Occupancy Category (Table 1604.5)  I  II  III  IV

Spectral Response Acceleration SS \_\_\_\_\_ %g S1 \_\_\_\_\_ %g

Site Classification (ASCE 7)  A  B  C  D  E  F

Data Source:  FIELD TEST  PRESUMPTIVE  HISTORICAL DATA

**Basic structural system**

BEARING WALL  DUAL W/ SPECIAL MOMENT FRAME

BUILDING FRAME  DUAL W/ INTERMEDIATE R/C OR SPECIAL FRAME

MOMENT FRAME  INVERTED PENDULUM

**Analysis Procedure:**

SIMPLIFIED

EQUIVALENT LATERAL FORCE

DYNAMIC

Architectural, Mechanical, Components anchored?  YES  NO

LATERAL DESIGN CONTROL:  EARTHQUAKE  WIND

**SOIL BEARING CAPACITIES:**

FIELD TEST (Provide copy of test report) \_\_\_\_\_ psf

PRESUMPTIVE BEARING CAPACITY \_\_\_\_\_ psf

PILE size, type, and capacity \_\_\_\_\_

**ENERGY SUMMARY**

**ENERGY REQUIREMENTS:**

The following data shall be considered minimum and any special attribute required to meet the energy code shall also be provided. Each Designer shall furnish the required portions of the project information for the plan data sheet. If performance method, state the annual energy cost for the standard reference design vs annual energy cost for the proposed design.

Existing building envelope complies with code:  YES (THE REMAINDER OF THIS SECTION IS NOT APPLICABLE)  
 NO

Exempt Building: Provide code or statutory reference:  YES  NO

Climate Zone:  3A  4A  5A

**Method of Compliance:**

ENERGY CODE: PERFORMANCE

ENERGY CODE: PERSCRIPTIVE

ASHRAE 90.1: PERFORMANCE

ASHRAE 90.1: PERSCRIPTIVE

OTHER: PERFORMANCE (If "Other" specify source here)

**2018 APPENDIX B**  
**BUILDING CODE SUMMARY FOR ALL COMMERCIAL PROJECTS**  
 MECHANICAL DESIGN  
 (PROVIDE ON THE MECHANICAL SHEETS IF APPLICABLE)

**MECHANICAL SYSTEMS, SERVICE SYSTEMS AND EQUIPMENT**

**MECHANICAL SUMMARY**

**Thermal Zone**

winter dry bulb: \_\_\_\_\_  
 summer dry bulb: \_\_\_\_\_

**Interior design conditions**

winter dry bulb: \_\_\_\_\_  
 summer dry bulb: \_\_\_\_\_  
 relative humidity: \_\_\_\_\_

**Building heating load:** \_\_\_\_\_

**Building cooling load:** \_\_\_\_\_

**Mechanical Spacing Conditioning System**

Unitary \_\_\_\_\_  
 description of unit: \_\_\_\_\_  
 heating efficiency: \_\_\_\_\_  
 cooling efficiency: \_\_\_\_\_  
 size category of unit: \_\_\_\_\_

Boiler \_\_\_\_\_  
 Size category, if oversized, state reason: \_\_\_\_\_

Chiller \_\_\_\_\_  
 Size category, if oversized, state reason: \_\_\_\_\_

**List equipment efficiencies:** \_\_\_\_\_

**2018 APPENDIX B**  
**BUILDING CODE SUMMARY FOR ALL COMMERCIAL PROJECTS**  
 ELECTRICAL DESIGN  
 (PROVIDE ON THE ELECTRICAL SHEETS IF APPLICABLE)

**ELECTRICAL SUMMARY**

**ELECTRICAL SYSTEM AND EQUIPMENT**

**Method of Compliance:**

ENERGY CODE: PERFORMANCE

ENERGY CODE: PERSCRIPTIVE

ASHRAE 90.1: PERFORMANCE

ASHRAE 90.1: PERSCRIPTIVE

OTHER: PERFORMANCE

**Lighting schedule (each fixture type)**

lamp type required in fixture \_\_\_\_\_

number of lamps in fixture \_\_\_\_\_

ballast type used in the fixture \_\_\_\_\_

number of ballasts in fixture \_\_\_\_\_

total wattage per fixture \_\_\_\_\_

total interior wattage specified vs. allowed (whole building or space by space) \_\_\_\_\_

total exterior wattage specified vs. allowed \_\_\_\_\_

























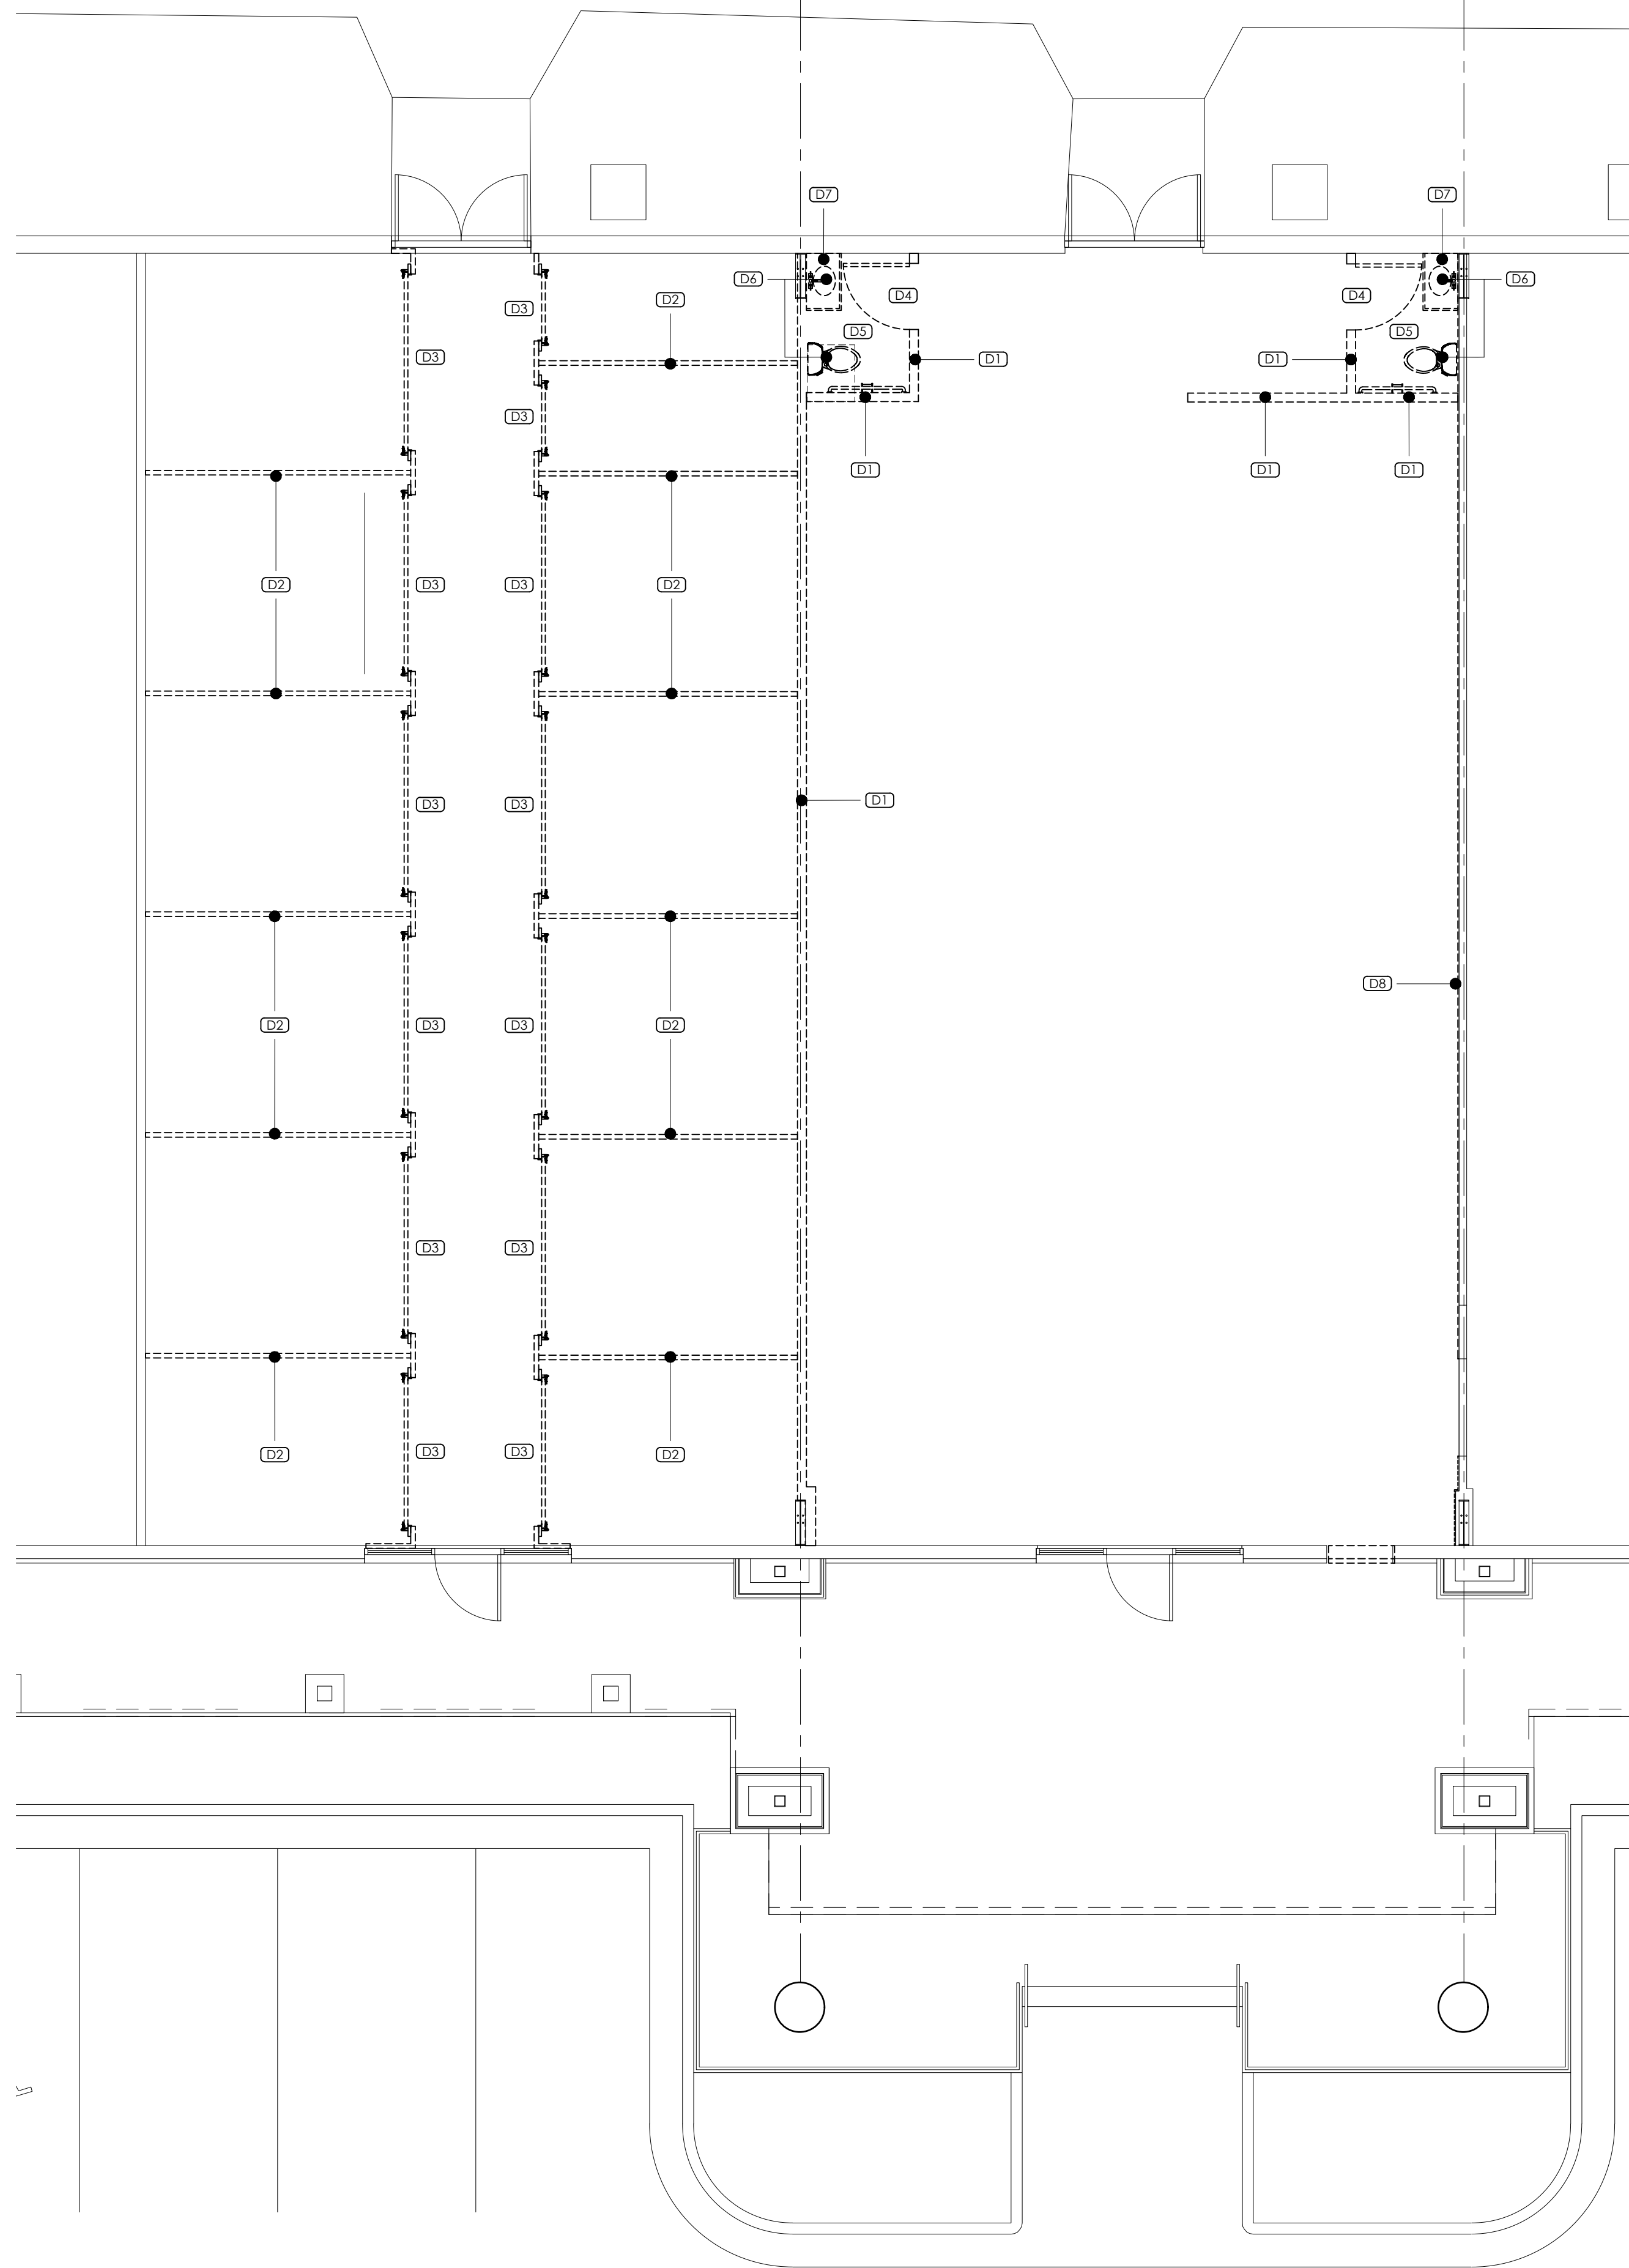

**01** DEMOLITION PLAN  
A-1 SCALE: 3/16"=1'-0"


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**02** FLOOR PLAN  
A-1 SCALE: 3/16"=1'-0"

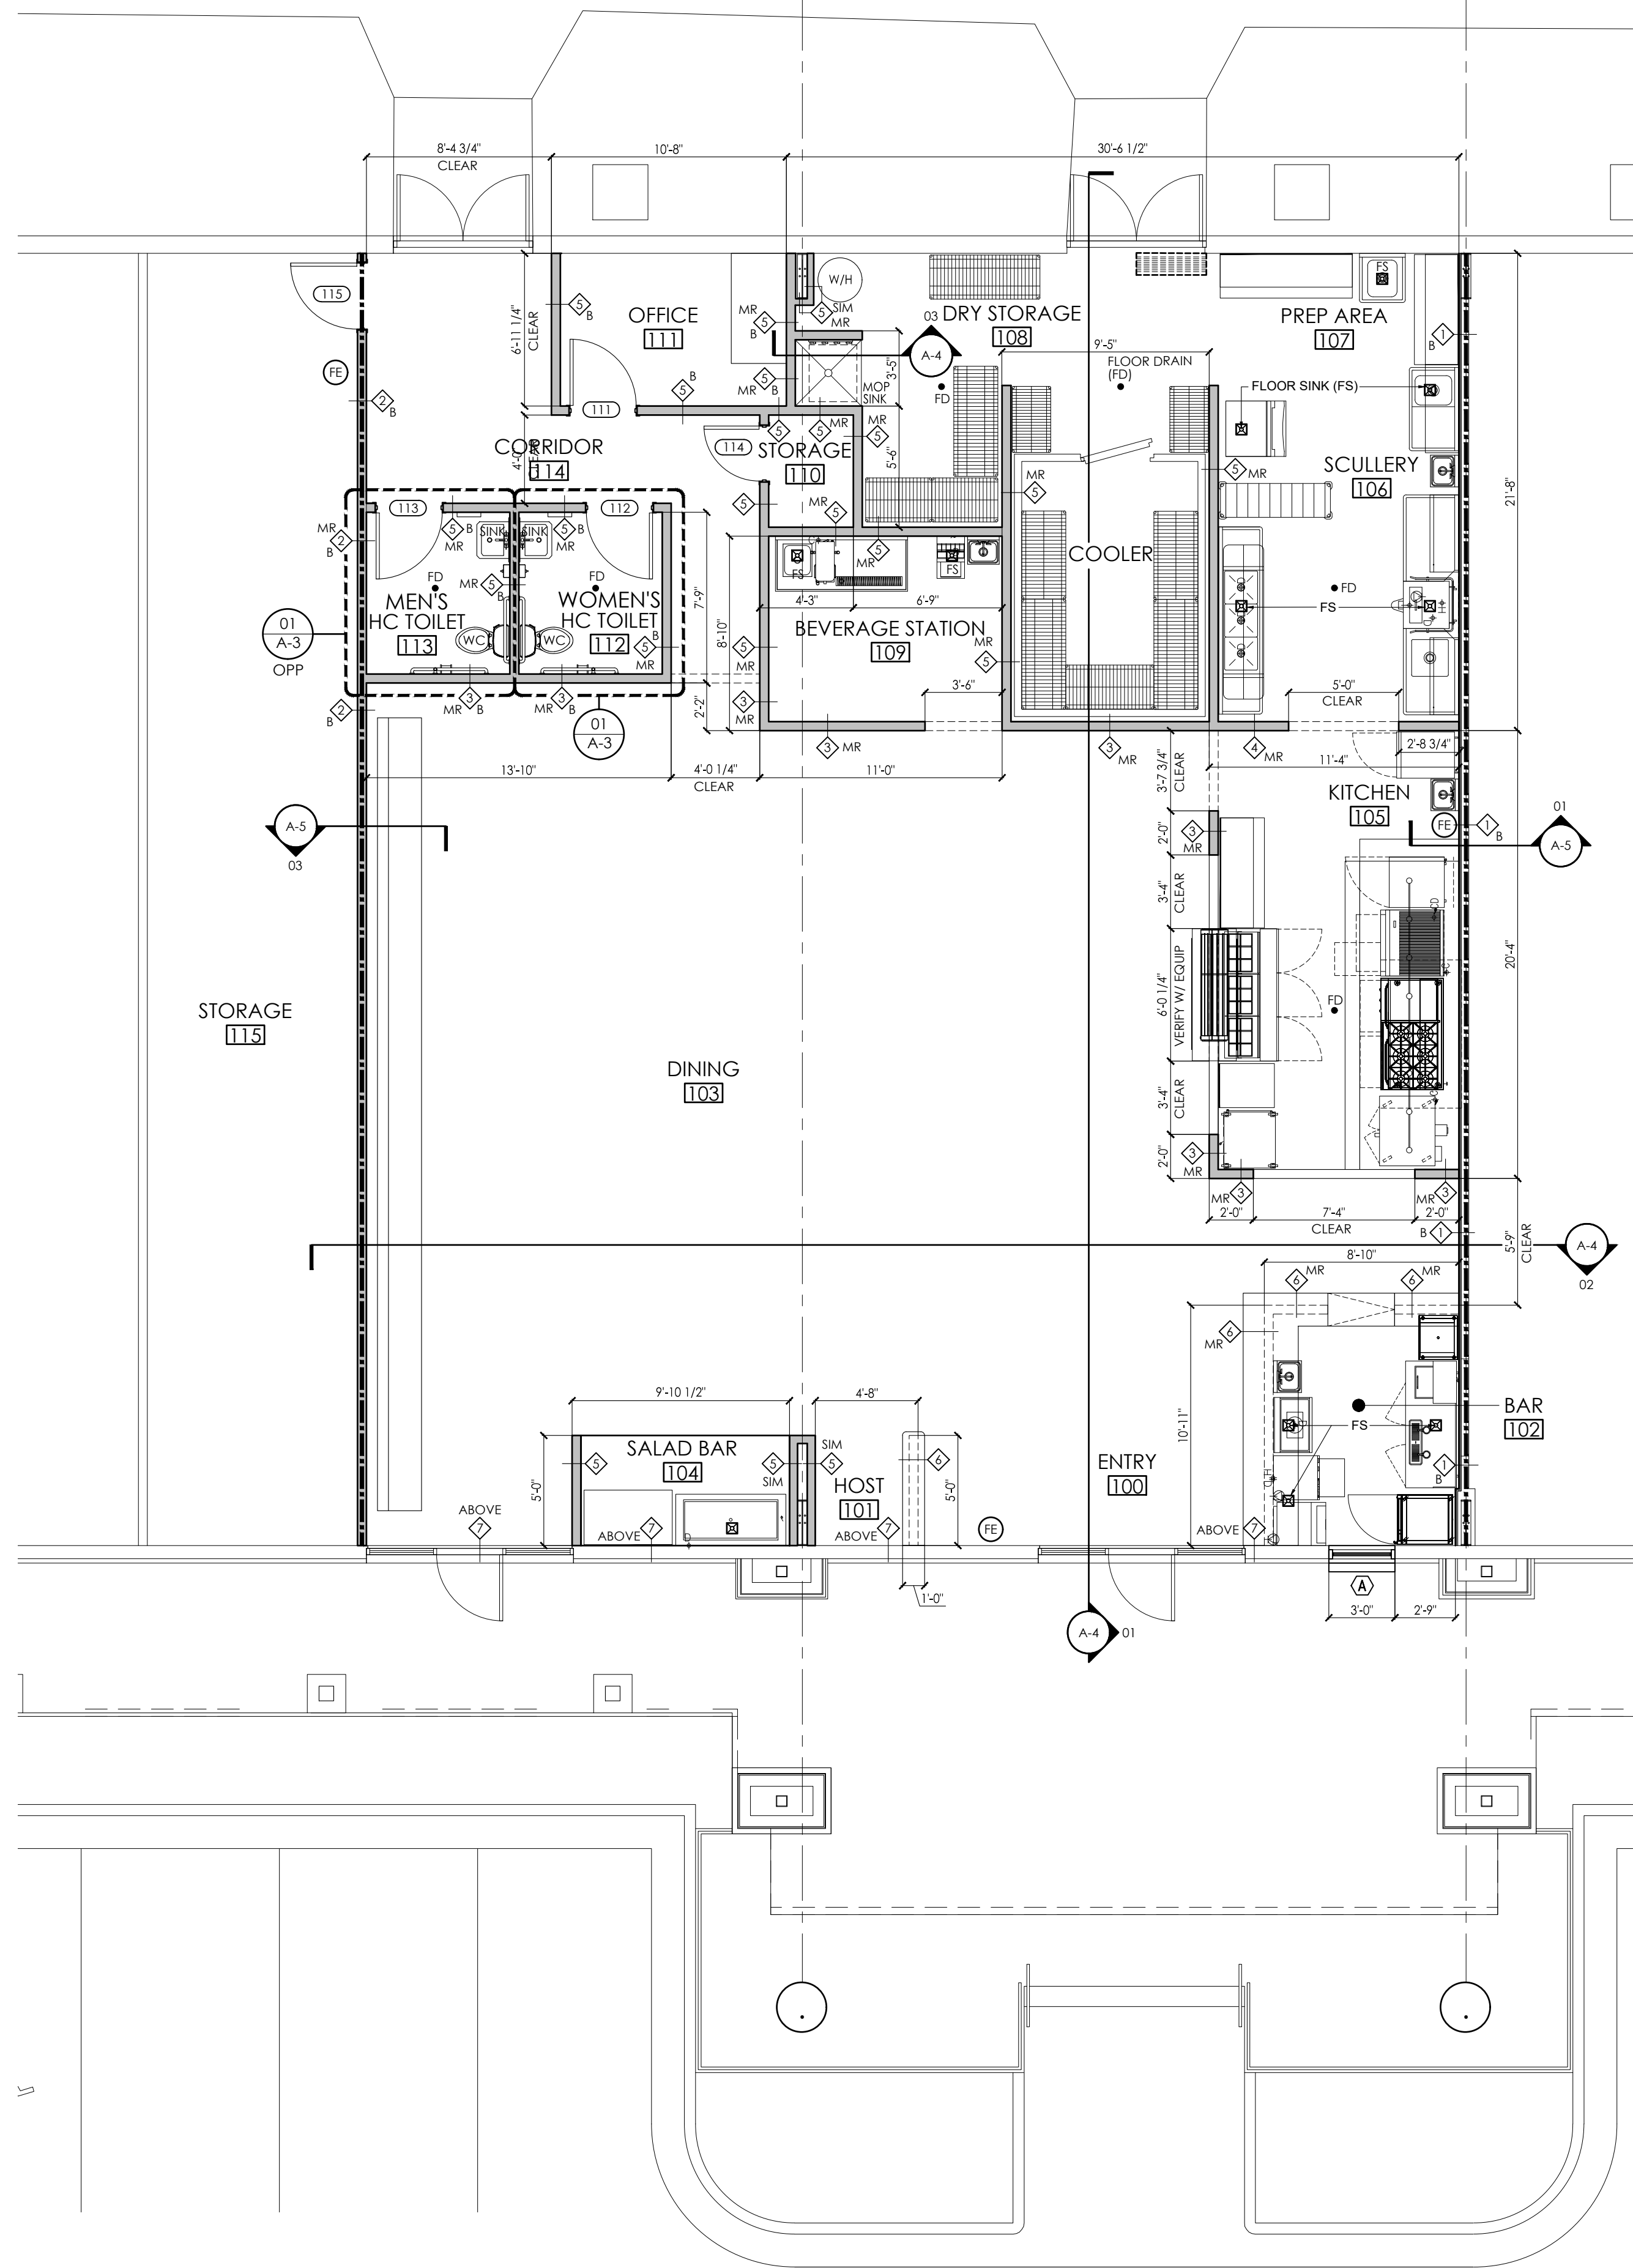
- SYMBOLS LEGEND**
- ==== INDICATES EXISTING PARTITIONS TO BE REMOVED
  - INDICATES EXISTING NON-RATED PARTITION
  - 1 HOUR RATED FIRE BARRIER, PROVIDE (2) LAYERS 5/8" GYPSUM WB ON PROJECT SIDE OF THE EXISTING WALL STUD FRAMING. SEE DETAIL 01/A-5 FOR WALL CONSTRUCTION AND DETAIL 02/A-5 FOR HEAD OF WALL DETAIL. UL DESIGN V497.
  - 1 HOUR RATE FIRE BARRIER, PROVIDE 5/8" GYPSUM WB ON EACH SIDE OF 3 5/8" METAL STUDS (20 GA.) @ 16" O.C. RUN WALL ASSEMBLY FROM THE FINISH FLOOR TO THE UNDERSIDE OF THE ROOFING ABOVE. SEE DETAIL 03/A-5. UL DESIGN U419.
  - NON-RATED PARTITION, PROVIDE 5/8" GYPSUM WB ON EACH SIDE OF 3 5/8" METAL STUDS (20 GA.) @ 16" O.C. RUN WALL ASSEMBLY FROM THE FINISH FLOOR TO THE UNDERSIDE OF THE ROOFING ABOVE. SEE DETAIL 04/A-5.
  - NON-RATED PARTITION, PROVIDE 5/8" GYPSUM WB ON EACH SIDE OF 3 5/8" METAL STUDS (25 GA.) @ 16" O.C. RUN WALL ASSEMBLY FROM THE FINISH FLOOR TO 10'-0" A.F.F. PROVIDE LATERAL BRACING TO STRUCTURE ABOVE AT 8'-0" O.C. MAX. SEE DETAIL 05/A-5.
  - NON-RATED PARTITION, PROVIDE 5/8" GYPSUM WB ON EACH SIDE OF 3 5/8" METAL STUDS (25 GA.) @ 16" O.C. RUN WALL ASSEMBLY FROM THE FINISH FLOOR TO 9'-0" A.F.F. PROVIDE LATERAL BRACING TO STRUCTURE ABOVE AT 8'-0" O.C. MAX. SEE DETAIL 05/A-5. AT SIM CONDITION, PROVIDE GYPSUM WB ON FINISH SIDE ONLY.
  - NON-RATED PARTITION, PROVIDE 5/8" GYPSUM WB ON EACH SIDE OF 3 5/8" METAL STUDS (25 GA.) @ 16" O.C. RUN WALL ASSEMBLY FROM THE FINISH FLOOR TO A HEIGHT SUCH THAT THE FINISHED COUNTERTOP IS AT 3'-6" A.F.F. FINISH THEME BY TENANT. INSTALL PONY WALL SUPPORT POST AT END. SEE DETAIL 05/A-3 & 06/A-5.
  - NON-RATED PARTITION, PROVIDE 5/8" GYPSUM WB ON INTERIOR SIDE OF EXISTING EXTERIOR WALL FRAMING TO THE TOP OF EXPOSED WALL WHERE NOT CURRENTLY INSTALLED. PROVIDE R-19 BATT INSULATION IF NOT CURRENTLY INSTALLED.
  - B PROVIDE SOUND BATTS IN WALL STUD CAVITIES FOR SOUND ATTENUATION WHERE INDICATED
  - MR PROVIDE MOISTURE RESISTANT GYPSUM WB FOR WALLS WITHIN BAR 102, KITCHEN 105, SCULLERY 106, PREP AREA 107, DRY STORAGE 108, BEVERAGE STATION 109, WOMEN'S HC TOILET 112 & MEN'S HC TOILET 113.
  - EXISTING DOOR TO REMAIN
  - NEW DOOR AND FRAME (SEE DOOR SCHEDULE)
  - EXISTING DOOR TO BE REMOVED
  - WALL MOUNTED FIRE EXTINGUISHER
  - EXISTING ELECTRICAL OUTLET TO REMAIN
  - EXISTING DATA TO REMAIN
  - EXISTING ELECTRICAL OUTLET TO BE REMOVED
  - EXISTING DATA TO BE REMOVED
  - NEW ELECTRICAL DUPLEX OUTLET
  - NEW ELECTRICAL QUAD OUTLET
  - NEW COMMUNICATIONS/DATA RECEPTACLE
  - NEW EXTERIOR CARRIAGE LIGHT FIXTURE - OWNER PROVIDED/CONTRACTOR INSTALLED
  - NEW INTERNALLY ILLUMINATED EXTERIOR MENU BOARD - OWNER PROVIDED/CONTRACTOR INSTALLED
  - NEW FLY FAN ABOVE DOOR - OWNER PROVIDED/CONTRACTOR INSTALLED

- DEMOLITION NOTES**
- D1 INDICATES PORTION OF EXISTING INTERIOR PARTITION TO BE REMOVED, REMOVE THE ENTIRE WALL ASSEMBLY AND ASSOCIATED ELECTRICAL COMPONENTS.
  - D2 INDICATES PORTION OF EXISTING INTERIOR STORAGE WALL DIVIDER PARTITIONS. COORDINATE WITH OWNER WHETHER TO SALVAGE FOR FUTURE USE.
  - D3 INDICATES PORTION OF EXISTING INTERIOR STORAGE ROOM ROLL UP DOOR. COORDINATE WITH OWNER WHETHER TO SALVAGE FOR FUTURE USE.
  - D4 INDICATES EXISTING DOOR AND FRAME TO BE REMOVED AND DISCARDED.
  - D5 INDICATES EXISTING FLOORING AND WALL BASE TO BE REMOVED AND DISCARDED. PREP FLOOR TO RECEIVE FLOORING
  - D6 INDICATES EXISTING PLUMBING FIXTURE / ACCESSORIES TO BE REMOVED AND DISCARDED.
  - D7 INDICATES EXISTING MILLWORK TO BE REMOVED AND DISCARDED.
  - D8 INDICATES EXISTING GYPSUM WB TO BE REMOVED ON PROJECT SIDE OF EXISTING DEMISING WALL.




JOB #:  
23HARVEYJOHNS

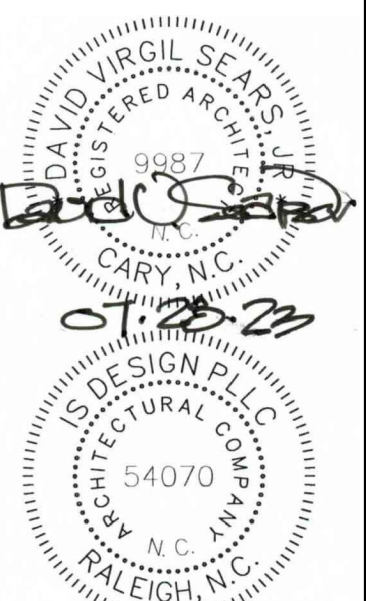DWG BY: DVS  
CHK BY: DVS  
DATE: 07/28/23  
REV NO DATE

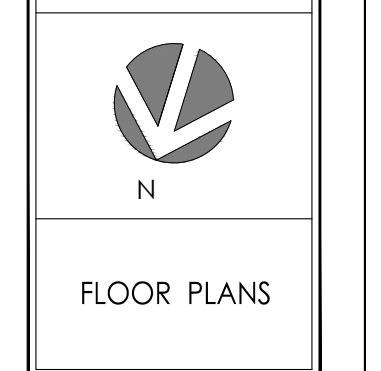




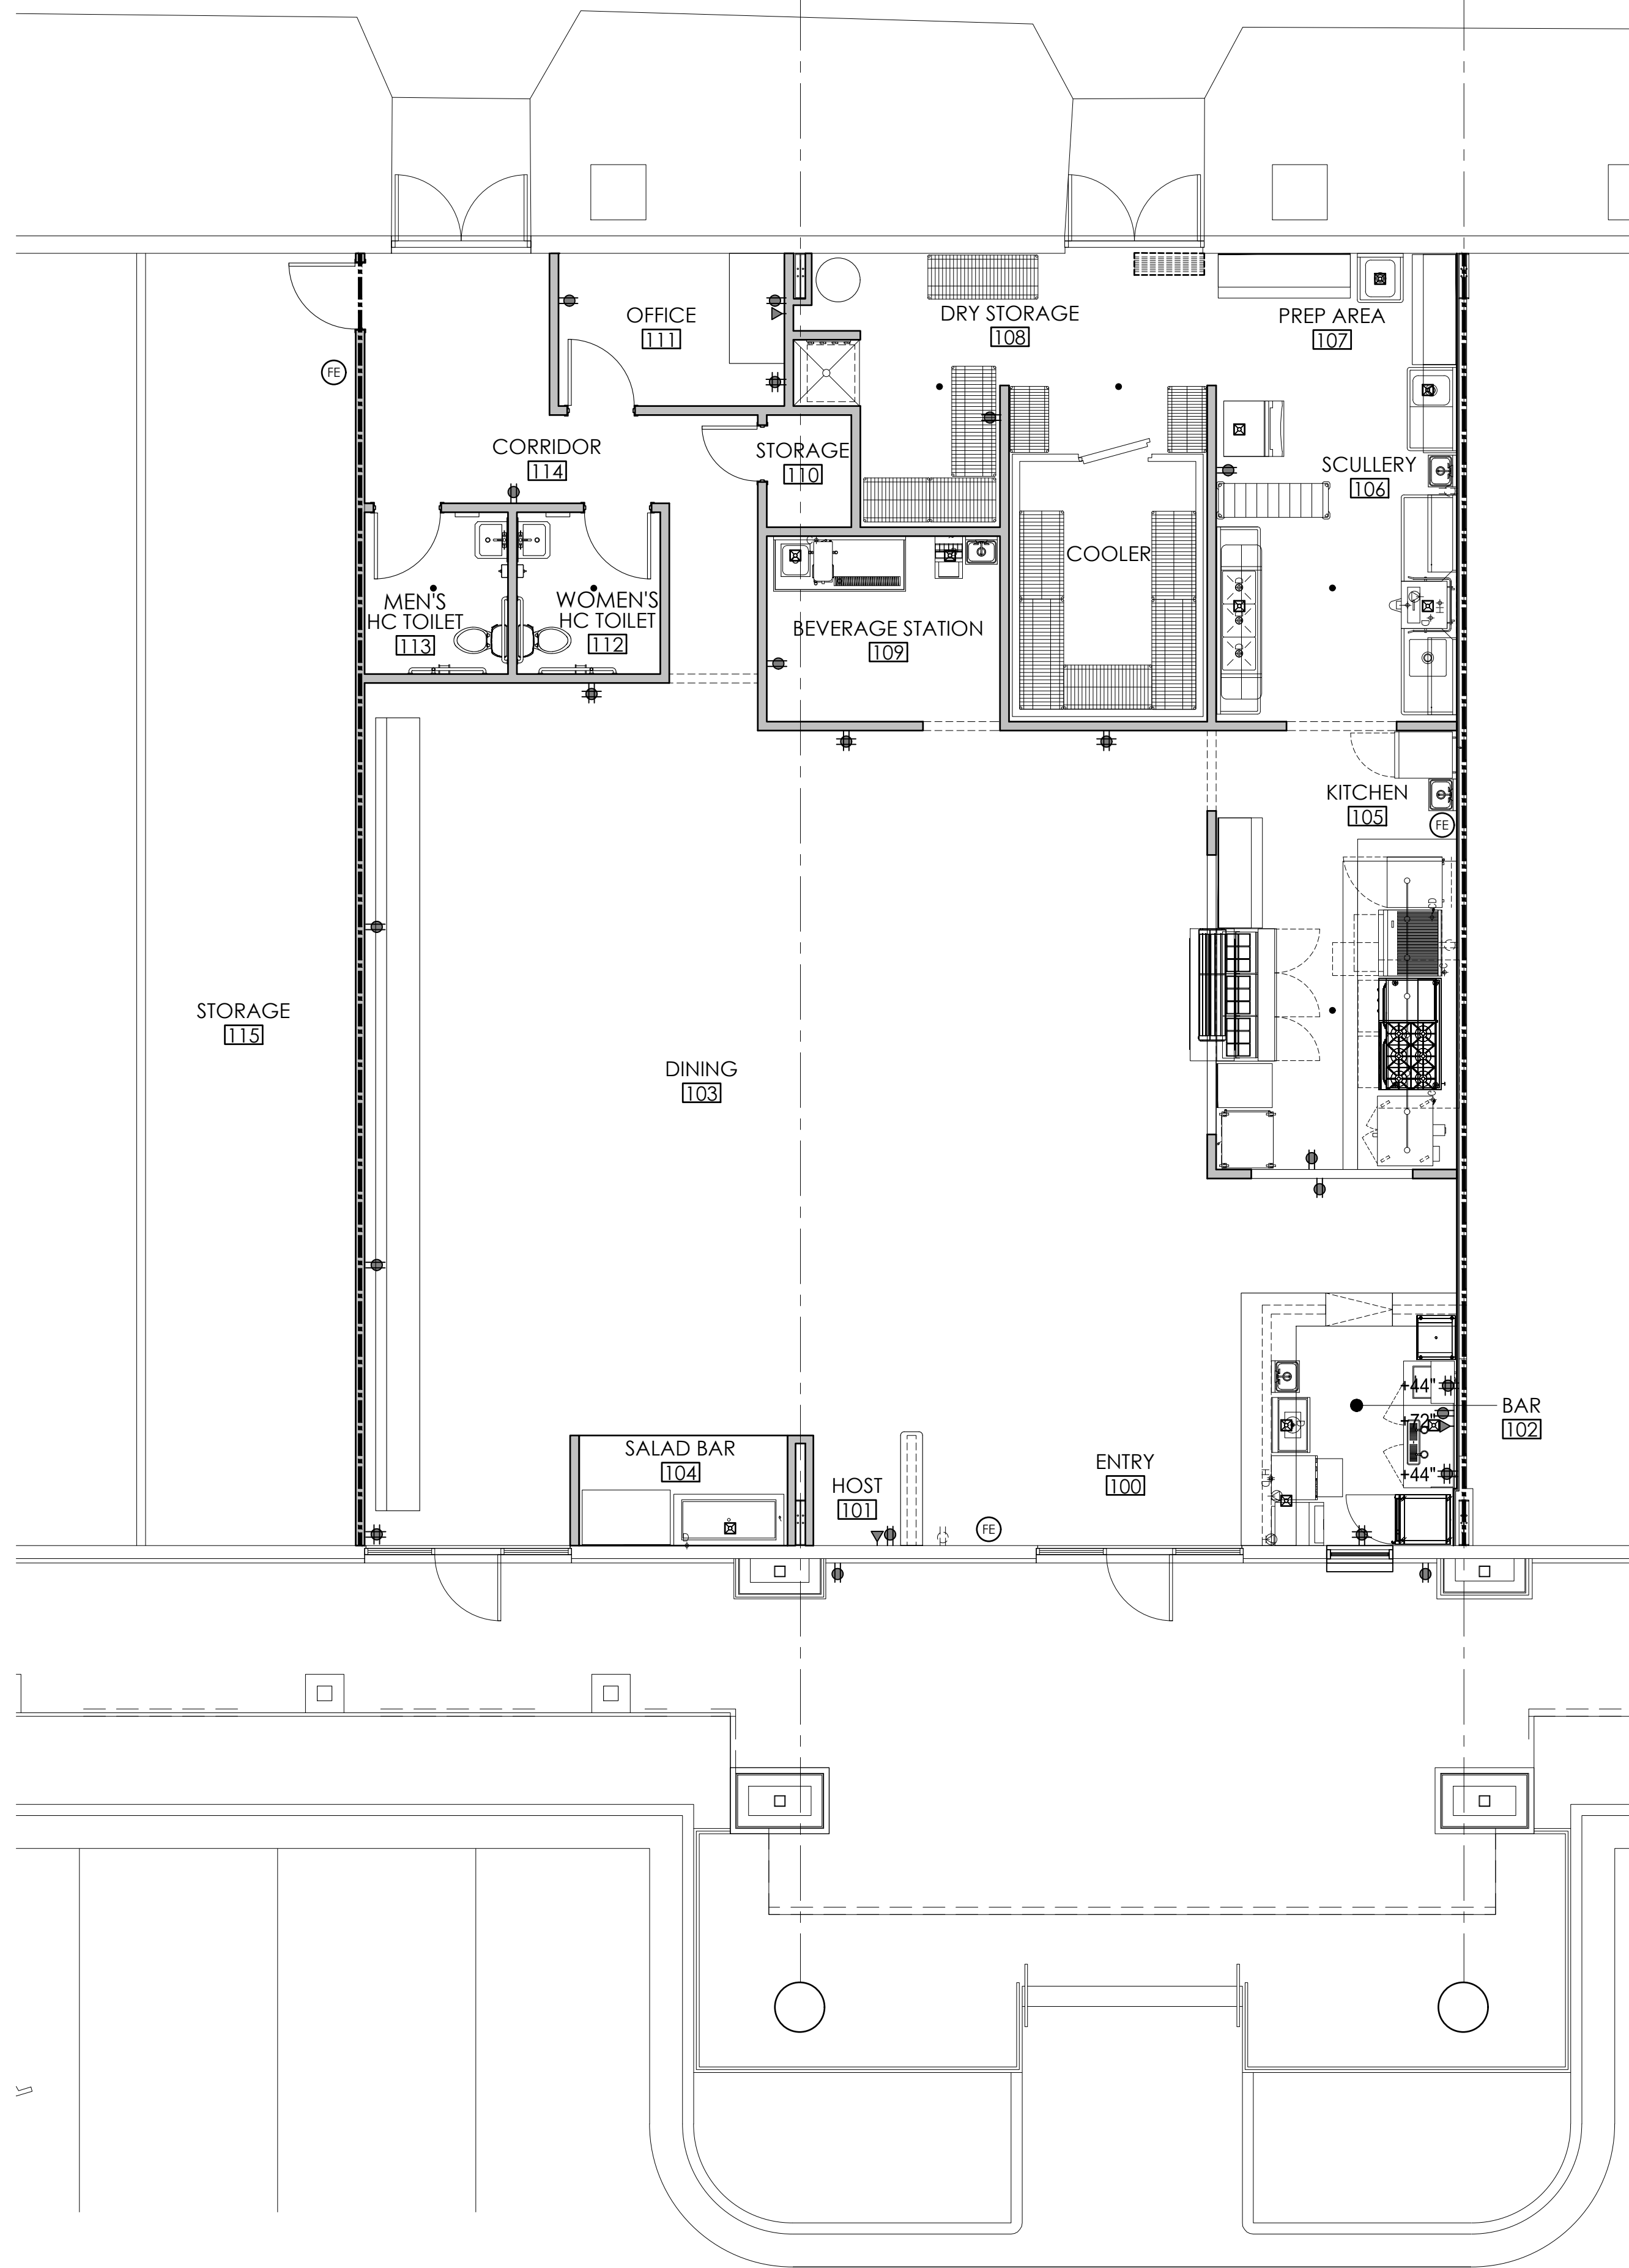


01 OUTLET FLOOR PLAN  
SCALE: 3/16"=1'-0"

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02 REFLECTED CEILING PLAN  
SCALE: 3/16"=1'-0"

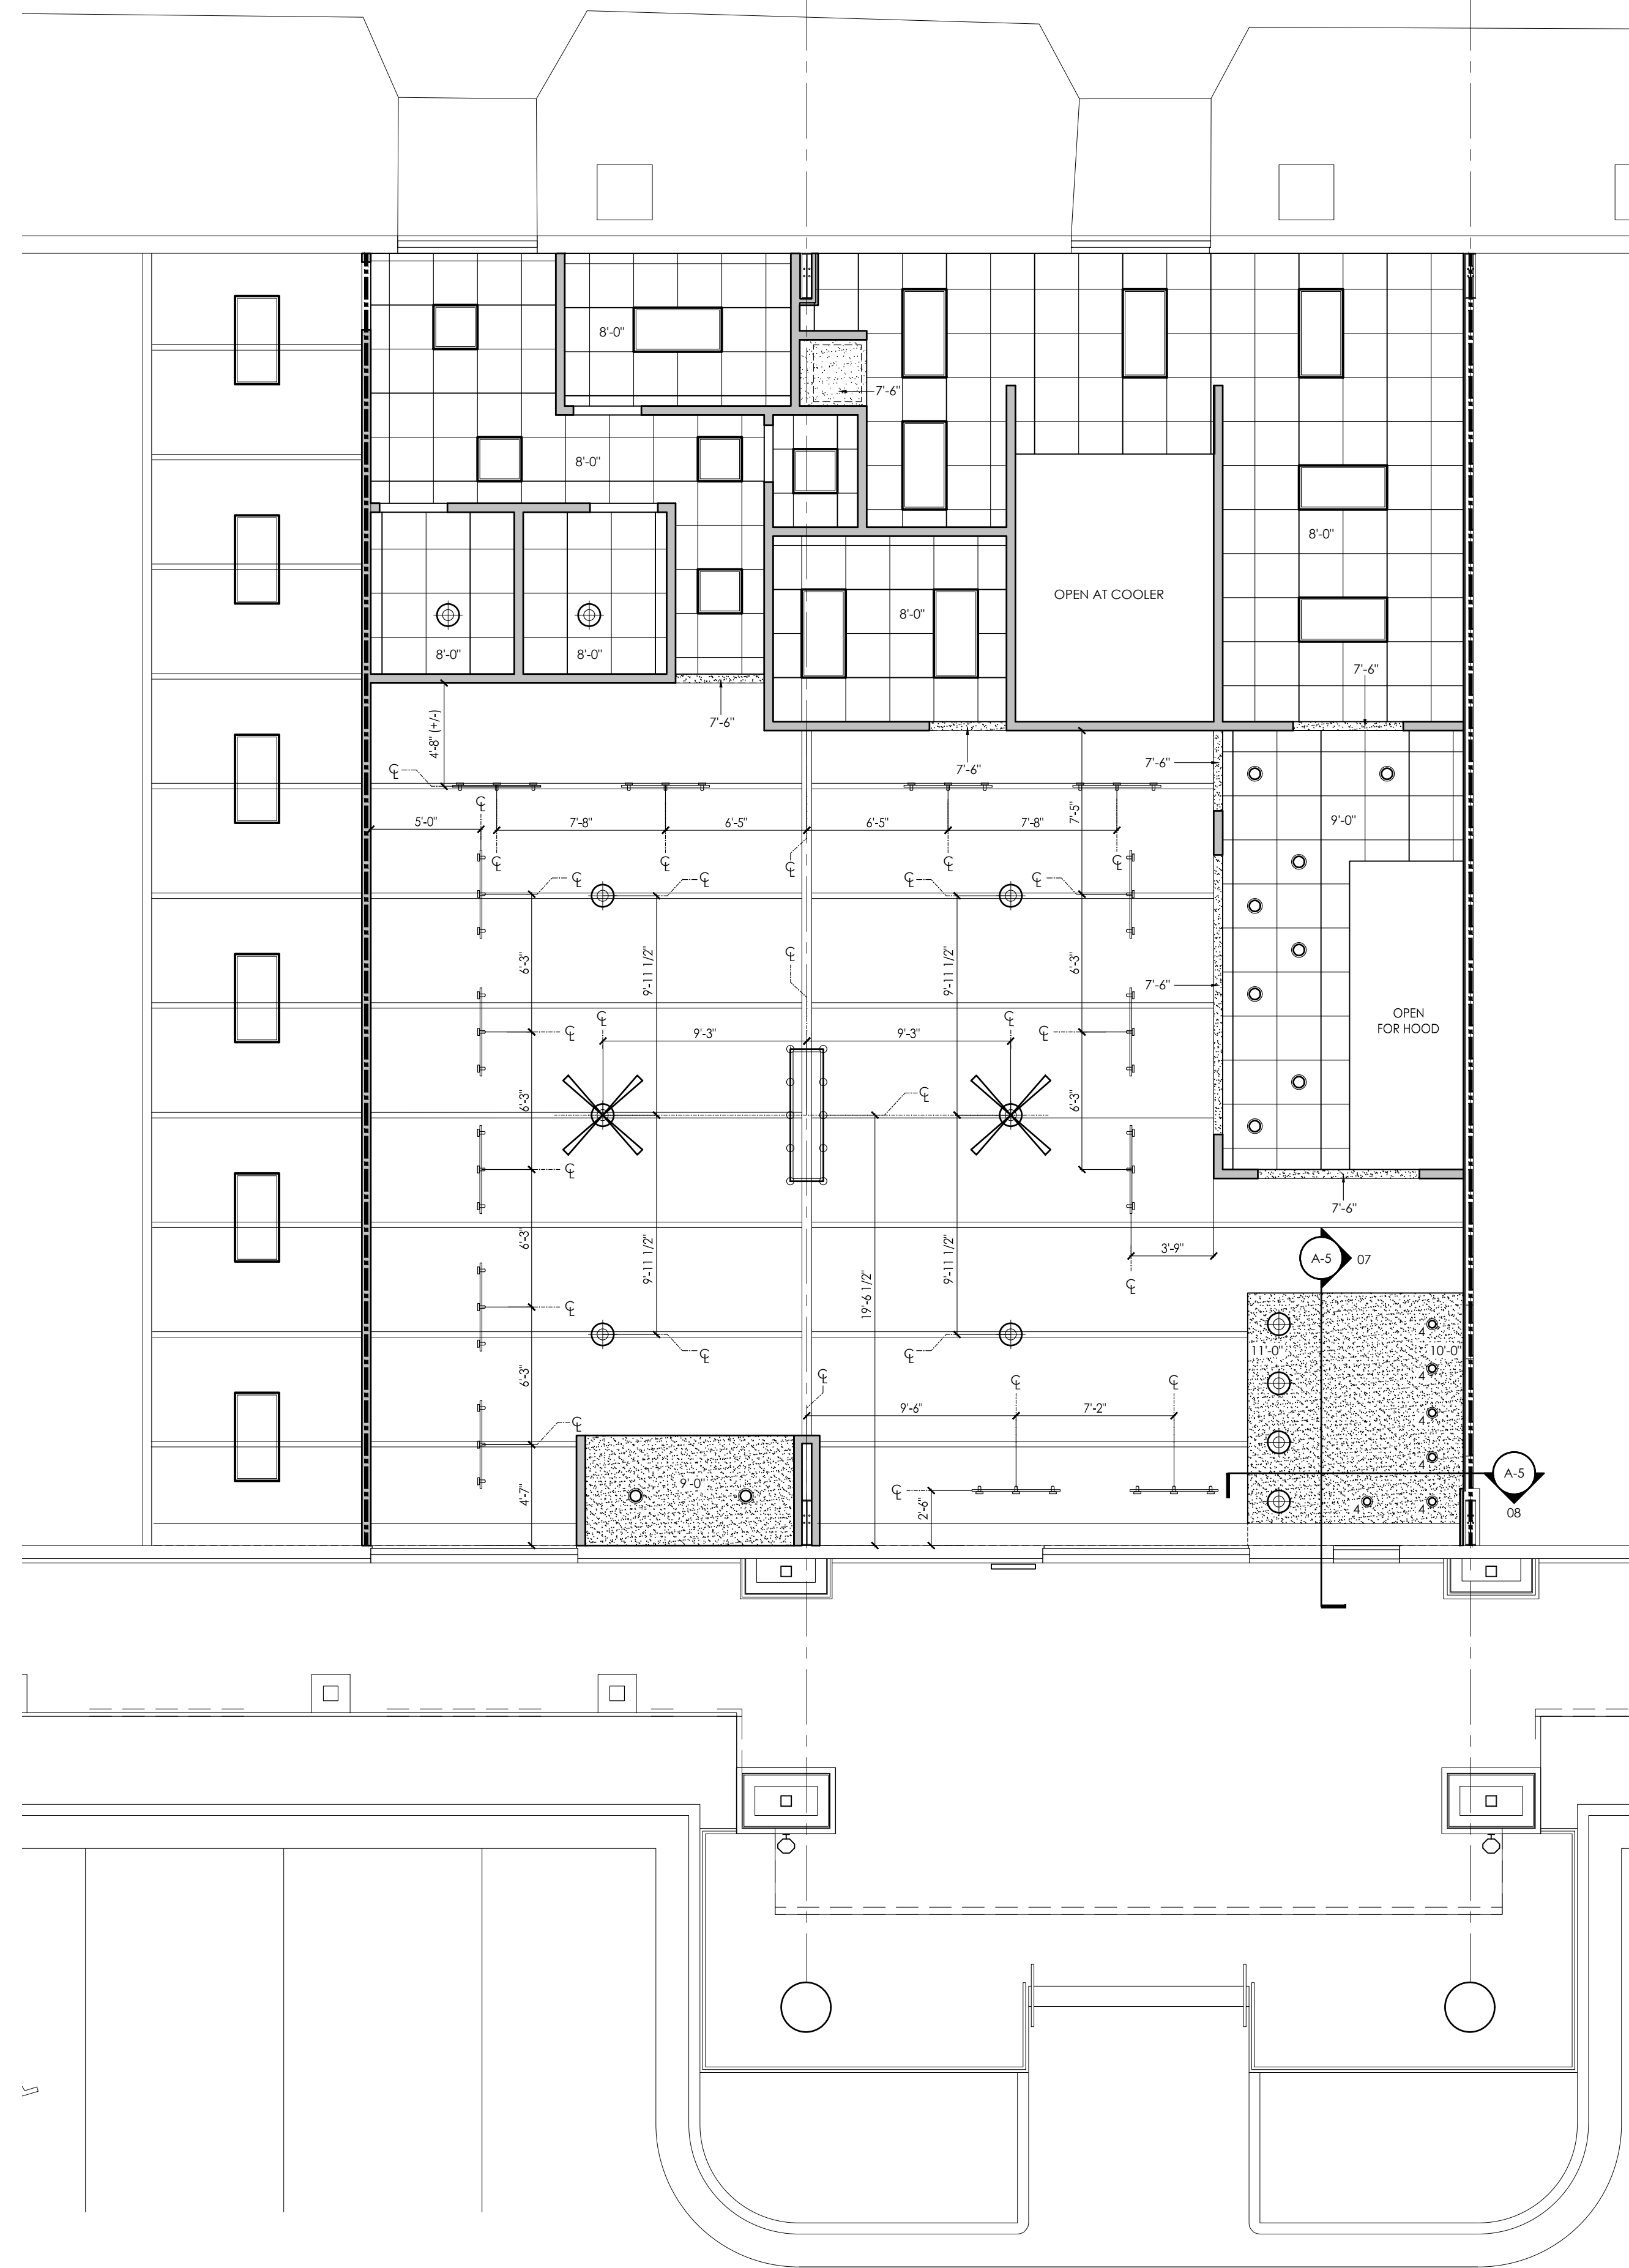
- SYMBOLS LEGEND**
- ==== INDICATES EXISTING PARTITIONS TO BE REMOVED
  - INDICATES EXISTING NON-RATED PARTITION
  - 1 HOUR RATED FIRE BARRIER, PROVIDE (2) LAYERS 5/8" GYPSUM WB ON EACH SIDE OF THE EXISTING WALL STUD FRAMING. SEE DETAIL 01/A-5 FOR WALL CONSTRUCTION AND DETAIL 02/A-5 FOR HEAD OF WALL DETAIL. UL DESIGN V497.
  - 1 HOUR RATE FIRE BARRIER, PROVIDE 5/8" GYPSUM WB ON EACH SIDE OF 3 5/8" METAL STUDS (20 GA.) @ 16" O.C. RUN WALL ASSEMBLY FROM THE FINISH FLOOR TO THE UNDERSIDE OF THE ROOFING ABOVE. SEE DETAIL 03/A-5. UL DESIGN U419.
  - NON-RATED PARTITION, PROVIDE 5/8" GYPSUM WB ON EACH SIDE OF 3 5/8" METAL STUDS (20 GA.) @ 16" O.C. RUN WALL ASSEMBLY FROM THE FINISH FLOOR TO THE UNDERSIDE OF THE ROOFING ABOVE. SEE DETAIL 04/A-5.
  - NON-RATED PARTITION, PROVIDE 5/8" GYPSUM WB ON EACH SIDE OF 3 5/8" METAL STUDS (25 GA.) @ 16" O.C. RUN WALL ASSEMBLY FROM THE FINISH FLOOR TO 9'-0" A.F.F. PROVIDE LATERAL BRACING TO STRUCTURE ABOVE AT 8'-0" O.C. MAX. SEE DETAIL 05/A-5. AT SIM CONDITION, PROVIDE GYPSUM WB ON FINISH SIDE ONLY.
  - NON-RATED PARTITION, PROVIDE 5/8" GYPSUM WB ON EACH SIDE OF 3 5/8" METAL STUDS (25 GA.) @ 16" O.C. RUN WALL ASSEMBLY FROM THE FINISH FLOOR TO A HEIGHT SUCH THAT THE FINISHED COUNTERTOP IS AT 3'-6" A.F.F. FINISH THEME BY OWNER. INSTALL PONY WALL SUPPORT POST AT END. SEE DETAIL 05/A-3 & 06/A-5.
  - NON-RATED PARTITION, PROVIDE 5/8" GYPSUM WB ON INTERIOR SIDE OF EXISTING EXTERIOR WALL FRAMING TO THE TOP OF EXPOSED WALL WHERE NOT CURRENTLY INSTALLED. PROVIDE R-19 BATT INSULATION IF NOT CURRENTLY INSTALLED.
  - B PROVIDE SOUND BATTS IN WALL STUD CAVITIES FOR SOUND ATTENUATION WHERE INDICATED
  - MR PROVIDE MOISTURE RESISTANT GYPSUM WB FOR WALLS WITHIN BAR 102, KITCHEN 105, SCULLERY 106, PREP AREA 107, DRY STORAGE 108, BEVERAGE STATION 109, WOMEN'S HC TOILET 112 & MEN'S HC TOILET 113.
  - EXISTING DOOR TO REMAIN
  - NEW DOOR AND FRAME (SEE DOOR SCHEDULE)
  - EXISTING DOOR TO BE REMOVED
  - WALL MOUNTED FIRE EXTINGUISHER
  - EXISTING ELECTRICAL OUTLET TO REMAIN
  - EXISTING DATA TO REMAIN
  - EXISTING ELECTRICAL OUTLET TO BE REMOVED
  - EXISTING DATA TO BE REMOVED
  - NEW ELECTRICAL DUPLEX OUTLET
  - NEW ELECTRICAL QUAD OUTLET
  - NEW COMMUNICATIONS/DATA RECEPTACLE
  - NEW EXTERIOR CARRIAGE LIGHT FIXTURE - OWNER PROVIDED/CONTRACTOR INSTALLED
  - NEW INTERNALLY ILLUMINATED EXTERIOR MENU BOARD - OWNER PROVIDED/CONTRACTOR INSTALLED
  - NEW FLY FAN ABOVE DOOR - OWNER PROVIDED/CONTRACTOR INSTALLED
  - NEW 2X4 LAY-IN LED LIGHT FIXTURE
  - NEW 2X2 LAY-IN LED LIGHT FIXTURE
  - NEW 6" RECESSED CAN LIGHT
  - NEW 4" RECESSED CAN LIGHT
  - NEW PENDANT LIGHT FIXTURE - OWNER PROVIDED/CONTRACTOR INSTALLED
  - NEW CEILING FAN - OWNER PROVIDED/ CONTRACTOR INSTALLED
  - NEW CHANDELIER LIGHT FIXTURE - OWNER PROVIDED/CONTRACTOR INSTALLED
  - NEW TRACK LIGHT SYSTEM - OWNER PROVIDED/ CONTRACTOR INSTALLED
  - NEW 2X2 CEILING GRID & ACOUSTIC CEILING TILE - PROVIDE WASHABLE VINYL WRAPPED GYPSUM WB PANELS AT ROOMS 105, 06, 107 & 108
  - NEW GYPSUM WB SOFFIT / CEILING



A Tenant Alteration for  
**HARVEY JOHNS STEAKHOUSE**  
1501 N. Raleigh Street, Suite G  
Angier, NC

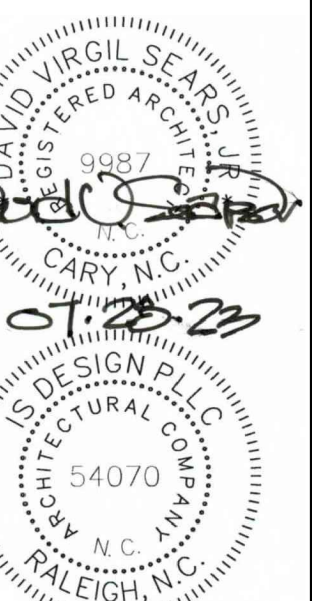JOB #:  
23HARVEYJOHNS

DWG BY: DVS  
CHK BY: DVS  
DATE: 07/28/23  
REV NO DATE

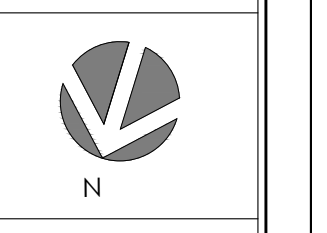

REFLECTED  
CEILING PLAN &  
OUTLET PLAN



SHEET NUMBER

**A-2**









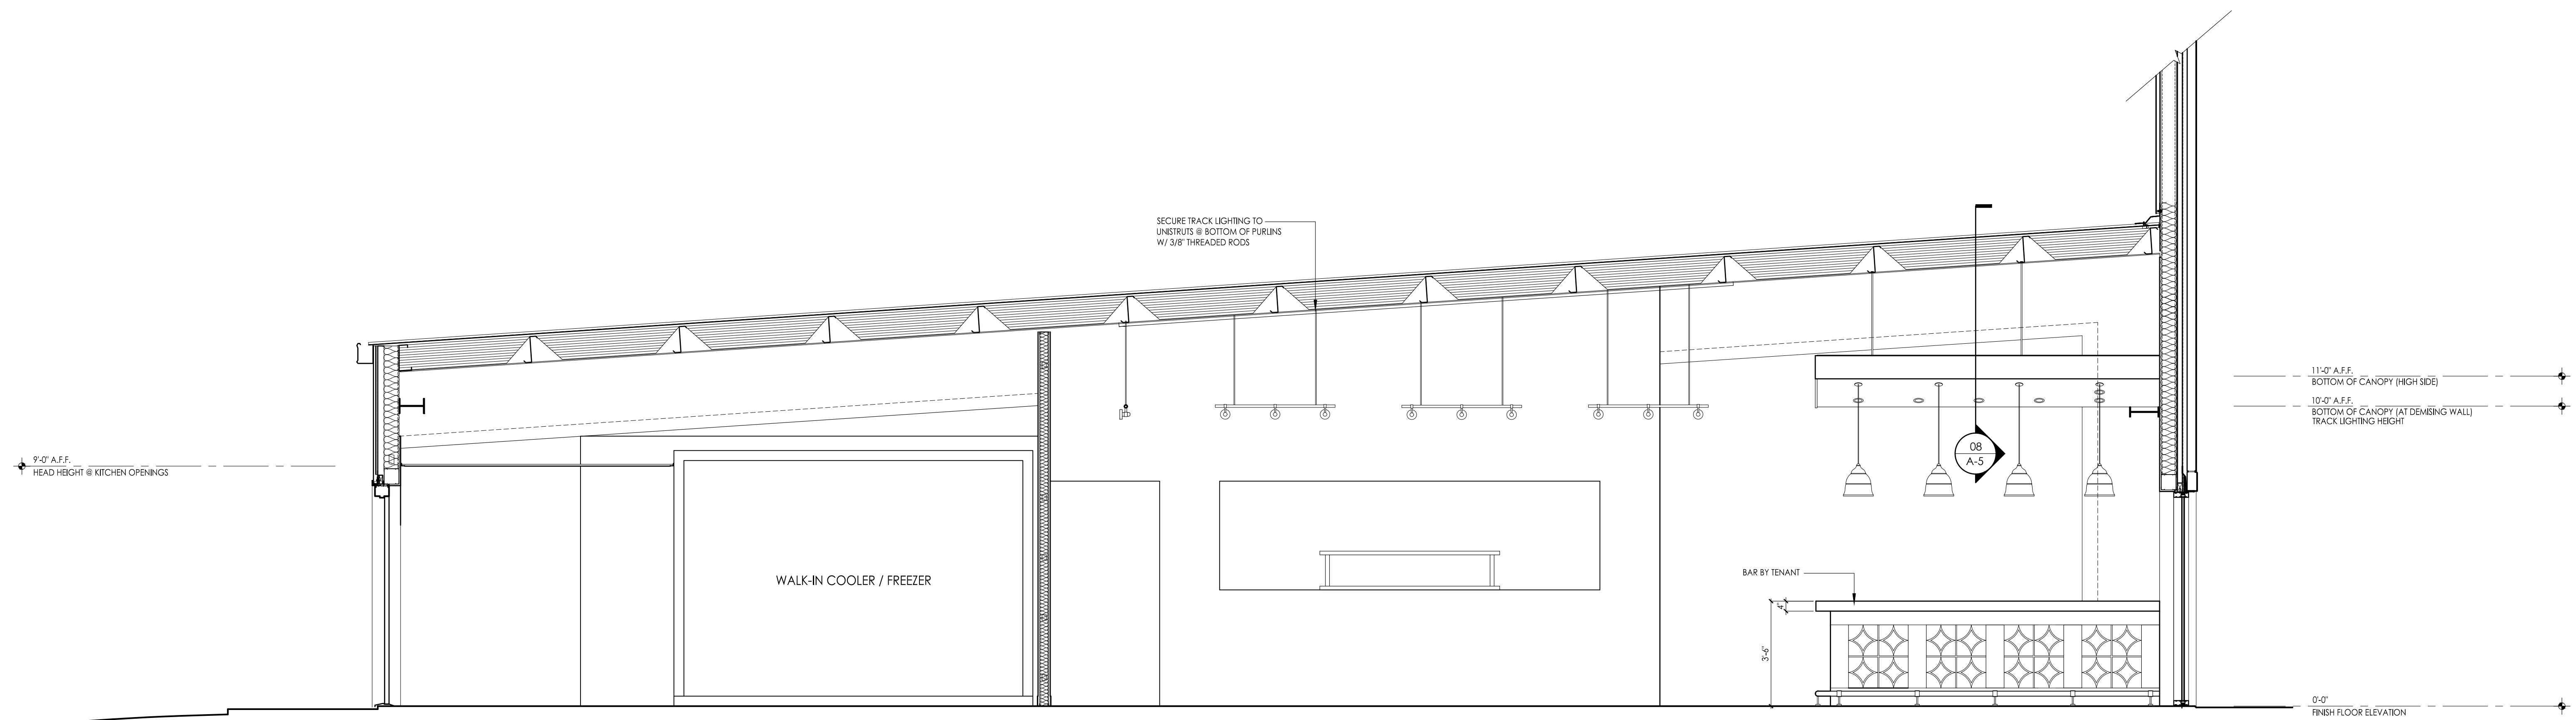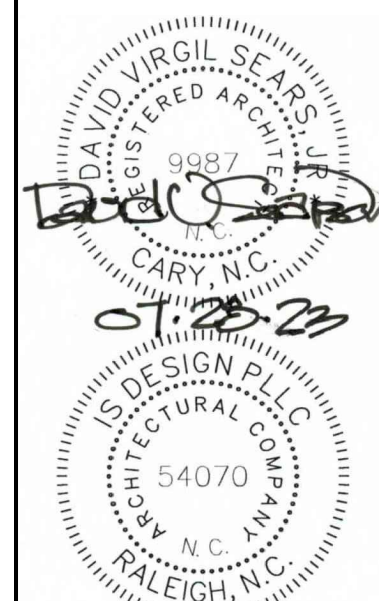

**01** BUILDING SECTION / INTERIOR ELEVATIONS  
 A-4 SCALE: 3/8"=1'-0"

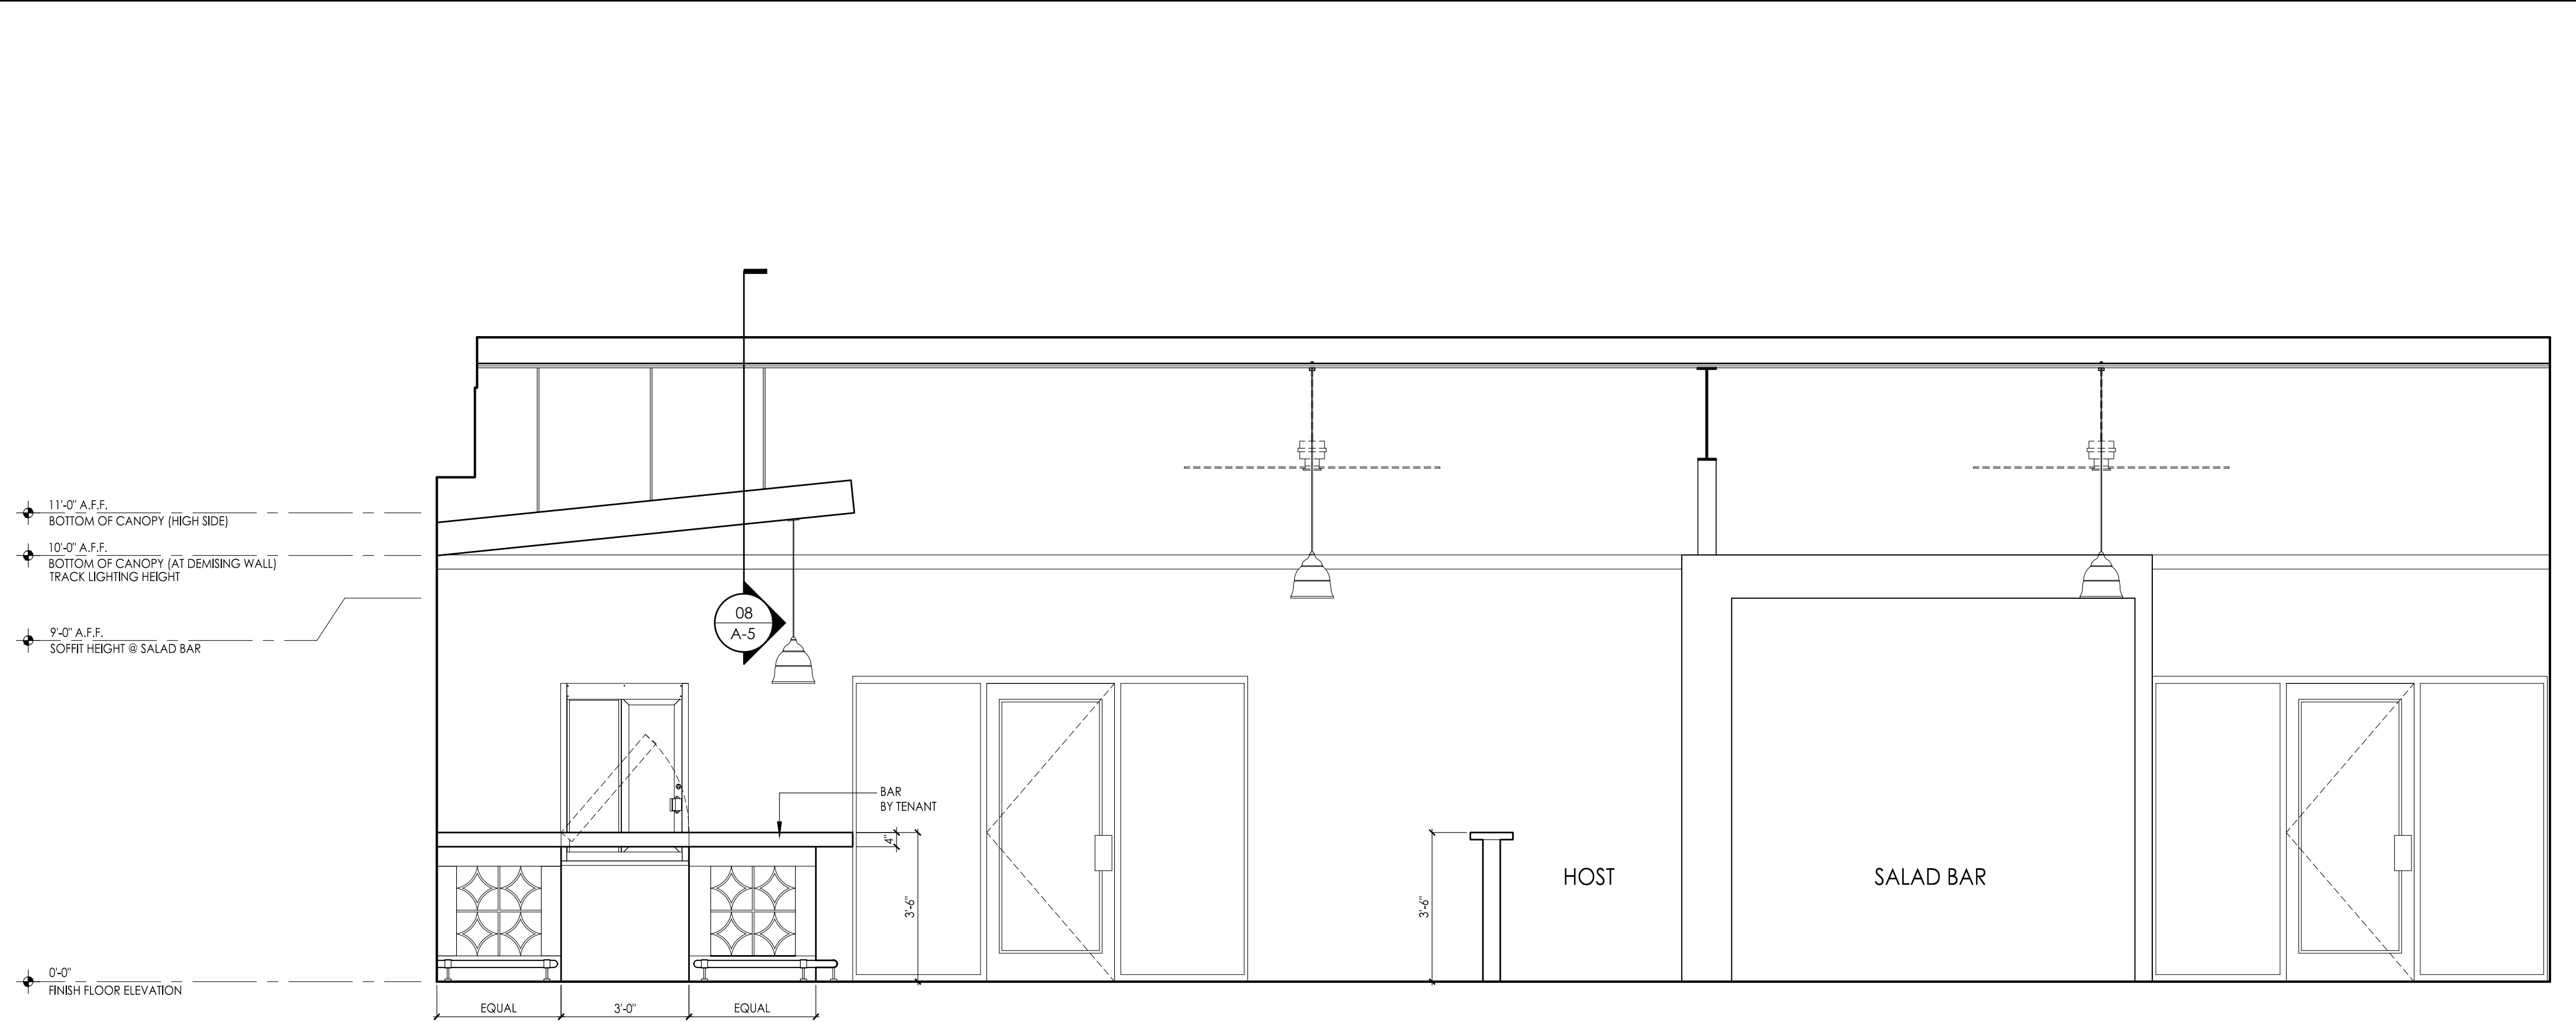

**02** BUILDING SECTION / INTERIOR ELEVATIONS  
 A-4 SCALE: 3/8"=1'-0"

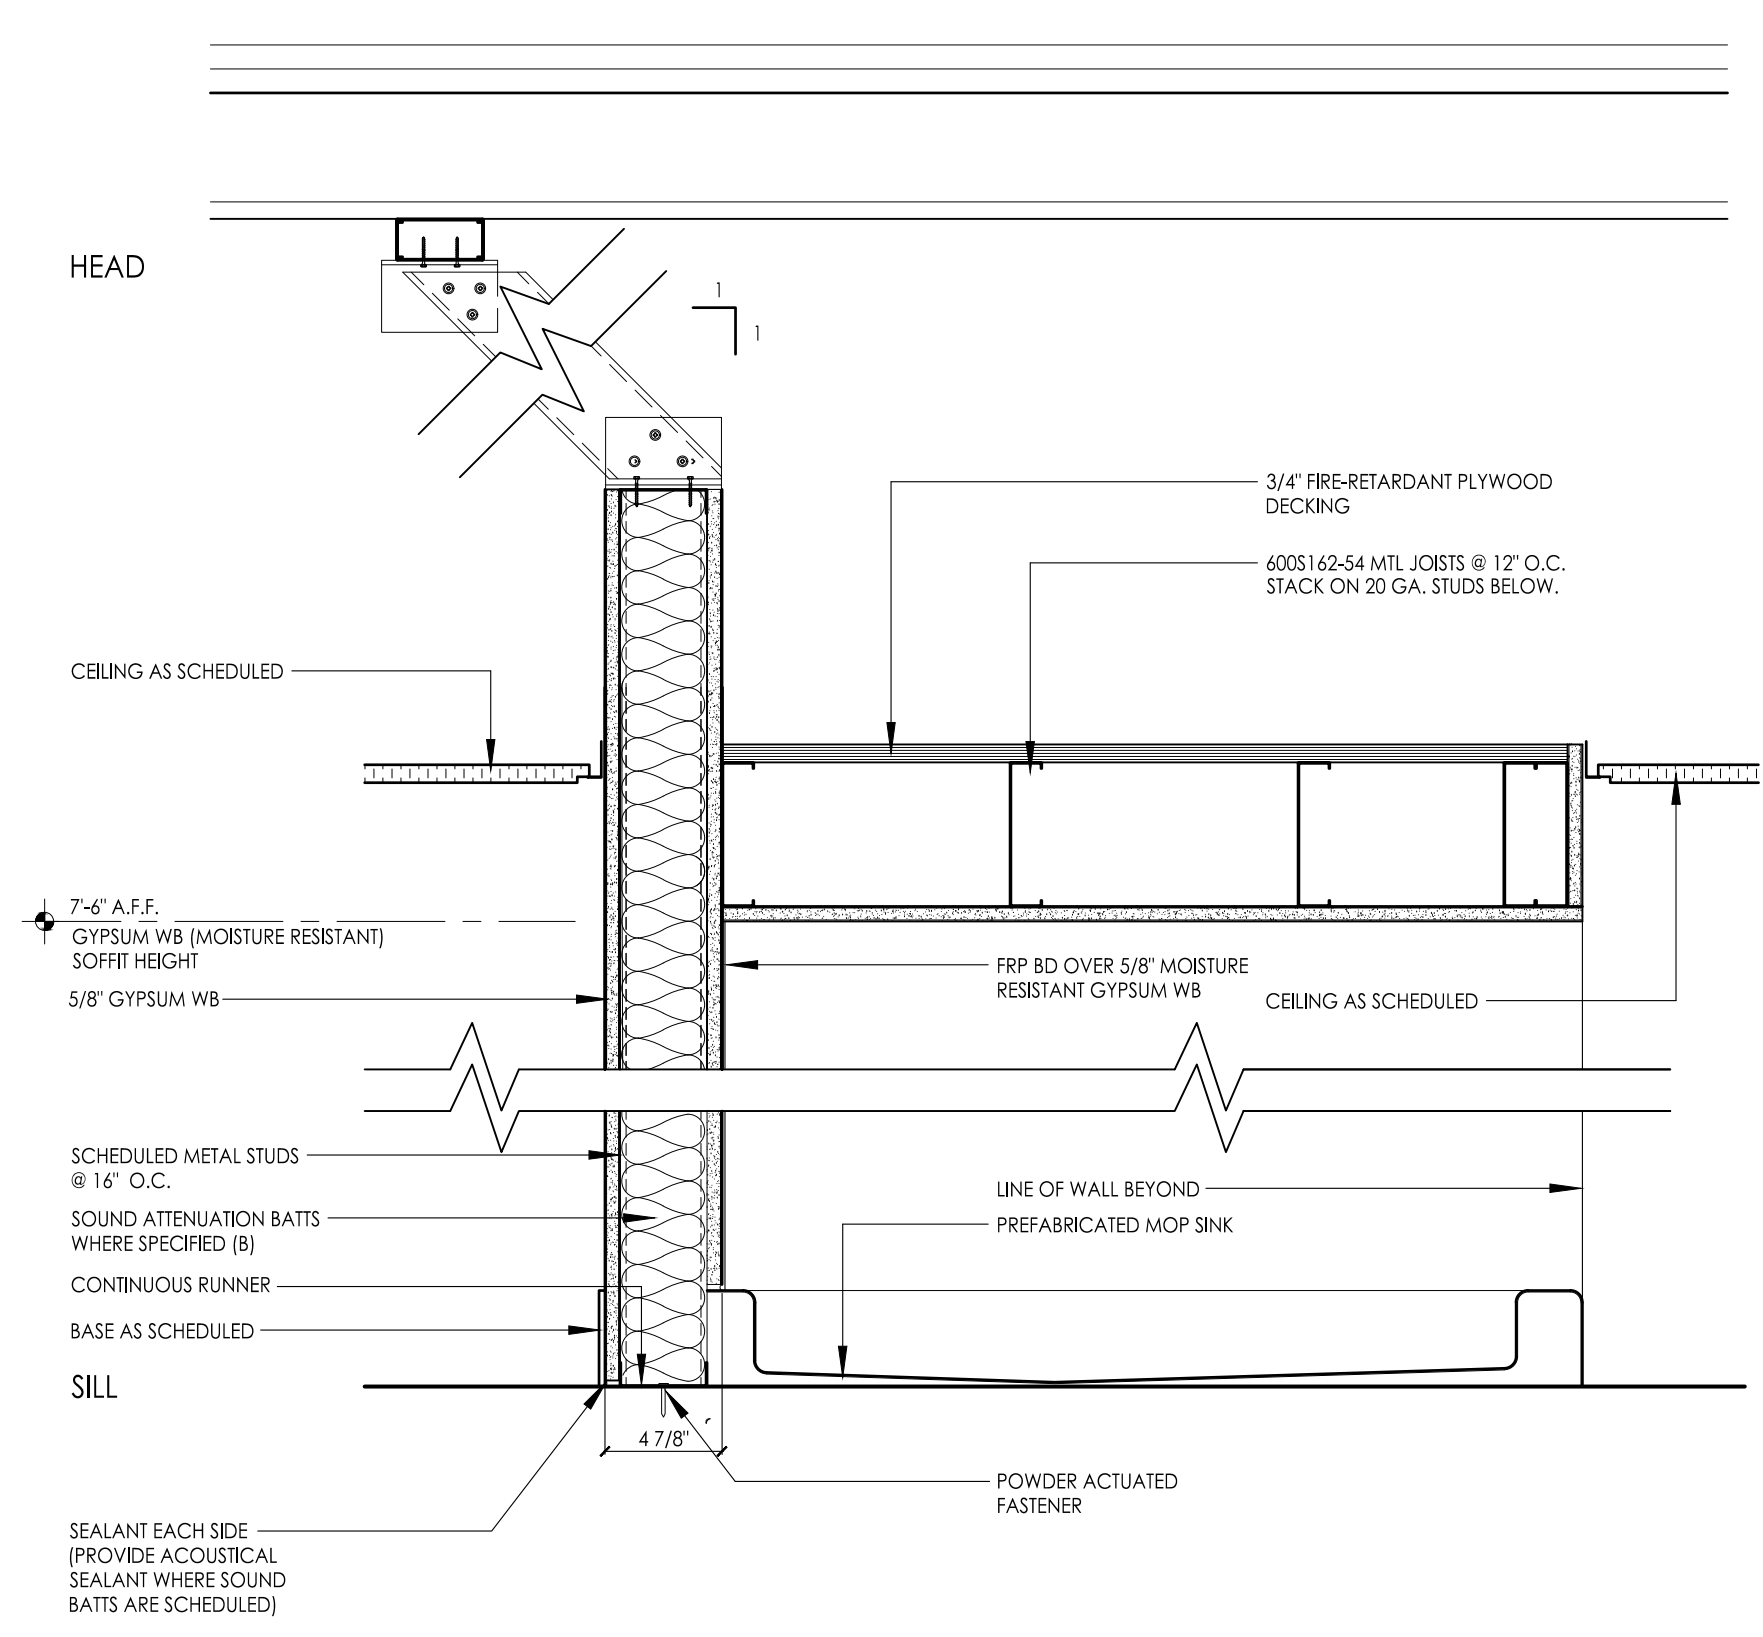

**03** SECTION DETAIL  
 A-4 SCALE: 1 1/2"=1'-0"

A Tenant Alteration for  
**HARVEY JOHNS STEAKHOUSE**  
 1501 N. Raleigh Street, Suite G  
 Angler, NC

JOB #:  
 23C1CHARVEYJOHNS

DWG BY: DVS  
 CHK BY: DVS  
 DATE: 07/28/23  
 REV NO DATE

BUILDING SECTIONS/  
 INTERIOR  
 ELEVATIONS/DETAILS

SHEET NUMBER  
**A-4**



