PRELIMINARY SITE PLAN REVIEW CIRCLE K - NTI NC55 KENNEBEC - ANGIER NC

ANGIER, NORTH CAROLINA 27501 **WAKE COUNTY**

OWNER:

ARCHITECT:

RDC

ALBERMARLE PROPERTIES LLC 10320 DURANT RD STE 113 RALEIGH, NC 27614

RALPH WATSON 11921 FREEDOM DRIVE, SUITE #1110 RESTON, VA 20190 RALPH.WATSON@RDCCOLLABORATIVE.COM PH: (703) 659-8252

DEVELOPER:

CIRCLE K STORES INC **ANDY PRIOLO** 1100 SITUS COURT SUITE 100 RALEIGH, NC 27606 PH: (919) 566-1714

FAX: (919) 777-5139

CIVIL ENGINEER:

TIMMONS GROUP RICK BAKER, P.E. 5410 TRINITY ROAD SUITE 102 RALEIGH, NC 27607 RICK.BAKER@TIMMONS.COM PH: (919) 866-4939

SURVEYOR:

BOHLER ENGINEERING THOMAS E. TEABO, PLS 4130 PARKLAKE AVENUE SUITE 130 RALEIGH, NC 27612 PH: (919) 578-9000

	SITE PLAN SUMMARY
PROJECT:	CIRCLE K - NTI NC-55 KENNEBEC - ANGIER, NC
OWNER:	ALBERMARLE PROPERTIES LLC
PROJECT ADDRESS:	9706 KENNEBEC CHURCH ROAD, ANGIER, NC 27501
PIN:	0675-50-0409
JURISDICTION:	ANGIER
ZONING:	GC (GENERAL COMMERCIAL)
EXISTING USE:	VACANT
PROPOSED USE:	CONVENIENCE STORE W/ GAS SALES & CAR WASH
FLOOD ZONE:	NOT LOCATED IN FLOOD HAZARDS AREA PER FEMA MAP #3720067500K (EFFECTIVE 10/03/2006)
PROP. TRACT AREA:	3.40 AC (148,166 SF)
PROPOSED OUTPARCEL AREA:	2.54 AC
DISTURBED AREA:	4.20 AC
EXISTING IMPERVIOUS SURFACE AREA:	4750 SF (3.2%)
PROP. IMPERVIOUS AREA TO REMAIN:	90,170 SF (2.07 AC)
TYPE OF BUILDING CONSTRUCTION:	CONVENIENCE STORE: V-B (NON-SPRINKLERED)
TYPE OF CANOPY CONSTRUCTION:	II-B
PROP. CONVENIENCE BUILDING SQUARE FOOTAGE:	3,666 SF
VEHICLE PARKING SUMMARY: REQUIRED	CONVENIENCE STORES W/ GAS SALES: 1 SPACE PER 150 SQUARE FEET OF GFA = 3,666 SF / 150 SF = 25 SPACES REQUIRED; TOTAL = 25 SPACES (1 MUST BE AN ADA SPACE)
VEHICLE PARKING SUMMARY: PROVIDED	25 PASSENGER PARKING SPACES 2 ADA SPACES (2 ARE VAN ACCESSIBLE) TOTAL: 27 SPACES
HOURS OF OPERATION	24 HOUR OPERATION



VICINITY MAP

GENERAL NOTE

ALL CONTRACTORS SHALL VISIT THE PROJECT TO FAMILIARIZE THEMSELVES WITH SITE CONDITIONS PRIOR TO BIDDING OR CONSTRUCTION. BY SUBMITTING A BID, THE CONTRACTOR AND HIS SUBCONTRACTORS ARE CONFIRMING THAT THEY HAVE VISITED THE SITE AND HAVE INCLUDED IN THEIR BID ANY ADDITIONAL ITEMS OF CONSTRUCTION THAT MAY BE REQUIRED DUE TO EXISTING SITE CONDITIONS.

Sheet List Table

	Silect Fist Table						
Sheet Number	Sheet Title						
C0.0	COVER SHEET						
C1.0	EXISTING CONDITIONS AND DEMOLITION PLAN						
C2.0	SITE PLAN						
C2.1	PAVING PLAN						
C2.2	VEHICULAR ROUTING PLAN						
C3.0	GRADING AND DRAINAGE PLAN						
C3.1	SPOT GRADING PLAN						
C3.2	SPOT GRADING PLAN						
C3.3	DRY DETENTION POND PLAN AND PROFILE						
C3.4	DRY DETENTION POND DETAILS						
C3.5	ROAD WIDENING AND STRIPPING PLAN						
C3.6	ROAD WIDENING AND STRIPPING PLAN						
C4.0	EROSION CONTROL PLAN - PHASE 1						
C4.1	EROSION CONTROL PLAN - PHASE 2						
C5.0	UTILITY PLAN						
C6.0	LANDSCAPE PLAN						
C6.1	LANDSCAPE DETAILS						
C7.0	NOTES AND DETAILS						
C7.1	NOTES AND DETAILS						
C7.2	NOTES AND DETAILS						
C7.3	NOTES AND DETAILS						
C7.4	NOTES AND DETAILS						
C7.5	NOTES AND DETAILS						
C7.6	NOTES AND DETAILS						
A2.1	EXTERIOR ELEVATIONS						
A2.0-CW	EXTERIOR ELEVATIONS						
A2-2	FUEL CANOPY ELEVATIONS						
PAGE 1 OF 3	LIGHTING PLAN						
PAGE 2 OF 3	LIGHTING PLAN						
PAGE 3 OF 3	LIGHTING PLAN						

PRELIMINARY - NOT RELEASED FOR CONSTRUCTION

ALL CONSTRUCTION TO BE IN ACCORDANCE WITH ALL TOWN OF ANGIER, NCDEQ AND NCDOT STANDARDS. SPECIFICATIONS. AND DETAILS


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10/10/2022 DRAWN BY J. YOKLEY

J. DOOLEY CHECKED BY R. BAKER

AS SHOWN

7630.105 SHEET NO. C0.0

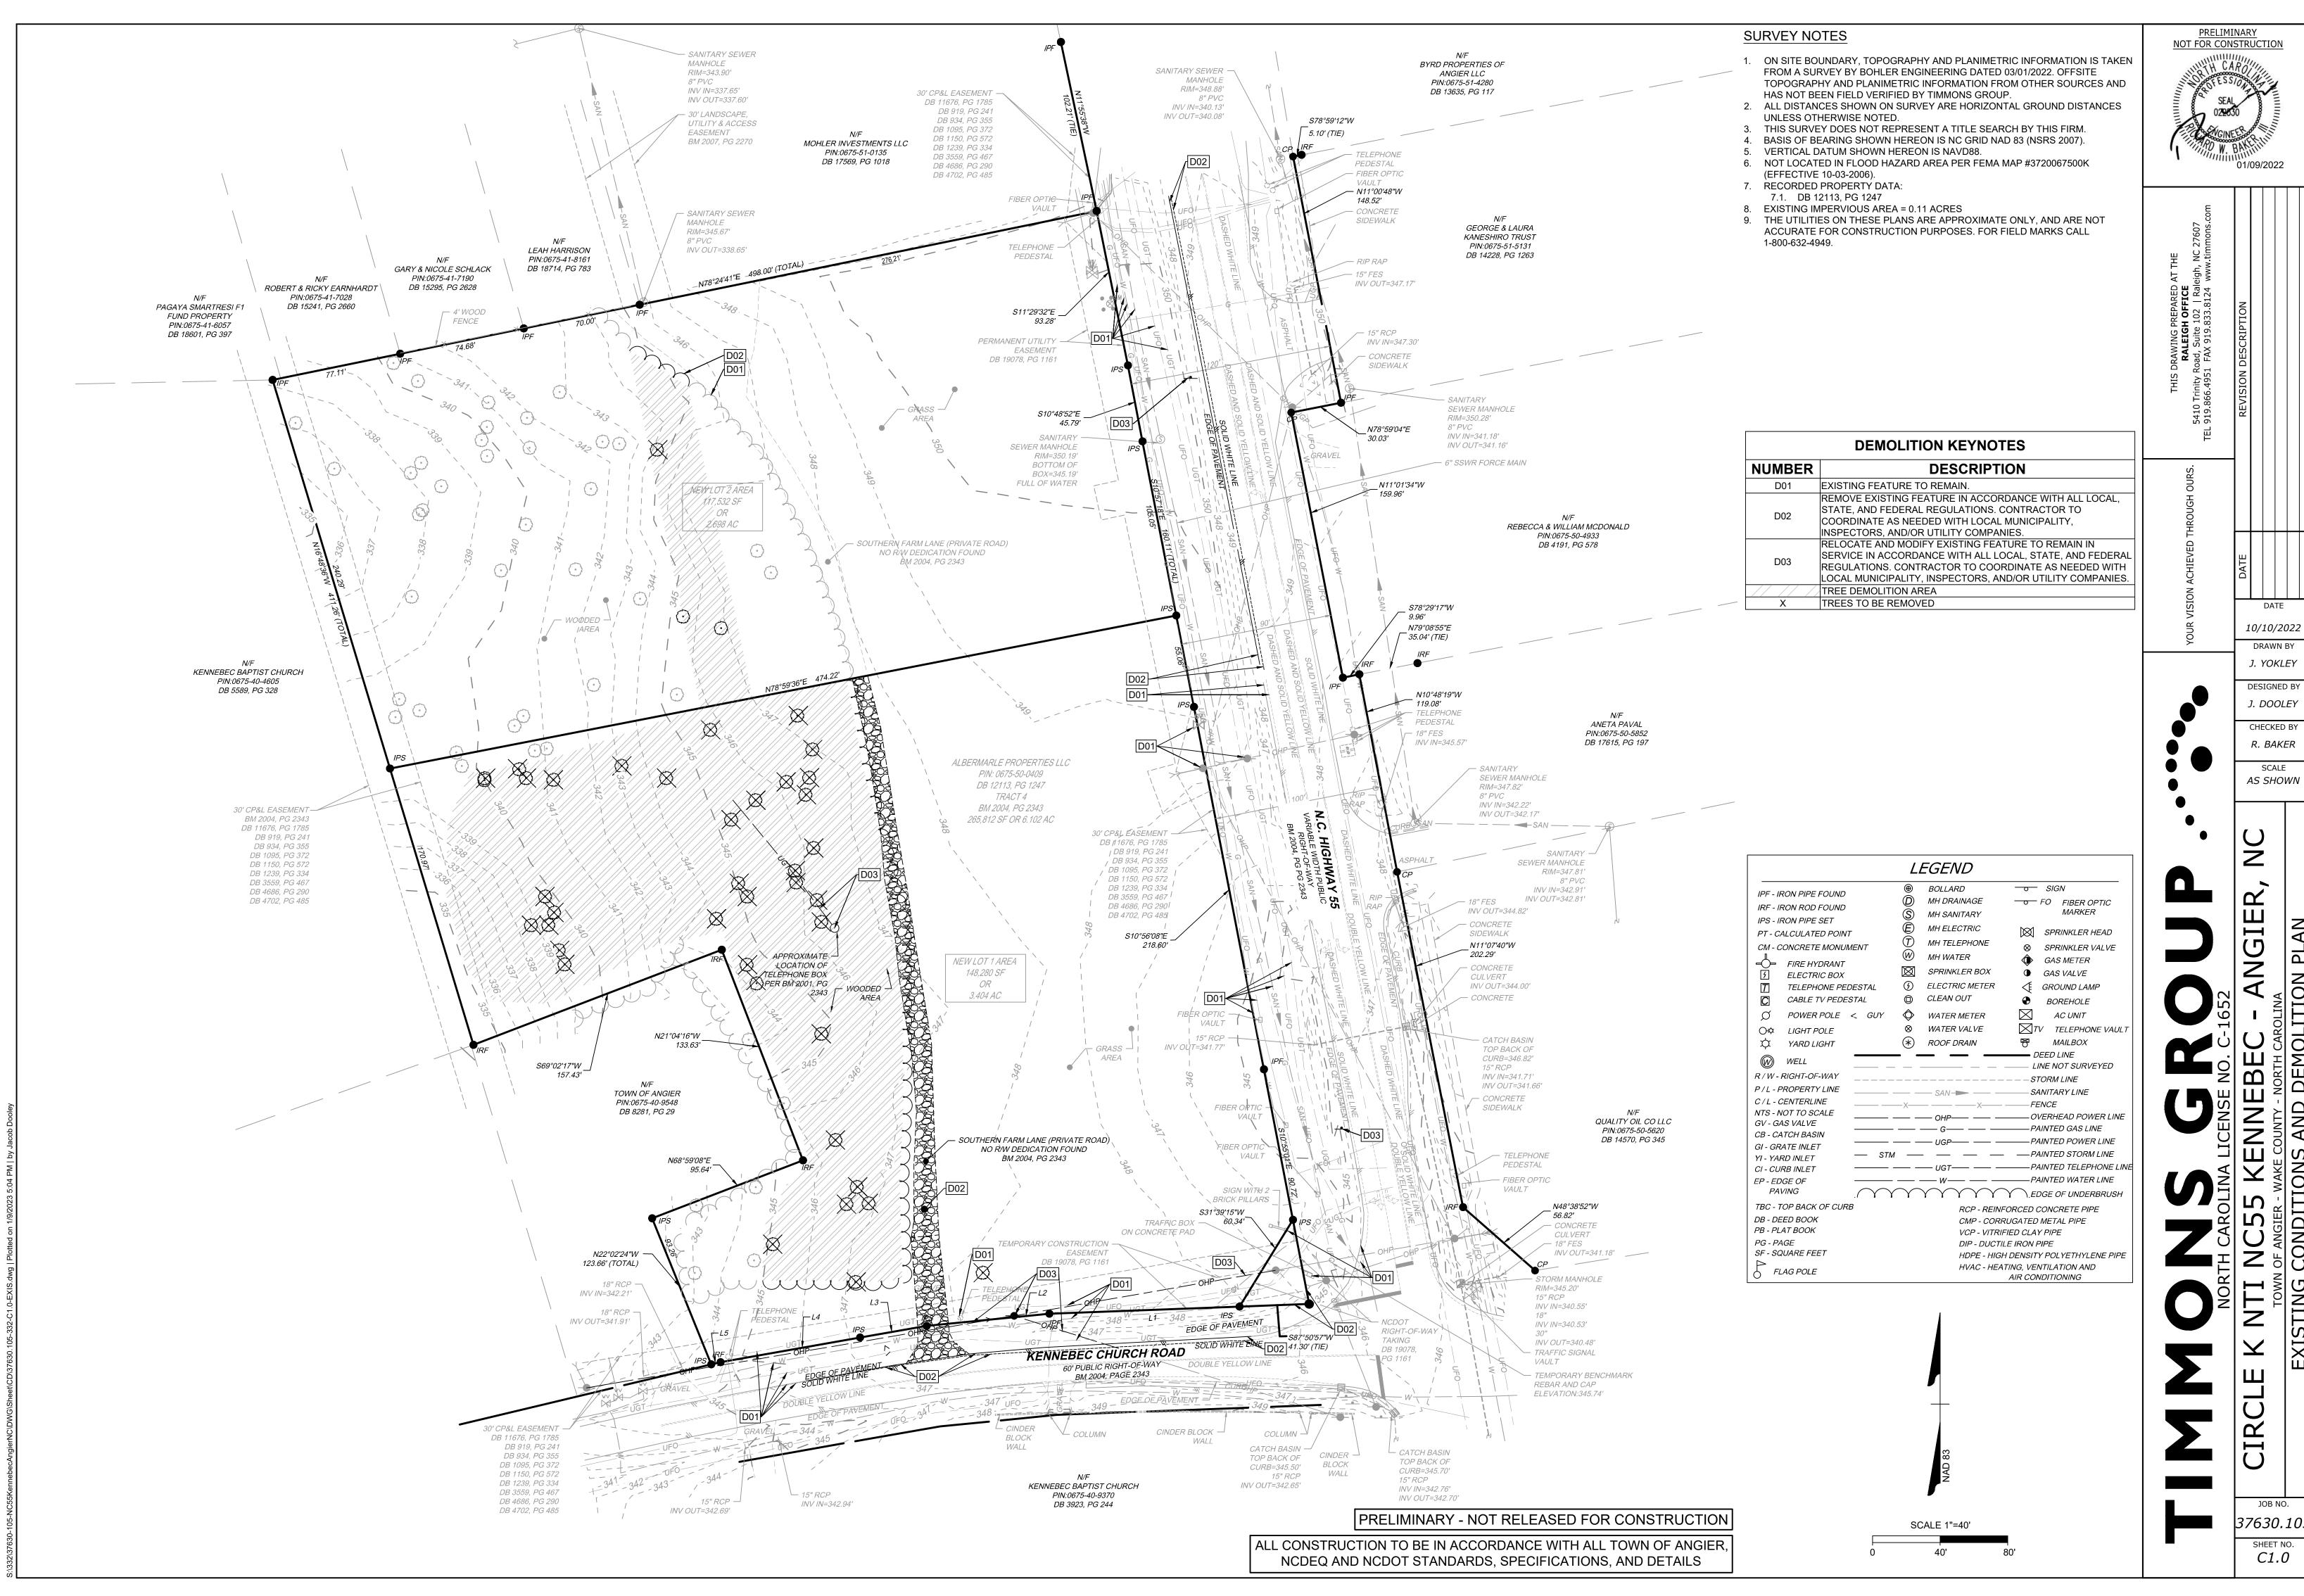


J. YOKLEY **DESIGNED BY** J. DOOLEY

CHECKED BY R. BAKER

AS SHOWN

7630.105 SHEET NO.

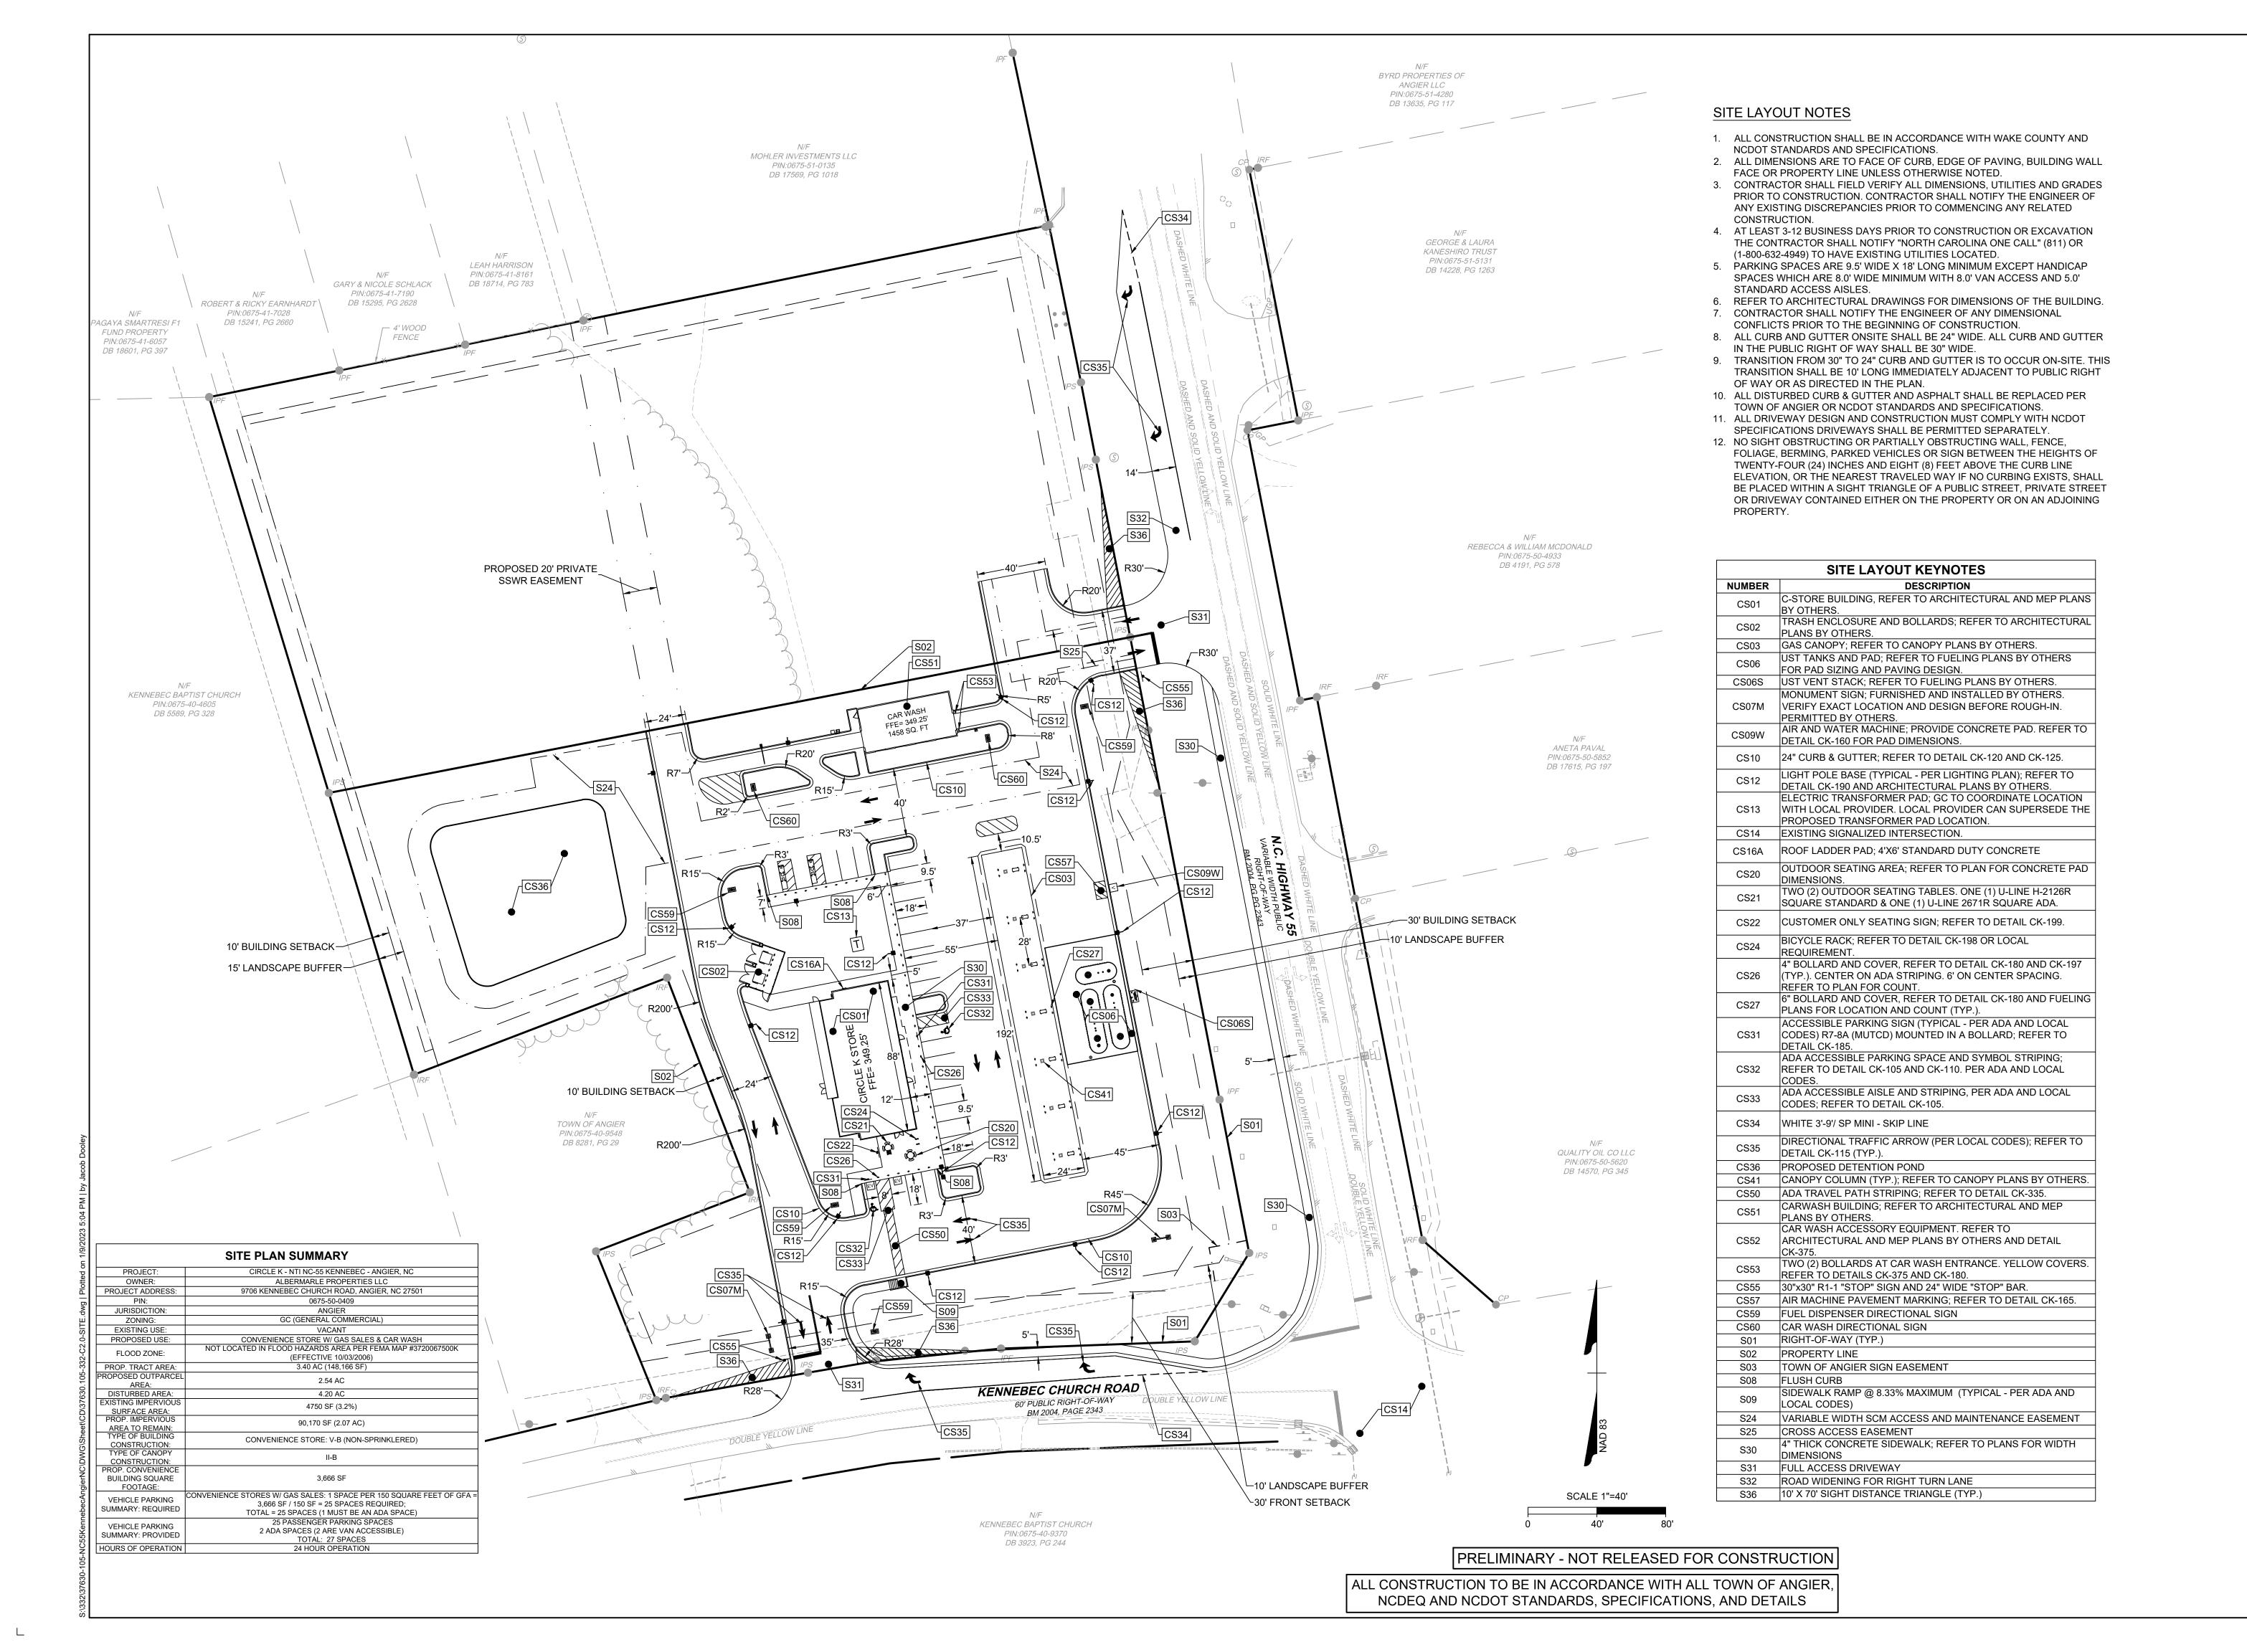

NOT FOR CONSTRUCTION


10/10/2022 DRAWN BY J. FRENCH

DESIGNED BY J. DOOLEY CHECKED BY R. BAKER

AS SHOWN

7630.105

SHEET NO. C2.0

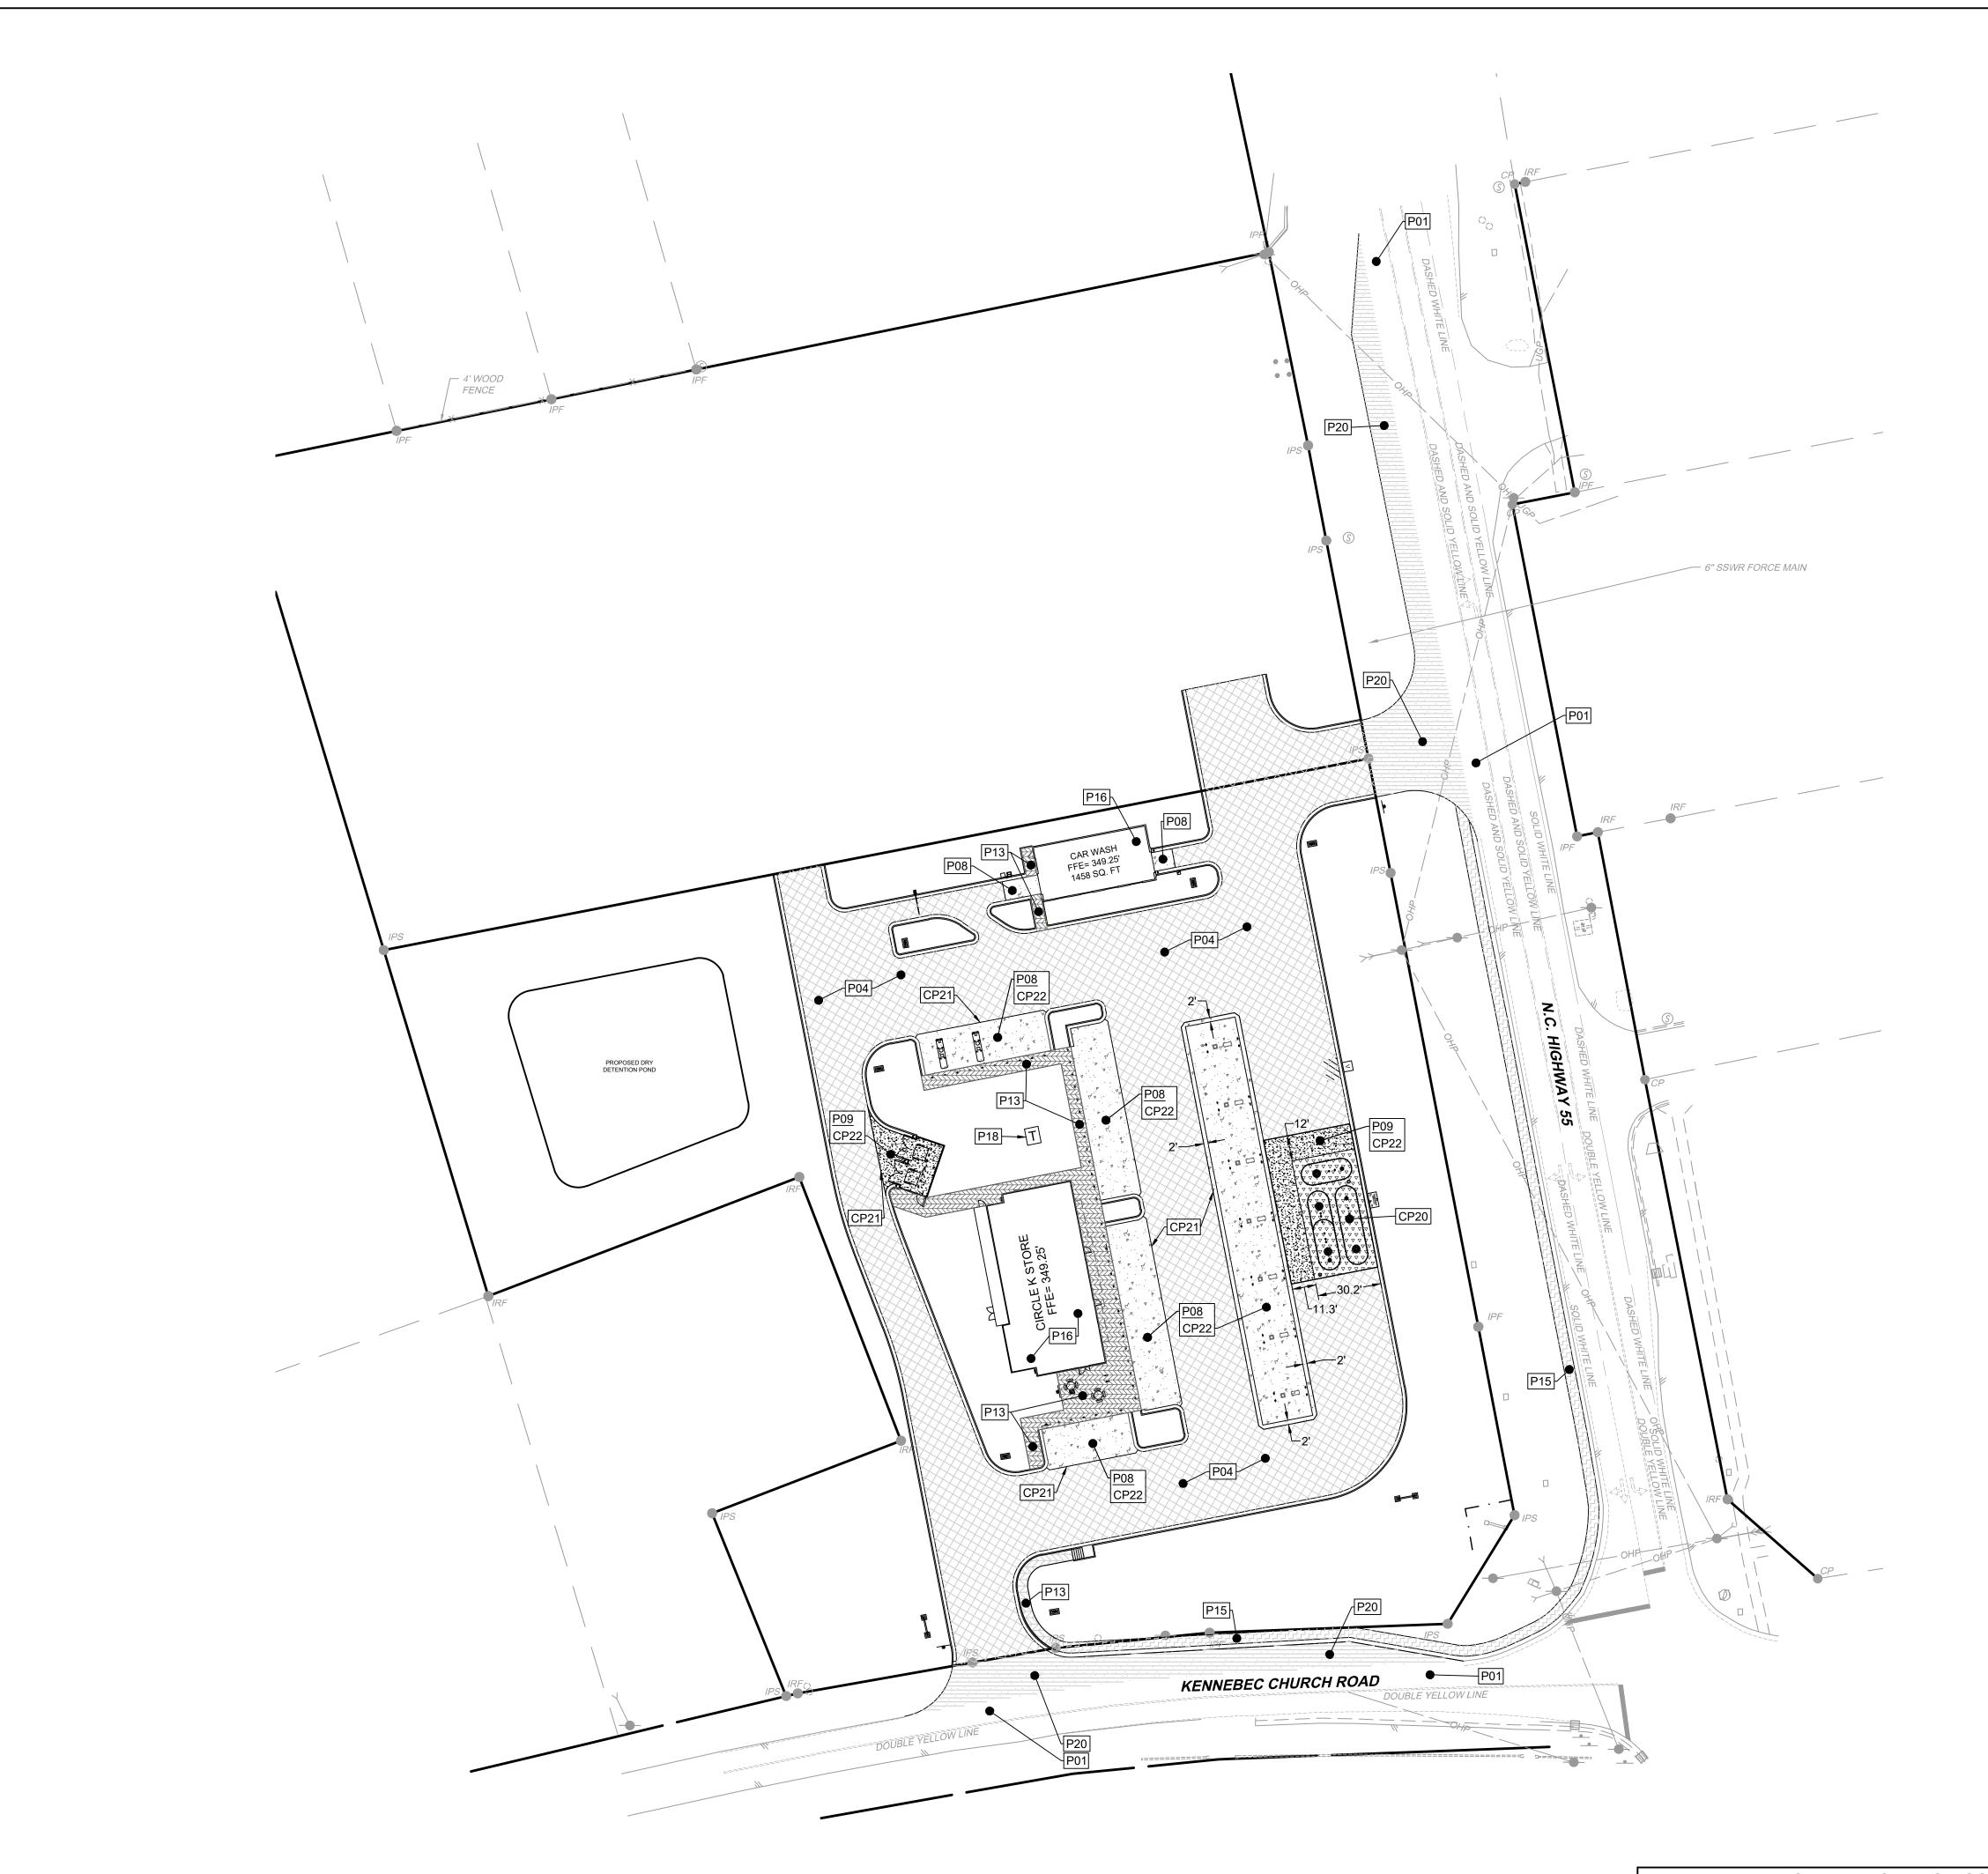

PAVING KEYNOTES				
NUMBER	HATCH	DESCRIPTION		
P01		EXISTING PAVEMENT TO REMAIN UNDISTURBED.		
P04		HEAVY DUTY ASPHALT PAVING; REFER TO PAVEMENT SECTIONS DETAIL.		
P08	P.A. A	STANDARD DUTY CONCRETE PAVING; REFER TO PAVEMI SECTIONS DETAIL.		
P09		HEAVY DUTY CONCRETE PAVING; REFER TO PAVEMENT SECTIONS DETAIL.		
P13		PRIVATE CONCRETE SIDEWALK; REFER TO PAVEMENT SECTIONS DETAIL.		
P15		PUBLIC CONCRETE SIDEWALK; REFER TO NCDOT DETAIL #720-150-00		
P16		BUILDING PAD; REFER TO ARCHITECTURAL PLANS BY OTHERS.		
P18		TRANSFORMER PAD PER UTILITY PROVIDER SPECIFICATIONS.		
P20		NCDOT ASPHALT, REFER TO PAVEMENT SECTIONS		
CP20	V	CONCRETE PAVING OVER UST TANKS. REFER TO FUELIN PLANS BY OTHERS FOR DETAILS.		
CP21		THICKENED EDGE; REFER TO DETAIL CK-155 AND CK-150		
CP22		REFER TO CONCRETE PAVEMENT JOINT DETAIL (TYP.); REFER TO DETAIL CK-175. THATCHED. REFER TO SITE LAYOUT PLAN FOR ADDITION		

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TOWN OF ANGIER - WAKE COUNTY - NORTH CAROLINA


VEHICULAR ROUTING PLAN

JOB NO.

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SHEET NO.

C2.2

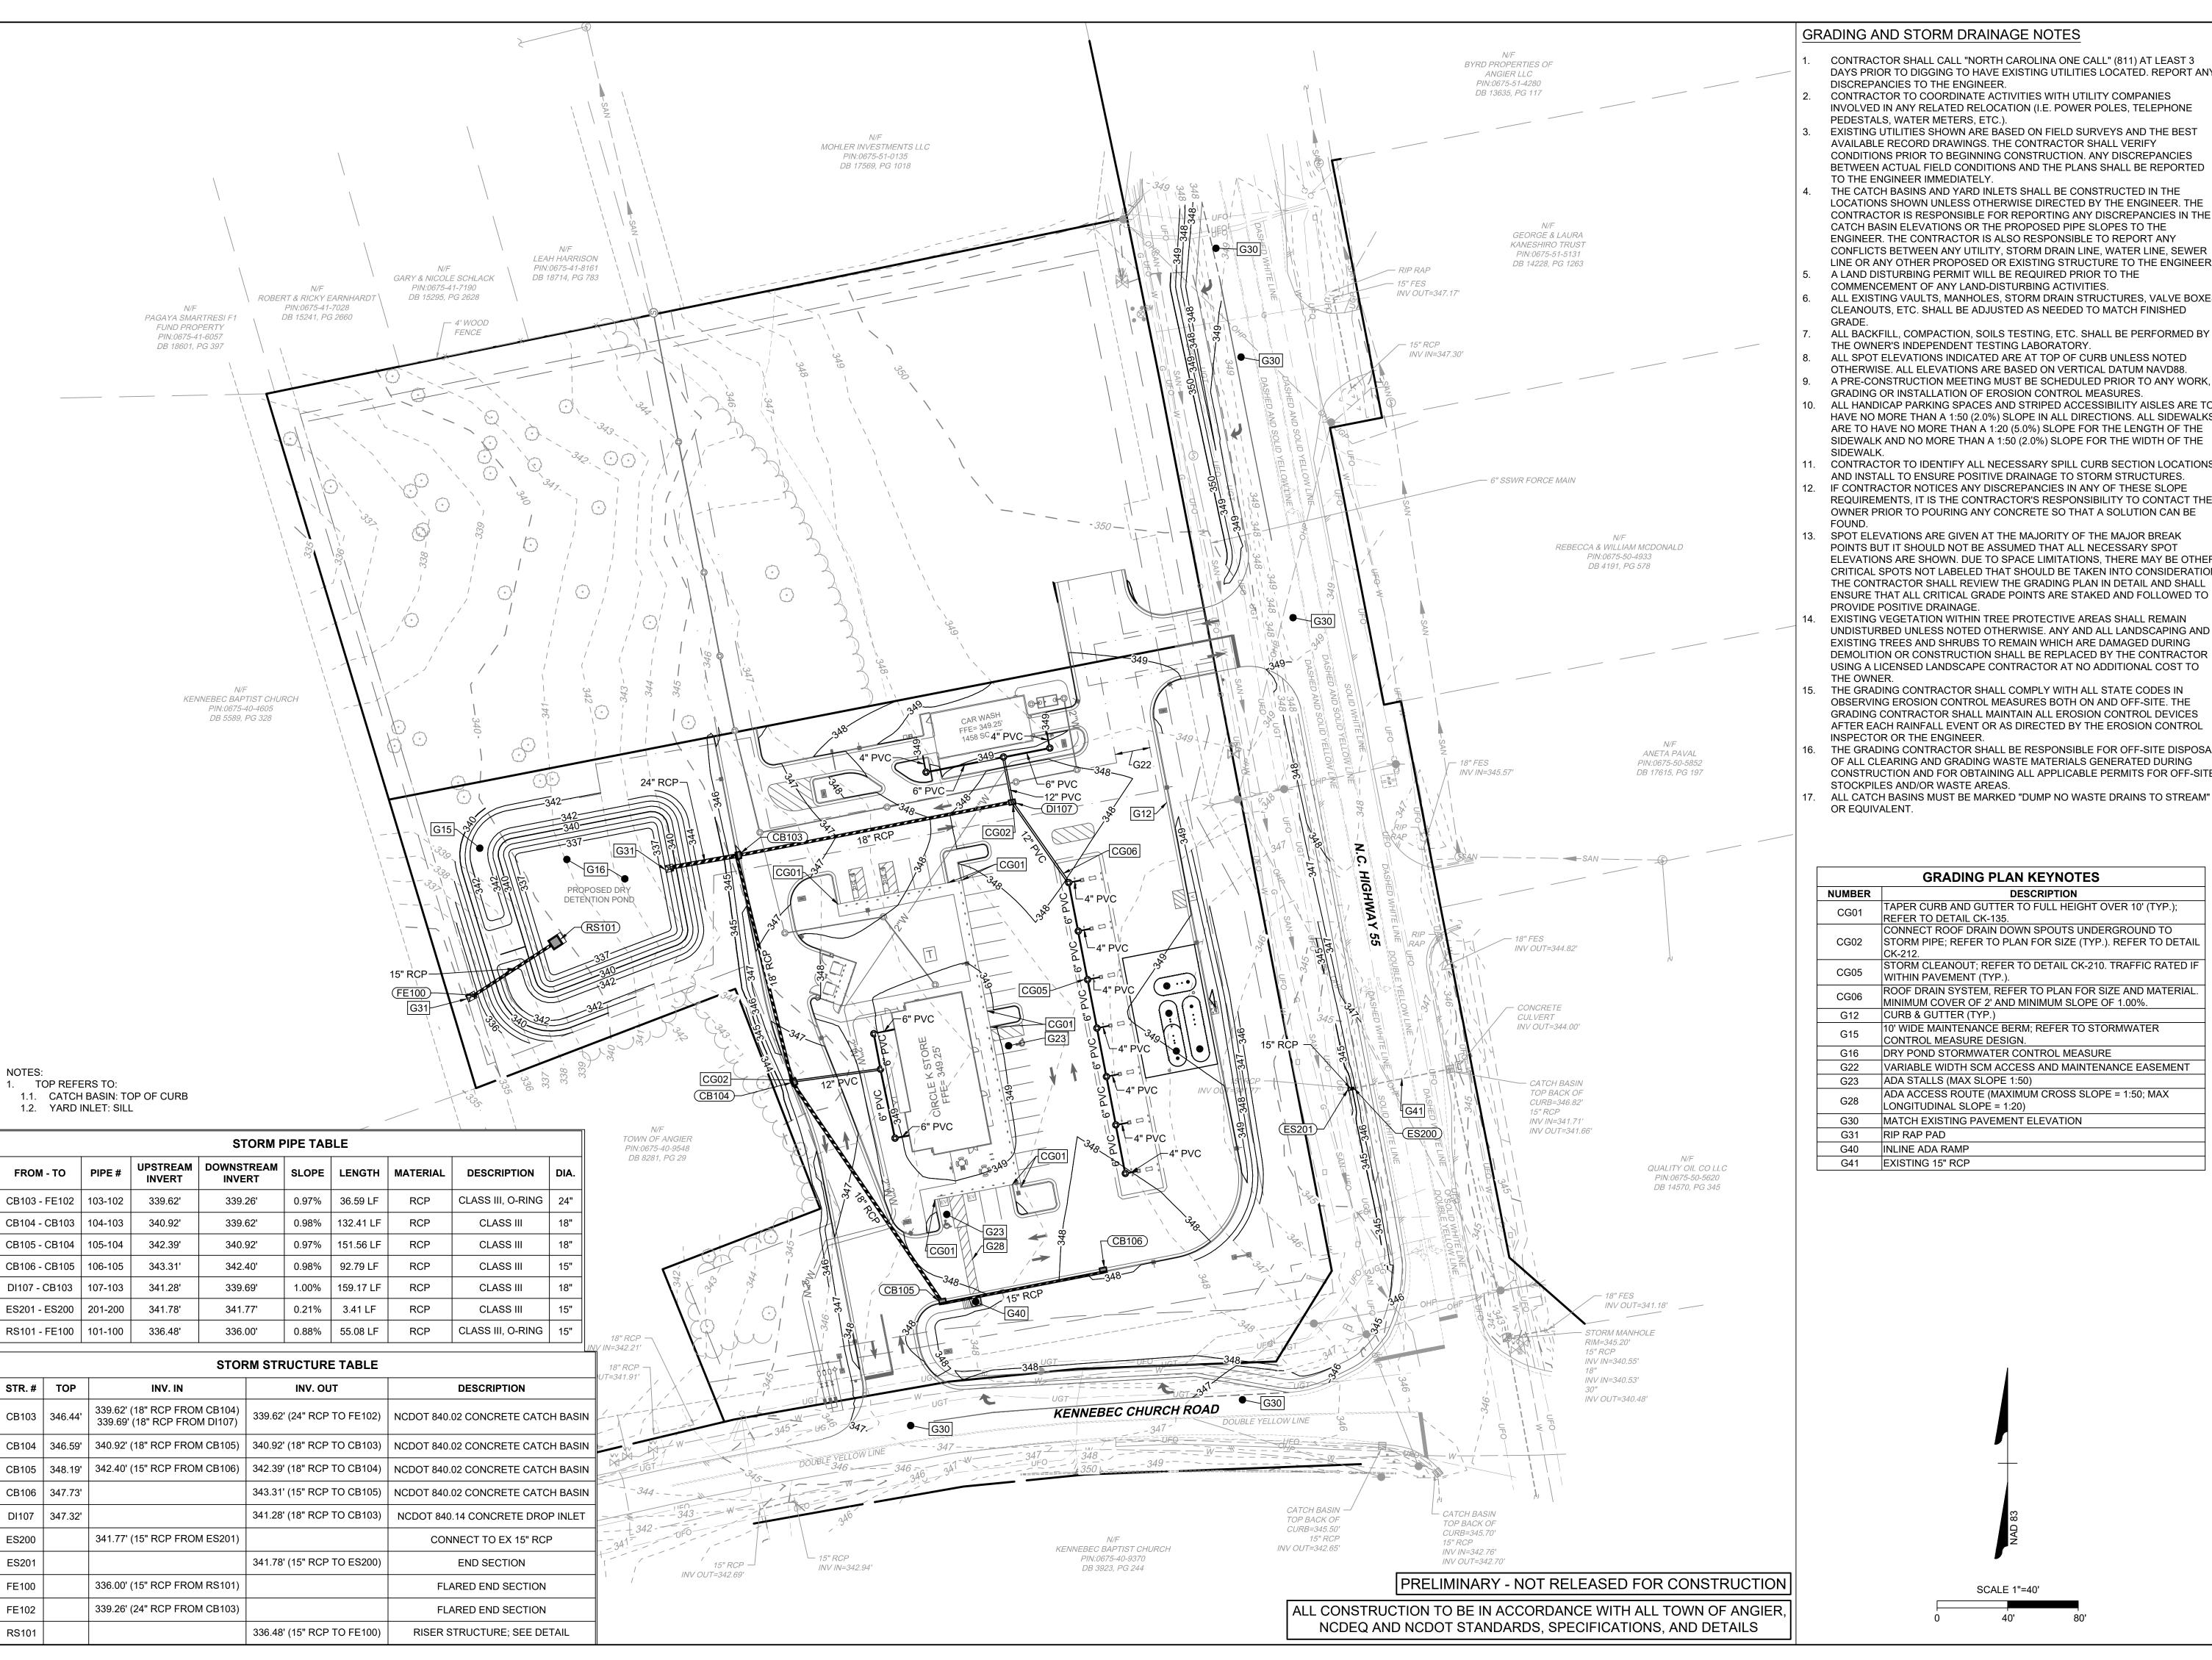

GRADING AND STORM DRAINAGE NOTES

- CONTRACTOR SHALL CALL "NORTH CAROLINA ONE CALL" (811) AT LEAST 3 DAYS PRIOR TO DIGGING TO HAVE EXISTING UTILITIES LOCATED. REPORT ANY DISCREPANCIES TO THE ENGINEER.
- CONTRACTOR TO COORDINATE ACTIVITIES WITH UTILITY COMPANIES INVOLVED IN ANY RELATED RELOCATION (I.E. POWER POLES, TELEPHONE
- EXISTING UTILITIES SHOWN ARE BASED ON FIELD SURVEYS AND THE BEST AVAILABLE RECORD DRAWINGS. THE CONTRACTOR SHALL VERIFY CONDITIONS PRIOR TO BEGINNING CONSTRUCTION. ANY DISCREPANCIES BETWEEN ACTUAL FIELD CONDITIONS AND THE PLANS SHALL BE REPORTED
- THE CATCH BASINS AND YARD INLETS SHALL BE CONSTRUCTED IN THE LOCATIONS SHOWN UNLESS OTHERWISE DIRECTED BY THE ENGINEER. THE CONTRACTOR IS RESPONSIBLE FOR REPORTING ANY DISCREPANCIES IN THE CATCH BASIN ELEVATIONS OR THE PROPOSED PIPE SLOPES TO THE ENGINEER. THE CONTRACTOR IS ALSO RESPONSIBLE TO REPORT ANY CONFLICTS BETWEEN ANY UTILITY, STORM DRAIN LINE, WATER LINE, SEWER LINE OR ANY OTHER PROPOSED OR EXISTING STRUCTURE TO THE ENGINEER.
- A LAND DISTURBING PERMIT WILL BE REQUIRED PRIOR TO THE COMMENCEMENT OF ANY LAND-DISTURBING ACTIVITIES.
- ALL EXISTING VAULTS, MANHOLES, STORM DRAIN STRUCTURES, VALVE BOXES CLEANOUTS, ETC. SHALL BE ADJUSTED AS NEEDED TO MATCH FINISHED
- ALL BACKFILL, COMPACTION, SOILS TESTING, ETC. SHALL BE PERFORMED BY THE OWNER'S INDEPENDENT TESTING LABORATORY.
- ALL SPOT ELEVATIONS INDICATED ARE AT TOP OF CURB UNLESS NOTED OTHERWISE. ALL ELEVATIONS ARE BASED ON VERTICAL DATUM NAVD88.
- GRADING OR INSTALLATION OF EROSION CONTROL MEASURES. ALL HANDICAP PARKING SPACES AND STRIPED ACCESSIBILITY AISLES ARE TO HAVE NO MORE THAN A 1:50 (2.0%) SLOPE IN ALL DIRECTIONS. ALL SIDEWALKS
- ARE TO HAVE NO MORE THAN A 1:20 (5.0%) SLOPE FOR THE LENGTH OF THE SIDEWALK AND NO MORE THAN A 1:50 (2.0%) SLOPE FOR THE WIDTH OF THE CONTRACTOR TO IDENTIFY ALL NECESSARY SPILL CURB SECTION LOCATIONS
- AND INSTALL TO ENSURE POSITIVE DRAINAGE TO STORM STRUCTURES. 12. IF CONTRACTOR NOTICES ANY DISCREPANCIES IN ANY OF THESE SLOPE REQUIREMENTS, IT IS THE CONTRACTOR'S RESPONSIBILITY TO CONTACT THE OWNER PRIOR TO POURING ANY CONCRETE SO THAT A SOLUTION CAN BE
- 13. SPOT ELEVATIONS ARE GIVEN AT THE MAJORITY OF THE MAJOR BREAK POINTS BUT IT SHOULD NOT BE ASSUMED THAT ALL NECESSARY SPOT ELEVATIONS ARE SHOWN. DUE TO SPACE LIMITATIONS, THERE MAY BE OTHER CRITICAL SPOTS NOT LABELED THAT SHOULD BE TAKEN INTO CONSIDERATION THE CONTRACTOR SHALL REVIEW THE GRADING PLAN IN DETAIL AND SHALL ENSURE THAT ALL CRITICAL GRADE POINTS ARE STAKED AND FOLLOWED TO PROVIDE POSITIVE DRAINAGE.
- EXISTING VEGETATION WITHIN TREE PROTECTIVE AREAS SHALL REMAIN UNDISTURBED UNLESS NOTED OTHERWISE. ANY AND ALL LANDSCAPING AND EXISTING TREES AND SHRUBS TO REMAIN WHICH ARE DAMAGED DURING DEMOLITION OR CONSTRUCTION SHALL BE REPLACED BY THE CONTRACTOR USING A LICENSED LANDSCAPE CONTRACTOR AT NO ADDITIONAL COST TO
- THE GRADING CONTRACTOR SHALL COMPLY WITH ALL STATE CODES IN OBSERVING EROSION CONTROL MEASURES BOTH ON AND OFF-SITE. THE GRADING CONTRACTOR SHALL MAINTAIN ALL EROSION CONTROL DEVICES AFTER EACH RAINFALL EVENT OR AS DIRECTED BY THE EROSION CONTROL INSPECTOR OR THE ENGINEER.
- THE GRADING CONTRACTOR SHALL BE RESPONSIBLE FOR OFF-SITE DISPOSAL OF ALL CLEARING AND GRADING WASTE MATERIALS GENERATED DURING CONSTRUCTION AND FOR OBTAINING ALL APPLICABLE PERMITS FOR OFF-SITE STOCKPILES AND/OR WASTE AREAS.
- ALL CATCH BASINS MUST BE MARKED "DUMP NO WASTE DRAINS TO STREAM"

GRADING PLAN KEYNOTES						
NUMBER	DESCRIPTION					
CG01	TAPER CURB AND GUTTER TO FULL HEIGHT OVER 10' (TYP.); REFER TO DETAIL CK-135.					
CG02	CONNECT ROOF DRAIN DOWN SPOUTS UNDERGROUND TO STORM PIPE; REFER TO PLAN FOR SIZE (TYP.). REFER TO DETAIL CK-212.					
CG05	STORM CLEANOUT; REFER TO DETAIL CK-210. TRAFFIC RATED IF WITHIN PAVEMENT (TYP.).					
CG06	ROOF DRAIN SYSTEM, REFER TO PLAN FOR SIZE AND MATERIAL. MINIMUM COVER OF 2' AND MINIMUM SLOPE OF 1.00%.					
G12	CURB & GUTTER (TYP.)					
G15	10' WIDE MAINTENANCE BERM; REFER TO STORMWATER CONTROL MEASURE DESIGN.					
G16	DRY POND STORMWATER CONTROL MEASURE					
G22	VARIABLE WIDTH SCM ACCESS AND MAINTENANCE EASEMENT					
G23	ADA STALLS (MAX SLOPE 1:50)					
G28	ADA ACCESS ROUTE (MAXIMUM CROSS SLOPE = 1:50; MAX					

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DATE 10/10/2022 DRAWN BY


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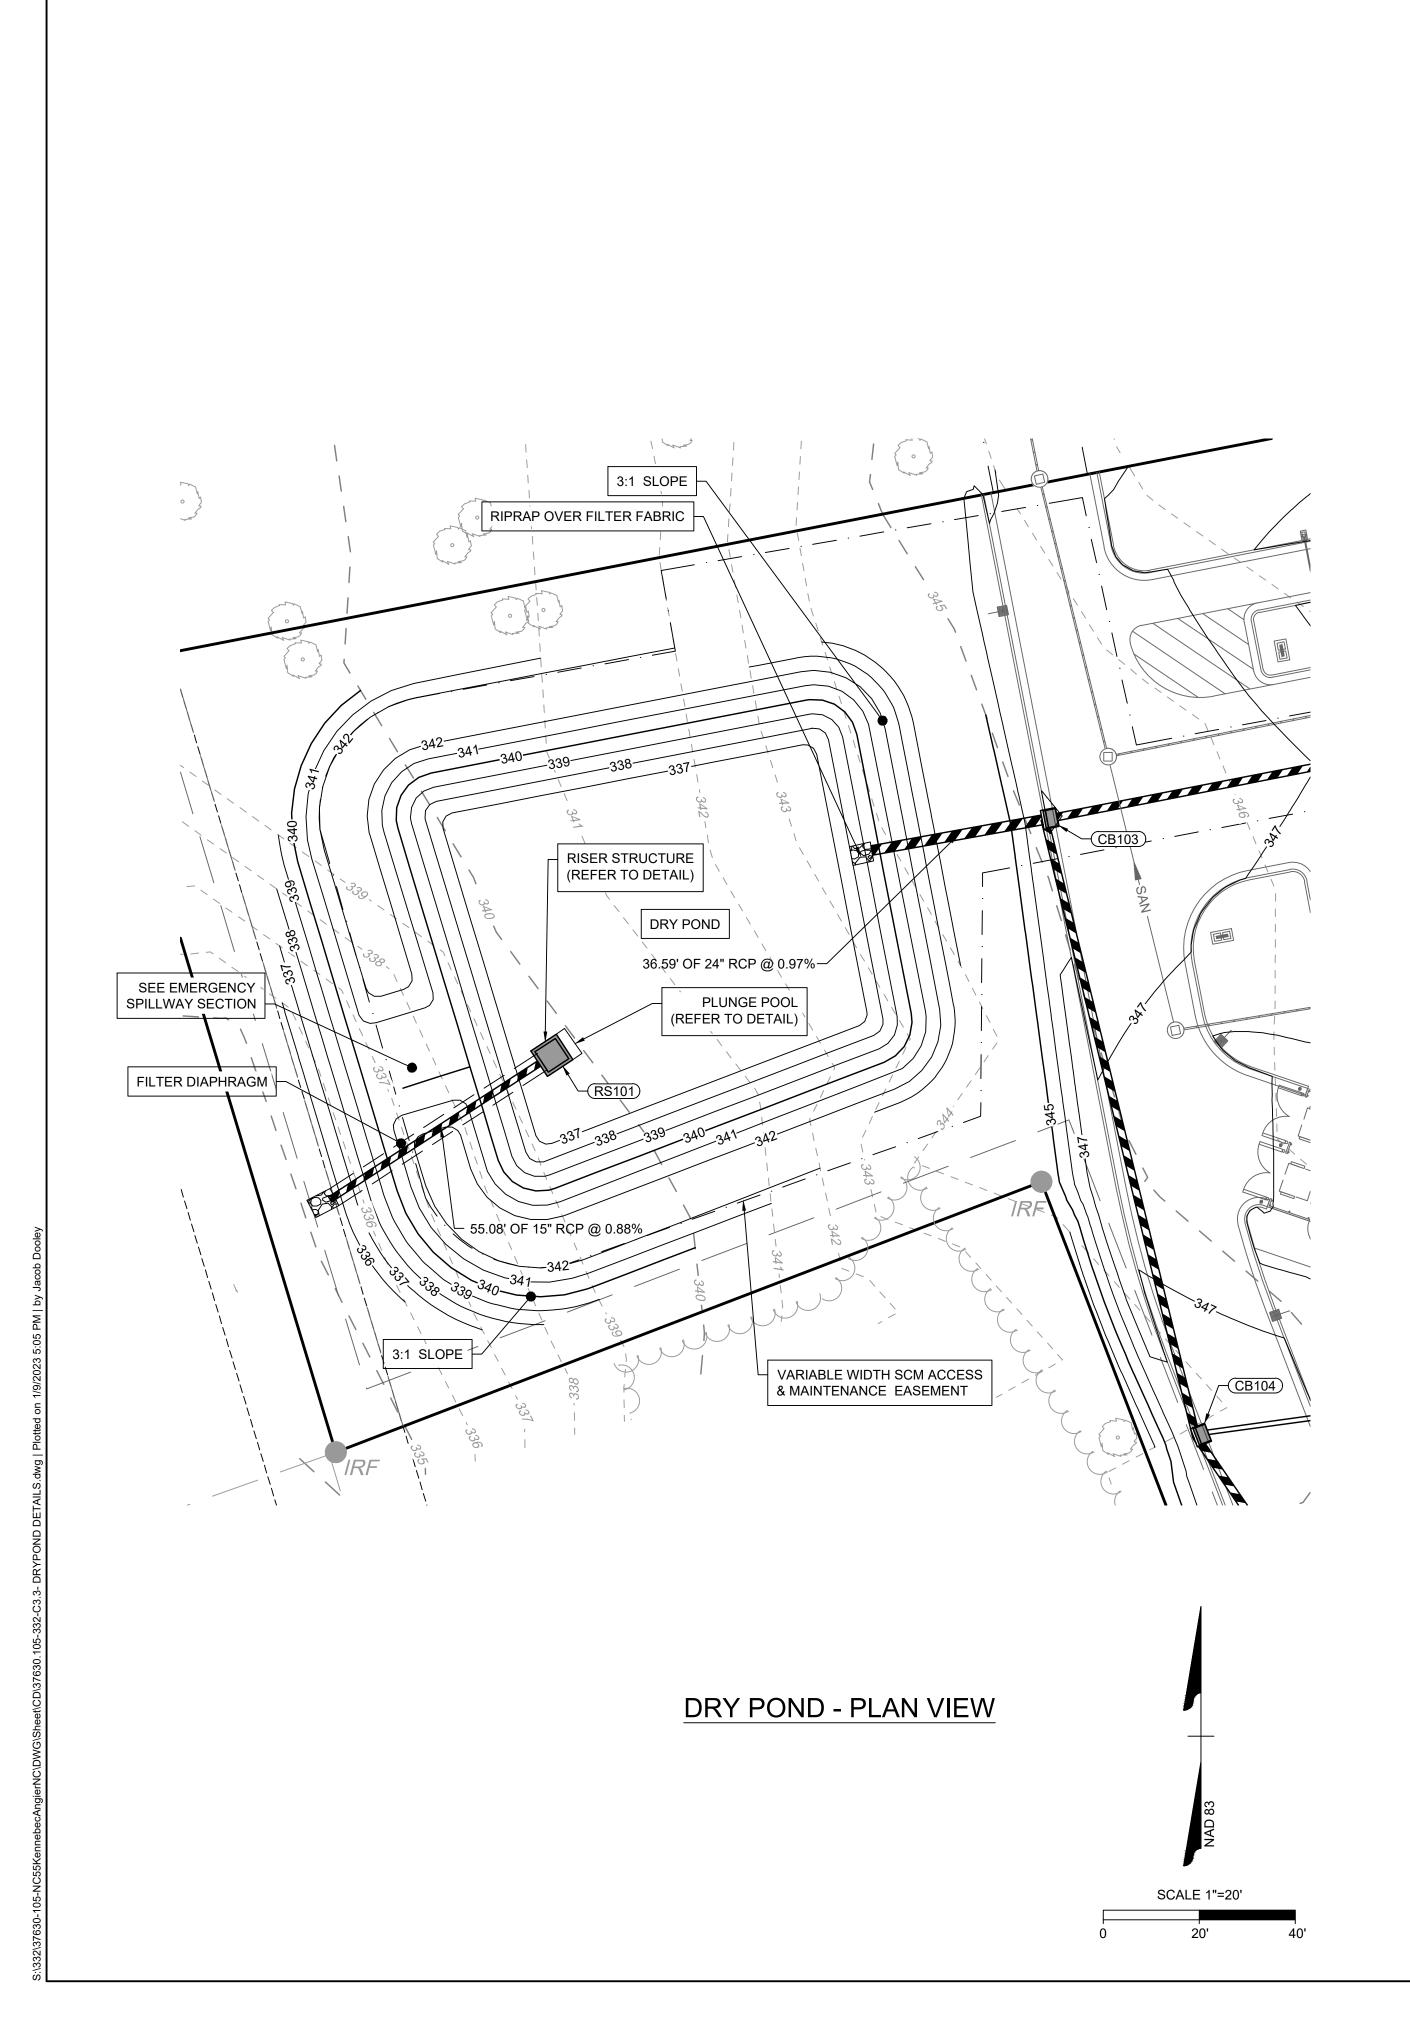
R. BAKER SCALE

AS SHOWN

7630.10 SHEET NO. C3.0





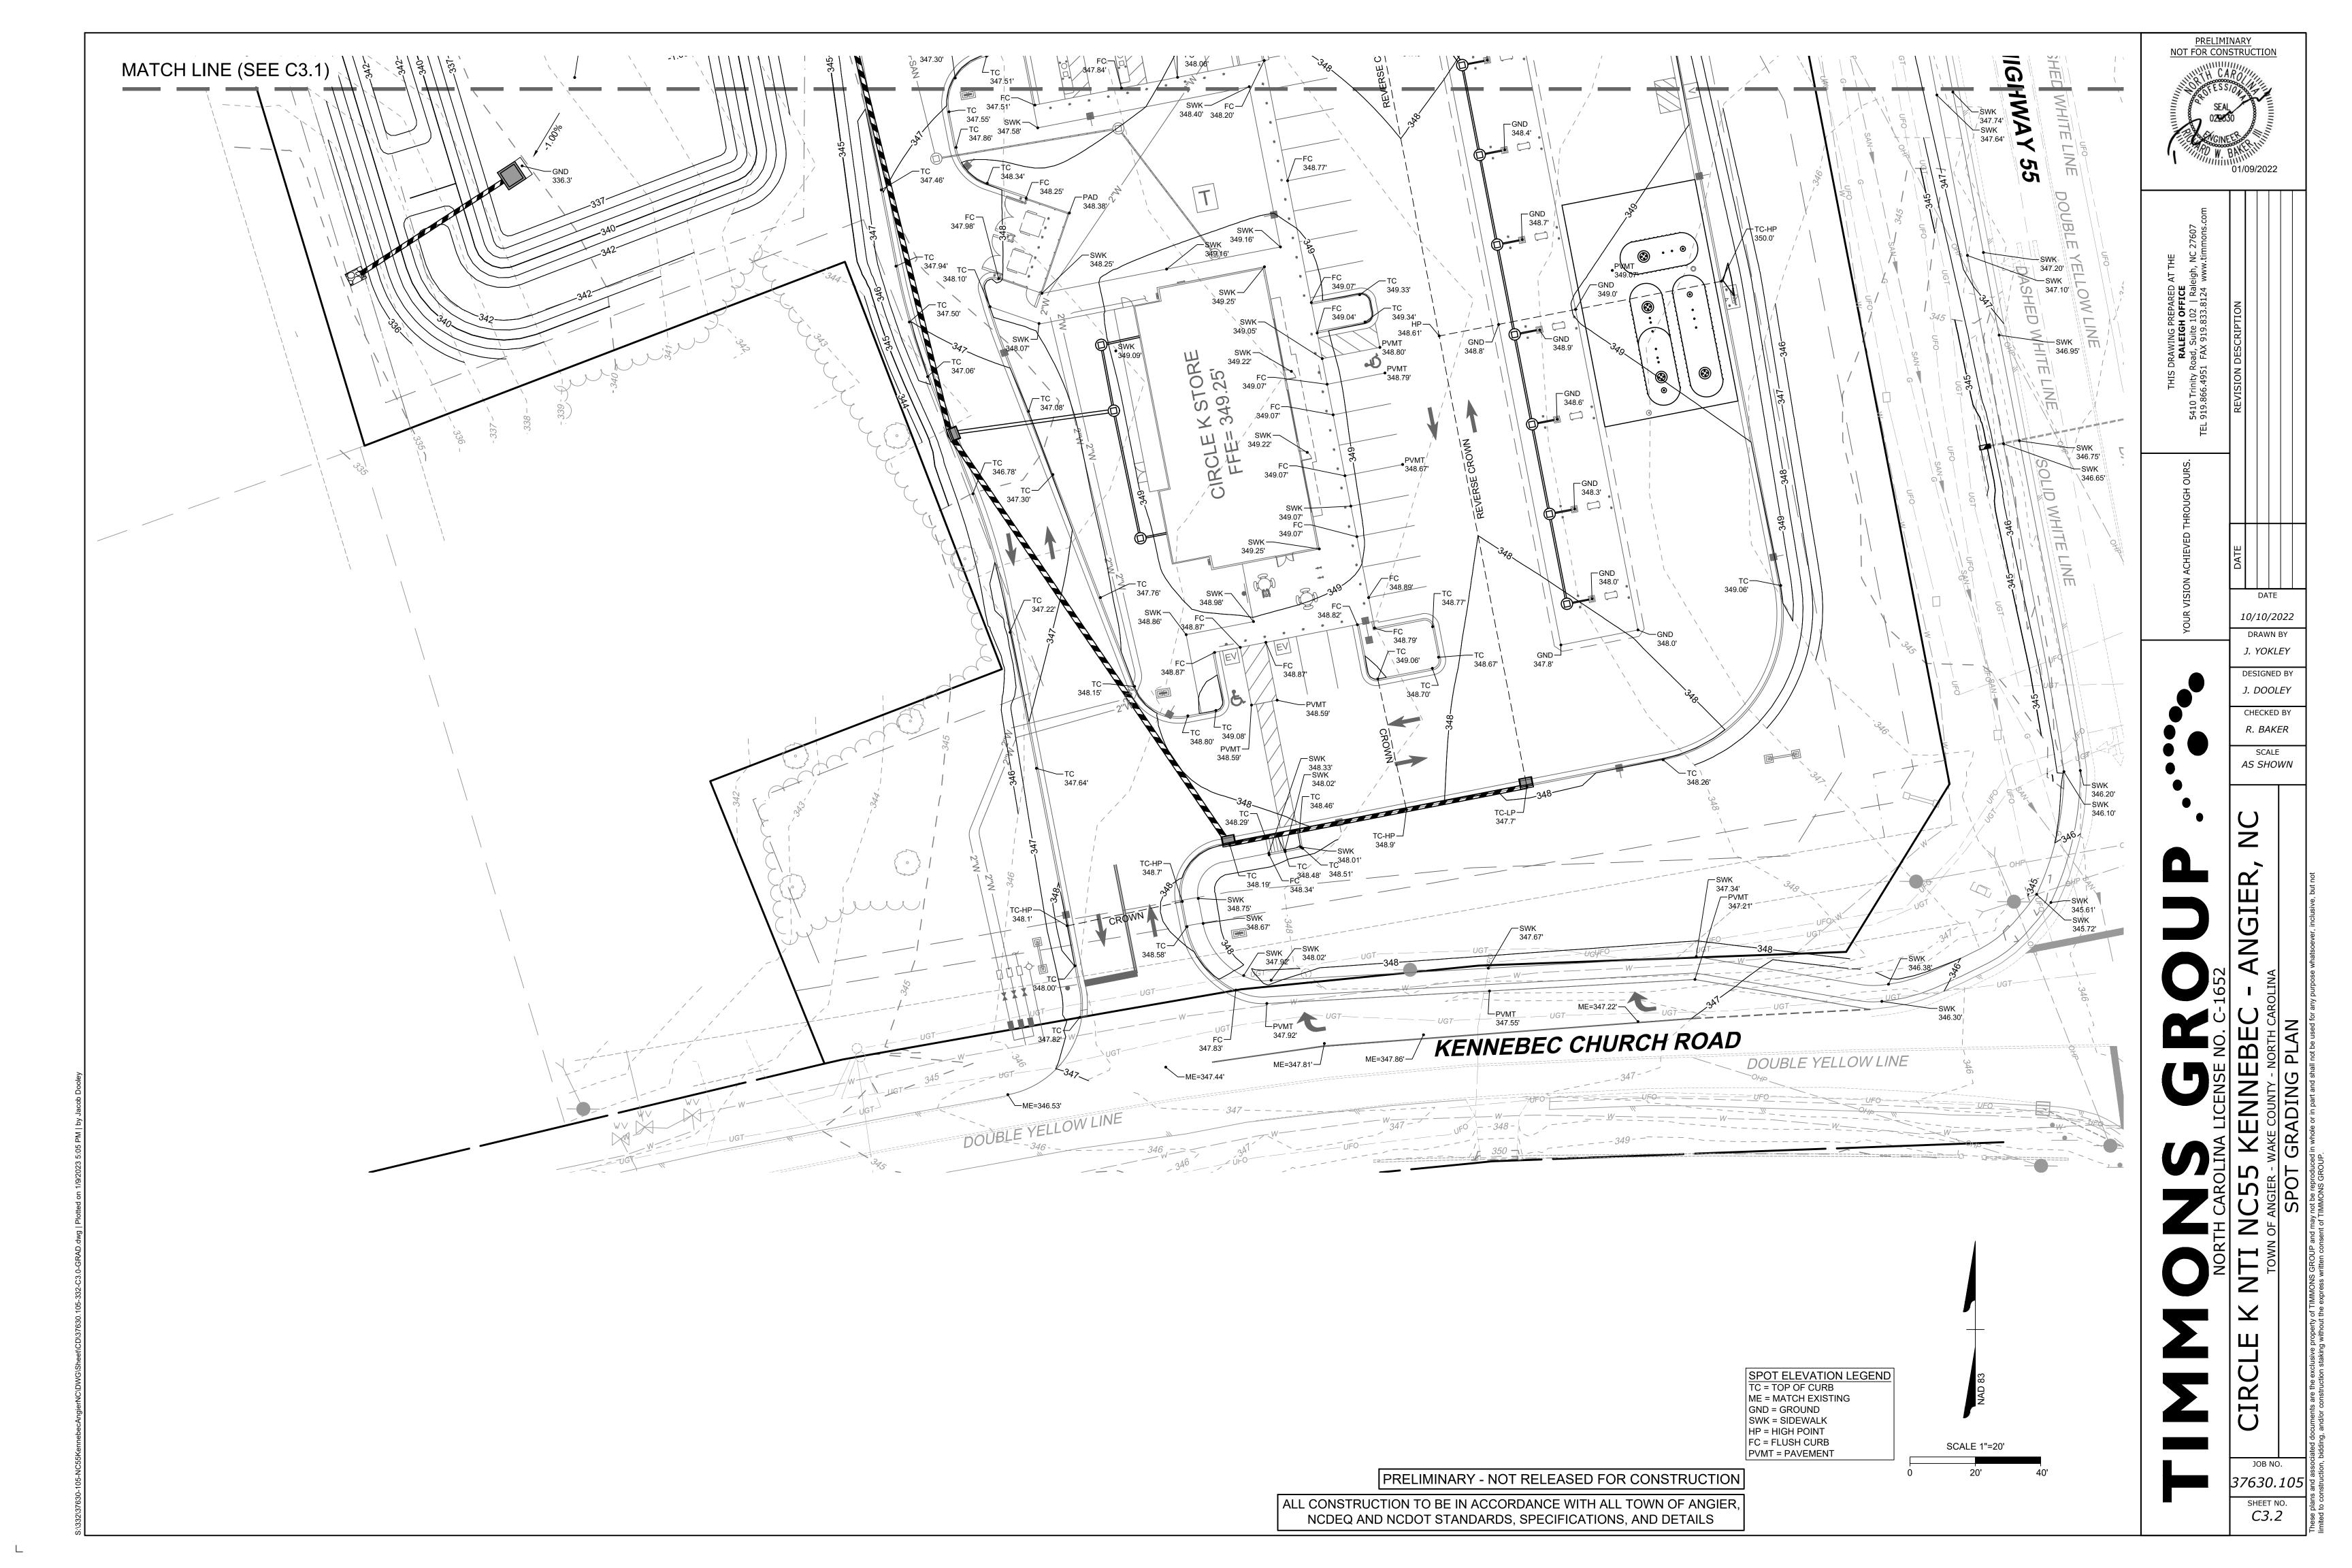

DRY POND CONSTRUCTION NOTES:


- SIDE SLOPES STABILIZED WITH VEGETATION SHALL BE NO STEEPER THAN 3:1.
- THE POND SHALL BE STABILIZED WITHIN 14 DAYS OF CONSTRUCTION.
- THE GRADES SHOWN ON THIS PLAN ARE FINISHED GRADES AND INCLUDE AT LEAST FOUR INCHES OF TOPSOIL IS REQUIRED FOR BOTH LINED AND UNLINED PONDS. A SOIL ANALYSIS SHOULD BE CONDUCTED WITHIN THE STORMWATER FACILITY AREA TO ASSURE HEALTHY VEGETATION GROWTH AND TO PROVIDE ADEQUATE INFILTRATION RATES.
- PRIOR TO CERTIFICATION, A DENSE STAND OF NON-CLUMPING TURF GRASS MUST BE IN PLACE ON ALL SLOPES, DAM, AND SPILLWAY. CONTRACTOR TO RE-SEED OR RE-SOD BARE SPOTS AS NEEDED AND INSTALL SLOPE STABILIZATION NETTING.

BERM EMBANKMENT AND SOIL COMPACTION SPECIFICATIONS:

- CONTROLLED FILL, AS SPECIFIED BY THE GEOTECHNICAL ENGINEER, IN THE BERM EMBANKMENT /KEY TRENCH SHALL BE PLACED IN 6-INCH LOOSE LAYERS (3-INCH LOOSE LAYERS WITHIN 3-FEET OF EITHER SIDE OF THE PRINCIPAL SPILLWAY PIPE TO A DEPTH OF 2-FEET OVER THE PIPE) AND SHALL BE COMPACTED TO A DENSITY OF NO LESS THAN 95% OF THE STANDARD PROCTOR MAXIMUM DENSITY AT A MOISTURE CONTENT OF + OR - TWO PERCENTAGE POINTS OF THE OPTIMUM MOISTURE CONTENT IN 2. ALL VISIBLE ORGANIC DEBRIS SUCH AS ROOTS AND LIMBS SHALL BE REMOVED FROM THE FILL MATERIAL PRIOR TO COMPACTION TO THE REQUIRED DENSITY. SOILS WITH
- ORGANIC MATTER CONTENT EXCEEDING 5% BY WEIGHT SHALL NOT BE USED. STONES GREATER THAN 3-INCH (IN ANY DIRECTION) SHALL BE REMOVED FROM THE FILL PRIOR TO COMPACTION.
- 3. FILL MATERIAL PLACED AT DENSITIES LOWER THAN SPECIFIED MINIMUM DENSITIES OR AT MOISTURE CONTENTS OUTSIDE THE SPECIFIED RANGES OR OTHERWISE NOT CONFORMING TO SPECIFIED REQUIREMENTS SHALL BE REMOVED AND REPLACED WITH ACCEPTABLE MATERIALS.

UNDERCUTTING SHALL BE PERFORMED AT THE DISCRETION OF THE GEOTECHNICAL ENGINEER AND SHALL BE MONITORED AND DOCUMENTED. IN NO CASE SHALL THERE

- ANY FILL LAYER THAT IS SMOOTH DRUM ROLLED TO REDUCE MOISTURE PENETRATION DURING A STORM EVENT SHALL BE PROPERLY SCARIFIED PRIOR TO THE PLACEMENT OF THE NEXT SOIL LIFT.
- SURFACE WATER AND STREAM FLOW SHALL BE CONTINUOUSLY CONTROLLED THROUGHOUT CONSTRUCTION AND THE PLACEMENT OF CONTROLLED FILL. FOUNDATION AREAS MAY REQUIRE UNDERCUTTING OF COMPRESSIBLE AND/OR UNSUITABLE SOILS IN ADDITION TO THAT INDICATED ON THE PLANS. ALL SUCH
- BE AN ATTEMPT TO STABILIZE ANY PORTIONS OF THE FOUNDATION SOILS WITH CRUSHED STONE. TREATMENT OF SEEPAGE AREAS, SUBGRADE PREPARATION, FOUNDATION DEWATERING AND ROCK FOUNDATION PREPARATION (I.E., TREATMENT WITH SLUSH GROUTING,
- DENTAL CONCRETE, ETC.) MAY BE REQUIRED AT THE DISCRETION OF THE GEOTECHNICAL ENGINEER. ALL SUCH ACTIVITIES SHALL BE CLOSELY MONITORED AND DOCUMENTED BY THE GEOTECHNICAL ENGINEER.
- FILL ADJACENT TO THE RISER AND PRINCIPAL SPILLWAY PIPE SHALL BE PLACED SO THAT LIFTS ARE AT THE SAME LEVEL ON BOTH SIDES OF THE STRUCTURES. EARTHWORK COMPACTION WITHIN 3-FEET OF ANY STRUCTURES SHALL BE ACCOMPLISHED BY MEANS OF HAND TAMPERS, MANUALLY DIRECTED POWER TAMPERS OR
- PLATE COMPACTORS OR MINIATURE SELF-PROPELLED ROLLERS.
- COMPACTION BY MEANS OF DROP WEIGHTS FROM A CRANE OR HOIST SHALL NOT BE PERMITTED.
- HEAVY EQUIPMENT SHALL NOT BE ALLOWED TO PASS OVER CAST-IN-PLACE STRUCTURES (INCLUDING THE CRADLE) UNTIL ADEQUATE CURING TIME HAS ELAPSED.
- INSTALL CLAY LINER PER MANUFACTURER'S INSTALLATION INSTRUCTIONS.
- TO RE-ESTABLISH VEGETATION AFTER CONSTRUCTION, A 2- TO 3-INCH LAYER OF TOPSOIL SHALL BE PLACED ON THE DISTURBED EMBANKMENT SURFACE AND THE AREA TEMPORARILY SEEDED AND MULCHED OR HYDROSEEDED WITH NON-CLUMPING TURF GRASS.
- 14. NO TREES OR WOODY VEGETATION ARE ALLOWED TO BE PLANTED ON THE DAM OR EMBANKMENT.

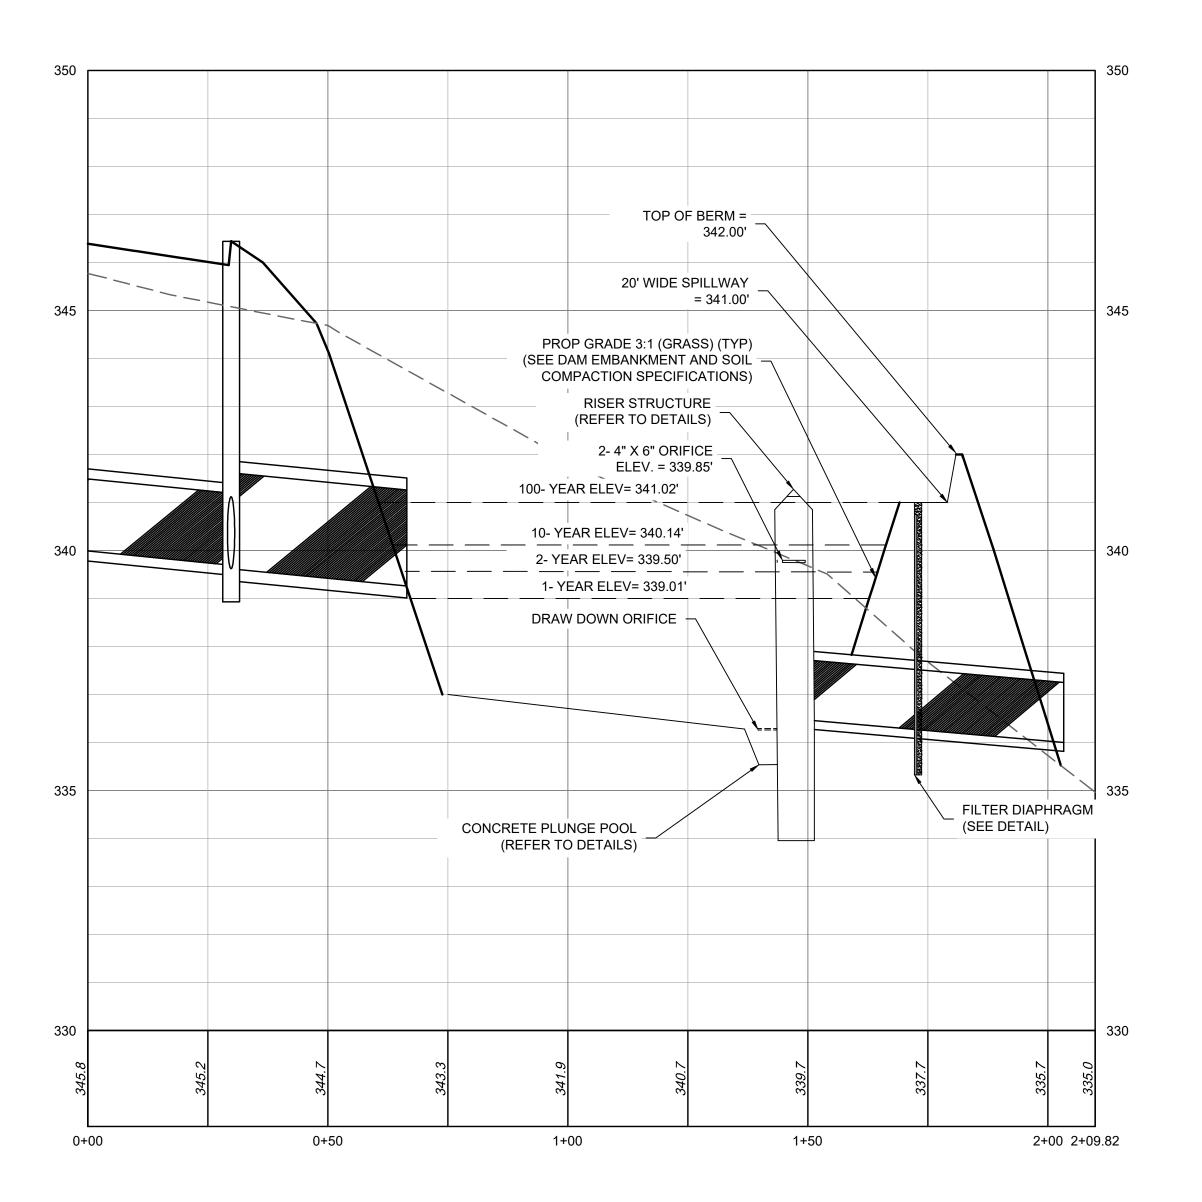


DRY POND - PROFILE VIEW

PROFILE SCALE

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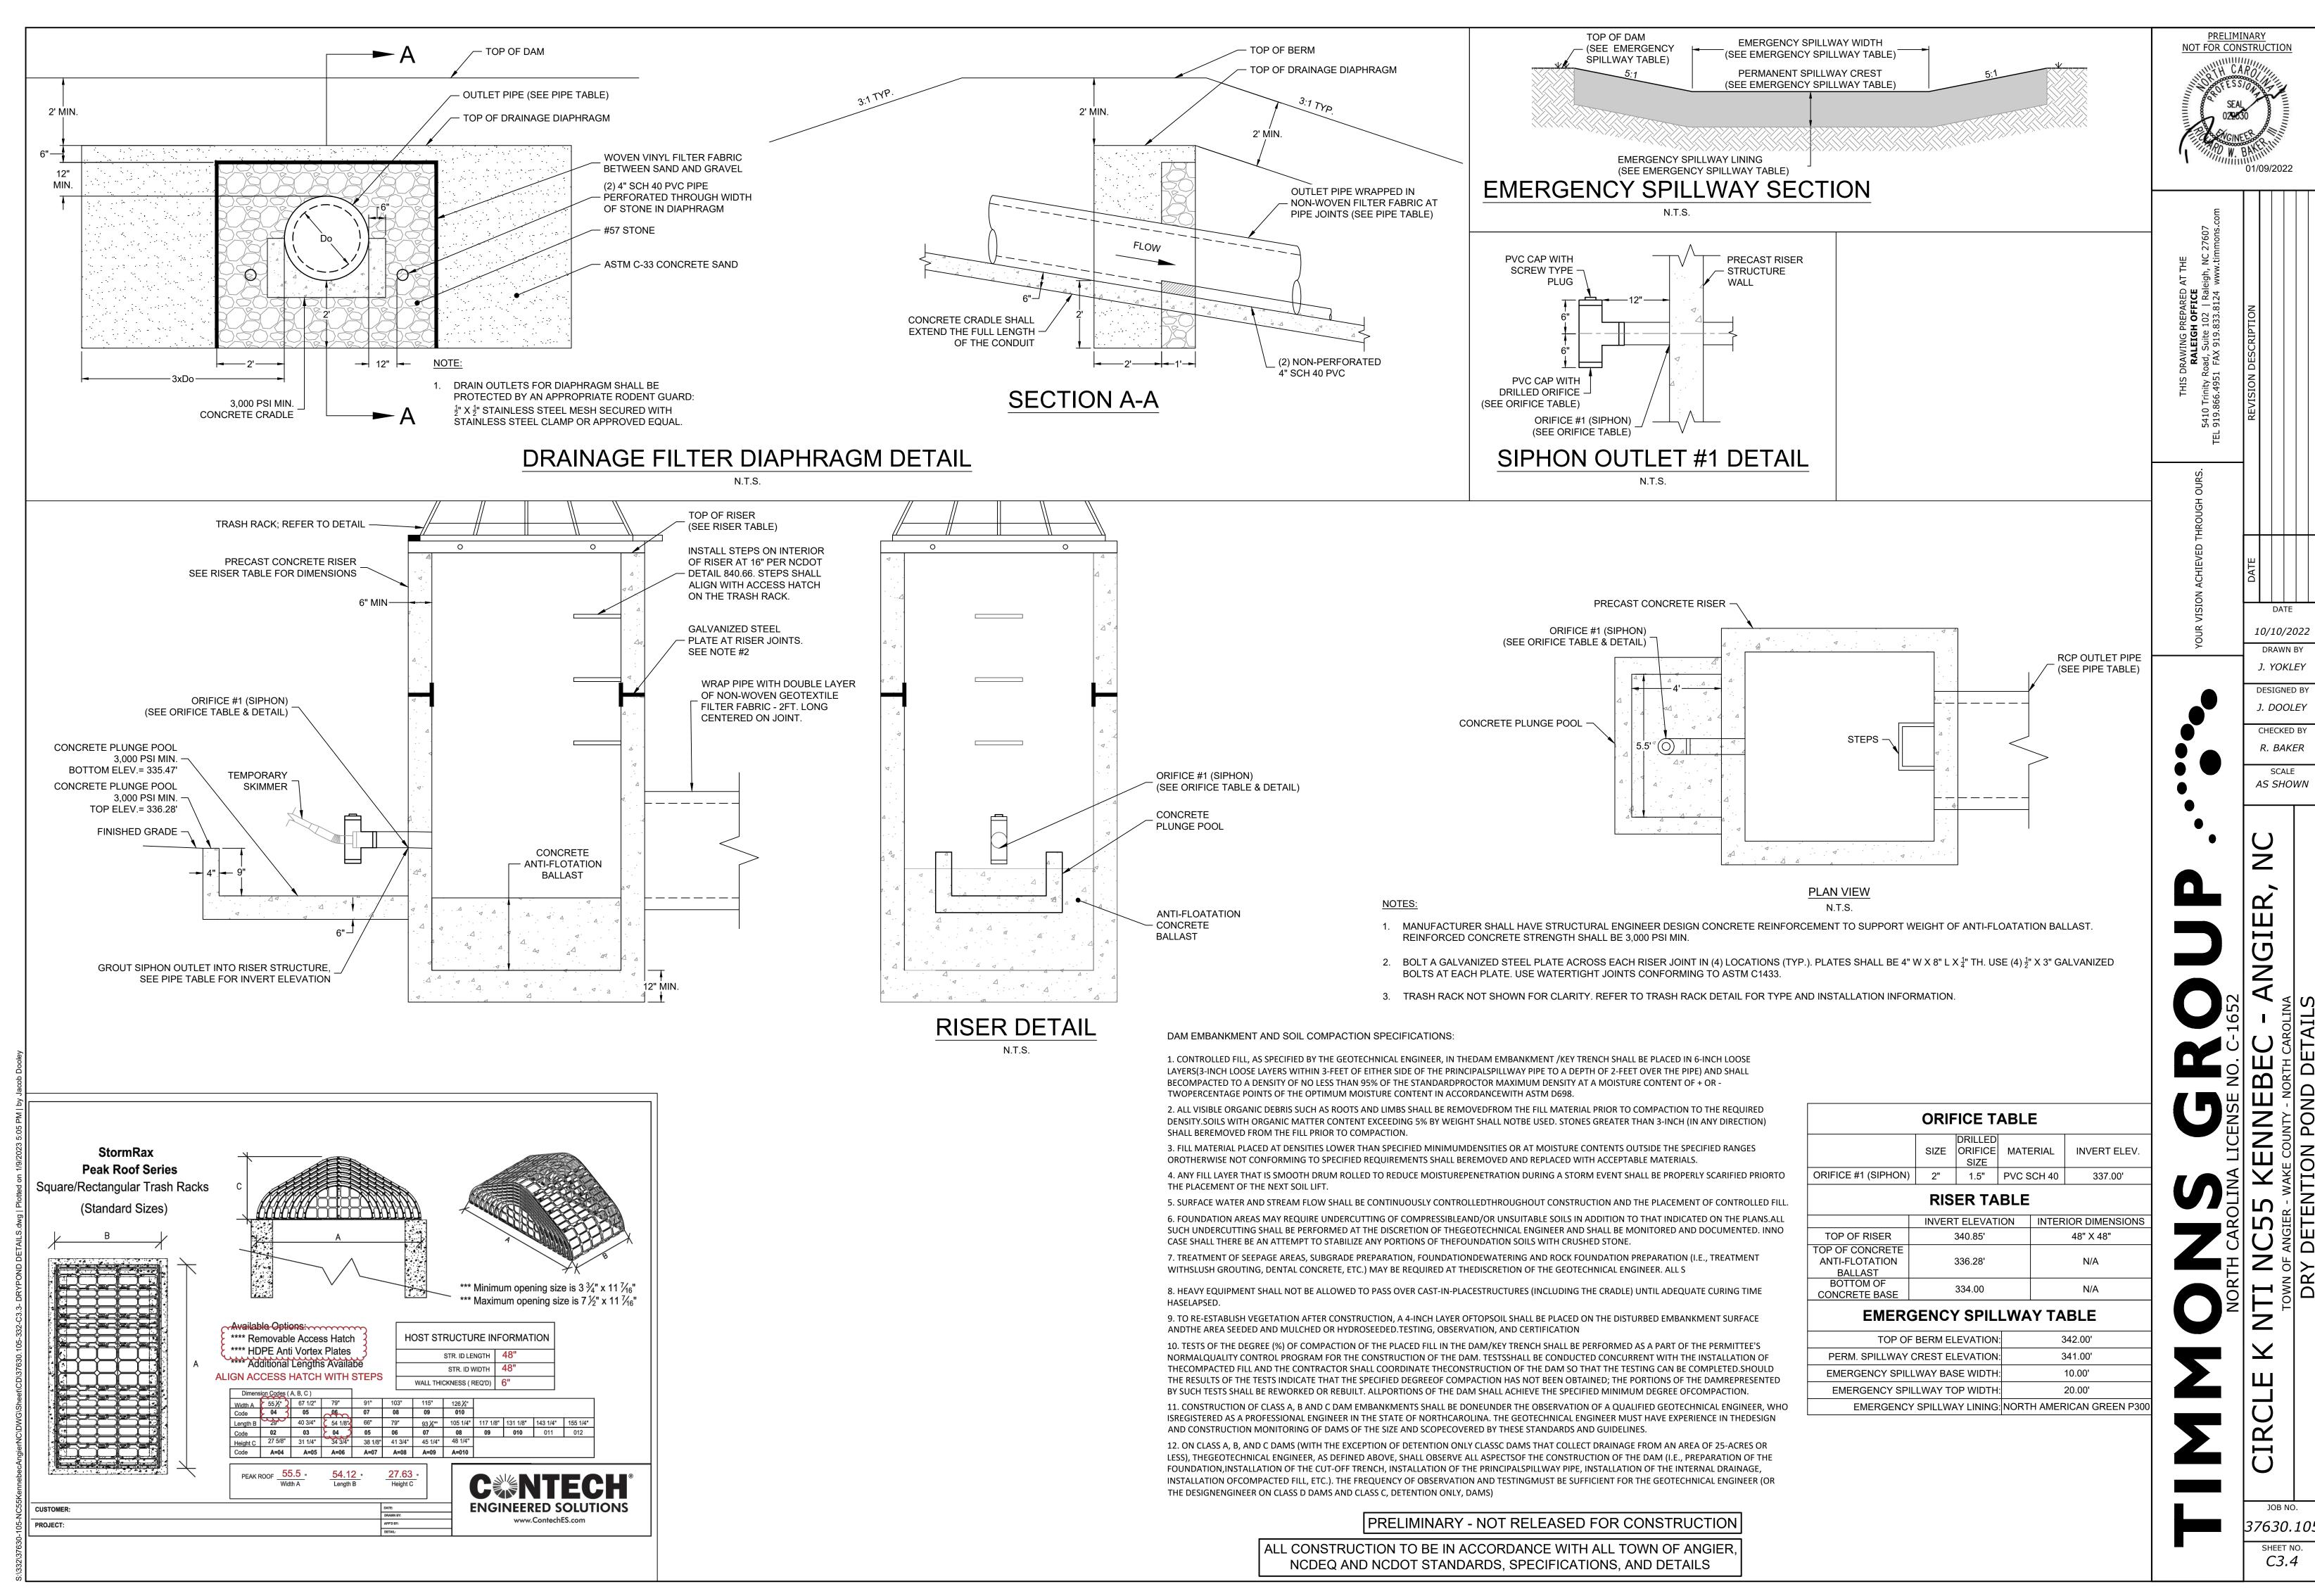
10/10/2022 DRAWN BY J. YOKLEY **DESIGNED BY** J. DOOLEY


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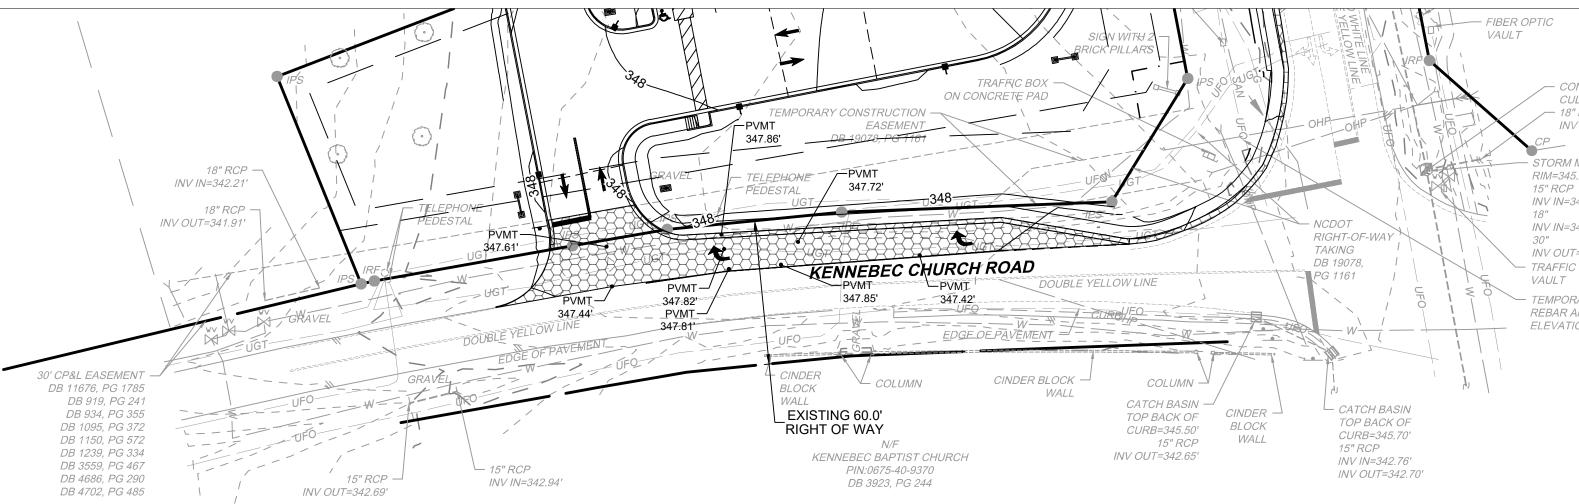
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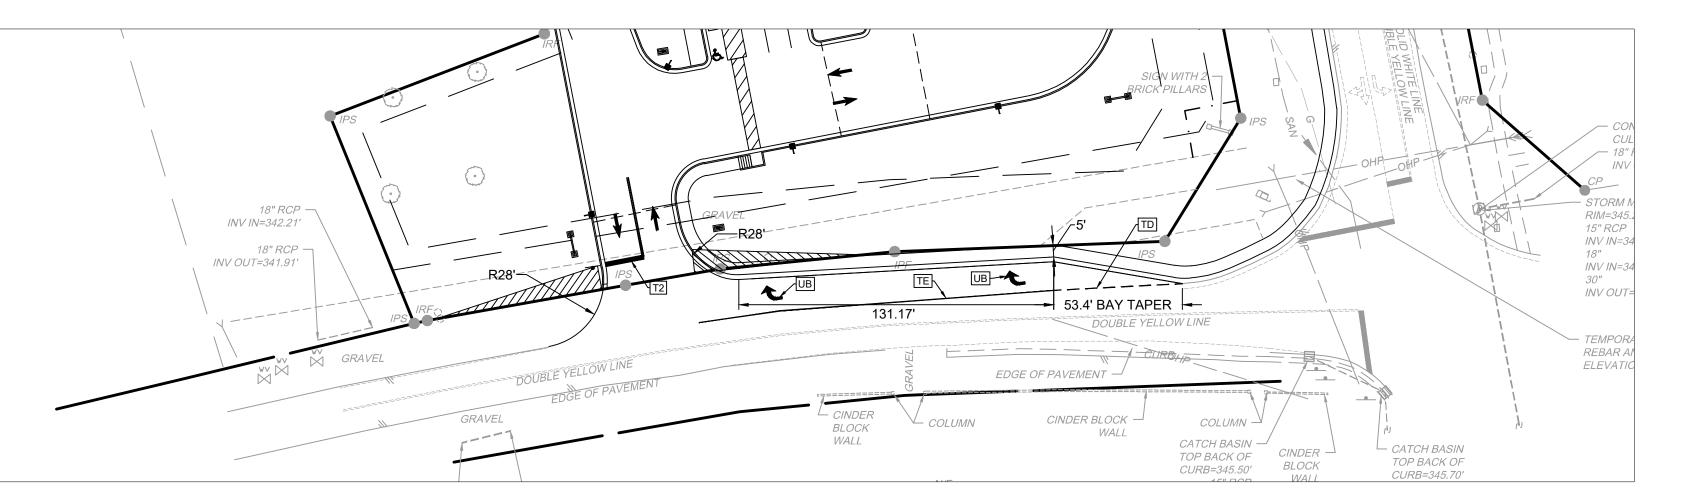


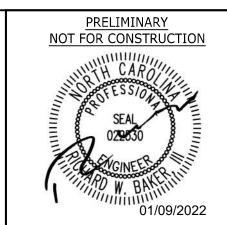

KENNEBEC CHURCH ROAD - EXISTING CONDITIONS - EXISTING ROW




KENNEBEC CHURCH ROAD - PROPOSED WIDENING, TRAFFIC SIGNAL MODIFICATIONS, AND GRADING

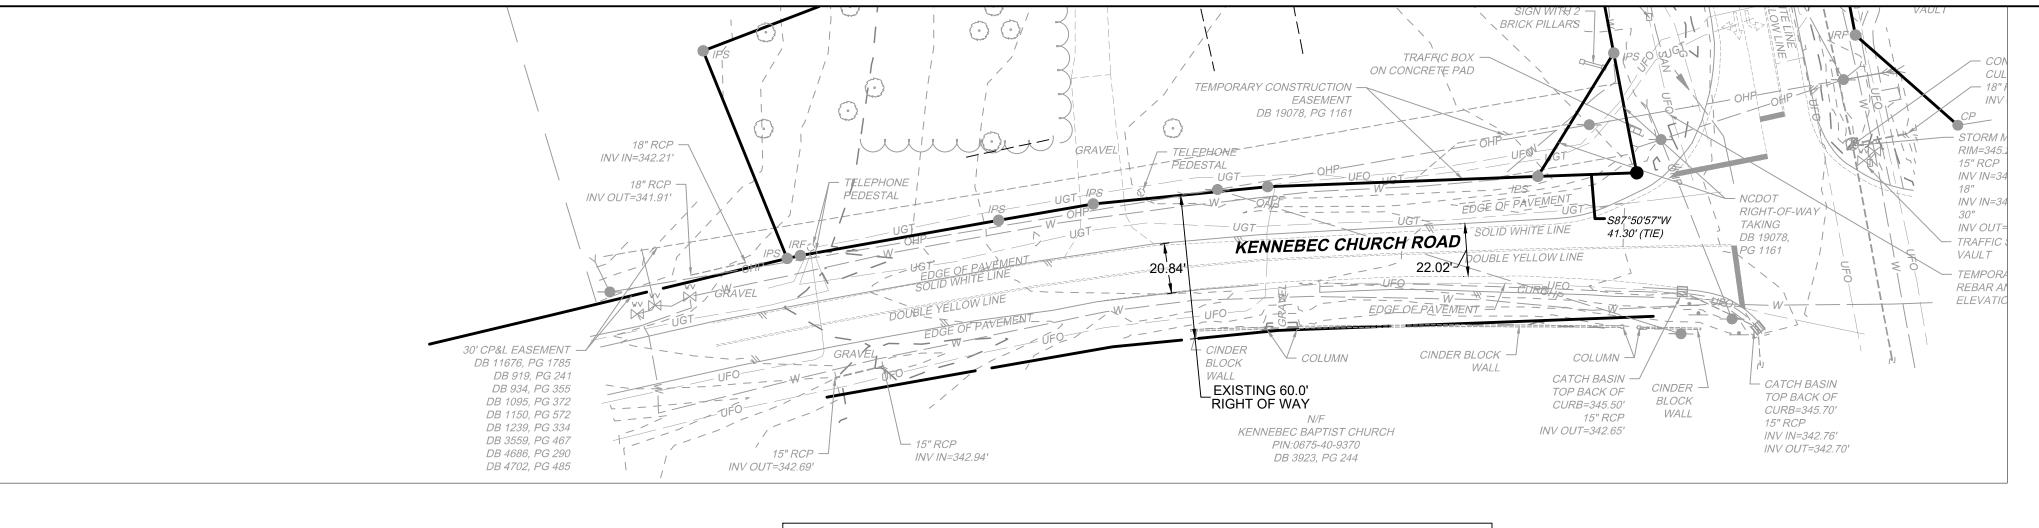

KENNEBEC CHURCH ROAD- PROPOSED STRIPING AND SIGNAGE

			Linear	
Symbol	Description	Material	Length	
•			Adjustmen	
T2	WHITE STOPBAR (24", 90 MIL); REFER TO NCDOT STANDARD DETAIL 1205.01.	Thermo	1	
TD	3 FT 9 FT./SP WHITE MINISKIP (4", 90 MIL); REFER TO NCDOT STANDARD DETAIL 1205.01.	Thermo	0.25	
TE	WHITE SOLID LANE LINE (4", 90 MIL); REFER TO NCDOT STANDARD DETAIL 1205.01.	Thermo	1	
UB	RIGHT TURN ARROW (90 MIL); REFER TO NCDOT STANDARD DETAIL 1205.08.	Thermo	1	

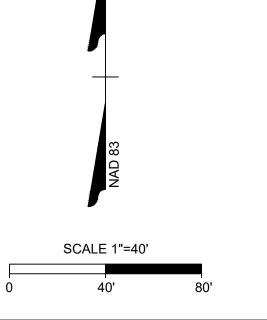

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TRANSPORTATION CONSTRUCTION NOTES

- 1. ALL CONSTRUCTION SHALL BE IN ACCORDANCE WITH TOWN OF ANGIER AND/OR NCDOT STANDARDS. 2. THE CONTRACTOR SHALL CONDUCT THE WORK IN A SAFE MANNER AND WITH A MINIMUM AMOUNT OF
- INCONVENIENCE TO TRAFFIC.
- 3. THE CONTRACTOR SHALL BE RESPONSIBLE FOR ALL TRAFFIC CONTROL AND SHALL ADHERE TO THE PROVISIONS OF THE MUTCH (MOST CURRENT EDITION).
- 4. PRIOR TO START OF WORK, A PRE-CONSTRUCTION MEETING MUST BE SET UP WITH THE CONTRACTOR AND NCDOT
- 5. PRIOR TO CONSTRUCTION BEGINNING, ALL SIGNAGE AND TRAFFIC CONTROL SHALL BE IN PLACE.
- 6. THE CONTRACTOR SHALL REPAIR ALL DAMAGED INFRASTRUCTURE IN THE RIGHT-OF-WAY AND RESTORE IT TO
- PREVIOUS OR BETTER CONDITION. 7. THE CONTRACTOR SHALL REPAIR ANY DAMAGES TO ADJACENT PROPERTIES AND RESTORE IT TO PREVIOUS OR
- BETTER CONDITION.
- 8. ALL SIDEWALKS MUST BE ACCESSIBLE TO PERSONS WHO ARE VISUALLY IMPAIRED AND PEOPLE WITH MOBILITY DISABILITIES. PEDESTRIAN EXISTING ROUTES AND ALTERNATE PEDESTRIAN ROUTES DURING CONSTRUCTION WILL BE REQUIRED TO BE COMPLIANT WITH THE PUBLIC RIGHTS OF WAY ACCESSIBILITY GUIDELINES (PROWAG), 2010 ADA STANDARDS FOR ACCESSIBLE DESIGN AND THE MANUAL ON UNIFORM TRAFFIC CONTROL DEVICES (MUTCD).

TRAFFIC CONTROL AND PEDESTRIAN PLAN NOTES **GENERAL NOTES:**

- ALL WORK SHALL BE IN ACCORDANCE WITH TOWN OF ANGIER AND/OR NCDOT STANDARD DETAILS AND
- SPECIFICATIONS. • PRIOR TO THE START OF WORK, THE CLIENT SHALL SCHEDULE A PRE-CONSTRUCTION MEETING WITH NCDOT TO
- REVIEW THE SPECIFIC COMPONENTS OF THE APPROVED PLAN, AND ENSURE ALL PERMITS ARE ISSUED. • MUST HAVE AN ISSUED RIGHT-OF-WAY PERMIT FOR STREET, LANE AND/OR SIDEWALK CLOSURE TO CONDUCT ANY WORK IN THE RIGHT-OF-WAY.
- ALL PERMITS MUST BE AVAILABLE ON-SITE DURING THE OPERATION.
- FIELD ADJUSTMENTS TO THE APPROVED PLAN MAY BE REQUIRED BY NCDOT AS NEEDED DURING CONSTRUCTION. • ANY REVISION TO THE APPROVED PLAN MUST BE APPROVED BY NCDOT PRIOR TO IMPLEMENTATION.
- ANY DAMAGE TO THE RIGHT OF WAY SHALL BE REPAIRED PER NCDOT SPECIFICATIONS AT NO COST TO THE CITY.
- ALL PAVEMENT MARKINGS SHALL BE RESTORED TO ORIGINAL PLACEMENT AND CONDITIONS. • CONSTRUCTION FENCING SHOULD NOT ENCROACH INTO THE PUBLIC RIGHT OF WAY. IF IT DOES, IT MUST BE MOVABLE
- IN CASE ADJUSTMENTS HAVE TO BE MADE. NO DRILLING, BORING OR ANY PERMANENT FASTENING OF THE FENCE IS ALLOWED IN THE PUBLIC RIGHT OF WAY.
- NO PORTABLE RESTROOMS ARE PERMITTED IN THE PUBLIC RIGHT-OF-WAY. ACCESSIBLE RESTROOMS MUST BE PROVIDED ON SITE.
- ALL SIGNAGE MUST BE VERIFIED AND MAINTAINED PROPERLY BY CONTRACTOR BEFORE THE START OF WORK AND
- REMAIN INTACT FOR THE DURATION OF THE PROJECT. • DRIVEWAYS IMPACTED BY THE LANE CLOSURE MUST REMAIN ACCESSIBLE
- WHEN WORK IS PERFORMED WITHIN A SCHOOL ZONE DURING SCHOOL OPERATIONAL HOURS, WORK MUST NOT IMPEDE WITHIN THE POSTED SCHOOL TRAFFIC TIMES. THE WORK BEING PERFORMED MUST BE REPORTED TO THE
- PRINCIPAL OF THE SCHOOL PRIOR TO COMMENCEMENT OF WORK.
- SEDIMENT AND EROSION CONTROL DEVICES SHALL BE INSTALLED PRIOR TO THE COMMENCEMENT OF THE PROJECT. SUCH MEASURES INCLUDE BUT ARE NOT LIMITED TO: SILT FENCE, INLET PROTECTION, AND CONSTRUCTION ENTRANCE.
- THE STORM WATER CONTROL DEVICES CANNOT INTERFERE WITH ANY ADA ACCESSIBLE PATH.
- ALL EXISTING UNDERGROUND UTILITIES SHALL BE LOCATED PRIOR TO BEGINNING ANY EXCAVATION OR UNDERGROUND CONSTRUCTION. ALL UNDERGROUND UTILITY LOCATES SHALL BE ORDERED NO LESS THAN 3 DAYS PRIOR AND NO MORE THAN 12 DAYS PRIOR TO THE BEGINNING OF SAID EXCAVATION OR UNDERGROUND
- CONSTRUCTION. • CURB/SIDEWALK REMOVAL DEBRIS, PRE-MADE BUILDING PACKAGES, GRAVEL, SOD, ETC. SHALL NOT BE STOCKPILED
- WITHIN THE PUBLIC RIGHT-OF-WAY. • IF WORK IS BEING PERFORMED 5' FROM BACK OF CURB NO LANE CLOSURE IS REQUIRED. SIGNAGE OF WORK AHEAD IS
- REQUIRED TO NOTIFY TRAFFIC AND PEDESTRIANS. • IF WORK IS BEING PERFORMED 15' FROM THE EDGE OF PAVEMENT NO LANE CLOSURE. SIGNAGE OF WORK AHEAD IS
- REQUIRED TO NOTIFY TRAFFIC AND PEDESTRIANS. • A MINIMUM TWO-WAY ACCESS OF 20' IS REQUIRED AT ALL TIMES FOR TRAFFIC, NOT INCLUDING THE CURB AND GUTTER
- IF ANY OPERATOR/CONTRACTOR PARKS IN A RESIDENTIAL AREA FORCING THE HOMEOWNER/RESIDENT TO PARK ON
- THE OTHER SIDE OF THE ROAD, NARROWING TO 20' OR LESS, THE OPERATOR/CONTRACTOR IS LIABLE TO ENSURE A LANE CLOSURE PERMIT IS OBTAINED.
- SIGHT VISIBILITY MUST BE MAINTAINED AT ALL TIMES.

LANE OBSTRUCTIONS:

ALL TRAFFIC CONTROL SIGNAGE AND PRACTICES SHALL ADHERE TO THE MANUAL ON UNIFORM TRAFFIC CONTROL, AND THE LATEST EDITION OF THE NCDOT "STANDARD SPECIFICATION FOR ROADWAY STRUCTURES", NCDOT "ROADWAY STANDARD DRAWING MANUAL", AND THE NCDOT SUPPLEMENT TO THE MUTCD. • LANE OBSTRUCTIONS: PRIOR TO ANY LANE OBSTRUCTION, THE CONTRACTOR SHALL NOTIFY NCDOT AT LEAST FIVE

BUSINESS DAYS PRIOR TO THE START OF WORK. THE CONTRACTOR MUST HAVE AN APPROVED PERMIT NUMBER AND TRAFFIC CONTROL PLAN (IF PREVIOUSLY APPROVED).

IF THERE IS NO APPROVED TRAFFIC CONTROL PLAN OR PERMIT, THE CONTRACTOR WILL BE REQUIRED TO PROVIDE A PLAN AND PERMIT REQUEST FOR APPROVAL.

STREET OBSTRUCTIONS (FULL STREET CLOSURE FOR CONSTRUCTION PURPOSES):

FULL STREET CLOSURES MUST BE PERMITTED AND COORDINATED WITH NCDOT IN ADVANCE. LANE CLOSURES MUST BE COORDINATED WITH NCDOT IN ACCORDANCE WITH PERMITS.

- STREET OBSTRUCTIONS: PRIOR TO ANY FULL STREET OBSTRUCTION, THE CONTRACTOR SHALL NOTIFY NCDOT AT LEAST THREE WEEKS PRIOR TO THE START OF WORK. THE CONTRACTOR MUST HAVE AN APPROVED PERMIT NUMBER AND TRAFFIC CONTROL PLAN AND DETOUR PLAN (IF PREVIOUSLY APPROVED) AND PROVIDE THE FOLLOWING INFORMATION TO NCDOT.
- RIGHT-OF-WAY PERMIT NUMBER
- DURATION OF OBSTRUCTION
- CONTACT PERSON (NAME, PHONE NUMBER, EMAIL)
- IF THERE IS NO APPROVED TRAFFIC CONTROL PLAN, DETOUR PLAN AND PERMIT REQUEST, THE CONTRACTOR WILL BE REQUIRED TO PROVIDE A PLAN AND PERMIT REQUEST FOR APPROVAL.
- THE CONTRACTOR IS RESPONSIBLE FOR SENDING NOTIFICATIONS TO ALL AFFECTED PROPERTY AND BUSINESS OWNERS AT LEAST TWO WEEKS BEFORE THE START OF THE WORK.
- DRIVEWAYS IMPACTED BY THE STREET CLOSURE MUST REMAIN ACCESSIBLE.
- THE STREET MUST REMAIN ACCESSIBLE FOR LOCAL TRAFFIC.
- STEEL PLATING MUST BE AVAILABLE ON-SITE TO ALLOW FOR QUICK ACCESS FOR EMERGENCY VEHICLES OVER OPEN

SIDEWALK OBSTRUCTIONS

ALL SIDEWALKS ARE PUBLIC AND MUST BE ACCESSIBLE TO PEDESTRIANS WHO ARE VISUALLY IMPAIRED AND/OR PEOPLE WITH MOBILITY DISABILITIES. EXISTING AND ALTERNATIVE PEDESTRIAN ROUTES DURING CONSTRUCTION SHALL BE REQUIRED TO BE COMPLIANT WITH THE PUBLIC RIGHTS OF WAY ACCESSIBILITY GUIDELINES(PROWAG), THE ADA STANDARDS FOR ACCESSIBLE DESIGN AND THE MANUAL ON UNIFORM TRAFFIC CONTROL DEVICES (MUTCD). SIDEWALKS CAN BE OBSTRUCTED TEMPORARILY FOR A CONTRACTOR TO PERFORM WORK; HOWEVER PROPER SIDEWALK CLOSURES MUST BE OBTAINED. ANY OBSTRUCTION IN THE SIDEWALK MUST BE APPROVED PRIOR TO THE SETUP OF THE WORK AREA. ANY TIME A SIDEWALK IS OBSTRUCTED AND IMPEDES PEDESTRIANS, A SAFE ALTERNATIVE ROUTE MUST BE

SIDEWALK OBSTRUCTIONS: PRIOR TO ANY SIDEWALK OBSTRUCTION, THE CONTRACTOR SHALL NOTIFY NCDOT AT LEAST FIVE BUSINESS DAYS PRIOR TO THE START OF WORK. THE CONTRACTOR MUST HAVE AN APPROVED PERMIT NUMBER AND PEDESTRIAN PLAN (IF PREVIOUSLY APPROVED) AND PROVIDE THE FOLLOWING INFORMATION TO NCDOT.

- RIGHT-OF-WAY PERMIT NUMBER
- DURATION OF OBSTRUCTION CONTACT PERSON (NAME, PHONE NUMBER, EMAIL)
- IF THERE IS NO APPROVED PEDESTRIAN PLAN THE CONTRACTOR WILL BE REQUIRED TO PROVIDE A PLAN AND PERMIT REQUEST FOR APPROVAL.
- IF A SIDEWALK IS CLOSED AN ALTERNATIVE SAFE PEDESTRIAN PATH MUST BE PROVIDED. IF THE SIDEWALK IS CLOSED ALONG MAJOR CORRIDORS AN ADDITIONAL PERSON IS REQUIRED TO ASSIST IN TRAFFIC OF PEDESTRIANS.
- NO PLACEMENT OF EQUIPMENT OR MATERIALS IS ALLOWED OUTSIDE OF THE APPROVED AREA.
- THE SIDEWALK AND PAVEMENT SHALL BE FREE AND CLEAR OF DEBRIS AT ALL TIMES.
- SIGHT VISIBILITY MUST BE MAINTAINED AT ALL TIMES.

NOT FOR CONSTRUCTION

01/09/2022

DATE

10/10/2022 DRAWN BY

J. YOKLEY **DESIGNED BY** J. DOOLEY


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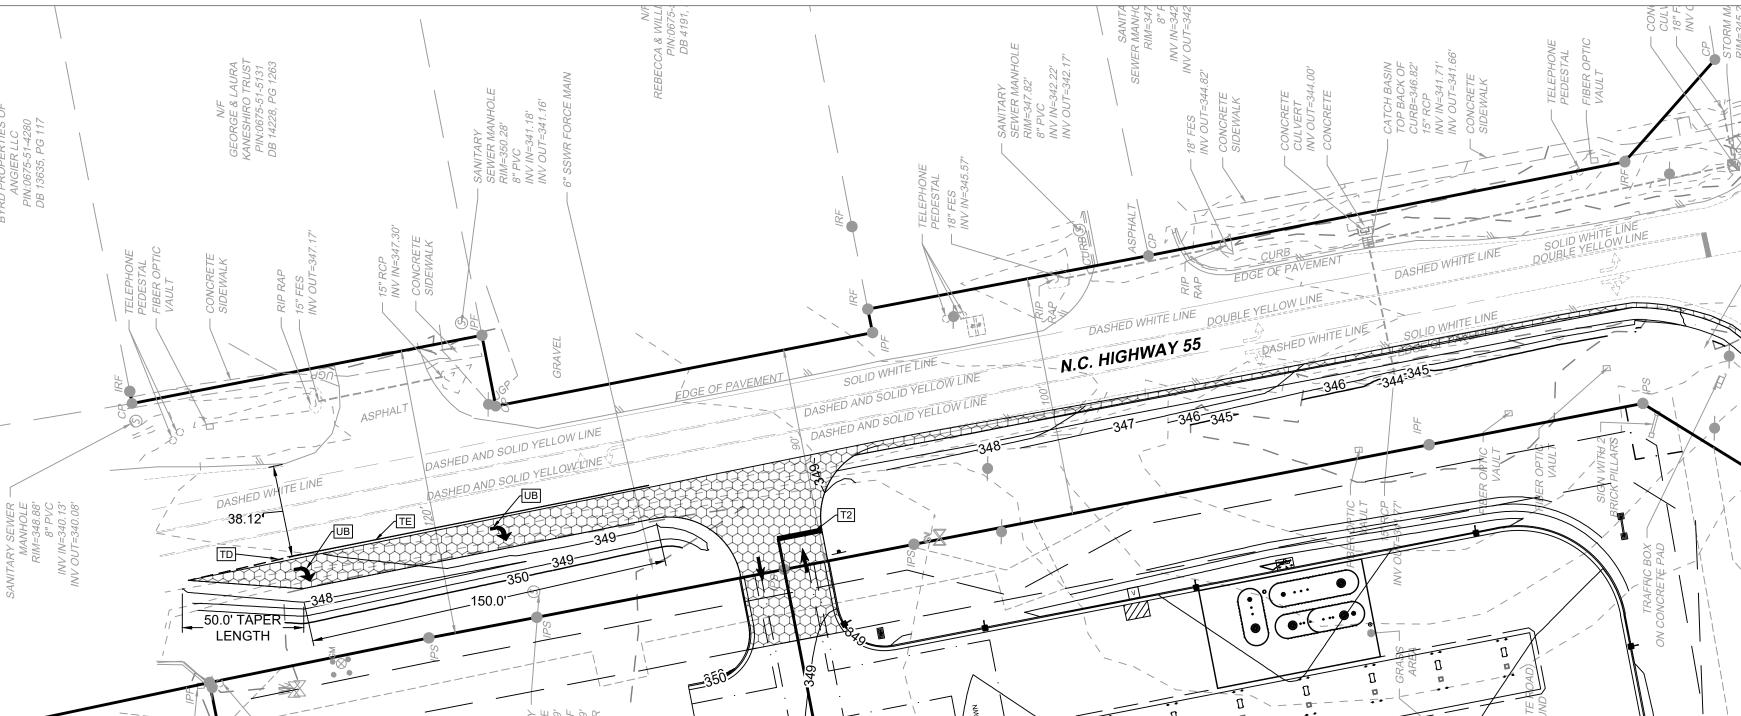
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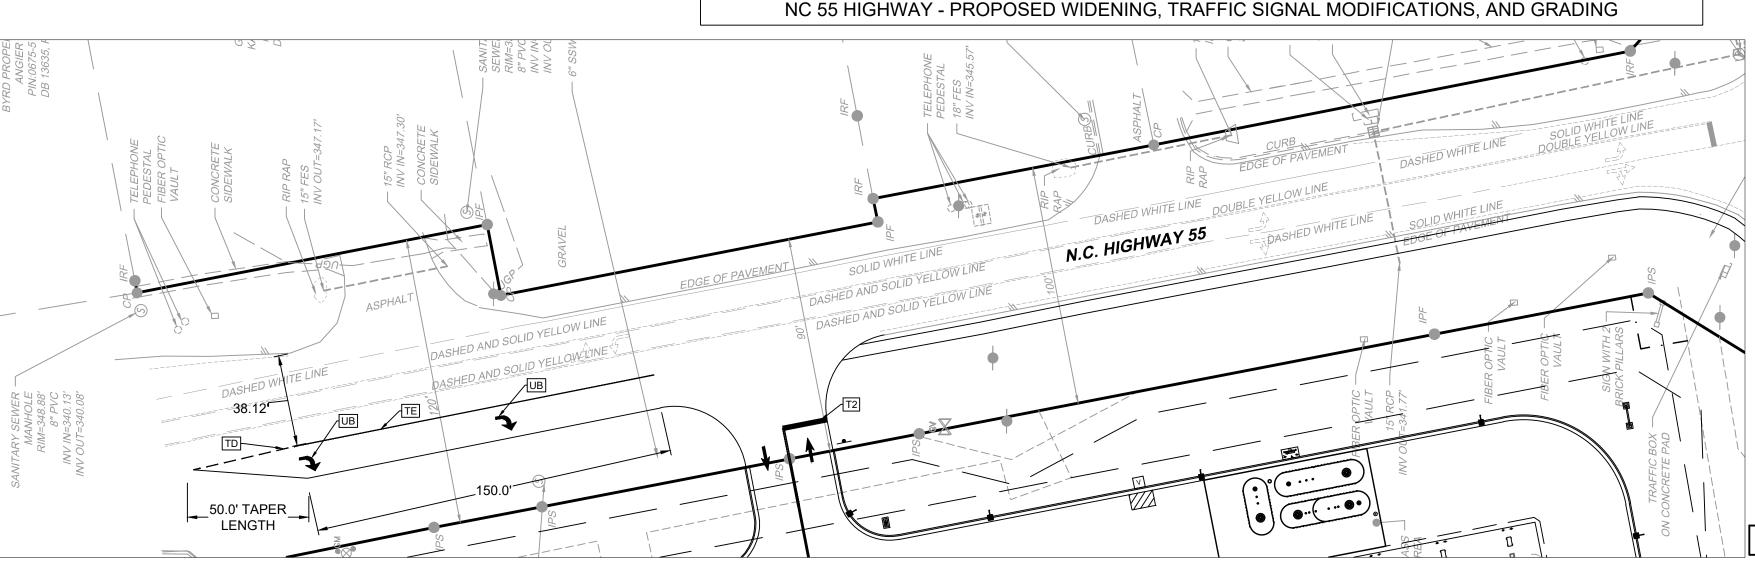
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NC 55 HIGHWAY- PROPOSED STRIPING AND SIGNAGE

TRANSPORTATION CONSTRUCTION NOTES

- 1. ALL CONSTRUCTION SHALL BE IN ACCORDANCE WITH TOWN OF ANGIER AND/OR NCDOT STANDARDS.
- 2. THE CONTRACTOR SHALL CONDUCT THE WORK IN A SAFE MANNER AND WITH A MINIMUM AMOUNT OF INCONVENIENCE TO TRAFFIC.
- 3. THE CONTRACTOR SHALL BE RESPONSIBLE FOR ALL TRAFFIC CONTROL AND SHALL ADHERE TO THE PROVISIONS OF
- THE MUTCH (MOST CURRENT EDITION).
- 4. PRIOR TO START OF WORK, A PRE-CONSTRUCTION MEETING MUST BE SET UP WITH THE CONTRACTOR AND NCDOT
- 5. PRIOR TO CONSTRUCTION BEGINNING, ALL SIGNAGE AND TRAFFIC CONTROL SHALL BE IN PLACE.
- 6. THE CONTRACTOR SHALL REPAIR ALL DAMAGED INFRASTRUCTURE IN THE RIGHT-OF-WAY AND RESTORE IT TO PREVIOUS OR BETTER CONDITION.
- 7. THE CONTRACTOR SHALL REPAIR ANY DAMAGES TO ADJACENT PROPERTIES AND RESTORE IT TO PREVIOUS OR BETTER CONDITION.
- 8. ALL SIDEWALKS MUST BE ACCESSIBLE TO PERSONS WHO ARE VISUALLY IMPAIRED AND PEOPLE WITH MOBILITY DISABILITIES. PEDESTRIAN EXISTING ROUTES AND ALTERNATE PEDESTRIAN ROUTES DURING CONSTRUCTION WILL
- BE REQUIRED TO BE COMPLIANT WITH THE PUBLIC RIGHTS OF WAY ACCESSIBILITY GUIDELINES (PROWAG), 2010 ADA STANDARDS FOR ACCESSIBLE DESIGN AND THE MANUAL ON UNIFORM TRAFFIC CONTROL DEVICES (MUTCD).

TRAFFIC CONTROL AND PEDESTRIAN PLAN NOTES **GENERAL NOTES:**

- ALL WORK SHALL BE IN ACCORDANCE WITH TOWN OF ANGIER AND/OR NCDOT STANDARD DETAILS AND SPECIFICATIONS.
- PRIOR TO THE START OF WORK, THE CLIENT SHALL SCHEDULE A PRE-CONSTRUCTION MEETING WITH NCDOT TO REVIEW THE SPECIFIC COMPONENTS OF THE
- APPROVED PLAN, AND ENSURE ALL PERMITS ARE ISSUED.
- MUST HAVE AN ISSUED RIGHT-OF-WAY PERMIT FOR STREET, LANE AND/OR SIDEWALK CLOSURE TO CONDUCT ANY WORK IN THE RIGHT-OF-WAY. • ALL PERMITS MUST BE AVAILABLE ON-SITE DURING THE OPERATION.
- FIELD ADJUSTMENTS TO THE APPROVED PLAN MAY BE REQUIRED BY NCDOT AS NEEDED DURING CONSTRUCTION.
- ANY REVISION TO THE APPROVED PLAN MUST BE APPROVED BY NCDOT PRIOR TO IMPLEMENTATION.
- ANY DAMAGE TO THE RIGHT OF WAY SHALL BE REPAIRED PER NCDOT SPECIFICATIONS AT NO COST TO THE CITY.
- ALL PAVEMENT MARKINGS SHALL BE RESTORED TO ORIGINAL PLACEMENT AND CONDITIONS. • CONSTRUCTION FENCING SHOULD NOT ENCROACH INTO THE PUBLIC RIGHT OF WAY. IF IT DOES, IT MUST BE MOVABLE IN CASE ADJUSTMENTS HAVE TO BE
- MADE. NO DRILLING, BORING OR ANY PERMANENT FASTENING OF THE FENCE IS ALLOWED IN THE PUBLIC RIGHT OF WAY.
- NO PORTABLE RESTROOMS ARE PERMITTED IN THE PUBLIC RIGHT-OF-WAY. ACCESSIBLE RESTROOMS MUST BE PROVIDED ON SITE.
- ALL SIGNAGE MUST BE VERIFIED AND MAINTAINED PROPERLY BY CONTRACTOR BEFORE THE START OF WORK AND REMAIN INTACT FOR THE DURATION OF THE
- DRIVEWAYS IMPACTED BY THE LANE CLOSURE MUST REMAIN ACCESSIBLE
- WHEN WORK IS PERFORMED WITHIN A SCHOOL ZONE DURING SCHOOL OPERATIONAL HOURS, WORK MUST NOT IMPEDE WITHIN THE POSTED SCHOOL TRAFFIC TIMES. THE WORK BEING PERFORMED MUST BE REPORTED TO THE PRINCIPAL OF THE SCHOOL PRIOR TO COMMENCEMENT OF WORK.
- SEDIMENT AND EROSION CONTROL DEVICES SHALL BE INSTALLED PRIOR TO THE COMMENCEMENT OF THE PROJECT. SUCH MEASURES INCLUDE BUT ARE NOT. LIMITED TO: SILT FENCE, INLET PROTECTION, AND CONSTRUCTION ENTRANCE.
- THE STORM WATER CONTROL DEVICES CANNOT INTERFERE WITH ANY ADA ACCESSIBLE PATH.
- ALL EXISTING UNDERGROUND UTILITIES SHALL BE LOCATED PRIOR TO BEGINNING ANY EXCAVATION OR UNDERGROUND CONSTRUCTION. ALL UNDERGROUND UTILITY LOCATES SHALL BE ORDERED NO LESS THAN 3 DAYS PRIOR AND NO MORE THAN 12 DAYS PRIOR TO THE BEGINNING OF SAID EXCAVATION OR UNDERGROUND CONSTRUCTION.
- CURB/SIDEWALK REMOVAL DEBRIS, PRE-MADE BUILDING PACKAGES, GRAVEL, SOD, ETC. SHALL NOT BE STOCKPILED WITHIN THE PUBLIC RIGHT-OF-WAY.
- IF WORK IS BEING PERFORMED 5' FROM BACK OF CURB NO LANE CLOSURE IS REQUIRED. SIGNAGE OF WORK AHEAD IS REQUIRED TO NOTIFY TRAFFIC AND
- IF WORK IS BEING PERFORMED 15' FROM THE EDGE OF PAVEMENT NO LANE CLOSURE. SIGNAGE OF WORK AHEAD IS REQUIRED TO NOTIFY TRAFFIC AND PEDESTRIANS.
- A MINIMUM TWO-WAY ACCESS OF 20' IS REQUIRED AT ALL TIMES FOR TRAFFIC, NOT INCLUDING THE CURB AND GUTTER AREAS.
- IF ANY OPERATOR/CONTRACTOR PARKS IN A RESIDENTIAL AREA FORCING THE HOMEOWNER/RESIDENT TO PARK ON THE OTHER SIDE OF THE ROAD, NARROWING TO 20' OR LESS, THE OPERATOR/CONTRACTOR IS LIABLE TO ENSURE A LANE CLOSURE PERMIT IS OBTAINED.

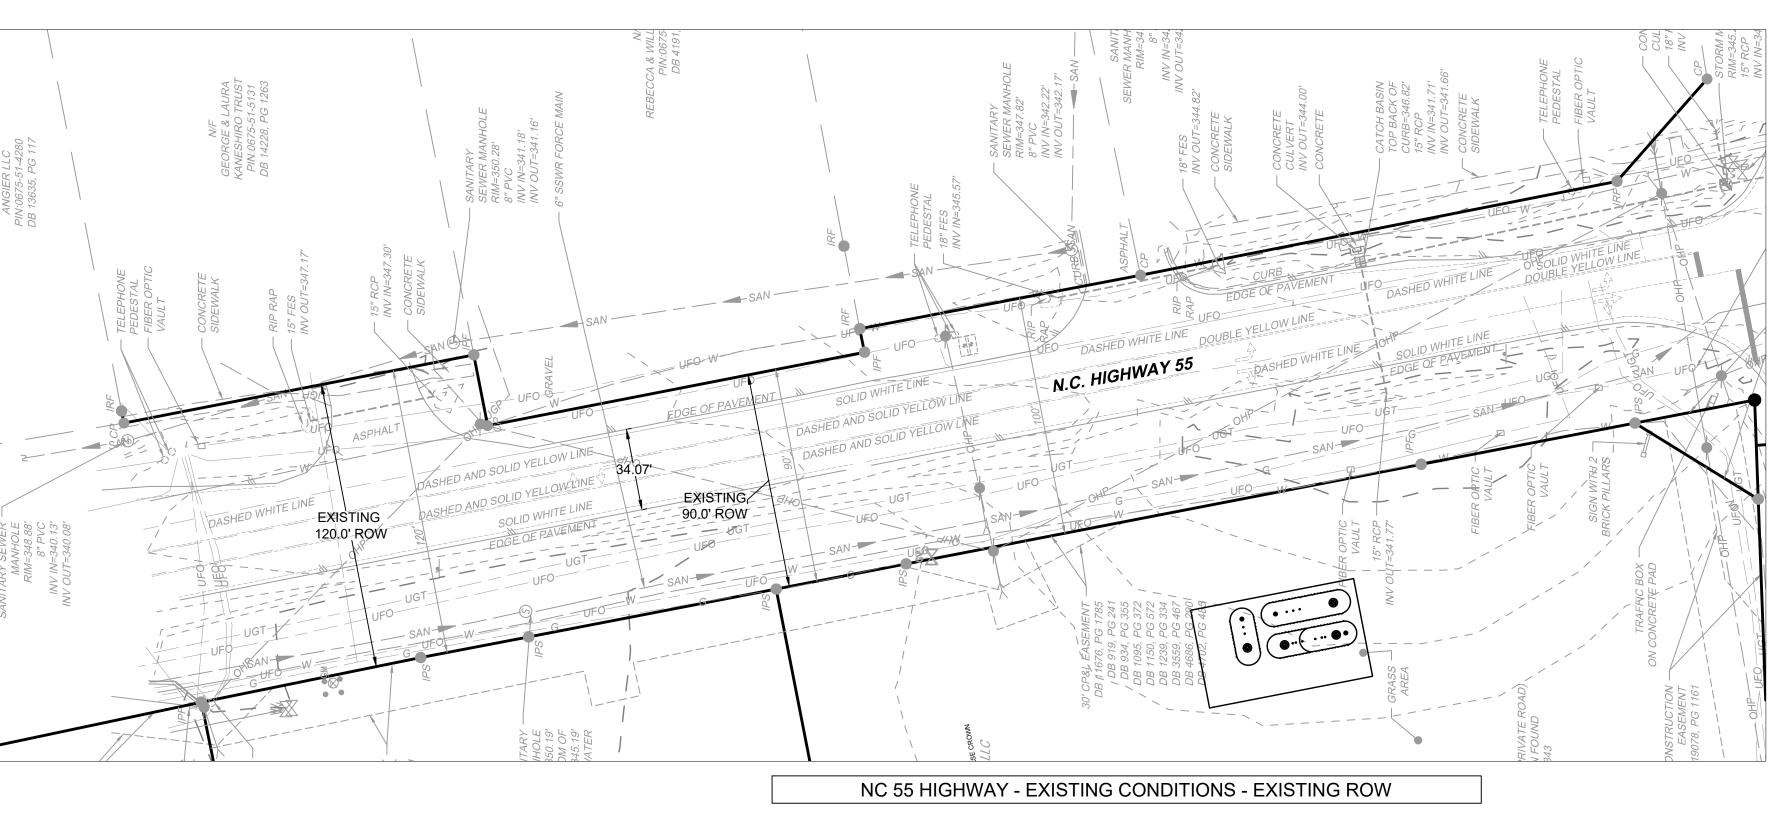- ALL TRAFFIC CONTROL SIGNAGE AND PRACTICES SHALL ADHERE TO THE MANUAL ON UNIFORM TRAFFIC CONTROL, AND THE LATEST EDITION OF THE NCDOT "STANDARD SPECIFICATION FOR ROADWAY STRUCTURES", NCDOT "ROADWAY STANDARD DRAWING MANUAL", AND THE NCDOT SUPPLEMENT TO THE MUTCD. • LANE OBSTRUCTIONS: PRIOR TO ANY LANE OBSTRUCTION, THE CONTRACTOR SHALL NOTIFY NCDOT AT LEAST FIVE BUSINESS DAYS PRIOR TO THE START OF
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- RIGHT-OF-WAY PERMIT NUMBER
- DURATION OF OBSTRUCTION

• SIGHT VISIBILITY MUST BE MAINTAINED AT ALL TIMES.

- IF THERE IS NO APPROVED TRAFFIC CONTROL PLAN, DETOUR PLAN AND PERMIT REQUEST, THE CONTRACTOR WILL BE REQUIRED TO PROVIDE A PLAN AND PERMIT REQUEST FOR APPROVAL.
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- DRIVEWAYS IMPACTED BY THE STREET CLOSURE MUST REMAIN ACCESSIBLE.
- THE STREET MUST REMAIN ACCESSIBLE FOR LOCAL TRAFFIC.
- STEEL PLATING MUST BE AVAILABLE ON-SITE TO ALLOW FOR QUICK ACCESS FOR EMERGENCY VEHICLES OVER OPEN CUTS.

- AND ALTERNATIVE PEDESTRIAN ROUTES DURING CONSTRUCTION SHALL BE REQUIRED TO BE COMPLIANT WITH THE PUBLIC RIGHTS OF WAY ACCESSIBILITY
- GUIDELINES(PROWAG), THE ADA STANDARDS FOR ACCESSIBLE DESIGN AND THE MANUAL ON UNIFORM TRAFFIC CONTROL DEVICES (MUTCD)
- SIDEWALK OBSTRUCTIONS: PRIOR TO ANY SIDEWALK OBSTRUCTION, THE CONTRACTOR SHALL NOTIFY NCDOT AT LEAST FIVE BUSINESS DAYS PRIOR TO THE START


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- THE SIDEWALK AND PAVEMENT SHALL BE FREE AND CLEAR OF DEBRIS AT ALL TIMES.
- SIGHT VISIBILITY MUST BE MAINTAINED AT ALL TIMES.

	TRAFFIC CONTROL KEYNOTES							
Symbol	Description	Material	Linear Length Adjustment					
T2	WHITE STOPBAR (24", 90 MIL); REFER TO NCDOT STANDARD DETAIL 1205.01.	Thermo	1					
TD	3 FT 9 FT./SP WHITE MINISKIP (4", 90 MIL); REFER TO NCDOT STANDARD DETAIL 1205.01.	Thermo	0.25					
TE	WHITE SOLID LANE LINE (4", 90 MIL); REFER TO NCDOT STANDARD DETAIL 1205.01.	Thermo	1					
UB	RIGHT TURN ARROW (90 MIL); REFER TO NCDOT STANDARD DETAIL 1205.08.	Thermo	1					

PRELIMINARY - NOT RELEASED FOR CONSTRUCTION ALL CONSTRUCTION TO BE IN ACCORDANCE WITH ALL TOWN OF ANGIER,

NCDEQ AND NCDOT STANDARDS, SPECIFICATIONS, AND DETAILS

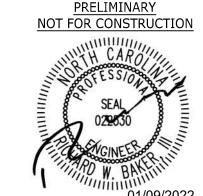

10/10/2022


DRAWN BY J. YOKLEY **DESIGNED BY** J. DOOLEY

CHECKED BY R. BAKER

AS SHOWN

7630.10

SHEET NO. C3.6

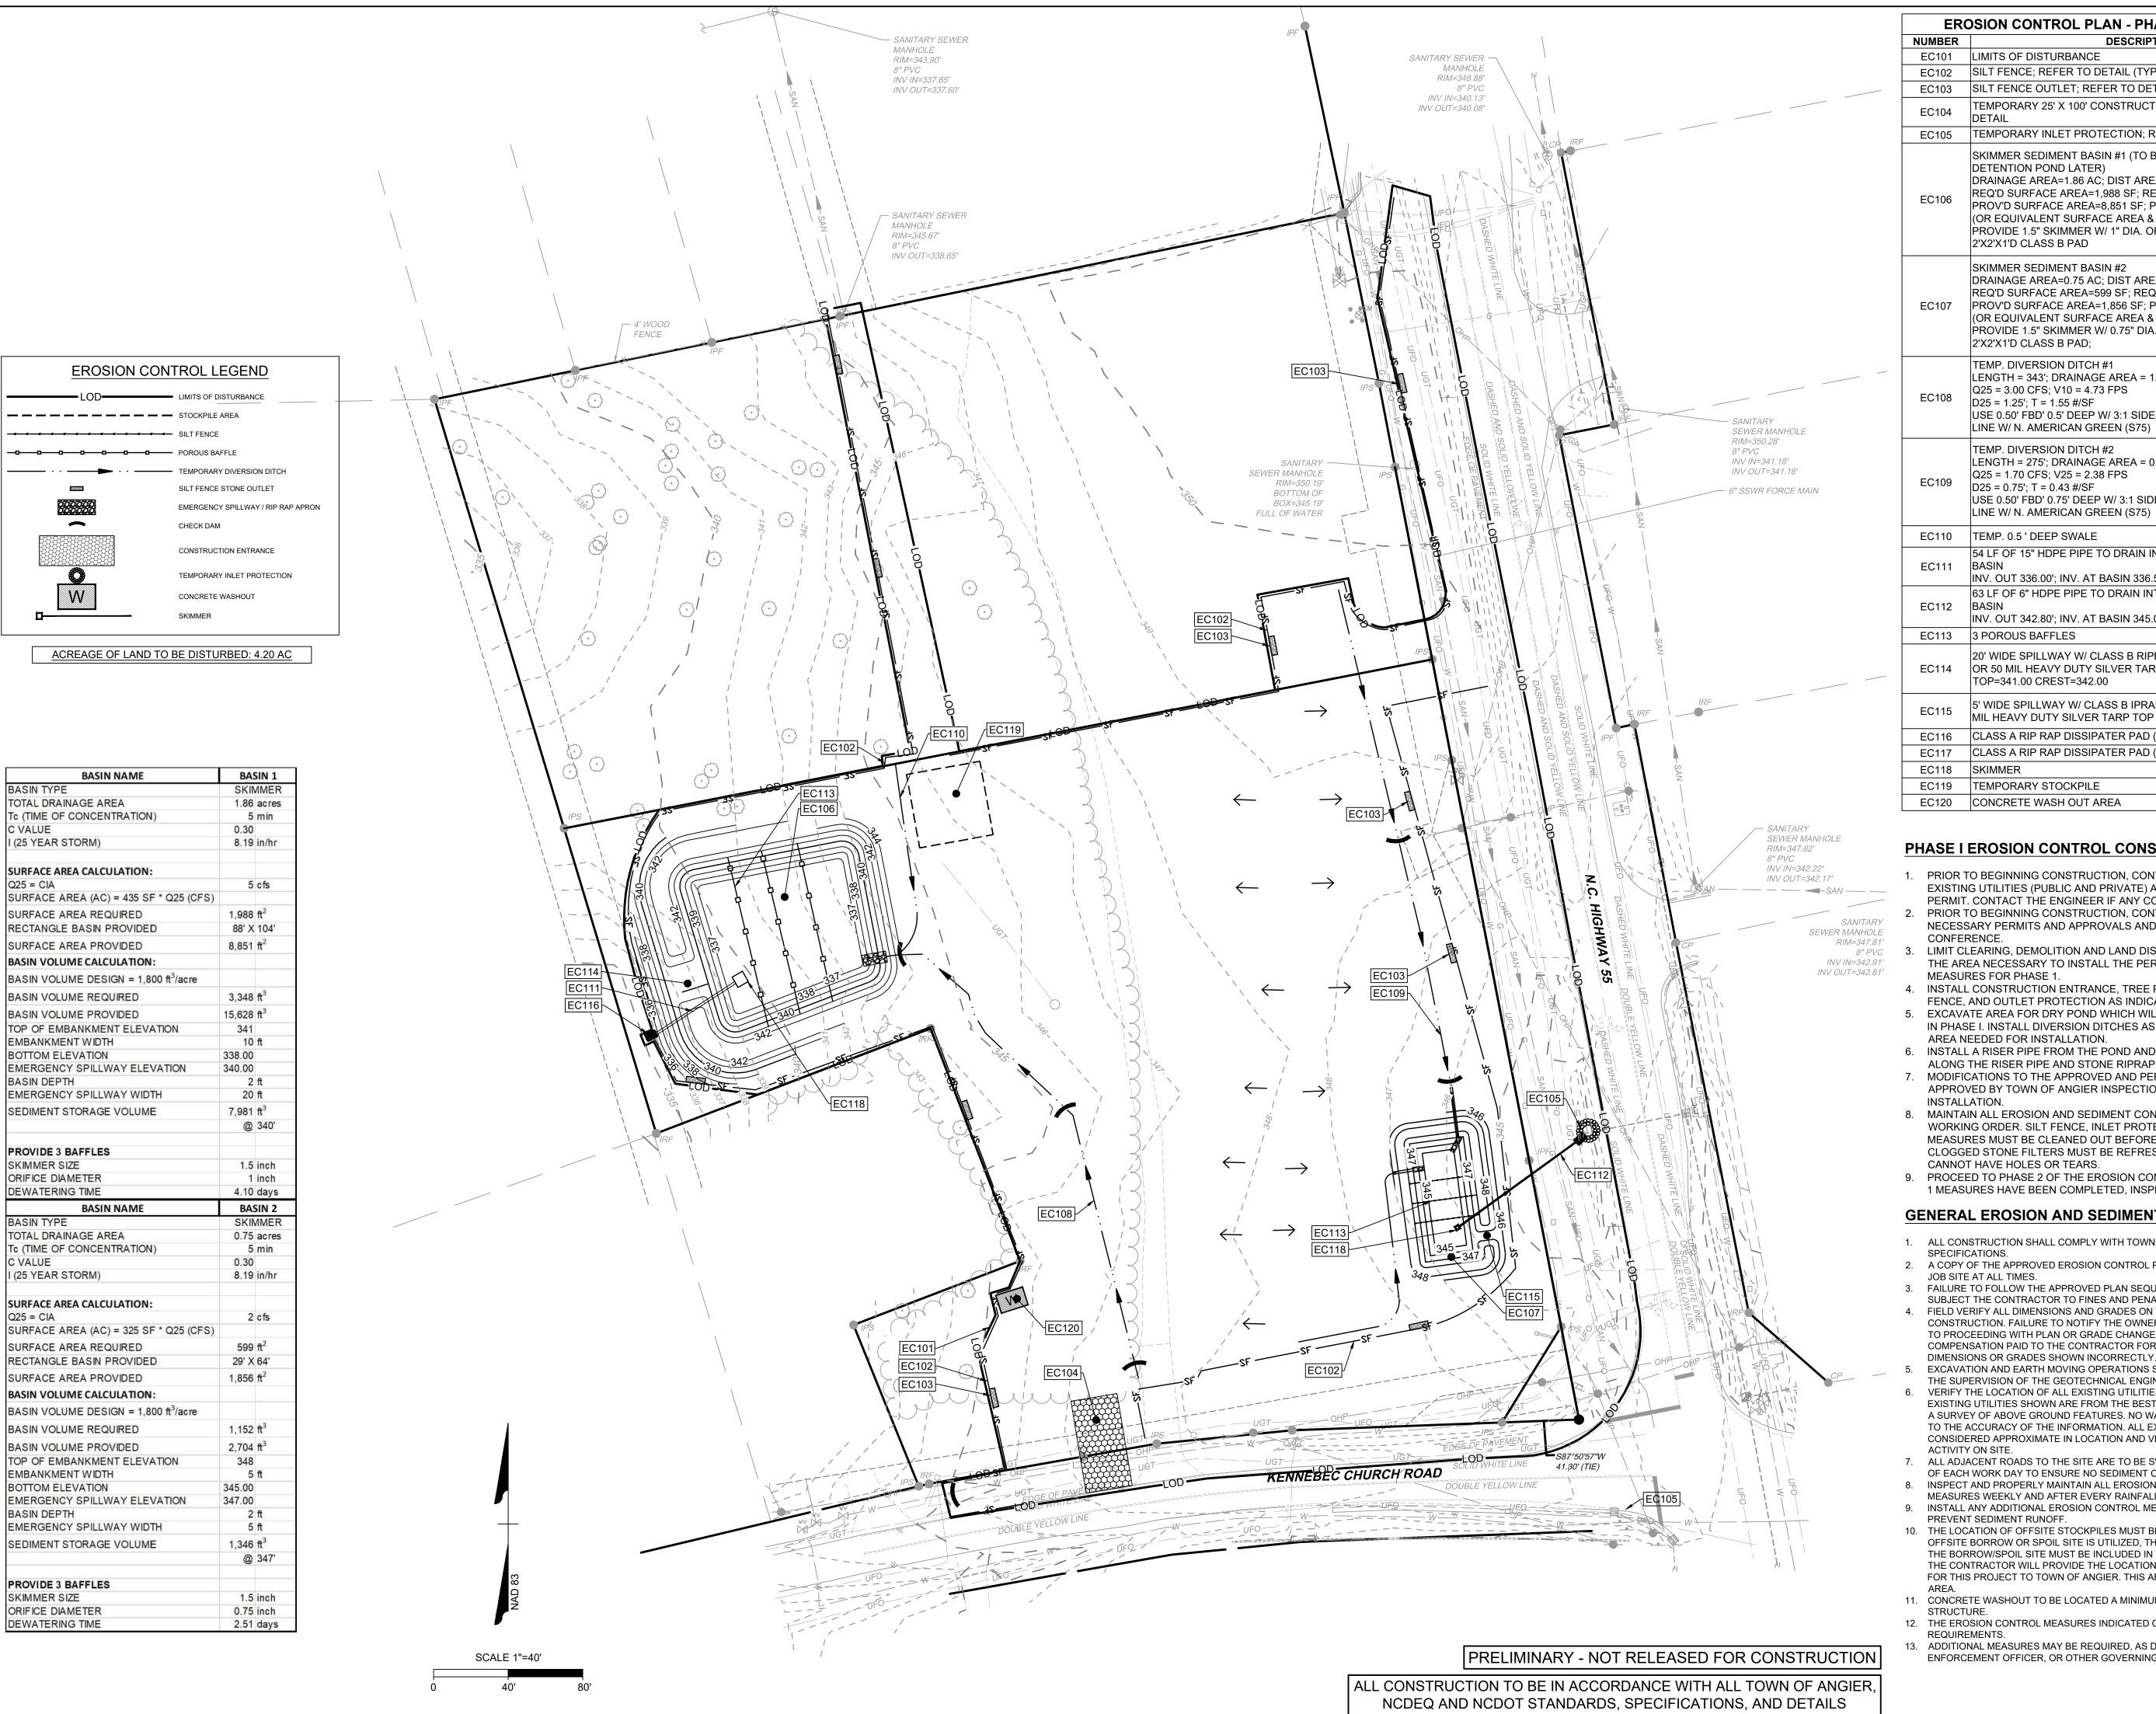

EROSION CONTROL PLAN - PHASE I KEYNOTES					
NUMBER	DESCRIPTION				
EC101	LIMITS OF DISTURBANCE				
EC102	SILT FENCE; REFER TO DETAIL (TYP).				
EC103	SILT FENCE OUTLET; REFER TO DETAIL (TYP.)				
EC104	TEMPORARY 25' X 100' CONSTRUCTION ENTRANCE; REFER TO DETAIL				
EC105	TEMPORARY INLET PROTECTION; REFER TO DETAIL (TYP.)				
EC106	SKIMMER SEDIMENT BASIN #1 (TO BE CONVERTED TO DETENTION POND LATER) DRAINAGE AREA=1.86 AC; DIST AREA=1.86AC REQ'D SURFACE AREA=1,988 SF; REQ'D STORAGE=3,348 CF PROV'D SURFACE AREA=8,851 SF; PROV'D STORAGE=15,628 CF (OR EQUIVALENT SURFACE AREA & VOLUME) PROVIDE 1.5" SKIMMER W/ 1" DIA. ORIFICE ON 2'X2'X1'D CLASS B PAD				
EC107	SKIMMER SEDIMENT BASIN #2 DRAINAGE AREA=0.75 AC; DIST AREA=0.64 AC REQ'D SURFACE AREA=599 SF; REQ'D STORAGE=1,152 CF PROV'D SURFACE AREA=1,856 SF; PROV'D STORAGE=2,692 CF (OR EQUIVALENT SURFACE AREA & VOLUME) PROVIDE 1.5" SKIMMER W/ 0.75" DIA. ORIFICE ON 2'X2'X1'D CLASS B PAD;				
EC108	TEMP. DIVERSION DITCH #1 LENGTH = 343'; DRAINAGE AREA = 1.87 AC; S = 2.2% Q25 = 3.00 CFS; V10 = 4.73 FPS D25 = 1.25'; T = 1.55 #/SF USE 0.50' FBD' 0.5' DEEP W/ 3:1 SIDES LINE W/ N. AMERICAN GREEN (S75)				
EC109	TEMP. DIVERSION DITCH #2 LENGTH = 275'; DRAINAGE AREA = 0.71AC; S = 0.1% Q25 = 1.70 CFS; V25 = 2.38 FPS D25 = 0.75'; T = 0.43 #/SF USE 0.50' FBD' 0.75' DEEP W/ 3:1 SIDES LINE W/ N. AMERICAN GREEN (S75)				
EC110	TEMP. 0.5 ' DEEP SWALE				
EC111	54 LF OF 15" HDPE PIPE TO DRAIN INTO TEMPORARY SKIMMER BASIN INV. OUT 336.00'; INV. AT BASIN 336.5'				
EC112	63 LF OF 6" HDPE PIPE TO DRAIN INTO TEMPORARY SKIMMER BASIN INV. OUT 342.80'; INV. AT BASIN 345.00'				
EC113	3 POROUS BAFFLES				
EC114	20' WIDE SPILLWAY W/ CLASS B RIPRAP & NON-WOVEN LINER OR 50 MIL HEAVY DUTY SILVER TARP TOP=341.00 CREST=342.00				
EC115	5' WIDE SPILLWAY W/ CLASS B IPRAP & NON- WOVEN LINER OR 50 MIL HEAVY DUTY SILVER TARP TOP =348.00 CREST =347.00				
EC116	CLASS A RIP RAP DISSIPATER PAD (5'W X 3.8'L X 12"D)				
EC117	CLASS A RIP RAP DISSIPATER PAD (2'W X 1.5'L X 12"D)				
EC118	SKIMMER				
EC119	TEMPORARY STOCKPILE				
EC120	CONCRETE WASH OUT AREA				

PHASE I EROSION CONTROL CONSTRUCTION SEQUENCE:

- PRIOR TO BEGINNING CONSTRUCTION, CONTRACTOR MUST LOCATE ALL EXISTING UTILITIES (PUBLIC AND PRIVATE) AND OBTAIN THE GRADING PERMIT. CONTACT THE ENGINEER IF ANY CONFLICTS ARISE
- PRIOR TO BEGINNING CONSTRUCTION, CONTRACTOR TO OBTAIN ALL NECESSARY PERMITS AND APPROVALS AND HOLD PRE CONSTRUCTION
- LIMIT CLEARING, DEMOLITION AND LAND DISTURBING ACTIVITY TO ONLY THE AREA NECESSARY TO INSTALL THE PERMITTED EROSION CONTROL MEASURES FOR PHASE 1.
- INSTALL CONSTRUCTION ENTRANCE, TREE PROTECTION FENCE, SILT FENCE, AND OUTLET PROTECTION AS INDICATED ON PLAN.
- EXCAVATE AREA FOR DRY POND WHICH WILL FUNCTION AS SKIMMER BASIN IN PHASE I. INSTALL DIVERSION DITCHES AS SHOWN. DISTURB ONLY THE AREA NEEDED FOR INSTALLATION.
- 6. INSTALL A RISER PIPE FROM THE POND AND THEN INSTALL A DIAPHRAGM
- ALONG THE RISER PIPE AND STONE RIPRAP AT THE OUTLET. MODIFICATIONS TO THE APPROVED AND PERMITTED PLANS SHALL BE APPROVED BY TOWN OF ANGIER INSPECTIONS PRIOR TO REMOVAL OR
- 8. MAINTAIN ALL EROSION AND SEDIMENT CONTROL MEASURES IN GOOD WORKING ORDER. SILT FENCE, INLET PROTECTION AND OTHER SIMILAR MEASURES MUST BE CLEANED OUT BEFORE THEY ARE HALF FULL. CLOGGED STONE FILTERS MUST BE REFRESHED/REPLACED. SILT FENCE
- 9. PROCEED TO PHASE 2 OF THE EROSION CONTROL SEQUENCE WHEN PHASE 1 MEASURES HAVE BEEN COMPLETED, INSPECTED, AND APPROVED.

GENERAL EROSION AND SEDIMENT CONTROL NOTES:

- 1. ALL CONSTRUCTION SHALL COMPLY WITH TOWN OF ANGIER STANDARDS AND
- 2. A COPY OF THE APPROVED EROSION CONTROL PLAN MUST BE ON FILE AT THE JOB SITE AT ALL TIMES.
- FAILURE TO FOLLOW THE APPROVED PLAN SEQUENCE AND DETAILS COULD SUBJECT THE CONTRACTOR TO FINES AND PENALTIES.
- FIELD VERIFY ALL DIMENSIONS AND GRADES ON THESE PLANS PRIOR TO CONSTRUCTION. FAILURE TO NOTIFY THE OWNER OF ANY DISCREPANCIES PRIOR TO PROCEEDING WITH PLAN OR GRADE CHANGES, MAY RESULT IN NO EXTRA COMPENSATION PAID TO THE CONTRACTOR FOR ANY WORK DONE DUE TO
- EXCAVATION AND EARTH MOVING OPERATIONS SHALL BE CONDUCTED UNDER THE SUPERVISION OF THE GEOTECHNICAL ENGINEER. VERIFY THE LOCATION OF ALL EXISTING UTILITIES PRIOR TO CONSTRUCTION.
- EXISTING UTILITIES SHOWN ARE FROM THE BEST AVAILABLE RECORDS AND FROM A SURVEY OF ABOVE GROUND FEATURES. NO WARRANTY IS GIVEN OR IMPLIED AS TO THE ACCURACY OF THE INFORMATION. ALL EXISTING UTILITIES SHOULD BE CONSIDERED APPROXIMATE IN LOCATION AND VERIFIED PRIOR TO COMMENCING ACTIVITY ON SITE. ALL ADJACENT ROADS TO THE SITE ARE TO BE SWEPT AND WASHED AT THE END
- OF EACH WORK DAY TO ENSURE NO SEDIMENT COLLECTS ON THE ROADWAYS. INSPECT AND PROPERLY MAINTAIN ALL EROSION AND SEDIMENT CONTROL MEASURES WEEKLY AND AFTER EVERY RAINFALL EVENT.
- INSTALL ANY ADDITIONAL EROSION CONTROL MEASURES AS NECESSARY TO PREVENT SEDIMENT RUNOFF.
- 10. THE LOCATION OF OFFSITE STOCKPILES MUST BE AN UPLAND AREA. IF AN OFFSITE BORROW OR SPOIL SITE IS UTILIZED, THEN THE DISTURBED AREA FOR THE BORROW/SPOIL SITE MUST BE INCLUDED IN THE LAND DISTURBANCE PERMIT. THE CONTRACTOR WILL PROVIDE THE LOCATION OF ALL EXCAVATED SOILS USED FOR THIS PROJECT TO TOWN OF ANGIER. THIS AREA MUST ALSO BE AN UPLAND
- 11. CONCRETE WASHOUT TO BE LOCATED A MINIMUM OF 50' FROM ANY DRAINAGE
- 12. THE EROSION CONTROL MEASURES INDICATED ON THE PLANS ARE THE MINIMUM REQUIREMENTS.
- 13. ADDITIONAL MEASURES MAY BE REQUIRED, AS DIRECTED BY THE ENGINEER, ENFORCEMENT OFFICER, OR OTHER GOVERNING AGENCY.




10/10/2022

J. YOKLEY **DESIGNED BY** J. DOOLEY

CHECKED BY R. BAKER

AS SHOWN

7630.105 SHEET NO.

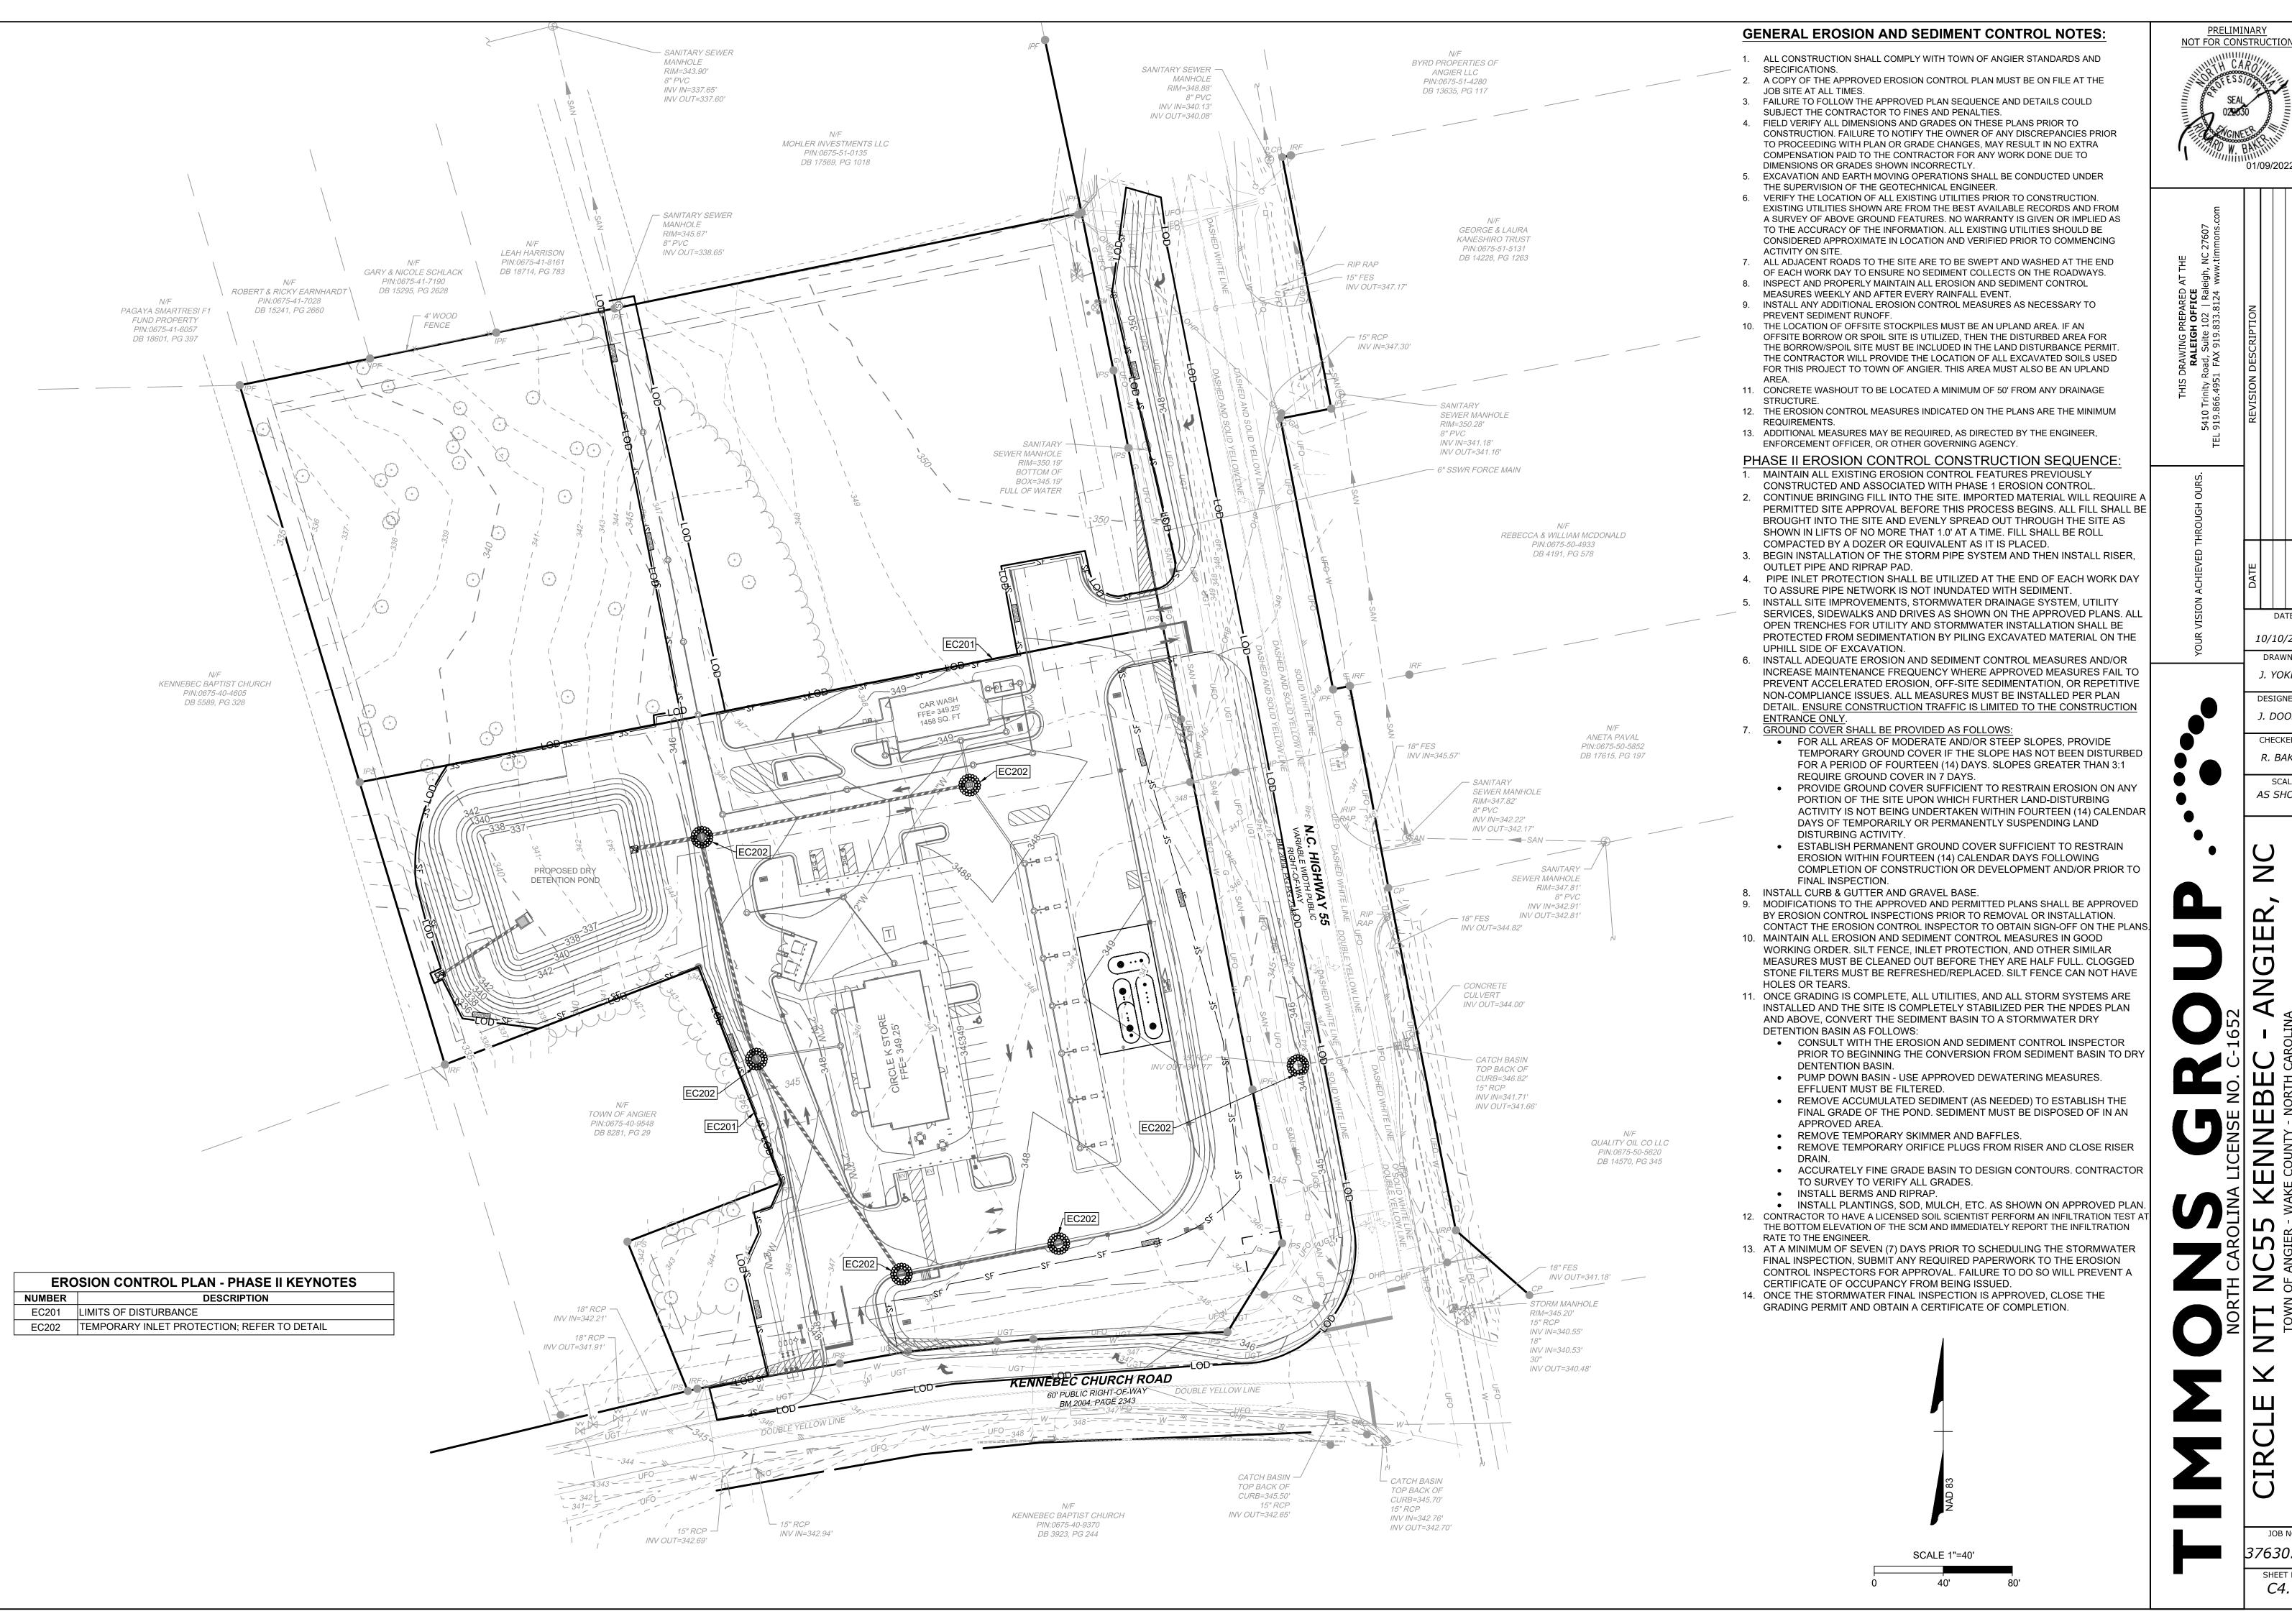

JOB NO. 7630.10

DATE

10/10/2022

DRAWN BY

J. YOKLEY

DESIGNED BY

J. DOOLEY


CHECKED BY

R. BAKER

SCALE

AS SHOWN

SHEET NO. C4.1

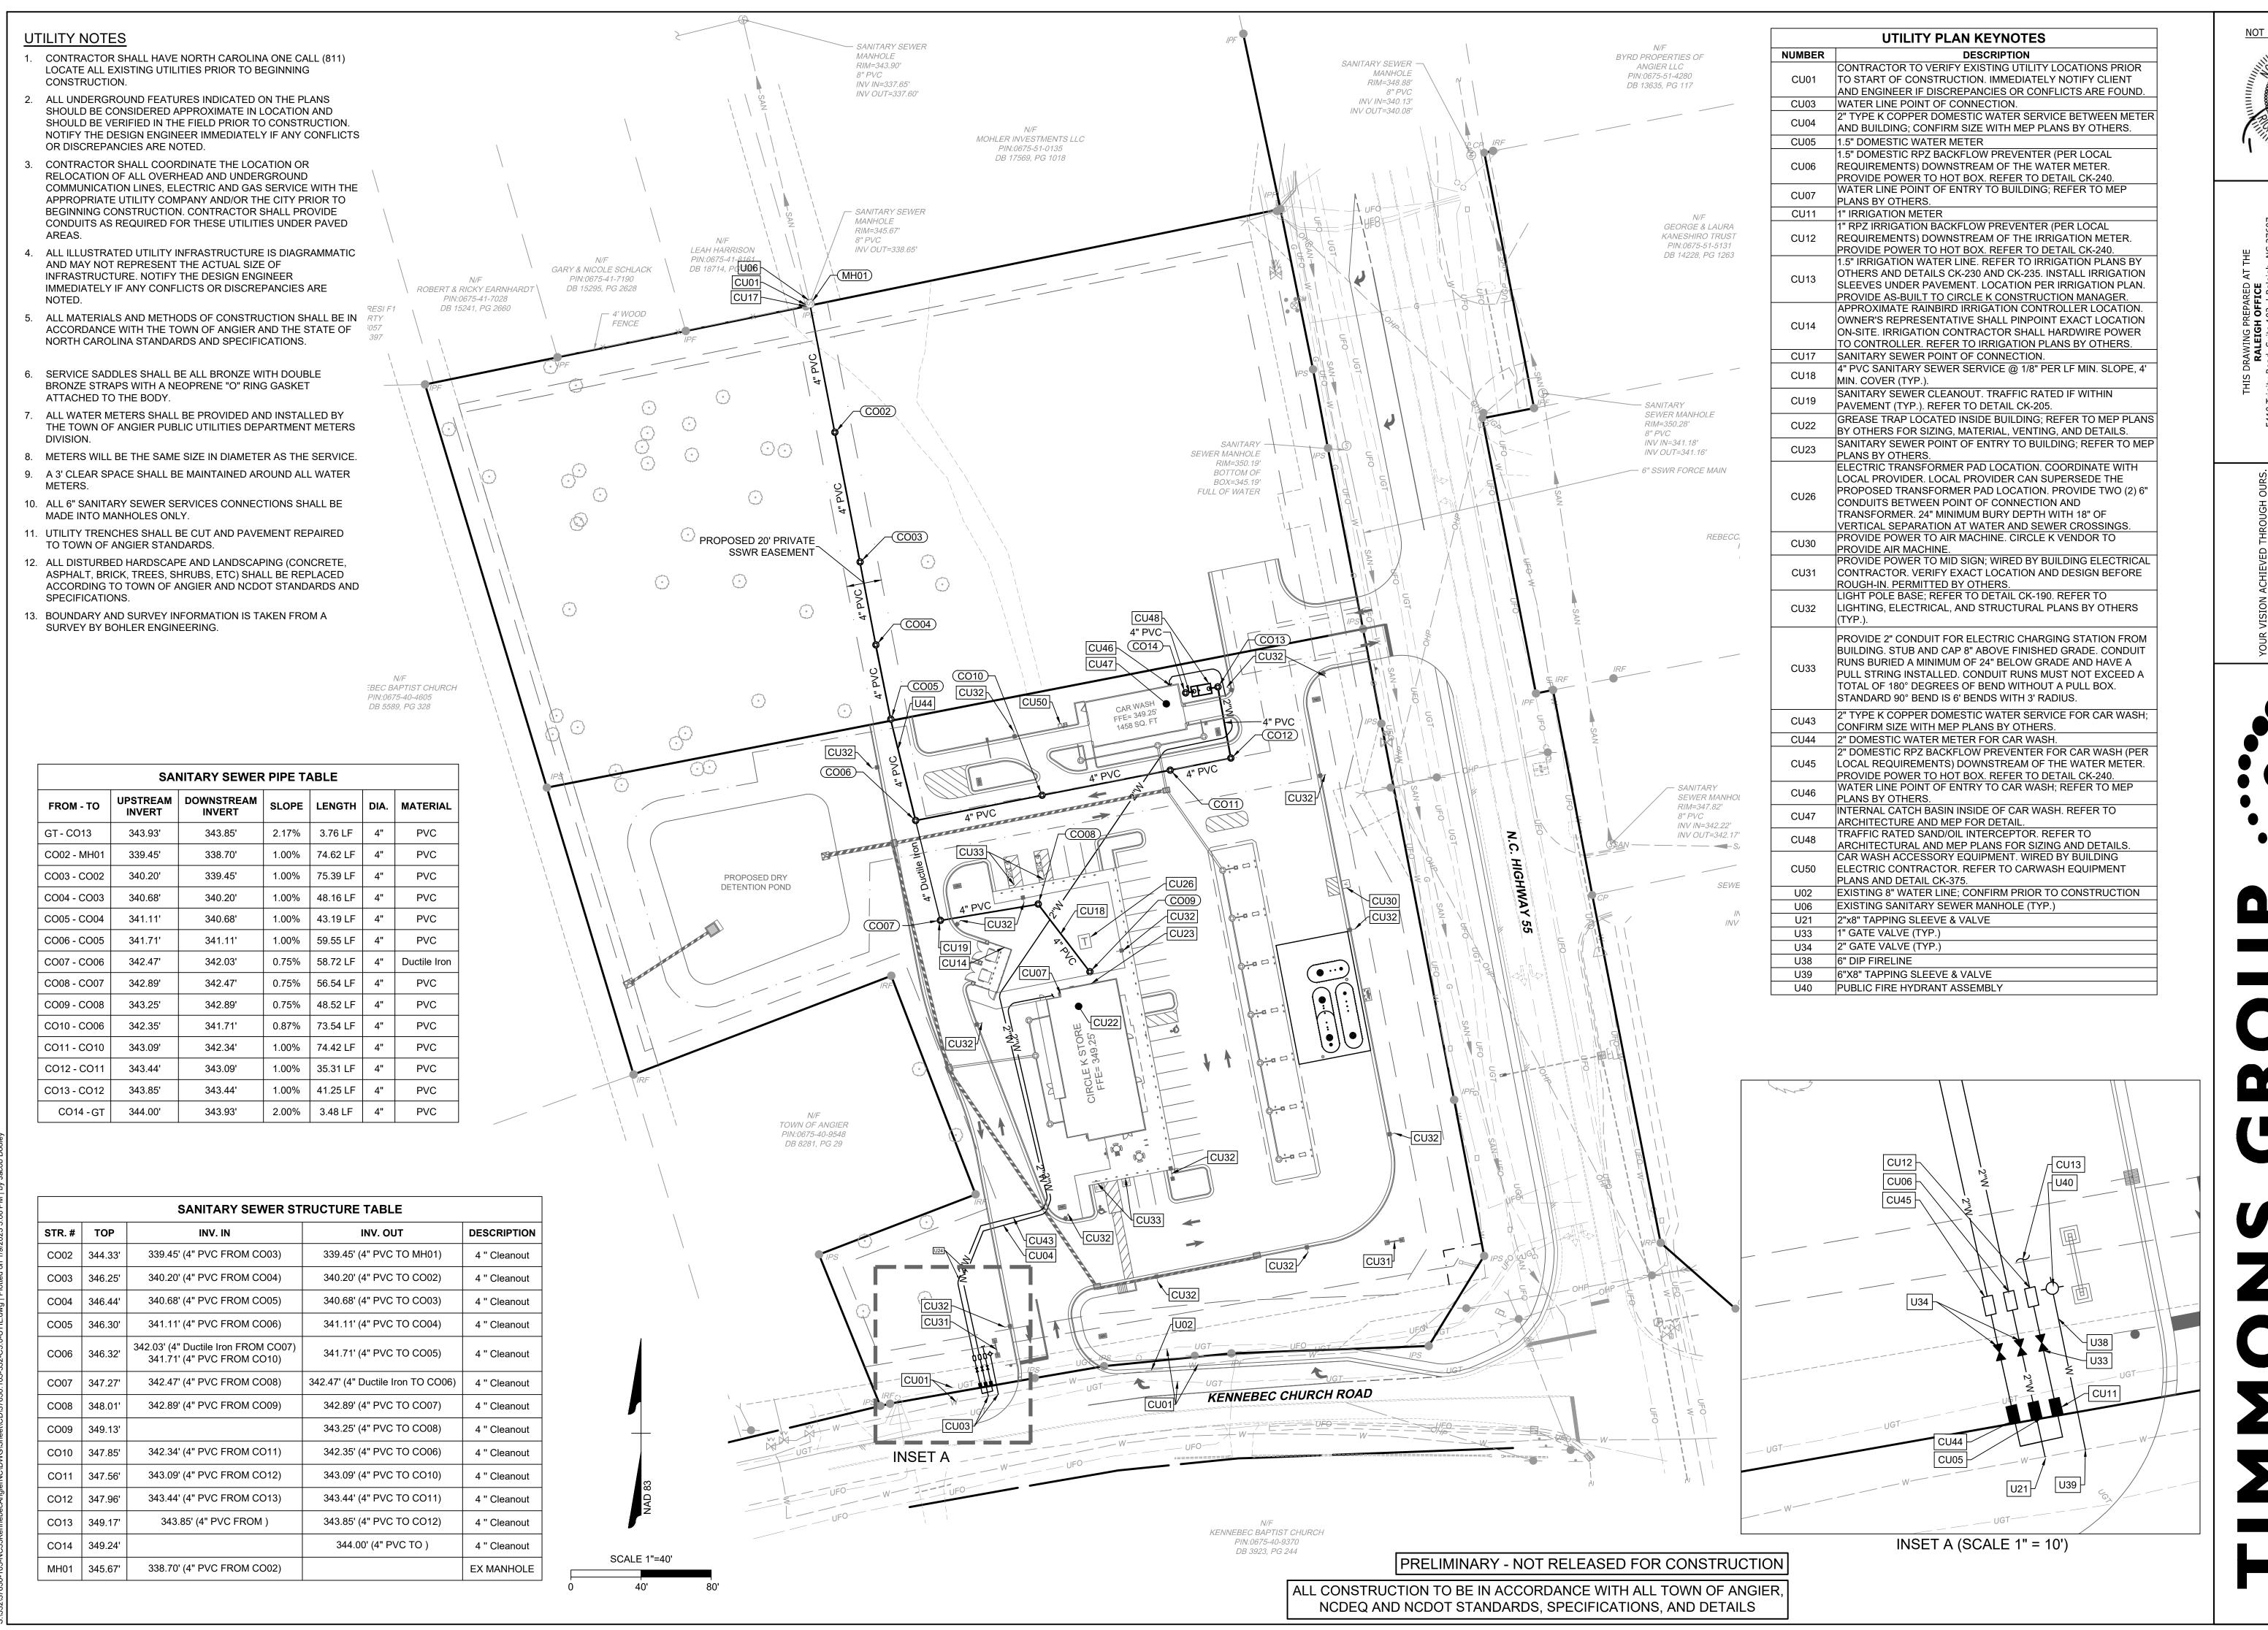

NOT FOR CONSTRUCTION

DATE 10/10/2022 DRAWN BY J. YOKLEY

DESIGNED BY J. DOOLEY CHECKED BY R. BAKER

SCALE AS SHOWN

7630.10 SHEET NO. C5.0

TOWN OF ANGIER LANDSCAPE **REQUIREMENTS**

GROUND COVER							
+ + + + + + + + + + + + + + + + + + +	BG	CYNODON DACTYLON	BERMUDA GRASS	SOD			
	BG	CYNODON DACTYLON	BERMUDA GRASS	SEED			
	RB		RED BARK MULCH				

KENNEBEC CHURCH ROAD 60' PUBLIC RIGHT-OF-WAY BM 2004, PAGE 2343

KENNEBEC BAPTIST CHURCH PIN:0675-40-9370 DB 3923, PG 244

EDGE OF PAVEMENT -

REQUIRENTS							
REQUIREMENT	REQUIRED						
PARKING LOT:							
UDO 7.3.2.B: 1 CANOPY TREE TO BE WITHIN OF EVERY PARKING SPACE	5 TREES						
STREET TREES:	STREET TREES:						
U.D.O. 7.3.1: STAGGERED ROW OF LARGE TREES, SPACED NOT MORE TH 30' APART. SUPPLEMENTED BY LOW GROWING SHRUBS FOR EVERY REQUIRED LARGE TREE	5						
BUFFERS:							
U.D.O. 7.3.1: TYPE A STAGGERED ROW OF LARGE TREES, SPACED NOT MORE TH	34 TREES, 167 SHRUBS AN						

- 6" SSWR FORCE I

30' APART. A ROW OF EVERGREEN SHRUBS PLACED NOT MORE THAN FOUR (4) TO SIX (6) FEET APART WHICH WILL GROW TO FORM A CONTINUOUS HEDGE OF AT LEAST SIX (6) FEET IN HEIGHT WITHIN TWO (2) YEARS OF PLANTING.

	PLANT SCHEDULE								
	SYMBOL	DECIDUOUS SHADE TREE	PROV'D	BOTANICAL NAME	COMMON NAME	MIN. INSTALLATION SIZE	COMMENTS		
	NN .	LB	14	ULMUS PARVIFOLIA	LACEBARK ELM	2.5." CAL. OR 10' MIN. HT.	STREET YARD & BUFFER		
		SO	25	QUERCUA SHUMARDII	SHUMARD OAK	2.5." CAL. OR 10' MIN. HT.	STREET YARD & BUFFER		
-	+	GA	6	FRAXINUS PENNSYLVANICA	GREEN ASH	2.5." CAL. OR 10' MIN. HT.	BUFFER		
		SHRUBS							
	\odot	WL	53	LIGUSTRUM JAPONICUM	WAXLEAF LIGUSTRUM	3 GAL. OR 18" MIN. HT	STREET YAD		
	E COTO	GB	26	ILEX GLABRA	GEM BOX INKBERRY	3 GAL. OR 18" MIN. HT	FOUNDATION PLANTING		
	\odot	КВ	146	BUXUS MICROPHYLLA VAR. 'KOREANA'	KOREAN BOXWOOD	3 GAL. OR 18" MIN. HT	BUFFER		
			1						

LANDSCAPE NOTES:

- PRIOR TO CONSTRUCTION LOCATE ALL UNDERGROUND UTILITIES WITHIN AND ADJACENT TO THE WORK AREA. LOCATIONS OF EXISTING BURIED UTILITY LINES SHOWN ON THE PLANS ARE BASED UPON BEST AVAILABLE INFORMATION AND ARE TO BE CONSIDERED APPROXIMATE. PROTECT ALL UTILITIES. REPAIR ALL DAMAGE TO UTILITIES, STRUCTURES, SITE APPURTENANCES, ETC. WHICH OCCURS AS A RESULT OF CONSTRUCTION.
- CONTRACTOR ENGAGED IN LANDSCAPE IMPLEMENTATION SHALL BE A LANDSCAPE CONTRACTOR REGISTERED IN THE STATE OF NORTH CAROLINA.
- VERIFY ALL PLANT MATERIAL QUANTITIES ON PLANS PRIOR TO BIDDING. PLANT LIST TOTALS ARE FOR CONVENIENCE ONLY AND MUST BE VERIFIED. PLANT MATERIAL SUBSTITUTIONS CAN ONLY OCCUR WITH PRIOR WRITTEN APPROVAL BY LANDSCAPE ARCHITECT.
- PRIOR TO THE COMMENCEMENT OF ANY ACTIVITIES REQUIRING A BUILDING OR ZONING PERMIT AN ON-SITE PRE-CONSTRUCTION CONFERENCE SHALL TAKE PLACE WITH THE DEVELOPER AND THE ADMINISTRATOR TO REVIEW PROCEDURES FOR THE PROTECTION AND MANAGEMENT OF ALL LANDSCAPE ELEMENTS TO REMAIN.
- ALL PLANT MATERIALS ARE SUBJECT TO LANDSCAPE ARCHITECT APPROVAL BEFORE, DURING, AND AFTER INSTALLATION. o ANY PLANT MATERIAL WHICH IS DISEASED, DISTRESSED, DEAD, OR REJECTED (PRIOR TO SUBSTANTIAL COMPLETION) SHALL BE PROMPTLY REMOVED FROM THE
- SITE AND REPLACED WITH MATERIAL OF THE SAME SPECIES, QUANTITY, AND SIZE.
- ALL PLANT MATERIALS AND INSTALLATION SHALL COMPLY WITH RECOMMENDATIONS AND REQUIREMENTS OF ANSI Z60.1 "AMERICAN STANDARD FOR NURSERY STOCK".
- o ALL PLANT MATERIAL SHALL BE HEALTHY, VIGOROUS, AND FREE OF PESTS AND DISEASE.
- ALL PLANT MATERIAL SHALL BE CONTAINER GROWN OR BALLED AND BURLAPPED AS INDICATED IN THE PLANT LIST.


o ALL TREES SHALL HAVE A STRAIGHT TRUNK AND FULL HEAD.

- CONTRACTOR IS ENCOURAGED TO COMPLETE TEMPORARY OR PERMANENT SEEDING IN STAGES FOR SOIL STABILIZATION AS AREAS ARE COMPLETED AFTER GRADING. THIS PLAN DOES NOT PRESENT ANY TEMPORARY STABILIZATION REQUIRED AS PART OF SWPPP PLAN.
- CONTRACTOR SHALL TAKE 3 REPRESENTATIVE SOIL SAMPLES OF EACH PROPOSED PLANT BED AND SUBMIT COPIES OF THE RESULTS TO THE LANDSCAPE ARCHITECT PRIOR TO BEGINNING WORK.
- STUMPS LABELED FOR REMOVAL SHALL BE EXCAVATED, NOT GROUND. REMOVE ALL DEBRIS FROM THE HOLE. FILL WITH TOP SOIL, COMPACT, AND RAKE SMOOTH PRIOR TO INSTALLING NEW PLANT MATERIAL.
- CONTRACTOR IS RESPONSIBLE FOR DELIVERY SCHEDULE AND PROTECTION BETWEEN DELIVERY AND PLANTING TO MAINTAIN HEALTHY PLANT CONDITIONS.
- ALL LANDSCAPED AND LAWN AREAS ARE TO RECEIVE A MINIMUM OF 4" OF TOPSOIL.
- ALL LANDSCAPE ISLANDS SHALL BE GRADED FOR POSITIVE DRAINAGE WITH NO LOW SPOTS ALLOWING WATER TO BE TRAPPED.
- INSTALL LANDSCAPE PLANTINGS AT ENTRANCES/EXITS AND PARKING AREAS ACCORDING TO PLANS SO MATERIAL WILL NOT INTERFERE WITH SIGHT DISTANCES.
- THE SIZE OF THE PLANTING AREA AND SIZE OF PLANT MATERIAL AT MATURITY SHALL ALLOW FOR A 2.5' BUMPER OVERHANG FROM THE BACK OF CURB. ALL TREES MUST BE GUYED OR STAKED AS DETAILED.
- AREAS DAMAGED FROM PLANT RELOCATION OR OTHER ACTIVITIES OF LANDSCAPE CONTRACTOR TO BE RESEEDED AND ESTABLISHED AT NO ADDITIONAL COST TO THE OWNER.
- CONTRACTOR IS RESPONSIBLE FOR WATERING ALL PLANT MATERIAL DURING INSTALLATION AND UNTIL FINAL INSPECTION AND ACCEPTANCE BY OWNER. CONTRACTOR SHALL NOTIFY OWNER OF CONDITIONS WHICH AFFECTS THE GUARANTEE. IT MAY BE NECESSARY TO TRUCK IN NON-CITY WATER TO MEET PLANT NEEDS.
- USE HERBICIDES, PESTICIDES, AND FERTILIZER IN A MANNER CONSISTENT WITH THE FEDERAL INSECTICIDE, FUNGICIDE, AND RODENTICIDE ACT AND IN ACCORDANCE.
- ALL LAWN AREAS TO BE SEEDED SHALL USE A LOCALLY GROWN COMMERCIAL MIX MEETING LATEST STATE OF NORTH CAROLINA AGRICULTURE STANDARDS FOR SEED AND PLANT CERTIFICATION.
- SEEDING AND STRAW NOTES FOR LAWN AREAS:
- o RIP THE ENTIRE AREA TO DEPTH OF NOT LESS THAN 6".
- o REMOVE ALL LOOSE ROCKS, ROOTS, AND OTHER OBSTRUCTIONS LEAVING SURFACE SMOOTH AND UNIFORM. DISPOSE OF WASTE MATERIAL OFF-SITE.
- o CHISEL COMPACTED AREAS AND SPREAD TOPSOIL TO SPECIFIED DEPTH. o APPLY AGRICULTURAL LIME, FERTILIZER, AND SUPER PHOSPHATE UNIFORMLY AND MIX WITH SOIL. APPLY SOIL AMENDMENTS PER REQUIRED SOIL ANALYSIS
- RECOMMENDATIONS.
- CONTINUE TILAGE UNTIL A WELL PULVERIZED, FIRM, REASONABLY UNIFORM SEEDBED IS PREPARED.
- o SEED ON A FRESHLY PREPARED SEEDBED AND COVER SEED LIGHTLY WITH SEEDING EQUIPMENT OR CULTIPACK AFTER SEEDING.
- MULCH IMMEDIATELY AFTER SEEDING AND ANCHOR MULCH. o INSPECT ALL SEEDED AREAS AND IF POSSIBLE. MAKE NECESSARY REPAIRS OR RESEEDINGS WITHIN THE PLANTING SEASON. IF GRANDSTAND SHOULD BE OVER 60%
- DAMAGED, REESTABLISH FOLLOWING ORIGINAL LIME, FERTILIZER, AND SEEDING RATES.
- ANCHOR TACK WITH LIQUID ASPHALT AT 400 GAL/ACRE OR EMULSIFIED ASPHALT AT 300 GAL/ACRE.
- BIODEGRADABLE WEED MATTING (ALL-PRO WEED MAT OR APPROVED EQUAL) SHALL BE REQUIRED IN SHRUB BEDS ADJACENT TO BUILDING FACADE. • PLANTING BEDS TO BE COMPLETELY COVERED WITH A MINIMUM 4" DEPTH OF MATERIAL FROM A LOCAL SOURCE HARVESTED IN A SUSTAINABLE MANNER. REFER TO
- LANDSCAPE SCHEME FOR MATERIAL SPECIFICATIONS. • MULCH ALL PLANT BEDS AND TREE RINGS WITH FRESH, CLEAN MATERIAL PER SPECIFICATIONS. ALL MULCH EDGES SHALL BE NEATLY TUCKED. ALL STRING AND/OR
- BAILING WIRE SHALL BE REMOVED. DUST SHRUBS AND GROUND COVER AFTER MULCHING TO REMOVE LOOSE MATERIAL FROM PLANTS. DO NOT PLACE MULCH IN CONTACT WITH THE TREE TRUNK: KEEP A MINIMUM OF 4" AWAY FROM TREE TRUNK OR BASE OF PLANT.
- MULCH AND NO-MOW MIXES SHALL BE REPLENISHED AS NEEDED, ESPECIALLY AFTER HEAVY RAIN EVENTS. IF NO-MOW MIX GERMINATES AT A RATE OF LESS THAN 90%, THEN REMOVE OTHER SPECIES AND RESEED.

TEMPORARY IRRIGATION

CONTRACTOR TO PROVIDE AND MAINTAIN TEMPORARY IRRIGATION FOR SOD WITHIN THE STORMWATER CONTROL MEASURE UNTIL SOD BECOMES ESTABLISHED.

- LANDSCAPE CONTRACTOR SHALL NOTIFY GENERAL CONTRACTOR UPON COMPLETION OF LANDSCAPE INSTALLATION. CONTRACTOR WILL VERIFY COMPLETENESS INCLUDING THE REPLACEMENT OF ALL DEAD PLANT MATERIAL. CONTRACTOR IS RESPONSIBLE FOR SCHEDULING A FINAL INSPECTION BY LANDSCAPE ARCHITECT.
- PLANT MATERIAL QUANTITIES AND SIZES WILL BE INSPECTED FOR COMPLIANCE WITH APPROVED PLANS BY A SITE PLAN REVIEW AGENT PRIOR TO THE RELEASE OF THE
- CONTRACTOR TO GUARANTEE ALL PLANT MATERIALS FOR ONE FULL YEAR AGAINST DEFECTS INCLUDING DEATH AND UNSATISFACTORY GROWTH. WARRANTY PERIOD SHALL BEGIN UPON CERTIFICATE OF OCCUPANCY OR WHEN THE OWNER TAKES OVER MAINTENANCE, WHICHEVER COMES FIRST.

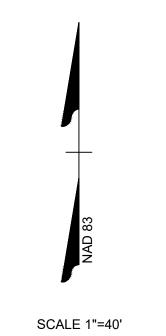

PRELIMINARY - NOT RELEASED FOR CONSTRUCTION

ALL CONSTRUCTION TO BE IN ACCORDANCE WITH ALL TOWN OF ANGIER. NCDEQ AND NCDOT STANDARDS, SPECIFICATIONS, AND DETAILS

NOT FOR CONSTRUCTION

10/10/2022 DRAWN BY J. YOKLEY

DESIGNED BY J. DOOLEY

CHECKED BY R. BAKER

AS SHOWN

7630**.**10. SHEET NO. C6.0

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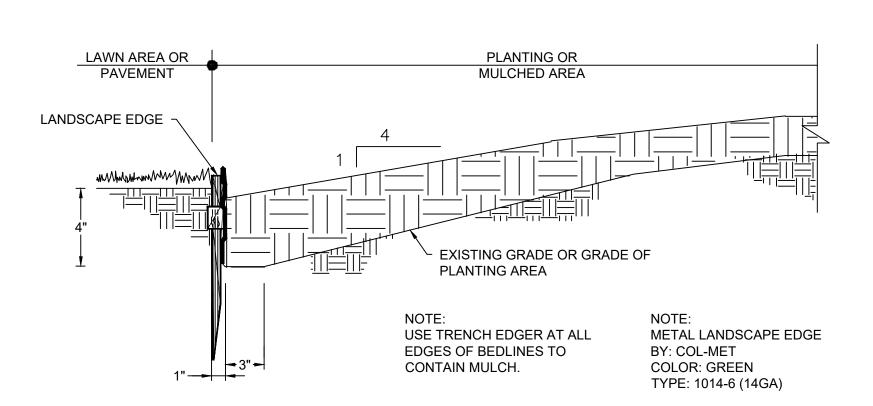
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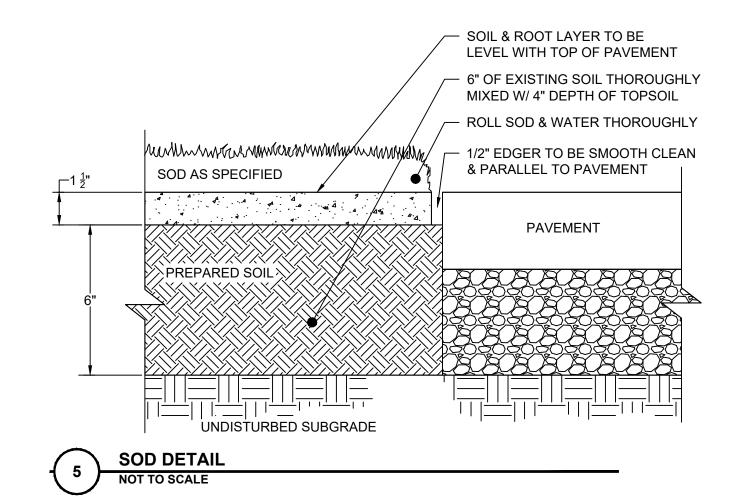
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DB 5589, PG 328



TRENCH EDGER DETAIL

INSTALL SHRUBS SO THAT THE -TOP OF THE ROOTBALL IS AT REMOVE ALL DEAD, BROKEN, THE SAME GRADE AS DISEASED, AND WEAK ORIGINALLY GROWN OR 1-2" BRANCHES AT TIME OF ABOVE IN POOR DRAINING PLANTING SOILS. DO NOT COVER THE TOP 2-3" MULCH LAYER, KEEP AWAY OF THE ROOTBALL WITH SOIL FROM TRUNK REMOVE ALL STRING, WIRE, AND — 1" COMPOST LAYER BURLAP FROM TOP 1/3 OF BALL - PROVIDE MULCH UP AND OVER SAUCER 6" SAUCER BACKFILL PLANTING PIT WITH NATIVE SOIL. INCORPORATE REMOVE CONTAINER. SCARIFY SLOW-RELEASE GRANULAR PERIMETER ROOTS **FERTILIZER CONTAINER** SCARIFY BOTTOM AND SIDES OF PIT SHRUB DETAIL



PLAN VIEW PRUNE CODOMINATE LEADERS -- ROOT BALL REMOVE BROKEN, BADLY DEFORMED, RUBBING, NARROW CROTCH ANGLES, WATER SPROUTS, OR CROSS-BRANCHES. — 12 GAUGE GALVANIZED WIRE — 3-2"x2" HARDWOOD STAKES NOTE: ONLY STAKE TREES WITH - GALVANIZED WIRE GUY LARGE CROWNS, 2" CALIPER OR 12 GAUGE. ALLOW FOR A GREATER, IF LOCATED ON WINDY SLIGHT AMOUNT OF MOVEMENT SITES, OR WHERE TAMPERING MAY OCCUR. - 8' 2"x2" HARDWOOD STAKE, 2'-6" MIN BELOW SURFACE. STAKE SHALL BE DRIVEN A MIN 18" OUT FROM TRUNK AND OUTSIDE OF ROOTBALL REMOVE TAGS, LABELS, AND -PLASTIC SLEEVING. DO NOT STAKE 2-3" MULCH LAYER TO EDGE OF DRIPLINE. UNLESS SPECIFIED (SEE KEEP 4-6" AWAY FROM TRUNKFLARE NOTE) DO NOT WRAP TRUNK SET ROOTBALL FLUSH TO GRADE OR 1-2" HIGHER IN SLOWLY DRAINING SOILS. DO NOT COVER THE TOP OF THE ROOTBALL PRUNE SUCKERS -WITH SOIL. ROOTFLARE SHALL BE VISIBLE IF FIELD GROWN, CUT AWAY ALL ABOVE FINISHED GRADE BALLING ROPES. REMOVE BURLAP OR WIRE BASKET FROM TOP ⅓ OF BALL. IF CONTAINER BACKFILL PLANTING PIT WITH NATIVE GROWN, REMOVE CONTAINER SOIL. INCORPORATE SLOW-RELEASE AND CUT CIRCLING ROOTS GRANULAR FERTILIZER 1:1 SLOPE OF SIDES OF 1" COMPOST LAYER PLANTING HOLE 4" x 18" PERFORATED CORRUGATED SCARIFY SIDES BEFORE PLANTING -PLASTIC PIPE; CAP FLUSH WITH MULCH TAMP SOIL AROUND ROOTBALL PLACE ROOTBALL ON BASE FIRMLY WITH FOOT UNEXCAVATED OR TAMPED SOIL 3 X ROOTBALL PRESSURE SO THAT ROOTBALL DIAMETER DOES NOT SHIFT

DECIDUOUS TREE - STAKING SPECIFIED NOT TO SCALE

PRELIMINARY - NOT RELEASED FOR CONSTRUCTION

ALL CONSTRUCTION TO BE IN ACCORDANCE WITH ALL TOWN OF ANGIER, NCDEQ AND NCDOT STANDARDS, SPECIFICATIONS, AND DETAILS

DATE 10/10/2022 DRAWN BY J. YOKLEY DESIGNED BY J. DOOLEY CHECKED BY

NOT FOR CONSTRUCTION

R. BAKER SCALE AS SHOWN

> 37630.105 SHEET NO.

C6.1

PERMANENT SEEDING SCHEDULE FOR COASTAL PLAIN

DATE	TYPE	BROADCAST SEEDING RATES
OCT 1 - APR 1	SPLITBEARD BLUESTEM	15 LBS/ACRE
AUG 30 - MAR 15	BIG BLUESTEM	200-250 LBS/ACRE
AUG 15 - APR 15	RYE GRAIN	40 LBS/ACRE
APR 15- AUG 15	GERMAN MILLET	10 LBS/ACRE

TEMPORARY SEEDING SCHEDULE

DATE	TYPE	<u> </u>	PLANTING RATE
DEC 1 - APR 15	SWITCHGRASS		50 LBS/ACRE
APR. 15 - AUG 15	GERMAN MILLET		40 LBS/ACRE
AUG 15 - DEC 30	RYE GRAIN		120 LBS/ACRE

SEEDBED PREPARATION

CONSTRUCTION SPECIFICATIONS


- CHISEL COMPACTED AREAS AND SPREAD TOPSOIL 3 INCHES DEEP OVER ADVERSE SOIL
- CONDITIONS, IF AVAILABLE.
- RIP THE ENTIRE AREA TO 6 INCHES DEPTH. REMOVE ALL LOOSE ROCK, ROOTS, AND OTHER OBSTRUCTIONS LEAVING SURFACE
- REASONABLY SMOOTH AND UNIFORM. 4. APPLY AGRICULTURAL LIME, FERTILIZER, AND SUPERPHOSPHATE UNIFORMLY AND MIX WITH
- SOIL (SEE BELOW*) CONTINUE TILLAGE UNTIL A WELL - PULVERIZED, FIRM, REASONABLY UNIFORM SEEDBED IS PREPARED 4 TO 6 INCHES DEEP.
- SEED ON A FRESHLY PREPARED SEEDBED AND COVER SEED LIGHTLY WITH SEEDING
- EQUIPMENT OR CULTIPACK AFTER SEEDING. MULCH IMMEDIATELY AFTER SEEDING AND ANCHOR MULCH.
- INSPECT ALL SEEDED AREAS AND MAKE NECESSARY REPAIRS OR RESEEDINGS WITHIN THE PLANTING SEASON, IF POSSIBLE. IF STAND SHOULD BE OVER 60% DAMAGED REESTABLISHED
- FOLLOWING ORIGINAL LIME, FERTILIZER, AND SEEDING RATES CONSULT CONSERVATION INSPECTOR ON MAINTENANCE TREATMENT AND FERTILIZATION AFTER PERMANENT COVER IS ESTABLISHED.


AGRICULTURAL LIMESTONE - 1-1.5 TONS/ACRE ON COURSE TEXTURED SOILS AND 2-3 TONS/ACRE IN


FINE-TEXTURED SOILS. SOILS WITH PH OF 6 OR HIGHER NEED NOT BE LIMED.

FERTILIZER - 700/1000 LBS/ACRE (10-10-10) MULCH - 2 TONS/ACRE (SMALL GRAIN STRAW)

ANCHOR - ASPHALT EMULSION AT 450 GAL/ACRE

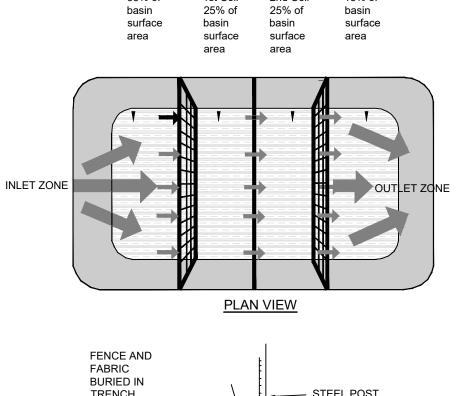

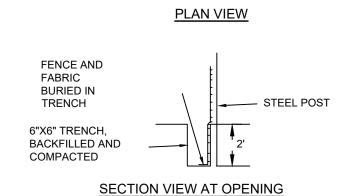

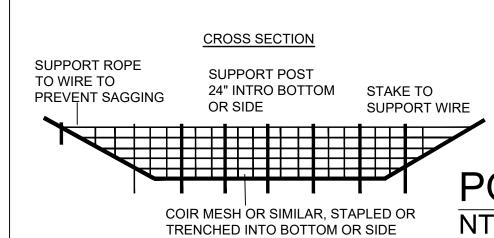

1. BAFFLE MATERIAL SHOULD BE SECURED AT THE BOTTOM AND

- USING STAPLES OR BY TRENCHING AS FOR SILT FENCE. 2. MOST OF THE SEDIMENT WILL ACCUMULATE IN THE 1ST BAY,
- WHICH SHOULD BE READILY ACCESSIBLE FOR MAINTENANCE. 3. PROVIDE 3 BAFFLES (USE TWO IF LESS THAN 20 FEET IN LENGTH). 5 BAFFLES FOR DRAINAGE AREAS GREATER THAN 10 ACRES.
- 4. BAFFLE SHALL BE 700 G/M2 COIR EROSION BLANKET. 5. TOPS OF BAFFLES SHOULD BE 2 INCHES LOWER THAN THE TOP
- OF THE BERMS 6. INSPECT BAFFLES FOR REPAIR ONCE A WEEK AND AFTER EACH RAINFALL

INSPECT BAFFLES AT LEAST ONCE A WEEK AND AFTER EACH RAINFALL. MAKE ANY REQUIRED REPAIRS IMMEDIATELY.

BE SURE TO MAINTAIN ACCESS TO THE BAFFLES. SHOULD THE FABRIC OF A BAFFLE COLLAPSE, TEAR, DECOMPOSE, OR BECOME INEFFECTIVE, REPLACE IT PROMPTLY.

REMOVE SEDIMENT DEPOSITS WHEN IT REACHES HALF FULL TO PROVIDE ADEQUATE STORAGE VOLUME FOR THE NEXT RAIN AND TO REDUCE PRESSURE ON THE BAFFLES. TAKE CARE TO AVOID UNDERMINING THE FENCE DURING CLEANOUT. SEDIMENT DEPTH SHOULD NEVER EXCEED HALF THE DESIGNED STORAGE DEPTH.

REMOVE ALL BAFFLE MATERIALS AND UNSTABLE SEDIMENT DEPOSITS AND BRING THE AREA TO GRADE AND STABILIZE IT AFTER THE CONTRIBUTING DRAINAGE AREA HAS BEEN PROPERLY STABILIZED.


POROUS BAFFLES DETAIL


TOP RIM OF DITCH

STEEP CUT OR

FILL SLOPE -

MAINTENANCE IMMEDIATELY. REMOVE SEDIMENT AND RESTORE THE BASIN TO ITS ORIGINAL DIMENSIONS WHEN SEDIMENT ACCUMULATES TO ONE-HALF THE HEIGHT OF THE FIRST BAFFLE. PULL THE STONE W/FABRIO SKIMMER TO ONE SIDE SO THAT THE SEDIMENT * AREA OF BASIN WATER SURFACE AT PROVIDE STABLE TRANSITIONS FROM TEMPORARY DIVERSIONS INTO BASINS. TOP OF PRINCIPAL SPILLWAY ELEVATION PROVIDE 25% BAFFLE SPACING WITHIN BASIN. STAKE TO SUPPORT WIR **BAFFLE DETAIL** DESIGN LIFE OF FABRIC IS 6-12 MONTHS JUTE OR COIR

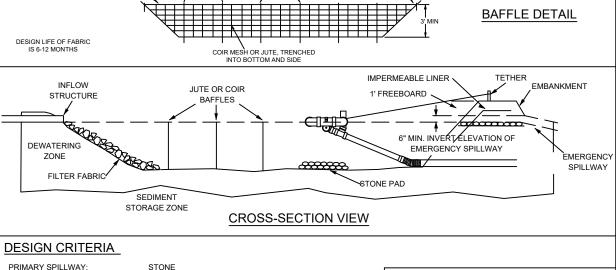

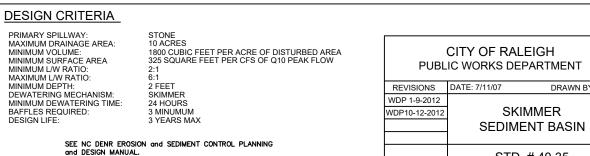

SKIMMER SEDIMENT BASIN INSPECT SKIMMER SEDIMENT BASINS AT LEAST WEEKLY AND AFTER EACH SIGNIFICANT (1/2 INCH OR GREATER) RAINFALL EVENT AND REPAIR

NOT FOR CONSTRUCTION 01/09/2022

UNDERNEATH IT CAN BE EXCAVATED. EXCAVATE THE SEDIMENT FROM THE ENTIRE BASIN, NOT JUST AROUND THE SKIMMER OR THE FIRST CELL MAKE SURE VEGETATION GROWING IN THE BOTTOM OF THE BASIN DOES NOT HOLD DOWN THE SKIMMER. REPAIR BAFFLES IF THEY ARE DAMAGED. RE-ANCHOR THE BAFFLES IF WATER IS FLOWING UNDERNEATH OR AROUND THEM. IF THE SKIMMER IS CLOGGED WITH TRASH AND THERE IS WATER IN THE BASIN, USUALLY JERKING ON THE ROPE WILL MAKE THE SKIMMER BOB UP AND DOWN AND DISLODGE THE DEBRIS AND RESTORE FLOW. IF THIS DOES NOT WORK, PULL THE SKIMMER OVER TO THE SIDE OF THE BASIN AND REMOVE THE DEBRIS. ALSO CHECK THE ORIFICE INSIDE THE SKIMMER TO SEE IF IT IS CLOGGED; IF SO REMOVE THE DEBRIS. IF THE SKIMMER ARM OR BARREL PIPE IS CLOGGED, THE ORIFICE CAN BE REMOVED AND THE OBSTRUCTION CLEARED WITH A PLUMBER'S SNAKE OR BY FLUSHING WITH WATER. BE SURE AND REPLACE THE ORIFICE BEFORE REPOSITIONING THE SKIMMER. CHECK THE FABRIC LINED SPILLWAY FOR DAMAGE AND MAKE ANY REQUIRED REPAIRS WITH FABRIC THAT SPANS THE FULL WIDTH OF THE SPILLWAY. CHECK THE EMBANKMENT, SPILLWAYS, AND OUTLET FOR EROSION DAMAGE, AND INSPECT THE EMBANKMENT FOR PIPING AND

SETTLEMENT. MAKE ALL NECESSARY REPAIRS

IMMEDIATELY. REMOVE ALL TRASH AND OTHER

DEBRIS FROM THE SKIMMER AND POOL AREAS.

PRECAUTIONS SHOULD BE TAKEN IN THE WINTER

TO PREVENT THE SKIMMER FROM PLUGGING

FREEZING WEATHER CAN RESULT IN ICE

FORMING IN THE BASIN. SOME SPECIAL

DATE 10/10/2022 DRAWN BY

J. YOKLEY **DESIGNED BY** J. DOOLEY

CHECKED BY R. BAKER

SCALE AS SHOWN

SECTION A-A

RIP RAP APRON NTS

2:1 SLOPE (MAXIMUM) STABILIZE DIVERSION DITCH WITH TEMPORARY SEEDING AND EROSION CONTROL NETTING. POSITIVE GRADE 1.0% MAXIMUM 2:1 (MAXIMUM) STEEP CUT OR FILL SLOPE

MINIMUM

CONSTRUCTION SPECIFICATIONS

20' FROM

PROPERTY LINE

 REMOVE AND PROPERLY DISPOSE OF ALL TREES, BRUSH, STUMPS, AND OTHER OBJECTIONABLE MATERIAL

2. ENSURE THAT THE MINIMUM CONSTRUCTED CROSS SECTION MEETS ALL DESIGN REQUIREMENTS.

3. ENSURE THAT THE TOP OF THE DIKE IS NOT LOWER AT ANY POINT THAN THE DESIGN ELEVATION PLUS THE SPECIFIED

4. PROVIDE SUFFICIENT ROOM AROUND DIVERSIONS TO PERMIT MACHINE REGRADING AND CLEANOUT.

5. DIVERSION DITCHES MUST COMPLY WITH THE 7-DAY GROUND STABILIZATION REQUIREMENT AT THE RIDGE OF THE BERM PER

6. VEGETATE THE RIDGE IMMEDIATELY AFTER CONSTRUCTION, UNLESS IT WILL REMAIN IN PLACE LESS THAN 30 WORKING DAYS

INSPECT TEMPORARY DIVERSIONS ONCE A WEEK AND AFTER EVERY RAINFALL.

IMMEDIATELY REMOVE SEDIMENT FROM THE FLOW AREA AND REPAIR THE DIVERSION RIDGE.

CAREFULLY CHECK OUTLETS AND MAKE TIMELY REPAIRS

WHEN THE AREA PROTECTED IS PERMANENTLY STABILIZED, REMOVE THE RIDGE AND THE CHANNEL TO BLEND WITH THE NATURAL GROUND LEVEL AND APPROPRIATELY STABILIZE IT.

STANDARD TEMPORARY DIVERSION DITCH

ROADWAY AGGREGATE EXISTING ROADWAY FABRIC UNDER STONE 12" MIN-

CONSTRUCTION SPECIFICATIONS


. CLEAR THE ENTRANCE AND EXIT AREA OF ALL VEGETATION, ROOTS AND OTHER OBJECTIONABLE MATERIAL AND PROPERLY GRADE IT

2. PLACE THE GRAVEL TO THE SPECIFIC GRADE AND DIMENSIONS SHOWN ON THE

- PLANS AND SMOOTH IT. 3. PROVIDE DRAINAGE TO CARRY WATER TO A SEDIMENT TRAP OR OTHER SUITABLE
- 4. USE GEOTEXTILE FABRICS BECAUSE THEY IMPROVE STABILITY OF THE FOUNDATION IN LOCATIONS SUBJECT TO SEEPAGE OR HIGH WATER TABLE.

MAINTAIN THE GRAVEL PAD IN A CONDITION TO PREVENT MUD OR SEDIMENT FROM LEAVING THE CONSTRUCTION SITE. THIS MAY REQUIRE PERIODIC TOP DRESSING WITH 2" STONE. AFTER EACH RAINFALL, INSPECT ANY STRUCTURE USED TO TRAP SEDIMENT AND IT OUT A NECESSARY. IMMEDIATELY REMOVE ALL OBJECTIONABLE MATERIALS SPILLED, WASHED OR TRACKED ONTO PUBLIC ROADWAYS

CONSTRUCTION ENTRANCE **DETAIL** NTS

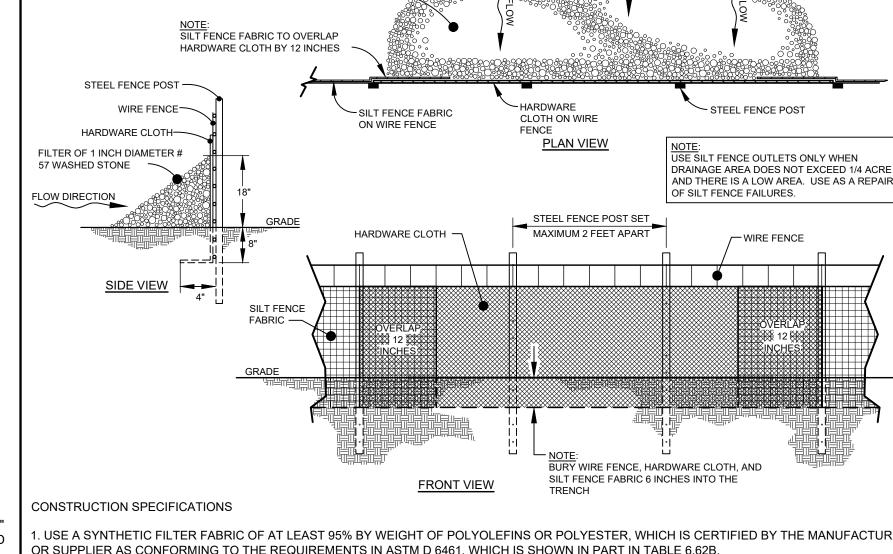

. USE A SYNTHETIC FILTER FABRIC OF AT LEAST 95% BY WEIGHT OF POLYOLEFINS OR POLYESTER, WHICH IS CERTIFIED BY THE MANUFACTUREI

SYNTHETIC FILTER FABRIC SHOULD CONTAIN ULTRAVIOLET RAY INHIBITORS AND STABILIZERS TO PROVIDE A MINIMUM OF 6 MONTHS OF

STEEL POSTS HAVE PROJECTIONS TO FACILITATE FASTENING THE FABRIC

INSPECT SEDIMENT FENCE AT LEAST ONCE A WEEK AND AFTER EACH RAINFALL. MAKE ANY REQUIRED REPAIRS IMMEDIATELY

REMOVE SEDIMENT DEPOSITS AS NECESSARY TO PROVIDE ADEQUATE STORAGE VOLUME FOR THE NEXT RAIN AND TO REDUCE PRESSURE ON THE FENCE. TAKE CARE TO AVOID UNDERMINING THE FENCE DURING CLEANOUT.

STANDARD SILT FENCE STONE OUTLET

PRELIMINARY - NOT RELEASED FOR CONSTRUCTION

ALL CONSTRUCTION TO BE IN ACCORDANCE WITH ALL TOWN OF ANGIER NCDEQ AND NCDOT STANDARDS, SPECIFICATIONS, AND DETAILS

2. ENSURE THAT POSTS FOR SEDIMENT FENCES ARE 1.25 LB/LINEAR FT MINIMUM STEEL WITH A MINIMUM LENGTH OF 5 FEET. MAKE SURE THAT

3. FOR REINFORCEMENT OF STANDARD STRENGTH FILTER FABRIC, USE WIRE FENCE WITH MINIMUM 14 GAUGE AND A MAXIMUM MESH SPACING OF 6 INCHES.

REMOVE ALL FENCING MATERIALS AND UNSTABLE SEDIMENT DEPOSITS AND BRING THE AREA TO GRADE AND STABILIZE IT AFTER THE

CLASS MINIMUM MIDRANGE MAXIMUM 14 PIPE DIA. SECTION, HEADWALL, OR ENDWALL PER PLAN ISOMETRIC VIEW

WITH ICE.

NOTE: FILTER FABRIC SHALL BE INSTALLED UNDER ALL RIPRAP ON THIS PROJECT

NCDOT GRADATION TABLE ACCEPTANCE CRITERIA FOR RIPRAP

AND STONE FOR EROSION CONTROL

REQUIRED STONE SIZES - INCHES

STD. # 40.35


do = PIPE DIA La = APRON LENGTH W1 = APRON WIDTH AT FES (=3 X PIPE Ø MIN) 2 = APRON WIDTH AT END


FOR FLAT AREA: W2 = do + La FOR CHANNEL : W2 = do + 0.4 La = APRON DEPTH SLOPE 0 % FILTER FABRIC


INSPECT RIPRAP OUTLET STRUCTURES WEEKLY AND AFTER SIGNIFICANT (1/2 INCH OR GREATER) RAINFAL EVENTS TO SEE IF ANY EROSION AROUND OR BELOW THE RIPRAP HAS TAKEN PLACE, OR IF STONES HAVE


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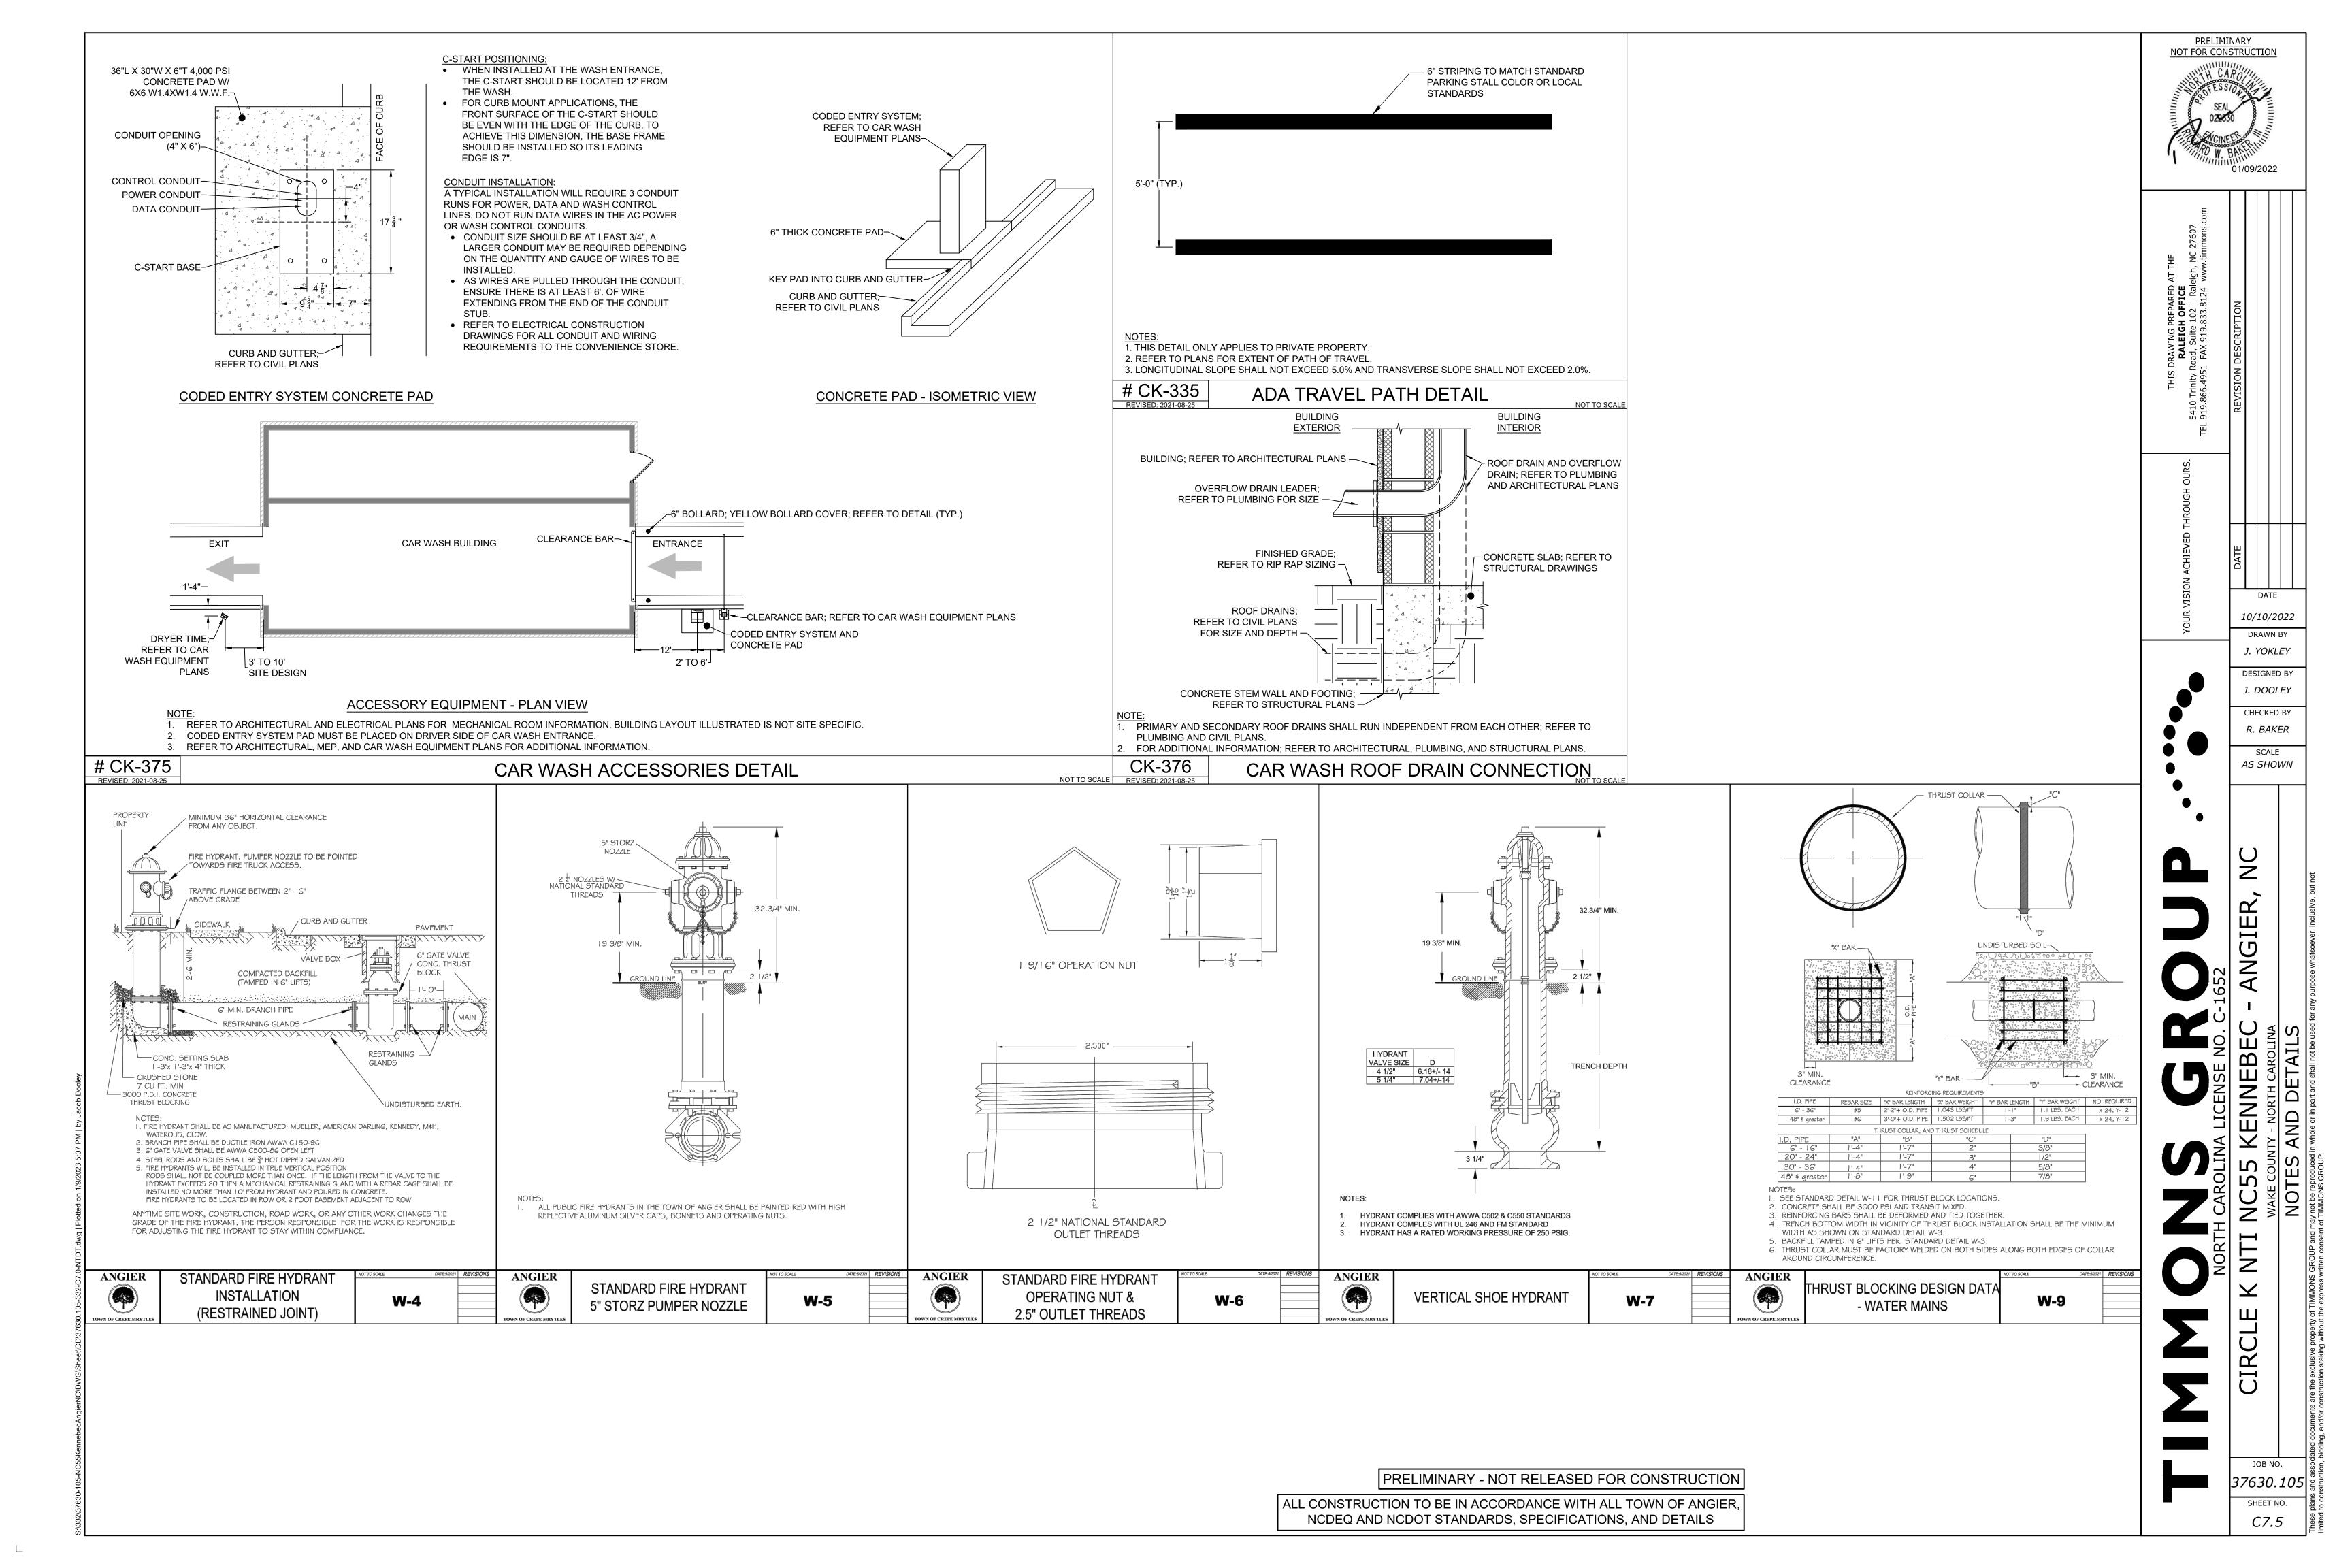



PRELIMINARY - NOT RELEASED FOR CONSTRUCTION
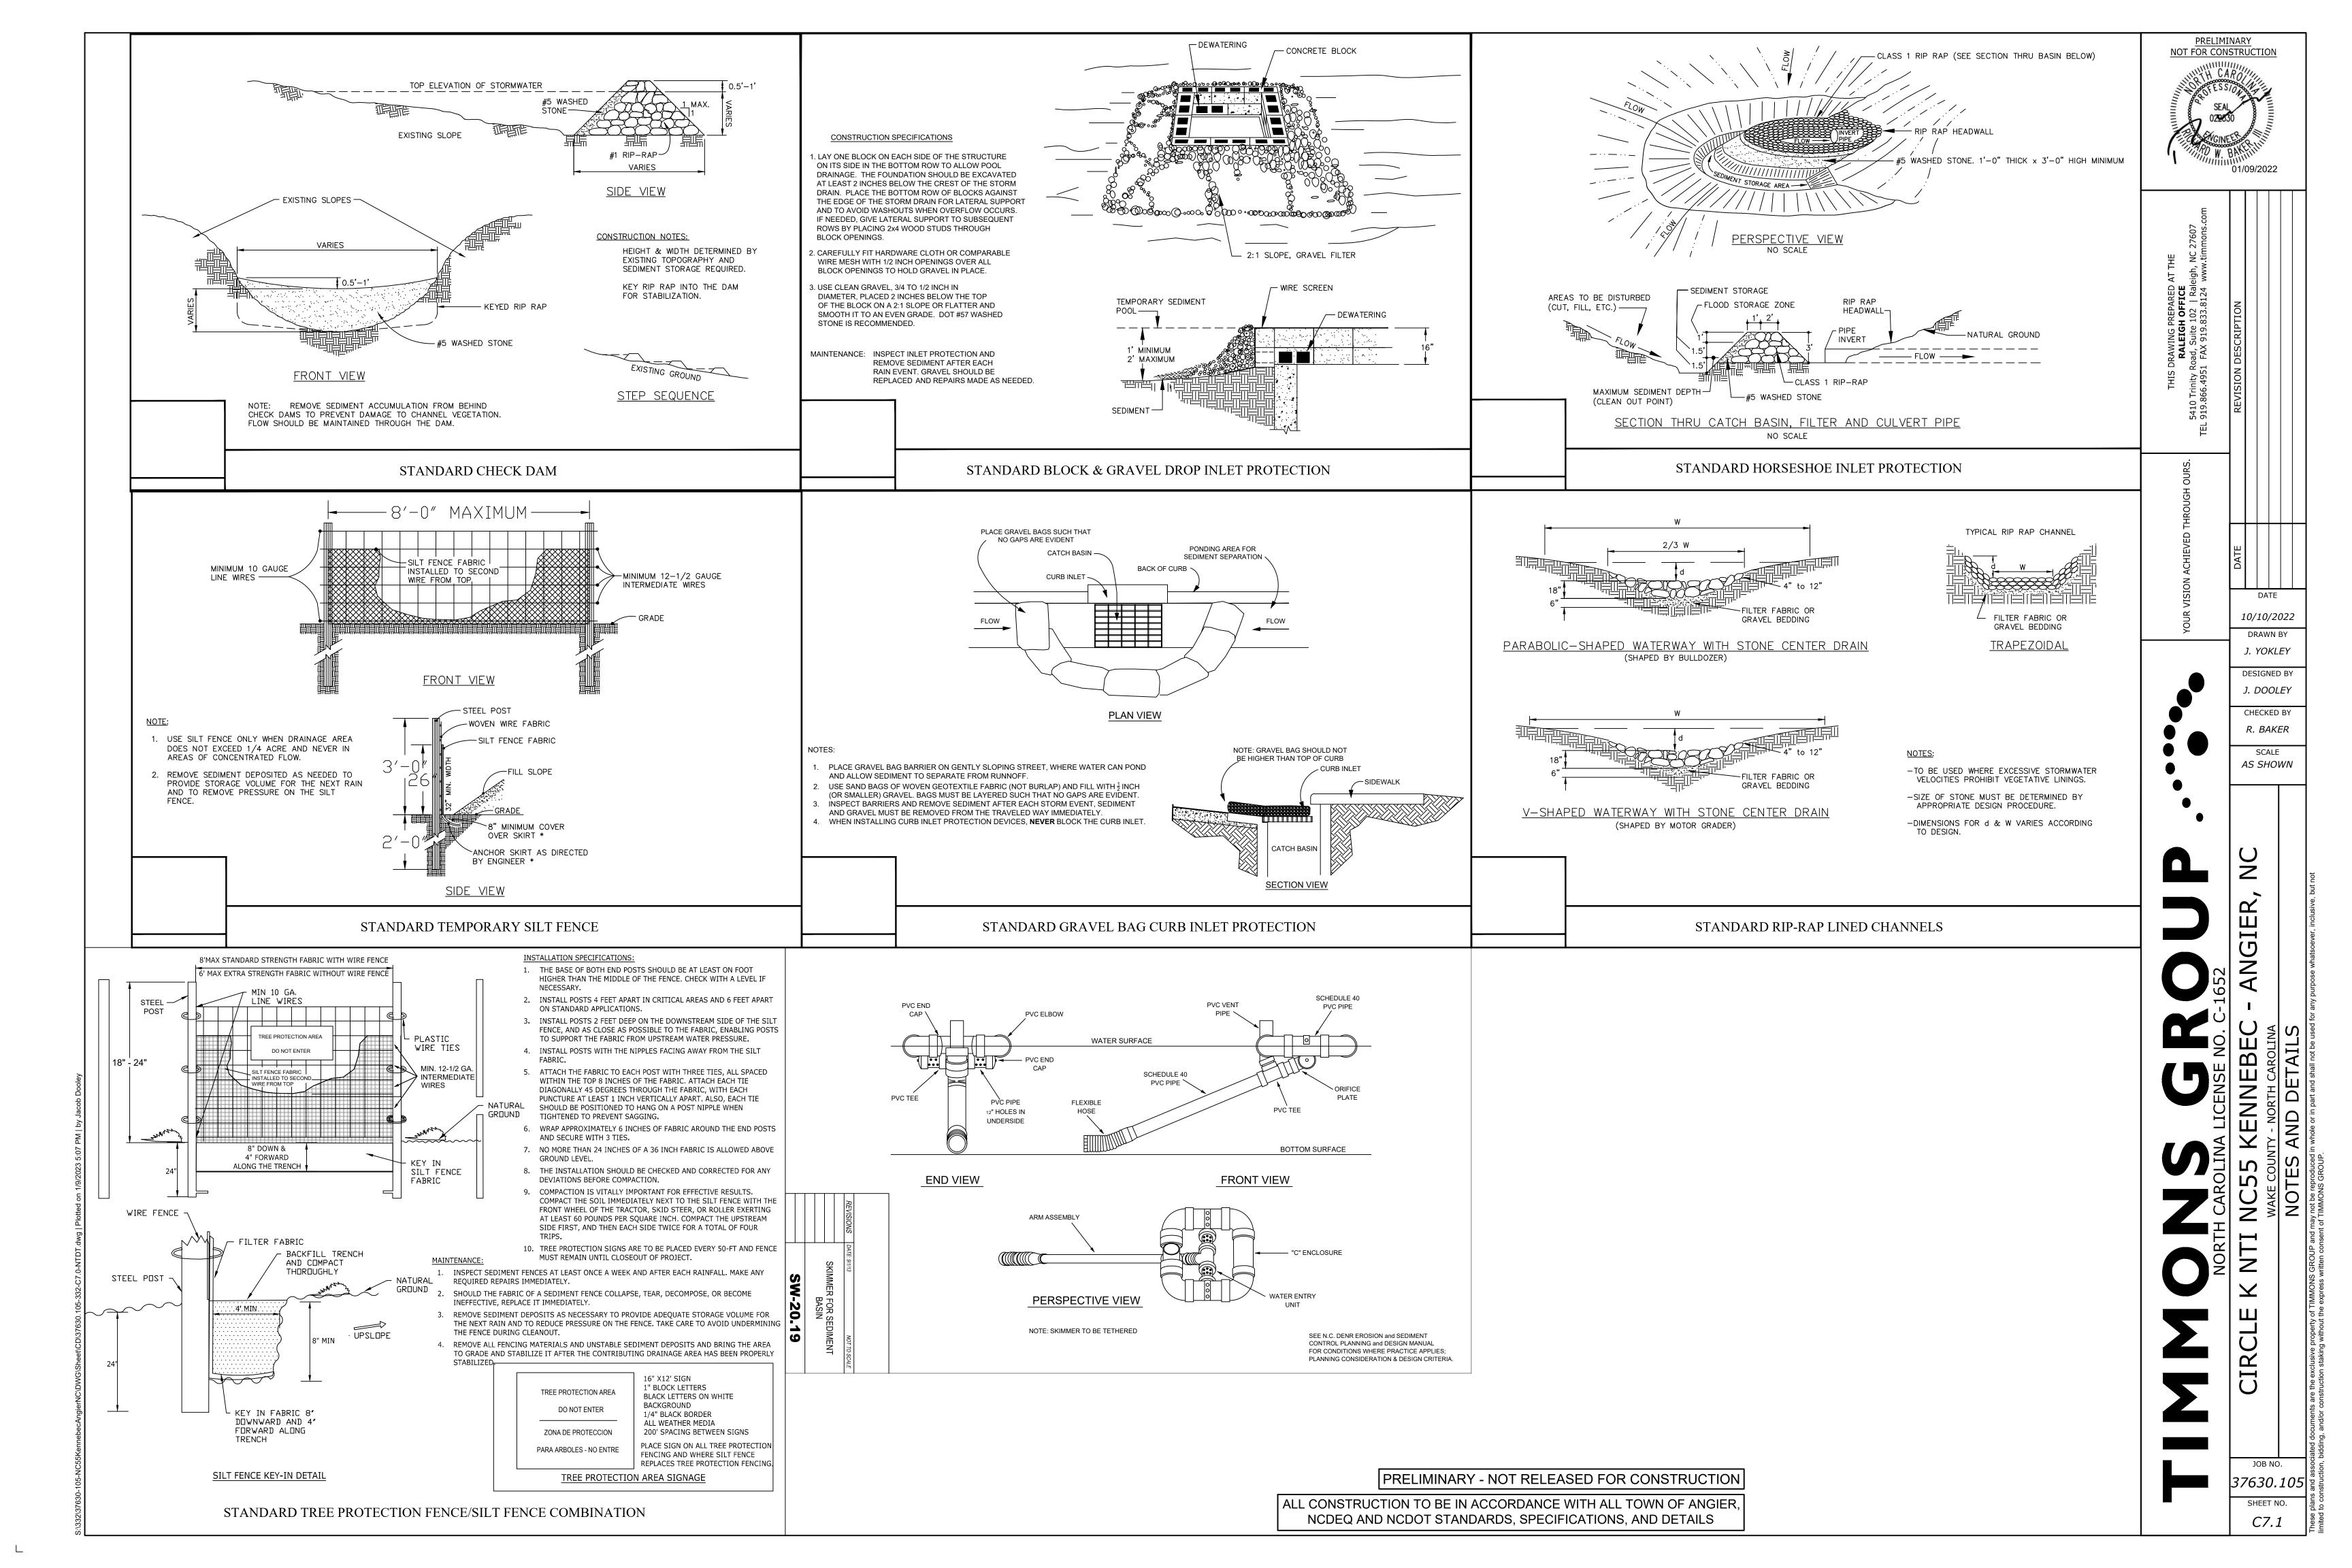
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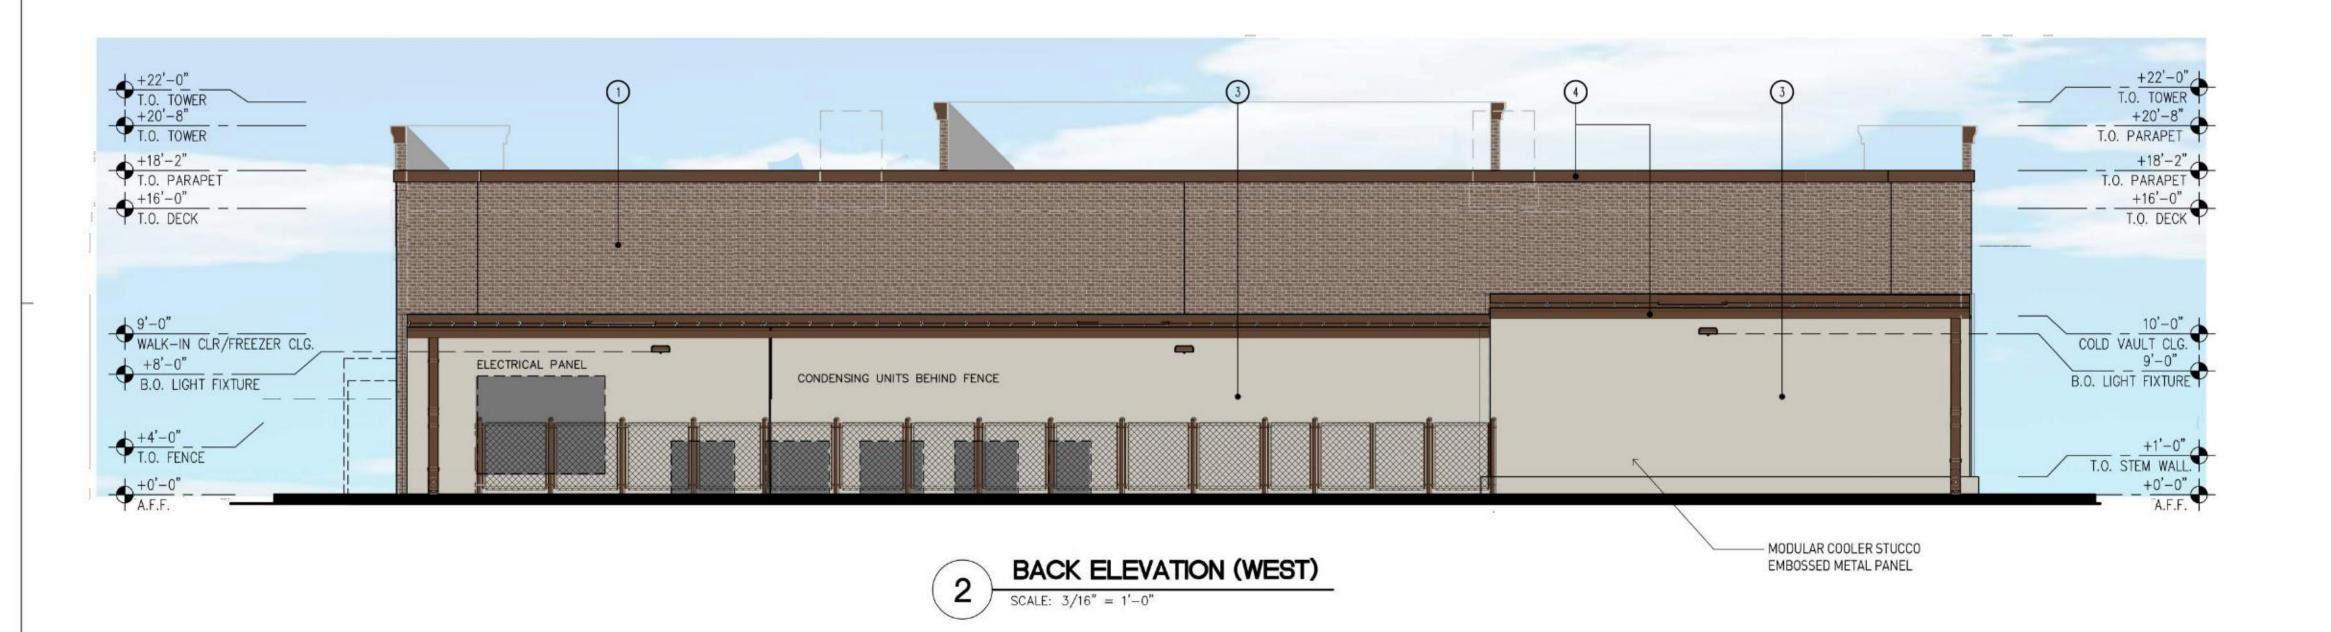
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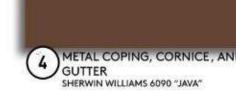
FRONT ELEVATION (EAST) SCALE: 3/16" = 1'-0"

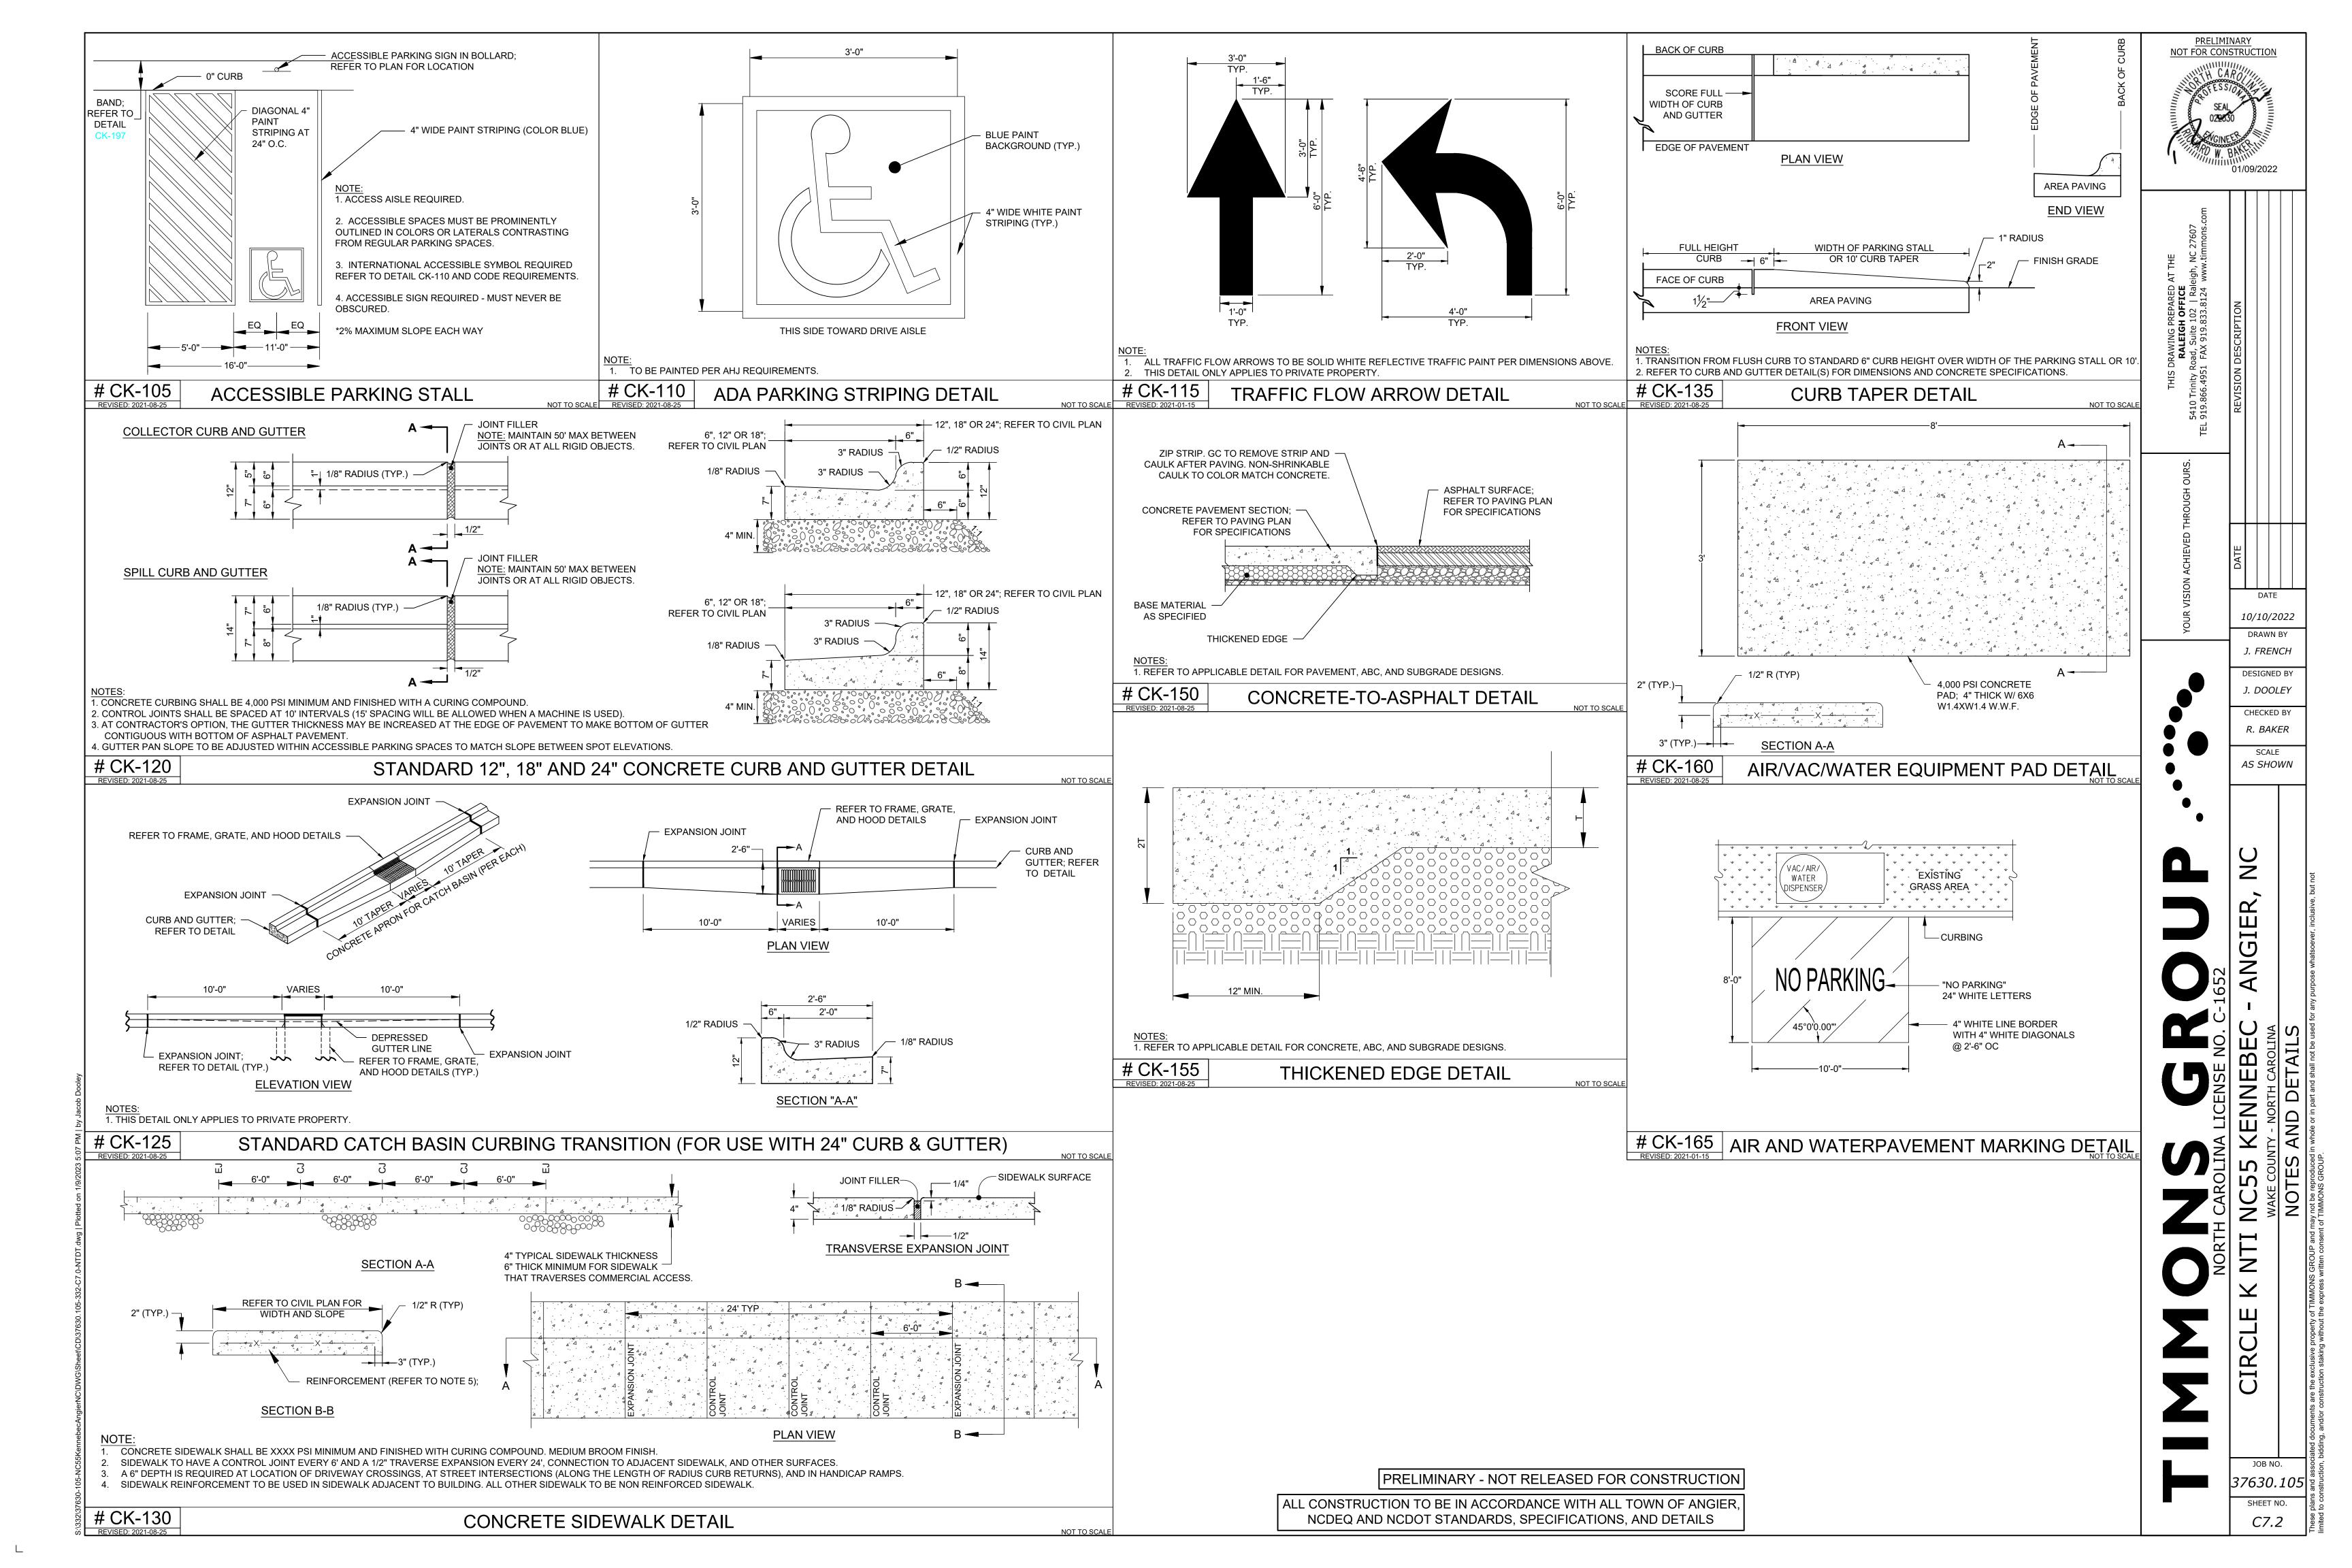

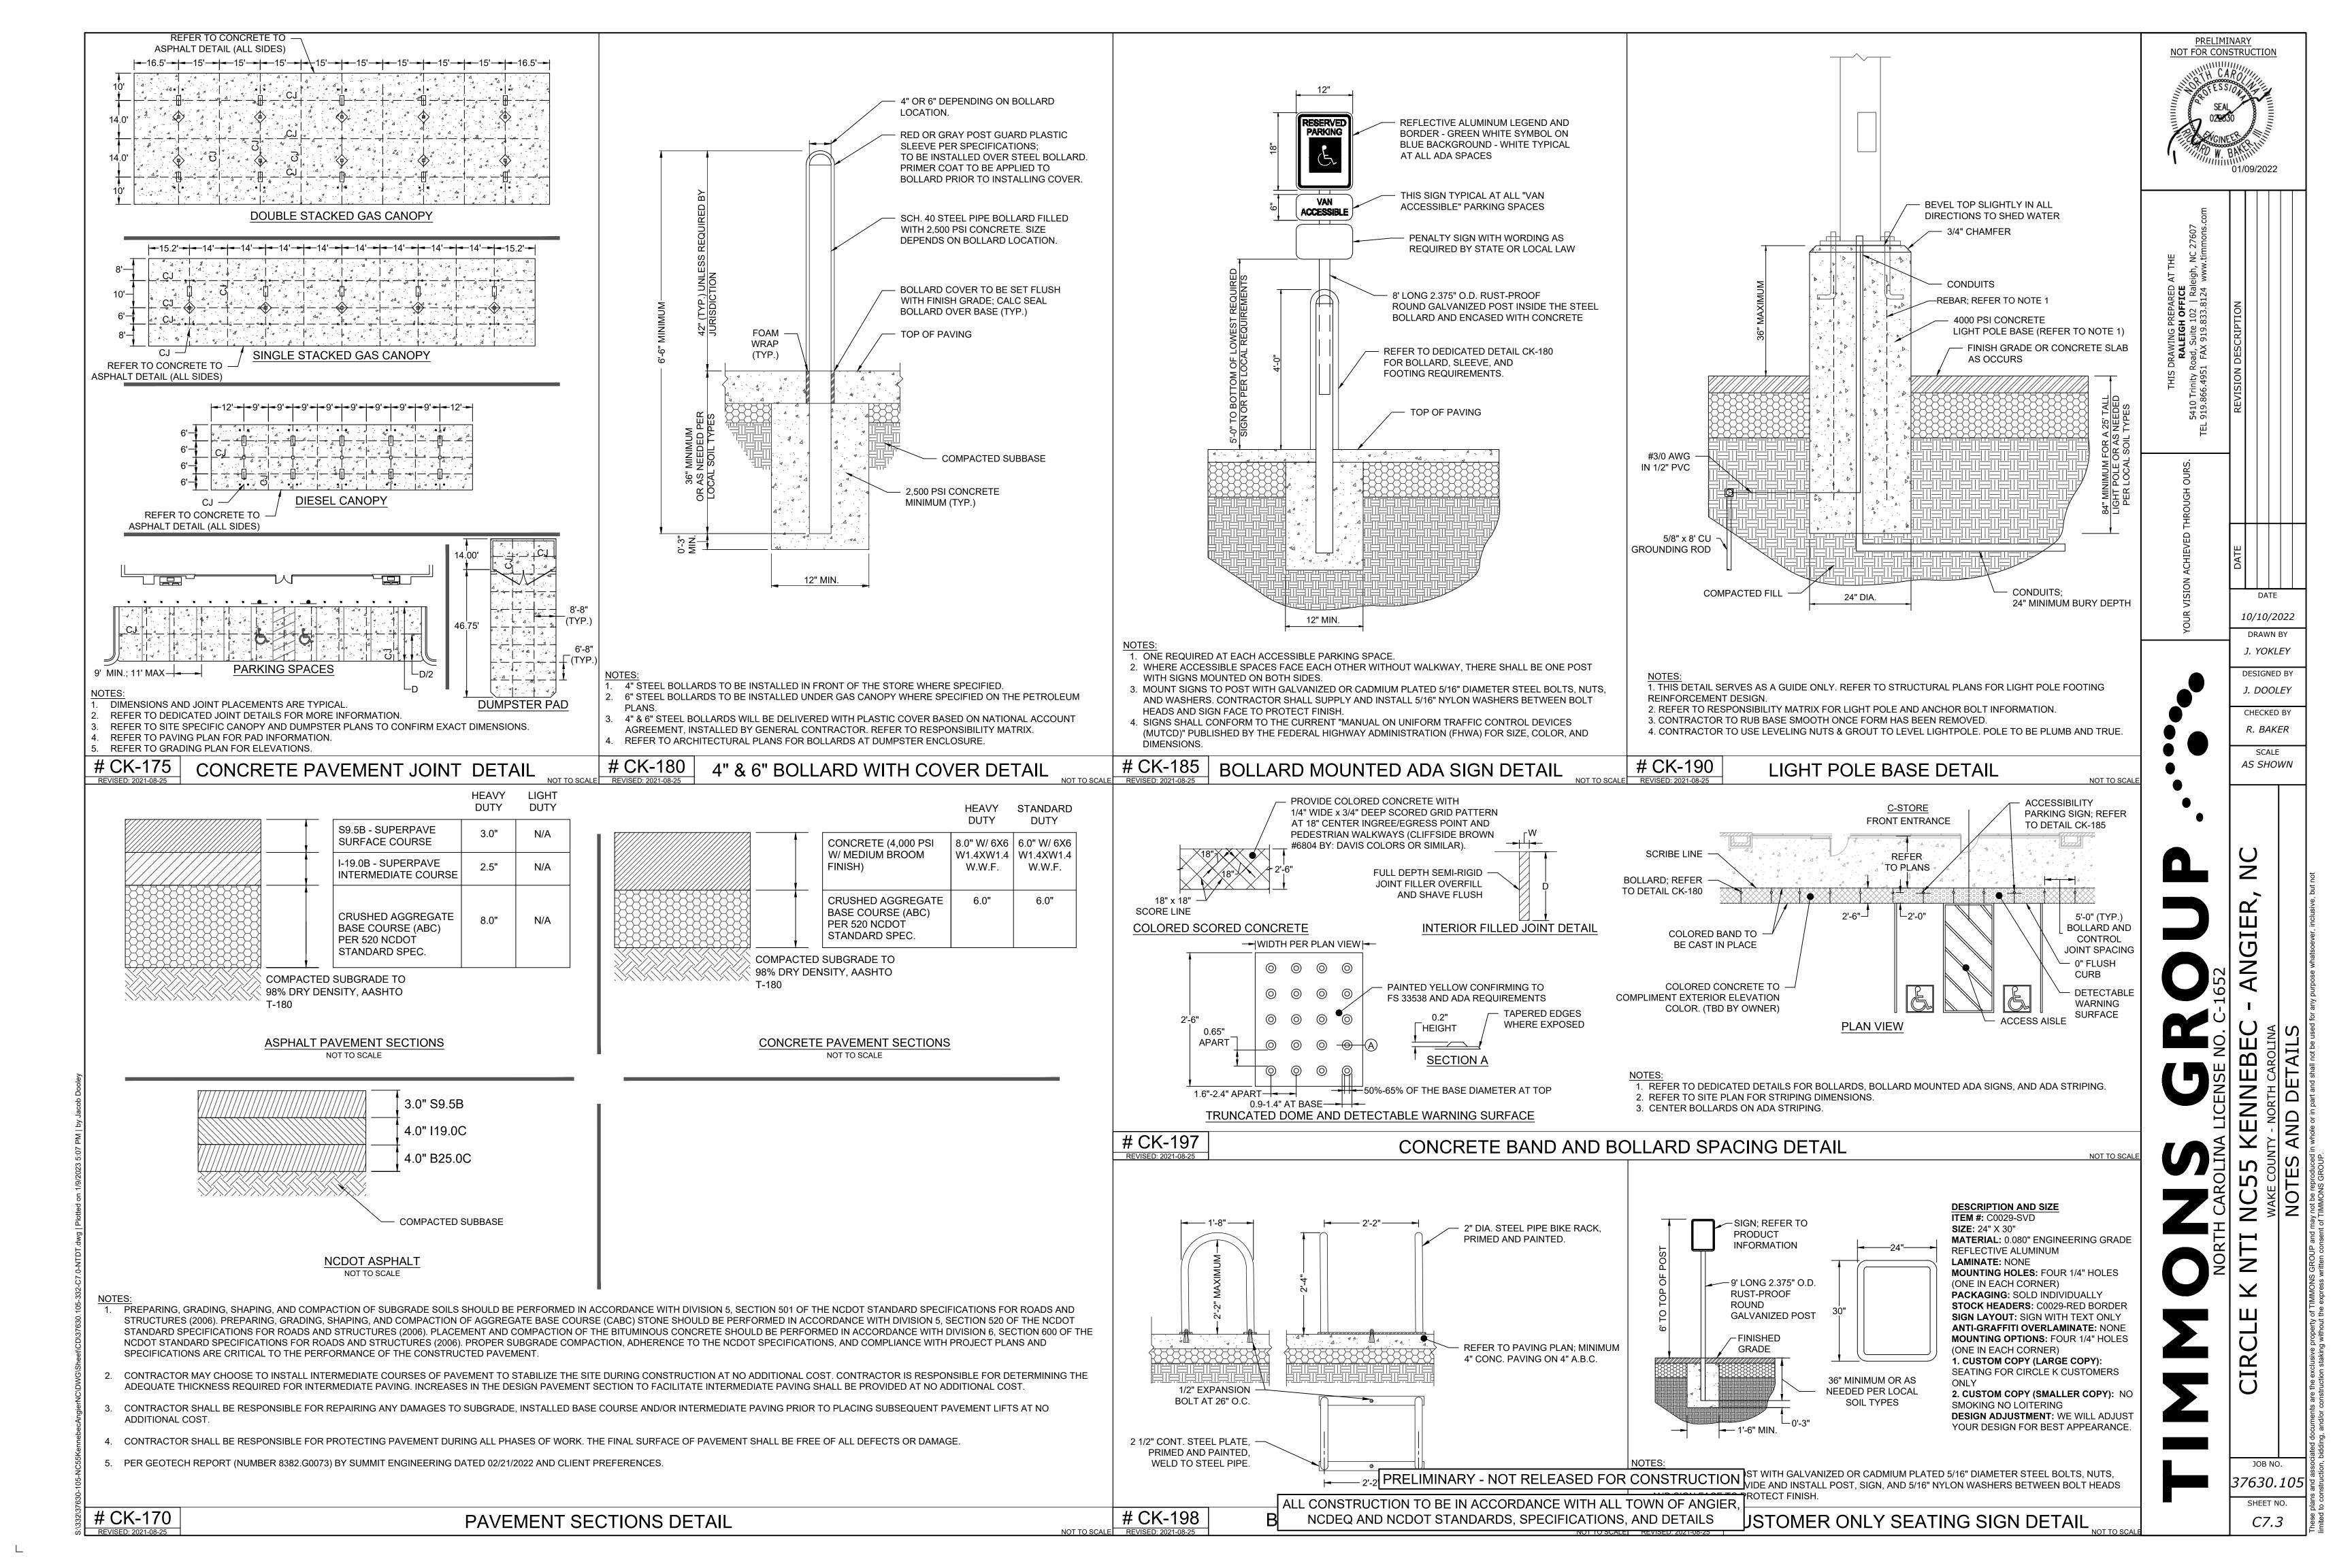SIDE ELEVATION (NORTH)

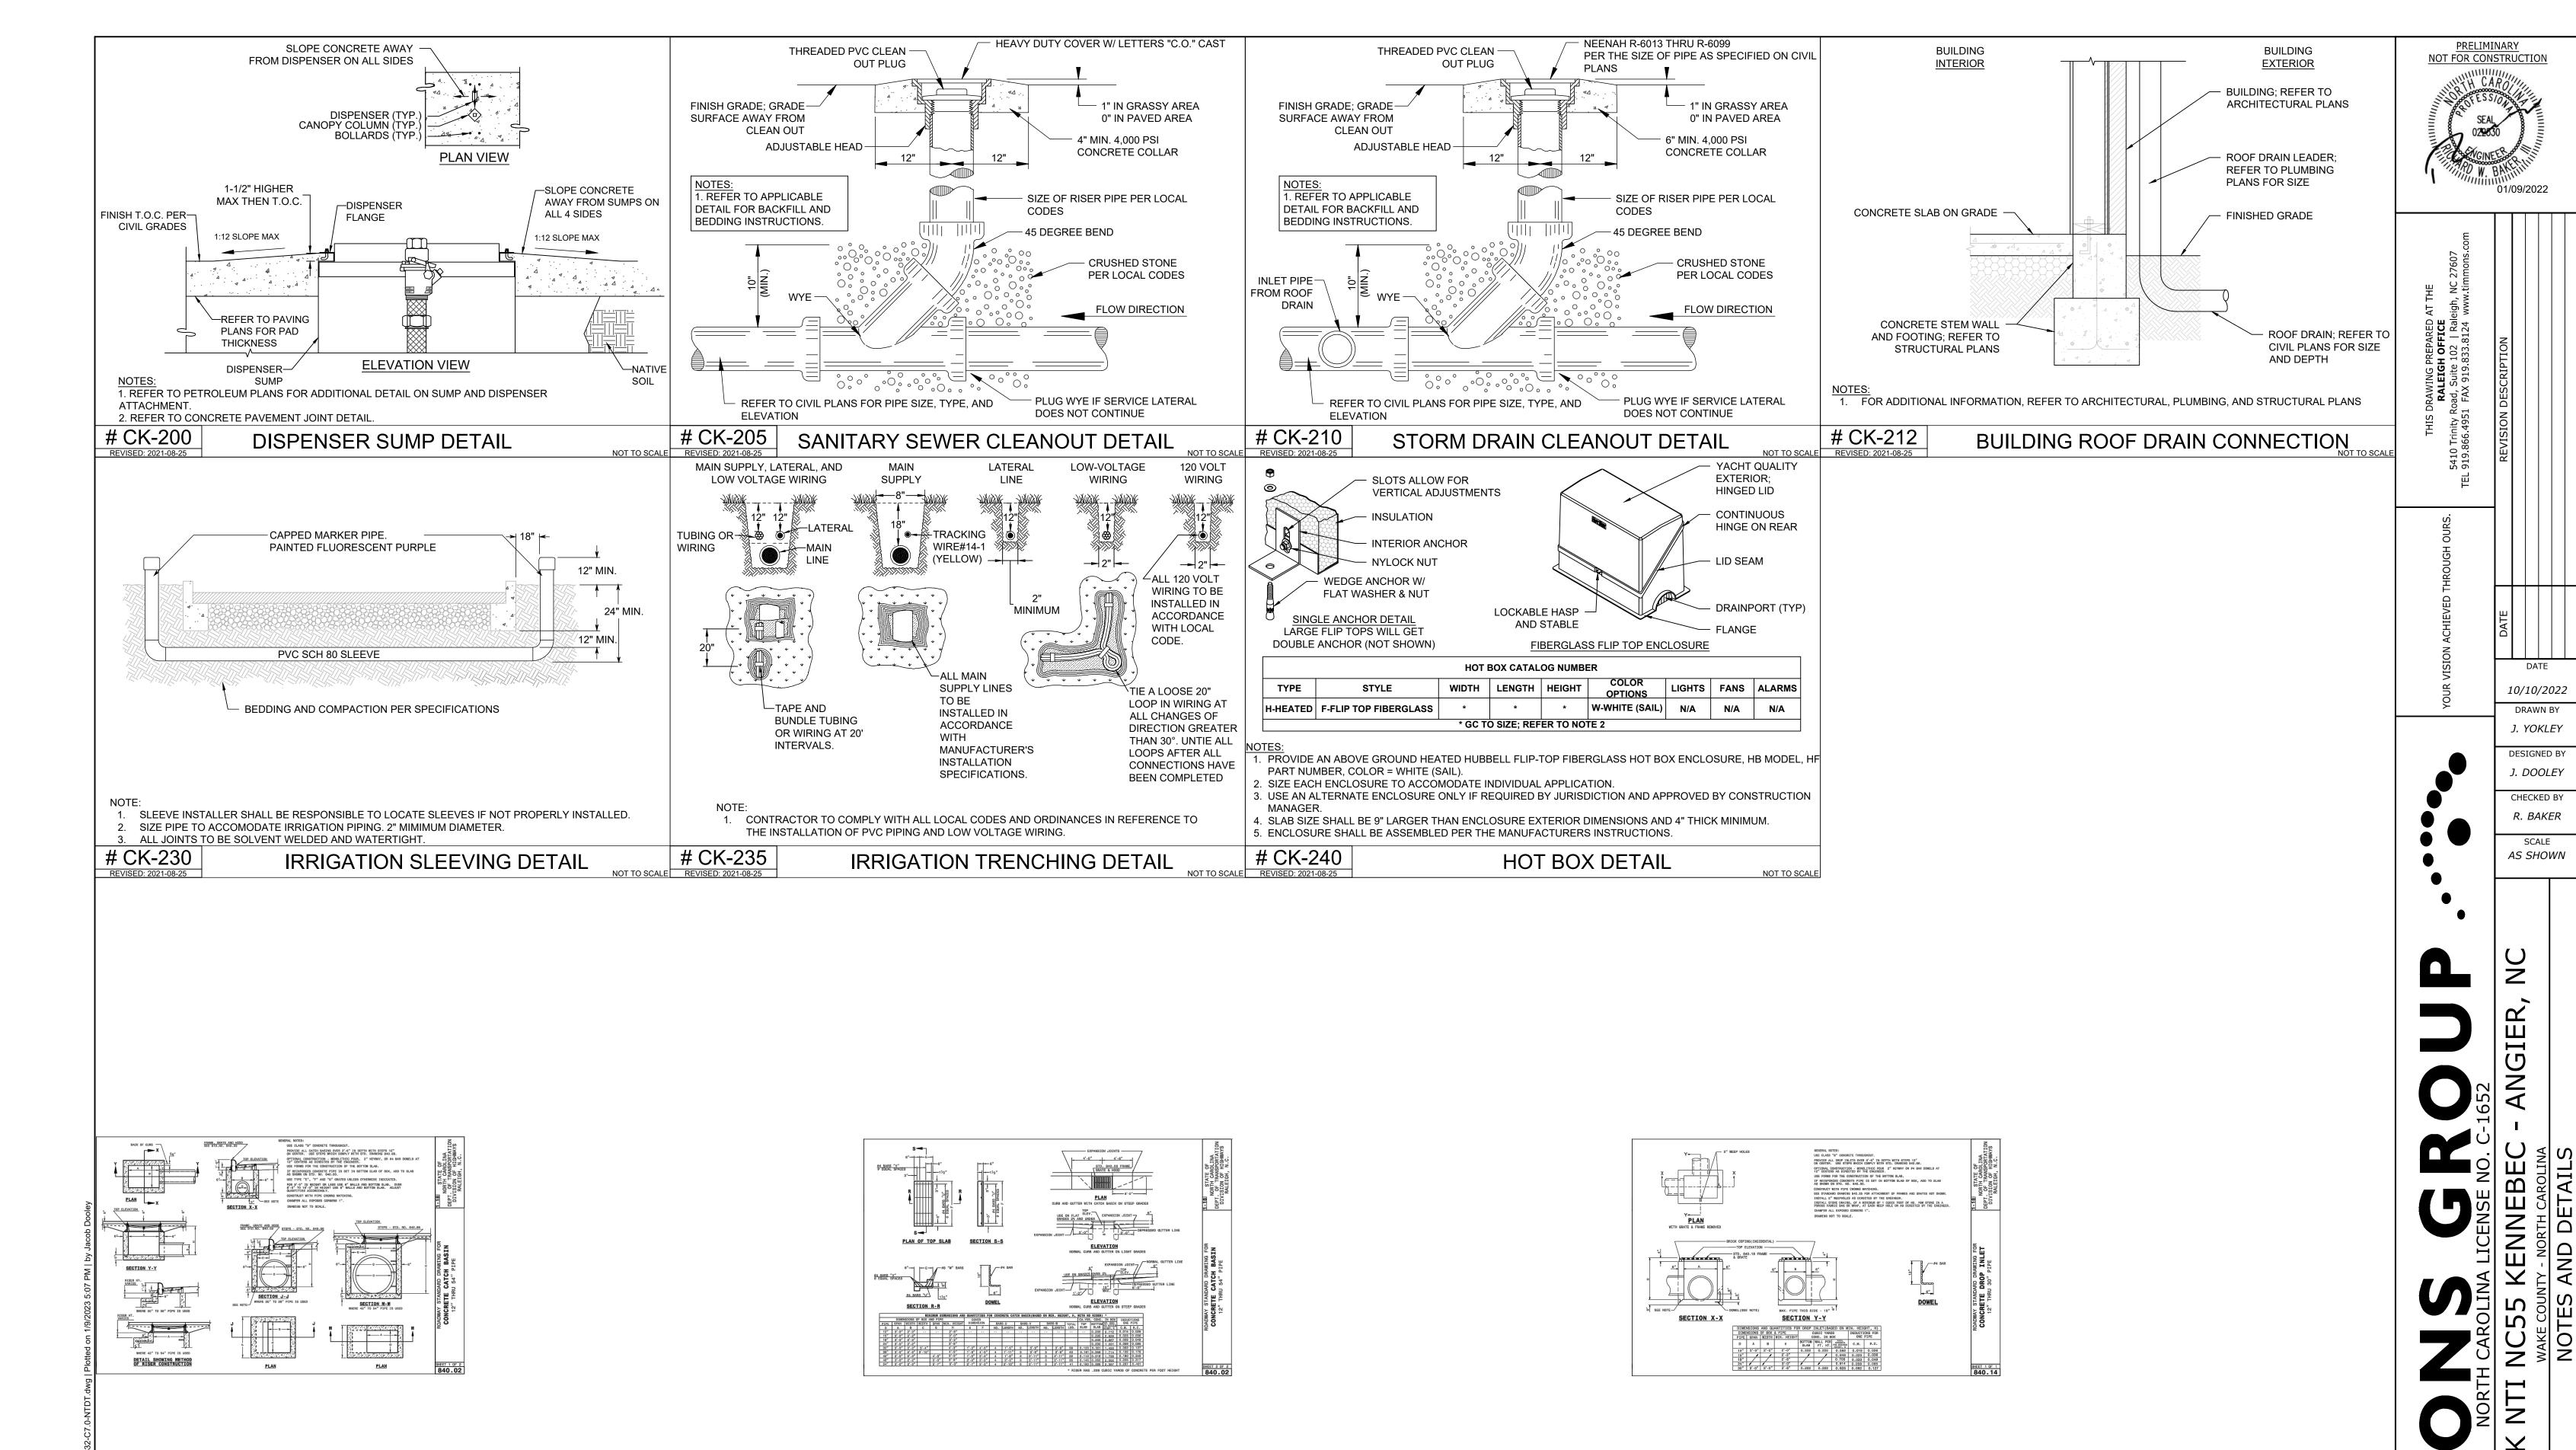

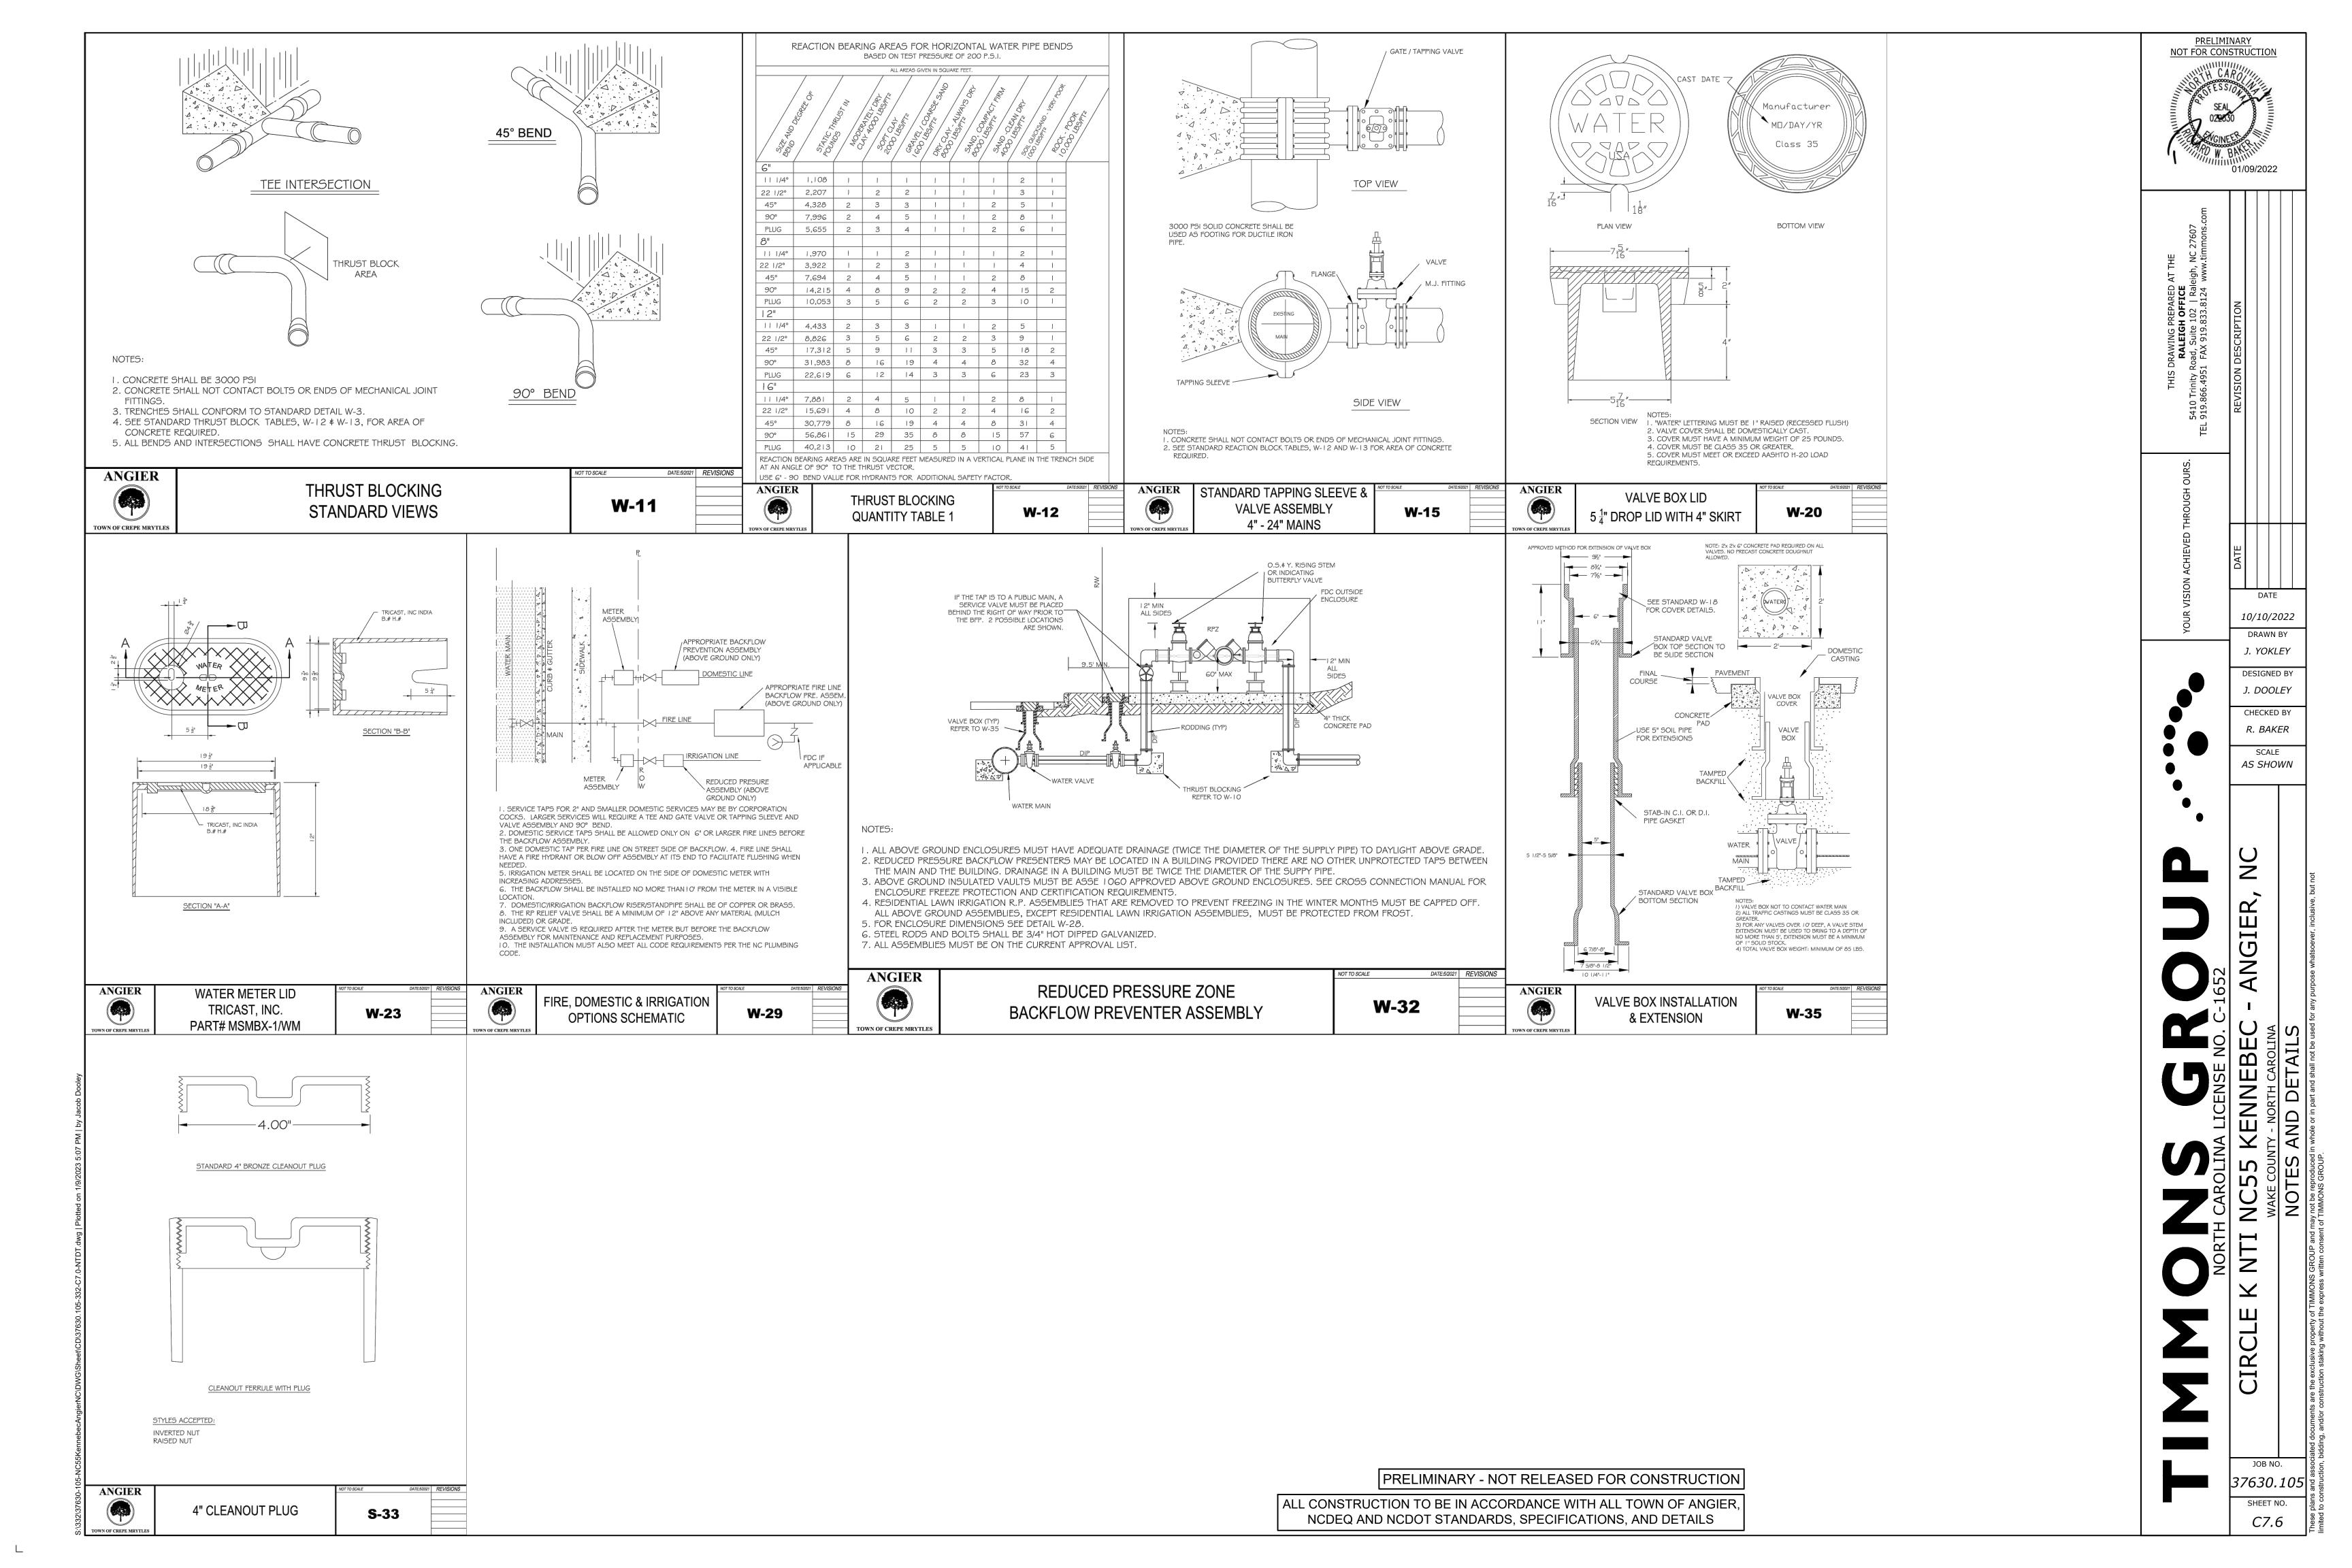5 1" INSULATED CLEAR GLASS



3 PRE-MANUFACTURED FREEZ-ER/COOLER WALLS



2 ALUMINUM CANOPY SHERWIN WILLIAMS 4081 "SAFETY RED"

Marke Marke Marke Marke MAIN COMMITT COMMITT COMMITTERS NICHIHA VINTAGE BRICK

ELEVATION CALCULATIONS: FRONT/EAST FACADE

68% - NICHIHA VINTAGE BRICK - "WHITE WASH" 3% - ALUMINUM CANOPY - SHERWIN WILLIAMS 4081 "SAFETY RED" 4% - METAL COPING, CORNICE, AND GUTTER - SHERWIN WILLIAMS 6090 "JAVA"

22% - 1" INSULATED CLEAR GLASS 3% - ANODIZED WINDOW FRAME - COLOR: DARK BRONZE

BACK/WEST FACADE

38% - NICHIHA VINTAGE BRICK - "WHITE WASH"

49% - PREMANUFACTURED FREEZER/COOLER WALLS - SHERWIN WILLIAMS 6115 "TOTALLY TAN" 13% - METAL COPING, CORNICE, AND GUTTER - SHERWIN WILLIAMS 6090 "JAVA"

SIDE/NORTH FACADE 79% - NICHIHA VINTAGE BRICK - "WHITE WASH"

1% - ALUMINUM CANOPY - SHERWIN WILLIAMS 40B1 "SAFETY RED"

15% - PREMANUFACTURED FREEZER/COOLER WALLS - SHERWIN WILLIAMS 6115 "TOTALLY TAN"
5% - METAL COPING, CORNICE, AND GUTTER - SHERWIN WILLIAMS 6090 "JAVA"

SIDE/SOUTH FACADE 74% - NICHIHA VINTAGE BRICK - "WHITE WASH"

1% - ALUMINUM CANOPY - SHERWIN WILLIAMS 4081 "SAFETY RED"

15% - PREMANUFACTURED FREEZER/COOLER WALLS - SHERWIN WILLIAMS 6115 "TOTALLY TAN" 4% - METAL COPING, CORNICE, AND GUTTER - SHERWIN WILLIAMS 6090 "JAVA"

3% - 1" INSULATED CLEAR GLASS

SIDE ELEVATION (SOUTH)

SCALE: 3/16" = 1'-0"

3% - ANODIZED WINDOW FRAME - COLOR: DARK BRONZE

rdc.

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PROFESSIONAL SEAL



PROFESSIONAL IN CHARGE

PROJECT MANAGER

QUALITY CONTROL

DRAWN BY

PROJECT NAME

CIRCLE K STORES, INC.

ANGIER NC

9706 KENNEBEC CHURCH RD. ANGIER, NC 27501




CIRCLE K STORES INC.

PROJECT NUMBER 22130

SHEET TITLE

EXTERIOR ELEVATIONS

SHEET NUMBER

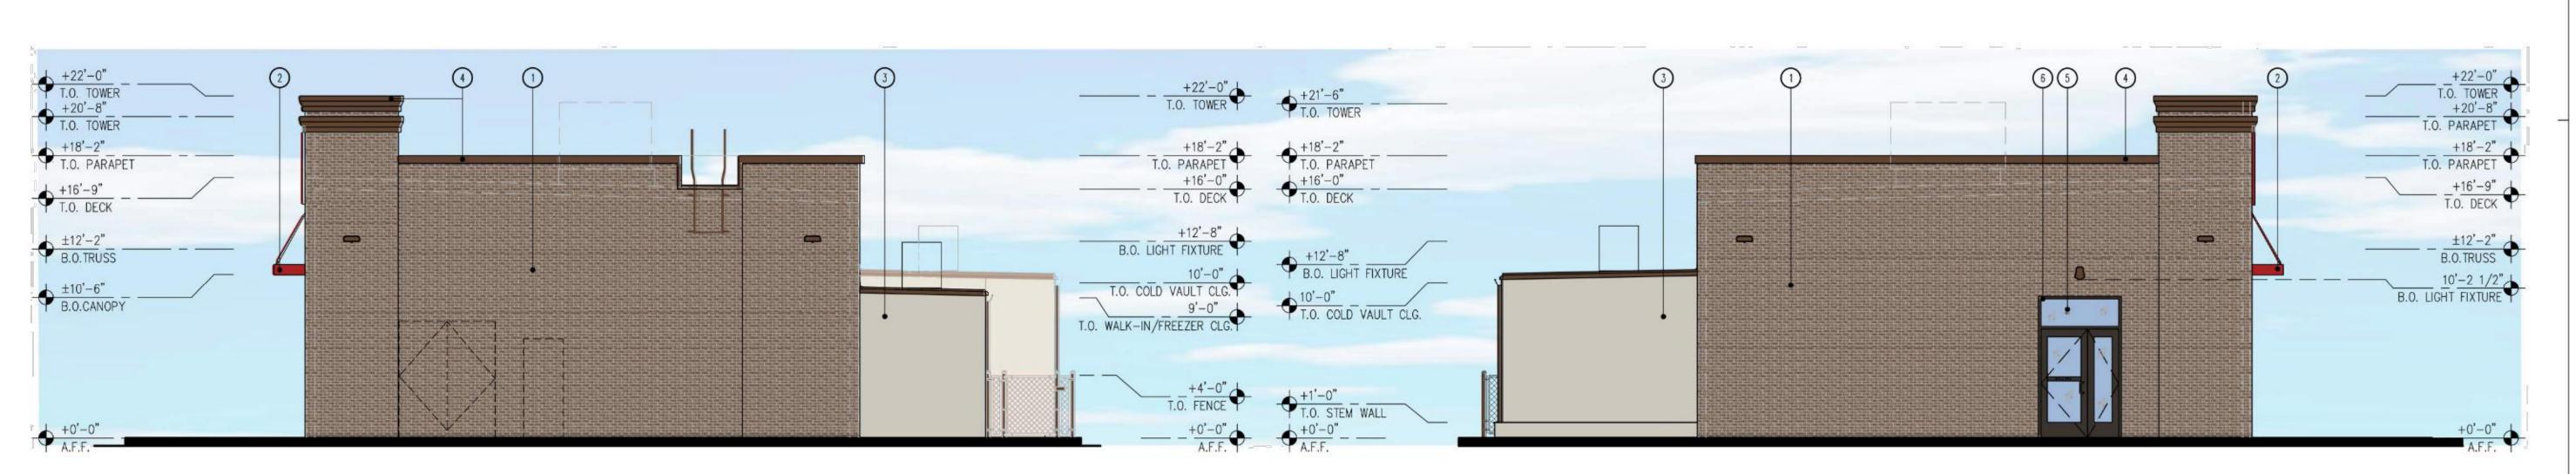



SCALE: 1/4" = 1'-0"

NORTH ELEVATION

SCALE: 1/4" = 1'-0"

SCALE: 1/14" = 1'-0"

SCALE: 1/4" = 1'-0"

T. O. SCREEN WALL +23'-4" T. O. SCREEN WALL +23'-4" T.O.PARAPET +21'-6" B. O. LIGHT FIXTURE B. O. LIGHT FIXTURE +14'-6" CAR WASH T.O.WINDOW FRAME +10'-8" T.O.WINDOW FRAME +10'-8" AND COME STORY STORY STORY SHALL COME STORY SHALL COME STORY AND A STORY STORY SHALL COME S r (1906) AND COMES STORE ST FF @ EQ. RM. FF @ EQ. RM. FINISH FLOOR

WEST ELEVATION

CIRCLE K STORE INC. PROJECT NUMBER: 22130

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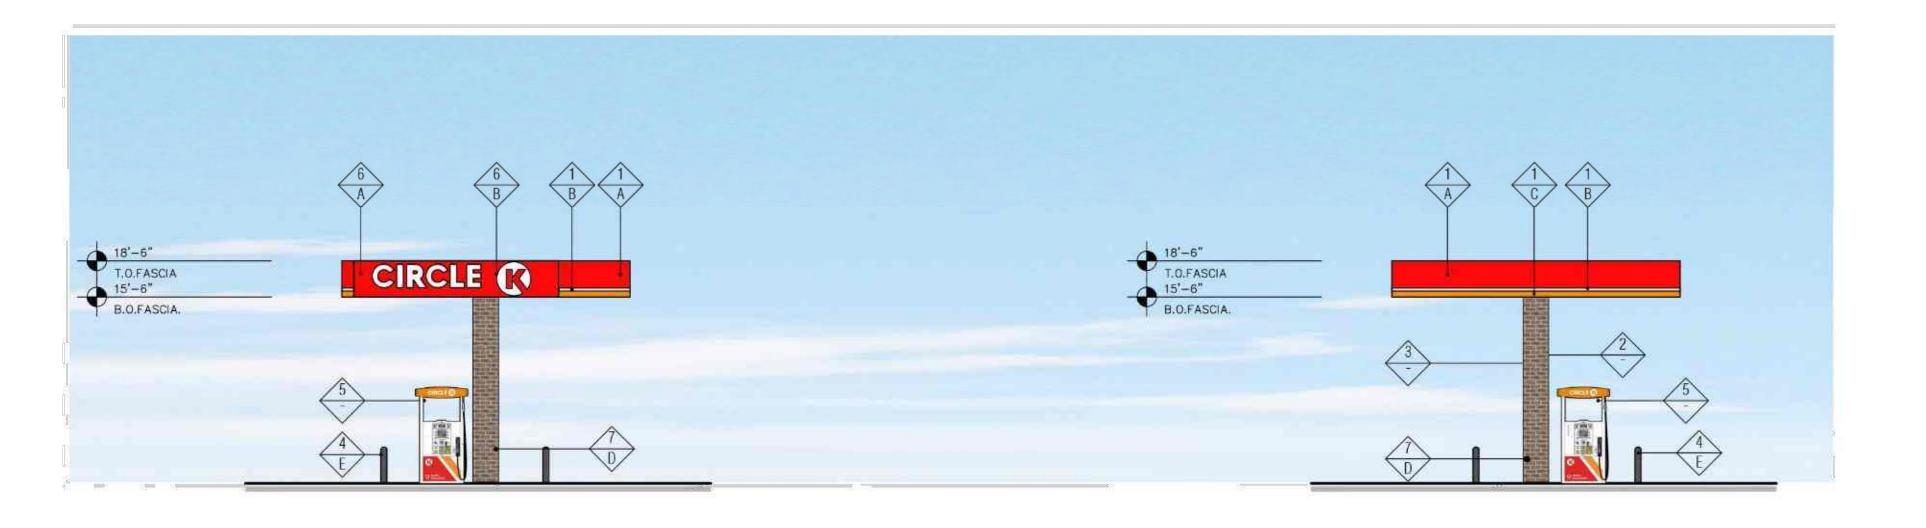
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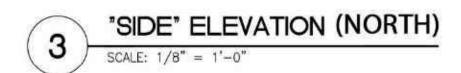
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EXTERIOR ELEVATIONS

A2.0-CW











	FINISH MATERIAL	
1	ACM PANEL "TEX-COTE"	
2	COLUMN FLAGS BY SIGNAGE VENDOR	
3	LINE OF STEEL COLUMN WITHIN	
4 6" Ø BOLLARD, 36" HIGH		
5	FUEL PUMP	
6	INTERNALLY ILLUMINATED SIGN UNDER SEPARATE PERMIT	
7	NICHIHA VINTAGE BRICK	
	FINISH COLOR	
Α	CIRCLE K RED #PMS 485	
В	GIRCLE K WHITE	
C	CIRCLE K ORANGE #PMS 144	
D	NICHIHA "WHITE WASH"	
E	PVC BOLLARD SLEEVE "DARK GRAY"	

- 1. Colors shown on these elevations are for illustration purposes only. For actual colors, refer to manufacturer's samples.
- The fascia panels are pre-finished by signage vendor
 All signs require a separate submittal.
 All lighting on canopy to be flush mounted with fascia.

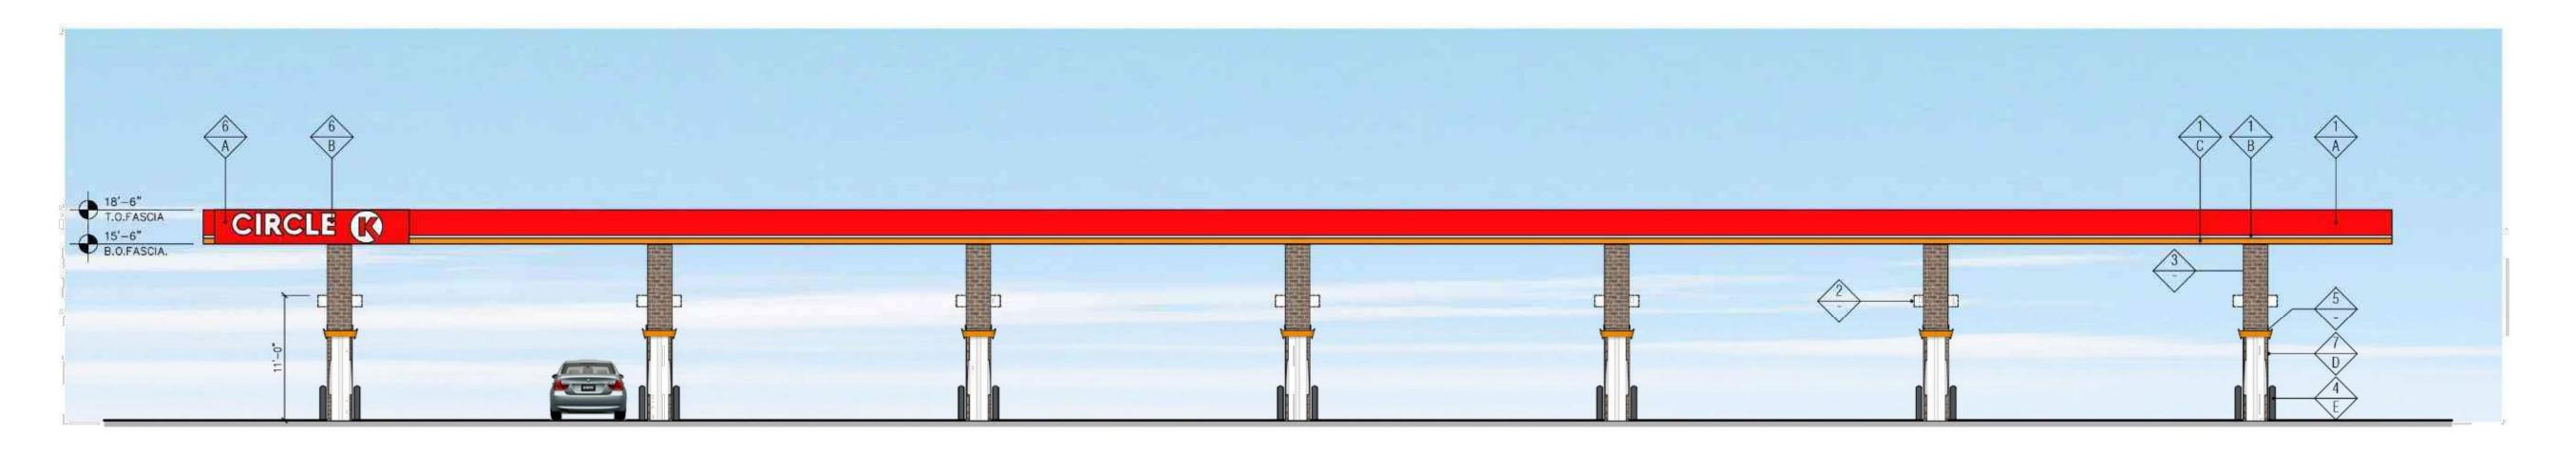

"FRONT" ELEVATION (EAST)

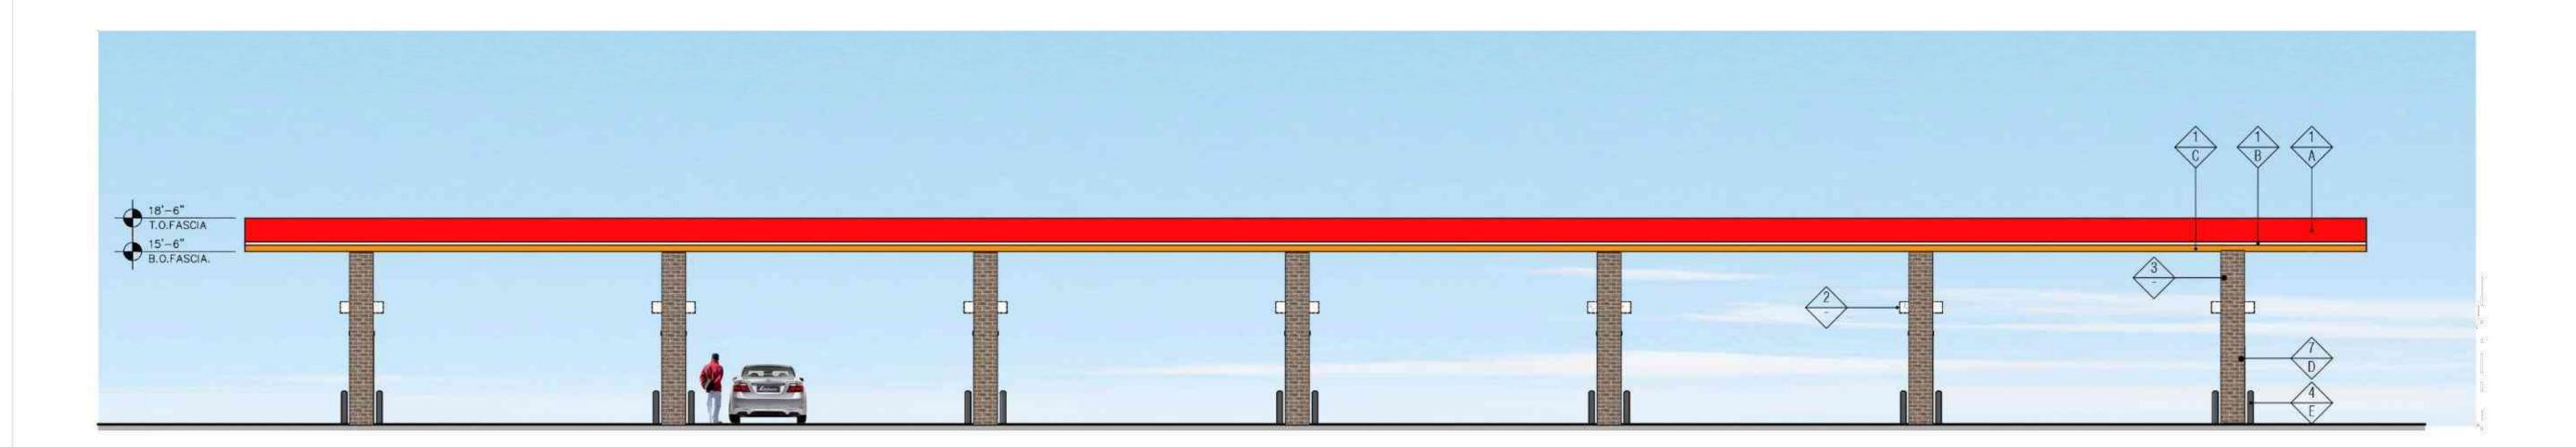



CLASS A COLUMN FINISH

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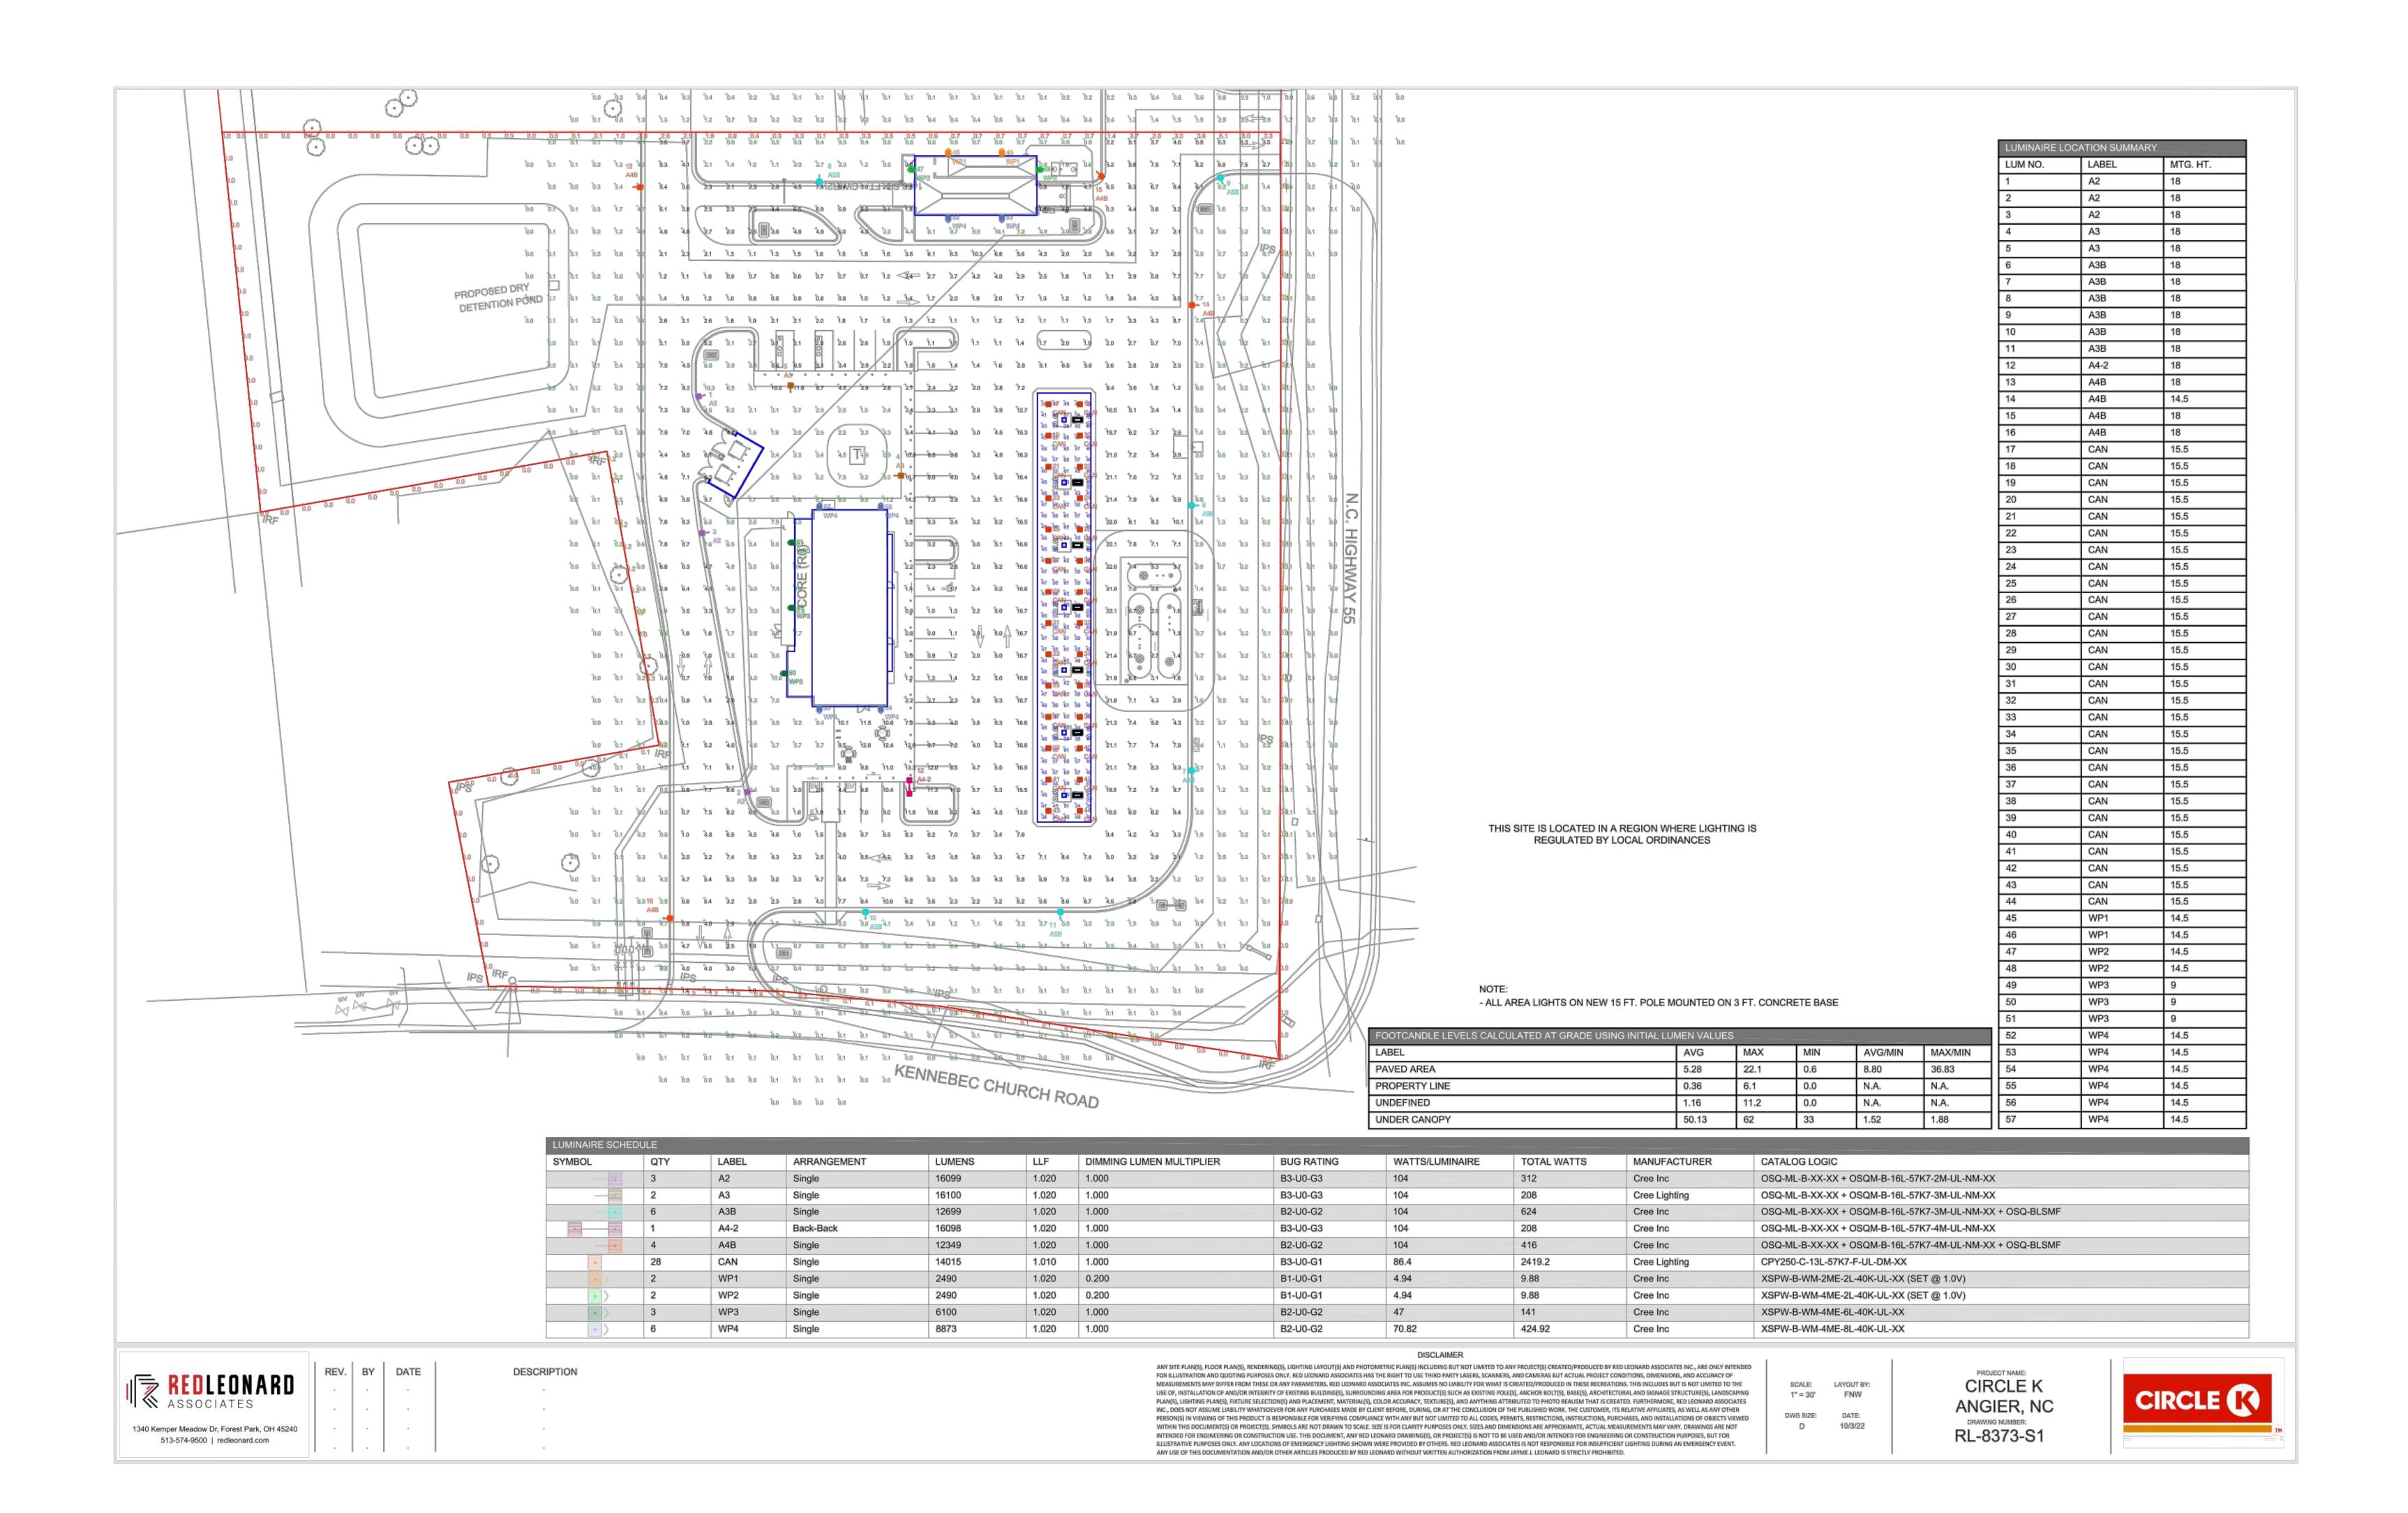



CIRCLE K STORE INC.

PROJECT NUMBER: 22130

FUEL CANOPY ELEVATIONS (VS07)

A2-2



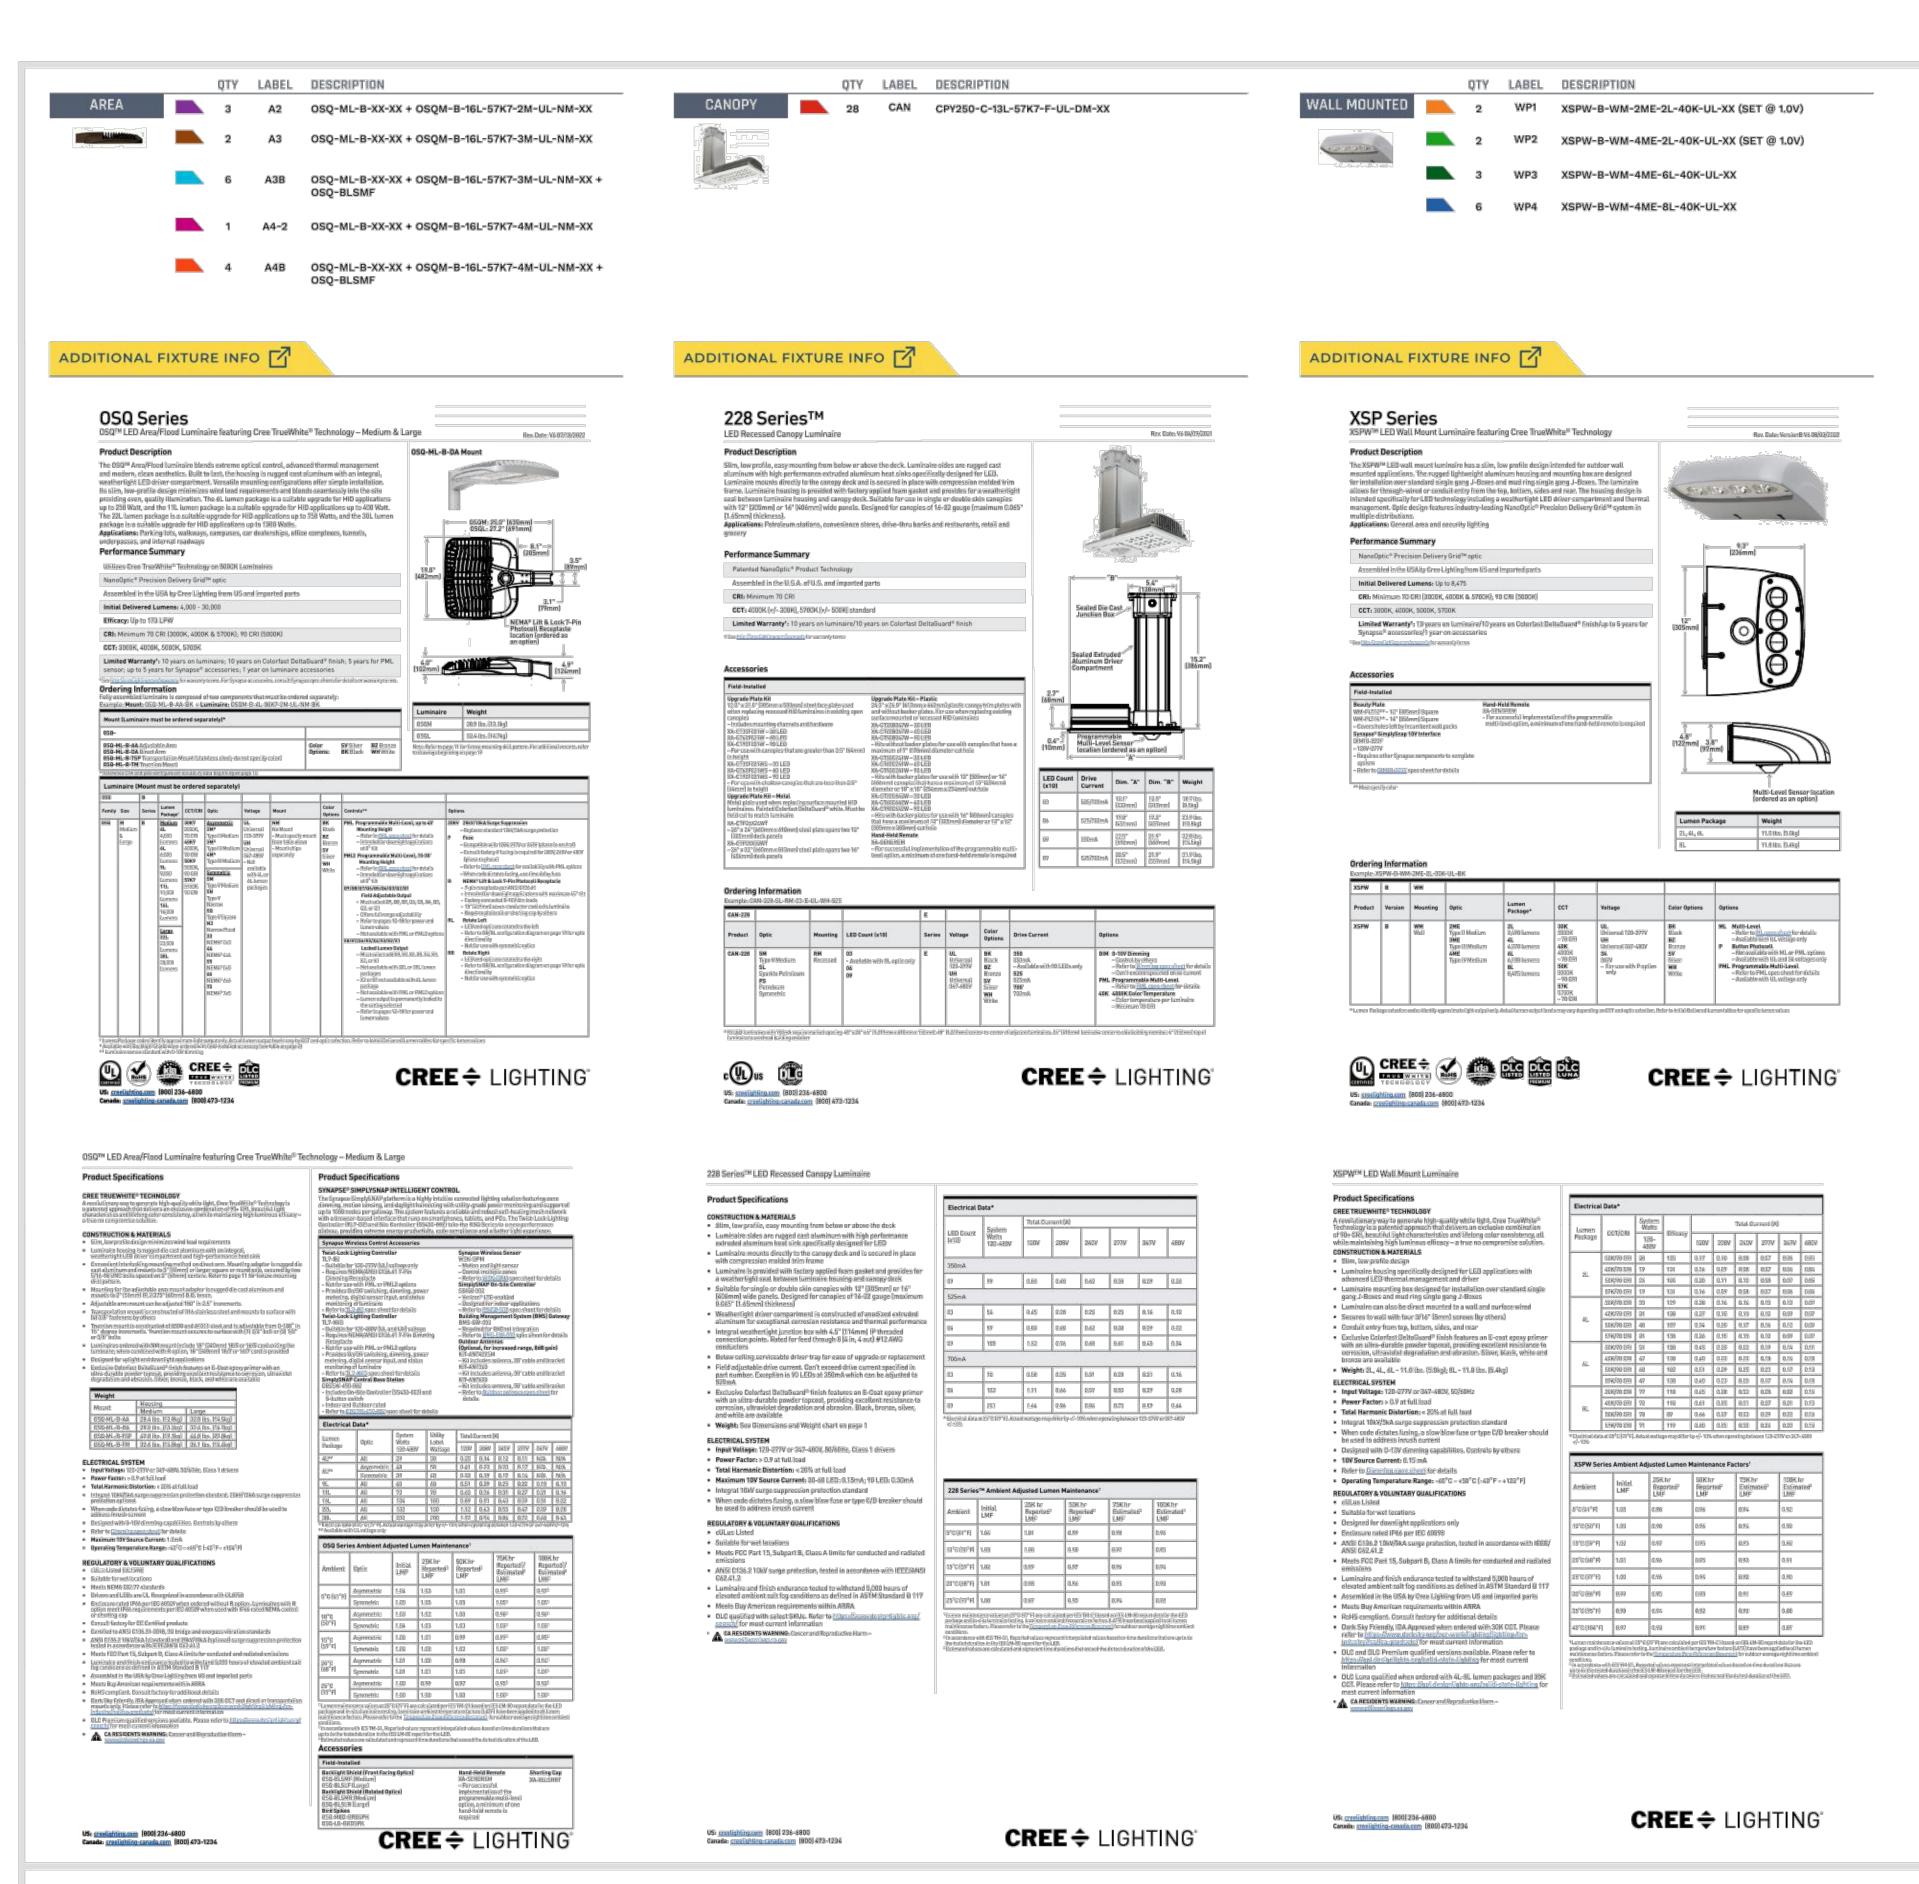




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PROJECT NAME: CIRCLE K ANGIER, NC DRAWING NUMBER: RL-8373-S1





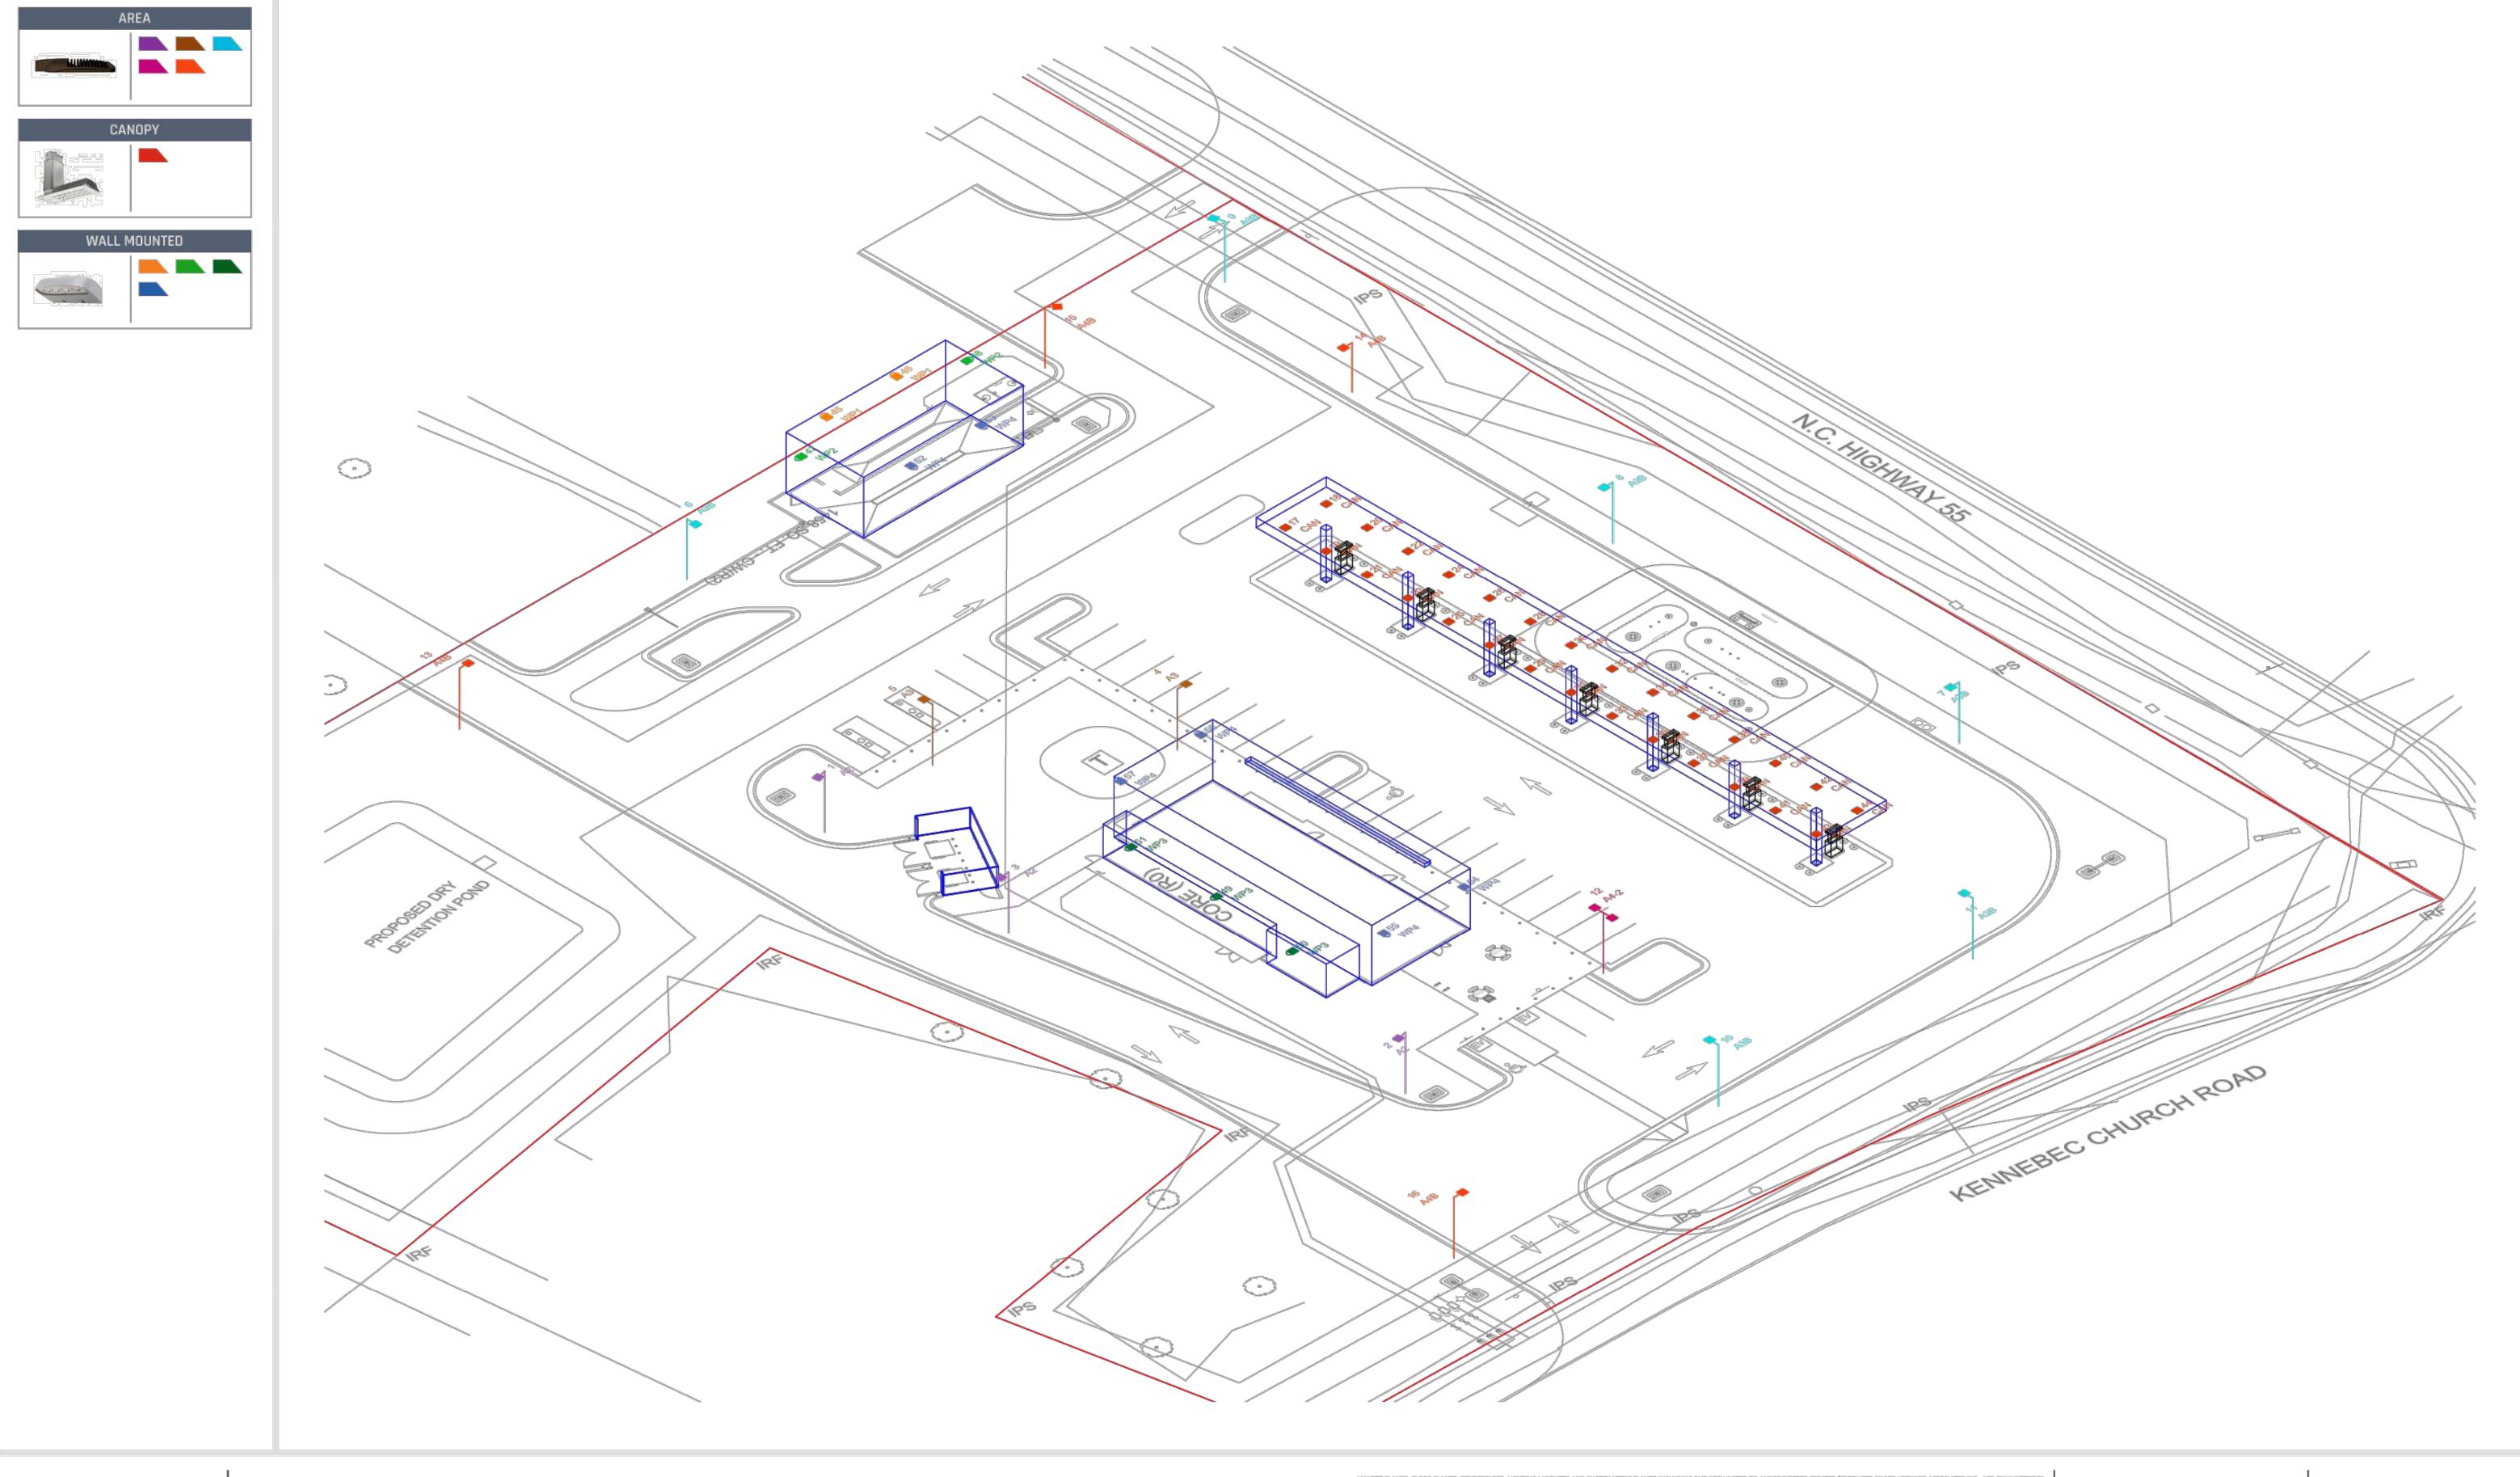

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PROJECT NAME:
CIRCLE K
ANGIER, NC
DRAWING NUMBER:
RL-8373-S1

