

FIRE ALARM SYSTEM INSTALLATION

HIGHWAY 55 FUQUAY-VARINA, NC

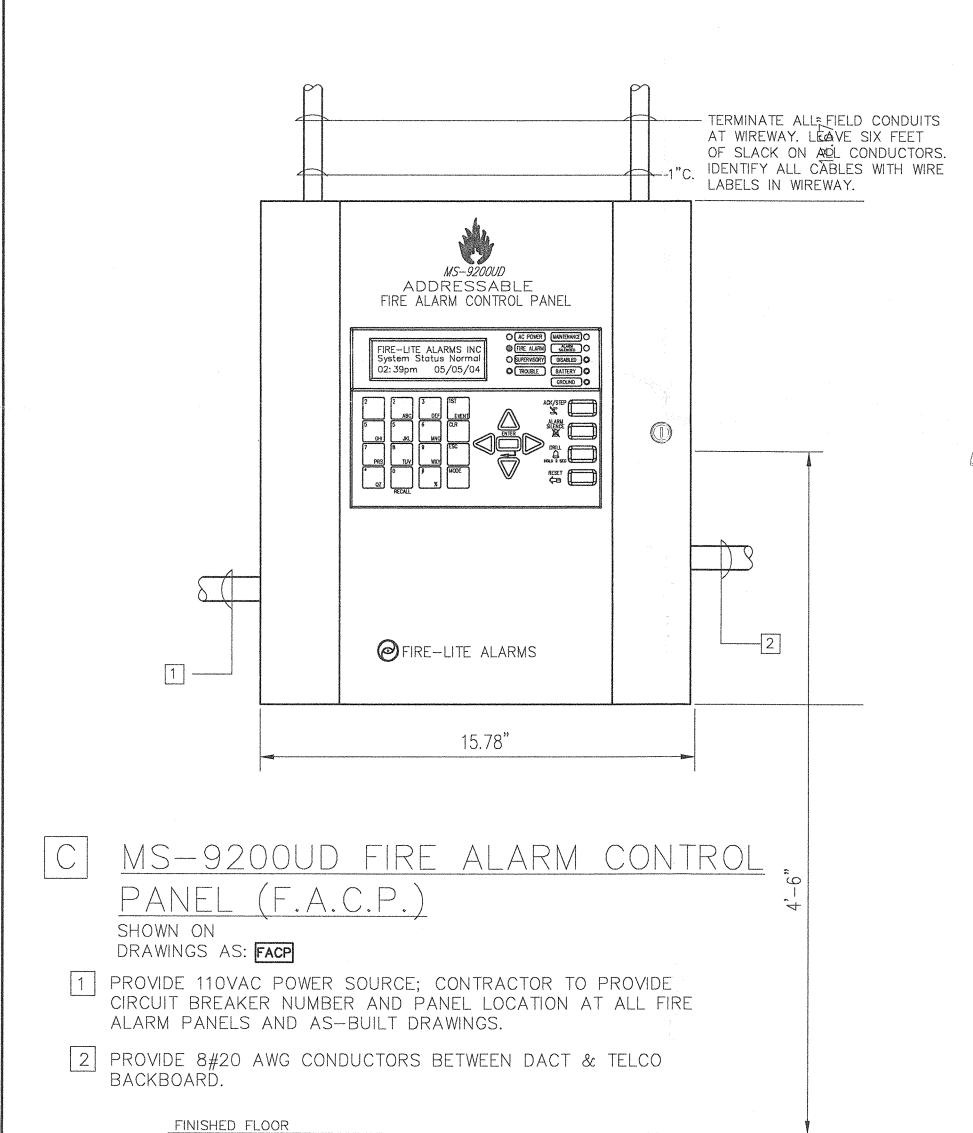

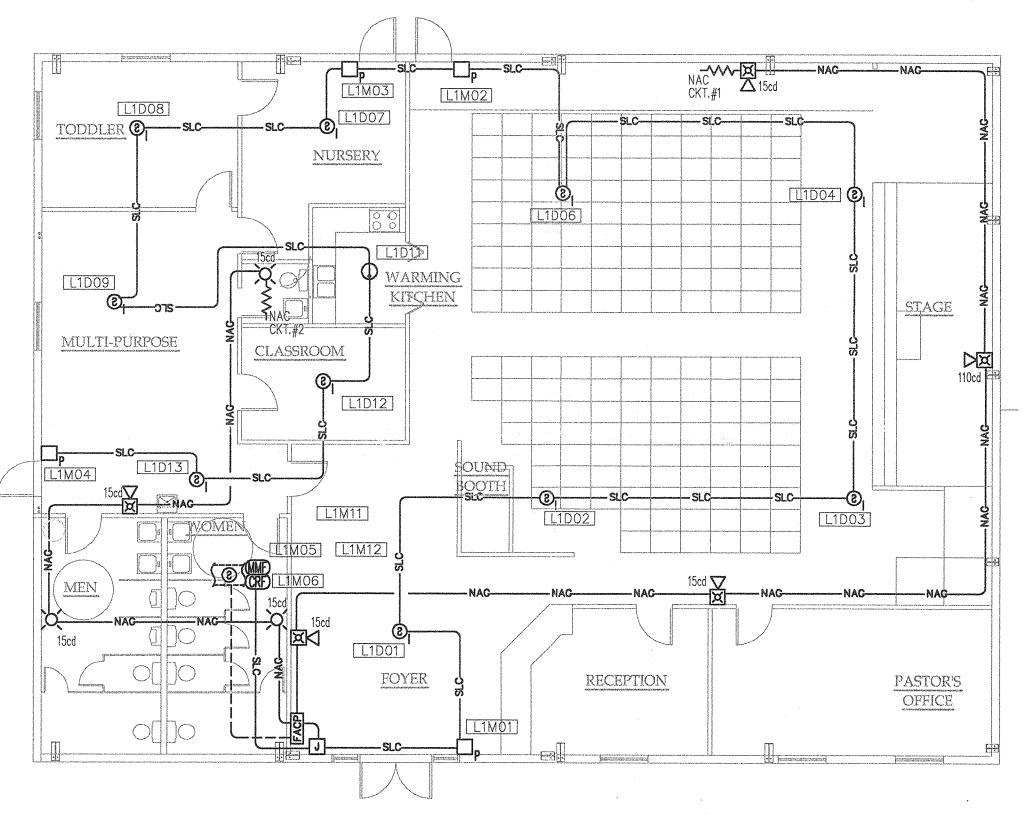

A FLOOR PLAN
SCALE: 1/8"=1'-0"

Prepared In Accordance with the Contract Documents

AS BUILTS 11/03/04

REV. # DESCRIPTION DATE

- REVISIONS --

- SCOPE OF WORK -

The intent of this project is to provide a fire alarm system for a new single level non sprinkleredchurch.

This new fire alarm system will consist of a fire alarm control panel (FACP), and a digital alarm communicator (DACT) that will be located in the foyer at the main entrance. In addition, we will be installing smoke detectors, heat detectors, manual stations, This Fire Alarm System will provide a general evacuation, utilizing strobe and horn—strobe appliances. The DACT provided with this fire alarm system will transmit "ALARM", "SUPERVISORY", and "TROUBLE" signals to an off—site monitoring station.

These shop drawings depict a proposed conduit and cable routing from which acceptable voltage loss and circuit capacities were obtained. The installer must verify the actual field conditions to assure the most efficient routing method is performed. The installer is responsible for recording all deviations for installation and return the "As—Installed" markups to Gregory Systems for preparation of the "As—Built" documents for submission to the owner upon project completion.

- FIRE ALARM DRAWING INDEX -

SHEET NO. SHEET DESCRIPTION

FA-1 COVER SHEET

FA-2 PANEL ELEVATION AND DEVICE DETAILS

- SYMBOL LEGEND -

FIRE ALARM
CONTROL PANEL

MANUAL PULL STATION

p Manual Pull Station

SMOKE DETECTOR

HEAT DETECTOR

END OF LINE RESISTOR

JUNCTION BOX

END OF LINE RESISTOR CHART

CKT. TYPE RESISTOR VALUE COLOR CODE

MS-9200UD PANEL A.7K YELLOW, VIOLET, RED

MMF-300 47K YELLOW, VIOLET, ORANGE
IDC CKT.

HORN STROBE COMBINATION

STROBE

cd DENOTES STROBE CANDELA
INTENSITY

DUCT SMOKE DETECTOR;
PROVIDED BY OTHERS

RELAY MODULE

ADDRESSABLE MONITOR MODULE

ADDRESSABLE CONTROL

L?M?? MODULE/DETECTOR ADDRESS ADDRESSABLE LOOP (SLC) #

- WIRING SYMBOLS -

- 2C#16 SHEILDED TWISTED FPLP

(SLC LOOP)

(NAC CKT.)

(919) 552-0670 FAX: (919) 552-0716 DESIGNED BY: DRAWN BY:

Gregory Systems

3540 Crain Highway #374

Bowie, MD 20716

1511 Farm Lake Drive Holly Springs, NC 27540

DESIGNED BY:
TODD GREGORY
REVAN DAVIS
CHECKED BY:

PROJECT TITLE:

FIRE ALARM SYSTEM INSTALLATION FOR JUBILEE CHURCH

HIGHWAY 55 FUQUAY-VARINA, NC

DATE: **08/24/04**

SHEET TITLE:

COVER SHEET

SHEET

FA-1