


# HARNETT COUNTY GOVERNMENT RESOURCE CENTER AND LIBRARY

307 W Cornelius Harnett Blvd, Lillington, NC

CONSTRUCTION DOCUMENTS - 06/28/19

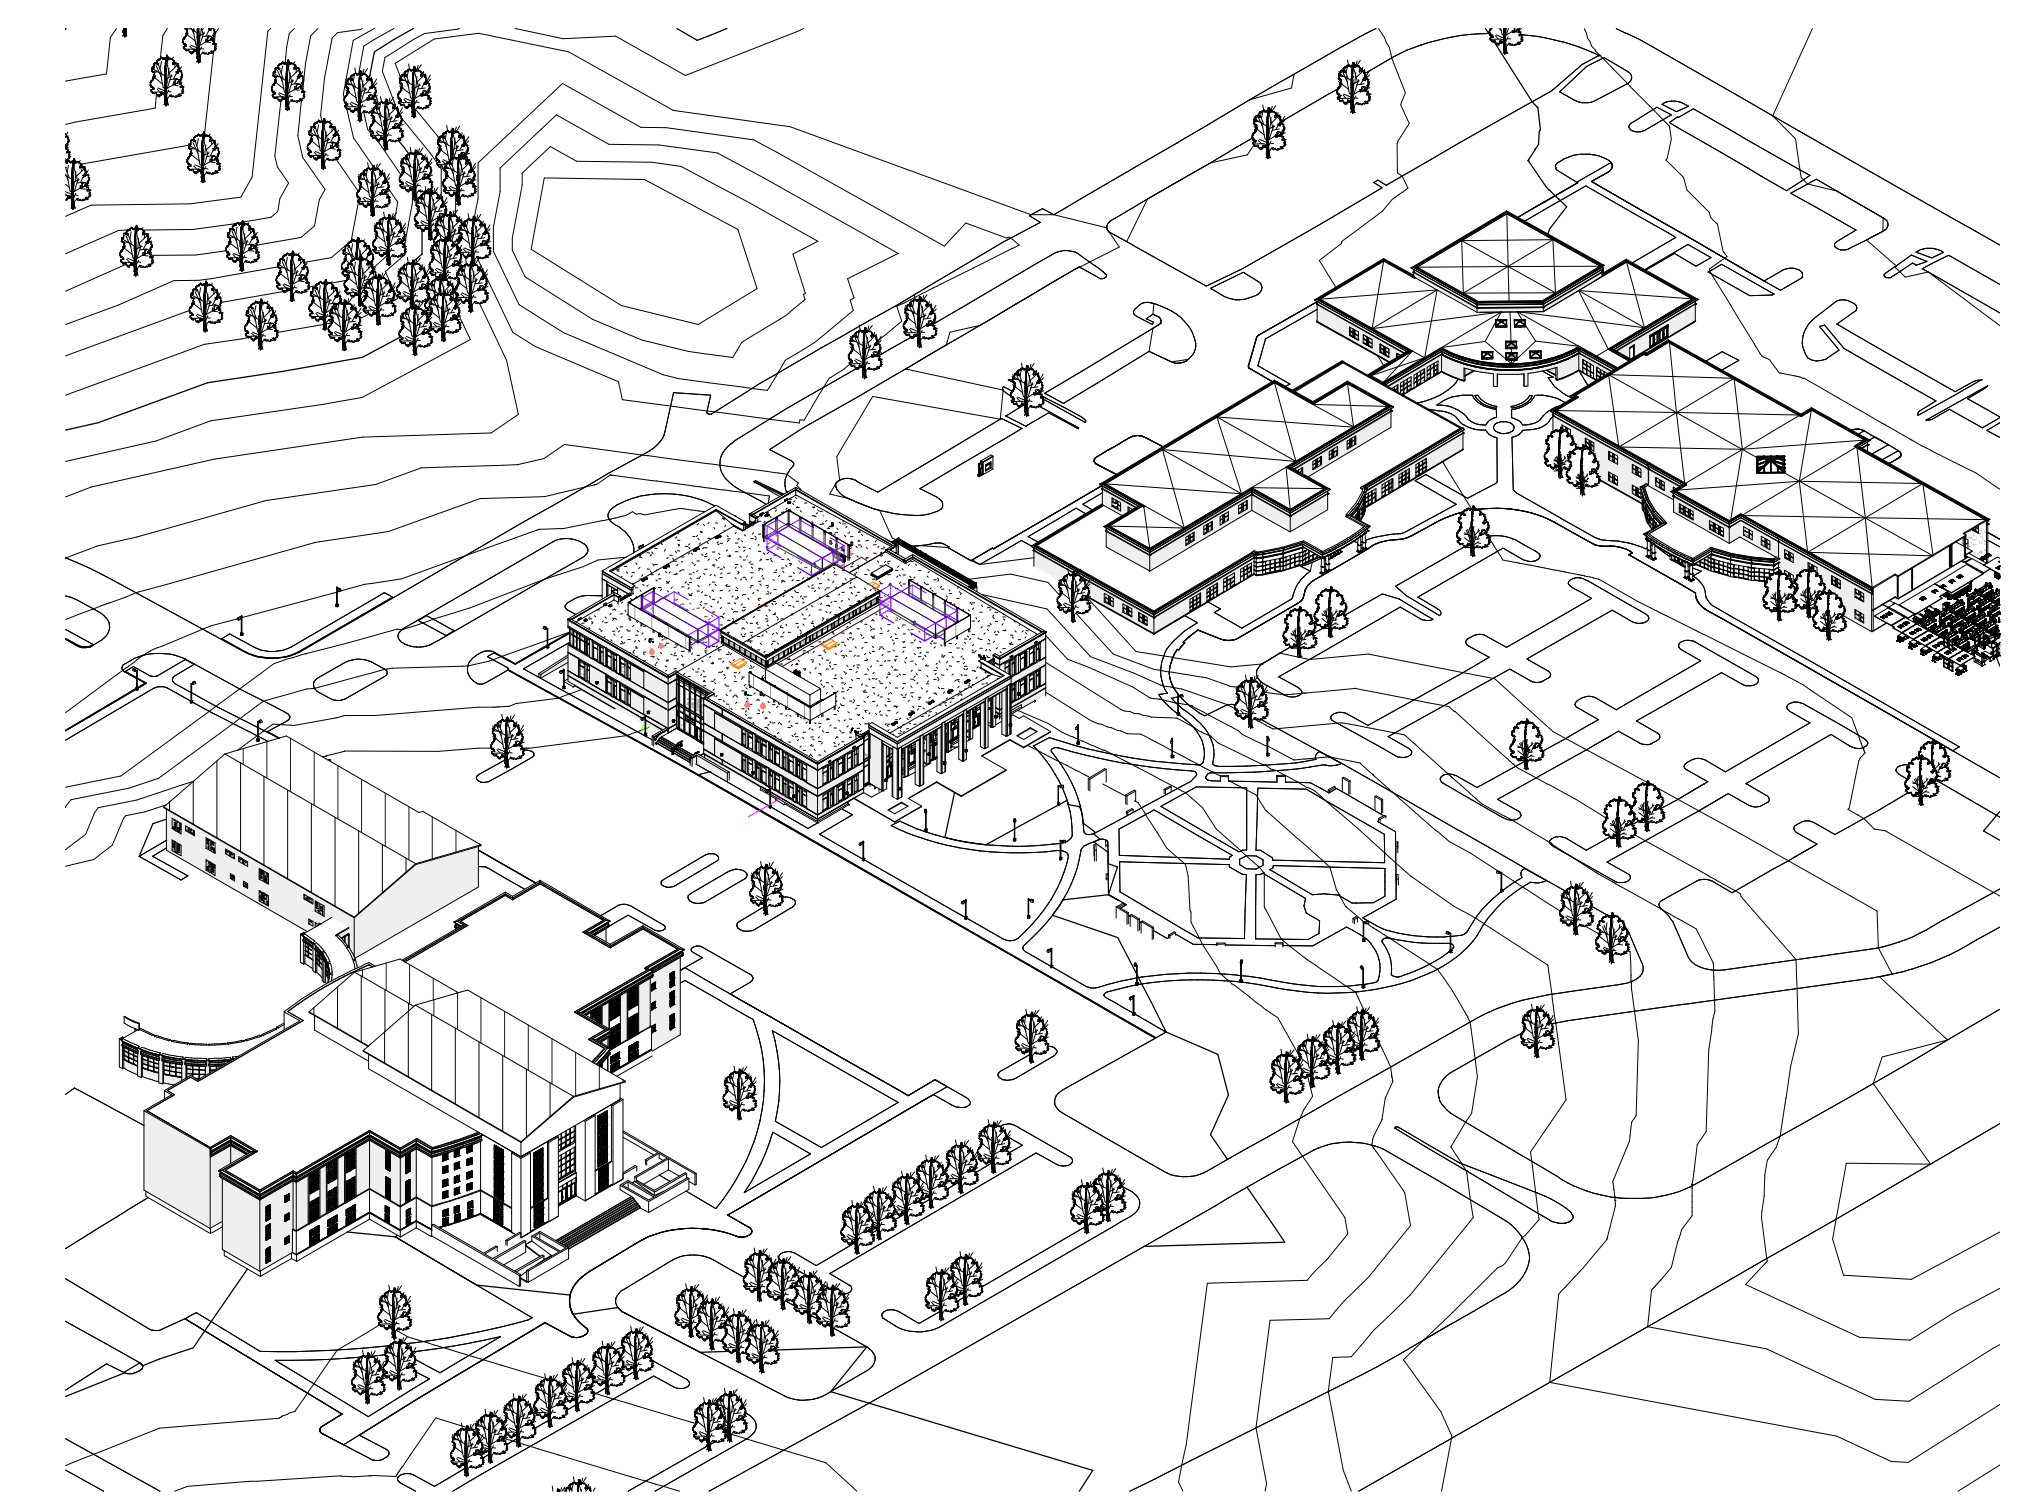

CAMPUS AERIAL



VICINITY PLAN  
1" = 400'-0"

LITTLE  
DIVERSIFIED ARCHITECTURAL CONSULTING

410 Blackwell Street, Suite 10  
Durham, NC 27701  
Tel: 919-474-2500

www.littleonline.com

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ISSUE FOR  
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06.28.2019

REVISIONS

NO.	REASON	DATE

PROJECT TEAM  
PRINCIPAL IN CHARGE  
JULIE MCLAURIN, AIA  
PROJECT MANAGER  
ERIC SCHOENAGEL, AIA  
DESIGN TEAM  
LITTLE  
PROGRAM NAME

HARNETT COUNTY  
GOVERNMENT RESOURCE  
CENTER AND LIBRARY

PROJECT NO.  
514-8066-00

SHEET TITLE  
COVER SHEET

SHEET NUMBER  
CS

**OWNER**

Harnett County  
307 West Cornelius  
Harnett Blvd  
Lillington, NC  
910-893-7555  
STEVE WARD

**ARCHITECT**

LITTLE  
410 Blackwell Street  
Durham, NC 27701  
919-474-2500  
ERIC SCHOENAGEL,  
AIA

**CIVIL**

Dewberry  
2610 Wycliff Road  
Raleigh, NC 27607  
919-424-3730  
MATT WEST, PE

**LANDSCAPE**

Dewberry  
2610 Wycliff Road  
Raleigh, NC 27607  
984-833-4833  
BENTLEY RUGGLES,  
RLA

**STRUCTURAL**

LITTLE  
410 Blackwell Street  
Durham, NC 27701  
919-474-2500  
SARAH MUSSER, PE

**PLUMBING**

Dewberry  
2610 Wycliff Road  
Raleigh, NC 27607  
919-424-3728  
EMMETT WILLIS, PE

**MECHANICAL**

Dewberry  
2610 Wycliff Road  
Raleigh, NC 27607  
984-232-6803  
JOHN TEETER, PE

**ELECTRICAL**

Dewberry  
2610 Wycliff Road  
Raleigh, NC 27607  
919-424-3724  
WILLIAM KEMP, PE

Reviewed For Code Compliance By:  
**D. Banks Wallace**  
Chief Deputy Fire Marshal  
09/04/2019 8:57:18 AM







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PROJECT TEAM
PRINCIPAL IN CHARGE <b>JULIE MCLAURIN, AIA</b>
PROJECT MANAGER <b>ERIC SCHOENAGEL, AIA</b>
DESIGN TEAM
<b>LITTLE</b>
PROGRAM
<b>HARNETT COUNTY GOVERNMENT RESOURCE CENTER AND LIBRARY</b>

PROJECT NO.  
**514-8066-00**



SHEET TITLE  
**FIRE RESISTANCE DESIGNS**

SHEET NUMBER  
**G010**

**UL U419**

Design No. U419  
September 28, 2018

Nonbearing Wall Ratings — 1, 2, 3 or 4 Hr (See Items 4 & 5 through 5K)  
\* Indicates such products shall bear the UL or cUL Certification Mark for jurisdictions employing the UL or cUL Certification (such as Canada), respectively.

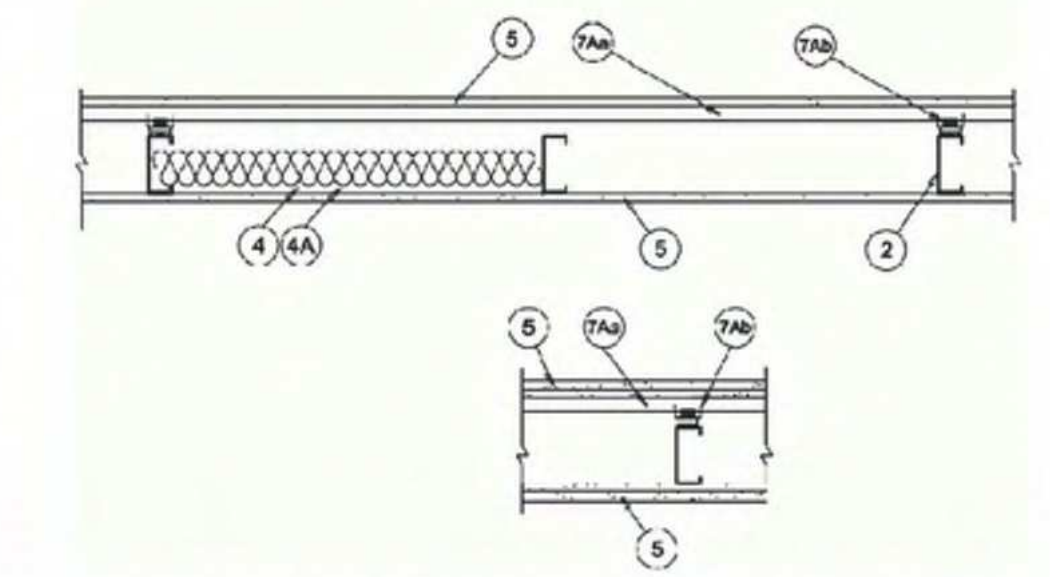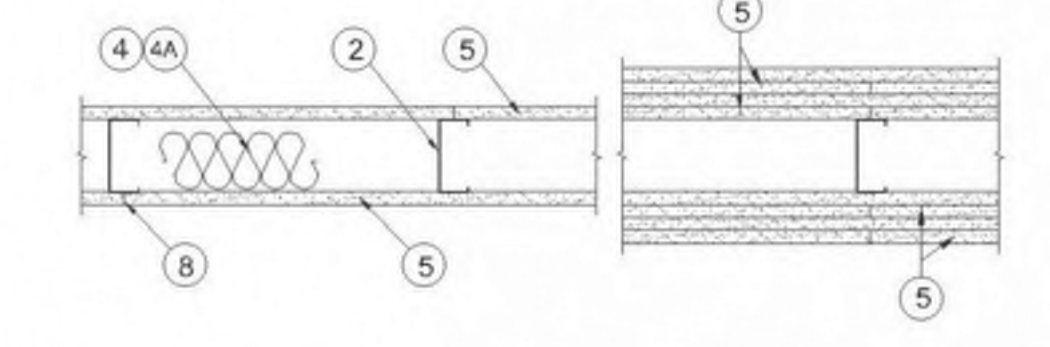

1. Floor and Ceiling Runners — (Not Shown) — For use with Item 2 — Channel shaped, fabricated from min 25 MSG corrosion-protected steel, min depth to accommodate stud size, with min 1-1/4 in. long legs, attached to floor and ceiling with fasteners 24 in. OC max.  
1A. Framing Members — Floor and Ceiling Runner — (Not Shown) — In lieu of Item 1 — For use with Item 2B, proprietary channel shaped runners, 3-5/8 in. deep attached to floor and ceiling with fasteners 24 in. OC max. CALIFORNIA EXPANDED METAL PRODUCTS CO — Viper25™ Track

CRACO MFG INC — SmartTrack25™  
MARINOWARE, DIV OF WARE INDUSTRIES INC — Viper25™ Track  
FUSION BUILDING PRODUCTS — Viper25™ Track  
IMPERIAL MANUFACTURING GROUP INC — Viper25™ Track

1B. Framing Members — Floor and Ceiling Runner — (Not Shown) — In lieu of Item 1 — For use with Item 2C, proprietary channel shaped runners, 1-1/4 in. wide by 3-5/8 in. deep fabricated from min D 0.18 in. thick galv steel, attached to floor and ceiling with fasteners spaced 24 in. OC max. CALIFORNIA EXPANDED METAL PRODUCTS CO — Viper20™ Track

MARINOWARE, DIV OF WARE INDUSTRIES INC — Viper20™ Track  
FUSION BUILDING PRODUCTS — Viper20™ Track  
IMPERIAL MANUFACTURING GROUP INC — Viper20™ Track

1C. Framing Members — Floor and Ceiling Runners — (Not Shown) — In lieu of Item 1 — Channel shaped, attached to floor and ceiling with fasteners 24 in. OC max. ALLSTEEL & GYPSUM PRODUCTS INC — Type SUPREME D24/30EQD and Type SUPREME D20

CONSOLIDATED FABRICATORS CORP. BUILDING PRODUCTS DIV — Type SUPREME D24/30EQD and Type SUPREME D20

QUAIL RUN BUILDING MATERIALS INC — Type SUPREME D24/30EQD and Type SUPREME D20

SCAFCO STEEL STUD MANUFACTURING CO — Type SUPREME D24/30EQD and Type SUPREME D20

STEEL CONSTRUCTION SYSTEMS INC — Type SUPREME D24/30EQD and Type SUPREME D20

UNITED METAL PRODUCTS INC — Type SUPREME D24/30EQD and Type SUPREME D20

1D. Floor and Ceiling Runners — (Not Shown) — For use with Item 2A — Channel shaped, fabricated from min 20 MSG corrosion-protected or galv steel, min depth to accommodate stud size, with min 1 in. long legs, attached to floor and ceiling with fasteners spaced max 24 in. OC.











1E. Framing Members — Floor and Ceiling Runners — (Not Shown, As an alternate to Item 1) — For use with Items 2E, 5F or 5G or 5I only, channel shaped, fabricated from min. D.015 in. (min bare metal thickness) galvanized steel, attached to floor and ceiling with fasteners 24 in. OC max. CLARKDIETRICH BUILDING SYSTEMS — CD ProTRAK

DMFCWBS L L C — ProTRAK

**UL U415**

Design No. U415  
September 27, 2018

Nonbearing Wall Ratings — 1, 2, 3 or 4 Hr  
\* Indicates such products shall bear the UL or cUL Certification Mark for jurisdictions employing the UL or cUL Certification (such as Canada), respectively.

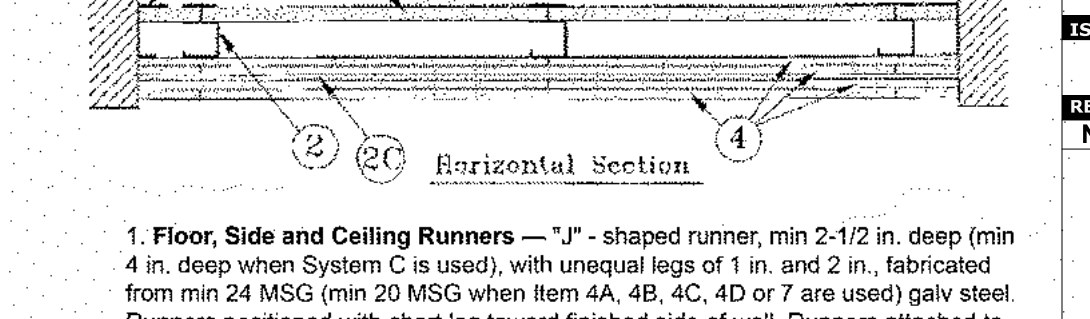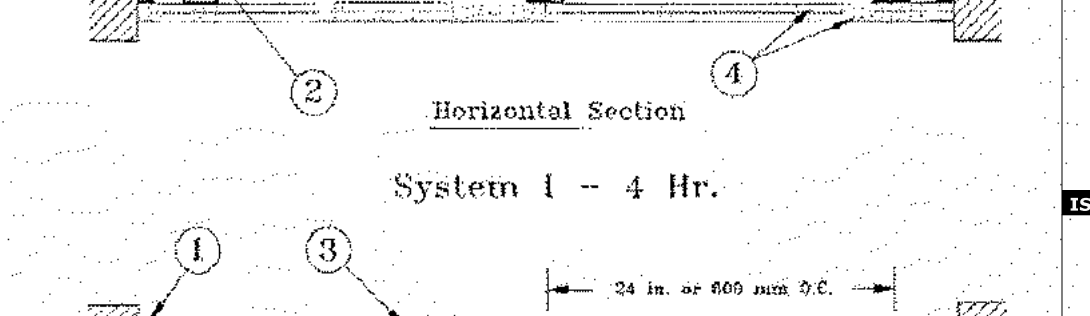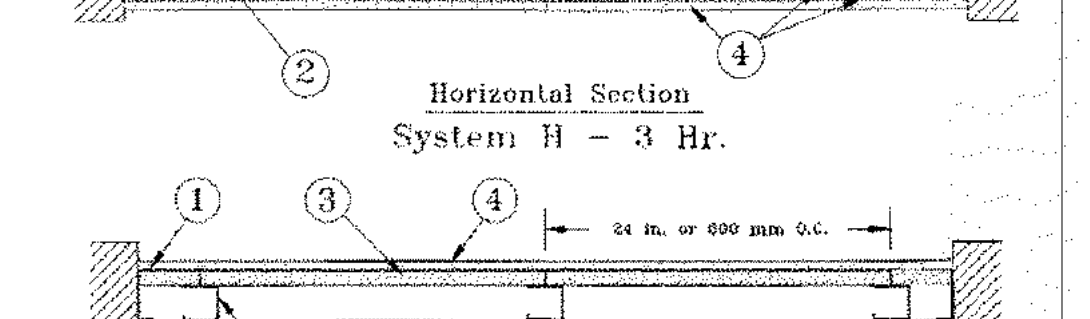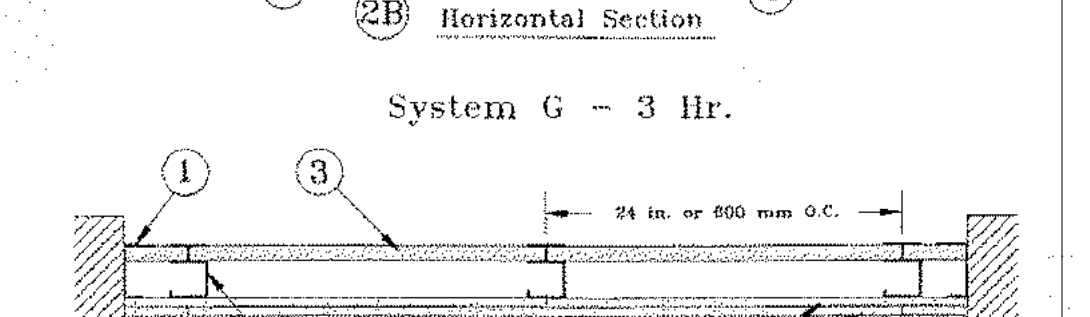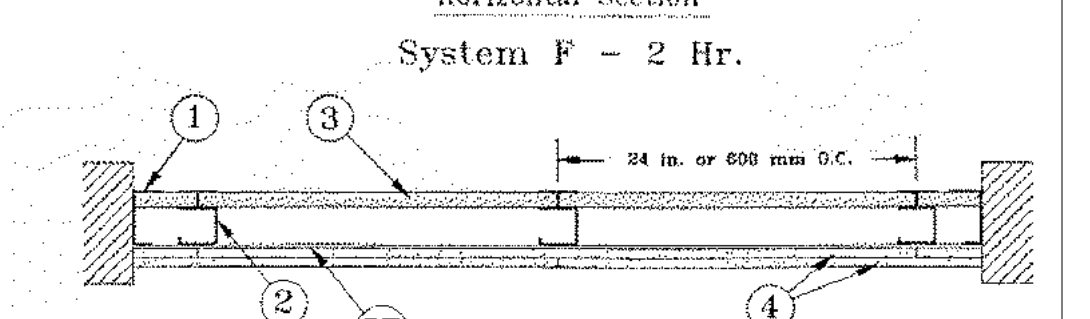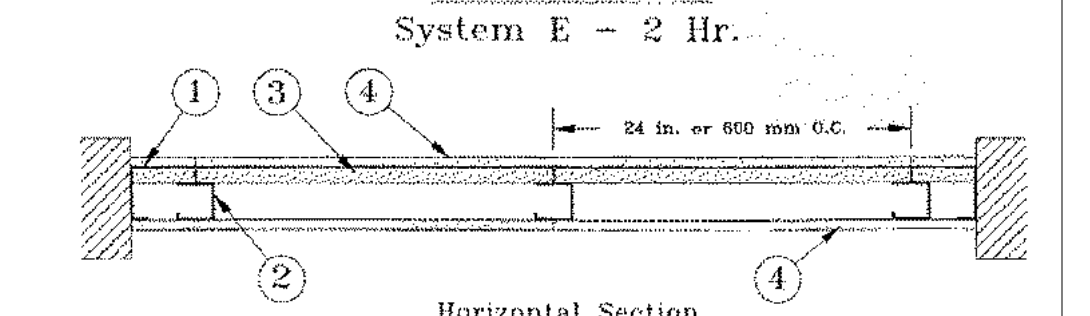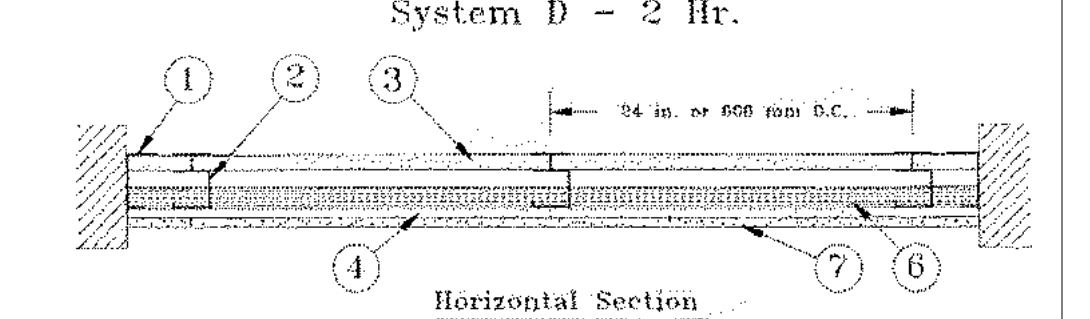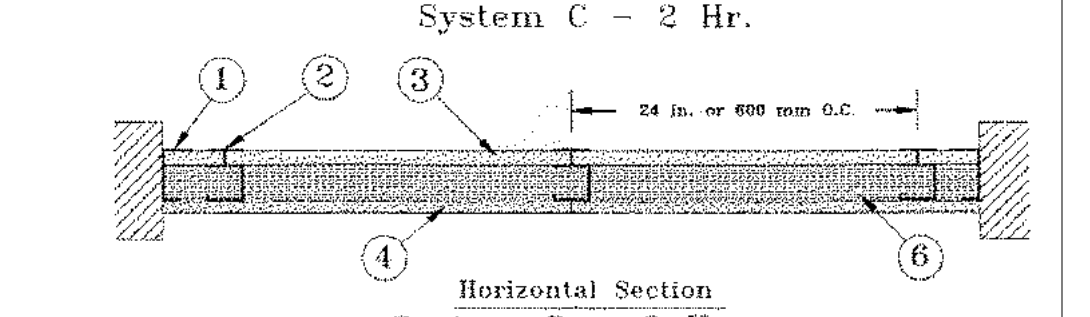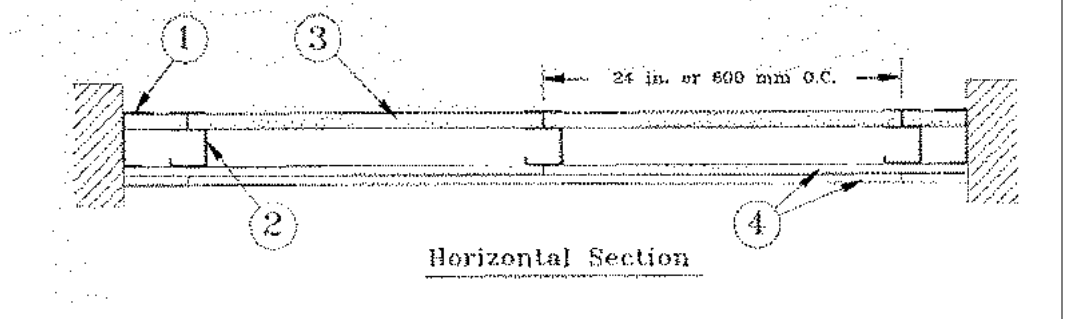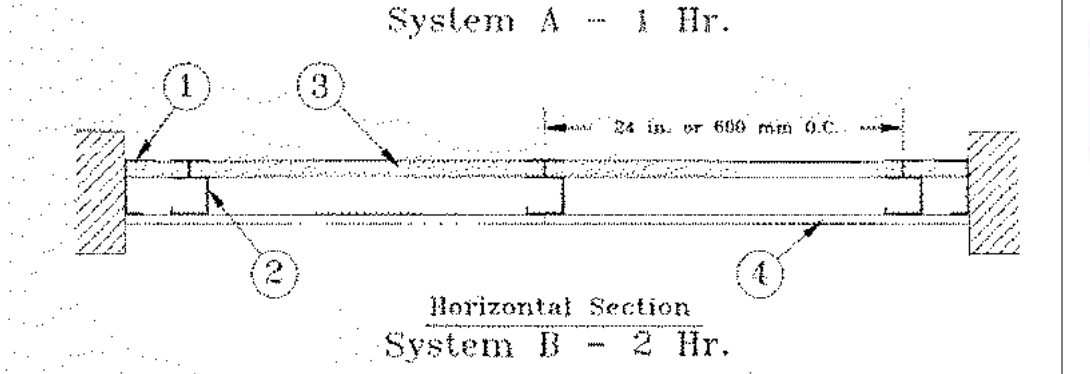


1. Floor, Side and Ceiling Runners — "J" - shaped runner, min 2-1/2 in. deep (min 4 in. deep when System C is used), with unequal legs of 1 in. and 2 in., fabricated from min 24 MSG (min 20 MSG when Items 4A, 4B, 4C, 4D or 7 are used) galv steel. Runners positioned with short leg toward finished side of wall. Runners attached to structural supports with steel fasteners located not greater than 2 in. from ends and not greater than 24 in. OC. "E" - shaped studs (Item 2A) may be used as side runners in place of "J" - shaped runners.

2. Steel Studs — "C"-H" - shaped studs, min 2-1/2 in. deep (min 4 in. deep when System C is used), fabricated from min 25 MSG (min 20 MSG when Items 2D, 4A, 4B, 4C, 4D or 7 is used) galv steel. Cut to lengths 3/8 to 1/2 in. less than floor-to-ceiling height and spaced 24 in. or 600 mm OC (max 16 in. OC when Items 4A, 4B, 4C, or 4D are used).

F  
E  
D  
C  
B  
A

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ISSUE FOR  
**CONSTRUCTION DOCUMENTS**

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REVISIONS

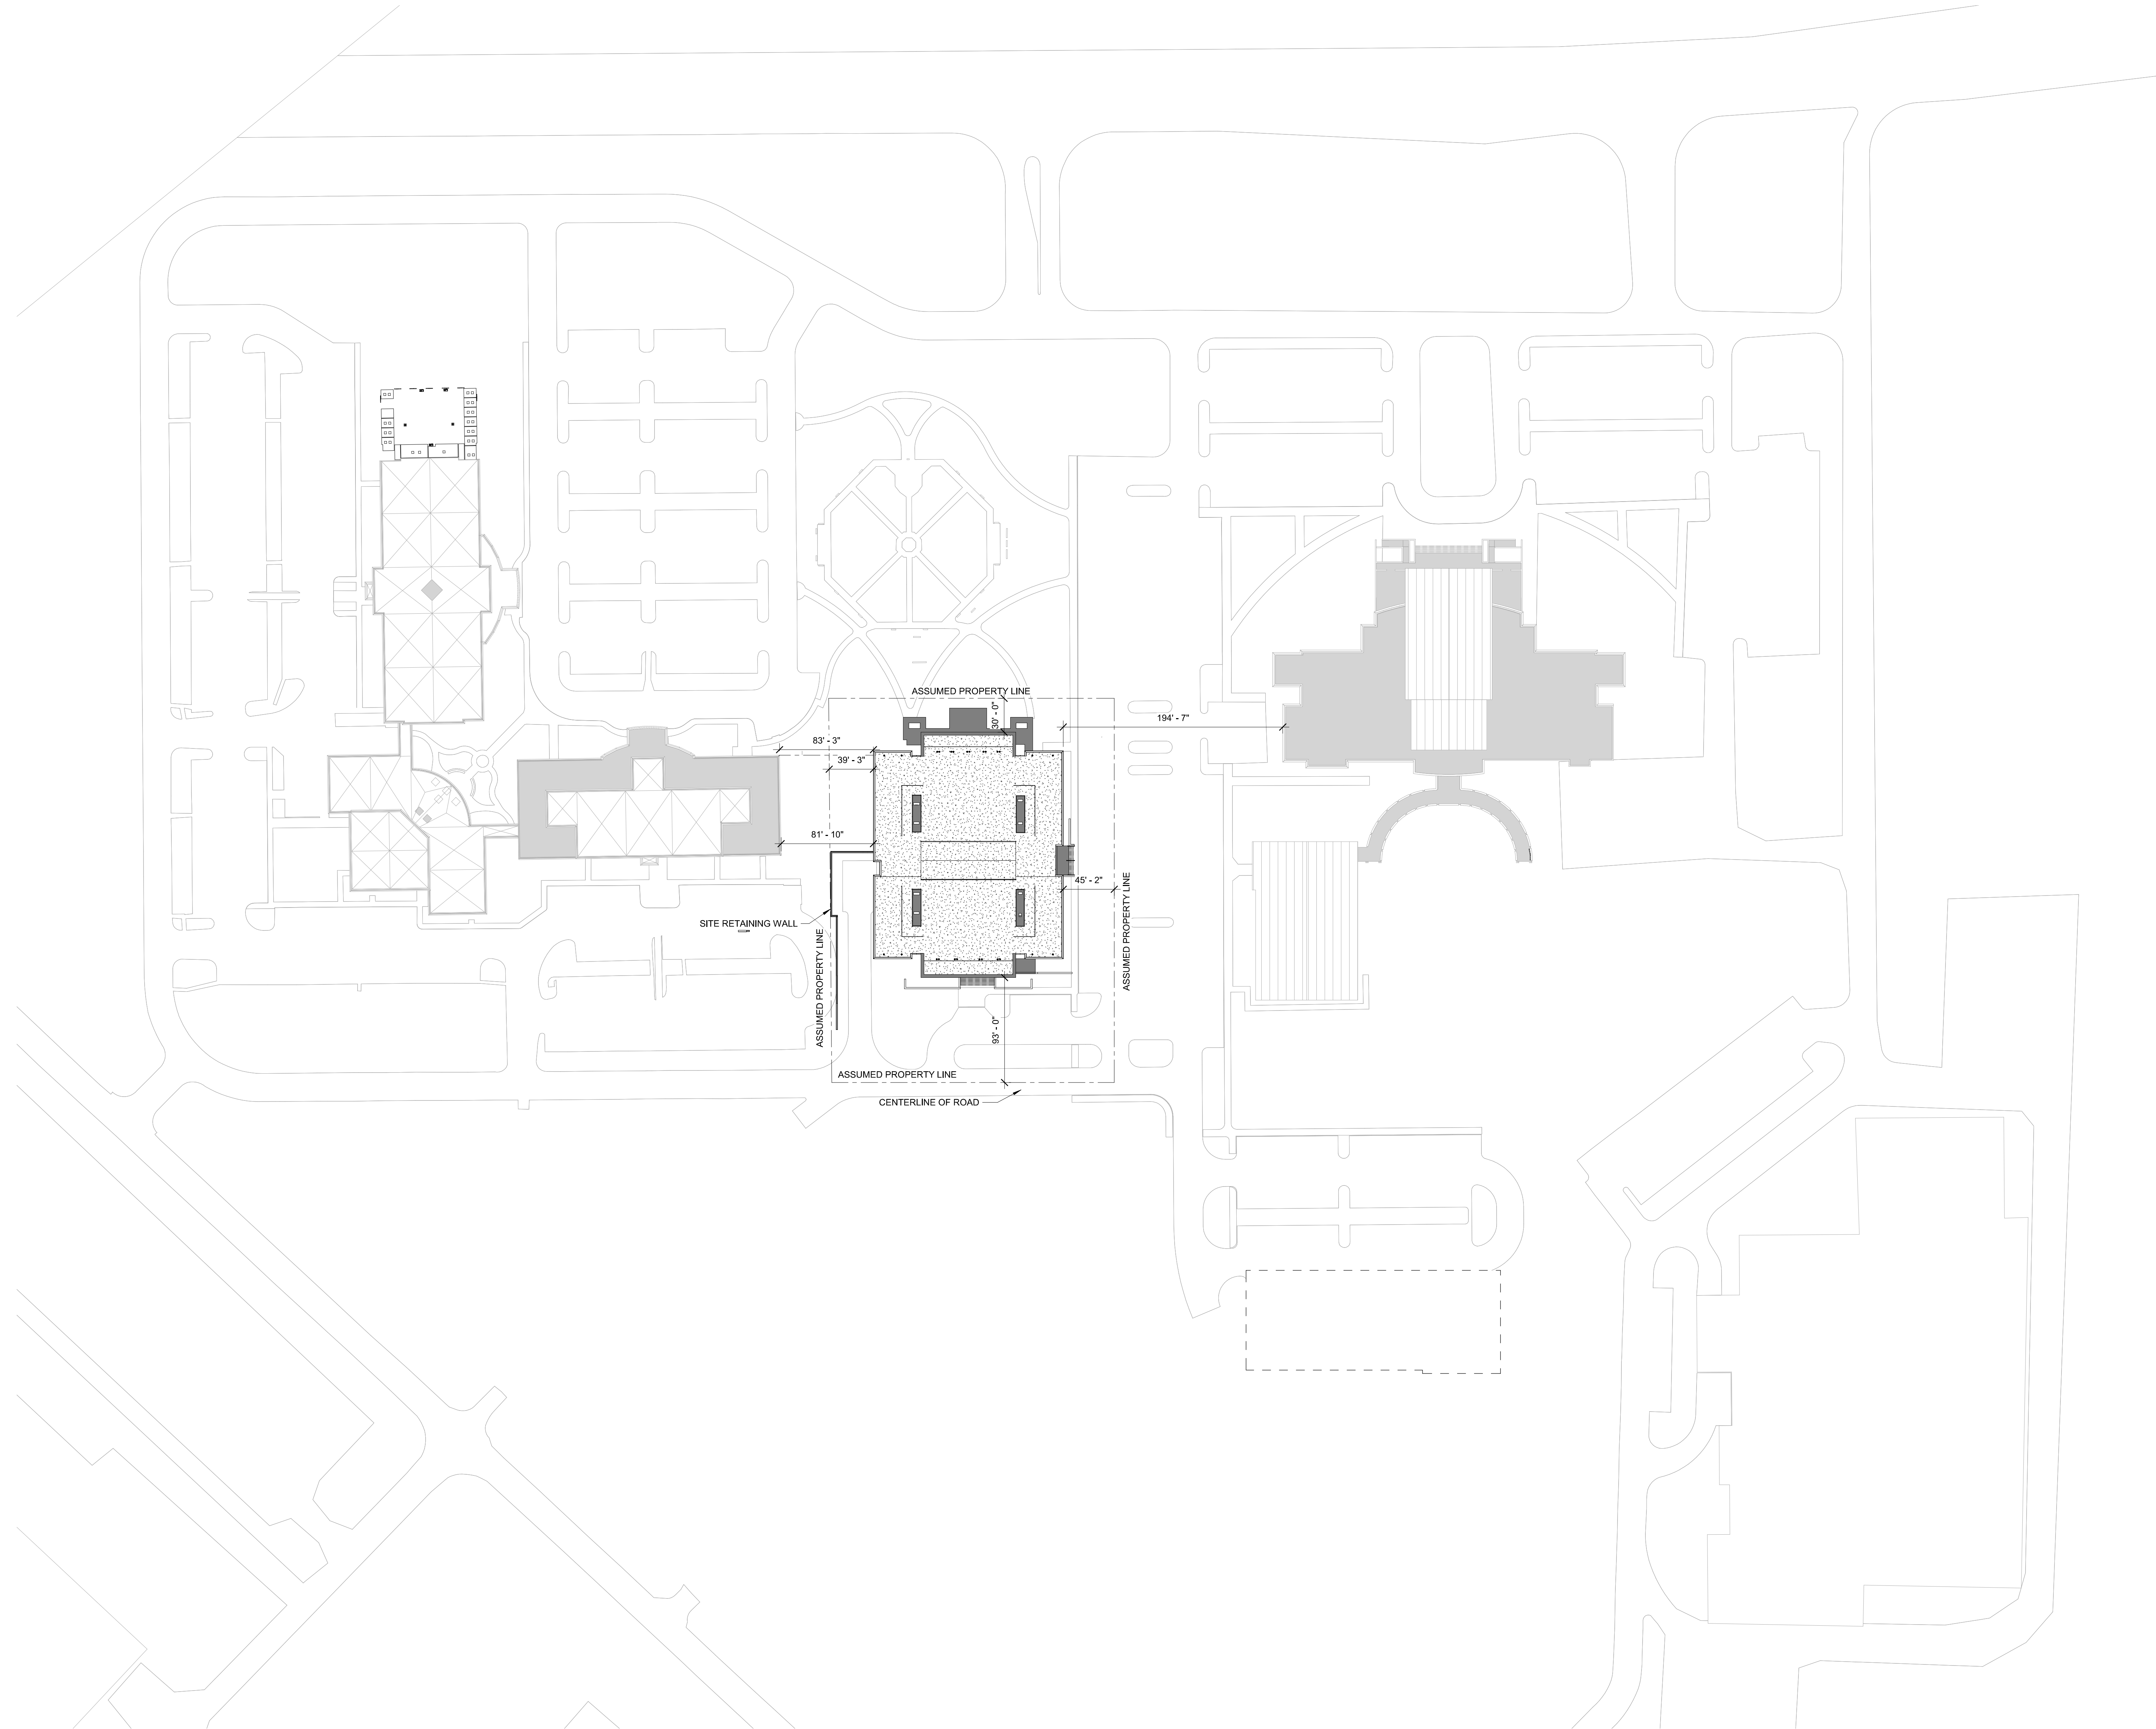NO.	REASON	DATE

PROJECT TEAM  
PRINCIPAL IN CHARGE  
**JULIE MCLAURIN, AIA**  
PROJECT MANAGER  
**ERIC SCHOENAGEL, AIA**  
DESIGN TEAM  
**LITTLE**  
PROGRAM NAME

**HARNETT COUNTY  
GOVERNMENT RESOURCE  
CENTER AND LIBRARY**


PROJECT NO.  
**514-8066-00**

SHEET TITLE  
**ARCHITECTURAL SITE  
PLAN**

SHEET NUMBER  
**G100**


1 ARCHITECTURAL SITE PLAN - LIFE SAFETY  
G100 1" = 60'-0"

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**LIFE SAFETY - AREA SCHEDULE - LEVEL 01**

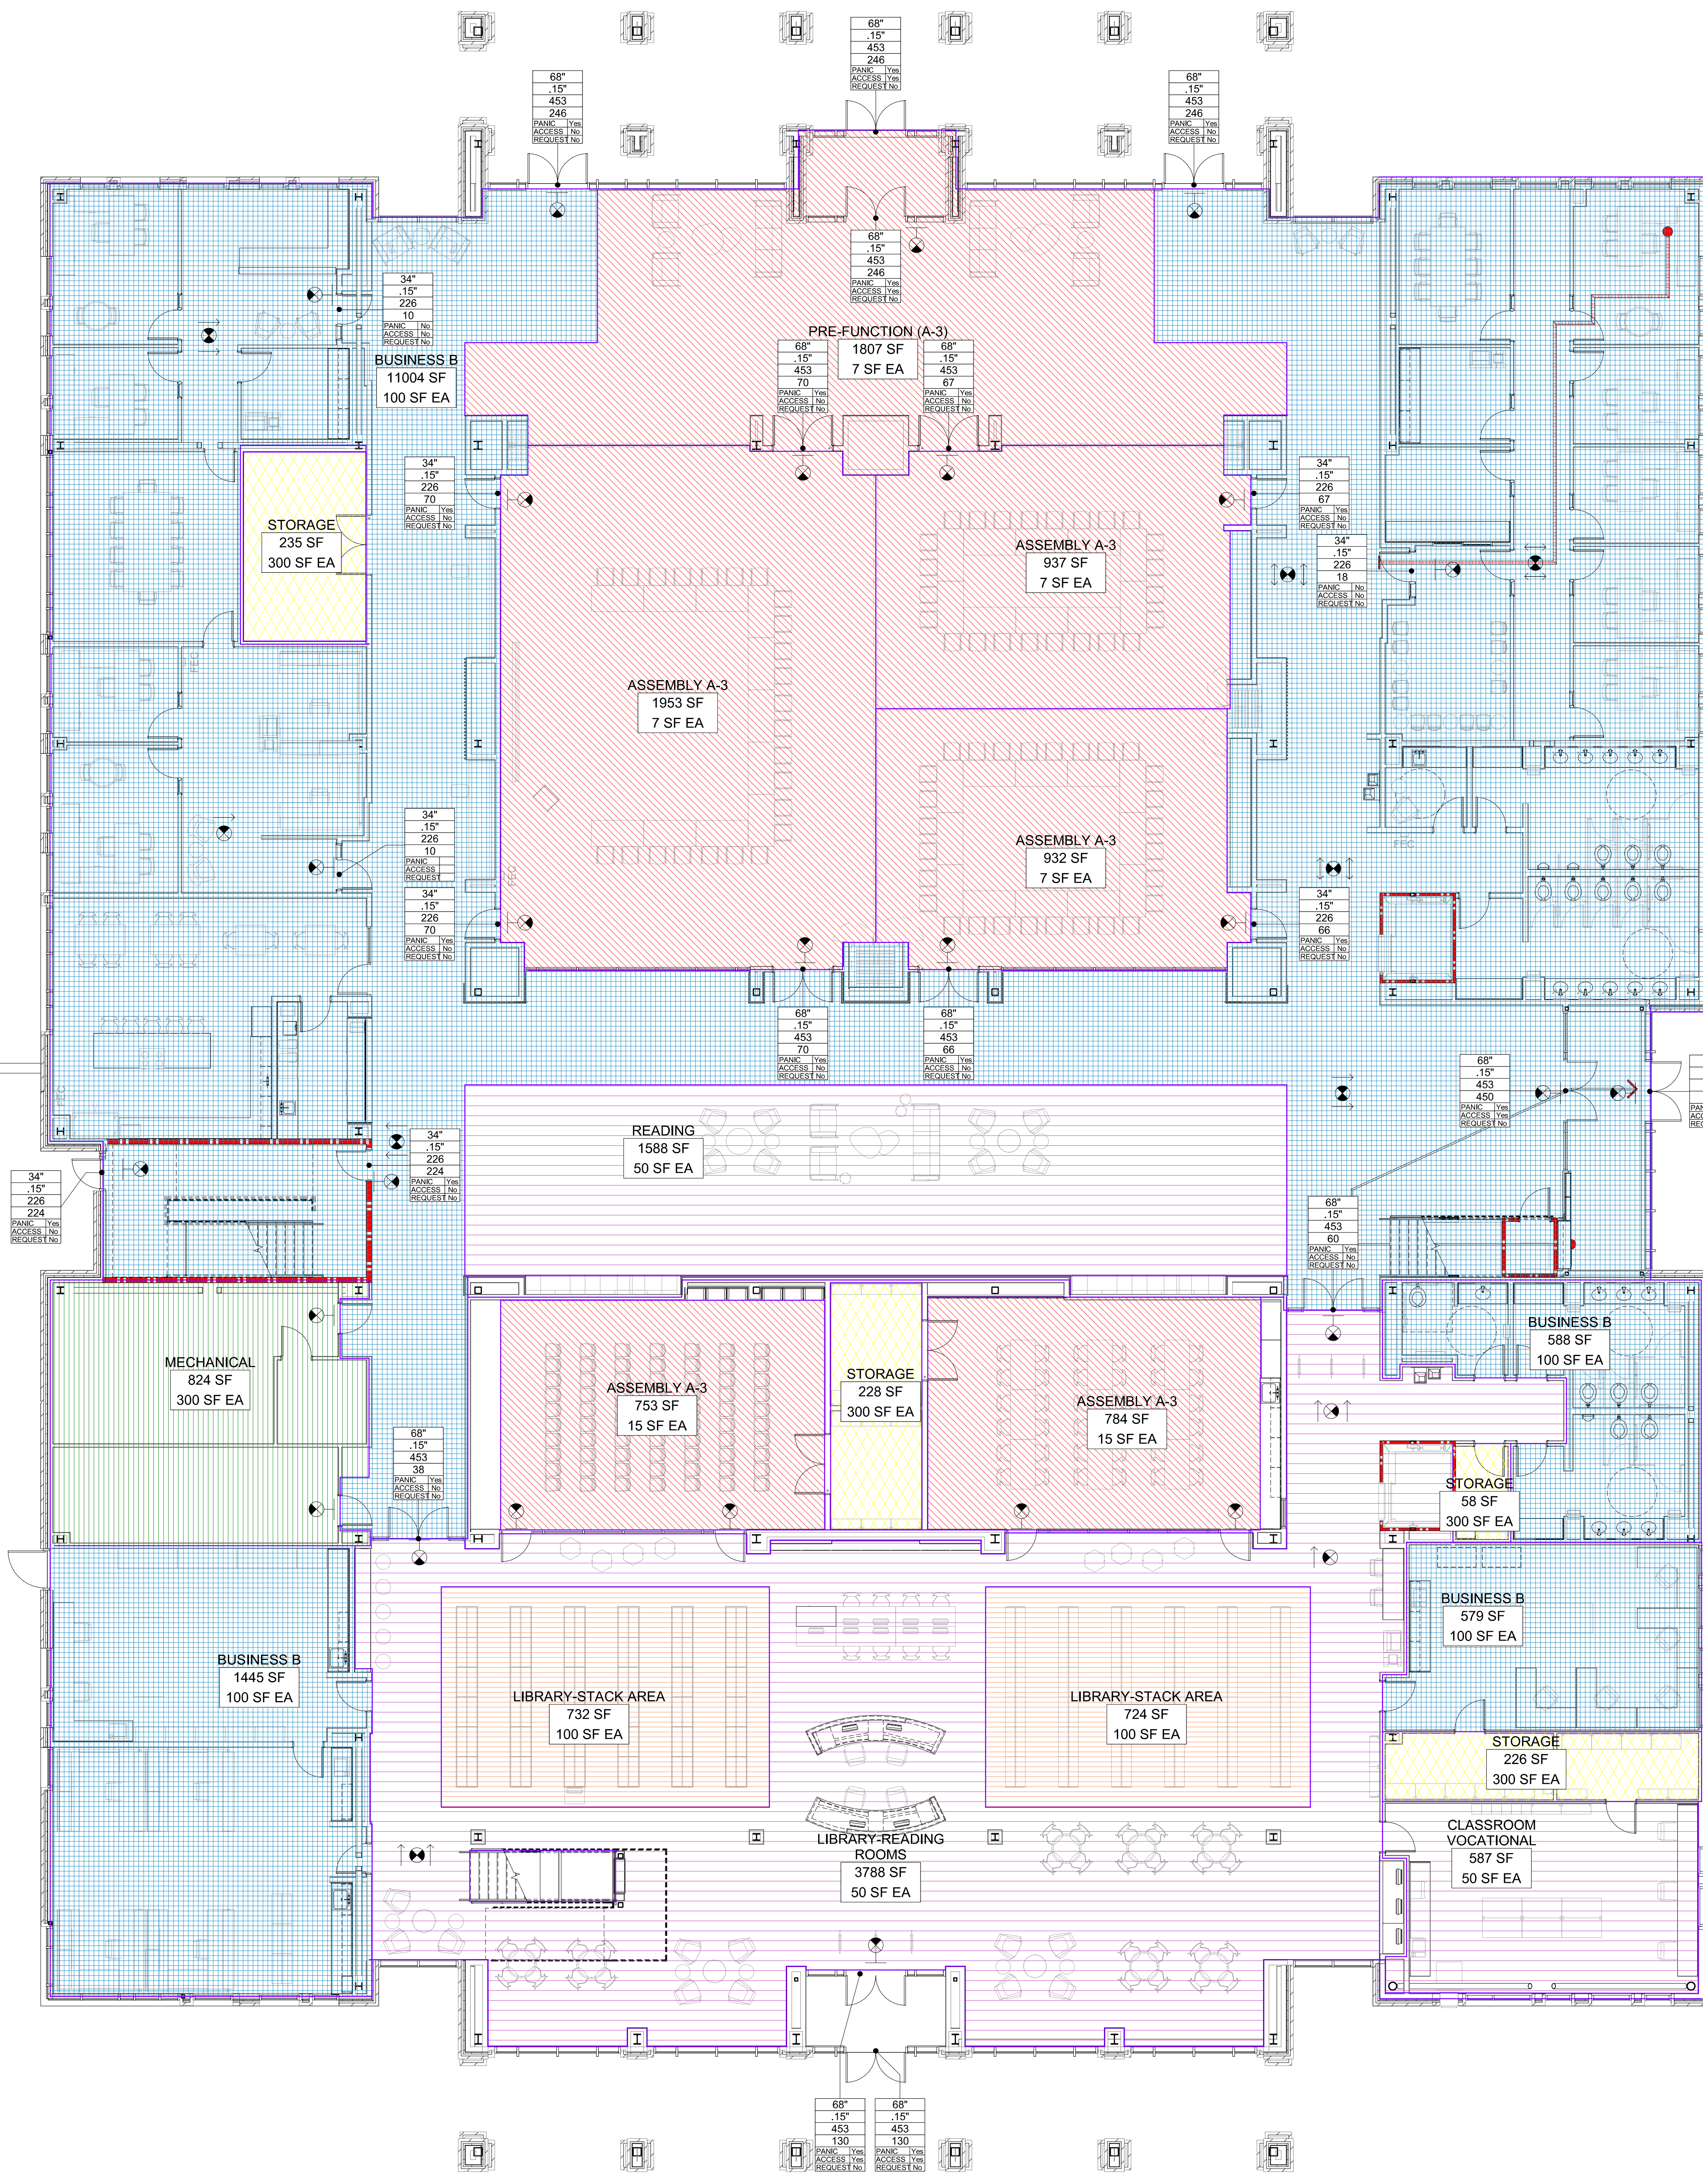OCCUPANCY	AREA	Load Factor	OCCUPANTS
BUSINESS B	11004 SF	100 SF	110
LIBRARY-READING ROOMS	3788 SF	50 SF	76
ASSEMBLY A-3	1953 SF	7 SF	279
PRE-FUNCTION (A-3)	1807 SF	7 SF	256
READING	1588 SF	50 SF	32
BUSINESS B	1445 SF	100 SF	14
ASSEMBLY A-3	937 SF	7 SF	134
ASSEMBLY A-3	932 SF	7 SF	133
MECHANICAL	824 SF	300 SF	3
ASSEMBLY A-3	784 SF	15 SF	52
ASSEMBLY A-3	753 SF	15 SF	50
LIBRARY-STACK AREA	724 SF	100 SF	7
LIBRARY-STACK AREA	724 SF	100 SF	7
BUSINESS B	588 SF	100 SF	6
CLASSROOM VOCATIONAL	587 SF	50 SF	12
BUSINESS B	579 SF	100 SF	6
STORAGE	235 SF	300 SF	1
STORAGE	226 SF	300 SF	1
STORAGE	226 SF	300 SF	1
STORAGE	58 SF	300 SF	0
	29770 SF		1,182



06.13.19
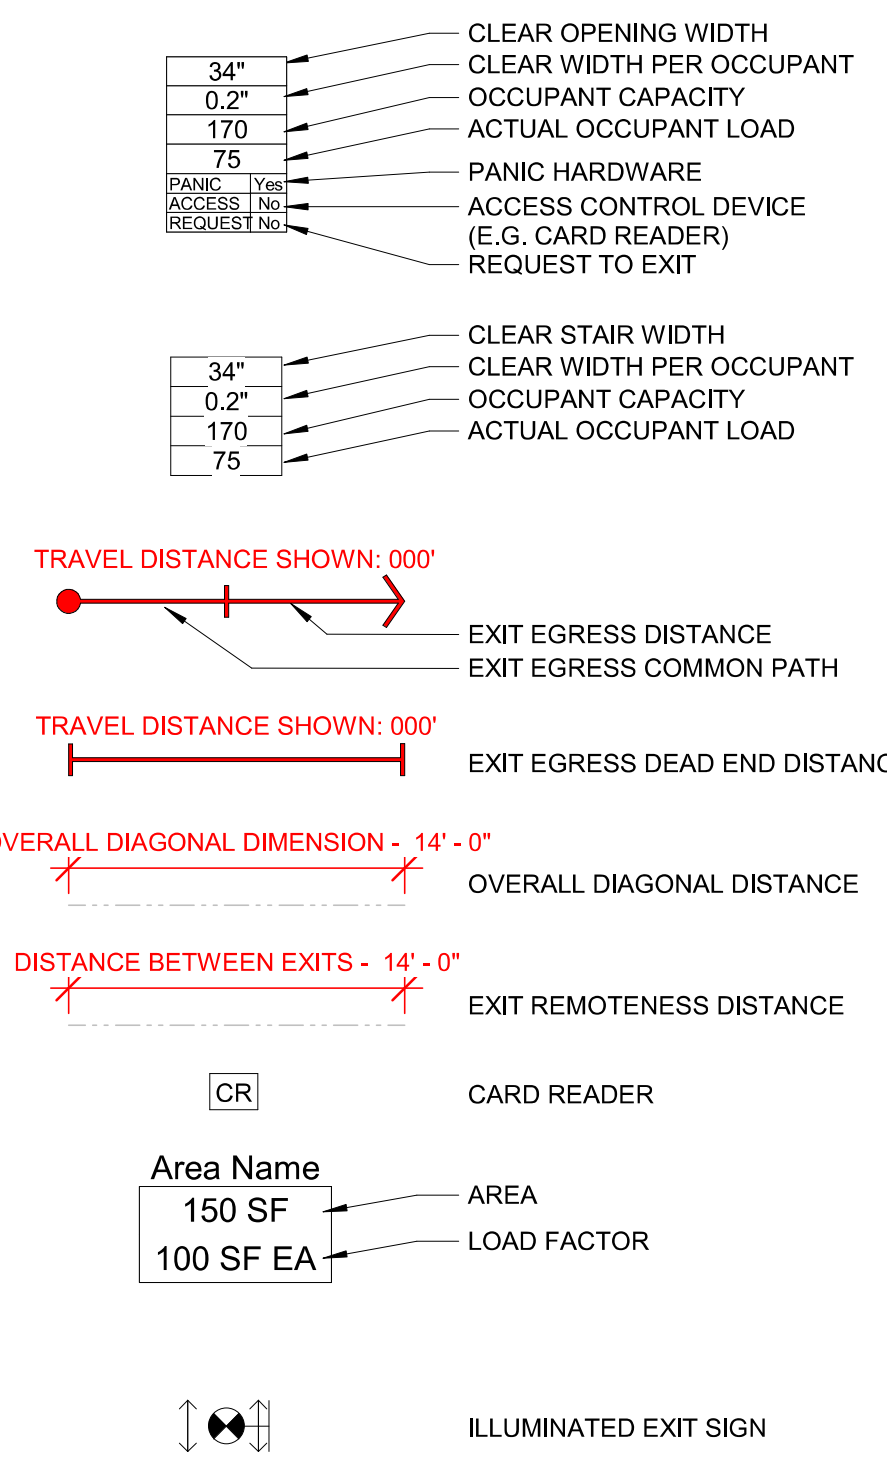
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PROJECT TEAM  
PRINCIPAL IN CHARGE  
JULIE MCLAURIN, AIA  
PROJECT MANAGER  
ERIC SCHOENAGEL, AIA


DESIGN TEAM  
LITTLE  
PROJECT NAME

HARNETT COUNTY  
GOVERNMENT RESOURCE  
CENTER AND LIBRARY

PROJECT NO.  
514-8066-00

SHEET TITLE  
OCCUPANCY PLAN -  
FIRST FLOOR

SHEET NUMBER  
G111

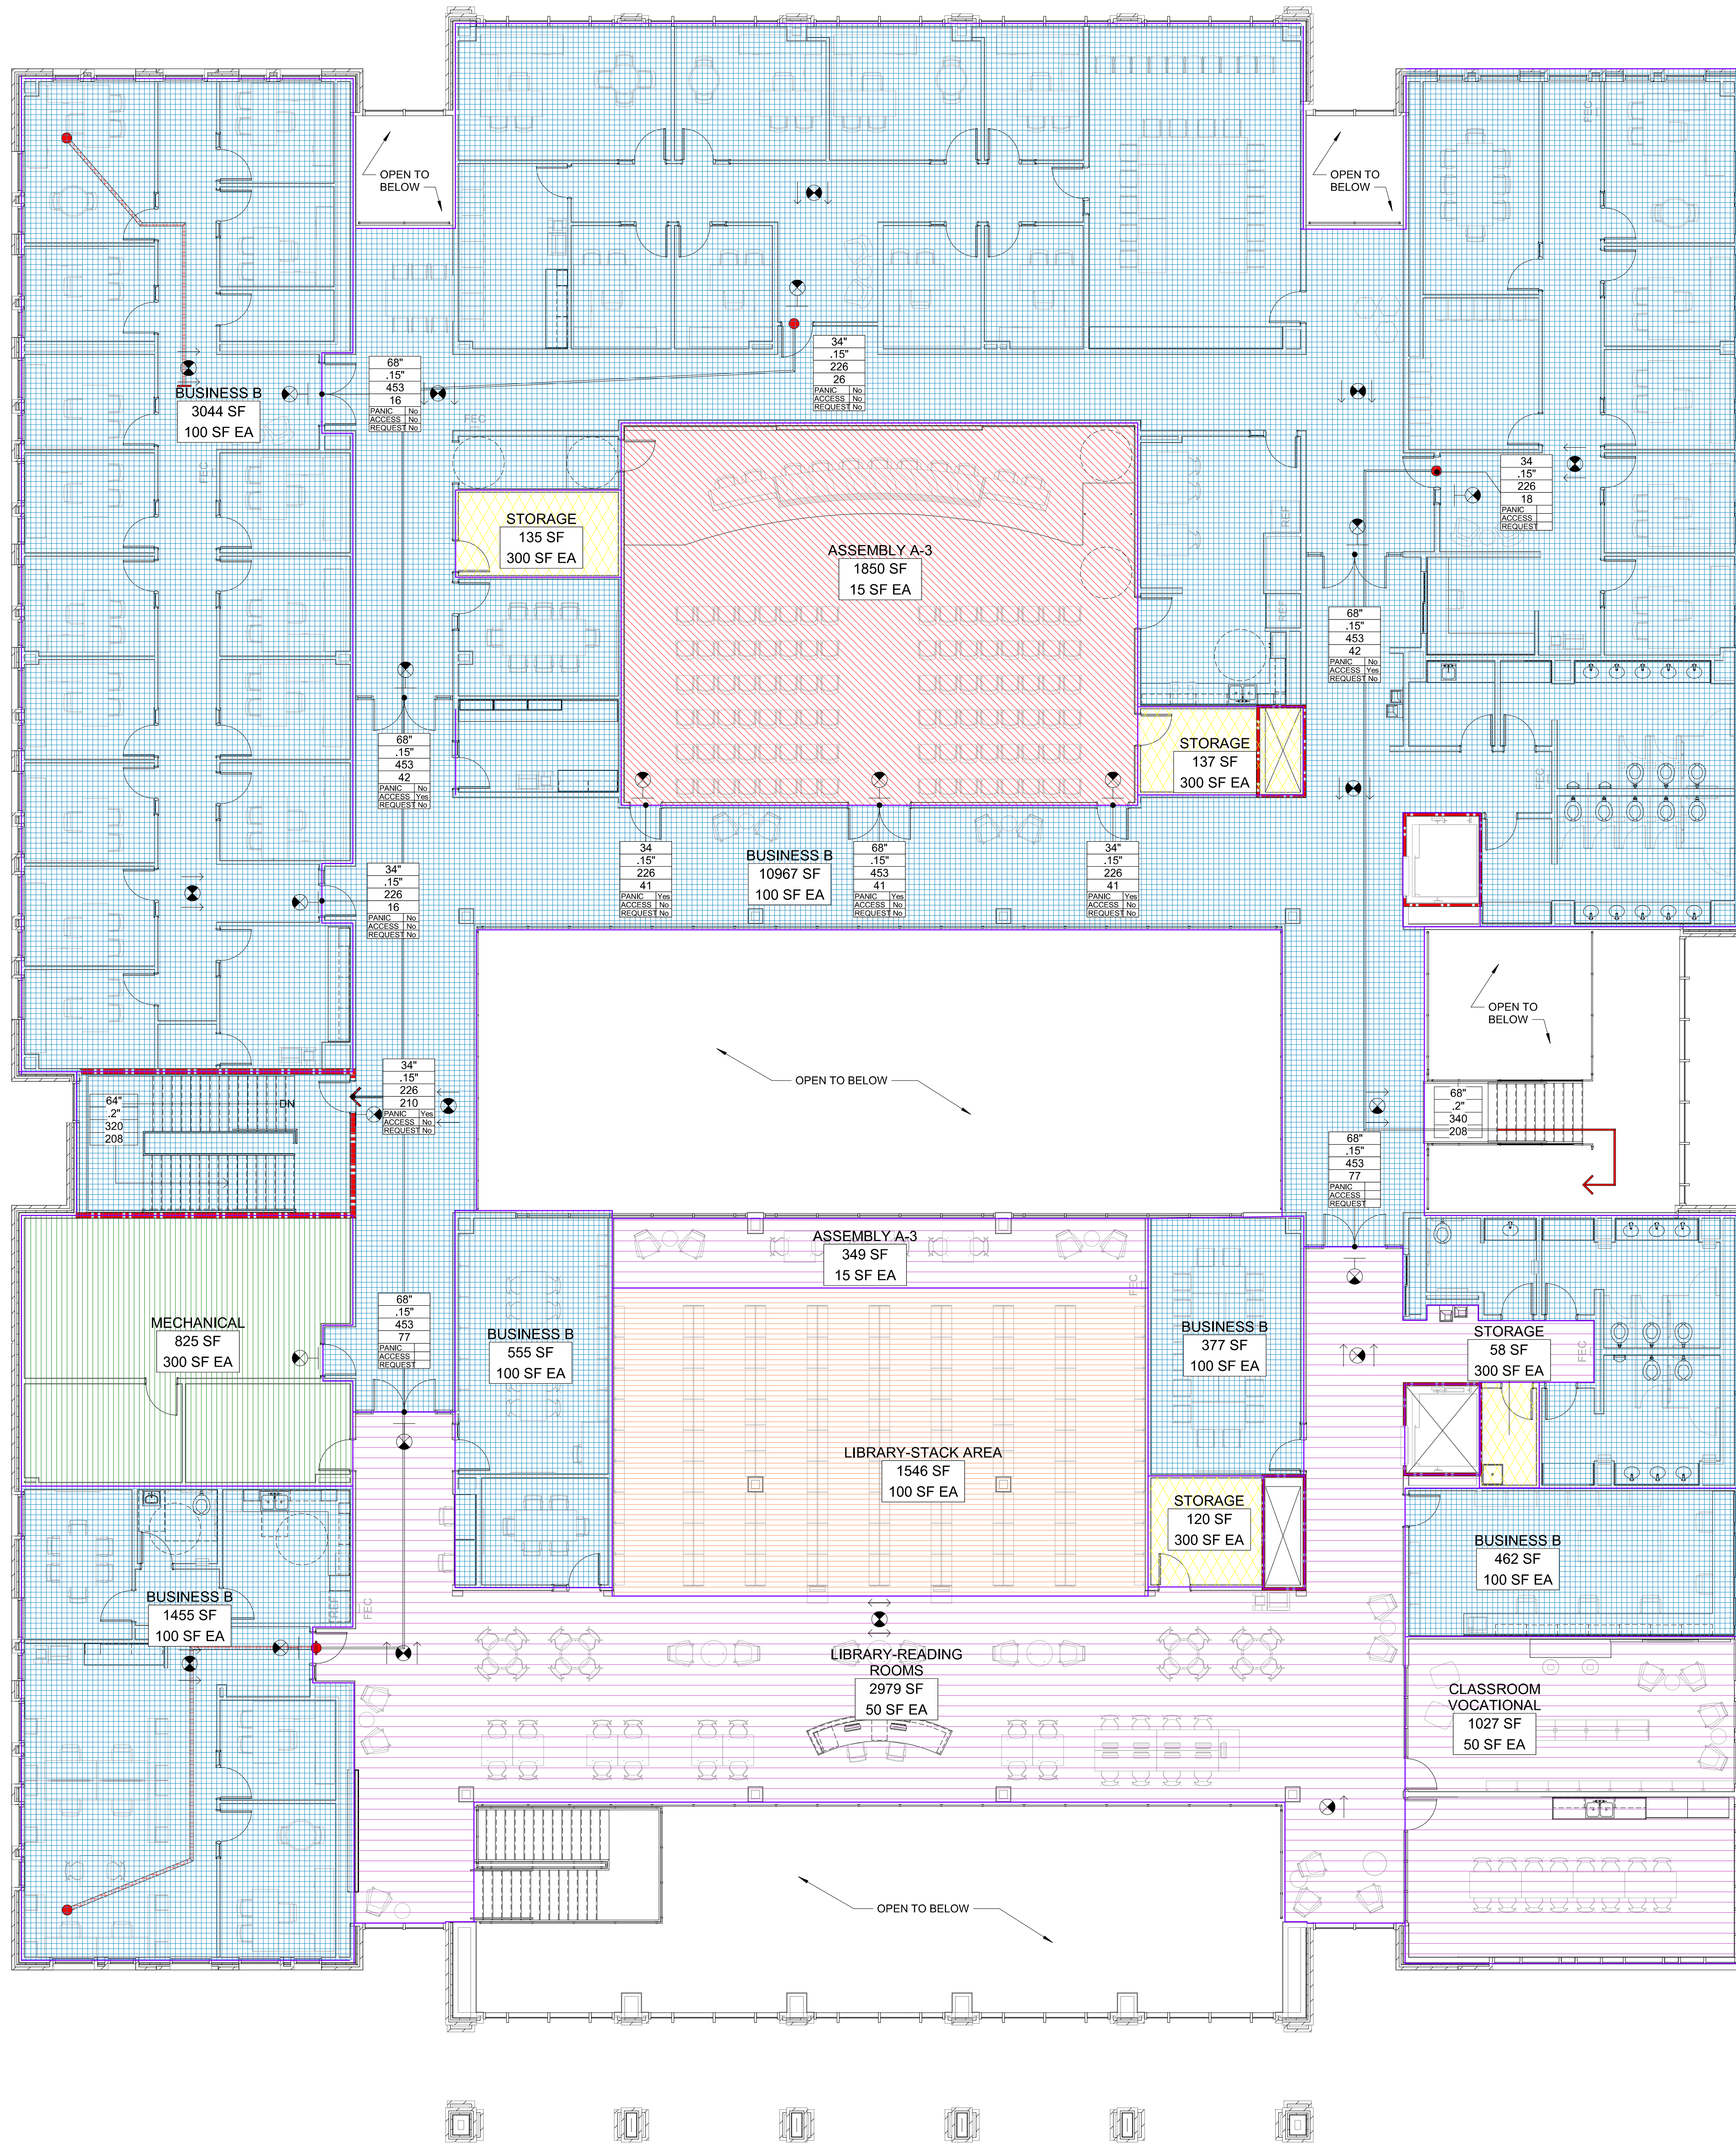

**LIFE SAFETY - AREA SCHEDULE - LEVEL 02**

OCCUPANCY	AREA	LOAD FACTOR	OCCUPANTS
BUSINESS B	10967 SF	100 SF	110
BUSINESS B	3044 SF	100 SF	30
LIBRARY-READING ROOMS	2979 SF	50 SF	60
ASSEMBLY A-3	1850 SF	15 SF	123
LIBRARY-STACK AREA	1546 SF	100 SF	15
BUSINESS B	1455 SF	100 SF	15
CLASSROOM VOCATIONAL	1027 SF	50 SF	21
MECHANICAL	825 SF	300 SF	3
BUSINESS B	555 SF	100 SF	6
BUSINESS B	462 SF	100 SF	5
BUSINESS B	377 SF	100 SF	4
ASSEMBLY A-3	349 SF	15 SF	23
STORAGE	137 SF	300 SF	0
STORAGE	135 SF	300 SF	0
STORAGE	120 SF	300 SF	0
STORAGE	58 SF	300 SF	0
	25887 SF		415



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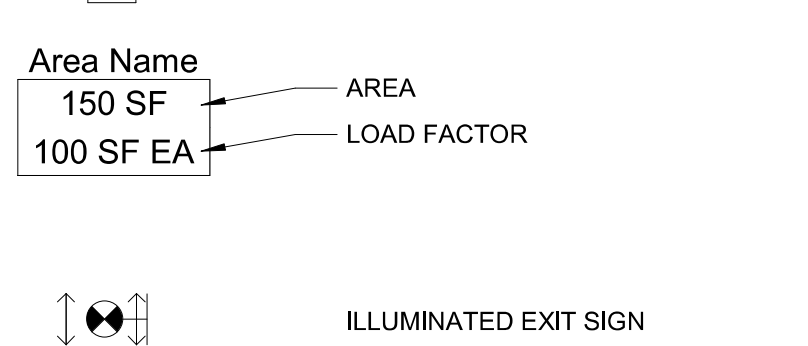
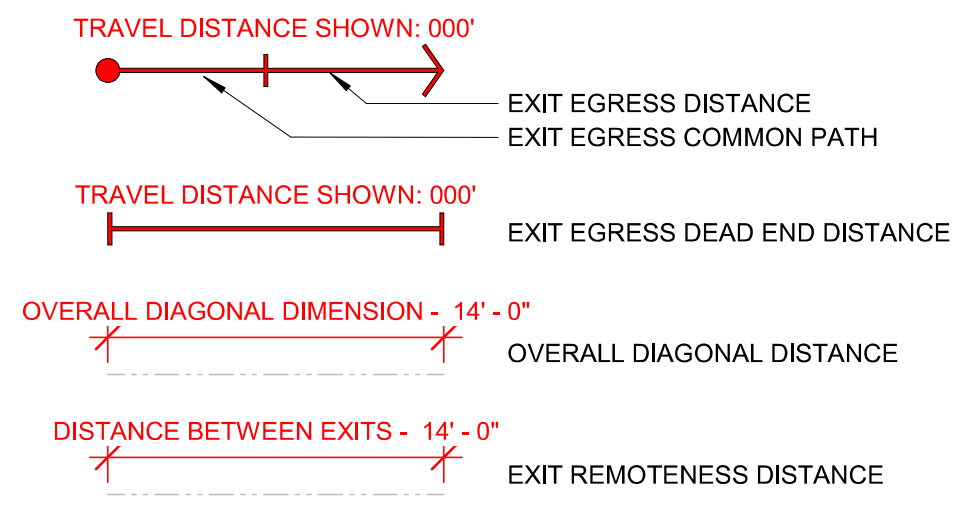
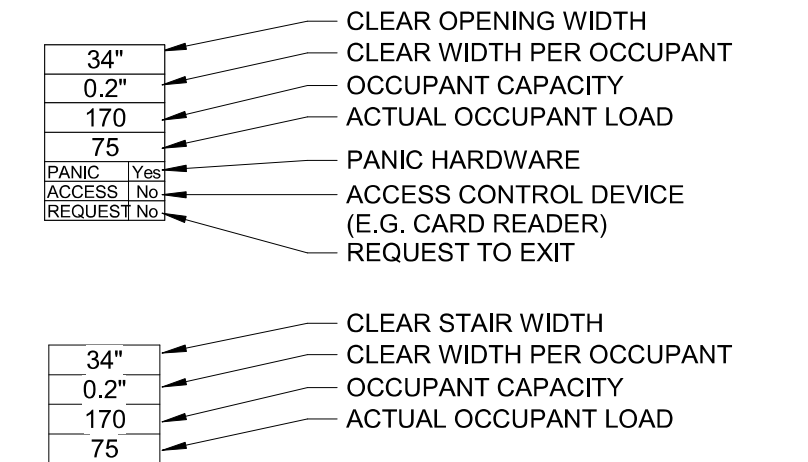
NO.	REASON	DATE

PROJECT TEAM:  
PRINCIPAL IN CHARGE: JULIE MCLAURIN, AIA  
PROJECT MANAGER: ERIC SCHOENAGEL, AIA  
DESIGN TEAM: LITTLE  
PROGRAM NAME: HARNETT COUNTY GOVERNMENT RESOURCE CENTER AND LIBRARY

PROJECT NO.: 514-8066-00

SHEET TITLE: OCCUPANCY PLAN - SECOND FLOOR


SHEET NUMBER: G112



**SYMBOLS - LIFE SAFETY**  
1/8" = 1'-0"





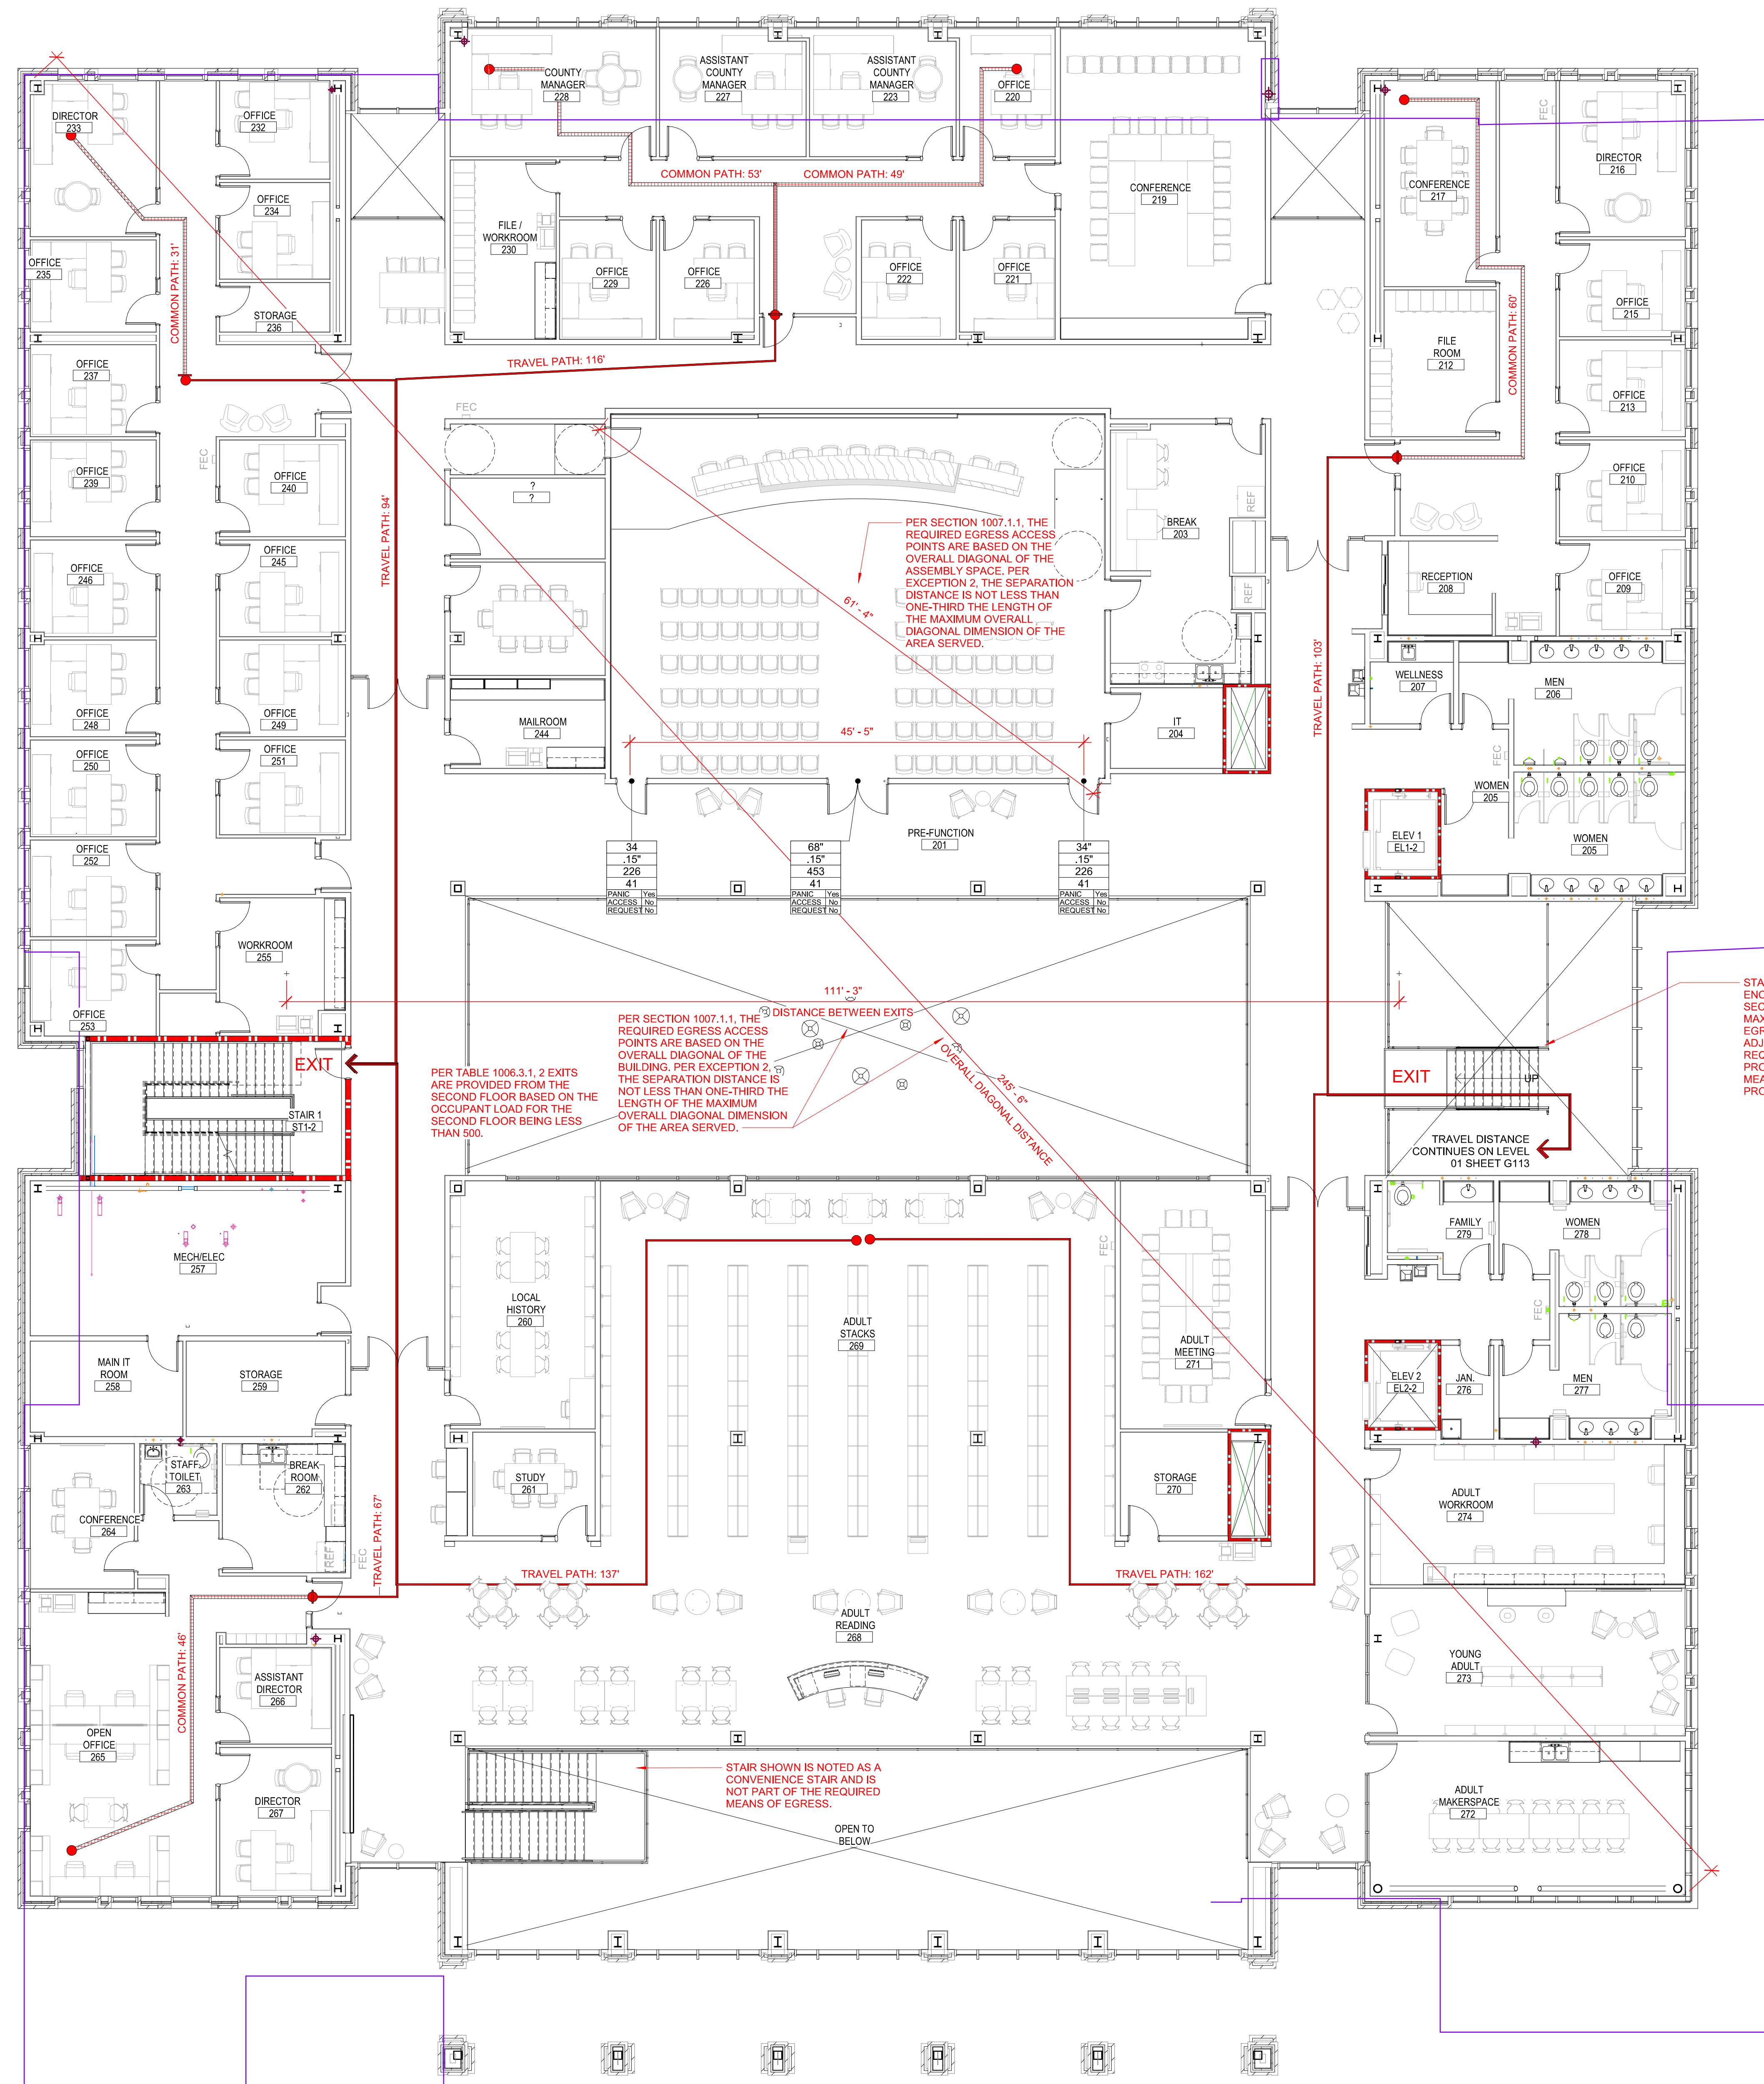

STAIR SHOWN IS NOT ENCLOSED PER EXCEPTION 3 IN SECTION 1023.2 NOTING THAT "A MAXIMUM OF 50 PERCENT OF EGRESS STAIRS SERVING ONE ADJACENT FLOOR ARE NOT REQUIRED TO BE ENCLOSED, PROVIDED AT LEAST TWO MEANS OF EGRESS ARE PROVIDED."

PER SECTION 1007.1.1, THE REQUIRED EGRESS ACCESS POINTS ARE BASED ON THE OVERALL DIAGONAL OF THE BUILDING. PER EXCEPTION 2, THE SEPARATION DISTANCE IS NOT LESS THAN ONE-THIRD THE LENGTH OF THE MAXIMUM OVERALL DIAGONAL DIMENSION OF THE AREA SERVED.


PER SECTION 1007.1.1, THE REQUIRED EGRESS ACCESS POINTS ARE BASED ON THE OVERALL DIAGONAL OF THE BUILDING. PER EXCEPTION 2, THE SEPARATION DISTANCE IS NOT LESS THAN ONE-THIRD THE LENGTH OF THE MAXIMUM OVERALL DIAGONAL DIMENSION OF THE AREA SERVED.

PER TABLE 1006.3.1.2 EXITS ARE PROVIDED FROM THE SECOND FLOOR BASED ON THE OCCUPANT LOAD FOR THE SECOND FLOOR BEING LESS THAN 500.

STAIR SHOWN IS NOTED AS A CONVENIENCE STAIR AND IS NOT PART OF THE REQUIRED MEANS OF EGRESS.

FIRE BARRIER		FIRE & SMOKE BARRIER	
1-HOUR		1-HOUR	
2-HOUR		2-HOUR	
3-HOUR		3-HOUR	
FIRE WALL		FIRE PARTITION	
2-HOUR		0.5-HOUR	
3-HOUR		1-HOUR	
4-HOUR			
SMOKE PARTITION		SMOKE BARRIER	
0-HOUR		1-HOUR	

**RATED WALL TYPES**  
NOT TO SCALE

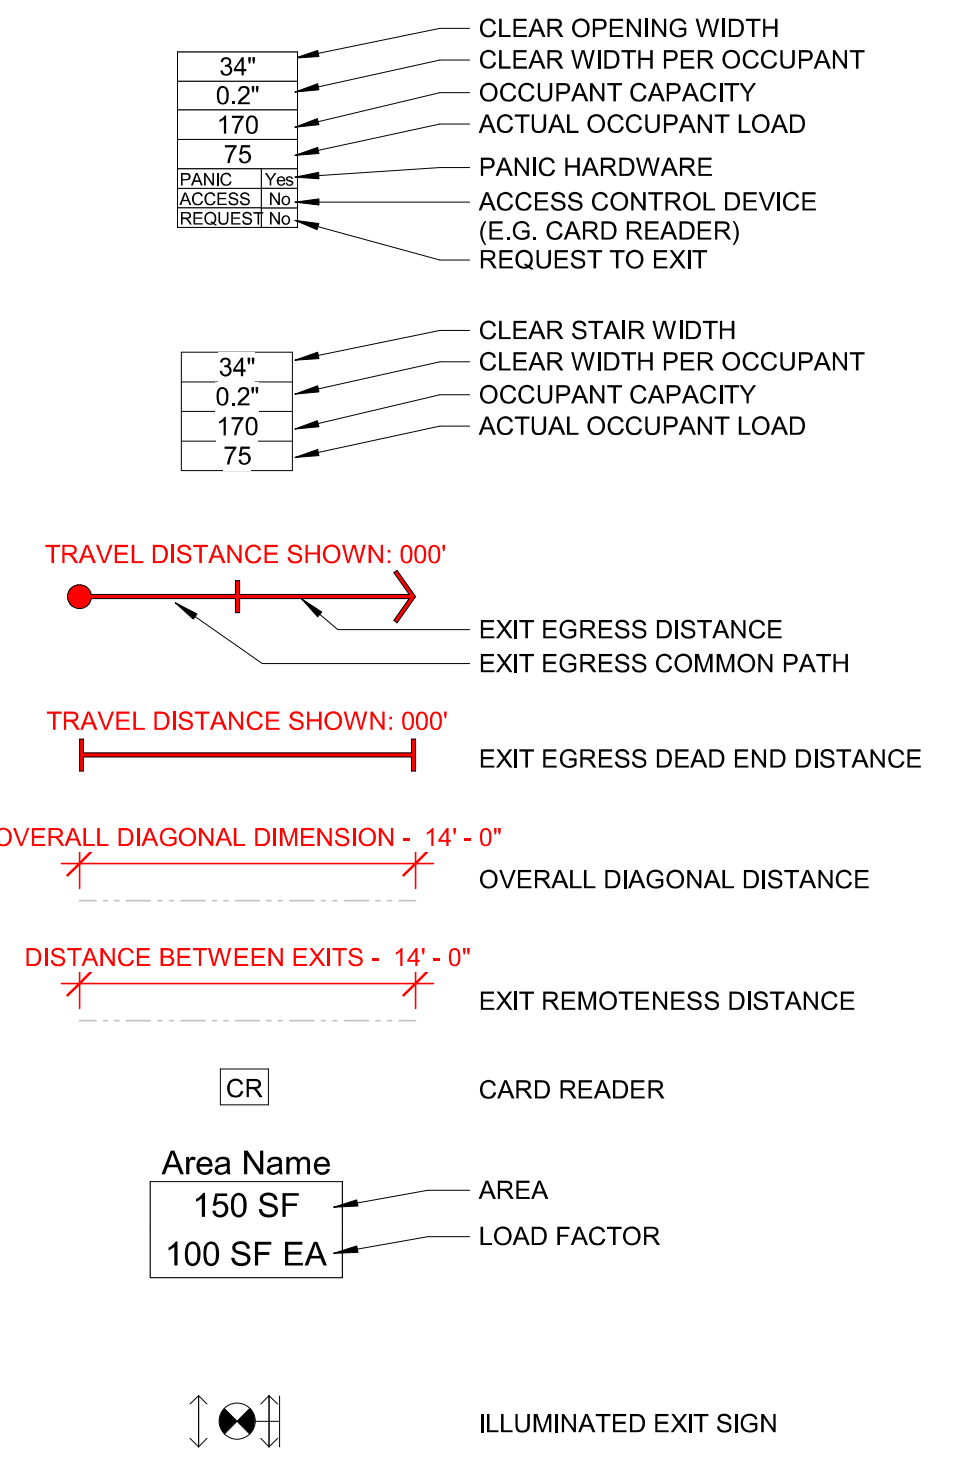

**SYMBOLS - LIFE SAFETY**  
NOT TO SCALE



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PRINCIPAL IN CHARGE: JULIE MCLAURIN, AIA  
PROJECT MANAGER: ERIC SCHOENAGEL, AIA  
DESIGN TEAM: LITTLE  
PROGRAM NAME: HARNETT COUNTY GOVERNMENT RESOURCE CENTER AND LIBRARY

PROJECT NO.: 514-8066-00

SHEET TITLE: LIFE SAFETY PLAN - SECOND FLOOR

SHEET NUMBER: G114

1 LIFE SAFETY PLAN - LEVEL 02  
G114 1/8" = 1'-0"