


FIRE SPRINKLER DRAWING LIST FP-1 SITE UTILITY PLAN FP-2 STANDPIPE ISOMETRIC LEVEL 1 AREA A&B FIRE SPRINKLER PLAN LEVEL 1 AREA C&D FIRE SPRINKLER PLAN LEVEL 1 AREA C&D CON'T & PUMP DETAILS LEVEL 2 AREA A&B FIRE SPRINKLER PLAN LEVEL 2 AREA C&D FIRE SPRINKLER PLAN LEVEL 1 AREA C&D CON'T & DETAILS FP-9 STANDPIPE ELEVATION DETAILS



SITE UTILITY PLAN FOR NODE REFERENCE ONLY-UNDERGROUND BY OTHERS

Reviewed For Code Compliance By: D. Banks Wallace **Chief Deputy Fire Marshal** 12/31/2018 1:21:50 PM

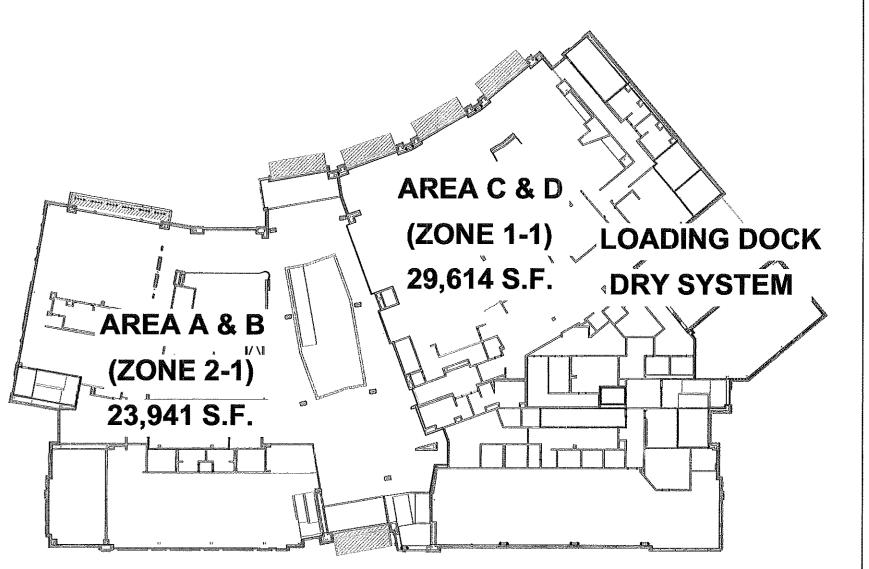

.) THIS SYSTEM IS DESIGNED AND INSTALLED PER NFPA 13 (2013 EDITION) 2.) 2"OR SMALLER PIPING TO BE SCH. 40 BLACK STEEL PIPE AND FITTINGS ARE THREADED FITTINGS. 3.)2-1/2" OR LARGER PIPING TO BE SCH. 10 BLACK STEEL PIPE AND FITTINGS ARE GROOVED/ FLANGED. 4.) ALL HANGERS ARE TO MEET THE CRITERIA SET FORTH BY NFPA 13 (2013 EDITION) AND SPACED ACCORDING TO MANUFACTURES SPECIFICATIONS. 5.) WIRING OF ELECTRICAL EQUIPMENT IS TO BE BY OTHERS. 6.XI)=REPRESENTS A HYDRAULIC REFERENCE POINT. 7.) CAROLINA FIRE CONTROL TO START 1'-0" ABOVE FINISHED FLOOR. 8.) ALL UNDERGROUND PIPING BY OTHERS. 9.) SPRINKLERS LOCATED 7'-6" OR LESS FROM FLOOR TO BE PROTECTED WITH

APPROVED GUARDS.

NFPA 13(2013 ED.) NFPA 14(2013 ED.) NFPA 20(2013 ED.) PLOT PLAN

	WATER SUPP	<u>LY INFORMATION</u>			DESIGN CRITI	<u>ERIA</u>	
STATIC PRESSURE	56	FIRE PUMP	УES	REMOTE AREA NUMBER			
RESIDUAL PRESSURE	38	SIZE GPM @ PSI	500@75	COVERAGE PER HEAD			
FLOW G.P.M.	920	TYPE OF DRIVER	ELEC.	DENSITY			
DATE OF TEST	10-10-18	ELECTRICAL REQ.5	480V	AREA OF APPLICATION			
HYDRANT LOCATION	CAMPBELL P	ARKING LOT ALONG TT	LANIER RD	PSI @ (BOR)			
TEST TAKEN BY	BUTES CRE	EK FIRE DEPARTMENT		GPM € (BOR)			
NOTES				NO. OF HEADS IN DESIGN AREA			
				ELEV. @HIGHEST HEAD			
				INSIDED HOSE			
				OUTSIDE HOSE			
				SAFETY			

						SPRINKLE		_)	NO.	DATE	REVISION DISCRIPTION
	SYMBOL	QUANITY	MAKE	MODEL	STYLE	K-FAC.	TEMP.	THREAD SIZE	SPRINKLER FINISH	TYPE OF ESCUTCHEON	ESCUTCHEON FINISH	SPRINKLER IDEN. NO.(5.I.N.)	/i\		
	(9)	0	RELIABLE	F1FR56	PENDENT	5.6	175°	1/2"	CHROME	SEMI-REC	CHROME	RA1414	\ \ \ \ \		
	0	0	RELIABLE	F1FR56	UPRIGHT	5.6	175°	1/2"	BRASS	N/A	N/A	RA1425	<u> </u>		
	⊗	0	RELIABLE	J112	EXT PEND	11.2	155°	3/4"	CHROME	SEMI-REC	CHROME	RA7216	3		
		0	RELIABLE	J112	EXTUPRIT	11,2	155°	3/4"	BRONZE	N/A	N/A	RA7326	\ \ \ \ \ \		
-	0	0	RELIABLE	F3QR56	DRY PEND	5.6	165°	1"	CHROME	SEMI-REC	CHROME	R5714			
		0											$ \wedge $		
		0													
-		0													
		0	TOTAL FO	OR SHEET			 		,	TOTAL FOR	PROJECT 0				
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		Ca
	*	

NC FIRE SPRINKLER CONTRACTOR #16603


SC FIRE SPRINKLER CONTRACTOR: FSC.1078

arolina Fire Control INCORPORATED


PH: 704-784-4218 P O BOX 1090 CONCORD, N.C. 28026 FAX: 704-784-4405


CAMPBELL UNIVERSITY STUDENT UNION MAIN STREET BUIES CREEK, NORTH CAROLINA 27506 TA LOVING 400 PATETOWN ROAD GOLDSBORO, NORTH CAROLINA 27530 DRAWN BY: JEFF WYATT AHJ: HARNETT COUNTY FM


CONTRACT NO. 18-2186

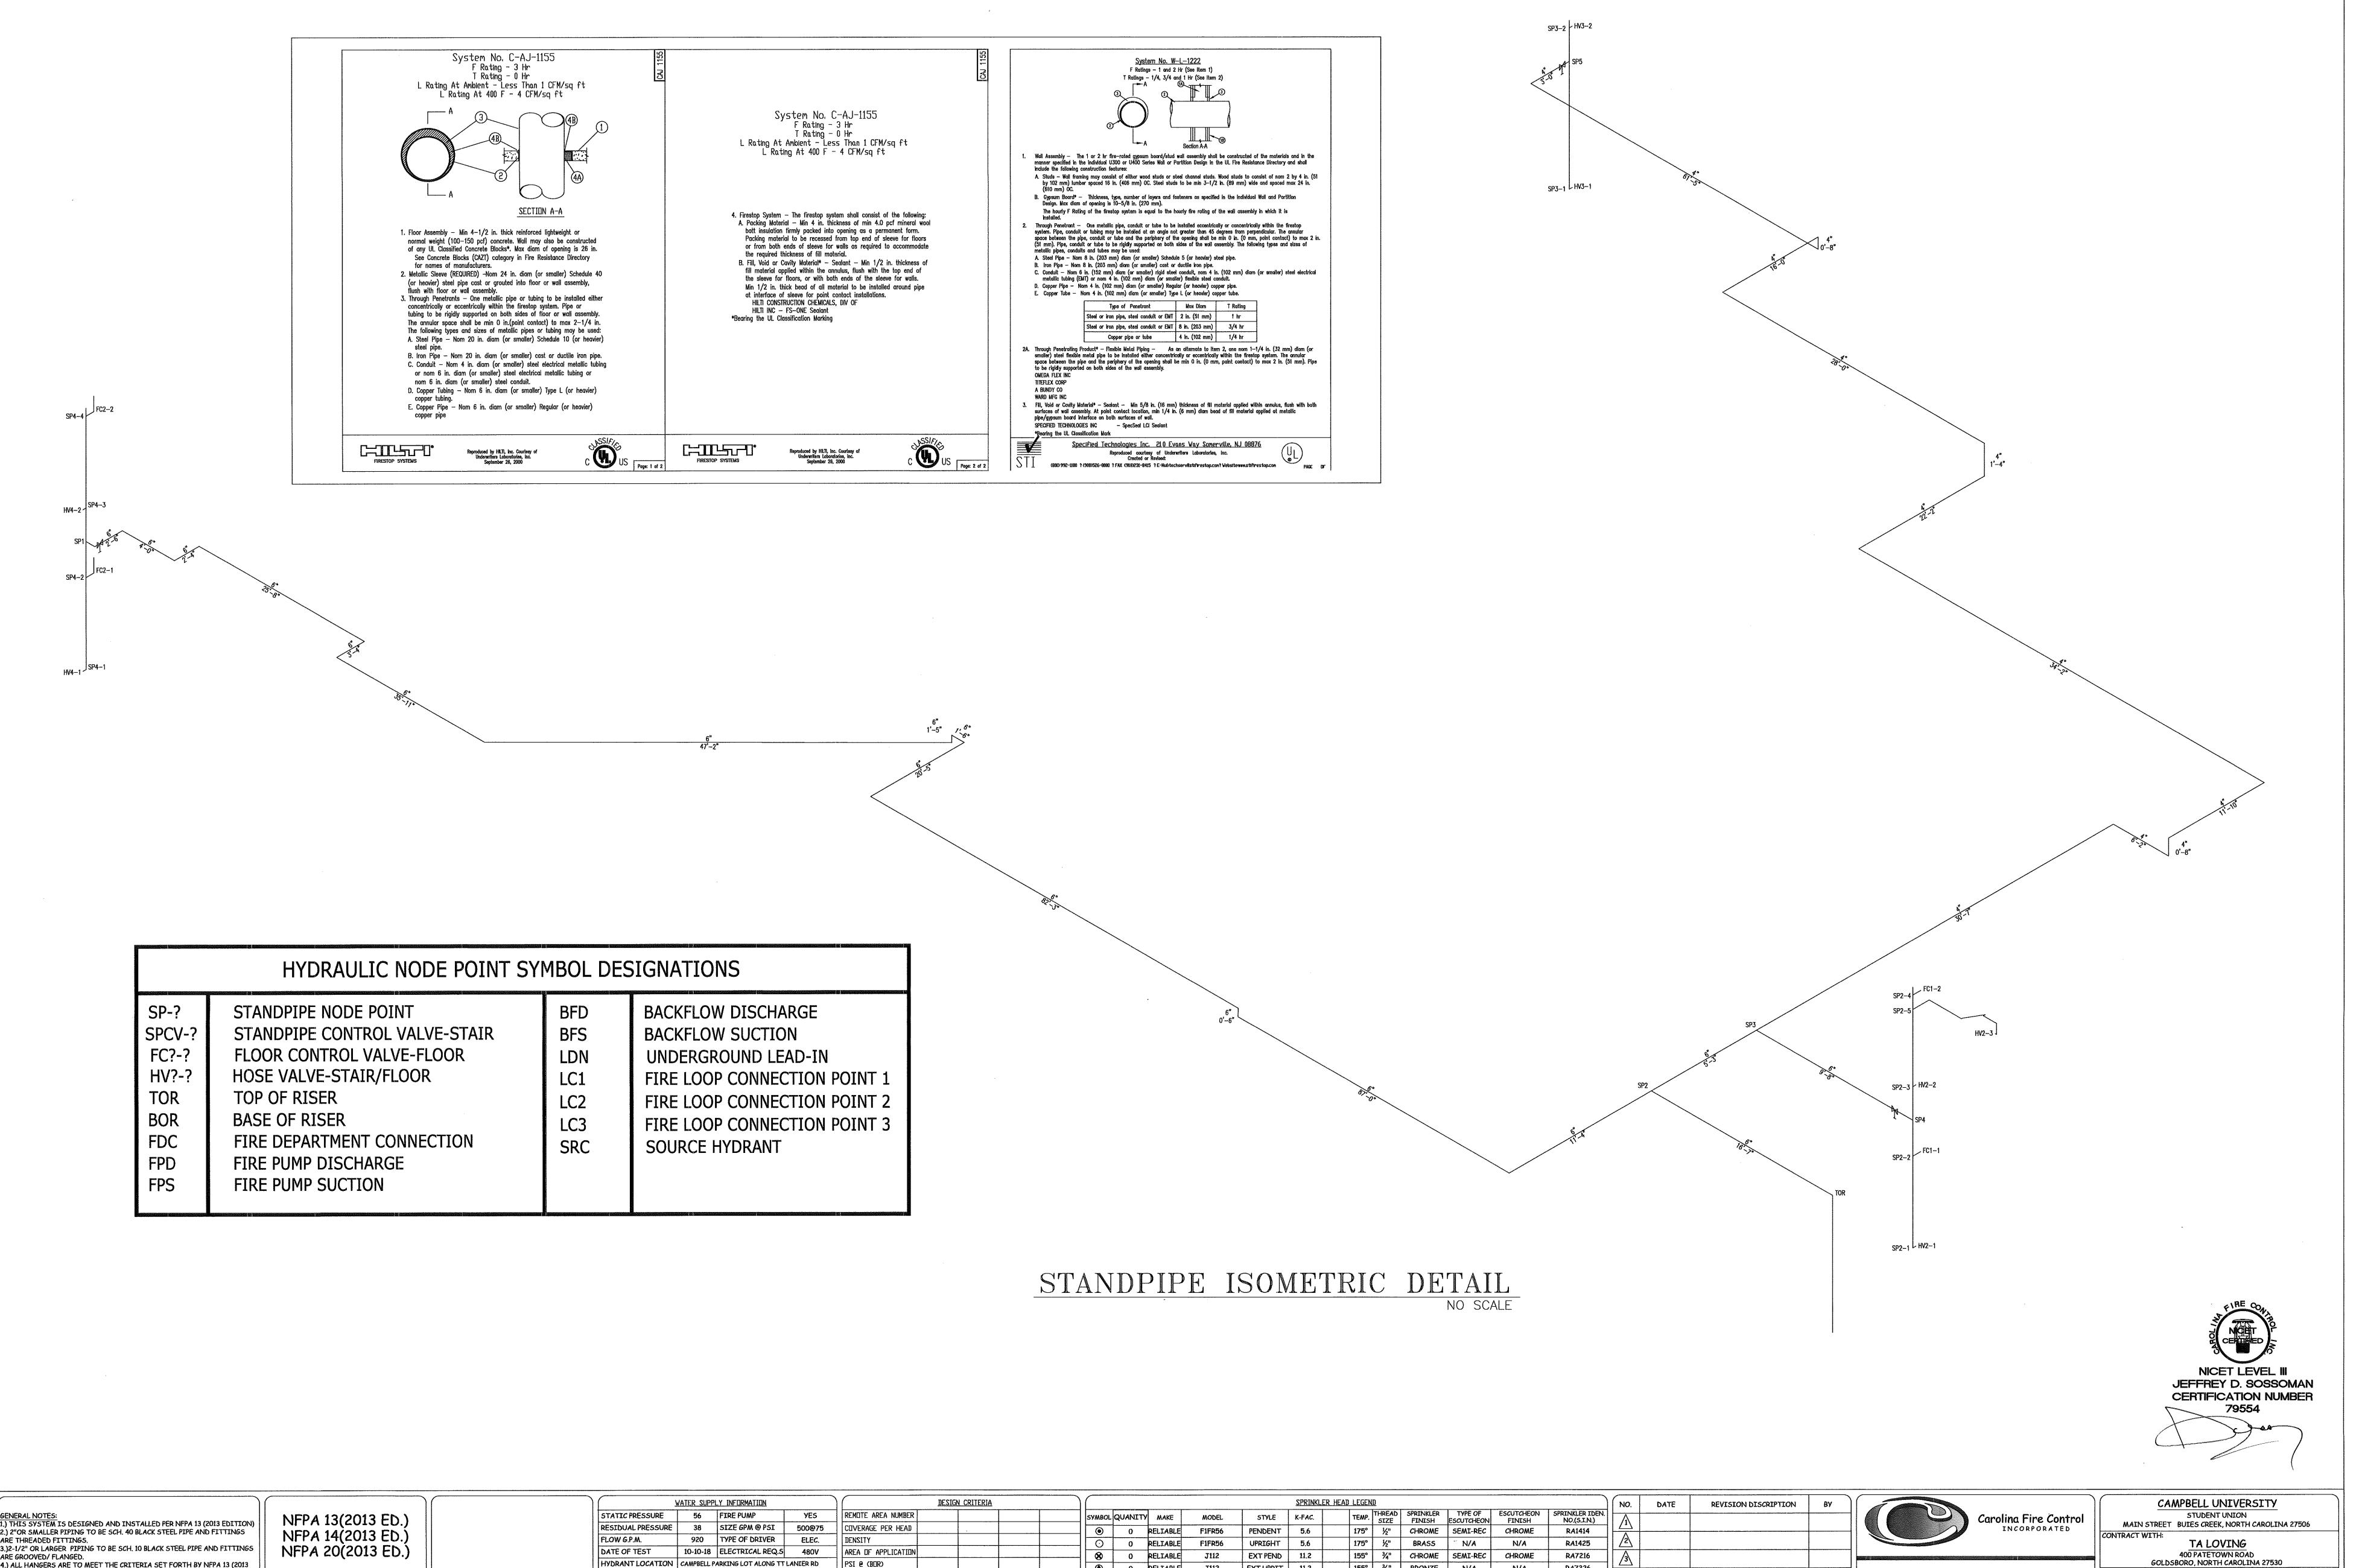



2.) 2"OR SMALLER PIPING TO BE SCH. 40 BLACK STEEL PIPE AND FITTINGS ARE THREADED FITTINGS. 3.)2-1/2" OR LARGER PIPING TO BE SCH. 10 BLACK STEEL PIPE AND FITTINGS ARE GROOVED/ FLANGED. 4.) ALL HANGERS ARE TO MEET THE CRITERIA SET FORTH BY NFPA 13 (2013 J112 EXTUPRIT BRONZE N/A RA7326 EDITION) AND SPACED ACCORDING TO MANUFACTURES SPECIFICATIONS. DRAWN BY: JEFF WYATT AHJ: HARNETT COUNTY FM TEST TAKEN BY BUIES CREEK FIRE DEPARTMENT GPM @ (BOR) PH: 704-784-4218 CHROME SEMI-REC R5714 5.) WIRING OF ELECTRICAL EQUIPMENT IS TO BE BY OTHERS. NO. OF HEADS IN DESIGN AREA FAX: 704-784-4405 6.X1)=REPRESENTS A HYDRAULIC REFERENCE POINT. CONCORD, N.C. 28026 7.) CAROLINA FIRE CONTROL TO START 1'-0" ABOVE FINISHED FLOOR. ELEV. @HIGHEST HEAD 8.) ALL UNDERGROUND PIPING BY OTHERS. HOSE ALLOWANCE NC FIRE SPRINKLER CONTRACTOR #16603 9.) SPRINKLERS LOCATED 7'-6" OR LESS FROM FLOOR TO BE PROTECTED WITH 0 SC FIRE SPRINKLER CONTRACTOR: FSC.1078 APPROVED GUARDS. CONTRACT NO. 0 TOTAL FOR SHEET TOTAL FOR PROJECT

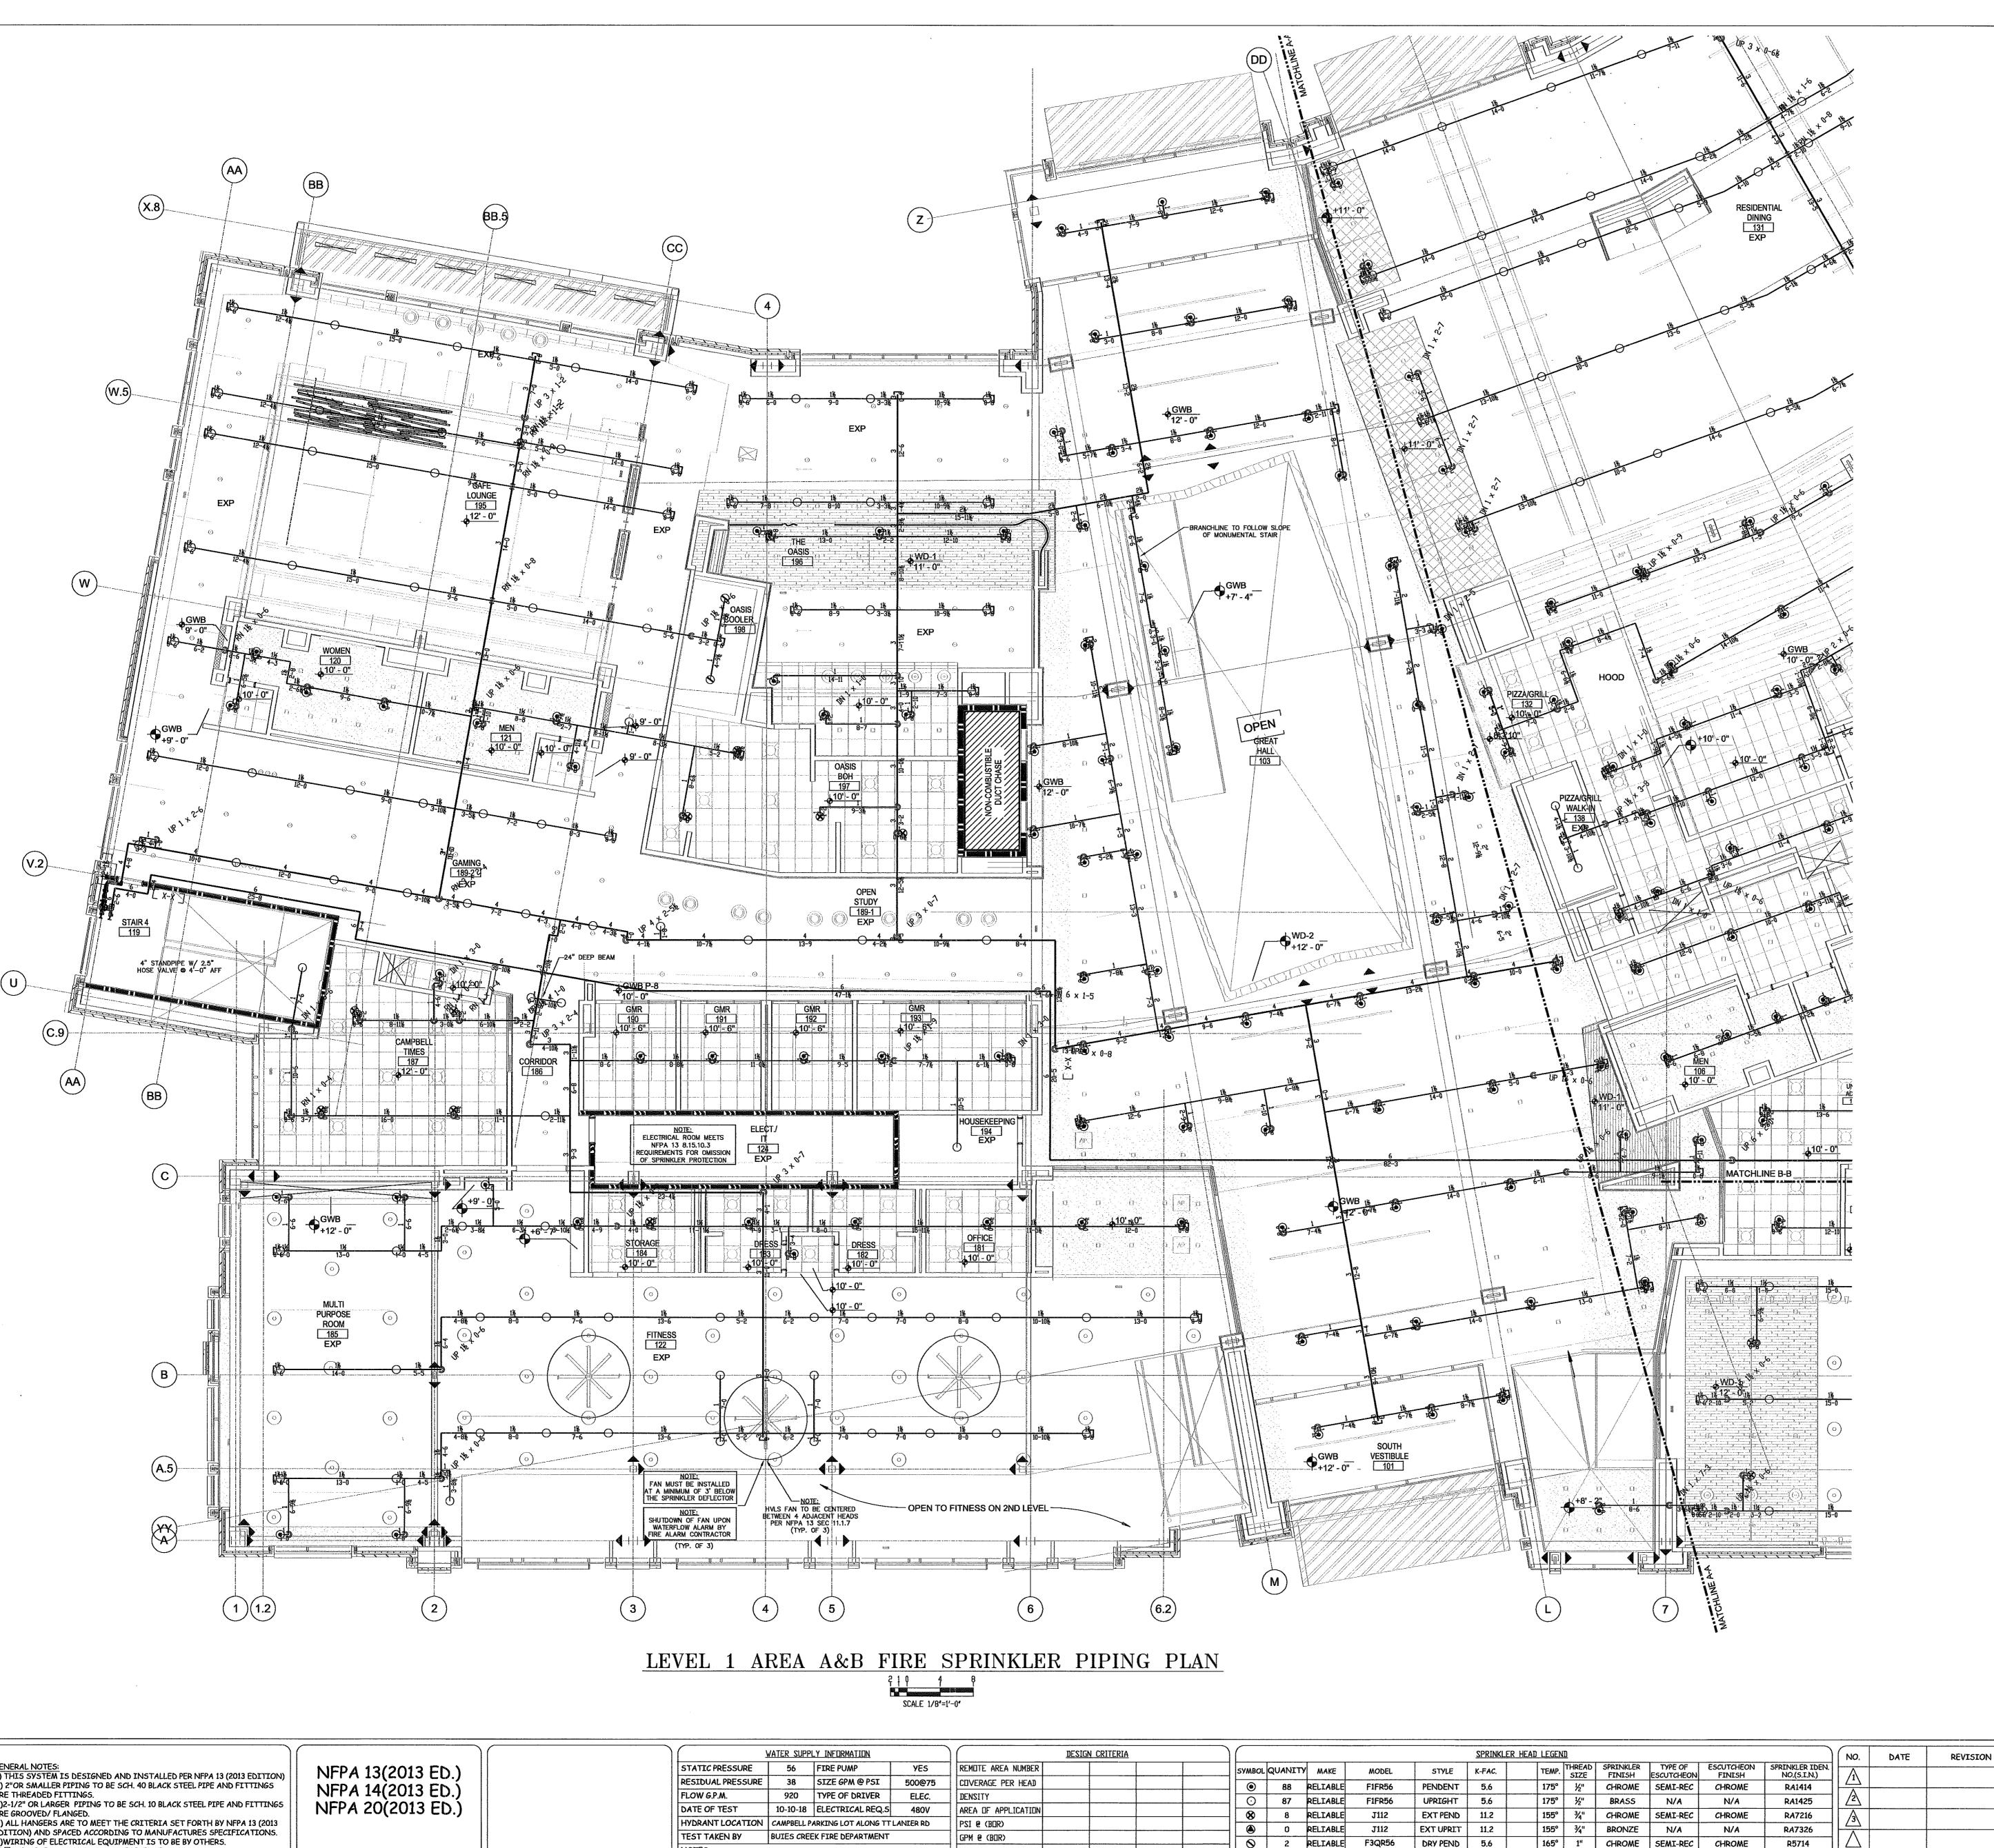

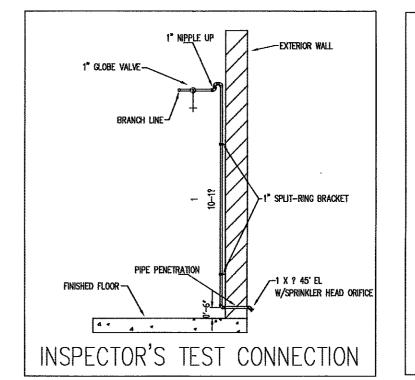

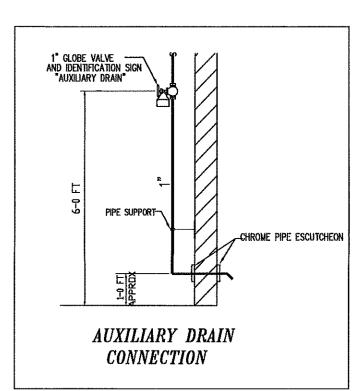

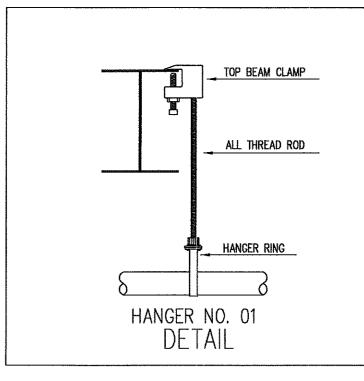

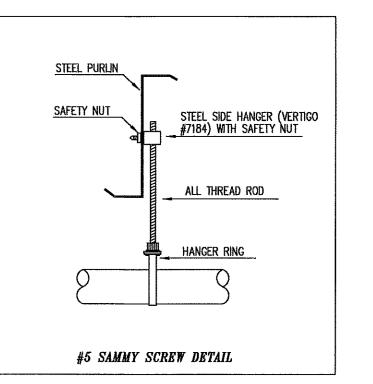

NOTE: HANGERS OMITTED FROM SUBMITTAL PLAN FOR CLARITY ONLY, FIELD SET INCLUDES HANGER LOCATIONS WHICH MEET NFPA 13 SPACING REQUIREMENTS SHOWN BELOW.

NUMINAL PIPE	3/4"	1.	1 1/4"	1 1/2	2"	2 1/2	3*	4"	6"	8*
SIZE (IN.)	<u> </u>	<u> </u>	1 17 1	2 17 -	-	- 1/ -		<u> </u>		
STEEL PIPE SCH 40, SCH 10, DF, EF	N/A	12-0	12-0	15-0	15-0	15-0	15-0	15-0	15-0	15-0
THREADED LIGHTVALL	N/A	12-0	12-0	12-0	12-0	12-0	N/A	N/A	N/A	N/A
Copper	8-0	8-0	10-0	10-0	12-0	12-0	12-0	15-0	15-0	15-0
CPVC	5-6	6-0	6-6	7-0	8-0	9-0	10-0	N/A	N/A	N/A

WHERE STATIC OR OPERATING PRESSURES EXCEED 100 PSI HANGERS SHALL BE PER NFPA 13 9.2.3.5.2.1 2013 EDITION

TOTAL HEAD COUNT LEVEL 1 479 LEVEL 2 PROJECT TOTAL 846



	GENERAL NOTES:
	1.) THIS SYSTEM IS DESIGNED AND INSTALLED PER NFPA 13 (2013 EDITION)
	2.) 2"OR SMALLER PIPING TO BE SCH. 40 BLACK STEEL PIPE AND FITTINGS
	ARE THREADED FITTINGS.
	3.)2-1/2" OR LARGER PIPING TO BE SCH. 10 BLACK STEEL PIPE AND FITTINGS
	ARE GROOVED/ FLANGED.
	4.) ALL HANGERS ARE TO MEET THE CRITERIA SET FORTH BY NFPA 13 (2013
	EDITION) AND SPACED ACCORDING TO MANUFACTURES SPECIFICATIONS.
	5.)WIRING OF ELECTRICAL EQUIPMENT IS TO BE BY OTHERS.
1	6.XI)=REPRESENTS A HYDRAULIC REFERENCE POINT.
1	7.) CAROLINA FIRE CONTROL TO START 1'-0" ABOVE FINISHED FLOOR.
	B.)ALL UNDERGROUND PIPING BY OTHERS.

9.) SPRINKLERS LOCATED 7'-6" OR LESS FROM FLOOR TO BE PROTECTED WITH

APPROVED GUARDS.

PLOT PLAN

NOTES

NO. OF HEADS IN DESIGN AREA ELEV. @HIGHEST HEAD HOSE ALLOWANCE

0 0 185 TOTAL FOR SHEET

	NO.	DATE	REVISION DISCRIPTION	ВУ	
(LER IDEN. (S.I.N.)	/i				
1414					1
1425	<u>/2</u> \	Annah			
7216	3	A comment			
7326	 				╢
5714		Alemanity			
	Λ		***************************************		1Ι

TOTAL FOR PROJECT



Carolina Fire Control


PH: 704-784-4218 P O BOX 1090 CONCORD, N.C. 28026 FAX: 704-784-4405 NC FIRE SPRINKLER CONTRACTOR #16603


SC FIRE SPRINKLER CONTRACTOR: FSC,1078

STUDENT UNION
MAIN STREET BUIES CREEK, NORTH CAROLINA 27506 TA LOVING
400 PATETOWN ROAD GOLDSBORO, NORTH CAROLINA 27530 DRAWN BY: JEFF WYATT


AHJ: HARNETT COUNTY FM 11-19-18 FP 3 of FP 9 CONTRACT NO. 18-2186


CAMPBELL UNIVERSITY

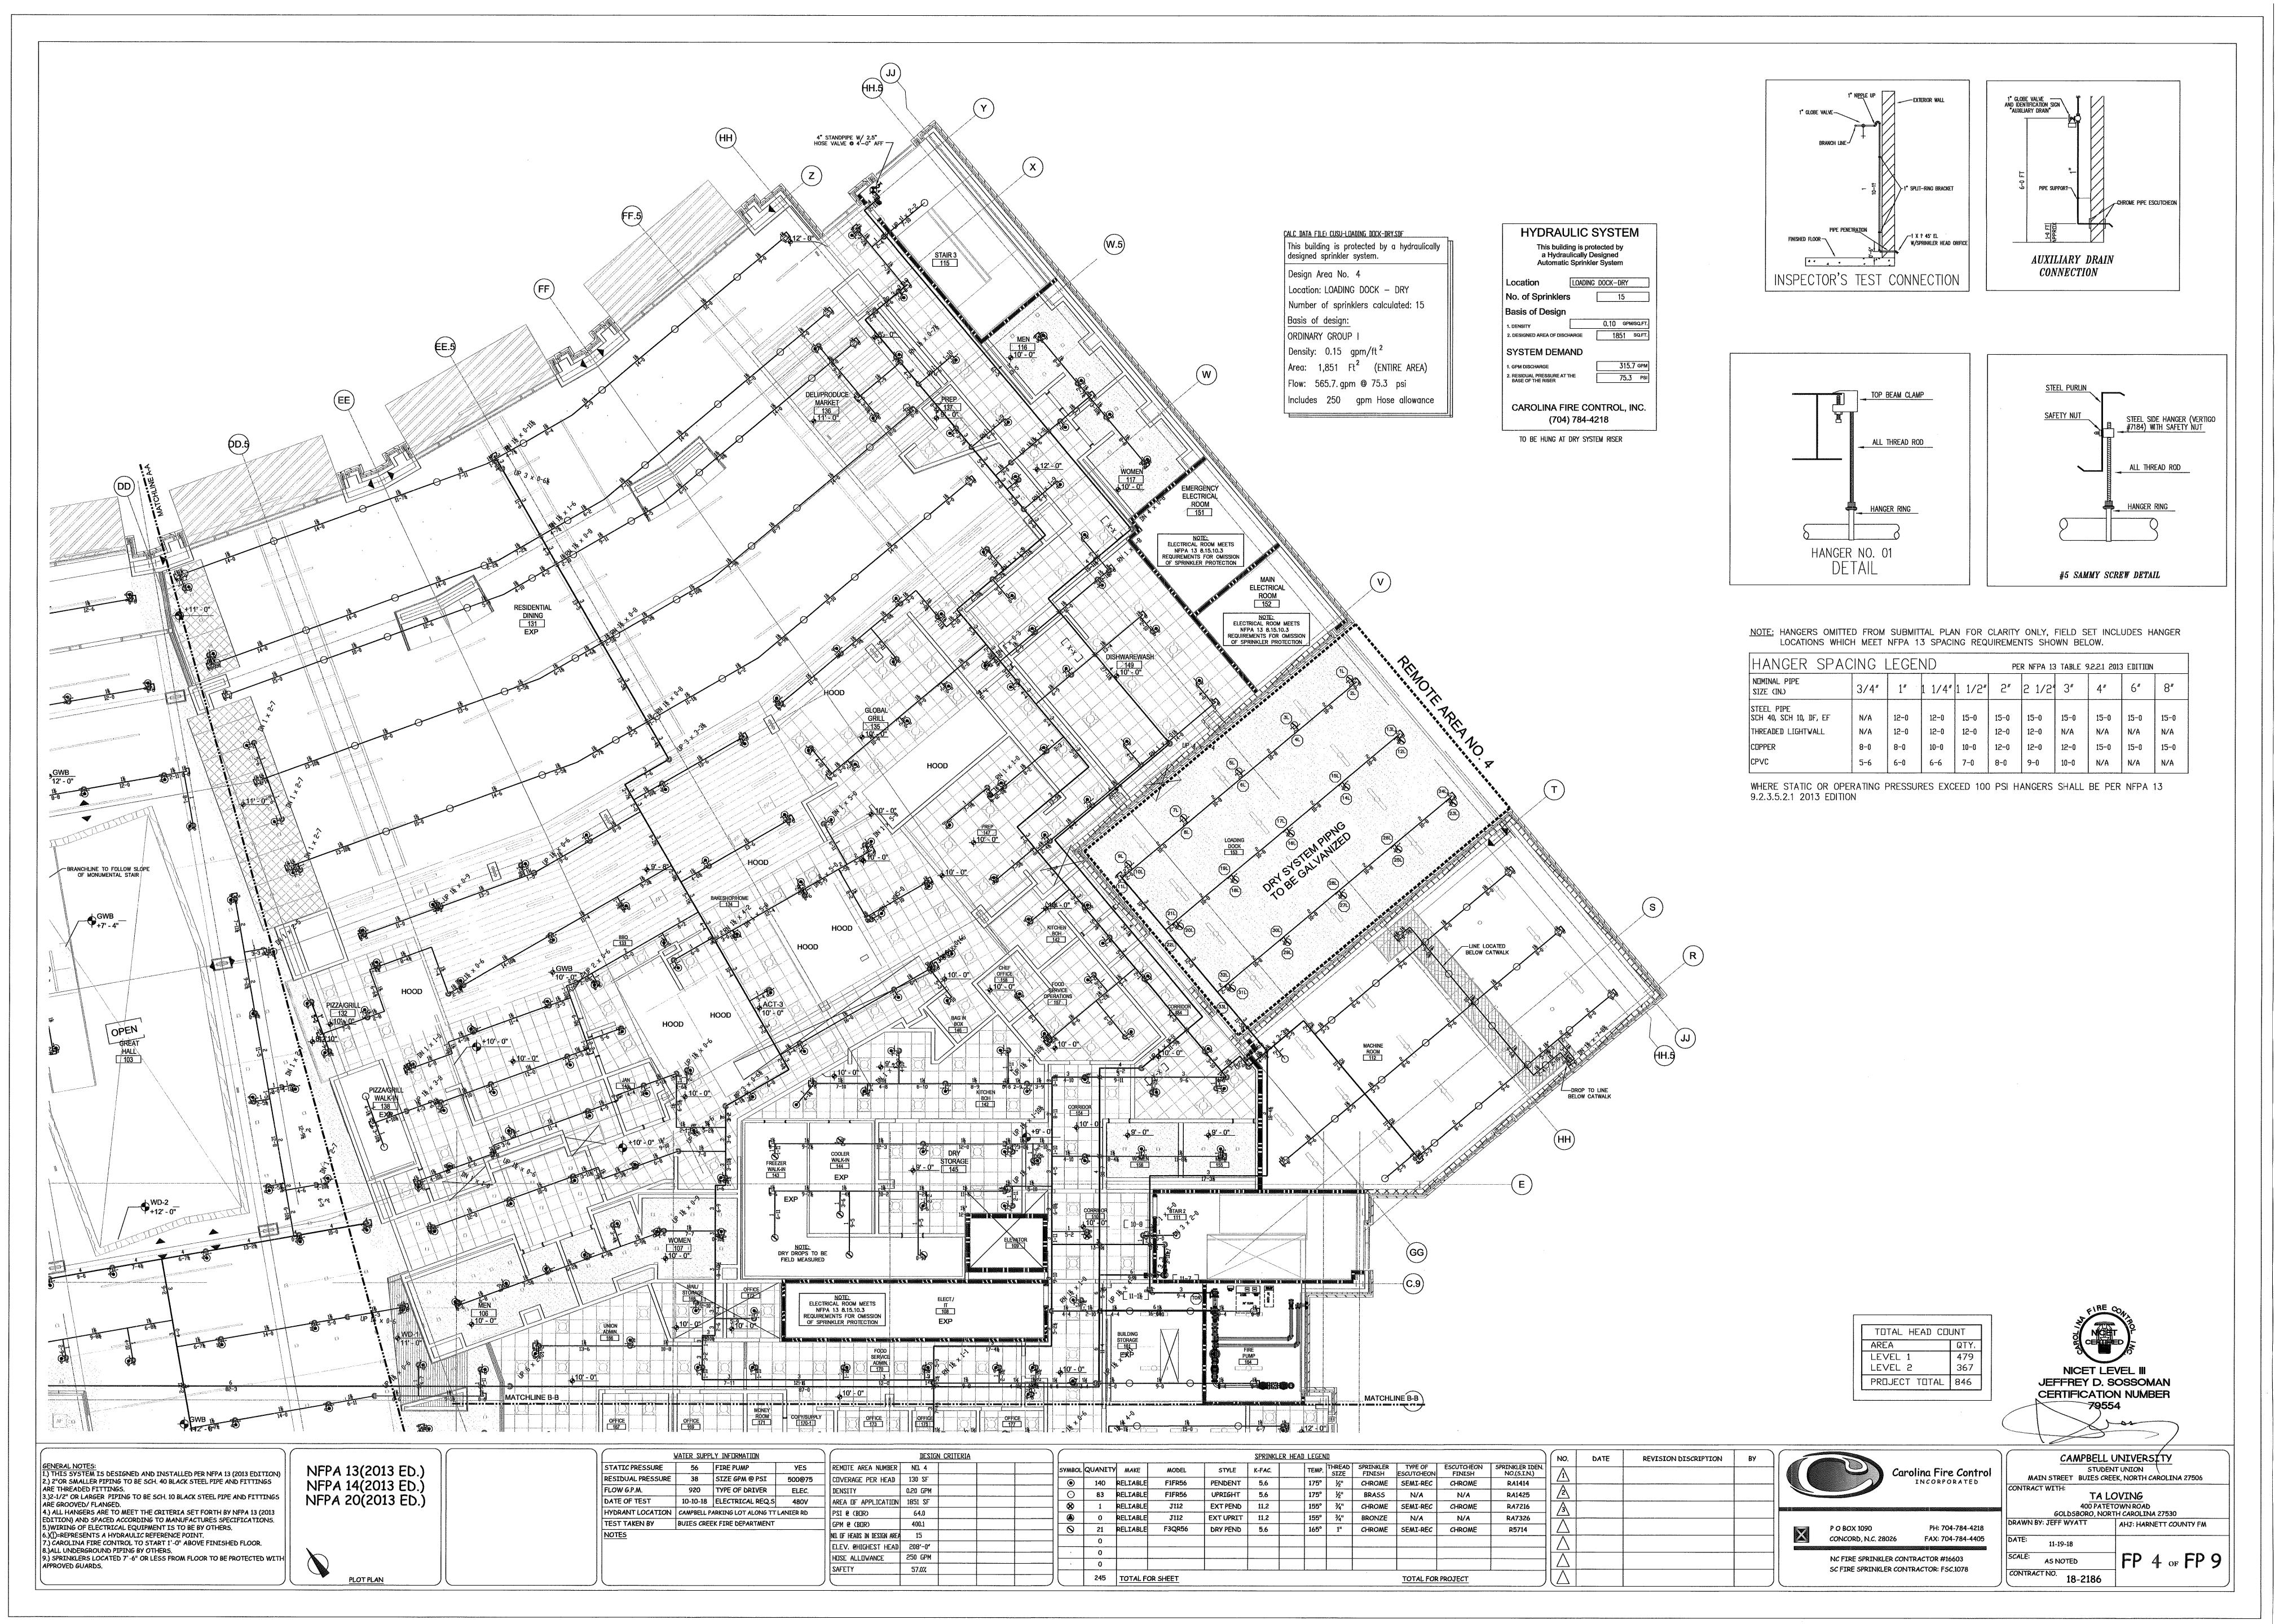


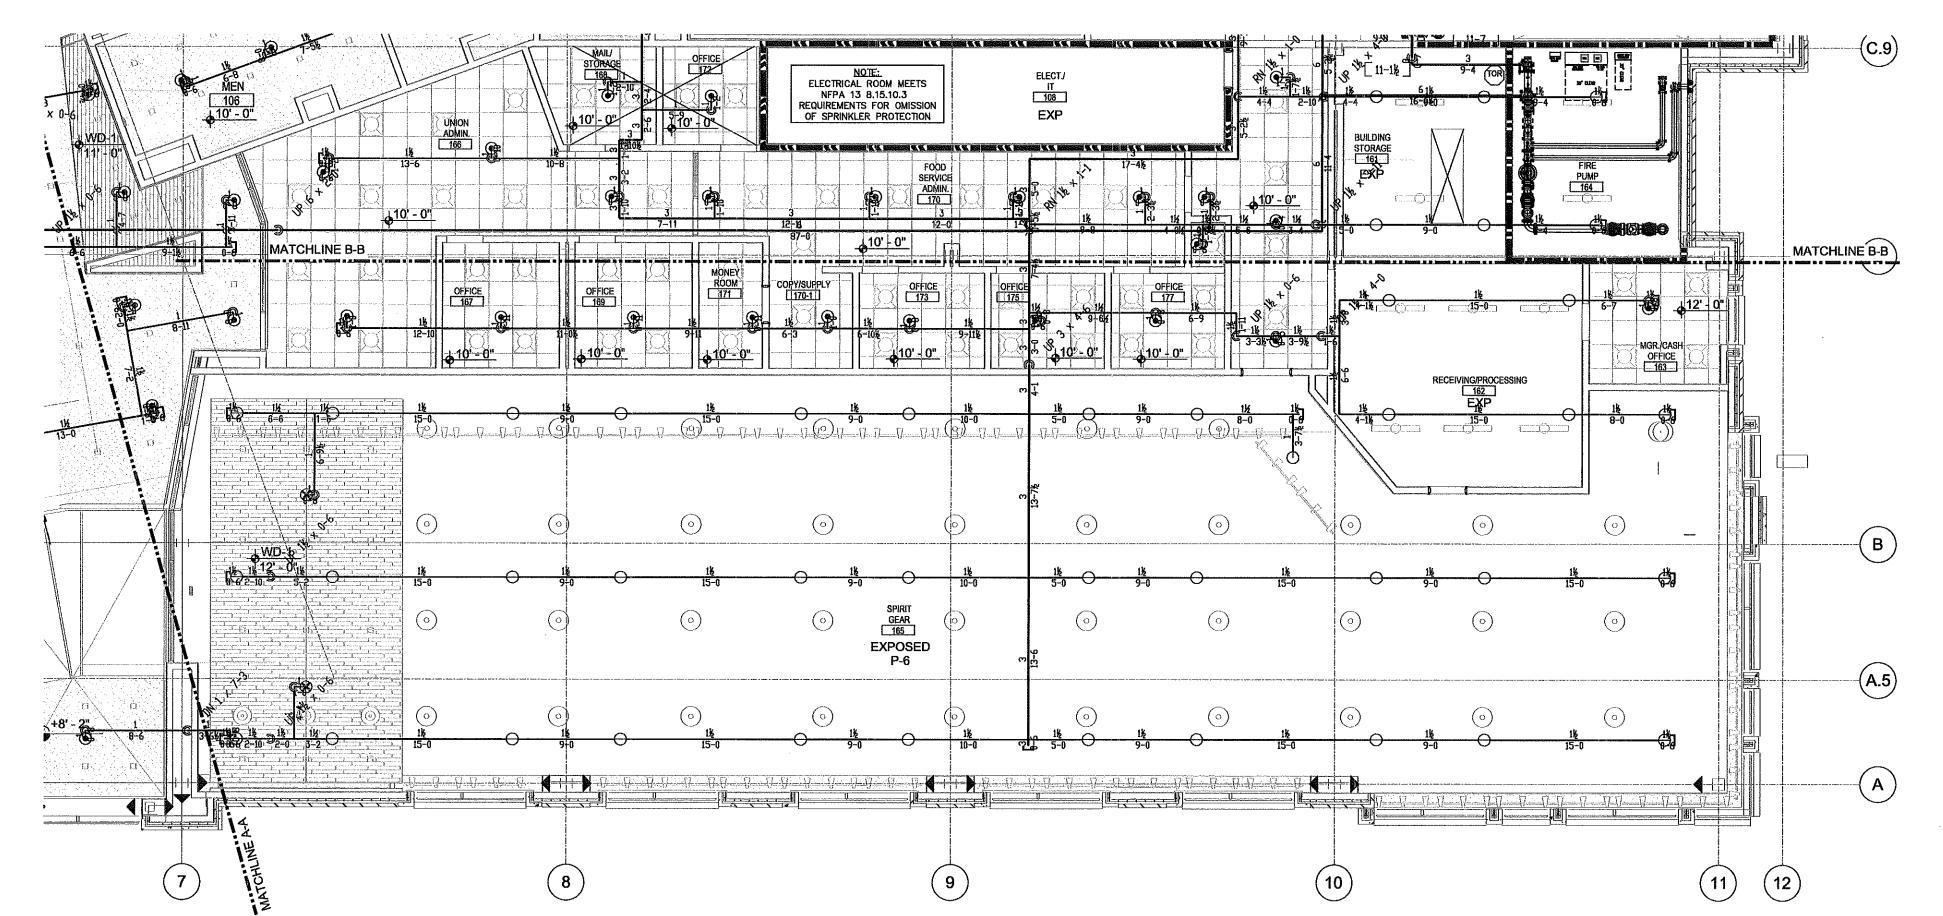



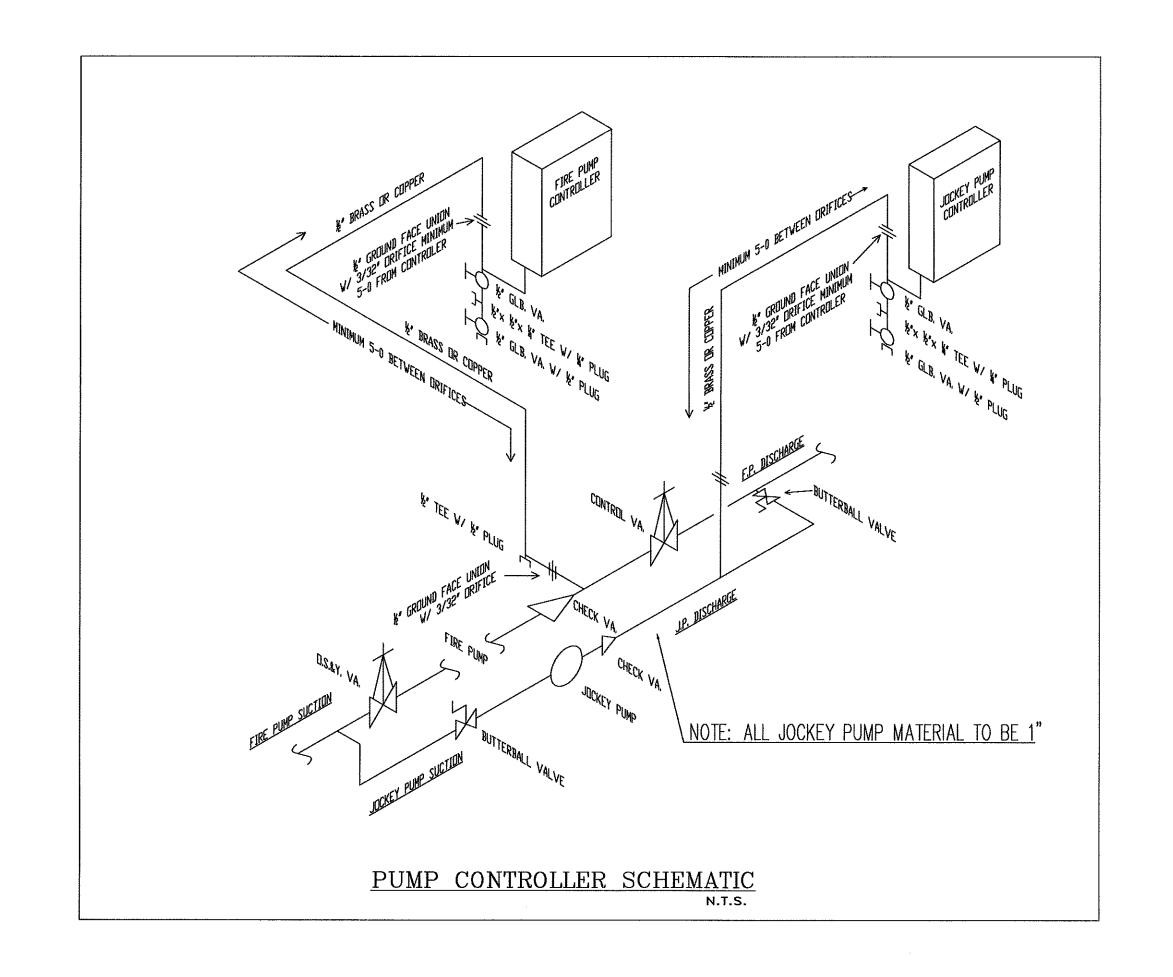


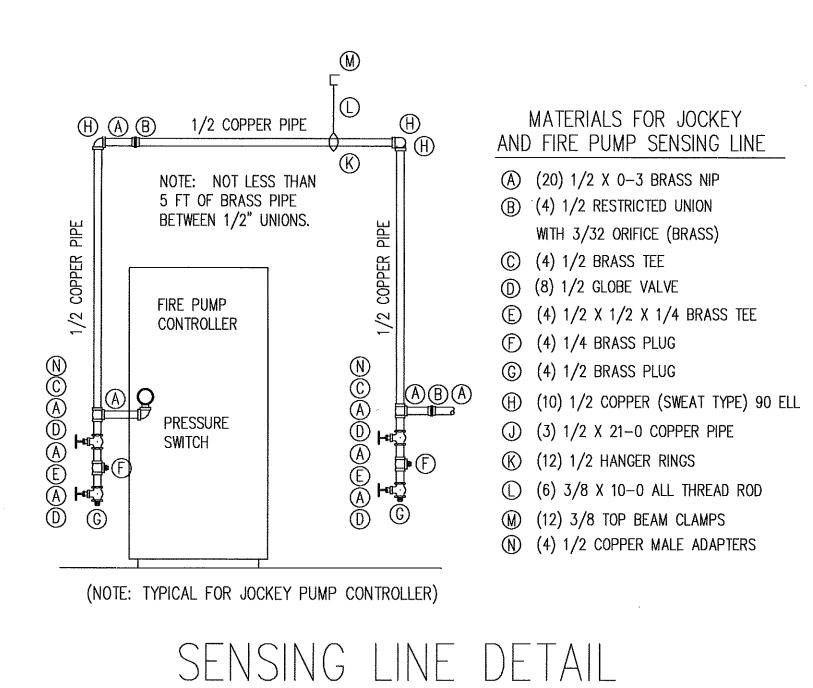

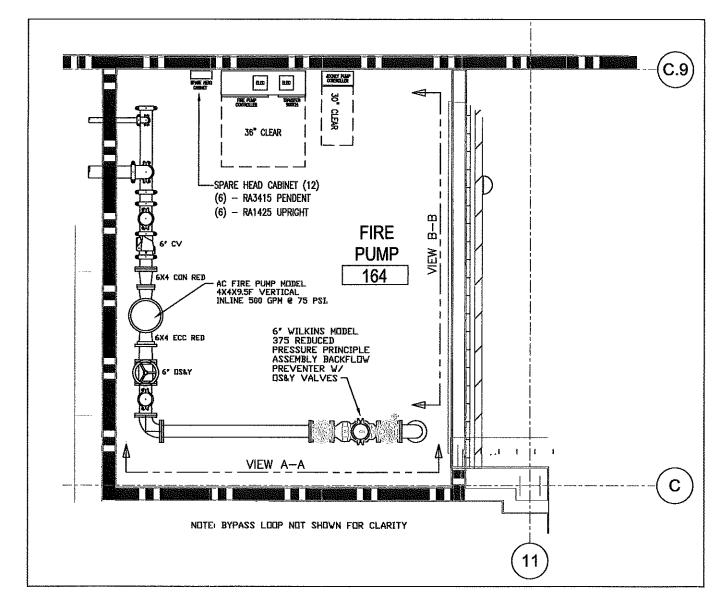


FIRE PUMP ROOM PLAN

SCALE: 1/4" = 1'-0"

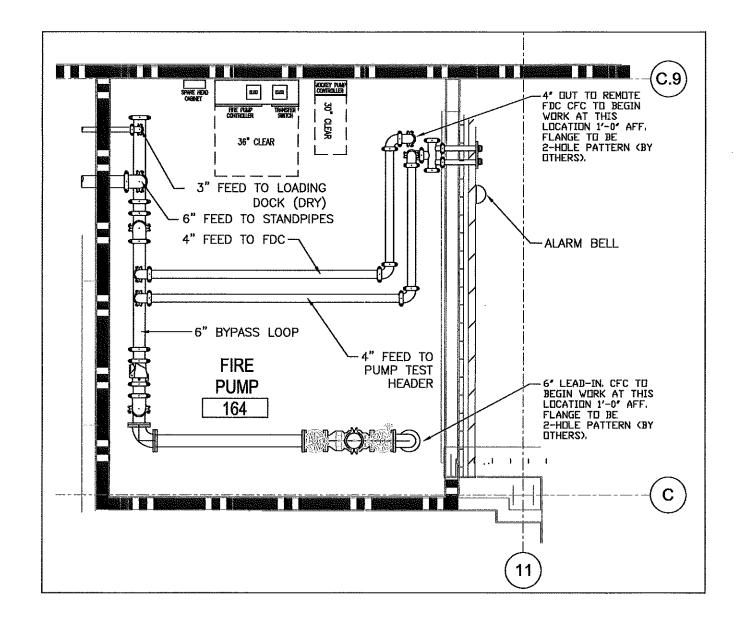


FIRE PUMP ROOM PLAN

SCALE: 1/4" = 1'-0"

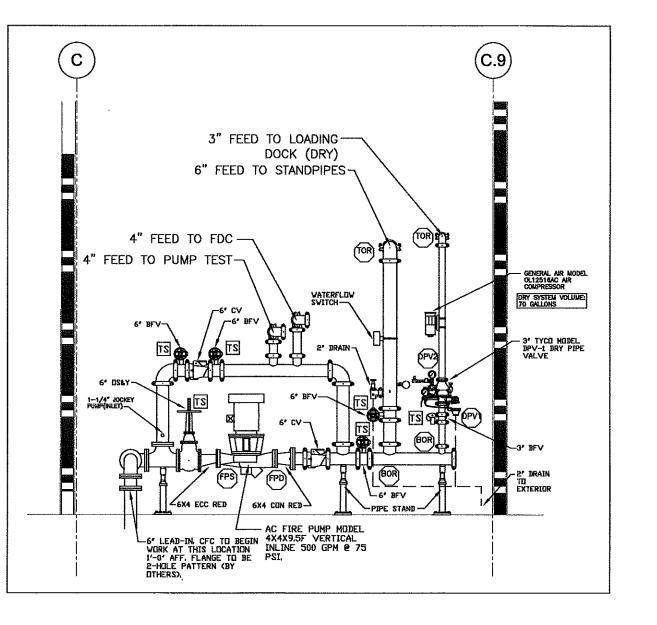


FIRE PUMP ELEVATION DETAIL

SCALE: 1/4" = 1'-0"

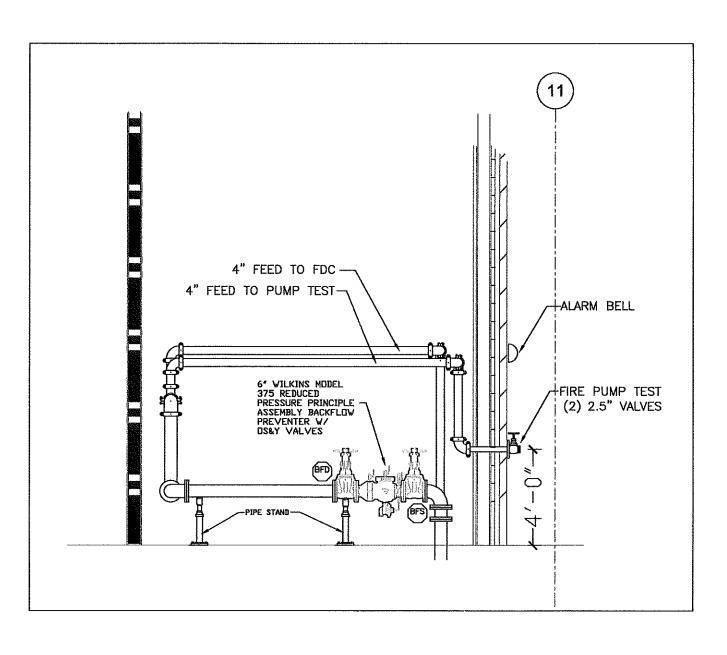


 $\frac{\text{VIEW } A - A}{\text{SCALE: } 1/4" = 1'-0"}$


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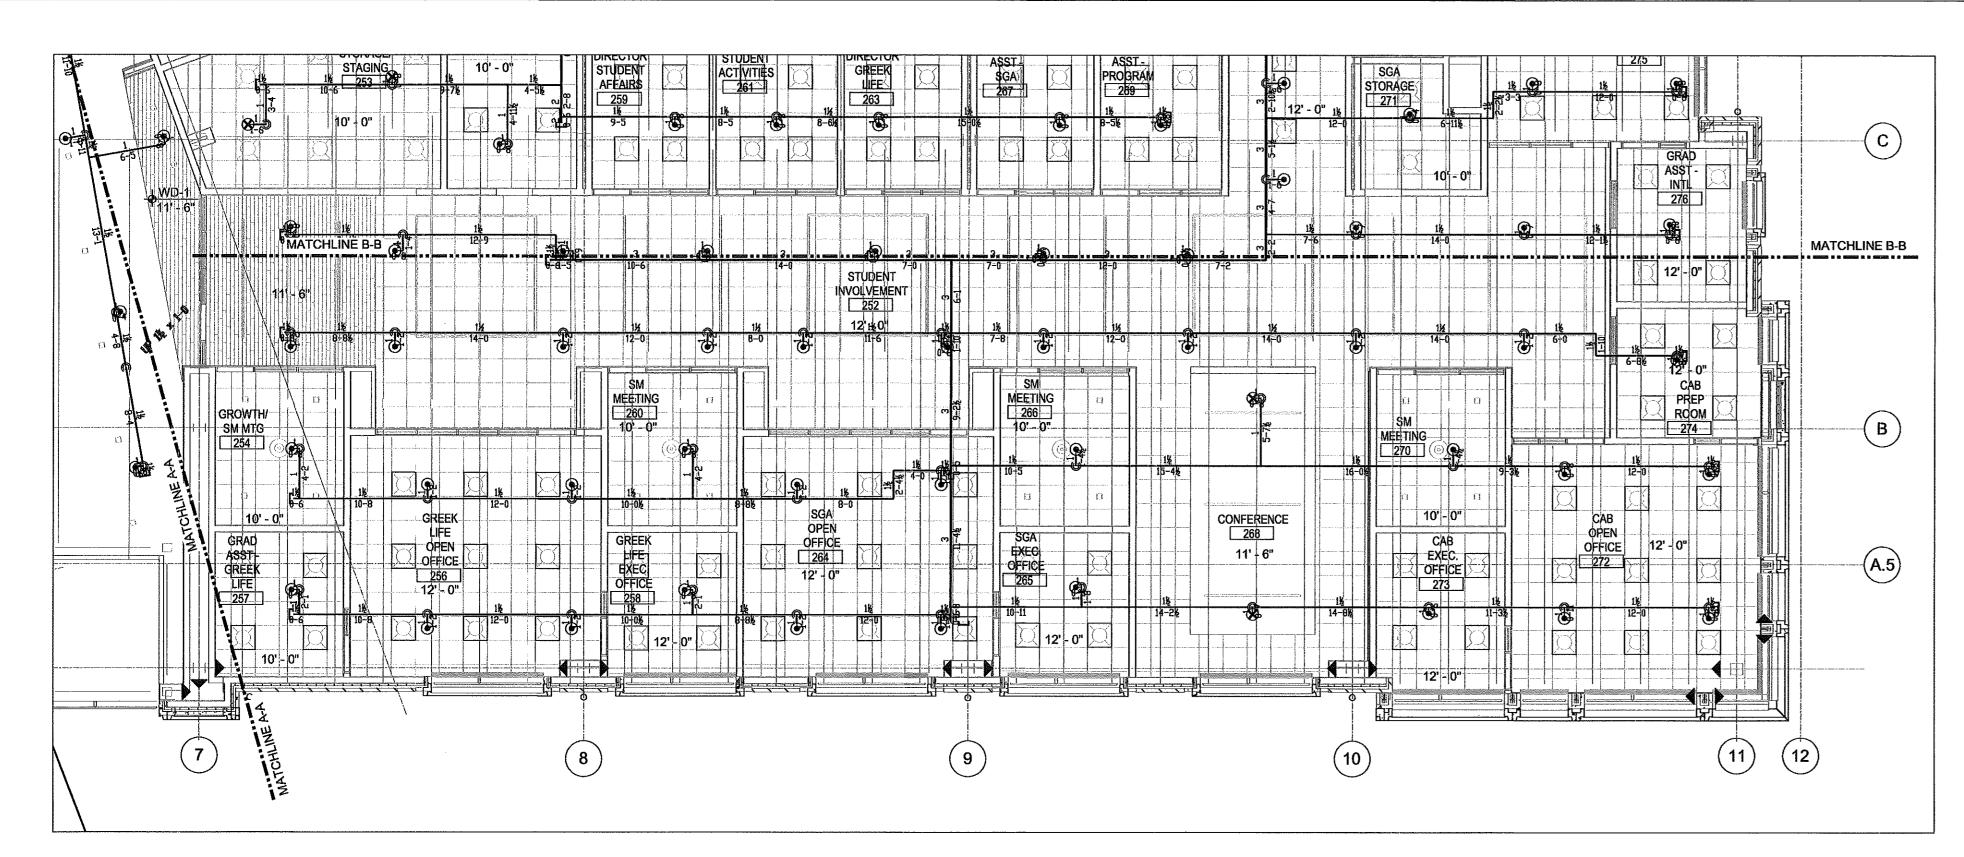


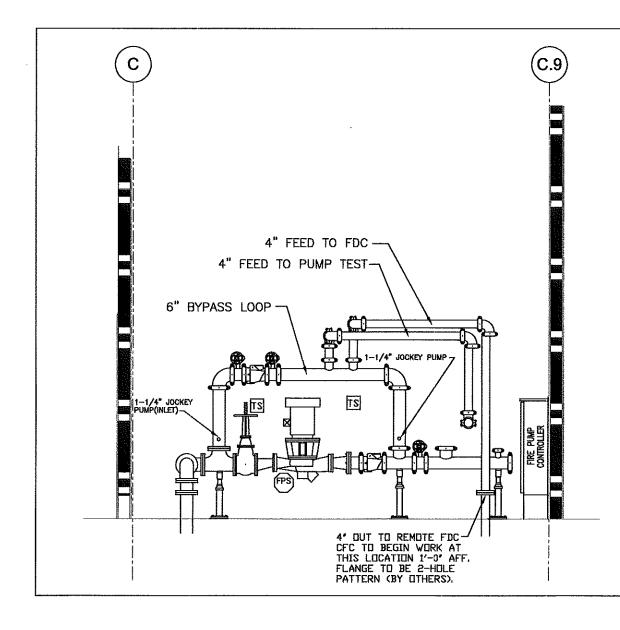NICET LEVEL III
JEFFREY D. SOSSOMAN
CERTIFICATION NUMBER
79554

		<u> </u>	ATER SUPPLY INFORMATION	***************************************	DESIGN CRITERIA			SPRINKLER	R HEAD LEGEND					NO. DATE	REVISION DISCRIPTION	ВУ			CAMPBEL	LL UNIVERSITY
GENERAL NOTES: 1.) THIS SYSTEM IS DESIGNED AND INSTALLED PER NFPA 13 (2013 EDITION)	NFPA 13(2013 ED.)	STATIC PRESSURE	56 FIRE PUMP	YES	REMOTE AREA NUMBER	SYMBOL QUANI	ITY MAKE	MODEL STYLE K-FAC.	TEMP. THRE	EAD SPRINKLER ZE FINISH	TYPE OF ESCUTCHEON	ESCUTCHEON FINISH	SPRINKLER IDEN. NO.(S.I.N.)	\wedge		+ $ -$		Carolina Fire Control	STUD	IDENT UNION CREEK, NORTH CAROLINA 27506
2.) 2"OR SMALLER PIPING TO BE SCH. 40 BLACK STEEL PIPE AND FITTINGS ARE THREADED FITTINGS.	NFPA 14(2013 ED.)	RESIDUAL PRESSURE FLOW G.P.M.	38 SIZE GPM @ PSI 920 TYPE OF DRIVER	500@75 ELEC.	COVERAGE PER HEAD DENSITY	11	RELIABL	LE F1FR56 PENDENT 5.6	175° ½	" CHROME	SEMI-REC	CHROME	RA1414	<u> </u>		+		INCORPORATED	CONTRACT WITH:	
3.)2-1/2" OR LARGER PIPING TO BE SCH. 10 BLACK STEEL PIPE AND FITTINGS ARE GROOVED/ FLANGED.	NFPA 20(2013 ED.)	DATE OF TEST	10-10-18 ELECTRICAL REQ.S	5 480V	AREA OF APPLICATION	SQ 2	RELIABL	LE J112 EXT PEND 11.2	175° ½	" BRASS " CHROME	N/A SEMI-REC	N/A CHROME	RA1425 RA7216	<u> </u>					11	A LOVING ATETOWN ROAD
4.) ALL HANGERS ARE TO MEET THE CRITERIA SET FORTH BY NFPA 13 (2013 EDITION) AND SPACED ACCORDING TO MANUFACTURES SPECIFICATIONS.		HYDRANT LOCATION TEST TAKEN BY	CAMPBELL PARKING LOT ALONG T BUIES CREEK FIRE DEPARTMENT		PSI @ (BDR)	a 0	RELIABL	LE J112 EXTUPRIT 11.2	155° ¾	" BRONZE	N/A	N/A	RA7326	/3\					GOLDSBORO, NO	NORTH CAROLINA 27530
5.)WIRING OF ELECTRICAL EQUIPMENT IS TO BE BY OTHERS. 6.XT)=REPRESENTS A HYDRAULIC REFERENCE POINT.		NOTES	POTES CKECK LIKE DELYK IWEIN	<u> </u>	GPM @ (BCIR) NO. OF HEADS IN DESIGN AREA	0 0	RELIABL	LE F3QR56 DRY PEND 5.6	165° 1'	" CHROME	SEMI-REC	CHROME	R5714	\triangle			P O BOX 1090	PH: 704-784-4218 026 FAX: 704-784-4405	DAAWIY BY JETT WYATT	AHJ: HARNETT COUNTY FM
7.) CAROLINA FIRE CONTROL TO START 1'-0" ABOVE FINISHED FLOOR. 8.)ALL UNDERGROUND PIPING BY OTHERS.					ELEV. @HIGHEST HEAD										THE COLUMN TO TH	Sanza	CONCORD, N.C. 280	U26 FAX: 704-784-4405	DATE: 11-19-18	
9.) SPRINKLERS LOCATED 7'-6" OR LESS FROM FLOOR TO BE PROTECTED WITH APPROVED GUARDS.					INSIDED HOSE	. 0								\triangle				ER CONTRACTOR #16603	SCALE: AS NOTED	FP 5 of FP 9
	PLOT PLAN				SAFFTY SAFFTY	49	TOTAL	FOR SHEET			TOTAL FO	DR PROJECT		\wedge			SC FIRE SPRINKLE	R CONTRACTOR: FSC,1078	CONTRACT NO. 18-2186	,




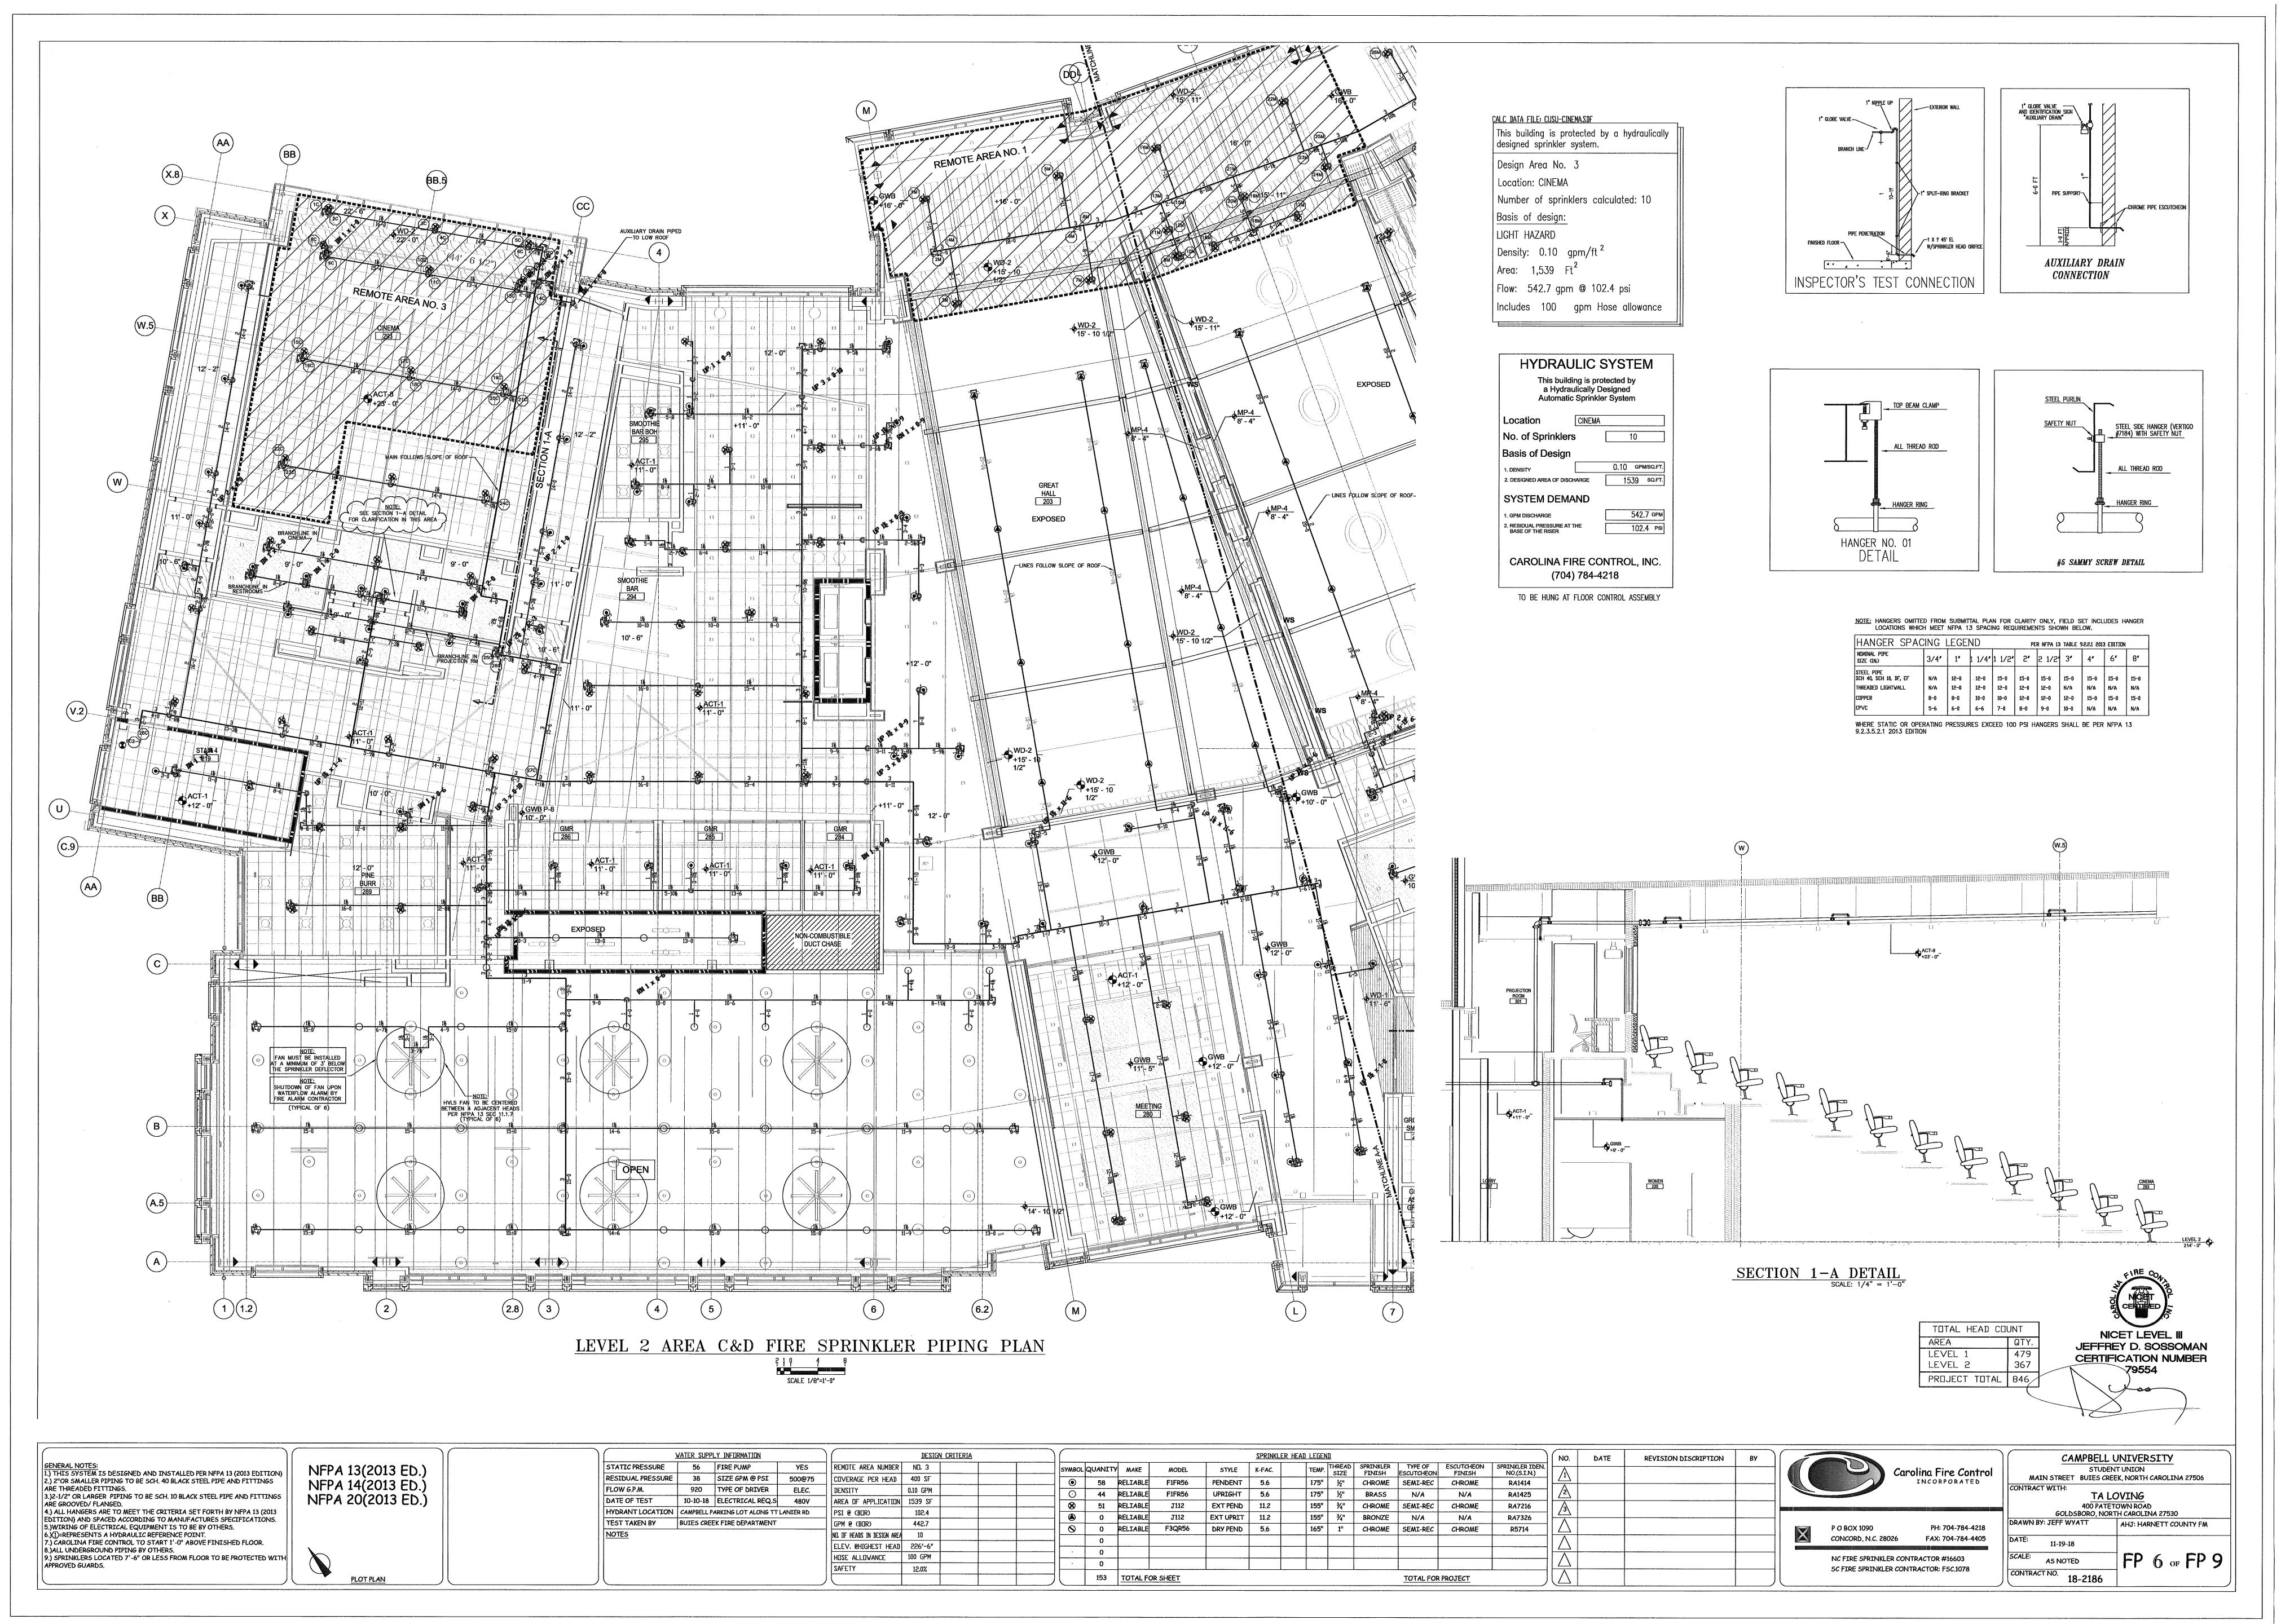

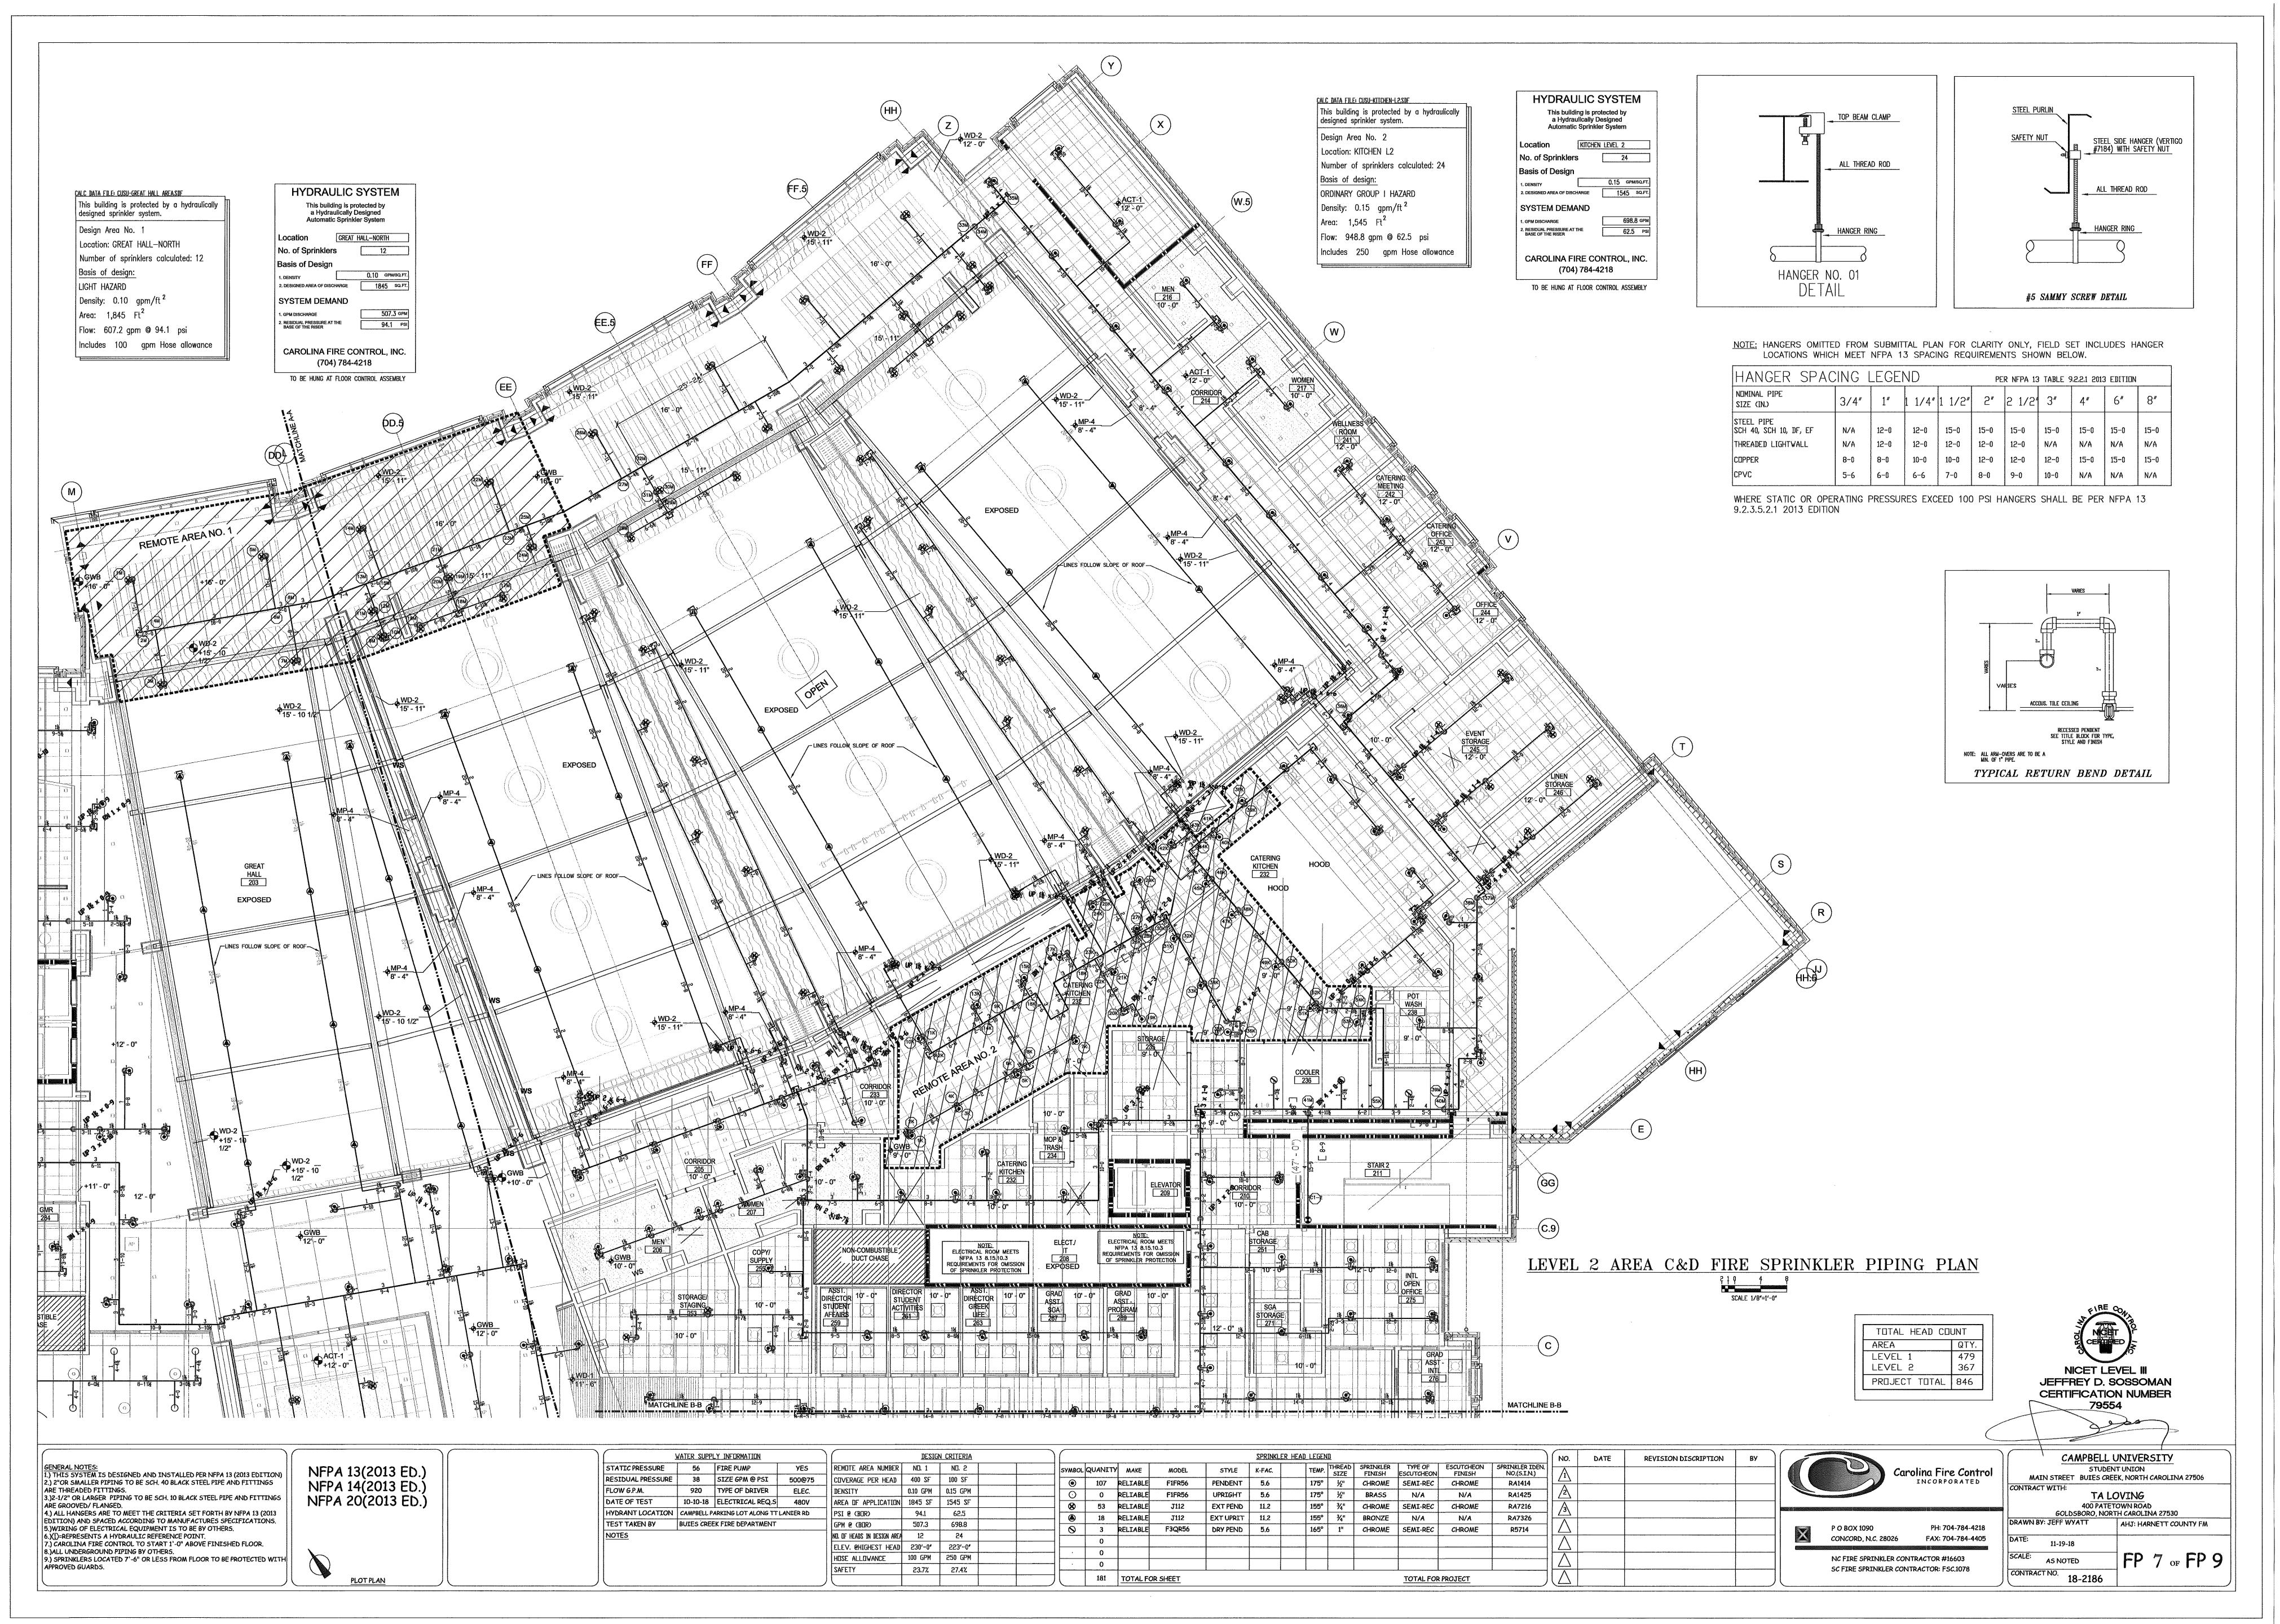

LEVEL 2 AREA C&D FIRE SPRINKLER PIPING CON'T

	—
TOTAL HEAD CO	UNI
AREA	QTY.
LEVEL 1	479
TEAET 5	367
PROJECT TOTAL	846

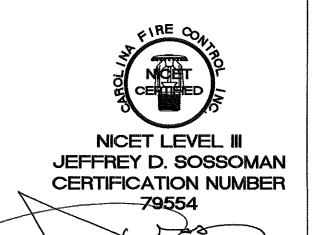

GENERAL NOTES:			
1.) THIS SYSTEM IS D	ESIGNED AND INSTA	ALLED PER NFPA 13 (2	(013 EDITION)
2.) 2"OR SMALLER PIP	ING TO BE SCH. 40 BL	ACK STEEL PIPE AND	FITTINGS
ARE THREADED FITTI	NGS,		
3.)2-1/2" OR LARGER 1	IPING TO BE SCH. 10	BLACK STEEL PIPE A	ND FITTINGS
ARE GROOVED/ FLANG	ED.		
4.) ALL HANGERS ARE	TO MEET THE CRITER	RIA SET FORTH BY N	FPA 13 (2013
EDITION) AND SPACE	D ACCORDING TO MA	NUFACTURES SPECI	FICATIONS.
5.)WIRING OF ELECTR	ICAL EQUIPMENT IS	TO BE BY OTHERS.	
6.XT)=REPRESENTS A I	IYDRAULIC REFERENCE	E POINT.	
7.) CAROLINA FIRE CO	NTROL TO START 1'-	O" ABOVE FINISHED	FLOOR.
8.) ALL UNDERGROUND	PIPING BY OTHERS.		
9.) SPRINKLERS LOCA	TED 7'-6" OR LESS FR	OM FLOOR TO BE PRO	OTECTED WITH

NFPA 13(2013 ED.) NFPA 14(2013 ED.) NFPA 20(2013 ED.)

PLOT PLAN

WATER SUPPLY INFORMATION

STATIC PRESSURE 56 FIRE PUMP YES

RESIDUAL PRESSURE 38 SIZE GPM @ PSI 500@75

FLOW G.P.M. 920 TYPE OF DRIVER ELEC.

DATE OF TEST 10-10-18 ELECTRICAL REQ.S 480V

HYDRANT LOCATION CAMPBELL PARKING LOT ALONG TT LANIER RD

TEST TAKEN BY BUIES CREEK FIRE DEPARTMENT

REMOTE AREA NUMBER

COVERAGE PER HEAD

DENSITY

AREA OF APPLICATION

PSI @ (BOR)

GPM @ (BOR)

NO. OF HEADS IN DESIGN AREA

ELEV. @HIGHEST HEAD

INSIDED HOSE

DUTSIDE HOSE

SAFETY

(A)

DESIGN CRITERIA

					SPRINKL	ER HEAD	LEGEN	<u>D</u>)	NO.	DATE	REVISION DISCRIPTION	E
L	QUANITY	MAKE	WODEL	STYLE	K-FAC.		TEMP.	THREAD SIZE	SPRINKLER FINISH	TYPE OF ESCUTCHEON	ESCUTCHEON FINISH	SPRINKLER IDEN. NO.(S.I.N.)	1			
	31	RELIABLE	F1FR56	PENDENT	5.6	Lucia	175°	1/2"	CHROME	SEMI-REC	CHROME	RA1414	__\			
	0	RELIABLE	F1FR56	UPRIGHT	5.6		175°	1/2"	BRASS	N/A	N/A	RA1425	2			
	2	RELIABLE	J112	EXT PEND	11.2		155°	3/411	CHROME	SEMI-REC	CHROME	RA7216	3			T
	0	RELIABLE	J112	EXT UPRIT	11.2		155°	3/4"	BRONZE	N/A	N/A	RA7326	1/3/			<u> </u>
	0	RELIABLE	F3QR56	DRY PEND	5.6		165°	1"	CHROME	SEMI-REC	CHROME	R5714				
	0												\wedge			
	0	TA T				-										-
	0															
	33	TOTAL FO	OR SHEET	•		· · · · · · · · · · · · · · · · · · ·		1		TOTAL FOR	PROJECT	·				



Carolina Fire Control

P O BOX 1090 PH: 704-784-4218
CONCORD, N.C. 28026 FAX: 704-784-4405

NC FIRE SPRINKLER CONTRACTOR #16603

SC FIRE SPRINKLER CONTRACTOR: FSC.1078

CAMPBELL UNIVERSITY

STUDENT UNION

MAIN STREET BUIES CREEK, NORTH CAROLINA 27506

CONTRACT WITH:

TA LOVING

400 PATETOWN ROAD

GOLDSBORO, NORTH CAROLINA 27530

400 PATETOWN ROAD
GOLDSBORO, NORTH CAROLINA 27530


DRAWN BY: JEFF WYATT


AHJ: HARNETT COUNTY FM


DATE:
11-19-18


SCALE: AS NOTED

CONTRACT NO.
18-2186

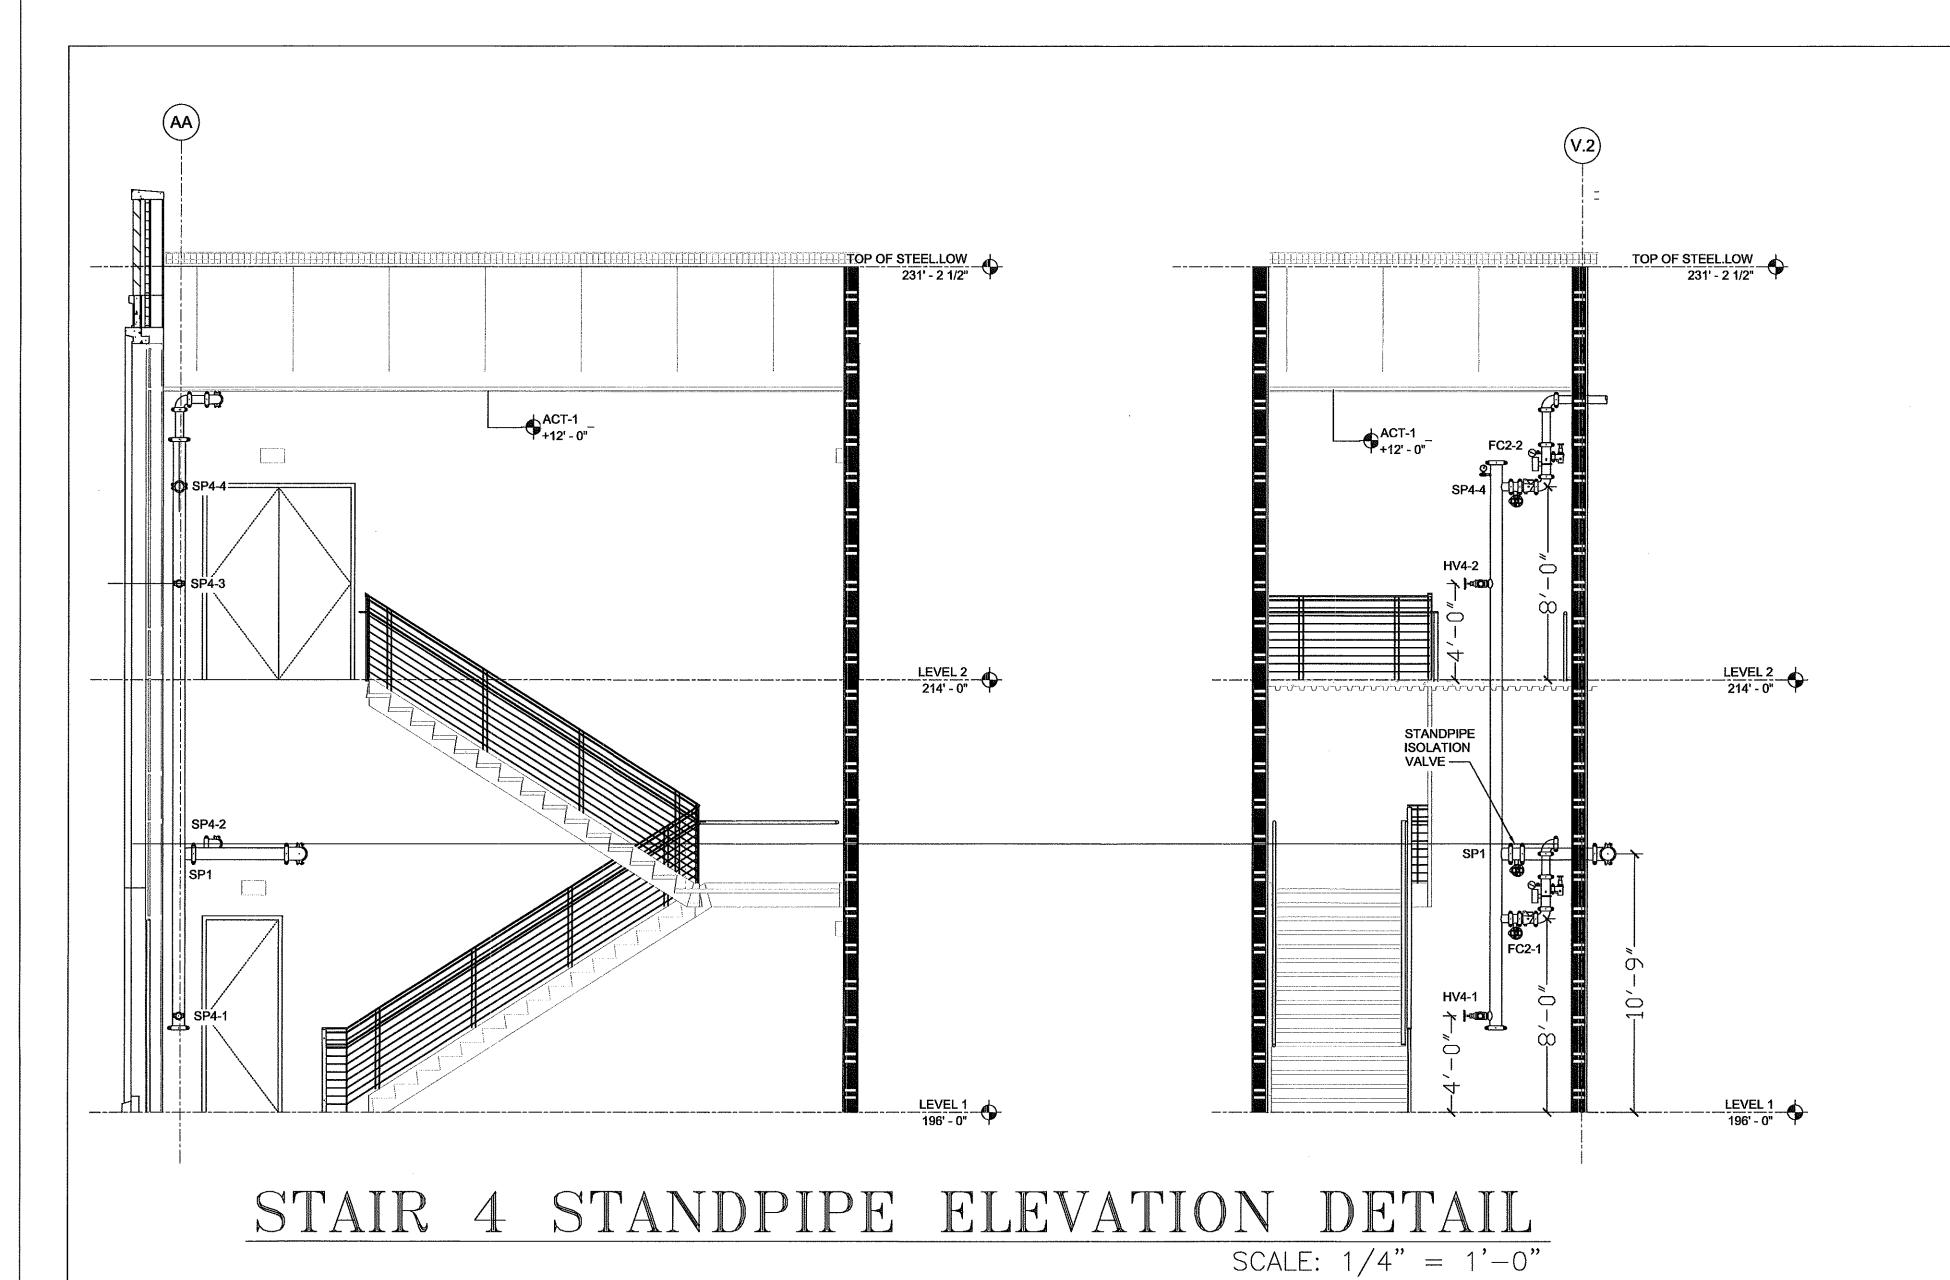

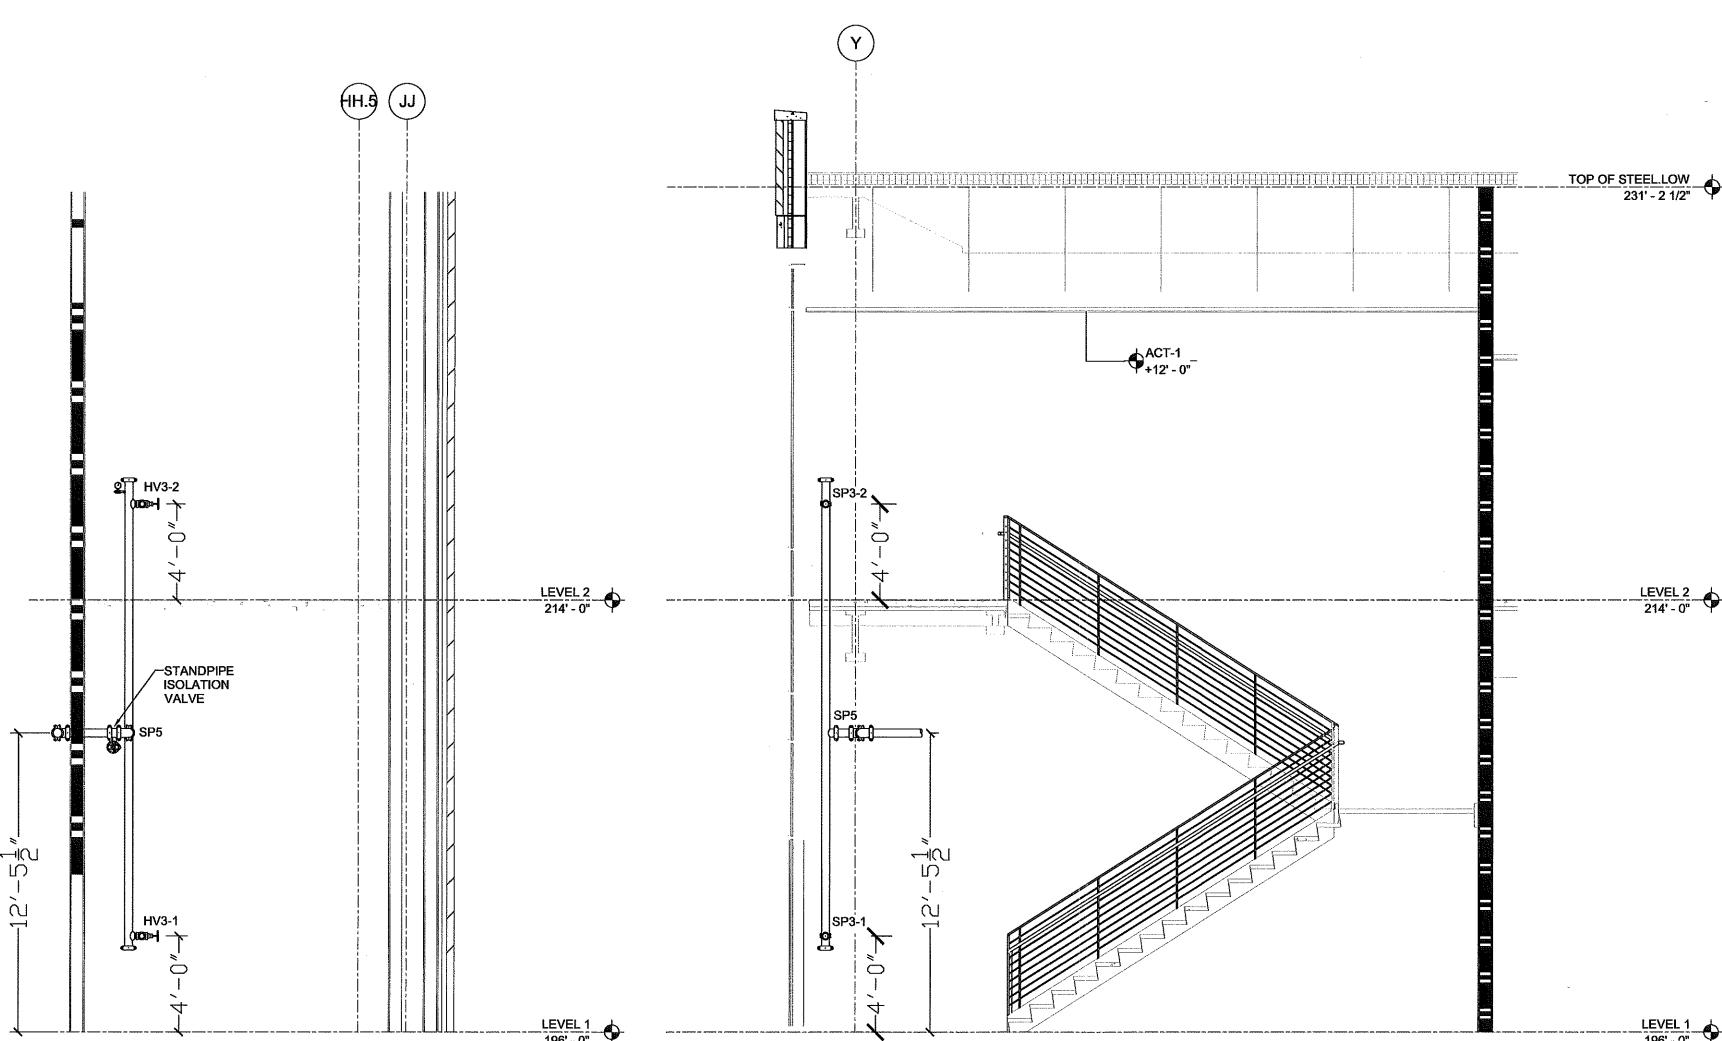

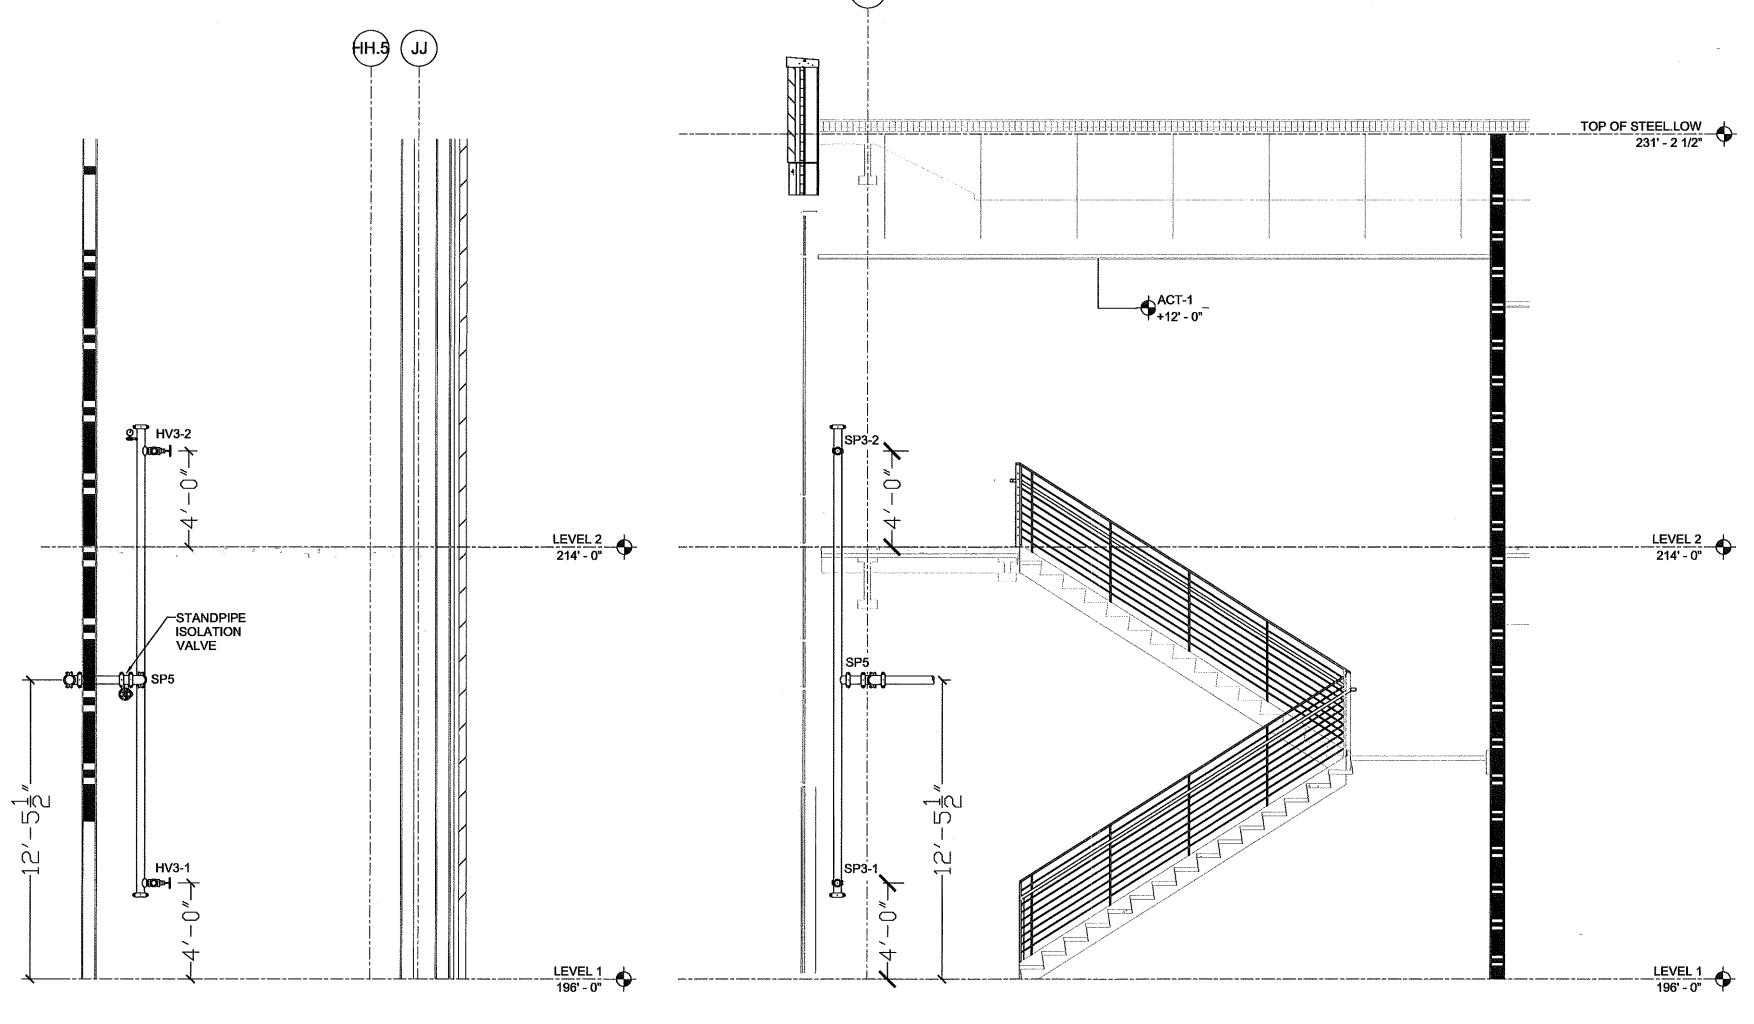

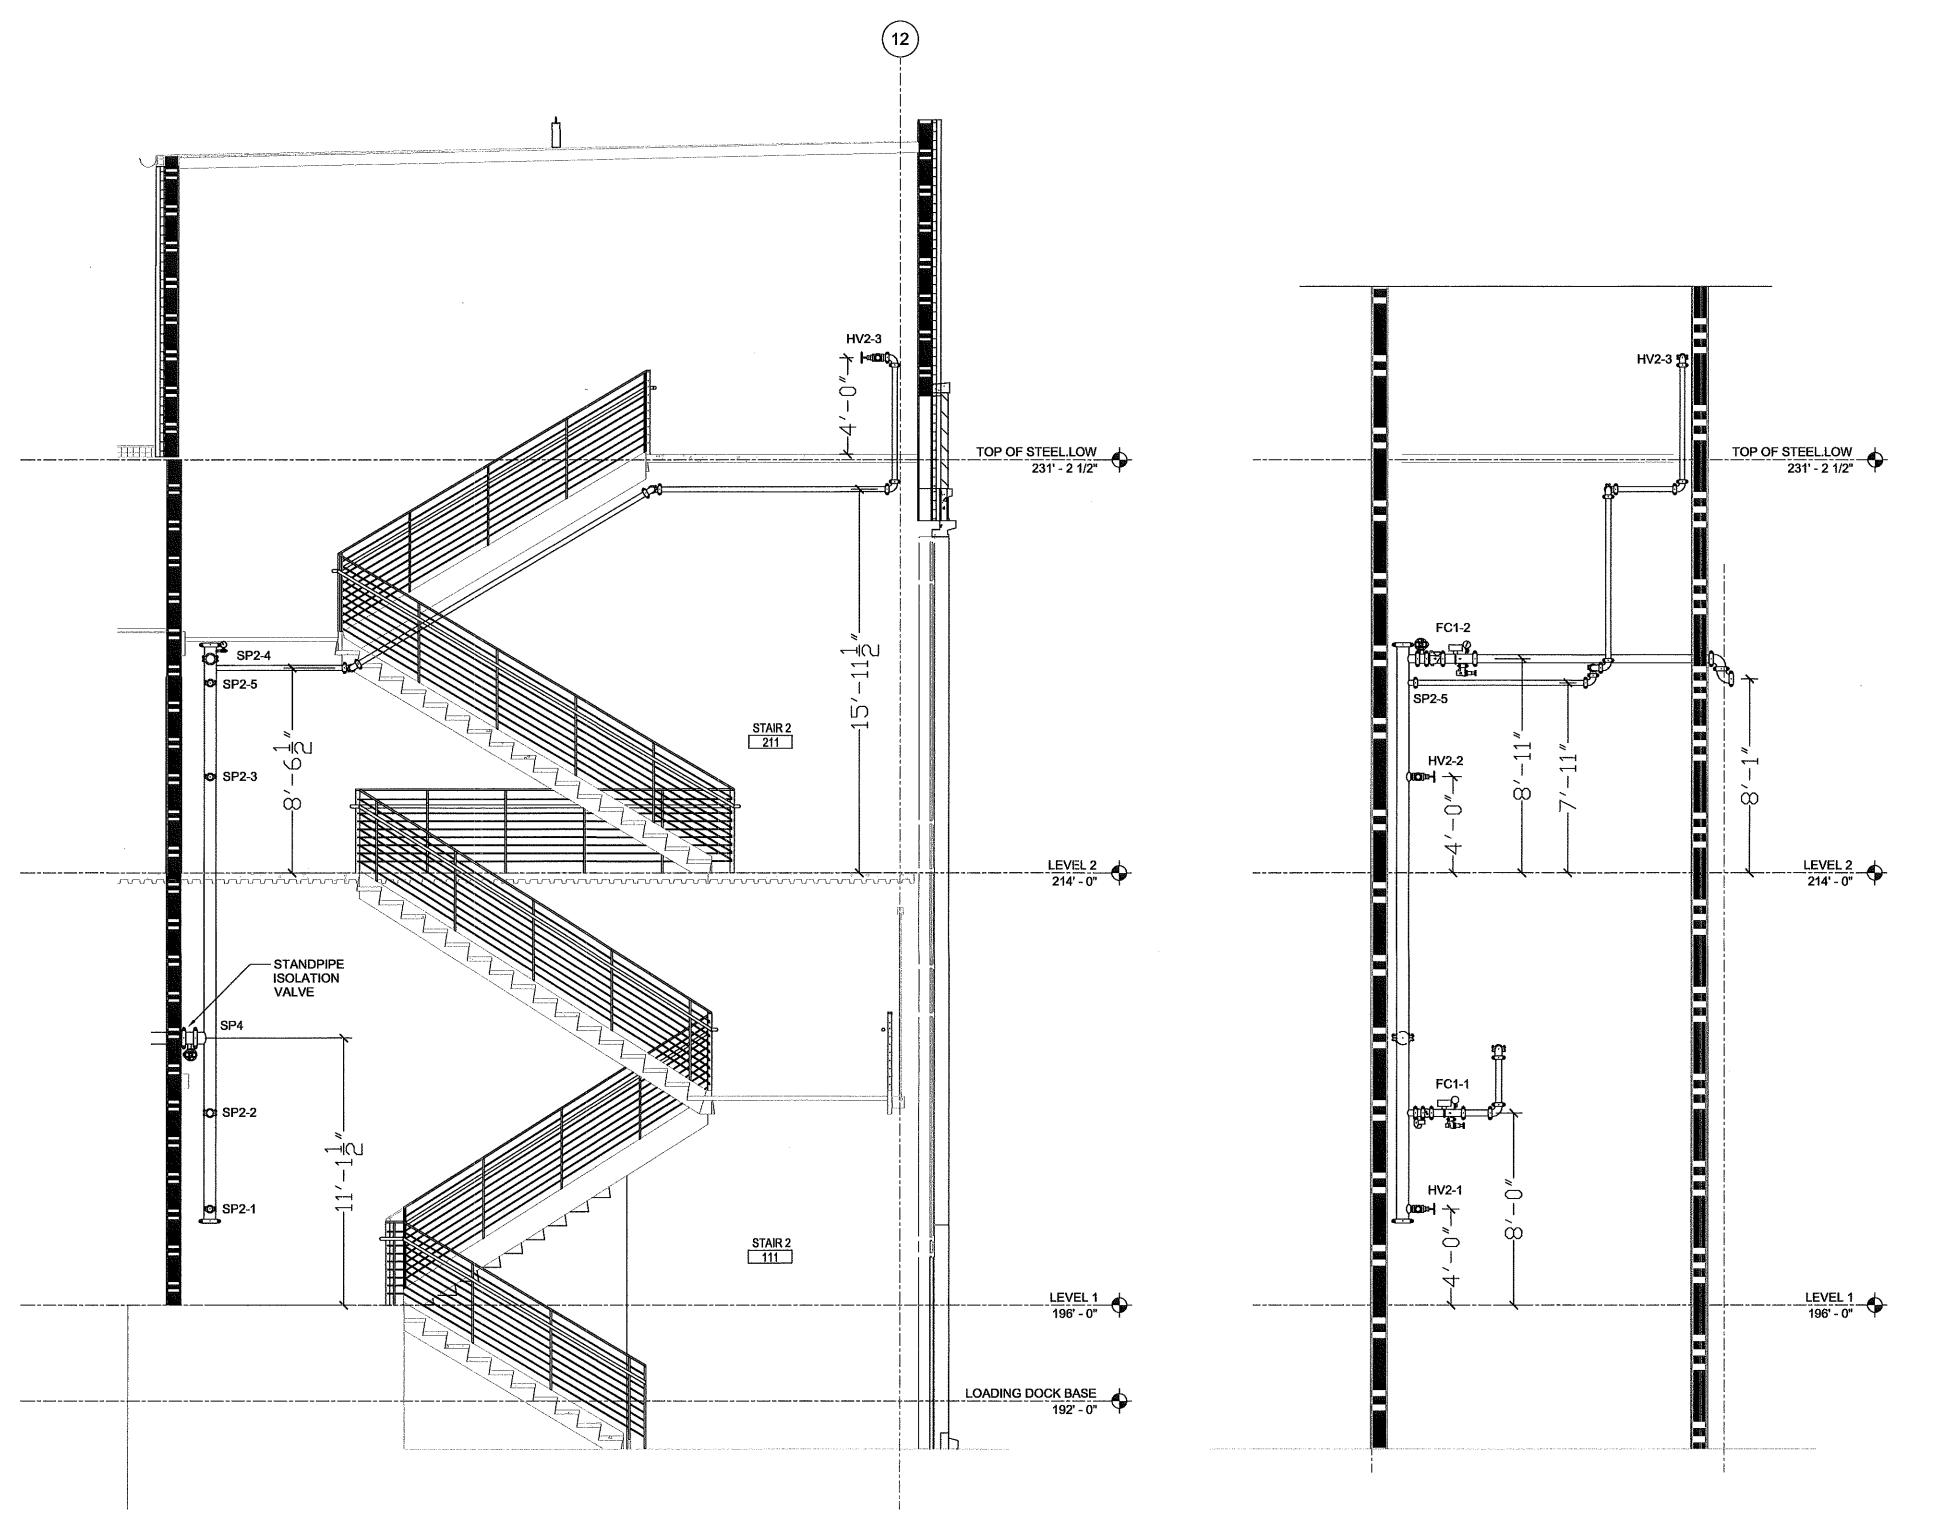


STAIR 2 STANDPIPE ELEVATION DETAIL

SCALE: 1/4" = 1'-0"



SCALE: 1/4" = 1'-0"

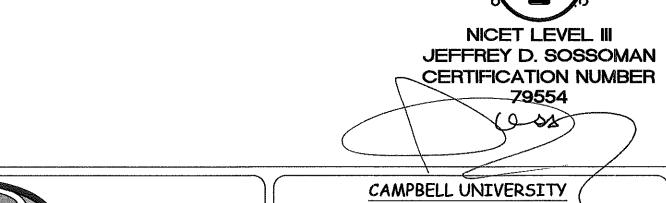

GENERAL NOTES:
1.) THIS SYSTEM IS DESIGNED AND INSTALLED PER NFPA 13 (2013 EDITION)
2.) 2"OR SMALLER PIPING TO BE SCH. 40 BLACK STEEL PIPE AND FITTINGS 3.)2-1/2" OR LARGER PIPING TO BE SCH. 10 BLACK STEEL PIPE AND FITTINGS ARE GROOVED/ FLANGED. 4.) ALL HANGERS ARE TO MEET THE CRITERIA SET FORTH BY NFPA 13 (2013 EDITION) AND SPACED ACCORDING TO MANUFACTURES SPECIFICATIONS. 5.) WIRING OF ELECTRICAL EQUIPMENT IS TO BE BY OTHERS. 6.X1)=REPRESENTS A HYDRAULIC REFERENCE POINT.
7.) CAROLINA FIRE CONTROL TO START 1'-0" ABOVE FINISHED FLOOR. 8.) ALL UNDERGROUND PIPING BY OTHERS. 9.) SPRINKLERS LOCATED 7'-6" OR LESS FROM FLOOR TO BE PROTECTED WITH

NFPA 13(2013 ED.) NFPA 14(2013 ED.) NFPA 20(2013 ED.)

PLOT PLAN

	WATER SUPP	LY INFORMATION	`		DESIGN	CRITERIA	
STATIC PRESSURE	56	FIRE PUMP	УES	REMOTE AREA NUMBER			
RESIDUAL PRESSURE	38	SIZE GPM @ PSI	500@75	COVERAGE PER HEAD			
FLOW G.P.M.	920	TYPE OF DRIVER	ELEC.	DENSITY			
DATE OF TEST	10-10-18	ELECTRICAL REQ.S	480V	AREA OF APPLICATION			
HYDRANT LOCATION	CAMPBELL P	ARKING LOT ALONG TT	LANIER RD	PSI @ (BDR)			
TEST TAKEN BY	BUTES CREE	EK FIRE DEPARTMENT		GPM @ (BOR)			
NOTES				NO. OF HEADS IN DESIGN AREA			
				ELEV. @HIGHEST HEAD			
				INSIDED HOSE			
				OUTSIDE HOSE			
				SAFETY			

					<u>SPRINKL</u>	er head lege	<u>ND</u>					1
SYMBOL	QUANITY	MAKE	MODEL	STYLE	K-FAC,	TEMP	THREAD	SPRINKLER FINISH	TYPE OF ESCUTCHEON	ESCUTCHEON FINISH	SPRINKLER IDEN. NO.(S.I.N.)	
•	0	RELIABLE	F1FR56	PENDENT	5.6	175°	1/2"	CHROME	SEMI-REC	CHROME	RA1414	
0	0	RELIABLE	F1FR56	UPRIGHT	5.6	175°	1/2"	BRASS	N/A	N/A	RA1425	1
8	0	RELIABLE	J112	EXT PEND	11,2	155°	3/4"	CHROME	SEMI-REC	CHROME	RA7216	1
(A)	0	RELIABLE	J112	EXT UPRIT	11.2	155°	3/4"	BRONZE	N/A	N/A	RA7326	1
0	0	RELIABLE	F3QR56	DRY PEND	5.6	165°	1"	CHROME	SEMI-REC	CHROME	R5714	1
	0											1
,	0											1
	0											Ī
	0	TOTAL FO	R SHEET						TOTAL FOR	PROJECT		\int

	NO.	DATE	REVISION DISCRIPTION	ВУ	
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\neg	$\overline{}$				711

	Carolina Fire Control	C
P O BOX 1090	PH: 704-784-4218	D
CONCORD, N.C. 2802	6 FAX: 704-784-4405	D

NC FIRE SPRINKLER CONTRACTOR #16603 SC FIRE SPRINKLER CONTRACTOR: FSC.1078

1	CAMPBELL UNIVERSITY (
	STUDENT UNION					
	MAIN STREET BUIES CREEK, NORTH CAROLINA 27506					
	CONTRACT WITH:					
	TA LOVING					
	400 PATETOWN ROAD					
	GOLDSBORO, NORTH CAROLINA 27530					
	DRAWN BY: JEFF WYATT	AHJ: HARNETT COUNTY FM				
	DATE: 11-19-18					
	SCALE:					
	AS NOTED	FP 9 or FP 9				
ł	CONTRACTNO					