RESIDENTIAL ROOFTOP SOLAR PERMIT PACKAGE



Goodluck Billingham

1527 Atkins Road Fuquay-Varina, North Carolina 27526 19842268324



BI UF RAVEN

1403 N 630 E Orem, Utah 84097 (800) 377-4480 BlueRavenSolar.com

Atkins Road North Carolina 27526 Billingham

Goodluck Fuquay-Varina,

1388685 9.660 kW DC

PV AC SYSTEM SIZE: 7.980 kW AC

REVISIONS:

McKay Ashton PLOT DATE:

June 23, 2025

Cover Sheet

DRAWING NUMBER:




SCOPE OF WORK

Cecil Lopeman

#042013-75

INSTALLATION OF ROOFTOP MOUNTED PHOTOVOLTAIC SOLAR SYSTEM

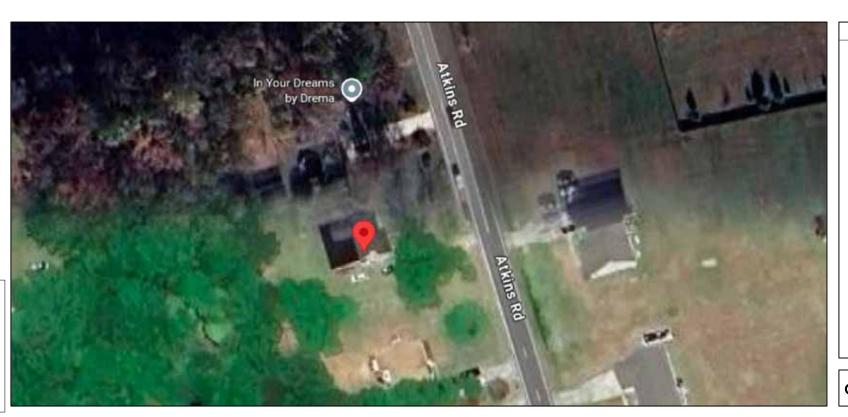

SHEET INDEX

PV1 COVER SHEET

PV2 SITE PLAN **PV3** ROOF PLAN

PV4 STRUCTURAL

PV5 ELECTRICAL 3-LINE

PV6 ELECTRICAL CALCULATIONS **PV7** LABELS

PV8 PLACARD SS SPEC SHEETS

CEC-AC SYSTEM SIZE: 8.892 kW AC

TOTAL PV AC SYSTEM SIZE

7.980 kW AC

TYPICAL STRUCTURAL INFORMATION

ROOF MATERIAL: Comp Shingle SHEATHING: PLYWOOD FRAMING: Rafter **RACKING: PEGASUS RAIL ROOF ATTACHMENT:** PEGASUS INSTAFLASH 2

TOTAL ATTACHMENTS: 56

NEW PV SYSTEM INFORMATION

AC SYSTEM SIZE: 7.98 kW AC

DC SYSTEM SIZE: 9.66 kW DC

MODULE TYPE: (21) REC Solar REC460AA Pure-RX

INVERTER TYPE: (21) Enphase IQ8X-80-M-US

GENERAL NOTES



Sealed For Existing Roof & Attachment Only

Digitally signed by John Calvert Date: 2025.09.22 18:26:47 -06'00'

9/22/25 Firm No. : D-0449

AHJ Harnett County NC

UTILITY COMPANY

Duke Energy Progress

TOTAL PV DC SYSTEM SIZE 9.660 kW DC

DESIGN CRITERIA

WIND SPEED: 115 mph

WIND EXPOSURE FACTOR: C **SEISMIC DESIGN CATEGORY: B** RISK CATEGORY: ||

GROUND SNOW LOAD: 15 psf


WEATHER STATION DATA

WEATHER STATION: SEYMOUR-JOHNSON AFB


HIGH TEMP 2% AVG: 35°C **EXTREME MINIMUM TEMP: -10°C**


APPLICABLE CODES

*2017 NATIONAL ELECTRIC CODE (NEC) *2018 NORTH CAROLINA BUILDING CODE (NCBC) *2018 NORTH CAROLINA RESIDENTIAL CODE (NCRC), 2018 NORTH CAROLINA PLUMBING CODE (NCPC), AND ALL STATE AND LOCAL BUILDING, ELECTRICAL, AND PLUMBING CODES

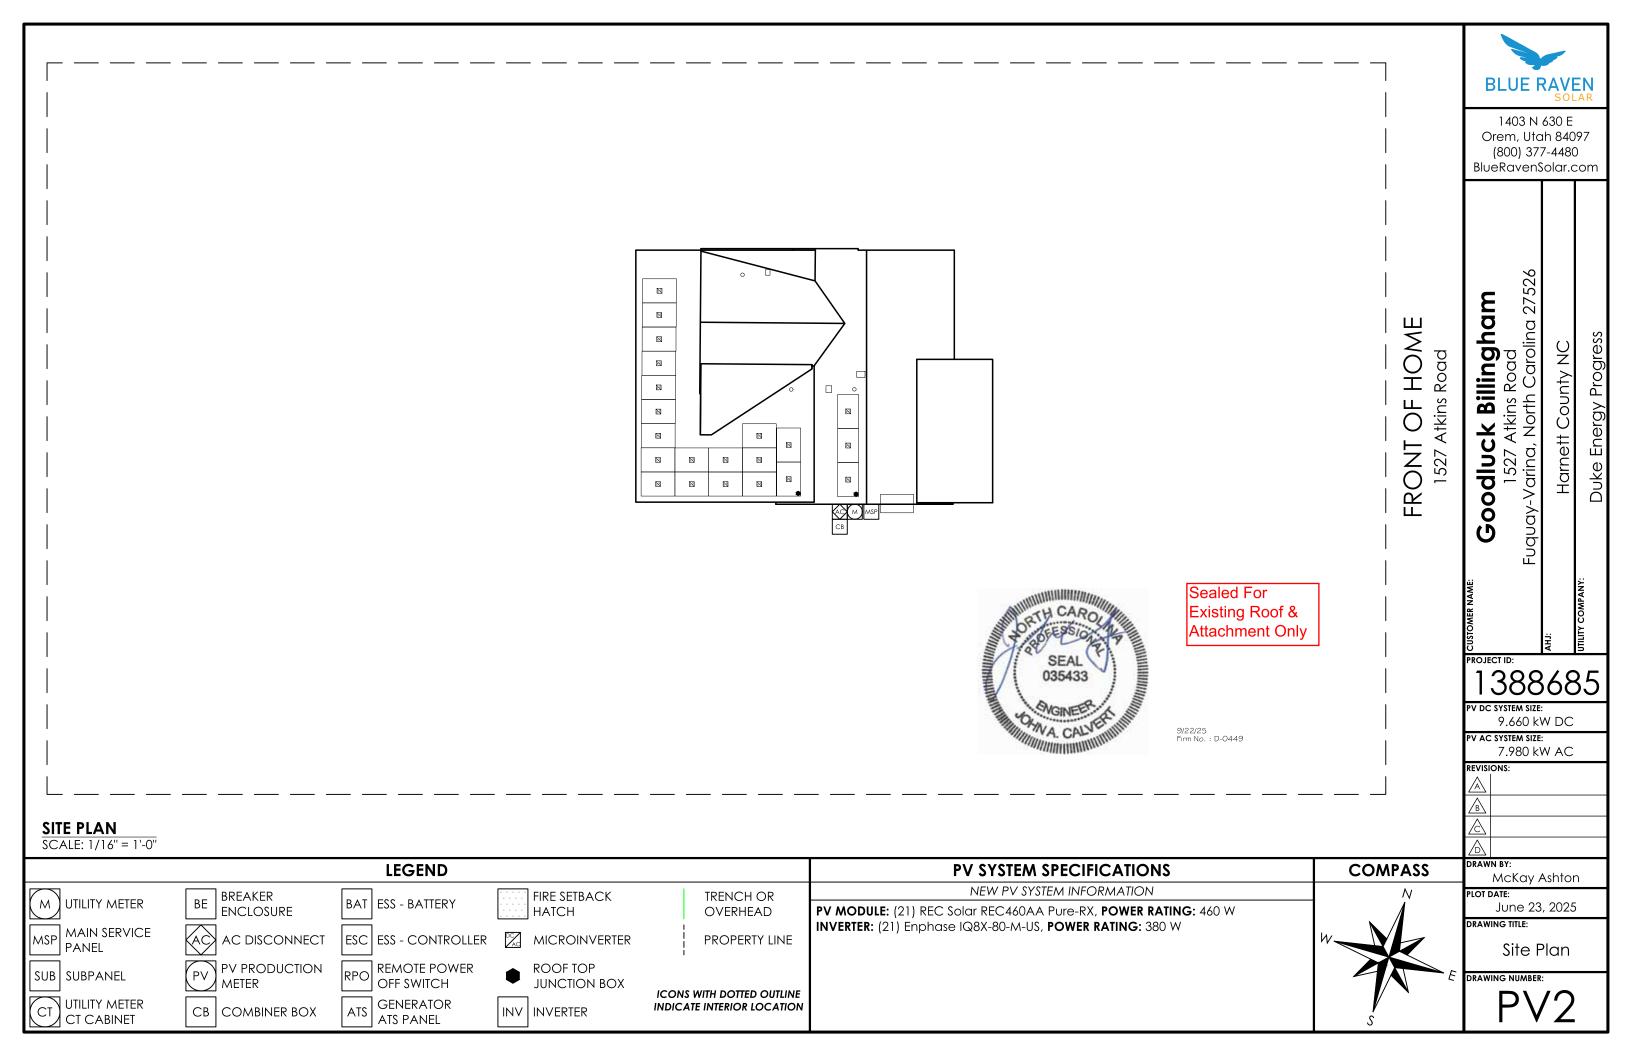

DC SYSTEM SIZE: 9.66 KW DCMODULE: REC 460INVERTER(S): Enphase IQ8X Microinverters **BLUE RAVEN** 1403 N 630 E Orem, Utah 84097 (800) 377-4480 BlueRavenSolar.com 0 **8** 1527 Atkins Road Fuquay-Varina, North Carolina 27526 Goodluck Billingham N FRONT OF HOME **Duke Energy Progress** Harnett County NC **8**8 **8**8 88 0 8 8 MP2 MP1 Sealed For MODULE QTY: 18 MODULE QTY: 3 Existing Roof & N N AZIMUTH: 254 AZIMUTH: 254 Attachment Only 8 N PITCH: 6 PITCH: 30 TSRF: 75 N N TSRF: 75 **8**8 **8**8 AREA: 813 ft² AREA: 382 ft² 8 N N N N N 388685 SEAL CHIMNEY V DC SYSTEM SIZE: Μ 035433 9.660 kW DC STRUCTURE PITCH IS 2 UNITS VERTICAL IN 12 UNITS HORIZONTAL OR LESS AND IS EXEMPT FROM FIRE ACCESS PATHWAY REQUIREMENTS СВ PV AC SYSTEM SIZE: 7.980 kW AC POINT OF INTERCONNECTION UNDERGROUND SERVICE LINE REVISIONS: 9/22/25 Firm No. : D-0449 **ROOF PLAN** SCALE: 1/8" = 1'-0" DRAWN BY: **COMPASS LEGEND PV SYSTEM SPECIFICATIONS** McKay Ashton NEW PV SYSTEM INFORMATION PLOT DATE: FIRE SETBACK TRENCH OR BREAKER UTILITY METER ΒE BAT ESS - BATTERY June 23, 2025 ENCLOSURE HATCH OVERHEAD PV MODULE: (21) REC Solar REC460AA Pure-RX, POWER RATING: 460 W DRAWING TITLE: INVERTER: (21) Enphase IQ8X-80-M-US, POWER RATING: 380 W MAIN SERVICE AC DISCONNECT MICROINVERTER ESC ESS - CONTROLLER PROPERTY LINE **PANEL** Roof Plan PV PRODUCTION REMOTE POWER **ROOF TOP** SUB SUBPANEL DRAWING NUMBER: METER **OFF SWITCH** JUNCTION BOX ICONS WITH DOTTED OUTLINE UTILITY METER **GENERATOR** INDICATE INTERIOR LOCATION CB | COMBINER BOX INV INVERTER CT CABINET ATS PANEL

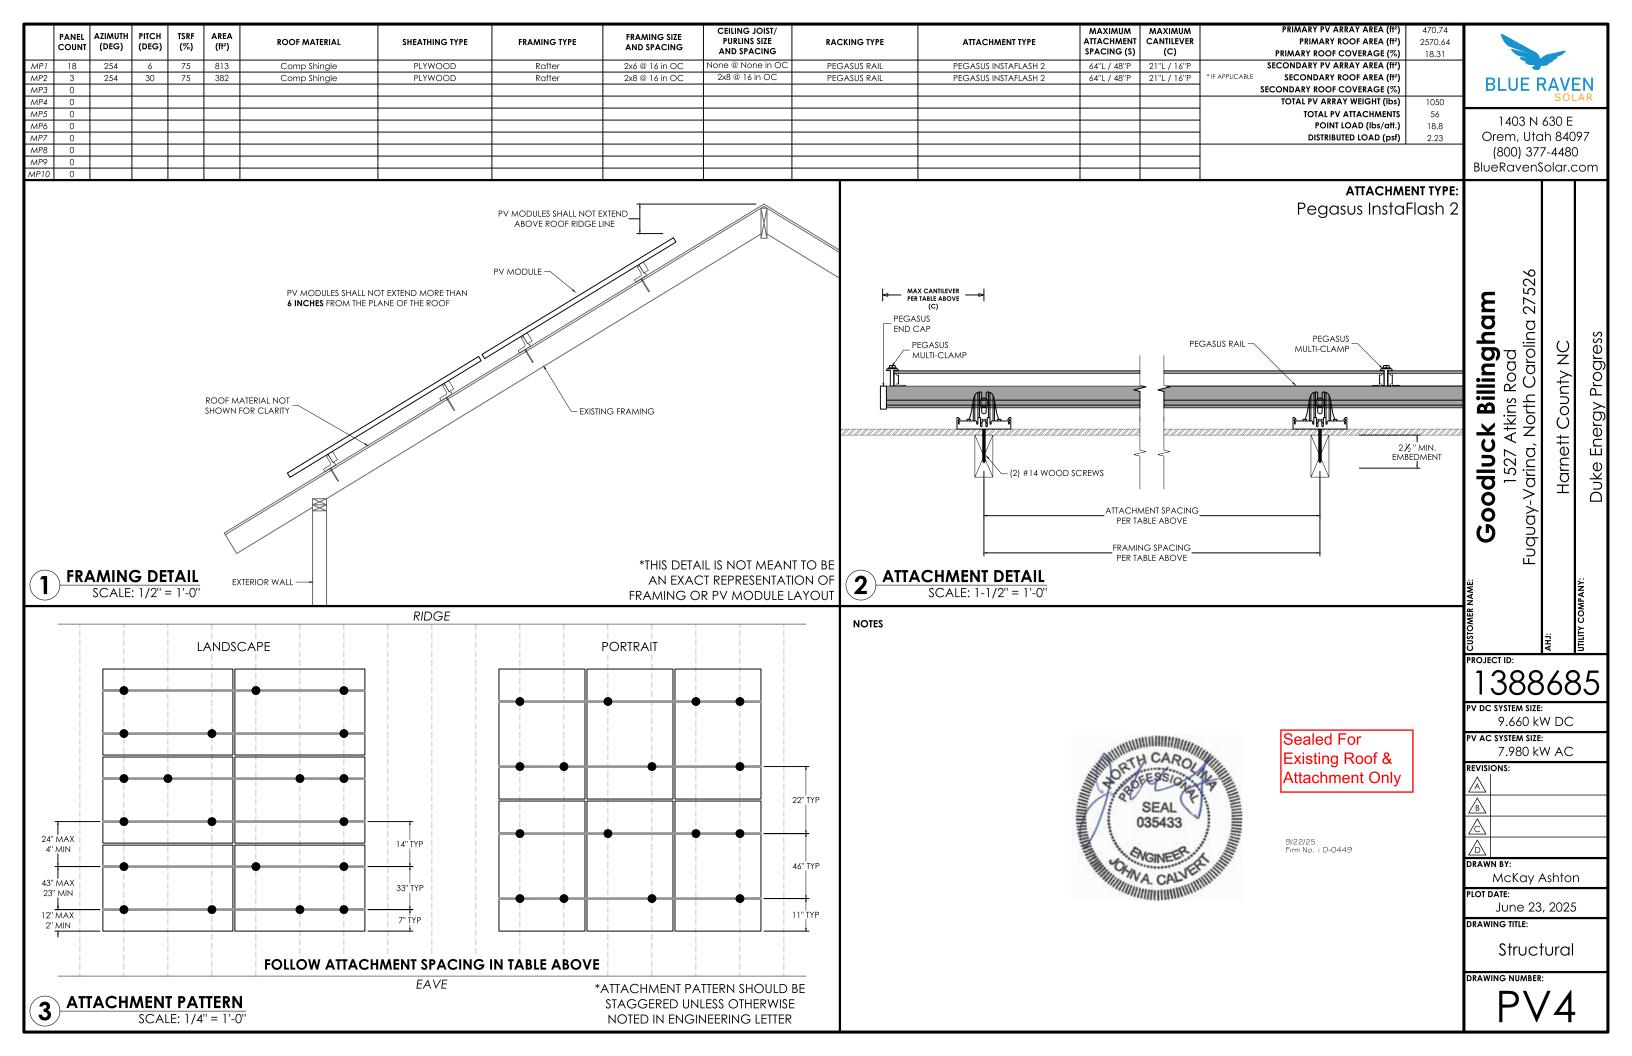

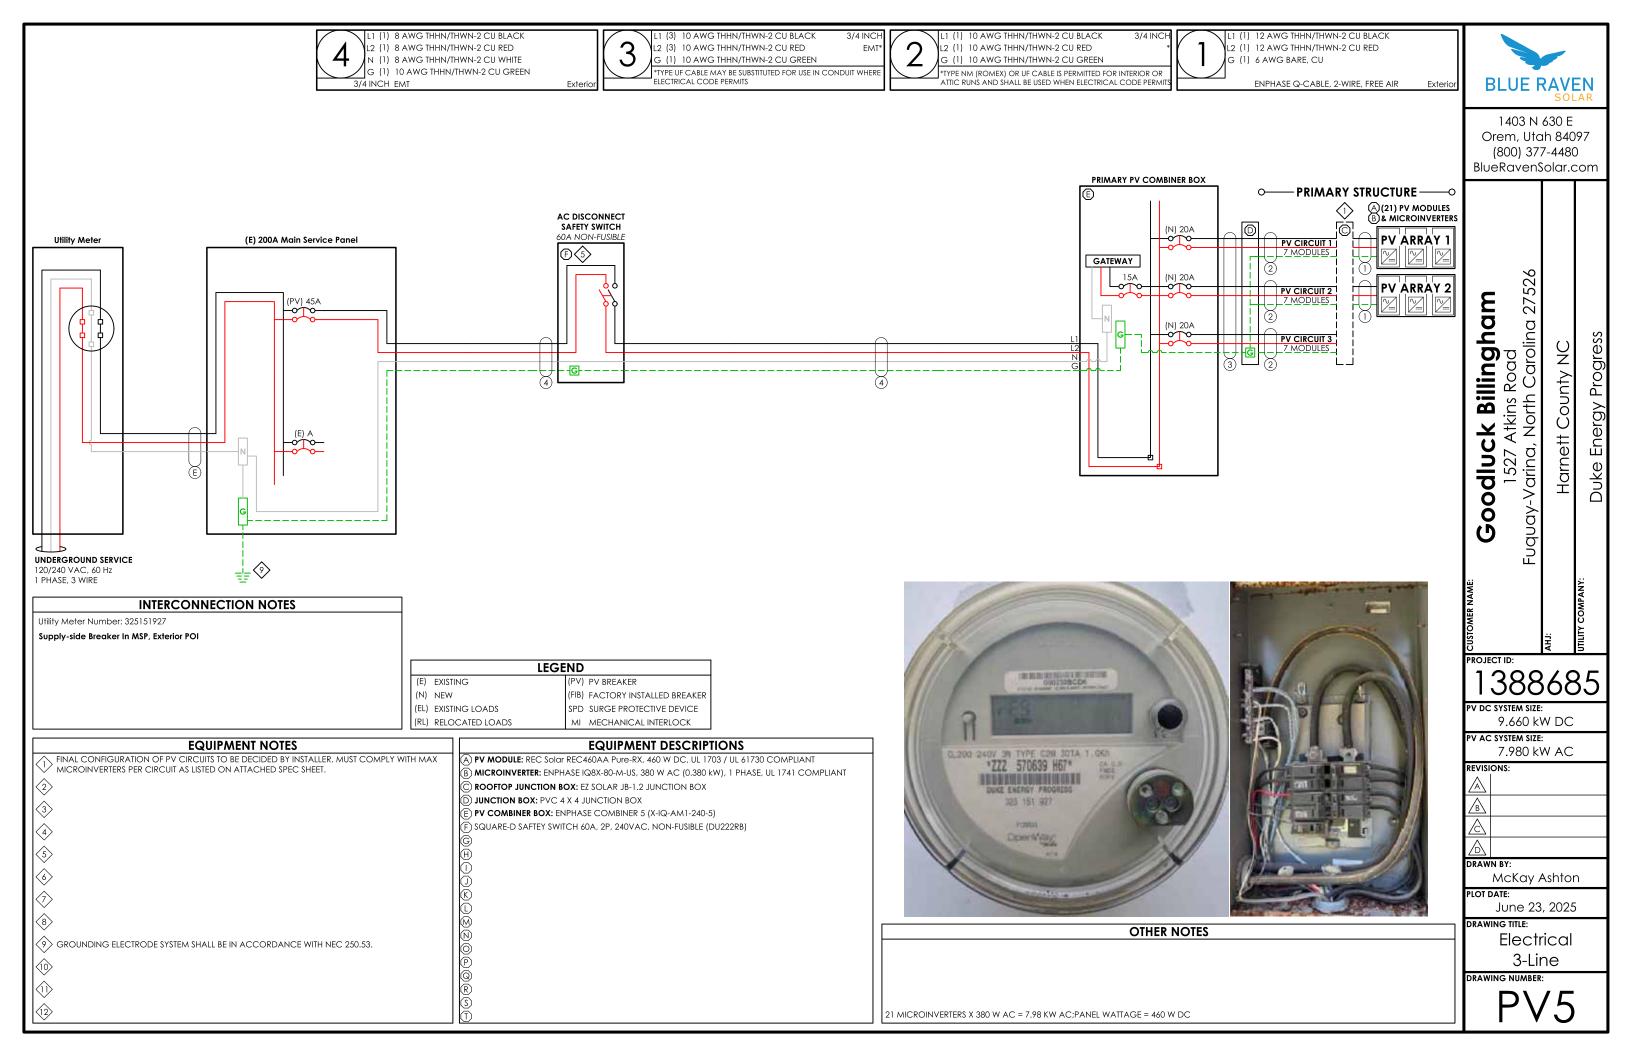

ELECTRICAL INFORMATION						
UTILITY ELECTRICAL SYSTEM						
1-Phase, 3-Wire, 60Hz, 120/240V						
NEW PV SYSTEM						
1-Phase, 3-Wire, 60Hz, 120/240V						
AC SYSTEM SIZE	7.98kW AC					
DC SYSTEM SIZE	9.66kW DC					
PV MODULES						
QUANTITY	21					
TYPE	REC Solar REC460AA Pure-RX					
WATTAGE	460W DC					
	INVERTERS					
TYPE	Enphase IQ8X-80-M-US					
OUTPUT CURRENT	1.58A AC					
NOMINAL VOLTAGE	240V AC					
OUTPUT POWER	380W AC					

PV BREAKER BACKFEED CALCULATIONS "120% RULE"

(BUSBAR RATING * 120%) - OCPD RATING = AVAILABLE BACKFEED							
	MAIN SERVICE PANEL	SUBPANEL 1	SUBPANEL 2				
BUSBAR RATING	200A	Α	Α				
PANEL OCPD RATING	NoneA	Α	Α				
AVAILABLE BACKFEED (120% RULE)	##A	##A	##A				
PV BREAKER RATING	45A	45A	45A				

*THESE CALCULATIONS ARE ONLY APPLICABLE IF PV INTERCONNECTION IS A
LOAD SIDE BREAKER. *PV BREAKER MUST BE RATED LESS THAN OR EQUAL TO
AVAILABLE BACKFEED FOR CODE COMPLIANCE*

DESIGN LOCATION				
AND TEMPERATURES				
ASHRAE Weather Station Data				
North Carolina				
CITY Fuquay-Varina				
SEYMOUR-JOHNSON AFB				
35°C				
-10°C				

	WIRE SIZE SPECIFICATIONS									
	1)	2	3	4	(5)	6	7	8	9	10
MINIMUM CONDUCTOR AMPACITY	13.83A AC	13.83A AC	13.83A AC	41.48A AC	A AC	A AC	A AC	A AC	A AC	A AC
CONDUCTOR MATERIAL	CU	CU	CU	CU						
CONDUCTOR TYPE	THHN/THWN-2	THHN/THWN-2	THHN/THWN-2	THHN/THWN-2						
CONDUCTOR SIZE	12 AWG	10 AWG	10 AWG	8 AWG						
CONDUCTOR AMPACITY	30A	40A	40A	55A	Α	A	Α	A	A	Α
AMBIENT TEMPERATURE ADJUSTMENT FACTOR	0.96	0.96	0.96	0.96						
CONDUIT FILL ADJUSTMENT FACTOR	1	1	0.7	1						
ADJUSTED CONDUCTOR AMPACITY	28.8A	38.4A	26.88A	52.8A	Α	A	Α	Α	Α	Α
WIRE RUN DISTANCE (FT)	46	20	10	5						
CALCULATED VOLTAGE DROP	0.48%	0.23%	0.11%	0.11%	0%	0%	0%	0%	0%	0%

PV CIRCUIT SPECIFICATIONS													
	PRIMARY STRUCTURE							DETACHED STRUCTURE					
	CIRCUIT 1	CIRCUIT 2	CIRCUIT 3	CIRCUIT 4	CIRCUIT 5	CIRCUIT 6	CIRCUIT 7	CIRCUIT 8	CIRCUIT 1	CIRCUIT 2	CIRCUIT 3	CIRCUIT 4	CIRCUIT 5
NUMBER OF MODULES PER CIRCUIT	7	7	7	0	0	0	0	0	0	0	0	0	0
RATED AC OUTPUT CURRENT (Iout)	11.1A	11.1A	11.1A	0.0A	0.0A	0.0A	0.0A	0.0A	0.0A	0.0A	0.0A	0.0A	0.0A
MINIMUM AMPACITY (Iout x 125%)	13.8A	13.8A	13.8A	0.0A	0.0A	0.0A	0.0A	0.0A	0.0A	0.0A	0.0A	0.0A	0.0A
OVERCURRENT PROTECTION RATING	20A	20A	20A	20A	20A	20A	20A	20A	20A	20A	20A	20A	20A
COMBINED AC OUTPUT CURRENT (Cout)		33.2A 41.5A 45AA						0.0A					
MINIMUM AMPACITY (Cout x 125%)								0.0A					
COMBINED PV BREAKER RATING							•	0AA					

TOTAL PV						
VOLTAGE DROP						
	VOLTAGE DROP					
WIRE TAG #1	0.48%					
WIRE TAG #2	0.23%					
WIRE TAG #3	0.11%					
WIRE TAG #4	0.11%					
WIRE TAG #5	0%					
WIRE TAG #6	0%					
TOTAL	0.930000%					



Orem, Utah 84097 (800) 377-4480 BlueRavenSolar.com

Goodluck Billingham 1527 Atkins Road Fuquay-Varina, North Carolina 27526 Harnett County NC

Duke Energy Progress

1388685

9.660 kW DC

PV AC SYSTEM SIZE: 7.980 kW AC

REVISIONS:


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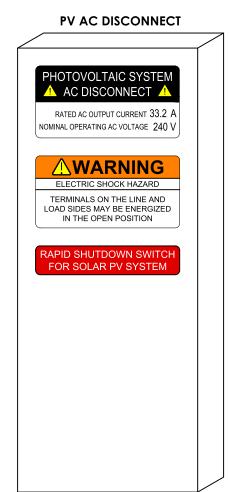
McKay Ashton PLOT DATE:

June 23, 2025

DRAWING TITLE: Electrical Calculations

WARNING LABELS



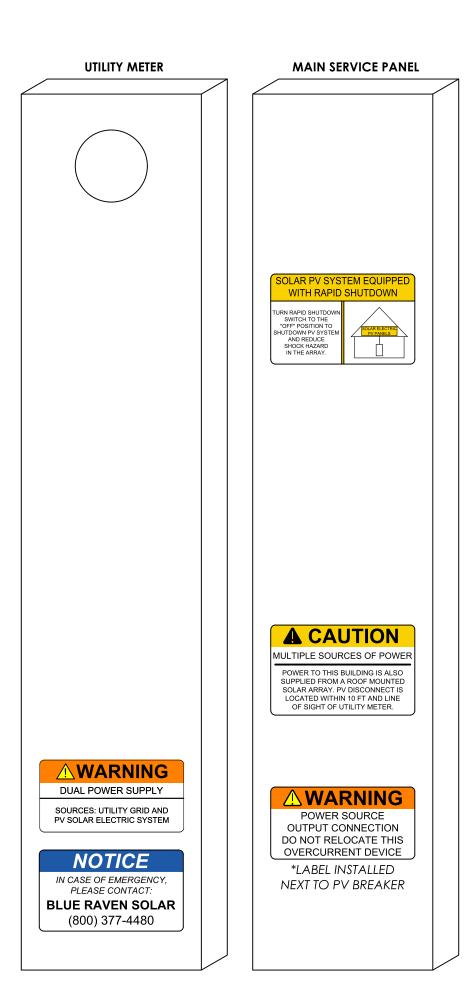



BLUE RAVEN 1403 N 630 E Orem, Utah 84097 (800) 377-4480 BlueRavenSolar.com 1527 Atkins Road Fuquay-Varina, North Carolina 27526 **Goodluck Billingham Energy Progress** Harnett County NC Duke 1388685 9.660 kW DC PV AC SYSTEM SIZE: 7.980 kW AC REVISIONS:

DRAWN BY:

PLOT DATE:

DRAWING TITLE:

DRAWING NUMBER:

McKay Ashton

June 23, 2025

Warning

Labels




REC ALPHA® PURE-RX SERIES





GENERAL DATA	
Cell Type	88 half-cut bifacial REC heterojunction cells, with gapless technology
Glass	3.2 mm solar glass with anti-reflective surface treatment in accordance with EN12150
Backsheet	Highly resistant polymer (Black)
Frame	Anodized aluminum (Black)
Junction Box	4-part, 4 bypass diodes, IP68 rated, in accordance with IEC 62790
Connectors	Stäubli MC4 PV-KBT4/KST4 (4 mm²) in accordance with IEC 62852, IP68 only when connected
Cable	4 mm² solar cable, 1.7 m + 1.7 m in accordance with EN50618
Dimensions	$1728 \times 1205 \times 30 \text{ mm} (2.08 \text{ m}^2)$
Weight	22.7 kg
Origin	Made in Singapore

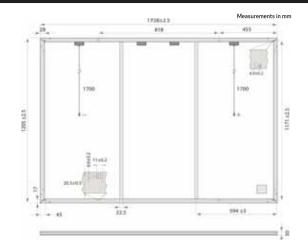

	ELECTRICAL DATA	PRODUCT CO	DE*: RECxxxAA	\ Pure-RX
	Power Output - P _{MAX} (W _P)	450	460	470
	Watt Class Sorting - (W)	0/+10	0/0	0/+10
	Nominal Power Voltage - $V_{MPP}(V)$	54.3	54.9	55.4
	Nominal Power Current - $I_{MPP}(A)$	8.29	8.38	8.49
STC	Open Circuit Voltage - $V_{OC}(V)$	65.1	65.3	65.6
0,	Short Circuit Current - I_{SC} (A)	8.81	8.88	8.95
	Power Density (W/m²)	216	221	226
	Panel Efficiency (%)	21.6	22.1	22.6
	Power Output - P _{MAX} (W _P)	343	350	358
Ы	Nominal Power Voltage - V_{MPP} (V)	51.2	51.7	52.2
NMOT	Nominal Power Current - I_{MPP} (A)	6.70	6.77	6.86
	Open Circuit Voltage - V_{OC} (V)	61.3	61.6	61.8
	Short Circuit Current - I _{SC} (A)	7.11	7.17	7.23

Values at standard test conditions (STC air mass AM1.5, irradiance 1000 W/m², temperature 25°C), based on a production spread with a tolerance of P_{Max} , V_{∞} , $\&l_{\infty}$, $\pm 3\%$ within one watt class. Nominal module operating temperature (NMOT: air mass AM1.5, irradiance 800 W/m², temperature 20°C, windspeed 1 m/s). "Where xxxx indicates the nominal power class (P_{Max}) at STC above.

Founded in 1996, REC Group is an international pioneering solar energy company dedicated to empowering consumers with clean, affordable solar power. As Solar's Most Trusted, REC is committed to high quality, innovation, and a low carbon footprint in the solar materials and solar panels it manufactures. Headquartered in Norway with operational headquarters in Singapore, REC also has regional hubs in North America,

-40 °C - 85 °C
1000 V
+7000 Pa (713 kg/m²)
-4000 Pa (407 kg/m²)
25 A
25 A
*See installation manual for mounting instructions Design load = Test load / 1.5 (safety factor

Available from:

TEMPERATURE RATINGS*	
Nominal Module Operating Temperature	44°C±2°C
Temperature coefficient of P _{MAX}	-0.24%/°C
Temperature coefficient of V _{oc}	-0.24%/°C
Temperature coefficient of I _{sc}	0.04%/°C
*The temperature coefficients stated are linear values	

DELIVERY INFORMATION	
Panels per Pallet	33
Panels per 40 ft GP/high cube container	594 (18 Pallets)
Panels per 13.6 m truck	660 (20 Pallets)

	CERTIFICATIONS		
	IEC 61215:2021; IEC61730:2016; UL61730		
	ISO 11925-2	Ignitability (EN 13501-1 Class E)	
	IEC 62716	Ammonia Resistance	
	IEC 61701	Salt Mist (SM6)	
	IEC 61215:2016	Hailstone (35 mm)	
	UL 61730	Fire Type 2	
ISO 14001; ISO9001; IEC45001; IEC62941		9001; IEC45001; IEC62941	










WARRANTY				
	Standard	REC Pr	oTrust	
nstalled by an REC Certified Professional	No	Yes	Yes	
System Size	All	<25 kW	25-500 kW	
Product Warranty yrs)	20	25	25	
Power Warranty yrs)	25	25	25	
abor Warranty yrs)	0	25	10	
Power in Year 1	98%	98%	98%	
Annual Degradation	0.25%	0.25%	0.25%	
Power in Year 25	92%	92%	92%	
The REC ProTrust War	ranty ie only av	ailahla on nan	ale nurchaead	

LOW LIGHT BEHAVIOUR


Typical low irradiance performance of module at STC:

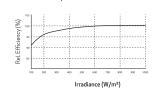

20 Tuas South Ave. 14 Singapore 637312 post@recgroup.com www.recgroup.com





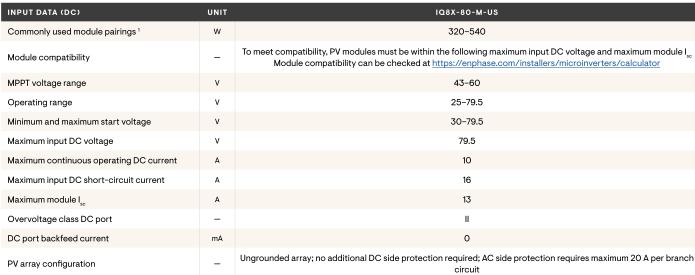

, ,		circuit		
OUTPUT DATA (AC)	UNIT	IQ8X-80-M-US @240 VAC	IQ8X-80-M-US @208 VAC	
Peak output power	VA	384	366	
Maximum continuous output power	VA	380	360	
Nominal grid voltage (L-L)	V	240, split-phase (L-L), 180°	208, single-phase (L-L), 120° ⁴	
Minimum and maximum grid voltage ²	V	211-264	183-229	
Max. continuous output current	Α	1.58	1.73	
Nominal frequency	Hz	60)	
Extended frequency range	Hz	47-1	68	
AC short circuit fault current over three cycles	A _{rms}	2.7	0	
Maximum units per 20 A (L-L) branch circuit ³	-	10	9	
Total harmonic distortion	%	<5	5	
Overvoltage class AC port	-	III		
AC port backfeed current	mA	18		
Power factor setting	-	1.C		
Grid-tied power factor (adjustable)	-	0.85 leading	0.85 lagging	
Peak efficiency	%	97.3	97.0	
CEC weighted efficiency	%	96.5	96.5	
Nighttime power consumption	mW	26	12	
MECHANICAL DATA	1			

MECHANICAL DATA		
Ambient temperature range	-40°C to 65°C (-40°F to 149°F)	
Relative humidity range	4% to 100% (condensing)	
DC connector type	Stäubli MC4	
Dimensions (H × W × D); Weight	212 mm (8.3") × 175 mm (6.9") × 30.2 mm (1.2"); 1.1 kg (2.43 lbs)	
Cooling	Natural convection - no fans	
Approved for wet locations; Pollution degree	Yes; PD3	
Enclosure	Class II double-insulated, corrosion-resistant polymeric enclosure	
Environmental category; UV exposure rating	NEMA Type 6; outdoor	

COMPLIANCE

Certifications

CA Rule 21 (UL 1741-SA), UL 62109-1, IEEE 1547:2018 (UL 1741-SB), FCC Part 15 Class B, ICES-0003 Class B, CAN/CSA-C22.2 NO. 107.1-01 This product is UL Listed as PV rapid shutdown equipment and conforms with NEC 2014, NEC 2017, NEC 2020, and NEC 2023 section 690.12 and C22.1-2018 Rule 64-218 rapid shutdown of PV systems for AC and DC conductors when installed according to the manufacturer's instructions.

(1) No enforced DC/AC ratio

for single-phase operation only. Check with the local utility requirements if you wish to install single phase inverter across three phases

IQ8X-MC4-DSH-00185-2.0-EN-US-2023-11-16



IQ8X Microinverter

Our newest IQ8 Series Microinverters are the industry's first microgrid-forming*, software-defined microinverters with split-phase power conversion capability to convert DC power to AC power efficiently. The brain of the semiconductor-based microinverter is our proprietary applicationspecific integrated circuit (ASIC), which enables the microinverter to operate in grid-tied or off-grid mode. This chip is built using advanced 55-nm technology with high-speed digital logic and superfast response times to changing loads and grid events, alleviating constraints on battery sizing for home energy systems.

IQ8X Microinverter is the latest addition to this family, designed to support PV modules with high input DC voltage and cell counts, such as 80-half-cut cells, 88-half-cut cells and 96-cells.



Part of the Enphase Energy System, IQ8 Series Microinverters integrate with the IQ Battery, IQ Gateway, and the Enphase App monitoring and analysis software.



Connect PV modules quickly and easily to the IQ8 Series Microinverters with integrated MC4 connectors.



IQ8 Series Microinverters redefine reliability standards with more than one million cumulative hours of power-on testing, enabling an industry-leading limited warranty of up to 25 years.



IQ8 Series Microinverters are UL Listed as PV rapid shutdown equipment and conform with regulations when installed according to the manufacturer's instructions.

*Meets UL 1741 only when installed with IQ System Controller 2 and 3.

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Easy to install

- · Lightweight and compact with plugand-play connectors
- · Power line communication (PLC) between components
- · Faster installation with simple two-wire cabling

High productivity and reliability

- · Produces power even when the grid is
- · More than one million cumulative hours
- · Class II double-insulated enclosure
- · Optimized for the latest high-powered PV modules

Microgrid-forming

- · Complies with the latest advanced grid
- · Remote automatic updates for the latest grid requirements
- Configurable to support a wide range of grid profiles
- · Meets CA Rule 21 (UL 1741-SA) and IEEE 1547:2018 (UL 1741-SB)

- · IQ8 Series Microinverters cannot be mixed with previous generations of Enphase microinverters (IO7 Series, IQ6 Series, and so on) in the same system.
- · IQ Gateway is required to change the default grid profile at the time of installation to meet local Authority Having Jurisdiction (AHJ) requirements.

IQ8X-MC4-DSH-00185-2.0-EN-US-2023-11-16

(2) Nominal voltage range can be extended beyond nominal if required by the utility.

(3) Limits may vary. Refer to local requirements to define the number of microinverters per branch in your area.

(4) IQ8X is not certified for use with Enphase Three Phase Network Protection Relay (NPR-3P-208-NA) and therefore designed

Enphase Q Cable Accessories

The **Enphase Q Cable™** and accessories are part of the latest generation Enphase IQ System™. These accessories provide simplicity, reliability, and faster installation times.



Enphase Q Cable

- Two-wire, double-insulated Enphase Q Cable is 50% lighter than the previous generation Enphase cable
- New cable numbering and plug and play connectors speed up installation and simplify wire management
- · Link connectors eliminate cable waste

Field-Wireable Connectors

- Easily connect Q cables on the roof without complex wiring
- Make connections from any open connector and center feed any section of cable within
- · Available in male and female connector types

Enphase Q Cable Accessories

CONDUCTOR SPECIFICATIONS	
Certification	UL3003 (raw cable), UL 9703 (cable assemblies), DG cable
Flame test rating	FT4
Compliance	RoHS, OIL RES I, CE, UV Resistant, combined UL for Canada and United States
Conductor type	THHN/THWN-2 dry/wet
Disconnecting means	The AC and DC bulkhead connectors have been evaluated and approved by UL for use as the load-break disconnect required by NEC 690.


Q CABLE TYPES / ORDERING OPTIONS

Connectorized Models	Size / Max Nominal Voltage	Connector Spacing	PV Module Orientation	Connector Count per Box
Q-12-10-240	12 AWG / 277 VAC	1.3 m (4.2 ft)	Portrait	240
Q-12-17-240	12 AWG / 277 VAC	2.0 m (6.5 ft)	Landscape (60-cell)	240
Q-12-20-200	12 AWG / 277 VAC	2.3 m (7.5 ft)	Landscape (72-cell)	200

ENPHASE Q CABLE ACCESSORIES

Name	Model Number	Description
Raw Q Cable	Q-12-RAW-300	300 meters of 12 AWG cable with no connectors
Field-wireable connector (male)	Q-CONN-10M	Make connections from any open connector
Field-wireable connector (female)	Q-CONN-10F	Make connections from any Q Cable open connector
Cable Clip	Q-CLIP-100	Used to fasten cabling to the racking or to secure looped cabling
Disconnect tool	Q-DISC-10	Disconnect tool for Q Cable connectors, DC connectors, and AC module mount
Q Cable sealing caps (female)	Q-SEAL-10	One needed to cover each unused connector on the cabling
Terminator	Q-TERM-10	Terminator cap for unused cable ends
Enphase EN4 to MC4 adaptor ¹	ECA-EN4-S22	Connect PV module using MC4 connectors to IQ micros with EN4 (TE PV4-S SOLARLOK). 150mm/5.9" to MC4.
Enphase EN4 non-terminated adaptor ¹	ECA-EN4-FW	For field wiring of UL certified DC connectors. EN4 (TE PV4-S SOLARLOK) to non-terminated cable. 150mm/5.9"
Enphase EN4 to MC4 adaptor (long) ¹	ECA-EN4-S22-L	Longer adapter cable for EN4 (TE PV4-S SOLARLOK) to MC4. Use with split cell modules or PV modules with short DC cable. 600mm/23.6"
Replacement DC Adaptor (MC4)	Q-DCC-2	DC adaptor to MC4 (max voltage 100 VDC)
Replacement DC Adaptor (UTX)	Q-DCC-5	DC adaptor to UTX (max voltage 100 VDC)

1. Qualified per UL subject 9703.

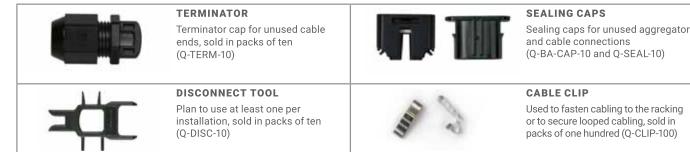

To learn more about Enphase offerings, visit enphase.com

ENPHASE.



SEALING CAPS

CABLE CLIP

Sealing caps for unused aggregator









X-IQ-AM1-240-5 X-IQ-AM1-240-5C

IQ Combiner 5/5C

The IQ Combiner 5/5C consolidates interconnection equipment into a single enclosure and streamlines IQ Series Microinverters and IQ Gateway installation by providing a consistent, pre-wired solution for residential applications. IQ Combiner 5/5C uses wired control communication and is compatible with IQ System Controller 3/3G and IQ Battery 5P.

The IQ Combiner 5/5C, IQ Series Microinverters, IQ System Controller 3/3G, and IQ Battery 5P provide a complete grid-agnostic Enphase Energy System.



IQ Series Microinverters

The high-powered smart grid-ready IQ Series Microinverters (IQ6, IQ7, and IQ8 Series) simplify the installation process.



IQ Battery 5P

Fully integrated AC battery system. Includes six field-replaceable IQ8D-BAT Microinverters.



IQ System Controller 3/3G Provides microgrid interconnection

device (MID) functionality by automatically detecting grid failures and seamlessly transitioning the home energy system from grid power to backup power.



IQ Load Controller

Helps prioritize essential appliances during a grid outage to optimize energy consumption and prolong battery life.



warrantv





*For country-specific warranty information, see the https://enphase.com/installers/resources/warranty page.

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Smart

- · Includes IQ Gateway for communication and control
- · Includes Enphase Mobile Connect (CELLMODEM-M1-06-SP-05), only with IQ Combiner 5C
- · Supports flexible networking: Wi-Fi, Ethernet, or cellular
- Provides production metering (revenue grade) and consumption monitoring

Easy to install

- · Mounts to one stud with centered brackets
- Supports bottom, back, and side conduit entries
- · Supports up to four 2-pole branch circuits for 240 VAC plug-in breakers (not included)
- · 80 A total PV branch circuits
- · Bluetooth-based Wi-Fi provisioning for easy Wi-Fi setup


Reliable

- · Durable NRTL-certified NEMA type 3R enclosure
- 5-year limited warranty
- 2-year labor reimbursement program coverage included for both the IQ Combiner SKUs*

IQC-5-5C-DSH-00007-3.0-EN-US-2024-03-01

· UL1741 Listed



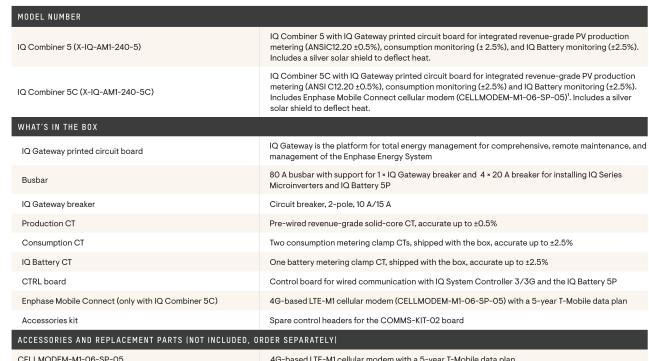

	· ·	
ACCESSORIES AND REPLACEMENT PARTS (NOT INCLUDED, ORDER SEPARATELY)		
CELLMODEM-M1-06-SP-05	4G-based LTE-M1 cellular modem with a 5-year T-Mobile data plan	
CELLMODEM-M1-06-AT-05	4G-based LTE-M1 cellular modem with a 5-year AT&T data plan	
Circuit breakers (off-the-shelf)	Supports Eaton BR2XX, Siemens O2XX and GE/ABB THOL21XX Series circuit breakers (XX represents 10, 15, 20, 30, 40, 50, or 60). Also supports Eaton BR220B, BR230B, and BR240B circuit breakers compatible with the hold-down kit.	
Circuit breakers (provided by Enphase)	BRK-10A-2-240V, BRK-15A-2-240V, BRK-20A-2P-240V, BRK-15A-2P-240V-B, and BRK-20A-2P-240V-B (more details in the "Accessories" section)	
XA-SOLARSHIELD-ES	Replacement solar shield for IQ Combiner 5/5C	
XA-ENV2-PCBA-5	IQ Gateway replacement printed circuit board (PCB) for IQ Combiner 5/5C	
X-IQ-NA-HD-125A	Hold-down kit compatible with Eaton BR-B Series circuit breakers (with screws)	
XA-COMMS2-PCBA-5	Replacement COMMS-KIT-02 printed circuit board (PCB) for IQ Combiner 5/5C	
ELECTRICAL SPECIFICATIONS		

ELECTRICAL SPECIFICATIONS		
Rating	80 A	
System voltage and frequency	120/240 VAC, 60 Hz	
Busbarrating	125 A	
Fault current rating	10 kAIC	
Maximum continuous current rating (input from PV/storage)	64 A	
Branch circuits (solar and/or storage)	Up to four 2-pole Eaton BR, Siemens Q, or GE/ABB THQL Series distributed generation (DG) breakers only (not included)	
Maximum total branch circuit breaker rating (input)	80 A of distributed generation/95 A with IQ Gateway breaker included	
IQ Gateway breaker	10 A or 15 A rating GE/Siemens/Eaton included	
Production metering CT	200 A solid core pre-installed and wired to IQ Gateway	
Consumption monitoring CT (CT-200-CLAMP)	A pair of 200 A clamp-style current transformers is included with the box	
IQ Battery metering CT	200 A clamp-style current transformer for IQ Battery metering, included with the box	

^{1.} A plug-and-play industrial-grade cell modern for systems of up to 60 microinverters. Available in the United States, Canada, Mexico, Puerto Rico, and the US Virgin Islands, where there is adequate

IQC-5-5C-DSH-00007-3.0-EN-US-2024-03-01

MECHANICAL DATA		
Dimensions (W × H × D)		$37.5~\text{cm}\times49.5~\text{cm}\times16.8~\text{cm}$ (14.75" \times 19.5" \times 6.63"). Height is 21.06" (53.5 cm) with mounting brackets
Weight		7.5 kg (16.5 lbs)
Ambient temperature range		-40°C to 46°C (-40°F to 115°F)
Cooling		Natural convection, plus heat shield
Enclosure environmental rating		Outdoor, NRTL-certified, NEMA type 3R, polycarbonate construction
Wire sizes		 20 A to 50 A breaker inputs: 14 to 4 AWG copper conductors 60 A breaker branch input: 4 to 1/0 AWG copper conductors Main lug combined output: 10 to 2/0 AWG copper conductors Neutral and ground: 14 to 1/0 copper conductors Always follow local code requirements for conductor sizing
Communication (in-premise conn	nectivity)	Built-in CTRL board for wired communication with IQ Battery 5P and IQ System Controller 3/3G. Integrated power line communication for IQ Series Microinverters
Altitude		Up to 2,600 meters (8,530 feet)
COMMUNICATION INTERFACES		
Integrated Wi-Fi		802.11b/g/n (dual band 2.4 GHz/5 GHz), for connecting the Enphase Cloud through the internet
Wi-Fi range (recommended)		10 m (32.8 feet)
Bluetooth		BLE4.2, 10 m range to configure Wi-Fi SSID
Ethernet Cellular/Mobile Connect Digital I/O		Optional, 802.3, Cat5E (or Cat 6) UTP Ethernet cable (not included), for connecting to the Enphast Cloud through the internet
		CELLMODEM-M1-06-SP-05 or CELLMODEM-M1-06-AT-05 (included with IQ Combiner 5C)
		Digital input/output for grid operator control
USB 2.0		Mobile Connect, COMMS-KIT-01 for IQ Battery 3/3T/10/10T, COMMS-KIT-02 for IQ Battery 5P
Access point (AP) mode		For connection between the IQ Gateway and a mobile device running the Enphase Installer App
Metering ports		Up to two Consumption CTs, one IQ Battery CT, and one Production CT
Power line communication		90–110 kHz
Web API		See https://developer-v4.enphase.com
Local API		See guide for local API
COMPLIANCE		
IQ Combiner with IQ Gateway		UL 1741, CAN/CSA C22.2 No. 107.1, Title 47 CFR, Part 15, Class B, ICES 003, NOM-208-SCFI-2016, UL 60601-1/CANCSA 22.2 No. 61010-1, IEEE 1547: 2018 (UL 1741-SB, 3rd Ed.), IEEE 2030.5/CSIP Compliant, Production metering: ANSI C12.20 accuracy class 0.5 (PV production)
COMPATIBILITY		
PV	Microinverters	IQ6, IQ7, and IQ8 Series Microinverters
	IQ System Controller	EP200G101-M240US00
COMMS-KIT-01 ²	IQ System Controller 2	EP200G101-M240US01
	IQ Battery	ENCHARGE-3-1P-NA, ENCHARGE-10-1P-NA, ENCHARGE-3T-1P-NA, ENCHARGE-10T-1P-NA
COMMS-KIT-02 ³	IQ System Controller 3	SC200D111C240US01, SC200G111C240US01
000 KH 02	IQ Battery	IQBATTERY-5P-IP-NA

Accessories



Mobile Connect

4G-based LTE-M1 cellular modem with a 5-year data plan

(CELLMODEM-M1-06-SP-05 for Sprint and CELLMODEM-M1-06-AT-05 for AT&T)



Circuit breakers

BRK-10A-2-240V Circuit breaker, 2-pole, 10 A, Eaton BR210 BRK-15A-2-240V Circuit breaker, 2-pole, 15 A, Eaton BR215 BRK-20A-2P-240V Circuit breaker, 2-pole, 20 A, Eaton BR220 BRK-15A-2P-240V-B Circuit breaker, 2-pole, 15 A, Eaton BR215B with hold-down kit support BRK-20A-2P-240V-B Circuit breaker, 2-pole, 20 A, Eaton BR220B with hold-down kit support

CT-200-SOLID



IQC-5-5C-DSH-00007-3.0-EN-US-2024-03-01

200 A revenue-grade solid core Production CT with <0.5% error rate (replacement SKU)



CT-200-CLAMP

200 A clamp-style consumption and battery metering CT with <2.5% error rate (replacement SKII)

3. IQ Combiner 5/5C comes pre-equipped with COMMS-KIT-02.

IQC-5-5C-DSH-00007-3.0-EN-US-2024-03-01



^{2.} For information about IQ Combiner 5/5C compatibility with the 2nd-generation batteries, refer to the compatibility matrix.







Smart

Simple

and control

· Provides bidirectional communications for remote

zero-export applications

· Enables web-based monitoring

· Supports power export limiting and

· Easy system configuration using Enphase Installer App · Flexible networking with Wi-Fi, Ethernet, or cellular

· Designed for installation indoors

or outdoors in a NEMA 3R rated

• ENV2-IQ-AM1-240 complies with IEEE® 1547:2018 (UL 1741-SB, 3rd Ed.)

IQ-G-DSH-00111-3.0-EN-US-2023-12-20

• 5-year limited warranty

IQ Gateway

The IQ Gateway delivers solar production and energy consumption data to Enphase Installer Portal monitoring and analysis software for comprehensive, remote maintenance, and management of Enphase systems.

With integrated production metering and optional consumption monitoring, the IQ Gateway is the platform for total energy management. It integrates with the IQ System Controller and IQ Battery.



IQ Series Microinverters

The high-powered smart grid-ready IQ Series Microinverters (IQ6, IQ7, and IQ8 Series) dramatically simplify the installation process.



IQ System Controller

Provides microgrid interconnect device (MID) functionality by automatically detecting grid failures and seamlessly transitioning the home energy system from grid power to backup power.



IQ Battery

All-in-one AC coupled storage system that is reliable, smart, simple, and safe. It provides backup capability and installers can quickly design the right system size to meet the needs of both new and retrofit solar customers.



Helps prioritize essential appliances during a grid outage to optimize energy consumption and prolong




IQ Load Controller





MODEL NUMBER	ENV-10-AM1-240, ENV2-10-AM1-240
IQ Gateway ENV-IQ-AM1-240 ENV2-IQ-AM1-240 (IEEE® 1547:2018)	IQ Gateway integrates revenue grade PV production metering (ANSI C12.20 \pm 0.5%), consumption metering (\pm 2.5%), and battery metering (\pm 2.5%) with IQ Battery 5P. Includes one 200 A continuous rated Production Current Transformer (CT).
ACCESSORIES - ORDER SEPARATELY	
Mobile Connect COMMS-CELLMODEM-M1-06 CELLMODEM-M1-06-SP-05 CELLMODEM-M1-06-AT-05	- Includes COMMS-KIT-01 and CELLMODEM-M1-06-SP-05 with 5-year Sprint data plan - 4G based LTE-M1 cellular modem with 5-year Sprint data plan - 4G based LTE-M1 cellular modem with 5-year AT&T data plan
Consumption monitoring CT and IQ Battery 5P metering CT CT-200-SPLIT CT-200-CLAMP	Split-core and clamp style CTs with 2.5% accuracy enable whole home and IQ Battery 5P metering
Communications Kit COMMS-KIT-01 COMMS-KIT-02	Installed at the IQ Gateway. For communications with IQ Battery and IQ System Controller. Includes USB cable for connection to IQ Gateway or IQ Combiner and allows wireless communication with IQ Battery and IQ System Controller.
POWER REQUIREMENTS	
AC power requirements	120/240 V, 120/208Y V, or 127/220Y V. Three-wire. 60 Hz.
IQ Gateway breaker	2-pole and maximum 20 A overcurrent protection required
Typical power consumption	5 W
CAPACITY	
Number of microinverters polled	Up to 300
MECHANICAL AND ELECTRICAL DATA	
Dimensions (W × H × D)	21.3 cm × 12.6 cm × 4.5 cm (8.4 in × 5 in × 1.8 in)
Weight	1.09 lb
Ambient temperature range	-40°C to 65°C (-40°F to 149°F) [ENV-IQ-AM1-240] -40°C to 50°C (-40°F to 122°F) [ENV2-IQ-AM1-240] -40°C to 46°C (-40°F to 115°F) if installed in an enclosure
Environmental rating	IP30. For installation indoors or in an NRTL-certified, NEMA type 3R or better-rated enclosure, if installing outdoors.
Altitude	Up to 2,600 meters (8,530 feet)
COMMUNICATION INTERFACES	
Integrated Wi-Fi	802.11b/g/n (2.4 GHz, 5 GHz), for connecting the Enphase Cloud via the internet.
Wi-Fi range (recommended)	10 m
Ethernet	Optional, 802.3, Cat5E (or Cat 6) UTP Ethernet cable (not included), for connecting to the Enphase Cloud via the internet.
Mobile Connect	$\label{lem:cellmodem} \textbf{CELLMODEM-M1-06-AT-05} \ (to be purchased separately, mandatory for sites with IQ Battery)$
Digital I/O	Digital input/output for grid operator control
USB 2.0	For Mobile Connect and Communications Kit
Access point (AP) mode	For a connection between the IQ Gateway and a mobile device running the Enphase Installer App
Metering ports	Up to two Consumption CTs, one Production CT, and one battery CT (for IQ Battery 5P)
Power line communication (PLC)	90 kHz-110 kHz (Class B), to microinverters.
Web API	Refer to https://developer-v4.enphase.com
Local API	Refer to guide for local API
LED indicators	From top to bottom: Cloud connectivity, Wi-Fi access point mode, PV production state, PLC



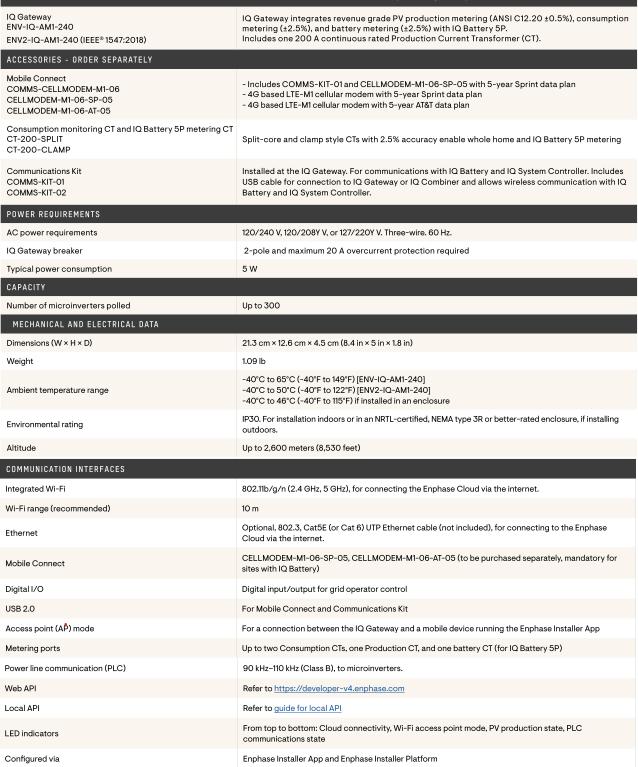



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IQ-G-DSH-00111-3.0-EN-US-2023-12-20



POWER PRODUCTION/EXPORT LIMITING VIA THE IQ GATEWAY'S DIGITAL IO		
Maximum relays read	4	
Capabilities supported	Power production limiting (Production CT/s required), power export limiting (Production CT/s required and Consumption CT/s – Load with Solar configuration)	
Minimum IQ Gateway version	v7.3.120	
Cable configurations	18 AWG, UL-Std. 62, 600 V, 105°C, and minimum 0.03 inches average thickness	
Signal voltage range	2.5 V-5 V (digital high), O V-1.9 V (digital low)	
Terminal blocks	Five terminals, up to 0.002 in ²	
Configuration via	Enphase Installer App, Enphase Installer Platform (site settings)	
SCOPE OF DELIVERY		
Package dimensions (H × W × D)	6.3 in × 10.8 in × 3.9 in	
Package weight	2.2 lb	
Aluminium DIN rail	4.9 in	
Current transformers (CTs)	One CT-200-SOLID included	
COMPLIANCE		
Compliance	CA Rule 21 (UL 1741-SA), IEEE® 1547:2018 - UL 1741-SB, 3rd Ed.(ENV2-IQ-AM1-240), UL 61010-1 CAN/CSA C22.2 No. 61010-1 Title 47 CFR, Part 15, Class B, ICES 003 IEC/EN 61010-1:2010, EN50065-1, EN61000-4-5, EN61000-6-1, EN61000-6-2 Metering: ANSI C12.20 accuracy class 0.5 (PV production only)	
COMPATABILITY		
IQ System Controller	SC200D111C240US01, SC200G111C240US01, EP200G101-M240US01, EP200G101-M240US00	
IQ Battery	IQBATTERY-5P-1P-NA, ENCHARGE-3T-1P-NA, ENCHARGE-10T-1P-NA	
Microinverter	IQ6, IQ7, and IQ8 Series Microinverters	



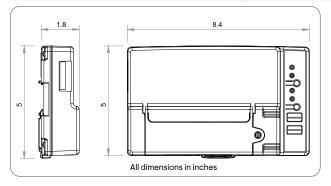

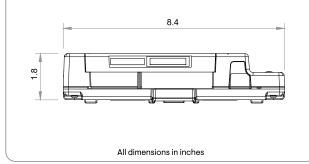Accessories



Enphase Mobile Connect

4G-based LTE-M1 cellular modem with a 5-year data plan (CELLMODEM-M1-06-SP-05 for Sprint and CELLMODEM-M1-06-AT-05 for AT&T) Druit lines

n)

Circuit breakers

BRK-10A-2-240V Circuit breaker, 2-pole, 10 A, Eaton BR210 BRK-15A-2-240V Circuit breaker, 2-pole, 15 A, Eaton BR215 BRK-20A-2P-240V Circuit breaker, 2-pole, 20 A, Eaton BR220 BRK-15A-2P-240V-B Circuit breaker, 2-pole, 15 A, Eaton BR215B with hold-down kit support BRK-20A-2P-240V-B Circuit breaker, 2-pole, 20 A, Eaton

CT-200-SOLID



200 A revenue grade solid core Production CT with <0.5% error rate (replacement SKU)



CT-200-CLAMP

BR220B with hold-down kit support

200 A clamp-style consumption and battery metering CT with <2.5% error rate (replacement SKU)

Revision history



REVISION	DATE	DESCRIPTION
DSH-00111-3.0	December 2023	Updated power requirement and added IG Gateway breaker values.
DSH-00111-2.0	August 2023	Updated temperature specification for ENV2-IQ-AM1-240.
DSH-00111-1.0	June 2023	Updated altitude and recommended maximum microinverters on a site.


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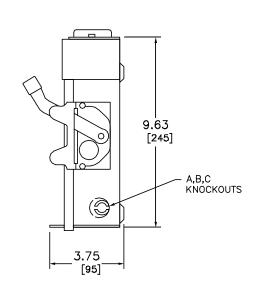
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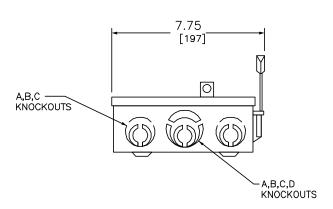
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SS







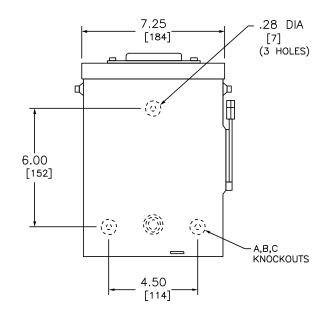

NEMA TYPE 3R

WIRIN	IG DIAGRAMS
NO	T FUSIBLE
A /-/	B /-/-/

TERMINAL LUGS ‡								
AMPERES	MAX. WIRE	MIN. WIRE	TYPE					
60	# 2 AWG # 2 AWG	#10 AWG #14 AWG	AL CU					

KNOCKOUTS									
SYMBOL	Α	В	С	D					
CONDUIT SIZE	.50	.75	1	1.25					

DUAL DIMENSIONS: INCHES MILLIMETERS

			HORSEPOWER RATINGS			
CATALOG	VOLTAGE DATINGO	WIRING DIAG.	240VAC			
NUMBER	VOLTAGE RATINGS		MAX.			
			1 Ø	3Ø		
DU222RB	240VAC	Α	10	-		
DU322RB	240VAC	В	10	15		

NOTES:

FINISH - GRAY BAKED ENAMEL

UL LISTED - FILE E-2875

SUITABLE FOR USE AS SERVICE EQUIPMENT

TOP OF NEMA TYPE 3R SWITCHES HAVE PROVISIONS FOR MAXIMUM 2 1/2" BOLT-ON HUB.

SHORT CIRCUIT CURRENT RATINGS:

10,000 AMPERES WHEN USED WITH OR PROTECTED BY CLASS H OR K FUSES

100,000 AMPERES WHEN USED WITH OR PROTECTED BY CLASS R FUSES.

‡ LUGS SUITABLE FOR 60°C OR 75°C COPPER OR ALUMINUM CONDUCTORS.

GENERAL DUTY SAFETY SWITCHES VISIBLE BLADE TYPE 60 AMPERE ENCLOSURE - NEMA TYPE 3R RAINPROOF SQUARE D Schneider Electric

DWG# 1861

DECEMBER 2004

REF DWG #1861

A. System Specifications and Ratings

Maximum Voltage: 1,000 Volts

Enclosure Rating: Type 3R Roof Slope Range: 2.5 – 12:12

Max Side Wall Fitting Size: 1"

Max Floor Pass-Through Fitting Size: 1"

Allowable Wire: 14 AWG - 6 AWG

JB-1.2, JB-1.XL

Specification Sheet

PV Junction Box for Composition/Asphalt Shingle Roofs

EZ#SOLAR

PHONE: 385-202-4150 WWW.EZSOLARPRODUCTS.COM



ITEM NO. PART NUMBER DESCRIPTION QTY POLYCARBONATE JB-1.2 BODY WITH UV INHIBITORS POLYCARBONATE JB-1.2 LID WITH UV INHIBITORS #10 X 1-1/4" PHILLIPS 3 PAN HEAD SCREW #8 X 3/4" PHILLIPS 4

SCALE: 1:2	WEIGHT	SHEET 1 OF 3	
TORQUE SPECII	FICATION:	15	5-20 LBS
CERTIFICA	TION:		1, NEMA 3R 2.2 No. 290
WEIGH [*]	Γ:	1.	45 LBS

JB-1.2

B

PAN HEAD SCREW

Compliance:

- JB-1.2: UL1741, CSA C22.2 No. 290; JB-1.XL: UL1741, CSA C22.2 No. 290

Spacing: Please maintain a spacing of at least 1/2" between uninsulated live parts and fittings for

- Approved wire connectors: must conform to UL1741, CSA C22.2 No. 290



System Marking: Interek Symbol and File #5019942

Ambient Operating Conditions: (-35°C) - (+75°C)

Periodic Re-inspections: If re-inspections yield loose components, loose fasteners, or any corrosion between components, components that are found to be affected are to be replaced immediately.

Table 1: Typical Wire Size, Torque Loads and Ratings


Maximum Current: JB-1.2: 80 Amps; JB-1.XL: 120 Amps


conduit, armored cable, and uninsulated live parts of opposite polarity.

	1 Conductor	2 Conductor			Torque		
	Conductor	2 Conductor	Туре	NM	Inch Lbs	Voltage	Current
ABB ZS6 terminal block	10-24 awg	16-24 awg	Sol/Str	0.5-0.7	6.2-8.85	600V	30 amp
ABB ZS10 terminal block	6-24 awg	12-20 awg	Sol/Str	1.0-1.6	8.85-14.16	600V	40 amp
ABB ZS16 terminal block	4-24 awg	10-20 awg	Sol/Str	1.6-2.4	14.6-21.24	600V	60 amp
ABB M6/8 terminal block	8-22 awg		Sol/Str	.08-1	8.85	600V	50 amp
Ideal 452 Red WING-NUT Wire Connector	8-18 awg		Sol/Str	Self-Torque	Self-Torque	600V	
Ideal 451 Yellow Wing Connector	10-18 awg		Sol/Str	Self-Torque	Self-Torque	600V	
Ideal, In-Sure Push-In Connector	10-14 awg		Sol/Str	Self-Torque	Self-Torque	600V	
WAGO, 2204-1201	10-20 awg	16-24 awg	Sol/Str	Self-Torque	Self-Torque	600V	30 amp
WAGO, 221-612	10-20 awg	10-24 awg	Sol/Str	Self-Torque	Self-Torque	600V	30 amp
Dottie DRC75	6-12 awg		Sol/Str	Snap-In	Snap-In		
ESP NG-53	4-6 awg		Sol/Str		45	200	101/
LSI 110-33	10-14 awg		Sol/Str		35	200	JUV
ESP NG-717	4-6 awg		Sol/Str		45	000	2017
ESI NG-717	10-14 awg		Sol/Str		35	200	JU V
Brumall 4-5.3	4-6 awg		Sol/Str		45	2000)O) (
Diaman +-0,0	10-14 awg		Sol/Str		35	200	JUV

Table 2: Minimum wire-bending space for conductors through a wall opposite terminals in mm (inches)

		Wires per terminal (pole)							
Wire size, AWG or	1	2	3	4 or More					
kcmil (mm2)	mm (inch)	mm (inch)	mm (inch)	mm (inch)					
14-10 (2.1-5.3)	Not Specified	-	-	-					
8 (8.4)	38.1 (1-1/2)	-	-	-					
6 (13.3)	50.8 (2)	-	-	-					

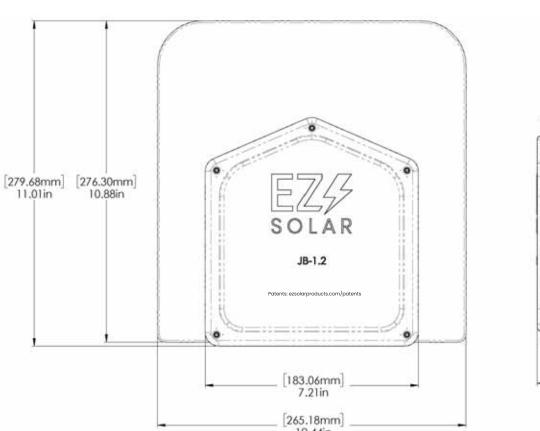

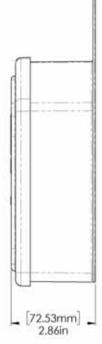

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RIGID PVC CONDUIT FITTINGS

ISSUE DATE:

SUPERCEDES:

REMPLACE:

DATE D'EMISSION: 2009 04 30

2004 07 15

RIGID PVC CONDUIT FITTINGS

JB444 JUNCTION BOXES


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DATE D'EMISSION: 2009 04 30

SUPERCEDES:

REMPLACE: 2004 07 15



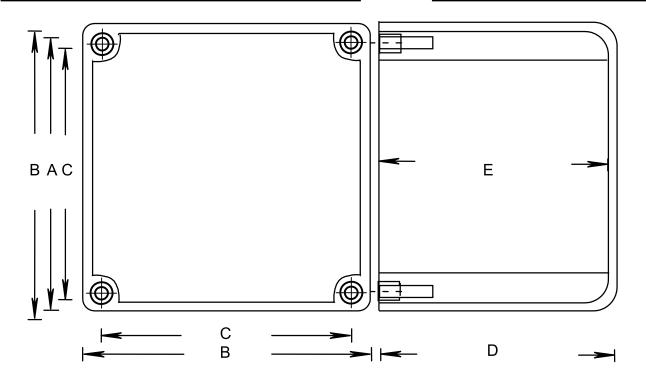


PRODUCT	PART	NOMINAL	SIZE	Α		В		С	
CODE	NUMBER	(in)	(mm)	(in)	(mm)	(in)	(mm)	(in)	(mm)
076668	J444 STAHLIN	4	103	3.675	93	4.000	102	3.450	88
076259	AMJB444 ALLIED	4	103	3.675	93	4.000	102	3.450	88
077643*	2037-424T CANLET	4	103	3.675	93	4.000	102	3.450	88
077696	JB 444	4	103	4.000	101	4.395	112	3.950	101

PRODUCT	PART	NOMINAL SIZE		D		E		VOLUME	
CODE	NUMBER	(in)	(mm)	(in)	(mm)	(in)	(mm)	(cu. ln)	(cu. Cm)
076668	J444 STAHLIN	4	103	4.180	106.	3.850	98	51.5	844.6
076259	AMJB444 ALLIED	4	103	4.180	106	3.850	98	51.5	844.6
077643*	2037-424T CANLET	4	103	4.180	106	3.850	98	51.5	844.6
077696	JB 444	4	103	4.170	106	3.930	100	51.5	844.6


PRODUCT	PART	NOMINAL SIZE		GASKET	INSERT	SCREW	M.FEET
CODE	NUMBER	(in)	(mm)	CODE	CODE	CODE	CODE
076668	J444 STAHLIN	4	103		072538 (4)		
076259	AMJB444 ALLIED	4	103		072538 (4)		
077643*	2037-424T CANLET	4	103		072538 (4)		
077696	JB 444	4	103	097731	072538 (4) 072539 (2)	072522 (4) 072513 (2)	097747

^{*} BOX WITH MOLDED MOUNTING FEET, INSERT ONLY; NO COVER, OR GASKET, UL LISTED 576J

COVER DIMENSIONS

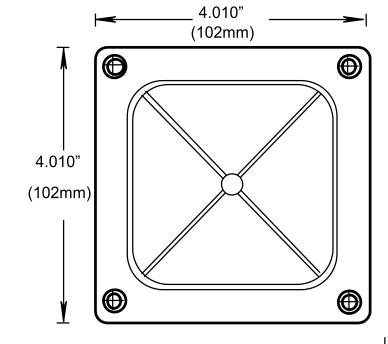



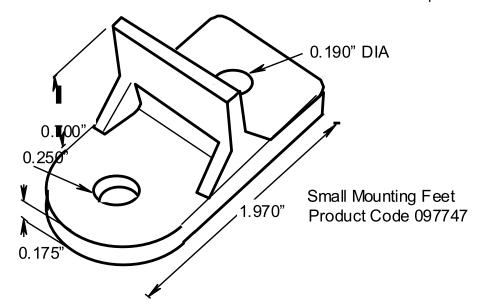

DRAWING NUMBER

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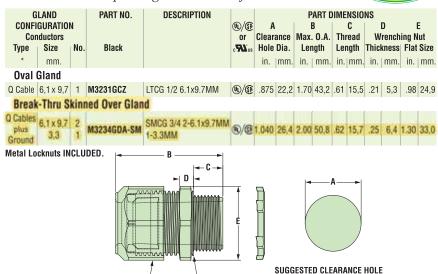
a PennEngineering® Company

Heyco®-Tite Liquid Tight Cordgrips for Enphase Q Cables

Straight-Thru, NPT Hubs with Integral Sealing Ring

The Ultimate in Liquid Tight Strain Relief Protection





Material
Certifications
Certificatio

INTEGRAL
SEALING RING

Heyco[®] Helios[®] UVX Clip – Blind Mount

SEALING NUT-



FOR NONTHREADED MOUNTING

PANEI	L THICK mum		RANGE imum	WIRE DIAMETER Range 1-2 Wires	PART NO.	DESCRIPTION	HOLI	NTING E DIA. A	OVERALL HEIGHT C	
in.	mm.	in.	mm.				in.	mm.	in.	mm.
1-2	Wires	3								
.028	0,7	.250	6,4	.23 (5,8 mm)32 (8,0 mm) each cable	\$6520 \$6560	Helios UVX Clip 100 Pack Helios UVX Clip Bulk	.260	6,6	.96	24,4
			c 			MOUNTING HOL	.E			

Material Nylon 6/6 with extended UV Capabilities Flammability Rating 94V-2

Temperature Range Dynamic -4°F (-20°C) to 185°F (85°C)



- The 1/2" version provides liquid tight entry for one Enphase Q Cable – .24 x .38" (6,1 x 9,7 mm).
- The 3/4" version provides liquid tight entry for up to two Enphase Q Cables – .24 x .38" (6,1 x 9,7 mm) and an additional .130" (3,3 mm) dia. hole for a #8 solid grounding cable.
- The 3/4" version utilizes our skinnedover technology so any unused holes will retain a liquid tight seal.
- Rated for use with DG Cable.



- The jersey pine tree mounting style installs easily with superior holding
- UVX nylon protects from corrosion due to outdoor exposure.
- Installs into .260" (6,6 mm) mounting hole.
- Holds up to 2 cables between .230 .315" (5,8 8,0 mm) each.
- Cables install with fingertip pressure.
- Molded from our robust UVX nylon 6/6 with extended UV capabilities for our Solar 20 Year Warranty.

DRAWING NUMBER:

SS

BLUE RAVEN

Carlon

Carlon Non-Metallic Junction Boxes

Molded Non-Metallic Junction Boxes — 6P Rated

Non-metallic junction boxes are UL® Listed with a NEMA 6P rating per Section 314.28 of the National Electrical Code® and CSA Certified per Section 12 of the Canadian Electrical Code. Manufactured from PVC or PPO thermoplastic molding compound and featuring foam-in-place gasketed lids attached with stainless steel screws, these rugged enclosures offer all the corrosion resistance and physical properties you need for direct burial applications.

Type 6P enclosures are intended for indoor or outdoor use, primarily to provide a degree of protection against contact with enclosed equipment, falling dirt, hosedirected water, entry of water during prolonged submersion at a limited depth and

· All Carlon® Junction Boxes are UL® Listed/CSA Certified and maintain a minimum of a NEMA Type 4/4x Rating

(0

· Part numbers with an asterisk (*) are UL® Listed and maintain a NEMA Type 6P Rating and Type 4/4X Rating






Enclosures

80

Junction Boxes



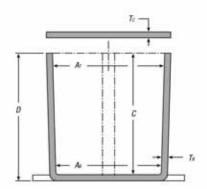

CAT. NO.	SIZE (IN.) H x W x D	STD. CTN.	DIMENSIONS (IN.)					MATERIAL			
			MIN A:	MIN As	MIN B	MIN C	Ta	Te	PVC	THERMO- PLASTIC	STD, WT. (LBS.)
E989NNJ*	4x4x2	10	3%	3%	N/A	2	.160	.155	X		3
E987N*	4×4×4	10	311/4	31/2	N/A	4	.160	.155	X		4
E989NNR*1	4x4x6	10	3'%	3%	N/A	6	.160	.200	X		5
E989PPJ*	5x5x2	10	4%	416	N/A	2	.110	.150		Х	3
E987R-CAR*	6x6x4	2	6	5%	N/A	4	.190	.190		X	3
E989RRR-UPC*	6×6×6	8	5%	5%	N/A	6	.160	.150		Х	14
E989N-CAR	8x8x4	1	8	8	N/A	4	.185	.190		X	2
E989SSX-UPC	8x8x7	2	7%	7%	N/A	7	.160	.150		X	6
E989UUN	12 x 12 x 4	3	11%	11%	11%	4	.160	.150		X	12
E989R-UPC	12 x 12 x 6	2	11%	11%	113%	6	.265	.185		X	10

^{*} LR. Listact


NEC and National Electrical Code are registered trademarks of the National Fire Protection Association, Inc.

www.tnb.com

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Thomas@Betts

A-269

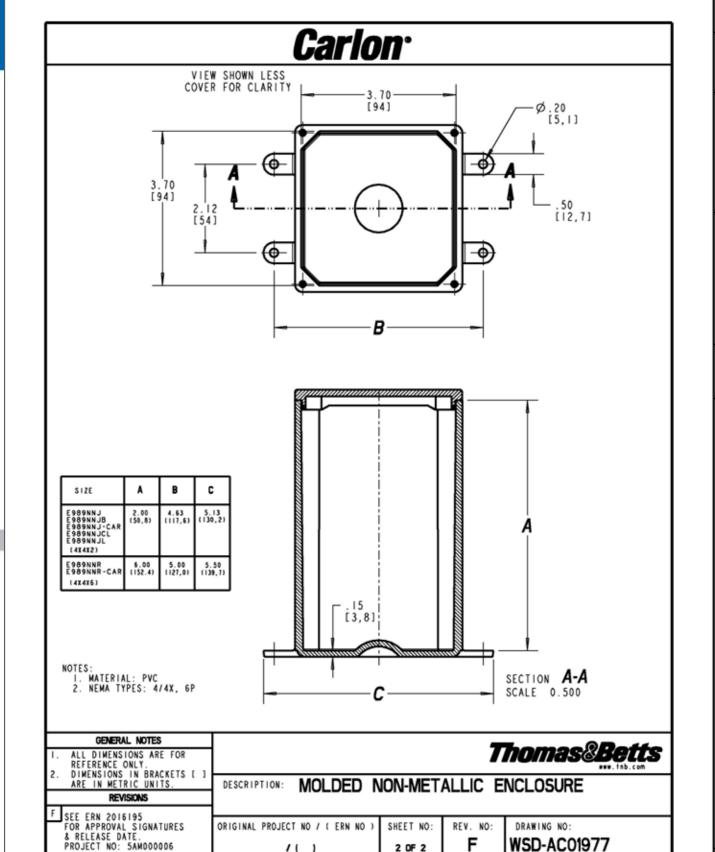

2 OF 2

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PV INSTALLATION PROFESSIONAL

Scott Gurney #PV-011719-015866

CONTRACTOR: **BRS FIELD OPS** 385-498-6700

SPEC SHEETS

REVISION: PAGE NUMBER:

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SS

¹ Not CSA Certified



RAIL SYSTEM

PEGASUS

RAIL SYSTEM





bonds row to row with no tools.

One Clamp Anywhere





Lifetime Wire Management

Open rail channel holds and protects wires. Clamps won't pinch wires after tightening.

The N-S Bonding Jumper



Available in 14' and 7' lengths for easy layout and shipping.

Open-channel design holds MC4 connectors, PV wire and trunk cables. Black and Mill finish





Pegasus Max Rail

Maximum-strength design. Meets specifications for high snow-load and hurricane zones. Black and Mill finish





Splice and Max Splice

Works over mounts. Structurally connects and bonds rails automatically; UL2703 listed as reusable.

Installs by hand.



Dovetail T-bolt

Dovetail shape for extra strength. Uses ½" socket.



Multi-Clamp

Fits 30-40mm PV frames, as mid- or

Twist-locks into position; doesn't pinch

Bonds modules to rail; UL2703 listed as reusable



Hidden End Clamp

Offers premium edge appearance. Preinstalled pull-tab grips rail edge, allowing easy, one-hand installation. Tucks away for reuse.

Ground Lug

Holds 6 or 8 AWG wire. Mounts on top or side of rail. Assembled on MLPE Mount. UL2703 listed as reusable.

N-S Bonding Jumper

Installs by hand, eliminates row-to-row copper wire.

UL2703 listed as reusable only with Pegasus Rail.







Secures and bonds most micro-inverters

MLPE Mount

and optimizers to rail. Connectors and wires easily route underneath after installation

UL2703 listed as reusable

• UL 2703, Edition 1

• LTR-AE-001-2012 • ASCE 7-16 PE certified

Certifications:

Cable Grip

Secures four PV wires or two trunk cables.

Stainless-steel backing provides Eliminates sagging wires.

Wire Clip

Hand operable Holds wires in channel. Won't slip.





End Cap and Max End Cap

Fits flush to PV module and hides raw or angled cuts.

Hidden drain quickly clears water from rail.

Next-Level Solar Mounting

A complete system for hassle-free rooftop installation, from watertight mounts to lifetime wire management.



Simplicity

1/2"socket for everything. One clamp for mid or end. No tool splicing and bonding. Easy wire management.



Code Compliant

UL 2703 listed LTR-AE-001-2012 listed Class A fire rating for any slope ASCE 7-16 PE Certified FL Cert of Approval FL41396



Premium Aesthetics

The narrowest panel gap available. Optional Hidden End Clamps and End Caps provide a flush look on the edge of the array.



Bonding Structural Splice

Connect rails instantly, without

tools, interference or limitations.

Watertight for Life

Secured on industry-leading Pegasus Mounts, for composite shingle and tile roofs. Backed by a 25-year warranty.




FREE PEGASUS SOLAR Design Tool

• FL Cert of Approval FL41396

Quickly calculate the most efficient layout, spans and materials needed to suit your job. Visit the Pegasus Customer Portal. pegasussolar.com/portal

• Class A fire rating for any slope roof

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For reference only. Spans above are calculated using 7-16 for a Gable Roof, Exposure Category B, 0-20deg roof angle, 30ft mean roof height with non-exposed modules. For PE certified span tables, visit www.pegasussolar.com/spans.
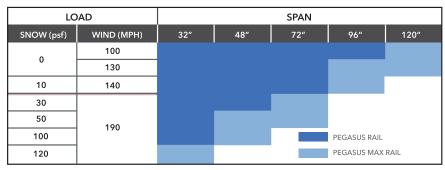
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Appendix A - Compatible PV Mod-

Pegasus Rail System may be used to ground a PV module complying with UL 2703 only when the specific module has been evaluated for grounding and/or mounting in compliance with this installation manual. Unless otherwise specified, "xxx" refers to the power rating of the PV module. Both black & silver frames are included in the UL2703 listing.



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Mission Solar	MSE60Axxx; MSExxxSB1A; MSExxxSQ6J; MSExxxSQ5K; MSExxxSQ5T; MSExxxSQ8K; MSExxxSQ8T; MSExxxSQ8T; MSExxxSQ9S; MSExxxSQ6S; MSExxxSX6S; MSExxxS			
Mitrex	Moox-L3H; Moox-H1H; Moox-B1F; Moox-A1F			
mSolar	TXI10-xxx10888			
Panasonic	VBHNxxxXA01; VBHNxxxXA03; VBHNxxxXA16; VBHNxxxXA168; VBHNxxxXA17; VBHNxxxXA17E; EVPVxxx; EVPVxxxX; EVPVxxxXF; EVPXxxXF; EVPXxXXXF; EVPXxXXXF; EVPXxXXXF; EVPXxXXXF; EVPXxXXXF; EVPXxXXXXF; EVPXxXXXXXXXXXXXXXXXXXXXXXXXXXXXXXXXXXXX			
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been evaluated for grounding and/or mounting in compliance with this installation manual. Unless otherwise specified, "xxxx" refers to the power rating of the PV module. Both black & silver frames are included in the UL2703 listing. Pegasus Rail System may be used to ground a PV module complying with UL 2703 only when the specific module has



BLUE RAVEN

1anufacturer	Model				
EC	RECooxPP; RECooxPP Black; RECooxPE; RECooxPE 72; RECooxPE (BLK); RECooxTP; RECooxTP BLK; RECooxTP2 BLK; RECooxTP2 BLK2; RECooxTP2 BLK2; RECooxTP2 BLK2; RECooxTP2 BLK2; RECooxP2 Black; RECoox				
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le le	TP6L60M; TP6L60M(H); TP7F60M; TP7F60M(H); TP7F54M; TP7F54M				
sla	SC31582; SCxxx; SCxxxB1; SCxxxB2; TxxxS; TxxxH; SxxxH				
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Rev 31 23 www.pegasussolar.com www.pegasussolar.com



INSTAFLASH° 2



The Ultimate Comp Roof Attachment

Simple to use. Works for rafter or deck attach. No caulking, no ripped shingles, no mess. Pre-installed sealant acts as a chemical flashing and fills all gaps, voids, and butt joints for an instant, watertight seal.



25-Year Warranty

Manufactured with advanced materials and coatings to outlast the roof itself



Code Compliant

Fully IBC/CBC Code Compliant Exceeds ASCE 7-22 Standards UL2703 Certified



Self-Healing

Proprietary non-hardening sealant will flex and reseal over years of thermal expansion



Larger Spans

Extra-large L-foot and proprietary screws result in larger spans between mounts

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PEGASUS

INSTAFLASH 2


















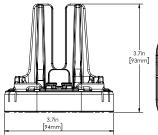

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SPECIFICATIONS		INSTAFLA	ASH KITS			
	PIF2-B0	PIF2-BDT	PIF2-M0	PIF2-MDT		
Finish	В	lack	Mill			
Kit Contents	Black InstaFlash2	Black InstaFlash2, Dovetail T-bolt	Mill InstaFlash2	Mill InstaFlash2, Dovetail T-bolt		
Attachment Type	Rafter & Deck Attach					
Roof Fasteners	1/2" Socket Driven; PF-DRW85 (sold separately in boxes of 24)					
Roof Type	Sloped Roof: Composition Shingle, Rolled Asphalt Flat Roof: Modified Bitumen Roof, Built-Up Roof					
Flashing Type	Factory Installed Non-Drying, Non-Skinning Butyl Based Chemical Flashing					
Installation Temperature	0° F to 170° F					
Cure Time	Instantly Waterproof; Non-Hardening					
Service Temperature	-40° F to 195° F					
Certifications	IBC, ASCE/SEI 7-16 & 7-22, UL2703					
Install Application	Most Railed Systems					
Kit Quantity	24					
Boxes Per Pallet	36					

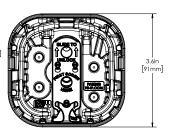

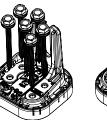

SCAN FOR INSTALLATION VIDEO



SCAN FOR FREE TRIAL

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FLASHLOC™ RM

THE STRONGEST ATTACHMENT FOR EVERY FLAT ROOF

has been successfully completed for assurance of long-term reliability.

FLASHLOC[™] Technology – no more membrane SKUs or heat welding • Works for all roof types – see Chemlink M-1's compatibility for details

• Attachment can accommodate roofing screw sizes #12 - #15



■■UNIRAC FLASHLOC™ RM



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CONTRACTOR: **BRS FIELD OPS**

385.498.6700

STEP ONE CLEAN SURFACE AND MARK LOCATION

-IMPORTANT: Thoroughly clean roof surface with isopropyl alcohol or denatured alcohol. Bonding surfaces should be clean, dry and free of dirt or contamination. Remove all previously applied caulk, mastic or other contaminants with a wire brush. Brush away all gravel or loose granules.

-Mark center point locations on the roof. NOTE: We recommend locating Flashloc RM after your equipment has been installed or layout is confirmed.

STEP 1

STEP TWO APPLY M1 SEALANT

-Apply a 5/16" bead of Chemlink M1 sealant to the entire bottom perimeter AND to the bottom of each bolt location to be used. Tool M1 sealant bead to form a smooth surface along the entire bottom perimeter. Refer to Chemlinks application guidelines with temperatures below 40 degrees F.

-IMPORTANT: CHEMLINK TPO PRIMER MUST BE USED ON TPO SINGLE-PLY ROOF SUBSTRATES MEMBRANES PRIOR TO INSTALLATION.

STEP 2

PRODUCT SPECIFICATIONS

Labor and attachment savings.

Industry-leading install time

6,600-lb. uplift offset (ultimate)

Includes 8 fastener holes

25-year warranty

7.5" diameter X 0.94" height

FEATURES

• Included hardware: 1 preassembled bolt and washer

Chemlink M-1 and 1-Part included in kit



^{*}Check with your local distributor for finalized pricing.





SECURE ATTACHMENT

STEP THREE SECURE ATTACHMENT

- Align mount using alignment marks on roof and base. Using fasteners specified by your P.E. of record, securely fasten attachment to the roof. Drive screws down until the base is firmly attached to the roof and the M1 sealant expands beyond the outer perimeter of the base.
- Tool M1 sealant bead around entire perimeter to form a smooth fillet. TIP: Use caution to avoid over-torqueing the screws.



FILL WITH CHEMLINK 1-PART & PLACE CAP

STEP FOUR FILL BASE WITH CHEMLINK 1-PART

- -Completely fill base with Chemlink 1-Part sealant. Sealant must completely cover all screw heads. Do NOT overfill.
- Place cap on base and secure racking to mount with Unirac provided 3/8" hardware or other 3/8"-16 threaded hardware as specified by the P.E. of record.
- -IMPORTANT: To ensure robust sealing over the life of the product, the maximum allowed gap between attachment kit strut and the top surface of the flat roof attachment is 1/16".



FOR QUESTIONS OR CUSTOMER SERVICE VISIT UNIRAC.COM OR CALL (505) 248-270

FOR QUESTIONS OR CUSTOMER SERVICE VISIT UNIRAC.COM OR CALL (505) 248-2702

SPEC SHEET GE NUMBER

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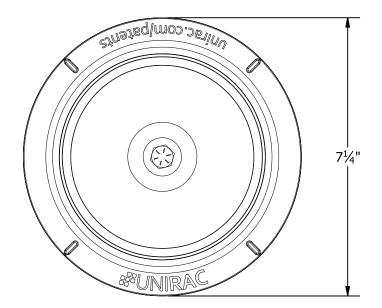
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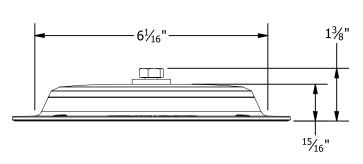
CLEAN SURFACE & MARK LOCATION

NOTES:


- 1. ATTACHMENT CAN ACCOMMODATE ROOFING SCREW SIZES #12 #15. FASTENER SIZE, LENGTH, AND QUANTITY TO BE SELECTED BY STRUCTURAL ENGINEER OF RECORD WHEN DESIGNING FOR THE SPECIFIC PROJECT CONSTRUCTION AND CAPACITY.
- 2. REFER TO THE UNIRAC INSTALLATION GUIDE FOR PROPER USE OF CHEM LINK M1 AND ONE-PART SEALANTS FOR WATER TIGHT INSTALLATION.



TOP VIEW



PART # TABLE				
P/N DESCRIPTION				
310999	FLASHLOC RM KIT			

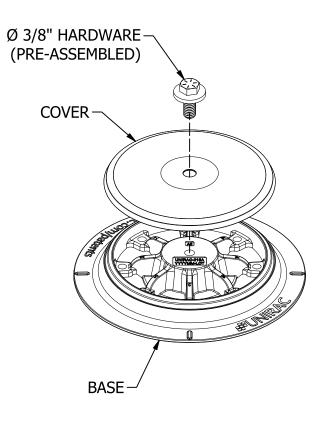

ULTIMATE TEST LOAD (WITH 8 ROOF FASTENERS)

UPLIFT ULTIMATE CAPACITY	6,670 lbs.
SHEAR ULTIMATE CAPACITY	5,760 lbs.



PRODUCT LINE:	RM
DRAWING TYPE:	ASSEMBLY DETAIL
DESCRIPTION:	FLASHLOC RM KIT
REVISION DATE:	6/26/2020

DRAWING NOT TO SCALE ALL DIMENSIONS ARE NOMINAL

PRODUCT PROTECTED BY ONE OR MORE US PATENTS LEGAL NOTICE

RMF-A01



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PV-011719-015866

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SPEC SHEET

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