

PHOTOVOLTAIC ROOF MOUNT SYSTEM

21 MODULES-ROOF MOUNTED - 8.925 kW DC, 6.090 kW AC

373 WINDING CRK DR, LILLINGTON, NC 27546

PROJECT DATA	GENERAL NOTES	VIC
		64
PROJECT 373 WINDING CRK DR, ADDRESS LILLINGTON, NC 27546	1. ALL COMPONENTS ARE UL LISTED AND NEC CERTIFIED, WHERE WARRANTED.	
	2. THE SOLAR PV SYSTEM WILL BE INSTALLED IN ACCORDANCE WITH ARTICLE 690 OF THE NEC 2020.	421 1
OWNER: JACOB WALTERS	3. THE UTILITY INTERCONNECTION APPLICATION MUST BE APPROVED AND PV SYSTEM INSPECTED PRIOR TO PARALLEL OPERATION.	Sanfo
PARCEL ID: 11066201 0027 16	4. ALL CONDUCTORS OF A CIRCUIT, INCLUDING THE EGC, MUST BE INSTALLED IN THE SAME RACEWAY, OR CABLE, OR OTHERWISE RUN WITH THE PV ARRAY CIRCUIT CONDUCTORS WHEN THEY LEAVE THE VICINITY OF THE PV ARRAY.	ant
DESIGNER: ESR	5. WHERE METALLIC CONDUIT CONTAINING DC CONDUCTORS IS USED INSIDE THE BUILDING, IT SHALL BE IDENTIFIED AS "CAUTION: SOLAR CIRCUIT" EVERY 10FT.	
SCOPE: 8.925 KW DC ROOF MOUNT SOLAR PV SYSTEM WITH	6. HEIGHT OF THE AC DISCONNECT SHALL NOT EXCEED 6'-7" PER NEC CODE 240.24.	
21 JINKO SOLAR: JKM425N-54HL4-B 425W MONO MODULES WITH 21 ENPHASE IQ8PLUS-72-M-US (290W)	7. A GROUNDING ELECTRODE SYSTEM IN ACCORDANCE WITH NEC 2020 690.47 AND 250.50 THROUGH 60 AND 250-166 SHALL BE PROVIDED. PER NEC GROUNDING ELECTRODE SYSTEM OF EXISTING BUILDING MAY BE USED AND BONDED TO THE SERVICE ENTRANCE. IF EXISTING SYSTEM IS INACCESSIBLE OR INADEQUATE A SUPPLEMENTAL GROUNDING ELECTRODE WILL BE USED AT THE INVESTED LOCATION CONSISTING OF A UNUSED AND PORTUGAL CONDING ELECTRODE FOR DOPE	A
MICROINVERTERS	AT THE INVERTER LOCATION CONSISTING OF A UL LISTED 8 FT. GROUND ROD WITH ACORN CLAMP. GROUNDING ELECTRODE CONDUCTORS SHALL BE NO LESS THAN #8 AWG AND NO LARGER THAN #6 AWG COPPER AND BONDED TO THE EXISTING GROUNDING ELECTRODE TO PROVIDE FOR A COMPLETE SYSTEM.	HO
AUTHORITIES HAVING JURISDICTION: BUILDING: HARNETT COUNTY	8. PHOTOVOLTAIC MODULES ARE TO BE CONSIDERED NON-COMBUSTIBLE.	
ZONING: HARNETT COUNTY	9. PHOTOVOLTAIC INSTALLATION WILL NOT OBSTRUCT ANY PLUMBING. MECHANICAL, OR BUILDING ROOF VENTS.	
UTILITY: DUKE ENERGY	10. ALL WIRING MUST BE PROPERLY SUPPORTED BY DEVICES OR MECHANICAL MEANS DESIGNED AND LISTED FOR SUCH USE. WIRING MUST BE PERMANENTLY AND COMPLETELY HELD OFF THE ROOF SURFACE.	
SHEET INDEX	11. ALL SINAGE TO BE PLACED IN ACCORDANCE WITH THE LOCAL BUILDING CODE. IF EXPOSED TO SUNLIGHT, IT SHALL BE UV RESISTANT. ALL PLAQUES AND SINAGE WILL BE INSTALLED AS REQUIRED BY THE NEC AND AHJ.	
PV-1COVER SHEETPV-2PLOT PLAN WITH ROOF PLAN	12. THE INSTALLATION OF EQUIPMENT AND ALL ASSOCIATED WIRING AND INTERCONNECTION SHALL BE PERFORMED ONLY BY QUALIFIED PERSONS [NEC 690.4(C)]	
PV-3ROOF PLAN & MODULESPV-4ELECTRICAL PLANPV-5ATTACHMENT DETAIL	13. ALL OUTDOOR EQUIPMENT SHALL BE NEMA 3R RATED (OR BETTER), INCLUDING ALL ROOF MOUNTED TRANSITION BOXES AND SWITCHES.	
PV-6 ELECTRICAL LINE DIAGRAM	14. ALL EQUIPMENT SHALL BE PROPERLY GROUNDED AND BONDED IN ACCORDANCE WITH NEC ARTICLE 250.	
PV-7 WIRING CALCULATION PV-8 LABELS	15. SYSTEM GROUNDING SHALL BE IN ACCORDANCE WITH NEC 690.41.	
PV-9 PLACARD PV-10 MICROINVERTER CHART	16. PV SYSTEM CIRCUITS INSTALLED ON OR IN BUILDINGS SHALL INCLUDE A RAPID SHUTDOWN FUNCTION IN ACCORDANCE WITH NEC 690.12	
PV-11+ EQUIPMENT SPECIFICATIONS	17. DISCONNECTING MEANS SHALL BE LOCATED IN A VISIBLE, READILY ACCESSIBLE LOCATION WITHIN THE PV SYSTEM EQUIPMENT OR A MAXIMUM OF 10 FEET AWAY FROM THE SYSTEM [NEC 690.13(A)]	CODE R
	18. ALL WIRING METHODS SHALL BE IN ACCORDANCE WITH NEC 690.31	
	19. WORK CLEARANCES AROUND ELECTRICAL EQUIPMENT WILL BE MAINTAINED PER NEC 110.26(A)(1), 110.26(A)(2) AND 110.26(A)(3).	PROJECT TO COMPLY
	20. ROOFTOP MOUNTED PHOTOVOLTAIC PANELS AND MODULES SHALL BE TESTED, LISTED & IDENTIFIED IN ACCORDANCE WITH UL1703	2020 NATIONAL ELECT 2018 NORTH CAROLIN 2018 NORTH CAROLIN
	21. ELECTRICAL CONTRACTOR TO PROVIDE CONDUIT EXPANSION JOINTS AND ANCHOR CONDUIT RUNS AS REQUIRED PER NEC.	2018 NORTH CAROLIN 2018 NORTH CAROLIN
	22. MODULE DOES NOT EXCEED THE SLOPE OF ROOF	
A		1

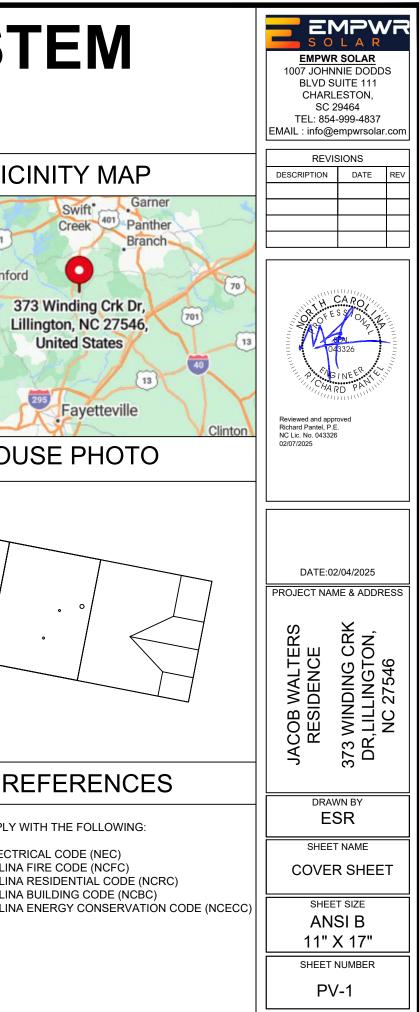

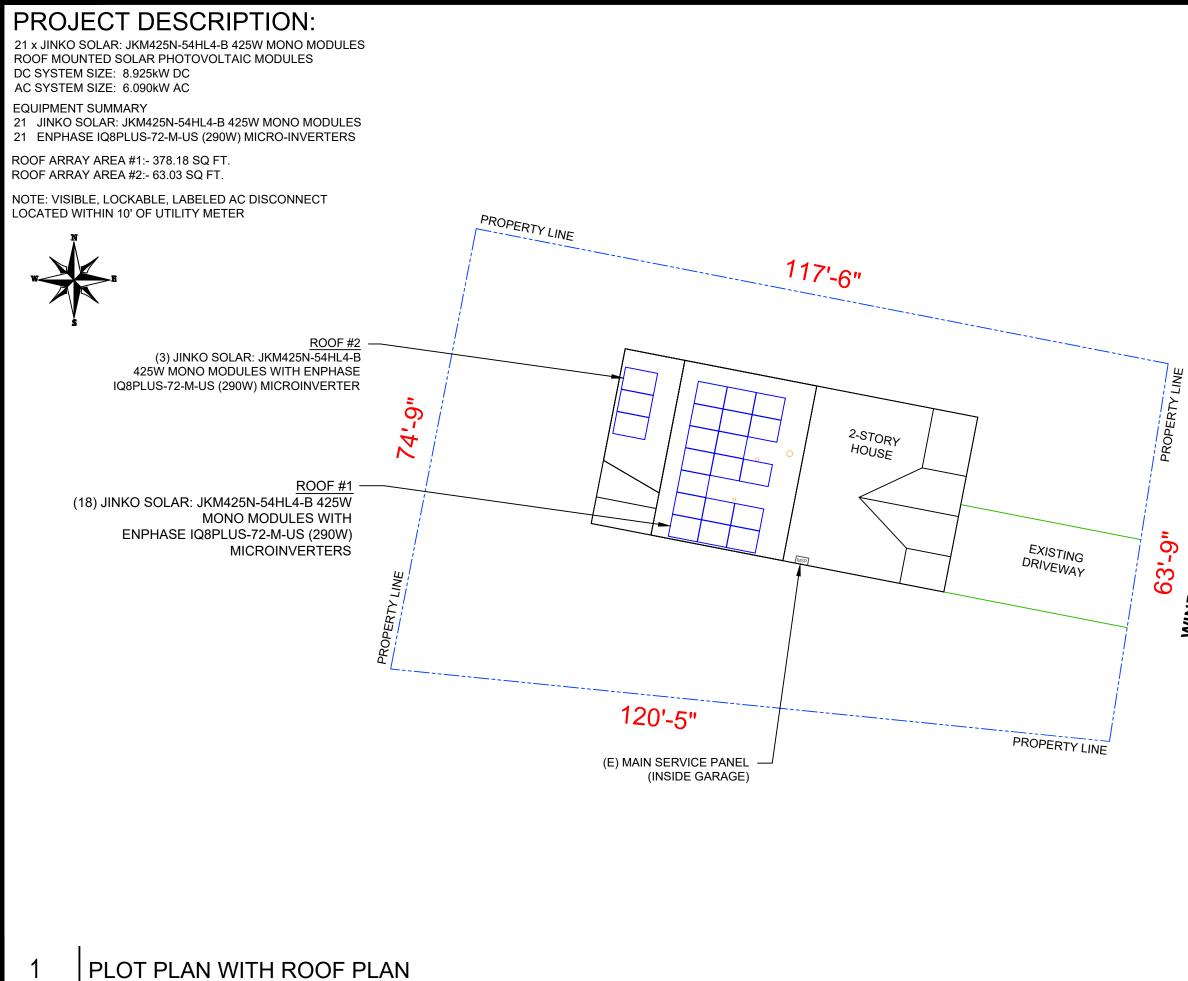


SCALE: 1/16" = 1'-0"

S O EMPWF 1007 JOHN BLVD S CHARL SC 2 TEL: 854 EMAIL : info@d	SIONS	
P CHA	E.	AMAMINING DE
	2/04/2025	
PROJECT NAM		
JACOB WALTERS RESIDENCE	373 WINDING CRK DR,LILLINGTON,	NC 2/ 240
	SR	
PLOT PL ROOF	PLAN	тн
	T SIZE	


11" X 17" SHEET NUMBER


PV-2

WINDING CRK DR

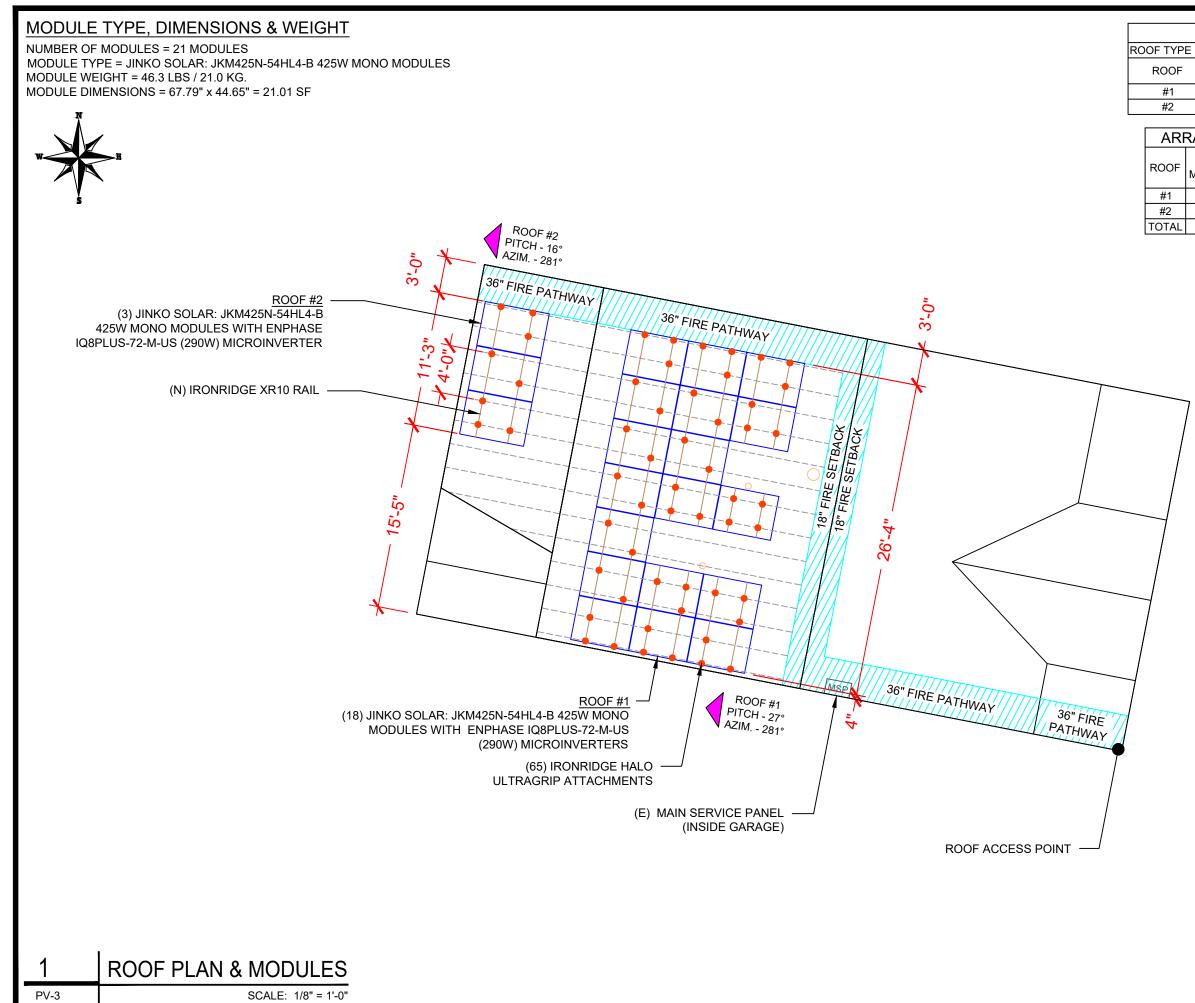


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ROOF I	JESCR	IPTION					
			T SHINGLE				
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PITCH 7	281°	SIZE 2"X6"	SPACING 24"	$\left\{ \left \right. \right \right\}$		UITE 111	-
27° 16°	281°		24"	$\left \right $		ESTON,	
10	201	2"X6"	24"			9464	
	8 000			ן	EMAIL : info@e	-999-4837 empwrsolar	.com
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MODILEEL			Y ARRAY (%)		DESCRIPTION	DATE	REV
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					PROJECT NAM		
		44 162.76	.65"		JACOB WALTERS RESIDENCE	373 WINDING CRK DR,LILLINGTON,	NC 2/ 540
		JKM425N	SOLAR: N-54HL4-B MONO			VN BY SR	
LEG	END		DULES		ROOF	PLAN &	&
MS • [- VE (RO • - RC	AIN SERVIG ENT, ATTIC OF OBSTF DOF ATTAG	RUCTION)		AN: 11" >	t size SI B K 17" NUMBER -3	

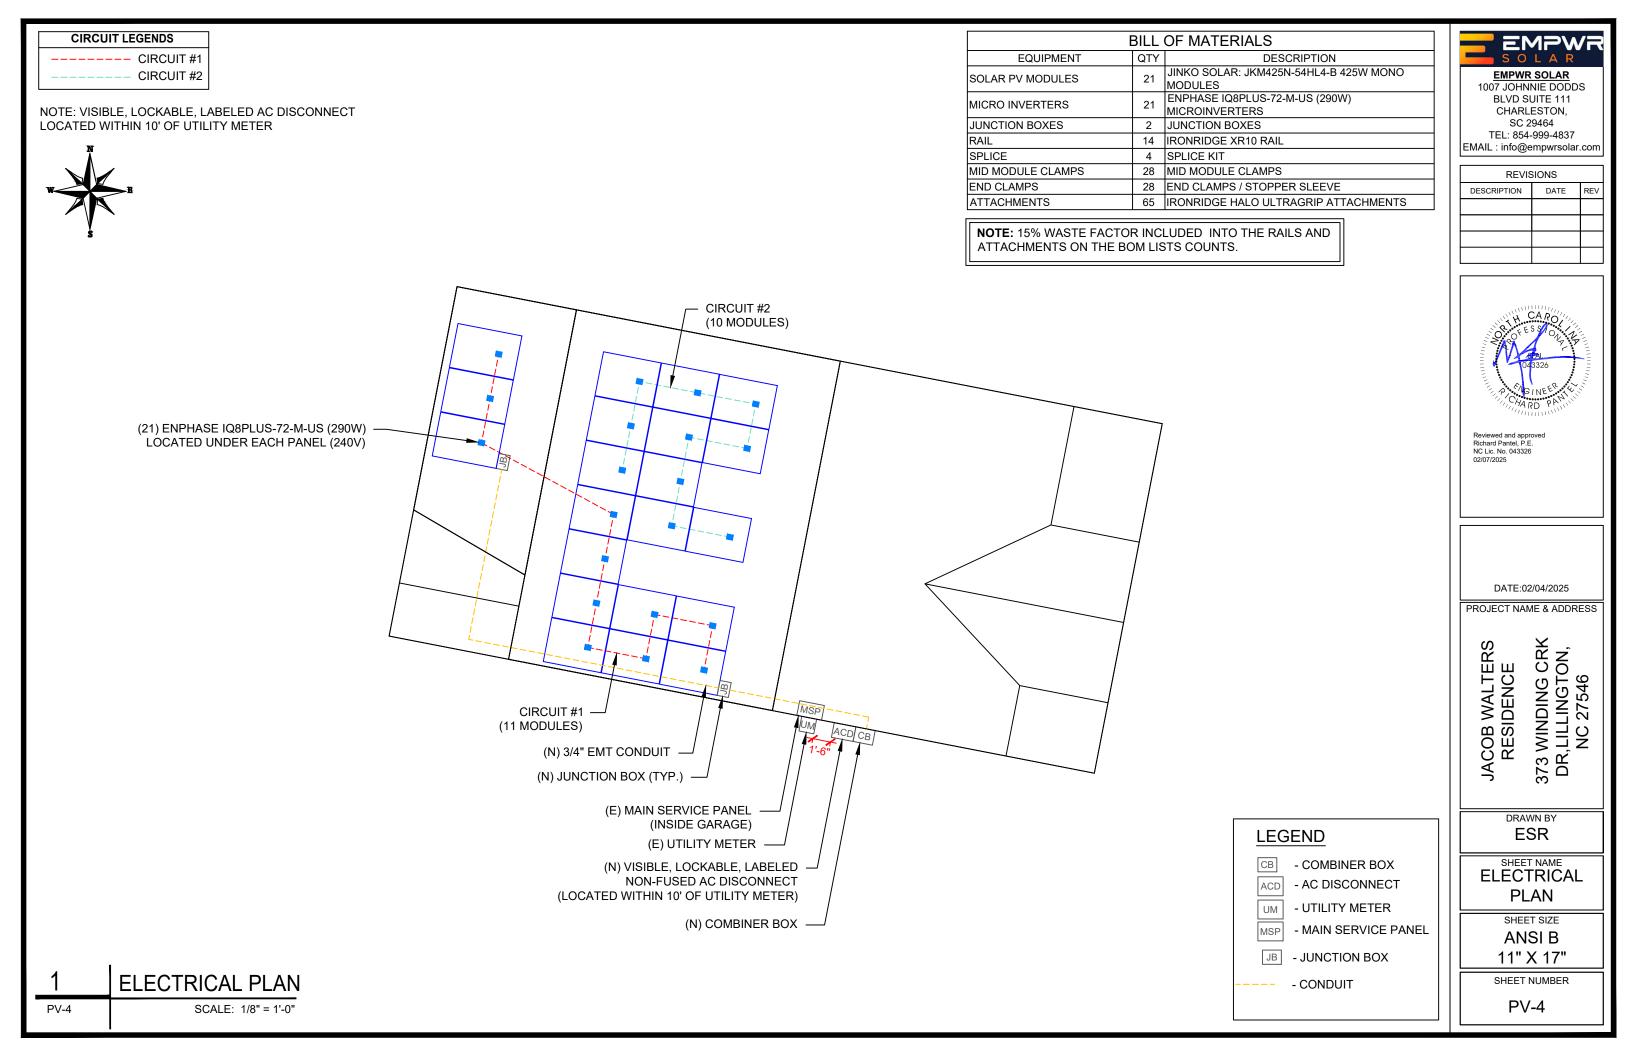

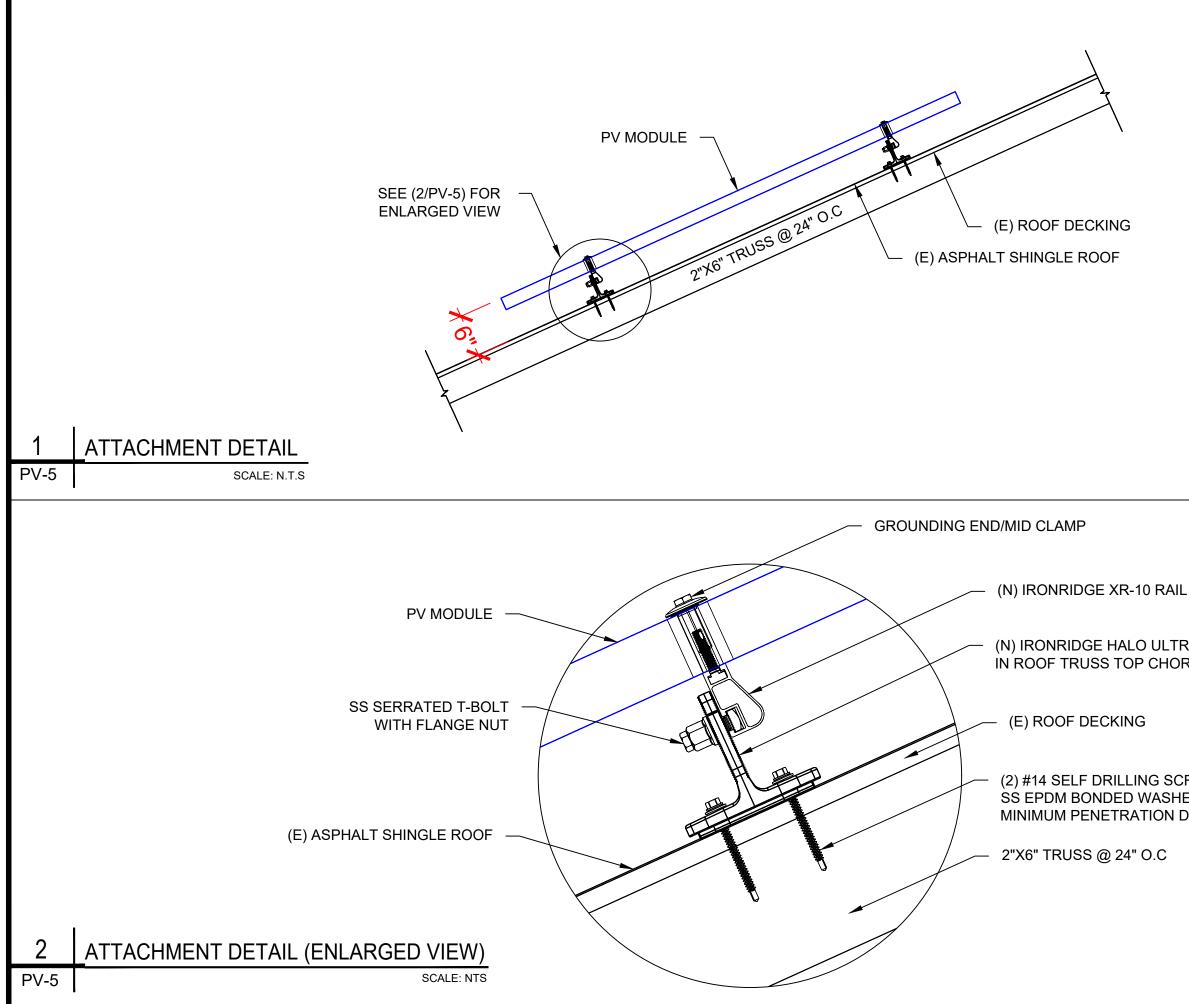

	EMPWR SOLAR 1007 JOHNNIE DODDS BLVD SUITE 111 CHARLESTON, SC 29464 TEL: 854-999-4837 EMAIL : info@empwrsolar.com Image: Comparison of the state of the s
	DATE:02/04/2025 PROJECT NAME & ADDRESS
-	
RAGRIP ATTACHMENT RD ONLY	JACOB WALTERS RESIDENCE 373 WINDING CRK DR,LILLINGTON, NC 27546
REW W/ ER WITH A DEPTH OF 1.75"	DRAWN BY ESR
JEF ITT OF 1.73	SHEET NAME ATTACHMENT DETAIL
	SHEET SIZE ANSI B 11" X 17"
	SHEET NUMBER PV-5

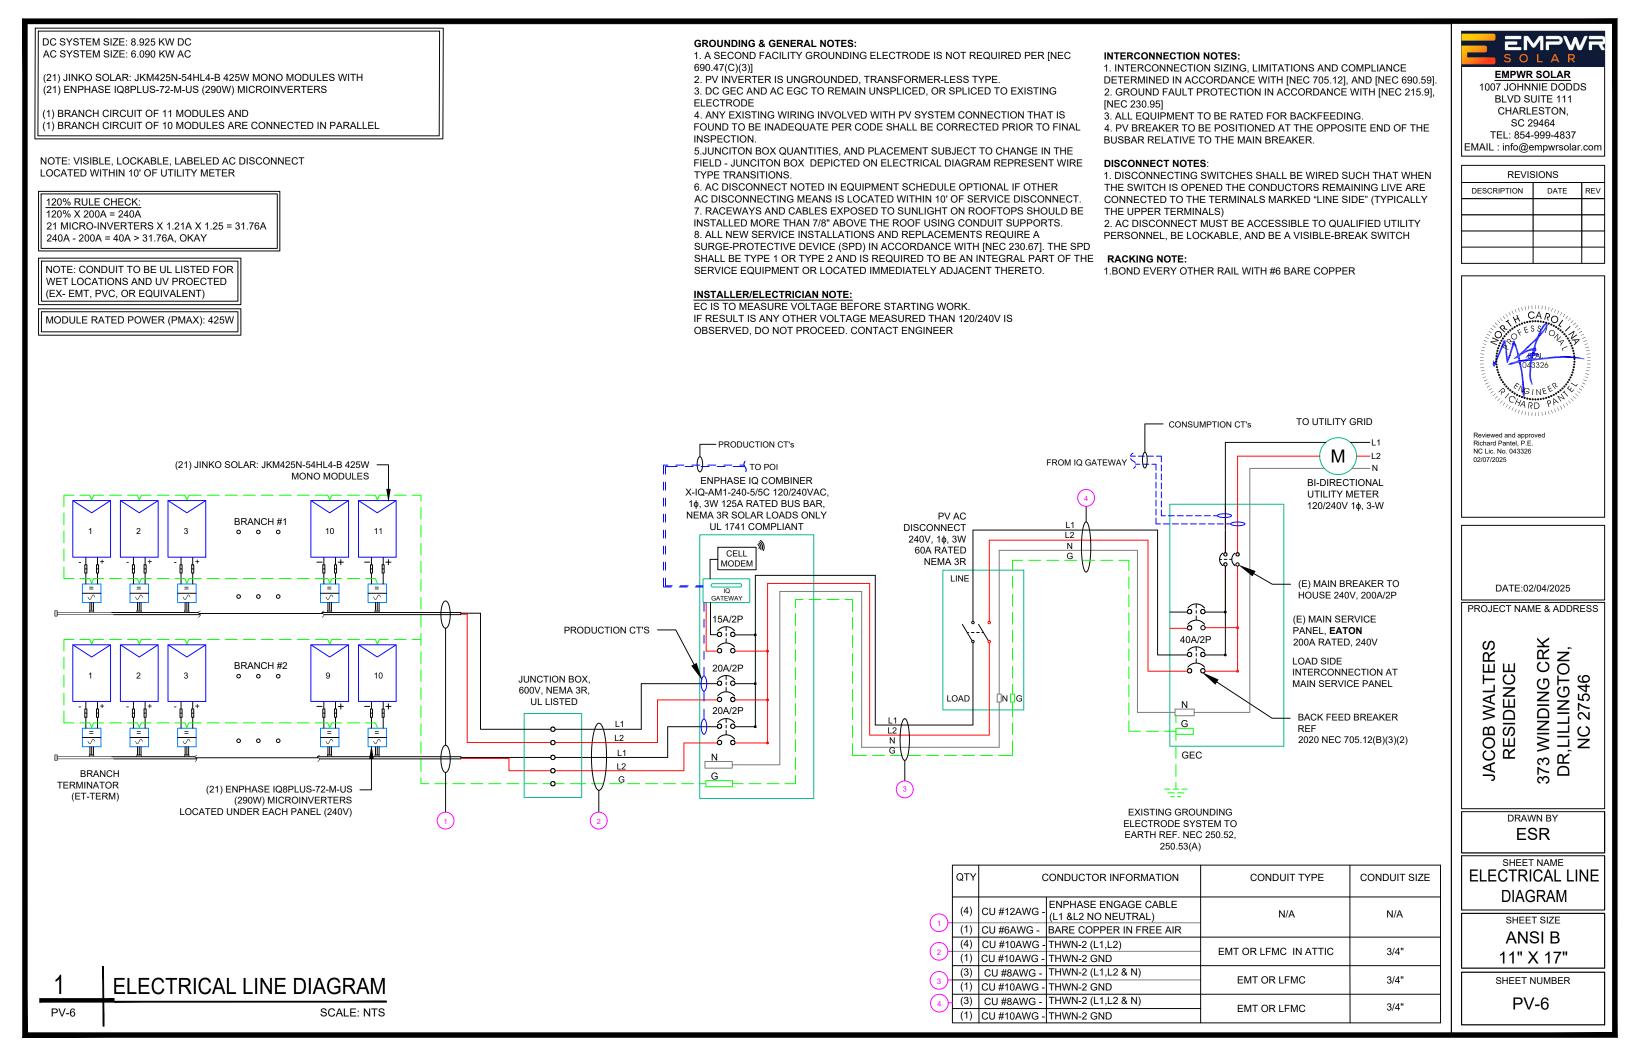

INVERT	ER SPECIFICATIONS	SOLA	R MODULE SPECIFICATIONS	AMBIENT TEMPERATURE SPECS				
MANUFACTURER / MODEL # ENPHASE IQ8PLUS-72-M-US (290W)		MANUFACTURER / MODEL #	MANUFACTURER / MODEL # JINKO SOLAR: JKM425N-54HL4-B 425W MODULE		RECORD LOW TEMP			
MANOTACTORER / MODEL #	MICROINVERTER			AMBIENT TEMP	38			
MIN/MAX DC VOLT RATING	22V MIN/ 58V MAX		32.37V	CONDUCTOR TE	MPERATURE RATE	90		
			13.13A	MODULE TEMPERATURE COEFFICIENT OF Vo		-0.25%/0		
MAX INPUT POWER	235W-440W +		38.95V			0.207070		
NOMINAL AC VOLTAGE RATING	240V/ 211-264V	ISC	13.58A	PERCENT OF	NUMBER OF CURRENT			
MAX AC CURRENT	1.21A	TEMP. COEFF. VOC	-0.25%/°C	VALUES	CARRYING CONDUCTORS IN	EMT		
		MODULE DIMENSION	67.79"L x 44.65"W x 1.26"D (In Inch)	.80	4-6			
MAX MODULES PER CIRCUIT	13 (SINGLE PHASE)			.70	7-9			
MAX OUTPUT POWER	290 VA]		.50	10-20			

CIRCUIT ORIGIN	CIRCUIT DESTINATION	VOLTACE	FULL LOAD AMPS "FLA" (A)	FLA*1.25 (A)	OCPD SIZE (A)	NEUTRAL SIZE	GROUND SIZE	CONDUCTOR SIZE	75°C AMPACITY (A)		TEMP (°C)	TOTAL CC CONDUCTORS IN RACEWAY	90°C AMPACITY (A)	FOR AMBIENT	DERATION FACTOR FOR CONDUCTORS PER RACEWAY NEC 310.15(C)(1)	AMPACITY	AMPACITY CHECK #2	LENGTH	CONDUCTOR RESISTANCE (OHM/KFT)	DROP AT	CONDUIT SIZE	CONDUIT FILL (%)
CIRCUIT 1	JUNCTION BOX	240	13.31	16.6375	20	N/A	BARE COPPER #6 AWG	CU #12 AWG	25	PASS	38	2	30	0.91	1	27.3	PASS			0.55	N/A	#N/A
CIRCUIT 2	JUNCTION BOX	240	12.1	15.125	20	N/A	BARE COPPER #6 AWG	CU #12 AWG	25	PASS	38	2	30	0.91	1	27.3	PASS			0.46	3/4" EMT	#N/A
JUNCTION BOX	COMBINER BOX	240	13.31	16.6375	20	N/A	CU #10 AWG	CU #10 AWG	35	PASS	38	4	40	0.91	0.8	29.12	PASS	37	1.24	0.509	3/4" EMT	19.79362
COMBINER BOX	AC DISCONNECT	240	25.41	31.7625	40	CU #8 AWG	CU #10 AWG	CU #8 AWG	50	PASS	38	2	55	0.91	1	50.05	PASS	5	0.778	0.082	3/4" EMT	24.5591
AC DISCONNECT	POI	240	25.41	31.7625	40	CU #8 AWG	CU #10 AWG	CU #8 AWG	50	PASS	38	2	55	0.91	1	50.05	PASS	5	0.778	0.082	3/4" EMT	24.5591

ELECTRICAL NOTES

- 1. ALL EQUIPMENT TO BE LISTED BY UL OR OTHER NRTL, AND LABELED FOR ITS APPLICATION.
- 2. ALL CONDUCTORS SHALL BE RATED UPTO 600V FOR RESIDENTIAL AND 1000V FOR COMMERCIAL AND 90 DEGREE C WET ENVIRONMENT.
- 3. WIRING, CONDUIT, AND RACEWAYS MOUNTED ON ROOFTOPS SHALL BE ROUTED DIRECTLY TO, AND LOCATED AS CLOSE AS POSSIBLE TO THE NEAREST RIDGE, HIP, OR VALLEY.
- 4. WORKING CLEARANCES AROUND ALL NEW AND EXISTING ELECTRICAL EQUIPMENT SHALL COMPLY WITH NEC 110.26.
- 5. DRAWINGS INDICATE THE GENERAL ARRANGEMENT OF SYSTEMS. CONTRACTOR SHALL FURNISH ALL NECESSARY OUTLETS, SUPPORTS, FITTINGS AND ACCESSORIES TO FULFILL APPLICABLE CODES AND STANDARDS.
- 6. WHERE SIZES OF JUNCTION BOX, RACEWAYS, AND CONDUITS ARE NOT SPECIFIED, THE CONTRACTOR SHALL SIZE THEM ACCORDINGLY.
- 7. ALL WIRE TERMINATIONS SHALL BE APPROPRIATELY LABELED AND READILY VISIBLE.
- 8. MODULE GROUNDING CLIPS TO BE INSTALLED BETWEEN MODULE FRAME AND MODULE SUPPORT RAIL, PER THE GROUNDING CLIP MANUFACTURER'S INSTRUCTION.
- 9. MODULE SUPPORT RAIL TO BE BONDED TO CONTINUOUS COPPER G.E.C. VIA WEEB LUG OR ILSCO GBL-4DBT LAY-IN LUG.
- 10. TEMPERATURE RATINGS OF ALL CONDUCTORS, TERMINATIONS, BREAKERS, OR OTHER DEVICES ASSOCIATED WITH THE SOLAR PV SYSTEM SHALL BE RATED FOR AT LEAST 75 DEGREE C.

		/R
1007 JOHN BLVD SI CHARL SC 2	JITE 111 ESTON, 9464 -999-4837	-
REVIS	SIONS	
DESCRIPTION	DATE	REV

Reviewed and approved Richard Pantel, P.E. NC Lic. No. 043326 02/07/2025					
DATE:02/04/2025					
JACOB WALTERS RESIDENCE 373 WINDING CRK DR,LILLINGTON, NC 27546					
DRAWN BY ESR					
SHEET NAME WIRING CALCULATIONS SHEET SIZE ANSI B					
11" X 17" SHEET NUMBER PV-7					

Circuit 1 Voltage Drop	1.224
Circuit 2 Voltage Drop	1.134

CAUTION: AUTHORIZED SOLAR PERSONNEL ONLY!

LABEL-1: LABEL LOCATION: AC DISCONNECT

WARNING

ELECTRIC SHOCK HAZARD

TERMINALS ON THE LINE AND LOAD SIDES MAY BE ENERGIZED IN THE OPEN POSITION

LABEL- 2: <u>LABEL LOCATION:</u> AC DISCONNECT COMBINER MAIN SERVICE PANEL SUBPANEL MAIN SERVICE DISCONNECT CODE REF: NEC 705.20(7) & 690.13(B)

MARNING DUAL POWER SOURCE SECOND SOURCE IS PHOTOVOLTAIC SYSTEM

LABEL- 3: <u>LABEL LOCATION:</u> UTILITY METER MAIN SERVICE PANEL SUBPANEL CODE REF: NEC 705.30(C) & NEC 690.59

TURN OFF PHOTOVOLTAIC AC DISCONNECT PRIOR TO WORKING INSIDE PANEL

LABEL- 4: <u>LABEL LOCATION:</u> MAIN SERVICE PANEL SUBPANEL MAIN SERVICE DISCONNECT COMBINER CODE REF: NEC 110.27(C) & OSHA 1910.145(f)(7)

POWER SOURCE OUTPUT CONNECTION. DO NOT RELOCATE THIS OVERCURRENT DEVICE

LABEL- 5: <u>LABEL LOCATION:</u> MAIN SERVICE PANEL (ONLY IF SOLAR IS BACK-FED) SUBPANEL (ONLY IF SOLAR IS BACK-FED) CODE REF: NEC 705.12 (B)(2)

SOLAR PV SYSTEM EQUIPPED WITH RAPID SHUTDOWN TURN RAPID SHUTDOWN SWITCH TO THE "OFF" POSITION TO SHUT DOWN PV SYSTEM

AND REDUCE SHOCK HAZARD IN THE ARRAY

LABEL- 6: LABEL LOCATION: AC DISCONNECT

CODE REF: IFC 605.11.3.1(1) & 690.12(D)

RAPID SHUTDOWN SWITCH FOR SOLAR PV SYSTEM

LABEL- 7:

LABEL LOCATION: AC DISCONNECT CODE REF: NEC 690.12(D)(2)


PHOTOVOLTAIC AC DISCONNECT	
OMINAL OPERATING AC VOLATGE	240 V
ATED AC OUTPUT CURRENT	25.41 A
BEL- 8:	

LABEL- 8: <u>LABEL LOCATION:</u> MAIN SERVICE PANEL SUBPANEL AC DISCONNECT CODE REF: NEC 690.54

> CAUTION PHOTOVOLTAIC SYSTEM CIRCUIT IS BACKFEED

LABEL- 9: <u>LABEL LOCATION:</u> MAIN SERVICE PANEL (ONLY IF SOLAR IS BACK-FED) SUBPANEL (ONLY IF SOLAR IS BACK-FED) CODE REF: NEC 705.12(B)(3-4) & NEC 690.59

S O EMPWI 1007 JOHN BLVD S CHARI SC 3	R SOLAR INIE DODD UITE 111 LESTON, 29464 I-999-4837 empwrsolar	
REVI	SIONS	
DESCRIPTION	DATE	REV
R CHA	Ξ.	AMMANDANG.
DATE:0	2/04/2025 ME & ADDRI	ESS
JACOB WALTERS RESIDENCE	373 WINDING CRK DR,LILLINGTON,	NC 2/ 540
	WN BY SR	
SHEE	T NAME	
	BELS	
AN 11"	SI B X 17"	
	NUMBER	

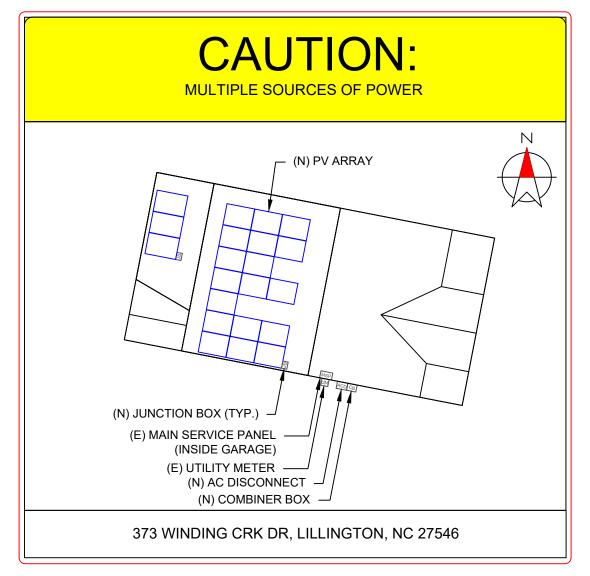

DIRECTORY

PERMANENT PLAQUE OR DIRECTORY PROVIDING THE LOCATION OF THE SERVICE DISCONNECTING MEANS AND THE PHOTOVOLTAIC SYSTEM.

(ALL PLAQUES AND SIGNAGE WILL BE INSTALLED AS OUTLINED WITHIN: NEC 690.56(A)(B), NEC 705.10)

LABELING NOTES:

- LABELS CALLED OUT ACCORDING TO ALL COMMON CONFIGURATIONS. ELECTRICIAN TO DETERMINE EXACT REQUIREMENTS IN THE FIELD PER CURRENT NEC AND LOCAL CODES AND MAKE APPROPRIATE ADJUSTMENTS.
 LABELING REQUIREMENTS BASED ON THE 2020 NATIONAL ELECTRIC CODE, OSHA STANDARD 19010.145, ANSI Z535.
- 3. MATERIAL BASED ON THE REQUIREMENTS OF THE AUTHORITY HAVING JURISDICTION.
- 4. LABELS TO BE OF SUFFICIENT DURABILITY TO WITHSTAND THE ENVIRONMENT INVOLVED [NEC 110.21]
- 5. LABELS TO BE A MINIMUM LETTER HEIGHT OF 3/8", WHITE ON RED BACKGROUND; REFLECTIVE, AND PERMANENTLY

AFFIXED [IFC 605.11.1.1]

EMPWR SOLAR <u>EMPWR SOLAR</u> 1007 JOHNNIE DODDS BLVD SUITE 111 CHARLESTON, SC 29464 TEL: 854-999-4837 EMAIL : info@empwrsolar.cc	om
DESCRIPTION DATE R	REV
Reviewed and approved Richard Pantel, P.E. NC Lie. No. 043326 02/07/2025	
DATE:02/04/2025 PROJECT NAME & ADDRES	SS
JACOB WALTERS RESIDENCE 373 WINDING CRK DR,LILLINGTON, NC 27546)
DRAWN BY ESR	
SHEET NAME	
PLACARD	
SHEET SIZE ANSI B 11" X 17" SHEET NUMBER	
PV-9	

	1-10	11-20	21-30	31-40	41-50	51-60	61-70		
1								MICRO INVERTER CHART	SOLAR EMPWR SOLAR 1007 JOHNNIE DODDS BLVD SUITE 111 CHARLESTON, SC 29464 TEL: 854-999-4837 EMAIL : info@empwrsolar.com
2									REVISIONS DESCRIPTION DATE REV
3									CA ROMAN
4									Reviewed and approved
5									Reviewed and approved Richard Pantel, P.E. NC Lic. No. 043326 02/07/2025
6									DATE:02/04/2025 PROJECT NAME & ADDRESS
7									JACOB WALTERS RESIDENCE 373 WINDING CRK DR,LILLINGTON, NC 27546
8									
9									DRAWN BY ESR SHEET NAME MICRO INVERTER CHART
10									SHEET SIZE ANSI B 11" X 17" SHEET NUMBER PV-10



THE MOST DEPENDABLE SOLAR PRODUCT

EAGLE[®] 54 G6R 420–440 WATT • N–TYPE TOPCON

Positive power tolerance of 0~+3%

- NYSE-listed since 2010, Bloomberg Tier 1 manufacturer
- Top performance in the strictest 3rd party labs
- Automated manufacturing utilizing artificial intelligence
- Vertically integrated, tight controls on quality
- Premium solar factories in USA, Vietnam, and Malaysia

KEY FEATURES

Ν

TOUGH

 \sim

30 YRS

Superior Aesthetics

Black backsheet and black frame create ideal look for residential applications.

N-Type Technology N-type cells with Jinko's in-house TOPCon technology offers better performance and improved reliability.

Thick and Tough Fire Type 1 rated module engineered with a thick frame, 3.2mm front side glass, and thick backsheet for added durability.

Shade Tolerant

Twin array design allows continued performance even with shading by trees or debris.

Protected Against All Environments

Certified to withstand humidity, heat, rain, marine environments, wind, hailstorms, and packed snow.

Warranty 25-year product and 30-year linear power warranty.

ISO9001:2015 Quality Standards

- IS014001:2015 Environmental Standards
- IEC61215, IEC61730 certified products

 ISO45001: 2018 Occupational Health & Safety Standards UL61730 certified products






TYPE

Solar


JinKO

ENGINEERING DRAWINGS

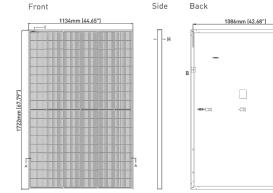

	CHARACTERISTICS
	JARACTERISTICS
No. of Half Cells	108 (2 x 54)
Dimensions	1722 × 1134 × 35mm (67.79 × 44.65 × 1.38 inch)
Weight	21.0kg (46.3lbs)
Front Glass	3.2mm, Anti-Reflection Coating High Transmission, Low Iron, Tempered Glass
Frame	Anodized Aluminum Alloy
Junction Box	IP68 Rated
Output Cables	12 AWG, 1400mm (55.12in) or Customized Length
Connector	Staubli MC4
Fire Type	Туре 1
Pressure Rating	5400Pa (Snow) & 2400Pa (Wind)*


TEMPERATURE CHARACTERISTICS

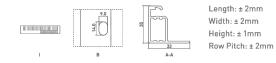

Temperature Coefficients o Temperature Coefficients o Temperature Coefficients o Nominal Operating Cell Tem

WARRANTY

ELECTRICAL PERFORMANCE & TEMPERATURE DEPENDENCE MAXIMUM RATINGS

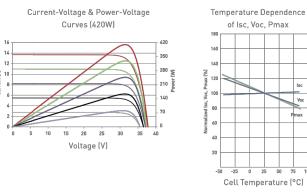

Operating Temperature (°C of Isc, Voc, Pmax Maximum System Voltage Maximum Series Fuse Ratin (Two pallets = One stack)

Cell Temperature (°C)


25-year product and 30-year linear power warranty 1st year degradation not to exceed 1%, each subsequent year not to exceed 0.4%, minimum power at year 30 is 87.4% or greater.

ELECTRICAL CHARACTERISTICS Module Type JKM420N-54HL4-B JKM425N-54HL4-B JKM430N-54HL4-B STC NOCT NOCT STC NOCT STC Maximum Power (Pmax) 425W 420Wp 316Wp 320Wp 430Wp 323Wp Maximum Power Voltage (Vmp) 32.16V 29.95V 32.37V 30.19V 32.58V 30.30V 13.13A Maximum Power Current (Imp) 13.06A 10.55A 10.60A 13.20A 10.66A 38.95V 37.20V Open-circuit Voltage (Voc) 38.74V 36.80V 37.00V 39.16V Short-circuit Current (lsc) 13.51A 10.91A 13.58A 10.96A 13.65A 11.02A Module Efficiency STC (%) 21.51% 22.02%

*STC: -∲- Irradiance 1000W/m² NOCT: -∲- Irradiance 800W/m²	Cell Temperature 25°C Ambient Temperature 20°C	AM = 1.5 AM = 1.5	<u></u>
*Power measurement tolerance: ±3%			

The company reserves the final right for explanation on any of the information presented hereby. JKM400-420N-54HL4-B-F4-US

BUILDING YOUR TRUST IN SOLAR, WWW.JINKOSOLAR.US

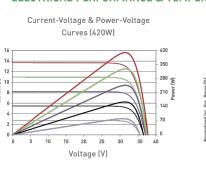

of Pmax	-0.29%/°C
of Voc	-0.25%/°C
of Isc	0.045%/°C
nperature (NOCT)	45±2°C

;]	-40°C~+85°C
	1000VDC
ng	25A

PACKAGING CONFIGURATION

31pcs/pallets, 62pcs/stack, 806pcs/40 HQ Container

JKM435N	-54HL4-B	JKM440N-54HL4-B		
STC	NOCT	STC	NOCT	
435Wp	327Wp	440Wp	331Wp	
32.78V	30.50V	32.99V	30.73V	
13.27A	10.72A	13.34A	10.77A	
39.36V	37.39V	39.57V	37.59V	
13.72A	11.08A	13.80A	11.14A	
22.3	28%	22.	53%	

SWind Speed 1m/s



EMPWR SOLAR 1007 JOHNNIE DODDS BLVD SUITE 111 CHARLESTON, SC 29464 TEL: 854-999-4837 EMAIL : info@empwrsolar.com			
REVIS DESCRIPTION	SIONS DATE	REV	
DATE:02	2/04/2025	FSS	
JACOB WALTERS RESIDENCE	373 WINDING CRK DR,LILLINGTON,		
E	VN BY SR		
SHEET NAME EQUIPMENT SPECIFICATION			
SHEET SIZE ANSI B 11" X 17"			
SHEET PV-	NUMBER		



IQ8 and IQ8+ Microinverters

Our newest IQ8 Microinverters are the industry's first microgrid-forming, softwaredefined microinverters with split-phase power conversion capability to convert DC power to AC power efficiently. The brain of the semiconductor-based microinverter is our proprietary application-specific integrated circuit (ASIC), which enables the microinverter to operate in grid-tied or off-grid modes. This chip is built using advanced 55-nm technology with high-speed digital logic and has superfast response times to changing loads and grid events, alleviating constraints on battery sizing for home energy systems.

Enphase

UL

CERTIFIED

manufacturer's instructions.

IQ8 Series Microinverters redefine reliability

leading limited warranty of up to 25 years.

IQ8 Series Microinverters are UL Listed as

PV rapid shutdown equipment and conform with various regulations when installed according to

standards with more than one million cumulative

hours of power-on testing, enabling an industry-



Part of the Enphase Energy System, IQ8 Series Microinverters integrate with the Enphase IQ Battery, Enphase IQ Gateway, and the Enphase App monitoring and analysis software.



Connect PV modules quickly and easily to the IQ8 Series Microinverters that have integrated MC4 connectors.

* Meets UL 1741 only when installed with IQ System Controller 2 or 3. ** IQ8 and IQ8+ support split-phase, 240 V installations only.

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Easy to install

• Lightweight and compact with plug-and-play connectors

DATA SHEET

- Power line communication (PLC) between components
- Faster installation with simple two-wire cabling

High productivity and reliability

- Produce power even when the grid is down* More than one million cumulative hours of testing
- Class II double-insulated enclosure
- Optimized for the latest high-powered PV modules

Microgrid-forming

- Complies with the latest advanced grid support**
- Remote automatic updates for the latest grid requirements
- Configurable to support a wide range of grid profiles
- Meets CA Rule 21 (UL 1741-SA) and IEEE 1547:2018 (UL 1741-SB)

NOTE:

- IQ8 Microinverters cannot be mixed together with previous generations of Enphase microinverters (IQ7 Series, IQ6 Series, and so on) in the same system.
- IQ Microinverters ship with default settings that meet North America's IEEE 1547 interconnection standard requirements. Region-specific adjustments may be requested by an Authority Having Jurisdiction (AHJ) or utility representative according to the IEEE 1547 interconnection standard. An IQ Gateway is required to make these changes during installation.

IQ8SP-MC4-DSH-00206-3.0-EN-US-2024-02-09

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Nominal voltage range can be extended beyond nominal if required by the utility. Limits may vary. Refer to local requirements to define the number of microinverters per branch in your area. IQ8SP-MC4-DSH-00206-3.0-EN-US-2024-02-09 ANS 11" X	



X-IQ-AM1-240-5 X-IQ-AM1-240-5C

DATA SHEET

IQ Combiner 5/5C

The IQ Combiner 5/5C consolidates interconnection equipment into a single enclosure and streamlines IQ Series Microinverters and IQ Gateway installation by providing a consistent, pre-wired solution for residential applications. IQ Combiner 5/5C uses wired control communication and is compatible with IQ System Controller 3/3G and IQ Battery 5P.

The IQ Combiner 5/5C, IQ Series Microinverters, IQ System Controller 3/3G, and IQ Battery 5P provide a complete grid-agnostic Enphase Energy System.



IQ Series Microinverters The high-powered smart grid-ready IQ Series Microinverters (IQ6, IQ7, and IQ8 Series) simplify device (MID) functionality by the installation process.



IQ Battery 5P Fully integrated AC battery system. Includes six field-replaceable IQ8D-BAT Microinverters.



5-year limited warranty



IQ System Controller 3/3G Provides microgrid interconnection automatically detecting grid failures and seamlessly transitioning the home energy system from grid power to backup power.



IQ Load Controller Helps prioritize essential appliances during a grid outage to optimize energy consumption and prolong battery life.







- Includes IQ Gateway for communication and control
- Includes Enphase Mobile Connect (CELLMODEM-M1-06-SP-05), only with IQ Combiner 5C
- Supports flexible networking: Wi-Fi, Ethernet, or cellular
- Provides production metering (revenue grade) and consumption monitoring

Easy to install

- Mounts to one stud with centered brackets
- Supports bottom, back, and side conduit entries
- Supports up to four 2-pole branch circuits for 240 VAC plug-in breakers (not included)
- 80 A total PV branch circuits
- · Bluetooth-based Wi-Fi provisioning for easy Wi-Fi setup

Reliable

- Durable NRTL-certified NEMA type 3R enclosure
- 5-year limited warranty
- 2-year labor reimbursement program coverage included for both the IQ Combiner SKUs
- UL1741 Listed

IQ Combiner 5/5C

IQ Combiner 5 (X-IQ-AMI-240-5) metering (AMSIC12.20:0.5%), consumption monthe includes a silver solar shield to deflect heat. IQ Combiner 5C (X-IQ-AMI-240-5C) IIQ Combiner 5C with IQ Gateway printed circuit bo metering (AMSIC12.20:0.5%), consumption monthe includes Enhanse Mobile Connect cellular medern (a solar shield to deflect heat. WHAT'S IN THE BDX IIQ Gateway is the platform for total energy management of the Enphase Energy System Busbar IIQ Gateway is the platform for total energy management of the Enphase Energy System Busbar BO A busbar with support for 1-IQ Gateway breaker IQ Gateway breaker Circuit breaker, 2-pole, 10 A/IS A Production CT Pre-wired revenue-grade solid-core CT, accurate up Consumption for T IQ Battery CT One battery metring clamp CT, shipped with the bot CRIL board Control board for wired communication with IQ Sys Erphase Mobile Connect (only with IQ Combiner 5C) 4G-based LTE-MI cellular modem (ELLMODEM-MI Accessories kit Accessories kit Spare control headers for the COMMS-KIT-02 board for wired communication with a 5-year AI& Circuit breakers (off-the-shell) Circuit Spare AIX (Spare AIX (Spa	29 SO B-B S-S-S-S-S-S-S-S-S-S-S-S-S-S-S-S-S-S	
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Accessories kitSpare control headers for the COMMS-KIT-02 boardACCESSORIES AND REPLACEMENT PARTS (NOT INCLUDED, UNDER SEPARATELY)CELLMODEM-MI-06-SP-054G-based LTE-MI cellular modem with a 5-year AT&CELLMODEM-MI-06-AT-054G-based LTE-MI cellular modem with a 5-year AT&Circuit breakers (off-the-shelf)Supports Eaton BR2XX, Siemens Q2XX and GE/ABECircuit breakers (provided by Enphase)BRK-10A-2-240V, BRK-15A-2-240V, BRK-20A-2P-24XA-SOLARSHIELD-ESReplacement solar shield for IQ Combiner 5/5CXA-SOLARSHIELD-ESReplacement solar shield for IQ Combiner 5/5CXA-COMMS2-PCBA-5IQ Gateway replacement printed circuit board (PCBX-IQ-NA-HD-125AHold-down kit compatible with Eaton BR-B series ofXA-COMMS2-PCBA-5I20/240 VAC, 60 HzBusbar rating120/240 VAC, 60 HzBusbar rating125 AFault current rating (input from PV/storage)64 ABranch circuit s(solar and/or storage)Wp to four 2-pole Eaton BR, Siemens Q, or GE/ABBMaximum total branch circuit breaker rating (input)80 A of distributed generation/95 A with IQ GatewayIQ Gateway breaker10 A or 15 A rating GE/Siemens/Eaton includedProduction metering CT200 A solid core pre-installed and wired to IQ GatewayIQ Gateway breaker10 A or 16 A cating GE/Siemens/Eaton included	CTRL board	Control board for wired communication with IQ Syste
ACCESSORIES AND REPLACEMENT PARTS (NOT INCLUDED, ORDER SEPARATELY) CELLMODEM-MI-06-SP-05 4G-based LTE-MI cellular modem with a 5-year T-M CELLMODEM-MI-06-AT-05 4G-based LTE-MI cellular modem with a 5-year AT& Circuit breakers (off-the-shelf) Supports Eaton BR2XX, Siemens Q2XX and GE/ABE Circuit breakers (provided by Enphase) BRK-10A-2-240V, BRK-15A-2-240V, BRK-20A-2P-24 XA-SOLARSHIELD-ES Replacement solar shield for IQ Combiner 5/5C XA-SOLARSHIELD-ES Replacement solar shield for IQ Combiner 5/5C XA-SOLARSHIELD-ES IQ Gateway replacement printed circuit board (PCE X-IQ-NA-HD-125A Hold-down kit. XA-COMMS2-PCBA-5 IQ Gateway replacement printed circuit board (PCE XA-COMMS2-PCBA-5 Replacement COMMS-KIT-02 printed circuit board ELECTRICAL SPECIFICATIONS BO A System voltage and frequency 120/240 VAC, 60 Hz Busbar rating 10 kAIC Maximum continuous current rating (input from PV/storage) 64 A Branch circuit breaker rating (input) 80 A of distributed generation/95 A with IQ Gateway IQ Gateway breaker 10 A or 15 A rating GE/Siemens/Eaton included Production metering CT 200 A solid core pre-installed and wired to IQ Gateway	Enphase Mobile Connect (only with IQ Combiner 5C)	4G-based LTE-M1 cellular modem (CELLMODEM-M1-
CELLMODEM-MI-06-SP-05 4G-based LTE-MI cellular modem with a 5-year T-M CELLMODEM-MI-06-AT-05 4G-based LTE-MI cellular modem with a 5-year AT& Circuit breakers (off-the-shelf) Supports Eaton BR2XX, Siemens 02XX and GE/ABE Circuit breakers (provided by Enphase) BRK-10A-2-240V, BRK-15A-2-240V, BRK-20A-2P-24 XA-SOLARSHIELD-ES Replacement solar shield for IQ Combiner 5/5C XA-SOLARSHIELD-ES IQ Gateway replacement printed circuit board (PCB X-IQ-NA-HD-125A Hold-down kit compatible with Eaton BR-Series circuit board XA-COMMS2-PCBA-5 IQ Gateway replacement common below in the doard of the circuit board ELECTRICAL SPECIFICATIONS 80 A System voltage and frequency 120/240 VAC, 60 Hz Busbar rating 10 kAIC Maximum continuous current rating (input from PV/storage) 64 A Branch circuit s (solar and/or storage) Up to four 2-pole Eaton BR, Siemens Q, or GE/ABB ON (not included) Maximum total branch circuit breaker rating (input) 80 A or 15 A rating GE/Siemens/Eaton included 200 A solid core pre-installed and wired to IQ Gateway breaker IQ Gateway breaker 10 A or 15 A rating GE/Siemens/Eaton included Production metering CT 200 A solid core pre-installed and wired to IQ Gateway breaker <td>Accessories kit</td> <td>Spare control headers for the COMMS-KIT-02 board</td>	Accessories kit	Spare control headers for the COMMS-KIT-02 board
CELLMODEM-MI-06-AT-054G-based LTE-MI cellular modem with a 5-year AT&Circuit breakers (off-the-shelf)Supports Eaton BR2XX, Siemens Q2XX and GE/ABE to, 15, 20, 30, 40, 50, or 60). Also supports Eaton BR compatible with the hold-down kit.Circuit breakers (provided by Enphase)BRK-10A-2-240V, BRK-15A-2-240V, BRK-20A-2P-24 240V-B (more details in the "Accessories" section)XA-SOLARSHIELD-ESReplacement solar shield for IQ Combiner 5/5CXA-ENV2-PCBA-5IQ Gateway replacement printed circuit board (PCE X-IQ-NA-HD-125AXA-COMMS2-PCBA-5Replacement COMMS-KIT-02 printed circuit boardELECTRICAL SPECIFICATIONS80 ARating80 ASystem voltage and frequency120/240 VAC, 60 HzBusbar rating10 kAICMaximum continuous current rating (input from PV/storage)64 ABranch circuits (solar and/or storage)Up to four 2-pole Eaton BR, Siemens Q, or GE/ABB only (not included)Maximum total branch circuit braker rating (input)80 A of distributed generation/95 A with IQ Gateway DreakerIQ Gateway breaker10 A or 15 A rating GE/Siemens/Eaton includedProduction metering CT Production metering CT (CT-200-CLAMP)200 A clamp-style current transformers is	ACCESSORIES AND REPLACEMENT PARTS (NOT INCLUDED, O	RDER SEPARATELY)
Circuit breakers (off-the-shelf)Supports Eaton BR2XX, Siemens Q2XX and GE/ABE 10, 15, 20, 30, 40, 50, or 60). Also supports Eaton BR compatible with the hold-down kit.Circuit breakers (provided by Enphase)BRK-10A-2-240V, BRK-15A-2-240V, BRK-20A-2P-24 240V-B (more details in the "Accessories" section)XA-SOLARSHIELD-ESReplacement solar shield for IQ Combiner 5/5CXA-ENV2-PCBA-5IQ Gateway replacement printed circuit board (PCB X-IQ-NA-HD-125AXA-COMMS2-PCBA-5Replacement COMMS-KIT-02 printed circuit boardELECTRICAL SPECIFICATIONS80 ARating80 ASystem voltage and frequency120/240 VAC, 60 HzBusbar rating10 kAICMaximum continuous current rating (input from PV/storage)64 ABranch circuits (solar and/or storage)Up to four 2-pole Eaton BR, Siemens Q, or GE/ABE only (not included)Maximum total branch circuit breaker rating (input)80 A of distributed generation/95 A with IQ GatewayIQ Gateway breaker10 A or 15 A rating GE/Siemens/Eaton includedProduction metering CT consumption monitoring CT (CT-200-CLAMP)200 A solid core pre-installed and wired to IQ Gateway	CELLMODEM-M1-06-SP-05	4G-based LTE-M1 cellular modem with a 5-year T-Mc
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Circuit breakers (provided by Enphase)240V-B (more details in the "Accessories" section)XA-SOLARSHIELD-ESReplacement solar shield for IQ Combiner 5/5CXA-ENV2-PCBA-5IQ Gateway replacement printed circuit board (PCBX-IQ-NA-HD-125AHold-down kit compatible with Eaton BR-B Series ofXA-COMMS2-PCBA-5Replacement COMMS-KIT-02 printed circuit boardELECTRICAL SPECIFICATIONS80 ARating80 ASystem voltage and frequency120/240 VAC, 60 HzBusbar rating10 kAICFault current rating10 kAICMaximum continuous current rating (input from PV/storage)64 ABranch circuits (solar and/or storage)Up to four 2-pole Eaton BR, Siemens Q, or GE/ABB only (not included)Maximum total branch circuit breaker rating (input)80 A of distributed generation/95 A with IQ GatewaIQ Gateway breaker10 A or 15 A rating GE/Siemens/Eaton includedProduction metering CT200 A solid core pre-installed and wired to IQ GatewaConsumption monitoring CT (CT-200-CLAMP)A pair of 200 A clamp-style current transformers is in	Circuit breakers (off-the-shelf)	Supports Eaton BR2XX, Siemens Q2XX and GE/ABB 10, 15, 20, 30, 40, 50, or 60). Also supports Eaton BR2 compatible with the hold-down kit.
XA-ENV2-PCBA-5IQ Gateway replacement printed circuit board (PCBX-IQ-NA-HD-125AHold-down kit compatible with Eaton BR-B Series ofXA-COMMS2-PCBA-5Replacement COMMS-KIT-02 printed circuit boardELECTRICAL SPECIFICATIONSELECTRICAL SPECIFICATIONSRating80 ASystem voltage and frequency120/240 VAC, 60 HzBusbar rating125 AFault current rating10 kAICMaximum continuous current rating (input from PV/storage)64 ABranch circuits (solar and/or storage)Up to four 2-pole Eaton BR, Siemens Q, or GE/ABB only (not included)Maximum total branch circuit breaker rating (input)80 A of distributed generation/95 A with IQ GatewayIQ Gateway breaker10 A or 15 A rating GE/Siemens/Eaton includedProduction metering CT200 A solid core pre-installed and wired to IQ GatewayConsumption monitoring CT (CT-200-CLAMP)A pair of 200 A clamp-style current transformers is an	Circuit breakers (provided by Enphase)	BRK-10A-2-240V, BRK-15A-2-240V, BRK-20A-2P-240 240V-B (more details in the "Accessories" section)
X-IQ-NA-HD-125AHold-down kit compatible with Eaton BR-B Series of Replacement COMMS-KIT-02 printed circuit boardXA-COMMS2-PCBA-5Replacement COMMS-KIT-02 printed circuit boardELECTRICAL SPECIFICATIONS80 ARating80 ASystem voltage and frequency120/240 VAC, 60 HzBusbar rating125 AFault current rating10 kAICMaximum continuous current rating (input from PV/storage)64 ABranch circuits (solar and/or storage)Up to four 2-pole Eaton BR, Siemens Q, or GE/ABB only (not included)Maximum total branch circuit breaker rating (input)80 A of distributed generation/95 A with IQ GatewayIQ Gateway breaker10 A or 15 A rating GE/Siemens/Eaton includedProduction metering CT200 A solid core pre-installed and wired to IQ GatewayConsumption monitoring CT (CT-200-CLAMP)A pair of 200 A clamp-style current transformers is a	XA-SOLARSHIELD-ES	Replacement solar shield for IQ Combiner 5/5C
XA-COMMS2-PCBA-5Replacement COMMS-KIT-02 printed circuit boardELECTRICAL SPECIFICATIONSRating80 ASystem voltage and frequency120/240 VAC, 60 HzBusbar rating125 AFault current rating10 kAICMaximum continuous current rating (input from PV/storage)64 ABranch circuits (solar and/or storage)80 A of distributed generation/95 A with IQ GatewardIQ Gateway breaker10 A or 15 A rating GE/Siemens/Eaton includedProduction metering CT200 A solid core pre-installed and wired to IQ Gateward	XA-ENV2-PCBA-5	IQ Gateway replacement printed circuit board (PCB)
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System voltage and frequency120/240 VAC, 60 HzBusbar rating125 AFault current rating10 kAICMaximum continuous current rating (input from PV/storage)64 ABranch circuits (solar and/or storage)64 AMaximum total branch circuit breaker rating (input)80 A of distributed generation/95 A with IQ GatewarIQ Gateway breaker10 A or 15 A rating GE/Siemens/Eaton includedProduction metering CT200 A solid core pre-installed and wired to IQ Gateward	ELECTRICAL SPECIFICATIONS	
Busbar rating125 AFault current rating10 kAICMaximum continuous current rating (input from PV/storage)64 ABranch circuits (solar and/or storage)04 OMaximum total branch circuit breaker rating (input)80 A of distributed generation/95 A with IQ GatewayIQ Gateway breaker10 A or 15 A rating GE/Siemens/Eaton includedProduction metering CT200 A solid core pre-installed and wired to IQ Gateway	Rating	80 A
Fault current rating 10 kAIC Maximum continuous current rating (input from PV/storage) 64 A Branch circuits (solar and/or storage) 04 A Maximum total branch circuit breaker rating (input) 80 A of distributed generation/95 A with IQ Gatewa IQ Gateway breaker 10 A or 15 A rating GE/Siemens/Eaton included Production metering CT 200 A solid core pre-installed and wired to IQ Gatewa Consumption monitoring CT (CT-200-CLAMP) A pair of 200 A clamp-style current transformers is an analysis of the state of the stat	System voltage and frequency	120/240 VAC, 60 Hz
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Consumption monitoring CT (CT-200-CLAMP) A pair of 200 A clamp-style current transformers is	IQ Gateway breaker	10 A or 15 A rating GE/Siemens/Eaton included
	Production metering CT	200 A solid core pre-installed and wired to IQ Gatew
	Consumption monitoring CT (CT-200-CLAMP)	A pair of 200 A clamp-style current transformers is in
200 A clamp-style current transformer for IQ Batte	IQ Battery metering CT	200 A clamp-style current transformer for IQ Batter

1. A plug-and-play industrial-grade cell modem for systems of up to 60 microinverters. Available in the United States, Canada, Mexico, Puerto cellular service in the installation area.

*For country-specific warranty information, see the <u>https://enphase.com/installers/resources/warranty</u> page.

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IQC-5-5C-DSH-00007-3.0-EN-US-2024-03-01

rd for integrated revenue-grade PV production oring (± 2.5%), and IQ Battery monitoring (±2.5%).	EMPWR SOLAR EMPWR SOLAR 1007 JOHNNIE DODDS BLVD SUITE 111 CHARLESTON, SC 29464 TEL: 854-999-4837 EMAIL : info@empwrsolar.com
ard for integrated revenue-grade PV production oring (±2.5%) and IQ Battery monitoring (±2.5%). (CELLMODEM-M1-06-SP-05)'. Includes a silver	REVISIONS DESCRIPTION DATE REV
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r and 4 × 20 A breaker for installing IQ Series	
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3 THQL21XX Series circuit breakers (XX represents R220B, BR230B, and BR240B circuit breakers	
40V, BRK-15A-2P-240V-B, and BRK-20A-2P-	
3) for IQ Combiner 5/5C	
ircuit breakers (with screws)	DATE:02/04/2025
(PCB) for IQ Combiner 5/5C	PROJECT NAME & ADDRESS
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THQL Series distributed generation (DG) breakers	REO REC
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ery metering, included with the box	ESR
o Rico, and the US Virgin Islands, where there is adequate	SHEET NAME EQUIPMENT SPECIFICATION
IQC-5-5C-DSH-00007-3.0-EN-US-2024-03-01	SHEET SIZE ANSI B 11" X 17" SHEET NUMBER PV-13

MECHANICAL DATA

Dimensions (W × H × D)	37.5 cm \times 49.5 cm \times 16.8 cm (14.75" \times 19.5" \times 6.63"). Height is 21.06" (53.5 cm) with mounting brackets
Weight	7.5 kg (16.5 lbs)
Ambient temperature range	-40°C to 46°C (-40°F to 115°F)
Cooling	Natural convection, plus heat shield
Enclosure environmental rating	Outdoor, NRTL-certified, NEMA type 3R, polycarbonate construction
Wire sizes	 20 A to 50 A breaker inputs: 14 to 4 AWG copper conductors 60 A breaker branch input: 4 to 1/0 AWG copper conductors Main lug combined output: 10 to 2/0 AWG copper conductors Neutral and ground: 14 to 1/0 copper conductors Always follow local code requirements for conductor sizing
Communication (in-premise connectivity)	Built-in CTRL board for wired communication with IQ Battery 5P and IQ System Controller 3/3G. Integrated power line communication for IQ Series Microinverters
Altitude	Up to 2,600 meters (8,530 feet)
COMMUNICATION INTERFACES	
Integrated Wi-Fi	802.11b/g/n (dual band 2.4 GHz/5 GHz), for connecting the Enphase Cloud through the internet
Wi-Fi range (recommended)	10 m (32.8 feet)
Bluetooth	BLE4.2, 10 m range to configure Wi-Fi SSID
Ethernet	Optional, 802.3, Cat5E (or Cat 6) UTP Ethernet cable (not included), for connecting to the Enphase Cloud through the internet
Cellular/Mobile Connect	CELLMODEM-M1-06-SP-05 or CELLMODEM-M1-06-AT-05 (included with IQ Combiner 5C)
Digital I/O	Digital input/output for grid operator control
USB 2.0	Mobile Connect, COMMS-KIT-01 for IQ Battery 3/3T/10/10T, COMMS-KIT-02 for IQ Battery 5P
Access point (AP) mode	For connection between the IQ Gateway and a mobile device running the Enphase Installer App
Metering ports	Up to two Consumption CTs, one IQ Battery CT, and one Production CT
Power line communication	90–110 kHz
Web API	See https://developer-v4.enphase.com
Local API	See guide for local API
COMPLIANCE	

IQ Combiner with IQ Gateway

UL 1741, CAN/CSA C22.2 No. 107.1, Title 47 CFR, Part 15, Class B, ICES 003, NOM-208-SCFI-2016, UL 60601-1/CANCSA 22.2 No. 101-1, IEE 47: 218 (UL 1741-58, 3rd Ed.), IEEE 2030-5/CSIP Compliant, Production metering: ANSI C12.20 accuracy class 0.5 (PV production)

COMPATIBILITY		
PV	Microinverters	IQ6, IQ7, and IQ8 Series Microinverters
	IQ System Controller	EP200G101-M240US00
COMMS-KIT-01 ²	IQ System Controller 2	EP200G101-M240US01
	IQ Battery	ENCHARGE-3-1P-NA, ENCHARGE-10-1P-NA, ENCHARGE-3T-1P-NA, ENCHARGE-10T-1P-NA
COMMS-KIT-02 3	IQ System Controller 3	SC200D111C240US01, SC200G111C240US01
	IQ Battery	IQBATTERY-5P-1P-NA

Accessories



Mobile Connect

4G-based LTE-M1 cellular modem with a 5-year data plan (CELLMODEM-M1-06-SP-05 for Sprint and CELLMODEM-M1-06-AT-05 for AT&T)





200 A revenue-grade solid core Production CT with <0.5% error rate (replacement SKU)



2. For information about IQ Combiner 5/5C compatibility with the 2nd-generation batteries, refer to the <u>compatibility matrix</u>.

3. IQ Combiner 5/5C comes pre-equipped with COMMS-KIT-02.

Circuit breakers

- BRK-10A-2-240V Circuit breaker, 2-pole, 10 A, Eaton BR210 BRK-15A-2-240V Circuit breaker, 2-pole, 15 A, Eaton BR215 BRK-20A-2P-240V Circuit breaker, 2-pole, 20 A, Eaton BR220 BRK-15A-2P-240V-B Circuit breaker, 2-pole, 15 A, Eaton BR215B
- BRK-15A-2P-240V-B Circuit Breaker, 2-pole, 10 A, Eaton with hold-down kit support BRK-20A-2P-240V-B Circuit breaker, 2-pole, 20 A, Eaton BR220B with hold-down kit support

CT-200-CLAMP

200 A clamp-style consumption and battery metering CT with <2.5% error rate (replacement


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	DRAWN BY ESR		
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SHEET SIZE ANSI B 11" X 17"			
SHEET N PV-	NUMBER 14		



Solar Is Not Always Sunny

Over their lifetime, solar panels experience countless extreme weather events. Not just the worst storms in years, but the worst storms in 40 years. High winds capable of ripping panels from a roof, and snowfalls weighing enough to buckle a panel frame.

XR Rails are the structural backbone preventing these results. They resist uplift, protect against buckling and safely and efficiently transfer loads into the building structure. Their superior spanning capability requires fewer roof attachments, reducing the number of roof penetrations and the amount of installation time.

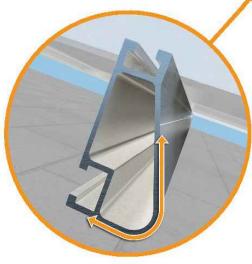

Force-Stabilizing Curve

Sloped roofs generate both vertical and lateral forces on mounting rails which can cause them to bend and twist. The curved shape of XR Rails is specially designed to increase strength in both directions while resisting the twisting. This unique feature ensures greater security during extreme weather and a longer system lifetime.

Compatible with Flat & Pitched Roofs





Corrosion-Resistant Materials

All XR Rails are made of 6000-series aluminum alloy, then protected with an anodized finish. Anodizing prevents surface and structural corrosion, while also providing a more attractive appearance.



XR Rail Family

The XR Rail Family offers the strength of a curved rail in three targeted sizes design loads, while minimizing material costs. Depending on your location, the strength of a curved rail in three targeted sizes design loads, while minimizing material costs.



Rail Selection

The table below was prepared in compliance with applicable engineering cod based on the following criteria: ASCE 7-16, Gable Roof Flush Mount, Roof Z Slope of 8 to 20 degrees and Mean Building Height of 30 ft. Visit IronRidge.c

Lo	ad			Rail	Span
Snow (PSF)	Wind (MPH)	4'	5' 4"	6'	8
	90				
None	120				
None	140	XR10		XR100	
	160				
	90				
20	120				
20	140				
	160				
30	90				
30	160				
40	90				
40	160				
80	160				
120	160				

*Table is meant to be a simplified span chart for conveying general rail capabilities. Use a

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XR Rail Family

Tech Brief	S O L A R <u>EMPWR SOLAR</u> 1007 JOHNNIE DODDS BLVD SUITE 111 CHARLESTON,
s. Each size supports specific here is an XR Rail to match.	SC 29464 TEL: 854-999-4837 EMAIL : info@empwrsolar.com
	REVISIONS DESCRIPTION DATE REV
 XR1000 XR1000 is a heavyweight among solar mounting rails. It's built to handle extreme climates and spans up to 12 feet for commercial applications. 12' spanning capability Extreme load capability Clear anodized finish Internal splices available 	
des and standards.* Values are Zones 1 & 2e, Exposure B, Roof com for detailed certification letters.	
B' 10' 12'	
8' 10' 12'	DATE:02/04/2025
8' 10' 12' XR1000	DATE:02/04/2025 PROJECT NAME & ADDRESS RESIDENCE 373 WINDING CRK DR, LILLINGTON, NC 27546 NC 27546
	PROJECT NAME & ADDRESS
	DRAMN BA DRAMN BA
	PROJECT NAME & ADDRESS PROJECT NAME & ADDRESS JACOB WALTERS RESIDENCE UR 27546 DRAMN BY ESR SHEET NAME EQUIPMENT






UFO Family of Components

Simplified Grounding for Every Application

The UFO family of components eliminates the need for separate grounding hardware by bonding solar modules directly to IronRidge XR Rails. All system types that feature the UFO family-Flush Mount, Tilt Mount and Ground Mount-are fully listed to the UL 2703 standard.

UFO hardware forms secure electrical bonds with both the module and the rail, resulting in many parallel grounding paths throughout the system. This leads to safer and more reliable installations.

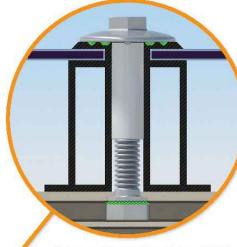

Stopper Sleeve The Stopper Sleeve snaps onto the UFO, converting it into a bonded end clamp.

Universal Fastening Object (UFO) The UFO securely bonds solar modules to XR Rails. It comes assembled and lubricated, and can fit a wide range of module heights.

Bonded Attachments

The bonding bolt attaches

rail. It is installed with the

system.

and bonds the L-foot to the

same socket as the rest of the


Bonded Splice Each Bonded Splice uses

self-drilling screws to form a secure connection. No bonding strap needed



Grounding Lug A single Grounding Lug connects an entire row of PV modules to the ounding conductor.




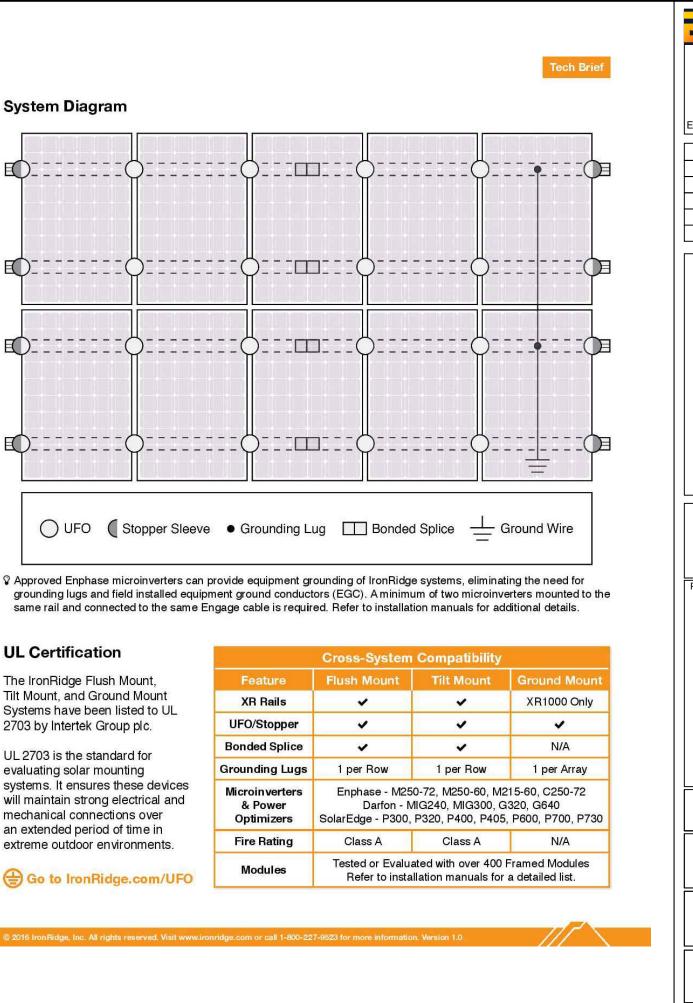

The IronRidge Flush Mount, Tilt Mount, and Ground Mount


	Cross-System	n Co
Feature	Flush Mount	
XR Rails	~	
UFO/Stopper	~	
Bonded Splice	~	
Grounding Lugs	1 per Row	
Microinverters & Power Optimizers	Enphase - M2 Darfon - SolarEdge - P300	MIG
Fire Rating	Class A	
Modules	Tested or Evalı Refer to inst	

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DRAWN BY ESR		
SHEET NAME EQUIPMENT SPECIFICATION		
SHEET SIZE ANSI B 11" X 17"		
SHEET NUMBER PV-16		

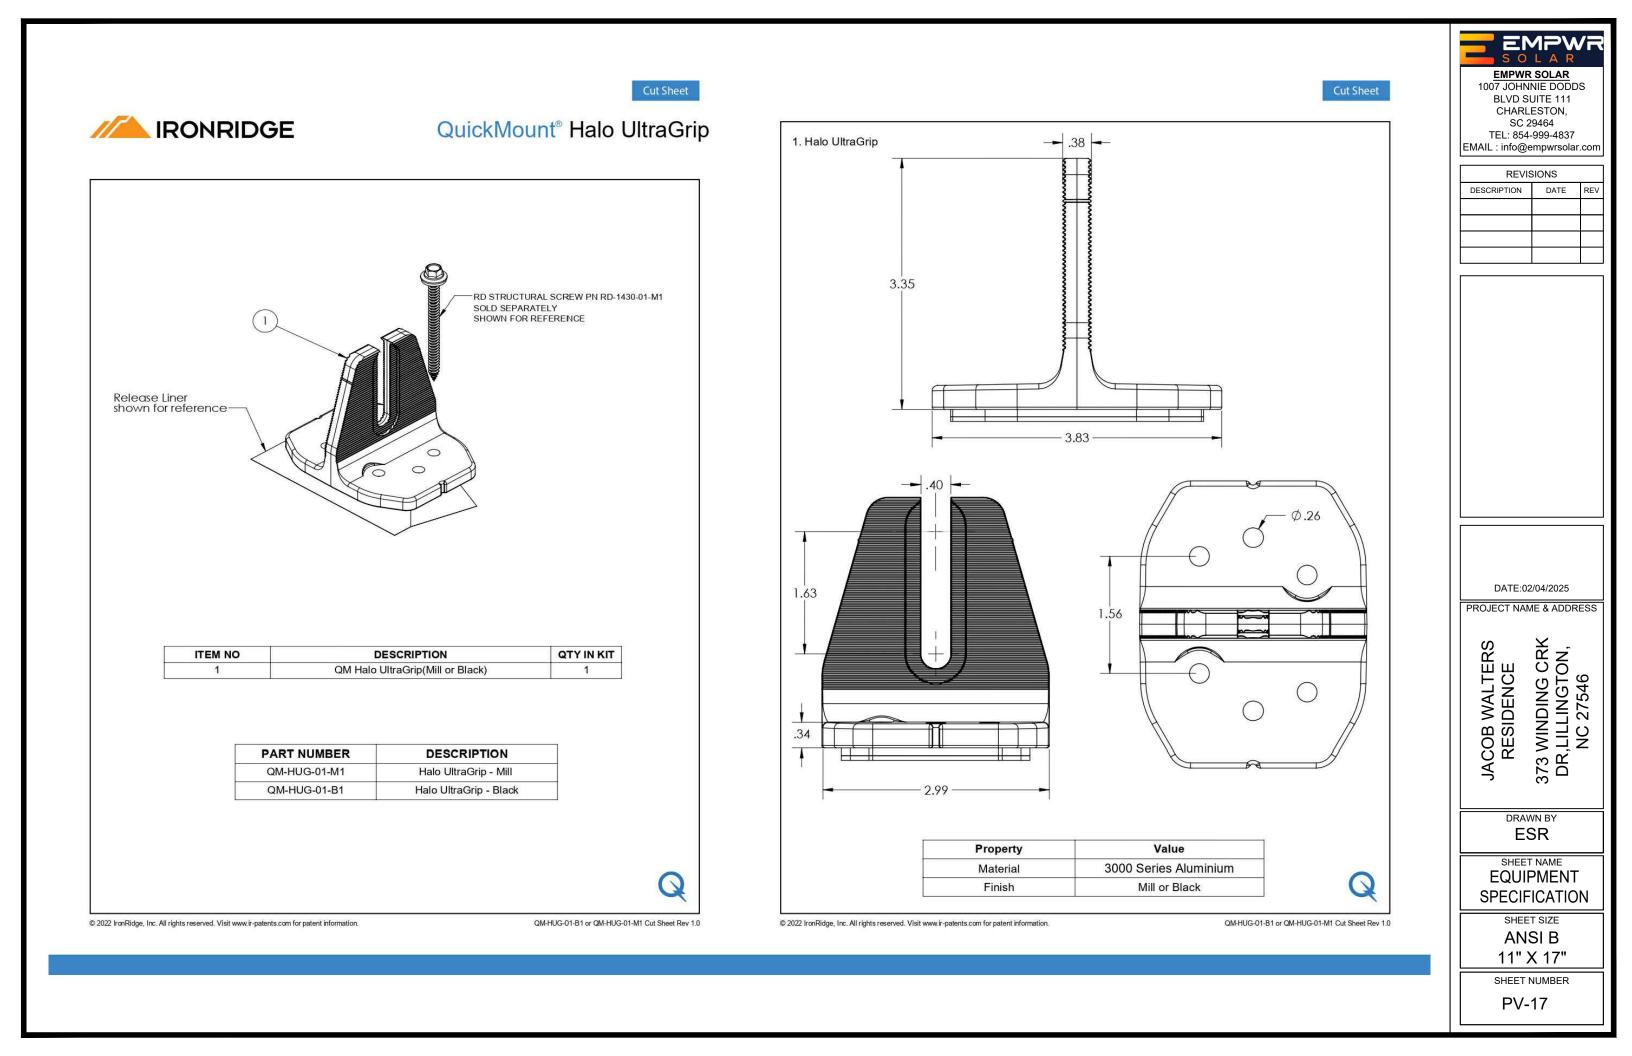



IRONRIDGE QuickMount® RD Structural Screw

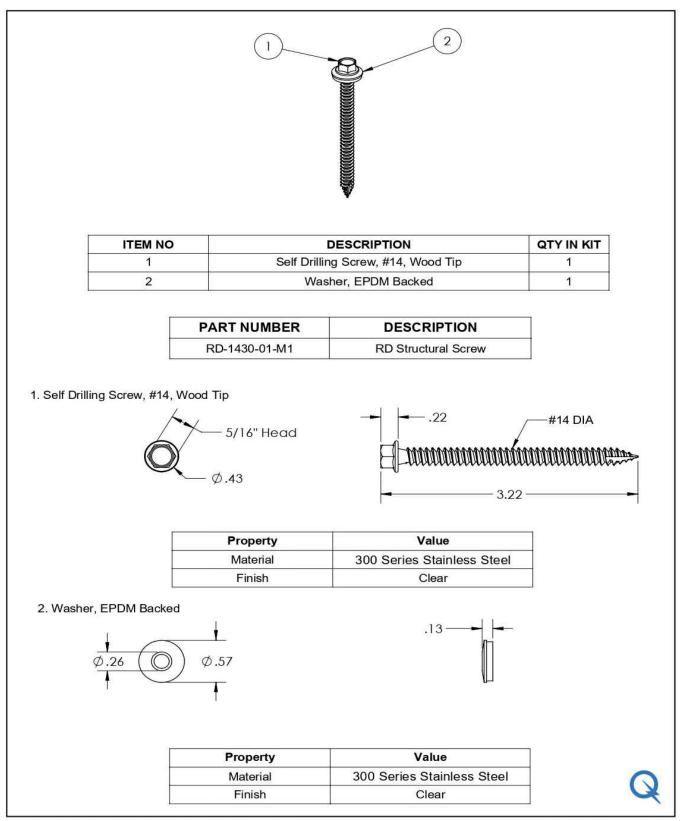

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QM-RD-1430-01-M1 Cut Sheet Rev 1.0

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