#### SCOPE OF WORK:

TO INSTALL A ROOF MOUNTED SOLAR PHOTOVOLTAIC SYSTEM AT THE OWNER RESIDENCE LOCATED AT 15, PAPER BIRCH WAY, FUQUAY VARINA, NC 27526 THE POWER GENERATED BY THE PV SYSTEM WILL BE INTERCONNECTED WITH THE UTILITY GRID THROUGH THE EXISTING ELECTRICAL SERVICE EQUIPMENT.

THE PV SYSTEM DOES NOT INCLUDE STORAGE BATTERIES

EQUIPMENT SUMMARY	SYSTEM RATING
26 LONGI SOLAR LR5-54HABB-400M MODULES	10.400 KWDC
13 DURACELL POWER CENTER SOLAR PV DUAL D700-M2	9.048 KWAC
(240V) MICROINVERTERS	

#### **GENERAL NOTES:**

- THESE CONSTRUCTION DOCUMENTS HAVE BEEN BASED ON FIELD INSPECTIONS AND OTHER INFORMATION AVAILABLE AT THE TIME. ACTUAL FIELD CONDITIONS MAY REQUIRE MODIFICATIONS IN CONSTRUCTION DETAILS.
- ARCHITECT HAS NOT BEEN RETAINED TO SUPERVISE ANY CONSTRUCTION OR INSTALLATION OF ANY EQUIPMENT AT SITE.
- CONTRACTOR SHALL FURNISH ALL LABOR, MATERIAL, EQUIPMENT, TOOLS, OBTAINS ALL PERMITS, LICENSES AND PAY ALL REQUIRED FEES AND COMPLETE INSTALLATION.
- CONTRACTOR HAS THE FULL RESPONSIBILITY TO CHECK AND VERIFY ALL DIMENSIONS AND EXISTING CONDITIONS. ANY DISCREPANCIES SHALL BE REPORTED TO THE ENGINEER BEFORE PROCEEDING WITH THE WORK. ANY WORK STARTED BEFORE CONSULTATION AND ACCEPTANCE BY THE ENGINEER SHALL BE THE SOLE RESPONSIBILITY OF THE CONTRACTOR AND SHALL BE SUBJECT TO CORRECTION BY THEM WITHOUT ADDITIONAL COMPENSATION.
- DAMAGE CAUSED TO THE EXISTING STRUCTURE, PIPES, DUCTS, WINDOWS, WALL FLOORS, ETC. SHALL BE REPAIRED TO THE ORIGINAL CONDITION OR REPLACED BY THE CONTRACTOR AT NO ADDITIONAL COST.
- THE CONTRACTOR SHALL BE HELD RESPONSIBLE FOR THE PROPER INSTALLATION AND COMPLETION OF THE WORK WITH APPROVED MATERIALS.
- NO CHANGES ARE TO BE MADE WITHOUT THE CONSULTATION AND APPROVAL OF THE ARCHITECT.
- CONTRACTOR SHALL OBTAIN BULDING PERMIT. NO WORK TO START UNLESS BUILDING PERMIT IS PROPERLY DISPLAYED.
- ALL WORKMANSHIP AND MATERIALS SHALL BE OF FIRST QUALITY AND IN COMPLIANCE WITH THE REQUIREMENTS OF THE NC BUILDING CODE, THE DEPARTMENT OF ENVIRONMENTAL PROTECTION AND ALL PERTINENT AGENCIES.
- IT IS ESSENTIAL THAT ALL WORK PROCEED WITH THE MAXIMUM COOPERATION OF ALL PARTIES AND WITH MINIMUM INTERFERENCE TO THE OCCUPANTS WITHIN THE BUILDING. THE OWNER'S DIRECTIONS IN THIS REGARD SHALL BE FULLY COMPLIED WITH
- ALL EXPOSED PLUMBING, HVAC, ELECTRICAL DUCTWORK, PIPING AND CONDUITS ARE TO BE PAINTED BY GENERAL CONTRACTOR.
- THE CONTRACTOR SHALL PERFORM THE WORK IN STRICT CONFORMANCE WITH THE LOCAL LAWS, REGULATIONS AND THE NATIONAL ELECTRIC CODE.
- THE CONTRACTOR SHALL OBTAIN ALL PERMITS, APPROVALS, AFFIDAVITS, CERTIFICATIONS, ETC. AND PAY ALL FEES AS REQUIRED BY THE LOCAL AUTHORITIES.
- CONTRACTORS SHALL OBTAIN FIRE CERTIF. UPON COMPLETION OF WORK.

### **GOVERNING CODES**

2018 INTERNATIONAL FIRE CODE 2018 INTERNATIONAL BUILDING CODE 2018 INTERNATIONAL RESIDENTIAL CODE 2018 NORTH CAROLINA STATE BUILDING CODE 2017 NATIONAL ELECTRICAL CODE

AUTHORITY HAVING JURISDICTION (AHJ): HARNETT COUNTY


#### **WIRING AND CONDUIT NOTES:**

- ALL CONDUIT SIZES AND TYPES, SHALL BE LISTED FOR ITS PURPOSE AND APPROVED FOR THE SITE APPLICATIONS.
- ALL PV CABLES AND HOME RUN WIRES BE #10AWG \*USE-2, PV WIRE, OR PROPRIETARY SOLAR CABLING SPECIFIED BY MFR. OR EQUIVALENT; ROUTED TO SOURCE CIRCUIT COMBINER BOXES AS REQUIRED.
- ALL CONDUCTORS AND OCPD SIZES AND TYPES SPECIFIED ACCORDING TO [NEC 690.8 (A)(1) & (B)(1)], [NEC 240] [NEC 690.7] FOR MULTIPLE CONDUCTORS.
- ALL PV DC CONDUCTORS IN CONDUIT EXPOSED TO SUNLIGHT SHALL BE DERATED ACCORDING TO [NEC TABLE 310.15 (B)(2)(C)] BLACK ONLY\*\*
- EXPOSED ROOF PV DC CONDUCTORS SHALL BE USE-2, 90°C RATED, WET AND UV RESISTANT, AND UL LISTED RATED FOR 600V, UV RATED SPIRAL WRAP SHALL BE USED TO PROTECT WIRE FROM SHARP EDGES.
- PHASE AND NEUTRAL CONDUCTORS SHALL BE DUAL RATED THHN/THWN-2 INSULATED, 90°C RATED, WET AND UV RESISTANT, RATED FOR 600V PER NEC 2008 OR 1000V PER NEC 2011.
- 4-WIRE DELTA CONNECTED SYSTEMS HAVE THE PHASE WITH THE HIGHER VOLTAGE TO GROUND MARKED ORANGE OR IDENTIFIED BY OTHER EFFECTIVE MEANS.
- ALL SOURCE CIRCUITS SHALL HAVE INDIVIDUAL SOURCE CIRCUIT PROTECTION.
- **VOLTAGE DROP LIMITED TO 2%**
- AC CONDUCTORS >4AWG COLOR CODED OR MARKED: PHASE A OR L1- BLACK, PHASE B OR L2- RED, PHASE C OR L3- BLUE, NEUTRAL- WHITE/GRAY.

SHEET INDEX						
PV-0	COVER PAGE					
PV-1	SITE PLAN					
PV-2	ROOF PLAN & MODULES					
PV-3	ATTACHMENT DETAIL					
PV-4	ELECTRICAL LINE DIAGRAM & CALCS.					
PV-5	ELECTRICAL PHOTOS					
PV-6	SPECIFICATIONS & CALCS.					
PV-7	LABLE & PLACARDS					
PV-8+	EQUIPMENT SPECIFICATIONS					



1 PV-0	HOUSE PHOTO	SCALE: NTS
		_

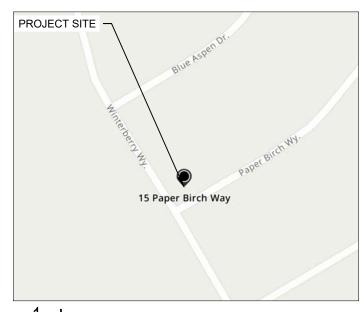

VICINITY MAP



**CAROLINA CONNECTIONS** 

422 HUFFMAN MILL ROAD, SUITE 105, BURLINGTON, NC 27215, UNITED STATES PHONE: (336) 585-1314

SYSTEM INFO. (26) LONGI SOLAR LR5-54HABB-400M (13) DURACELL POWER CENTER SOLAR PV DUAL D700-M2 (240V) DC SYSTEM SIZE: 10.400 KWDC

AC SYSTEM SIZE: 9.048 KWAC REVISIONS DESCRIPTION DATE



PROJECT NAME & ADDRESS

K CIOLEK RESILL.
5 PAPER BIRCH WAY,
2UAY VARINA, NC 27526
... (716) 307-0539 15 PAP FUQUAY PH.#

> DATE: 12/10/2024 SHEET NAME

**COVER PAGE** 

SHEET SIZE

ANSI B 11" X 17"


> SHEET NUMBER PV-0


SCALE: NTS

# **ELECTRICAL NOTES:**

RIDGE, HIP, OR VALLEY.

- ALL EQUIPMENT TO BE LISTED BY UL OR OTHER NRTL, AND LABELED FOR ITS APPLICATION.
- ALL CONDUCTORS SHALL BE COPPER, RATED FOR 600 V AND 90 DEGREE C WET ENVIRONMENT.
- WIRING, CONDUIT, AND RACEWAYS MOUNTED ON ROOFTOPS SHALL BE ROUTED DIRECTLY TO, AND LOCATED AS CLOSE AS POSSIBLE TO THE NEAREST
- WORKING CLEARANCES AROUND ALL NEW AND EXISTING ELECTRICAL EQUIPMENT SHALL COMPLY WITH NEC 110.26.
- WHERE SIZES OF JUNCTION BOXES, RACEWAYS, AND CONDUITS ARE NOT SPECIFIED, THE CONTRACTOR SHALL SIZE THEM ACCORDINGLY.
- ALL WIRE TERMINATIONS SHALL BE APPROPRIATELY LABELED AND READILY VISIBLE.
- MODULE GROUNDING (UFO) FASTENER TO BE INSTALLED BETWEEN MODULE FRAME AND MODULE SUPPORT RAIL, PER THE (UFO) FASTENER MANUFACTURE'S INSTRUCTION.

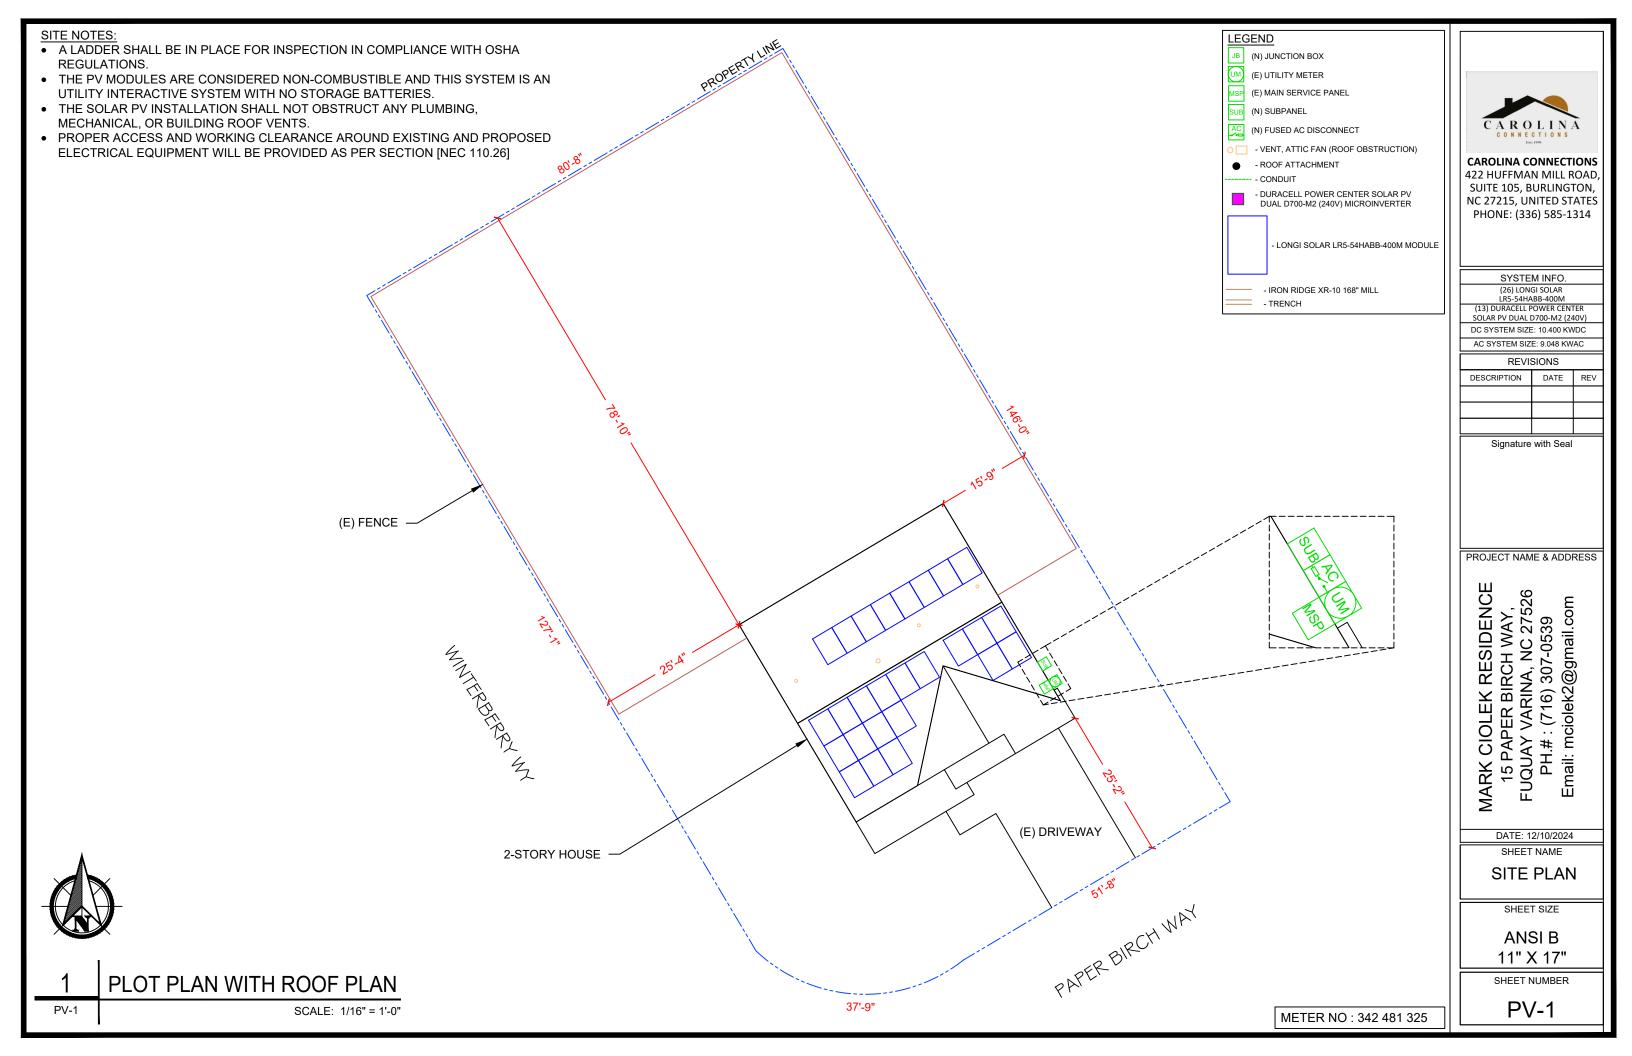

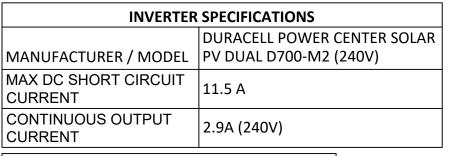


MODULE TYPE, DIMENSIONS & WEIGHT							
NUMBER OF MODULES:	26 MODULES						
MODULE TYPE:	LONGI SOLAR LR5-54HABB-400M						
MODULE WEIGHT:	49.60 LBS/22.5 KG						
MODULE DIMENSIONS:	67.80" x 44.65" = 21.02SF						
UNIT WEIGHT OF ARRAY:	2.36 PSF						

ARRAY AREA & ROOF AREA CALC'S								
ROOF	ROOF # OF MODULES ARRAY AREA (Sq. Ft.)							
#1	18 336.14							
#2 8 149.21								
(TOTAL ARRAY AREA/TOTAL ROOF AREA) X 100%								
(485.36/1711.22) X 100% = 28.36%								

DESIGN SPECIFICATION					
RISK CATEGORY:	II				
CONSTRUCTION:	SFD				
ZONING:	RESIDENTIAL				
SNOW LOAD (ASCE 7-10):	15 PSF				
EXPOSURE CATEGORY:	В				
WIND SPEED (ASCE 7-10):	116 MPH				

ROOF DESCRIPTION								
ROOF	ROOF TILT	AZIMUTH	TRUSS SIZE	TRUSS SPACING	ROOF MATERIAL			
#1	28°	149°	2" X 4"	24" O.C.	COMP. SHINGLE			
#2	28°	329°	2" X 4"	24" O.C.	COMP. SHINGLE			

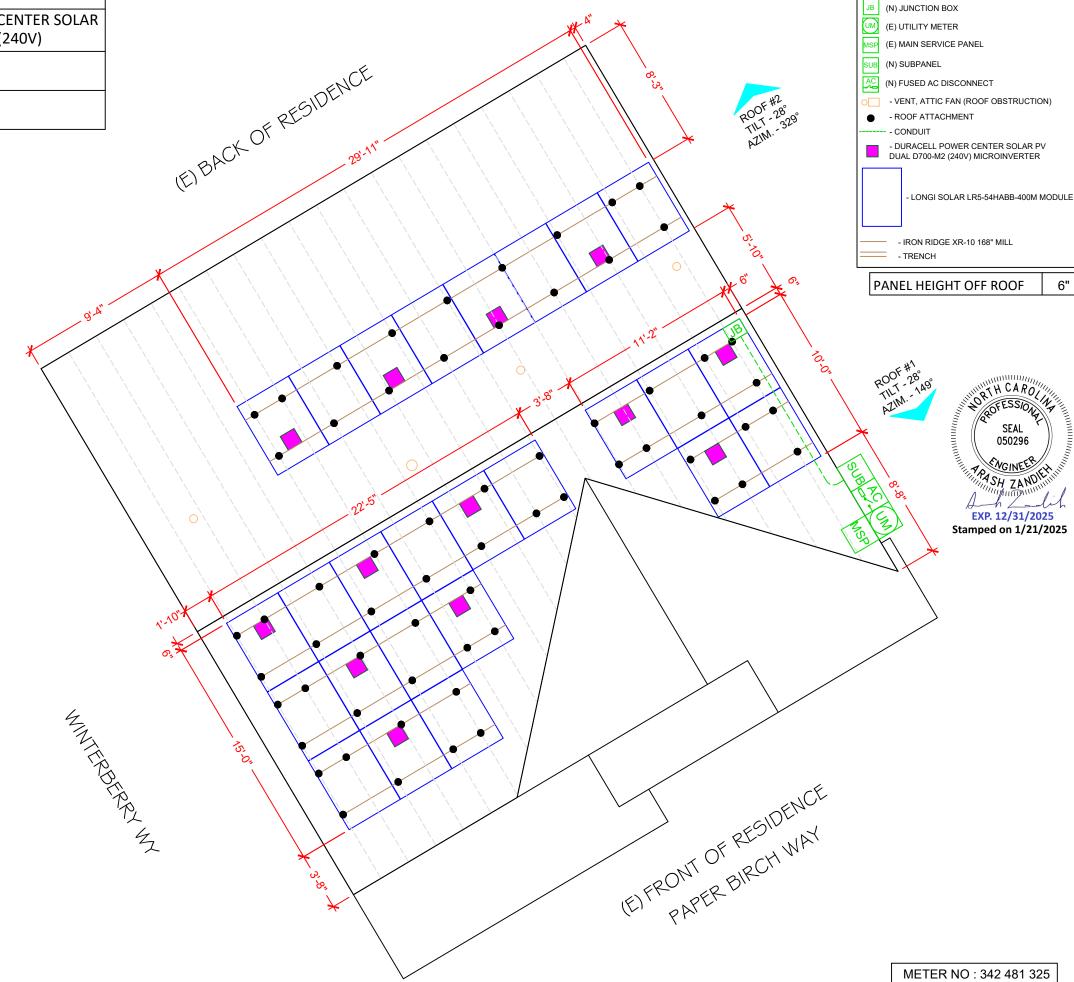



PV-2

**ROOF PLAN & MODULES** 

SCALE: 1/6" = 1'-0"



<u>LEGEND</u>

**CAROLINA CONNECTIONS** 

422 HUFFMAN MILL ROAD, SUITE 105, BURLINGTON, NC 27215, UNITED STATES PHONE: (336) 585-1314

SYSTEM INFO.

(26) LONGI SOLAR LR5-54HABB-400M (13) DURACELL POWER CENTER SOLAR PV DUAL D700-M2 (240V)

DC SYSTEM SIZE: 10.400 KWDC AC SYSTEM SIZE: 9.048 KWAC

**REVISIONS** DATE DESCRIPTION

Signature with Seal

PROJECT NAME & ADDRESS

MARK CIOLEK RESIDENCE 15 PAPER BIRCH WAY, FUQUAY VARINA, NC 27526 PH.#: (716) 307-0539 Email: mciolek2@gmail.com

DATE: 12/10/2024


SHEET NAME

**ROOF PLAN & MODULES** 

SHEET SIZE

ANSI B 11" X 17"

SHEET NUMBER

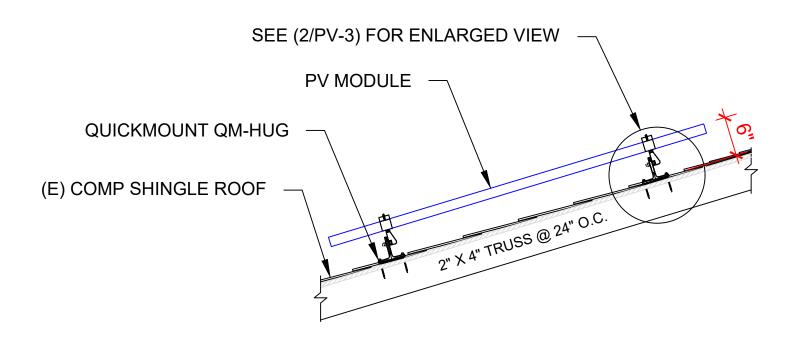

SH ZANDIE

EXP. 12/31/2025 Stamped on 1/21/2025

ATTACHMENT DETAILS

MID CLAMP/END CLAMP (N) LONGI SOLAR (N) BND T-BOLT & NUT LR5-54HABB-400M MODULE 3/8"X1" SS W/SS SERRATED **FLANGE NUT IRONRIDGE XR-10 RAIL** QUICKMOUNT QM-HUG (E) COMP. SHINGLE (N) ROOF / DECK MEMBRANE SELF DRILLING SCREW, #14, WOOD TIP WITH EPDM BACKED WASHER, MIN 2.5" **EMBEDMENT** 

(E) 2" X 4" TRUSS @ 24" O.C.

MARK CIOLEK RESIDENCE 15 PAPER BIRCH WAY, FUQUAY VARINA, NC 27526 PH.#: (716) 307-0539

**CAROLINA CONNECTIONS** 422 HUFFMAN MILL ROAD SUITE 105, BURLINGTON,

NC 27215, UNITED STATES PHONE: (336) 585-1314

SYSTEM INFO. (26) LONGI SOLAR LR5-54HABB-400M (13) DURACELL POWER CENTER SOLAR PV DUAL D700-M2 (240V) DC SYSTEM SIZE: 10.400 KWDC AC SYSTEM SIZE: 9.048 KWAC **REVISIONS** 

Signature with Seal

PROJECT NAME & ADDRESS

DATE

DESCRIPTION

DATE: 12/10/2024

SHEET NAME

**ATTACHMENT DETAIL** 

SHEET SIZE

**ANSI B** 11" X 17"

SHEET NUMBER

PV-3


**ENLARGED VIEW OF ATTACHMENT** 

PV-3

PV-3

SCALE: NTS

ID	TYPICAL	INITIAL CONDUCTOR LOCATION	FINAL CONDUCTOR LOCATION	CONDUCT	OR	CONDUIT	# OF PARALLEL CIRCUITS	CURRENT-CARRYING CONDUCTORS IN CONDUIT	CONDUIT FILL PERCENT	OCPD	E	GC		CORR.	CONDUIT FILL FACTOR	CONT. CURRENT	MAX. CURRENT	BASE AMP.	DERATED AMP.	TERM. TEMP. RATING	LENGTH	VOLTAGE DROP	
1	3	ARRAY	JUNCTION BOX	10 AWG AC CABLE	-	-	1	2	N/A	N/A	6 AWG	BARE COPPER	0.71	(56°C)	N/A	14.50A	18.13A	N/A	N/A	90°C	44FT	0.66%	
2	1	JUNCTION BOX	SUBPANEL	10 AWG THWN-2	COPPER	MIN 0.75" Dia	3	6	26.72%	20A	10 AWG	THWN-2, COPPER	0.96	(34°C)	0.8	14.50A	18.13A	40A	30.7A	75°C	32FT	0.50%	
3	1	SUBPANEL	FUSED AC DISCONNECT	8 AWG THWN-2	COPPER	MIN 0.75" Dia	1	3	23.86%	60A	10 AWG	THWN-2, COPPER	0.96	(34°C)	1	37.70A	47.13A	55A	52.8A	75°C	5FT	0.13%	
4	1	FUSED AC DISCONNECT	MAIN SERVICE PANEL	8 AWG THWN-2	COPPER	MIN 0.75" Dia	1	3	23.86%	N/A	10 AWG	THWN-2, COPPER	0.96	(34°C)	1	37.70A	47.13A	55A	52.8A	75°C	5FT	0.13%	<b>C</b> A

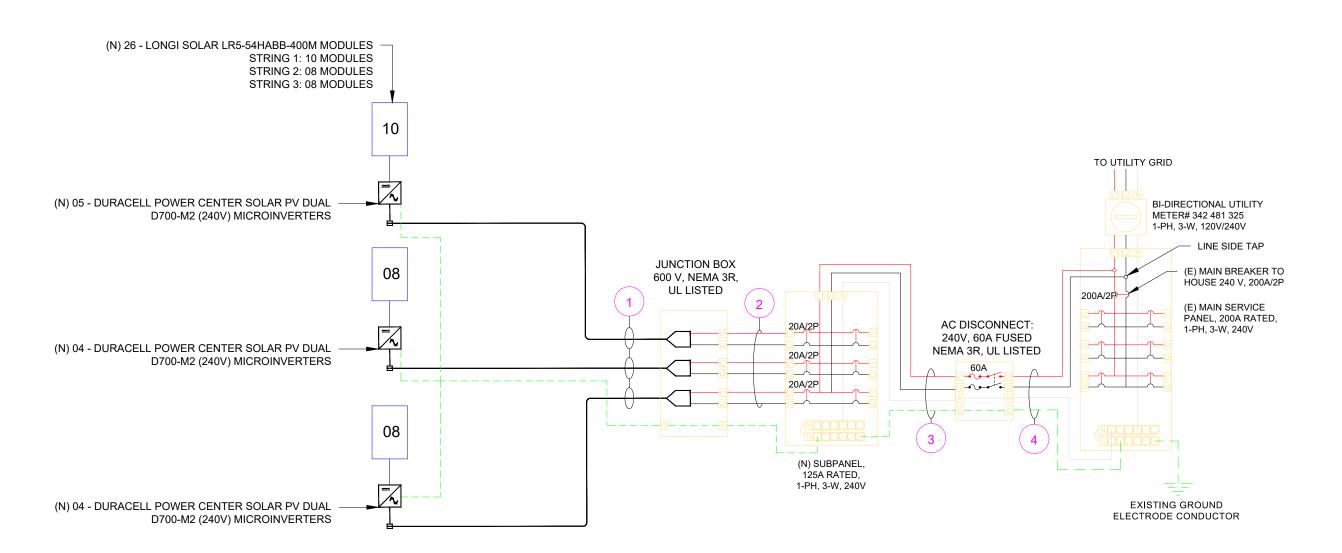

INVERTER SPECIFICATIONS						
MANUFACTURER / MODEL	DURACELL POWER CENTER SOLAR PV DUAL D700-M2 (240V)					
MAX DC SHORT CIRCUIT CURRENT	11.5 A					
CONTINUOUS OUTPUT CURRENT	2.9A (240V)					
MAX CONTINUOUS OUTPUT POWER	696W					

			1 4				
)	SERVICE INFO						
	UTILITY PROVIDER:	DUKE ENERGY	IN				
	AHJ NAME:	HARNETT COUNTY	٧				
	MAIN PANEL BRAND:	SQUARE D	IS				
	MAIN SERVICE PANEL:	200A	Т				
	MAIN PANEL LOCATION:	NORTH EAST	N				
	SERVICE FEED SOURCE:	UNDERGROUND	P				

SOLAR MODU	SOLAR MODULE SPECIFICATIONS						
MANUFACTURER / MODEL	LONGI SOLAR LR5-54HABB-400M						
VMP	30.94 V						
IMP	12.93 A						
VOC	37.05 V						
ISC	13.72 A						
TEMP. COEFF. VOC	-0.265 %/C						
MODULE DIMENSION	67.80" (L) x 44.65" (W)						
PANEL WATTAGE	400W						



**CAROLINA CONNECTIONS** 

422 HUFFMAN MILL ROAD, SUITE 105, BURLINGTON, NC 27215, UNITED STATES PHONE: (336) 585-1314

SYSTEM INFO. (26) LONGI SOLAR LRS-54HABB-400M (13) DURACELL POWER CENTER SOLAR PV DUAL D700-M2 (240V)

DC SYSTEM SIZE: 10.400 KWDC

AC SYSTEM SIZE: 9.048 KWAC

REVISIONS DESCRIPTION DATE REV

Signature with Seal SEAL 047345

**STAMPED 01/21/2025** 

PROJECT NAME & ADDRESS

MARK CIOLEK RESIDENCE 15 PAPER BIRCH WAY, FUQUAY VARINA, NC 27526 PH.#: (716) 307-0539 Email: mciolek2@gmail.com

DATE: 12/10/2024 SHEET NAME

**ELECTRICAL LINE** & CALCS.

SHEET SIZE

ANSI B 11" X 17"

SHEET NUMBER

PV-4

**ELECTRICAL LINE DIAGRAM** 

PV-4

SCALE: NTS





**CAROLINA CONNECTIONS** 

422 HUFFMAN MILL ROAD, SUITE 105, BURLINGTON, NC 27215, UNITED STATES PHONE: (336) 585-1314

SYSTEM INFO.

(26) LONGI SOLAR LR5-54HABB-400M (13) DURACELL POWER CENTER SOLAR PV DUAL D700-M2 (240V)

DC SYSTEM SIZE: 10.400 KWDC AC SYSTEM SIZE: 9.048 KWAC

**REVISIONS** 

DATE DESCRIPTION

Signature with Seal



PROJECT NAME & ADDRESS

MARK CIOLEK RESIDENCE 15 PAPER BIRCH WAY, FUQUAY VARINA, NC 27526 PH.#: (716) 307-0539 Email: mciolek2@gmail.com

DATE: 12/10/2024

SHEET NAME **ELECTRICAL PHOTOS** 

SHEET SIZE

ANSI B 11" X 17"

SHEET NUMBER

SOLAR MODULE SPECIFICATIONS					
MANUFACTURER / MODEL	LONGI SOLAR LR5-54HABB-400M				
VMP	30.94 V				
IMP	12.93 A				
VOC	37.05 V				
ISC	13.72 A				
TEMP. COEFF. VOC	-0.265 %/C				
MODULE DIMENSION	67.80" (L) x 44.65" (W)				
PANEL WATTAGE	400W				

INVERTER SPECIFICATIONS						
	DURACELL POWER CENTER SOLAR					
MANUFACTURER / MODEL	PV DUAL D700-M2 (240V)					
MAX DC SHORT CIRCUIT CURRENT	11.5 A					
CONTINUOUS OUTPUT CURRENT	2.9A (240V)					

AMBIENT TEMPERATURE SPECS	3
RECORD LOW TEMP	-12°C
AMBIENT TEMP (HIGH TEMP 2%)	34°C
CONDUIT HEIGHT	7/8"
ROOF TOP TEMP	90°C
CONDUCTOR TEMPERATURE RATE	56°C
MODULE TEMPERATURE COEFFICIENT OF VOC	-0.265 %/C

PERCENT OF VALUES	NUMBER OF CURRENT CARRYING CONDUCTORS IN EMT
0.80	4-6
0.70	7-9
0.50	10-20

# Voltage rise from the Microinverters to the Junction Box

For branch circuit #1 of 05 D700-M2 Micros, the voltage rise on the 240 VAC AC Cable is 0.66% For branch circuit #2 of 04 D700-M2 Micros, the voltage rise on the 240 VAC AC Cable is 0.47% For branch circuit #3 of 04 D700-M2 Micros, the voltage rise on the 240 VAC AC Cable is 0.35%

# Voltage rise from the Junction Box to the Subpanel

VRise = (amps/inverter × number of inverters) × (resistance in  $\Omega/\text{ft}$ ) × (2-way wire length in ft)

- =  $(2.9 \text{ amp} \times 5) \times (0.00129 \Omega/\text{ft}) \times (32 \text{ ft} \times 2)$
- = 14.50 amps × 0.00129  $\Omega/\text{ft}$  × 64 ft
- = 1.20 volts

%VRise = 1.20 volts ÷ 240 volts = 0.50%

The voltage rise from the Junction Box to the Subpanel is 0.50%

# **Voltage rise from the Subpanel to Fused AC Disconnect**

VRise = (amps/inverter × number of inverters) × (resistance in  $\Omega/\text{ft.}$ ) × (2-way wire length in ft.)

- =  $(2.9 \text{ amp} \times 13) \times (0.000809 \Omega/\text{ft}) \times (5 \text{ ft.} \times 2)$
- = 37.70 amps × 0.000809  $\Omega/\text{ft}$  × 10 ft.
- = 0.30 volts

 $%VRise = 0.30 \text{ volts} \div 240 \text{ volts} = 0.13\%$ 

The voltage rise from the Subpanel to the Fused AC Disconnect is 0.13%

# **Voltage rise from the Fused AC Disconnect to Main Service Panel**

VRise = (amps/inverter × number of inverters) × (resistance in  $\Omega/\text{ft.}$ ) × (2-way wire length in ft.)

- =  $(2.9 \text{ amp} \times 13) \times (0.000809 \Omega/\text{ft}) \times (5 \text{ ft.} \times 2)$
- = 37.70 amps × 0.000809  $\Omega/\text{ft}$  × 10 ft.
- = 0.30 volts

 $%VRise = 0.30 \text{ volts} \div 240 \text{ volts} = 0.13\%$ 

The voltage rise from the Fused AC Disconnect to the Main Service Panel is 0.13%

# Total system voltage rise for all wire sections

0.66% + 0.50% + 0.13% + 0.13% = 1.42%



**CAROLINA CONNECTIONS 422 HUFFMAN MILL ROAD** SUITE 105, BURLINGTON, NC 27215, UNITED STATES

PHONE: (336) 585-1314

SYSTEM INFO. (26) LONGI SOLAR LR5-54HABB-400M (13) DURACELL POWER CENTER SOLAR PV DUAL D700-M2 (240V)

DC SYSTEM SIZE: 10.400 KWDC

AC SYSTEM SIZE: 9.048 KWAC DESCRIPTION DATE



PROJECT NAME & ADDRESS

MARK CIOLEK RESIDENCE 15 PAPER BIRCH WAY, FUQUAY VARINA, NC 27526 PH.#: (716) 307-0539

DATE: 12/10/2024

SHEET NAME **SPECIFICATIONS** & CALC.

SHEET SIZE

ANSI B 11" X 17"

SHEET NUMBER

# **WARNING ELECTRIC SHOCK HAZARD**

TERMINALS ON BOTH LINE AND LOAD SIDES MAY BE ENERGIZED IN THE OPEN POSITION

LABEL LOCATION:

MAIN SERVICE PANEL/AC DISCONNECT/AC COMBINER (PER CODE: NEC 2017 690.13(B))

2

**WARNING: PHOTOVOLTAIC POWER SOURCE** 

LABEL LOCATION:

EVERY 10' AND ON CONDUIT BODIES WHEN EXPOSED (PER CODE: NEC2017 690.31(G)(3)(4))

3

PHOTOVOLTAIC SYSTEM AC DISCONNECT RATED AC OUTPUT CURRENT 37.70 AMPS NOMINAL OPERATING AC VOLTAGE 240 VOLTS

MAIN SERVICE PANEL/AC DISCONNECT NEC2017, 690,53

4

**RAPID SHUTDOWN SWITCH FOR SOLAR PV SYSTEM** 

LABEL LOCATION: AT OR WITHIN 3' OF THE AC/DC COMBINER SWITCH PER CODE: NEC 690.58(C)(3)

5



**DUAL POWER SOURCE SECOND SOURCE IS PHOTOVOLTAIC SYSTEM** 


LABEL LOCATION: MAIN SERVICE PANEL/AC DISCONNECT/AC COMBINER/REVENUE METER 2017 NEC 705.12(B)(3)

#### ADHESIVE FASTENED SIGNS

- ANSI Z535.4-2011 PRODUCT SAFETY SIGNS AND LABELS, PROVIDES GUIDELINES FOR SUITABLE FONT SIZES, WORDS, COLORS, SYMBOLS, AND LOCATION REQUIREMENTS FOR LABELS. NEC 110.21(B)(1).
- THE LABEL SHALL BE OF SUFFICIENT DURABILITY TO WITHSTAND THE ENVIRONMENT INVOLVED. NEC 110.21(B)(3).
- ADHESIVE FASTENED SIGNS MAY BE ACCEPTABLE IF PROPERLY ADHERED. VINYL SIGNS SHALL BE WEATHER RESISTANT.

SOLAR PV SYSTEM EQUIPPED WITH RAPID SHUTDOWN

URN RAPID SHUTDOWN SWITCH TO THE "OFF" POSITION TO HUT DOWN PV SYSTEM AND REDUCE SHOCK HAZARD IN THE ARRAY

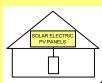

MAIN SERVICE PANEL IF MSD IS OUTSIDE PLACE IT THERE / IF MSD IS INSIDE PLACE ON THE AC DISCONNECT PER CODE: NEC 690.56(C)(1)

7

6

**PHOTOVOLTAIC SYSTEM UTILITY DISCONNECT SWITCH** 

LABEL LOCATION: 2017 NEC 690.56(C)(3) 8

**SERVICE DISCONNECT** 


**SECTIONNEUR PRINCIPALE** 

**SERVICIO DE DESCONEXION** 

LABEL LOCATION: AC DISCONNECT 2017 NEC 230.66

**CAUTION** 

POWER TO THIS BUILDING IS ALSO SUPPLIED FROM THE FOLLOWING SOURCES WITH DISCONNECTS

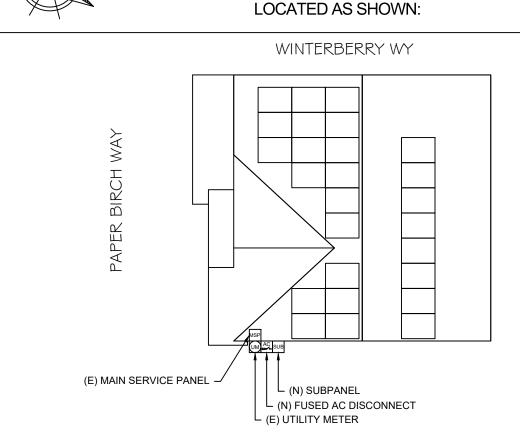



**CAROLINA CONNECTIONS** 422 HUFFMAN MILL ROAD,

SUITE 105, BURLINGTON, NC 27215, UNITED STATES PHONE: (336) 585-1314

SYSTEM INFO. (26) LONGI SOLAR LR5-54HABB-400M (13) DURACELL POWER CENTER

SOLAR PV DUAL D700-M2 (240V) DC SYSTEM SIZE: 10.400 KWDC AC SYSTEM SIZE: 9.048 KWAC

REVISIONS DESCRIPTION DATE

Signature with Seal 047345 STAMPED 01/21/2025

PROJECT NAME & ADDRESS

MARK CIOLEK RESIDENCE 15 PAPER BIRCH WAY, FUQUAY VARINA, NC 27526 PH.#: (716) 307-0539 Email: mciolek2@gmail.com

DATE: 12/10/2024

SHEET NAME **SIGNAGE** 

SHEET SIZE

ANSI B 11" X 17"

> SHEET NUMBER PV-7













## LR5-54HABB 390~415M

21.3%


0~3%

<2% FIRST YEAR POWER DEGRADATION


0.45% YEAR 2-30 POWER DEGRADATION

**HALF-CELL** Lower operating temperature

#### **Additional Value**

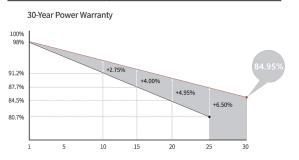

#### **Mechanical Parameters** Cell Orientation 108 (6×18) Junction Box IP68, three diodes 4mm $^2$ , $\pm 1200$ mm Output Cable length can be customized Glass Dual glass, 2.0+1.6mm heat strengthened glass Frame Anodized aluminum alloy frame Weight 1722×1134×30mm Packaging 36pcs per pallet / 216pcs per 20' GP / 936pcs or 792pcs (Only for USA) per 40' HC

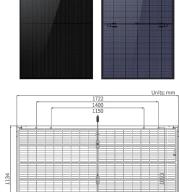

	115	50 i	
1134			1083
Tolerance:	>		
Length: ±2mm Width: ±2mm	45 C	30 A-A	S B-B

Module Type	LR5-54H	ABB-390M	LR5-54H	ABB-395M	LR5-54H	ABB-400M	LR5-54H	ABB-405M	LR5-54H/	ABB-410M	LR5-54H	ABB-415M
Testing Condition	STC	NOCT	STC	NOCT	STC	NOCT	STC	NOCT	STC	NOCT	STC	NOCT
Maximum Power (Pmax/W)	390	291.5	395	295.2	400	299.0	405	302.7	410	306.5	415	310.2
Open Circuit Voltage (Voc/V)	36.58	34.39	36.81	34.61	37.05	34.84	37.29	35.06	37.53	35.29	37.77	35.51
Short Circuit Current (Isc/A)	13.57	10.95	13.65	11.01	13.72	11.07	13.79	11.13	13.87	11.19	13.94	11.25
Voltage at Maximum Power (Vmp/V)	30.47	28.43	30.70	28.64	30.94	28.86	31.18	29.09	31.42	29.31	31.66	29.54
Current at Maximum Power (Imp/A)	12.80	10.26	12.87	10.31	12.93	10.36	12.99	10.41	13.05	10.45	13.11	10.50
Module Efficiency(%)	2	0.0	2	0.2	2	0.5	2	0.7	2	1.0	2	1.3

Electrical characteristics	with different rear side p	ower gain (reference to 40	00W front)		
Pmax /W	Voc/V	Isc /A	Vmp/V	Imp /A	Pmax gain
420	37.05	14.41	30.94	13.58	5%
440	37.05	15.09	30.94	14.22	10%
460	37.15	15.78	31.04	14.87	15%
480	37.15	16.46	31.04	15.52	20%
500	37.15	17.15	31.04	16.16	25%

Operating Parameters		
Operational Temperature	-40°C ~ +85°C	
Power Output Tolerance	0~3%	
Voc and Isc Tolerance	±3%	
Maximum System Voltage	DC1500V (IEC/UL)	
Maximum Series Fuse Rating	30A	
Nominal Operating Cell Temperature	45±2℃	
Protection Class	Class II	
Bifaciality	70±5%	
Fire Rating	UL Similar type 38 *	

IEC Class C

Web: www.longi.com

No.8369 Shangyuan Road, Xi'an Economic And

Technological Development Zone, Xi'an, Shaanxi, China.

Reference Standard: UL61730 Second	Edition,	Dated	October	28, 20	)22

subject to change without notice. LONGi reserves the right of final interpretation. (20230115V17) Only for North America

#### **Mechanical Loading**

Front Side Maximum Static Loading	5400Pa
Rear Side Maximum Static Loading	2400Pa
Hailstone Test	25mm Hailstone at the speed of 23m/s

#### **Temperature Ratings (STC)**

Temperature Coefficient of Isc	+0.050%/°C
Temperature Coefficient of Voc	-0.265%/°C
Temperature Coefficient of Pmax	-0.340%/°C



**CAROLINA CONNECTIONS** 422 HUFFMAN MILL ROAD, SUITE 105, BURLINGTON, NC 27215, UNITED STATES PHONE: (336) 585-1314

SYSTEM INFO. (26) LONGI SOLAR LR5-54HABB-400M (13) DURACELL POWER CENTER

SOLAR PV DUAL D700-M2 (240V) DC SYSTEM SIZE: 10.400 KWDC AC SYSTEM SIZE: 9.048 KWAC

REVISIONS DESCRIPTION DATE

Signature with Seal

PROJECT NAME & ADDRESS

MARK CIOLEK RESIDENCE 15 PAPER BIRCH WAY, FUQUAY VARINA, NC 27526 PH.#: (716) 307-0539

Email: mciolek2@gmail.com

DATE: 12/10/2024


SHEET NAME **EQUIPMENT** 

**SPECIFICATION** 

SHEET SIZE

ANSI B 11" X 17"

SHEET NUMBER

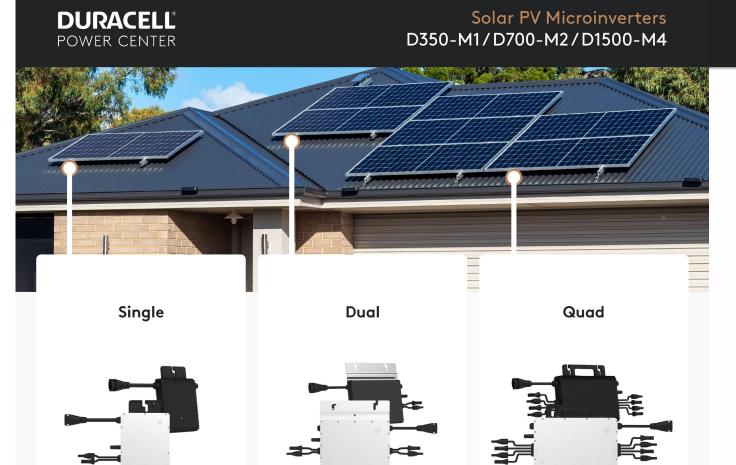

# Fast, Easy & Flexible Installation

Duracell Power Center's family of single, dual, and quad microinverters delivers the lowest cost, highest yield per panel PV installation.

The AC trunk cable format permits any combination of the three models to optimize even the most complex rooftop installations.

**Reactive Power Control** CA Rule 21 compliant

**Become a Duracell Partner Today** 

Compliant with U.S. NEC-2017 & NEC-2020 690.12 rapid shutdown

High reliability: NEMA 6 (IP67) enclosure, 6000V surge protection

# **DURACELL**° POWER CENTER

## Solar PV Microinverters D350-M1/D700-M2/D1500-M4

### **Technical Data**

<b>dodel</b>	D35	0-M1	D700	0-M2	D150	0-M4	
Input Data (DC)							
Number of PV inputs	id	1		2	4	1	
Module power range, typical (W)	280 to	o 470+	280 to	470+	300 to 505+		
Maximum input voltage (V)	0		6	0			
MPPT voltage range (V)	Ĺ		16-	-60			
Start-up voltage (V)			2	2			
Maximum input current (A)			11	.5			
Output Data (AC)							
Peak output power (VA)		50	7(	00	1500	1350	
Maximum continuous output power (VA)	34	49	69	96	1438	1246	
Maximum continuous output current (A)	1.45	1.68	2.9	3.35	5.99	5.99	
Nominal output voltage(V)	240	208	240	208	240	208	
Nominal output voltage range1 (V)	211-264	183-228	211-264	183-228	211-264	183-22	
Nominal frequency/range1 (Hz)			60/5	5-65			
Power factor (adjustable)		>0	.99 default (0.	8 lead to 0.8 lo	ag)		
Total harmonic distortion	Ì		< 3	5%			
Maximum units per branch2 (10 AWG)	16	14	8	7	4	4	
Efficiency							
CEC peak efficiency (%)	•		96	5.7			
CEC weighted efficiency (%)			96	5.5			
Nominal MPPT efficiency (%)			99	P.8			
Nighttime power consumption (mW)			<;	50			
Mechanical Data							
Ambient temperature range (°C)	ł		-40 t	0 +65			
Dimensions (W × H × D) mm	182 x 16	4 x 29.5	250 x 1	70 x 28	280 x 1	76 x 33	
Weight (kg)	1.	75	2	.6	3.	35	
Enclosure rating			Outdoor	NEMA 6			
Cooling			Natural conve	ction - no fans			
Features							
Communication		2	.4 GHz proprie	tary RF (Nordi	c)		
Monitoring				es	•		
Warranty	1			25 years			
Compliance	UL 1741, IEEE 1	1547, UL 1741 SA	(240 Vac), CA		/ac), CSA C22.	2 No. 107.1	
PV Rapid Shutdown	Conforms		and NEC-2020			Sec 64-218	

sales@duracellpowercenter.com

Duracell is a registered trademark of Duracell U.S. Operations, Inc., used under license. All rights reserved.



**CAROLINA CONNECTIONS** 422 HUFFMAN MILL ROAD, SUITE 105, BURLINGTON, NC 27215, UNITED STATES PHONE: (336) 585-1314

SYSTEM INFO.
(26) LONGI SOLAR
LR5-54HABB-400M
(13) DURACELL POWER CENTER
SOLAR PV DUAL D700-M2 (240)
DC SYSTEM SIZE: 10 400 KWD0

AC SYSTEM SIZE: 9.048 KWAC

REVISIONS			
DESCRIPTION	DATE	REV	

Signature with Seal

PROJECT NAME & ADDRESS

MARK CIOLEK RESIDENCE 15 PAPER BIRCH WAY, FUQUAY VARINA, NC 27526 PH.#: (716) 307-0539

DATE: 12/10/2024 SHEET NAME

**EQUIPMENT SPECIFICATION** 

SHEET SIZE

ANSI B 11" X 17"

SHEET NUMBER

<sup>\*1.</sup> Nominal voltage/frequency range can vary depending on local requirements. \*2. Refer to local requirements for exact number of microinverters per branch.



# QuickMount® HUG



### **The Respect Your Roof Deserves**

When integrating with a home, solar attachments must be dependable for the lifetime of the rooftop. Due to recent innovations, many asphalt shingles have bonded courses. A mount that protects without the need to pry shingles can really speed things up.

UltraGrip, our industrial-grade, foam-and-mastic seal. This allows HUG to accelerate the installation process and provide the utmost in waterproofing



# **Triple Rated & Certified** to Respect the Roof™ UL 2703, 441 (27) TAS 100(A)-95





### **Rafter & Deck Mounting Options**

Mount HUG to the roof rafters, the roof deck, or both with our custom-engineered RD (rafter-or-deck) Structural Screw. The RD Structural Screw anchors HUG to the roof with an EPDM sealing washer, completing the stack of waterproofing barriers. See

#### **Adaptive, Rafter-Friendly Installation**







Place another screw to the left or right. If rafter is found, install 3rd and final screw.



Still no luck? Install the rest. If more than 3 screws miss the rafter secure six screws to deck mount it.

### **Trusted Strength & Less Hassle**



Structural capacities of HUG™ were reviewed in many load directions, with racking rail running cross-slope or up-slope in relation to roof pitch.

For further details, see the HUG certification letters for attaching to rafters and decking.

IronRidge designed the HUG, in combination with the RD Structural Screw to streamline installs, which means the following:

- No prying shingles
- · No roof nail interference
- No pilot holes necessary
- · No sealant (in most cases)
- No butyl shims needed

## Attachment Loading



The rafter-mounted HUG has been tested and rated to support 1004 (lbs) of uplift and 368 (lbs) of lateral load.

**Structural** Design Ħ

Parts are designed and certified for compliance with the International **Building Code &** ASCE/SEI-7.

### Water Seal Ratings 11111

HUG passed both the UL 441 Section 27 "Rain Test" and TAS 100(A)-95 "Wind Driven Rain Test" by Intertek.

### **UL 2703** System



Systems conform to UL 2703 mechanical and bonding requirements. See Flush Mount Manual for more info.







**CAROLINA CONNECTIONS** 

422 HUFFMAN MILL ROAD, SUITE 105, BURLINGTON, NC 27215, UNITED STATES PHONE: (336) 585-1314

SYSTEM INFO. (26) LONGI SOLAR LR5-54HABB-400M (13) DURACELL POWER CENTER

SOLAR PV DUAL D700-M2 (240V) DC SYSTEM SIZE: 10.400 KWDC AC SYSTEM SIZE: 9.048 KWAC

**REVISIONS** DESCRIPTION DATE

Signature with Seal

PROJECT NAME & ADDRESS

MARK CIOLEK RESIDENCE 15 PAPER BIRCH WAY, FUQUAY VARINA, NC 27526 PH.#: (716) 307-0539 Email: mciolek2@gmail.com

DATE: 12/10/2024


SHEET NAME **EQUIPMENT SPECIFICATION** 

SHEET SIZE

ANSI B 11" X 17" SHEET NUMBER



# XR10® Rail

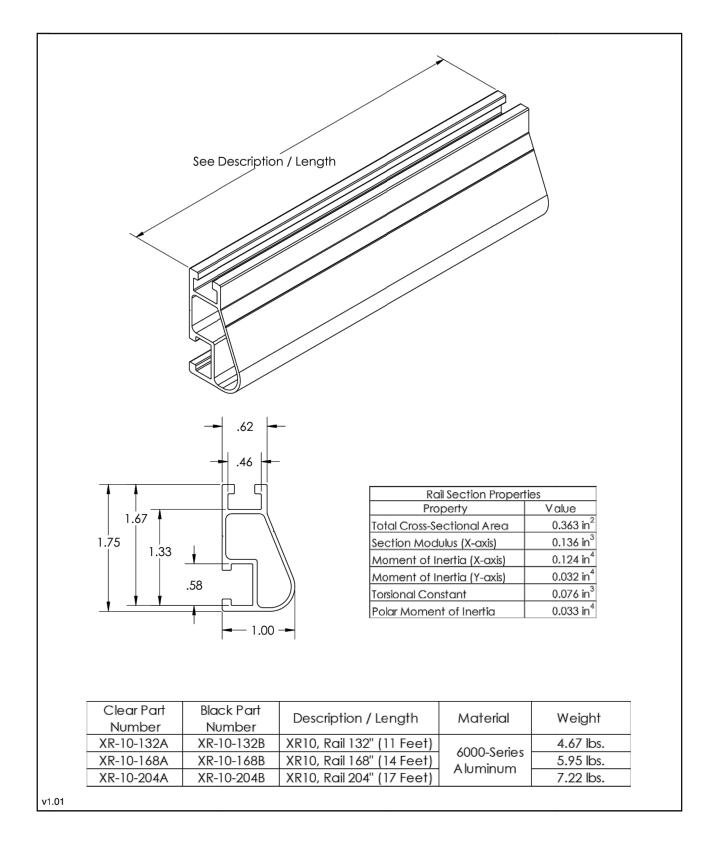



### CAROLINA CONNECTIONS

422 HUFFMAN MILL ROAD, SUITE 105, BURLINGTON, NC 27215, UNITED STATES PHONE: (336) 585-1314

SYSTEM INFO.
(26) LONGI SOLAR

(26) LONGI SOLAR LR5-54HABB-400M (13) DURACELL POWER CENTER SOLAR PV DUAL D700-M2 (240V)

DC SYSTEM SIZE: 10.400 KWDC

AC SYSTEM SIZE: 9.048 KWAC

TEVIOIONO				
DESCRIPTION	DATE	REV		

Signature with Seal

PROJECT NAME & ADDRESS

MARK CIOLEK RESIDENCE 15 PAPER BIRCH WAY, FUQUAY VARINA, NC 27526 PH.#: (716) 307-0539 Email: mciolek2@gmail.com

DATE: 12/10/2024

SHEET NAME

EQUIPMENT SPECIFICATION

SHEET SIZE

ANSI B 11" X 17"

SHEET NUMBER