SCOPE OF WORK:

GENERAL NOTES:

ARCHITECT.

ELECTRICAL NOTES:

TO INSTALL A ROOF MOUNTED SOLAR PHOTOVOLTAIC SYSTEM AT THE OWNER RESIDENCE LOCATED AT 40 DAVINHALL DR, FUQUAY-VARINA, NC 27526 THE POWER GENERATED BY THE PV SYSTEM WILL BE INTERCONNECTED WITH THE UTILITY GRID THROUGH THE EXISTING ELECTRICAL SERVICE EQUIPMENT.

THE PV SYSTEM DOES NOT INCLUDE STORAGE BATTERIES

REQUIRE MODIFICATIONS IN CONSTRUCTION DETAILS.

INSTALLATION OF ANY EQUIPMENT AT SITE.

THEM WITHOUT ADDITIONAL COMPENSATION.

COMPLETION OF THE WORK WITH APPROVED MATERIALS.

ENVIRONMENTAL PROTECTION AND ALL PERTINENT AGENCIES.

LOCAL LAWS, REGULATIONS AND THE NATIONAL ELECTRIC CODE. THE CONTRACTOR SHALL OBTAIN ALL PERMITS, APPROVALS, AFFIDAVITS,

CONTRACTOR AT NO ADDITIONAL COST.

BE PAINTED BY GENERAL CONTRACTOR.

PERMIT IS PROPERLY DISPLAYED.

EQUIPMENT SUMMARY	SYSTEM RATING
28 LONGI SOLAR LR5-54HABB-400M MODULES	11.200 KWDC
14 DURACELL POWER CENTER SOLAR PV DUAL D700-M2	9.744 KWAC
(240V) MICROINVERTERS	

THESE CONSTRUCTION DOCUMENTS HAVE BEEN BASED ON FIELD INSPECTIONS AND

CONTRACTOR SHALL FURNISH ALL LABOR, MATERIAL, EQUIPMENT, TOOLS, OBTAINS ALL

CONTRACTOR HAS THE FULL RESPONSIBILITY TO CHECK AND VERIFY ALL DIMENSIONS

RESPONSIBILITY OF THE CONTRACTOR AND SHALL BE SUBJECT TO CORRECTION BY

FLOORS, ETC. SHALL BE REPAIRED TO THE ORIGINAL CONDITION OR REPLACED BY THE

THE CONTRACTOR SHALL BE HELD RESPONSIBLE FOR THE PROPER INSTALLATION AND

NO CHANGES ARE TO BE MADE WITHOUT THE CONSULTATION AND APPROVAL OF THE

CONTRACTOR SHALL OBTAIN BULDING PERMIT. NO WORK TO START UNLESS BUILDING

ALL WORKMANSHIP AND MATERIALS SHALL BE OF FIRST QUALITY AND IN COMPLIANCE

IT IS ESSENTIAL THAT ALL WORK PROCEED WITH THE MAXIMUM COOPERATION OF ALL

THE CONTRACTOR SHALL PERFORM THE WORK IN STRICT CONFORMANCE WITH THE

CERTIFICATIONS, ETC. AND PAY ALL FEES AS REQUIRED BY THE LOCAL AUTHORITIES.

PARTIES AND WITH MINIMUM INTERFERENCE TO THE OCCUPANTS WITHIN THE BUILDING.

ALL EXPOSED PLUMBING, HVAC, ELECTRICAL DUCTWORK, PIPING AND CONDUITS ARE TO

WITH THE REQUIREMENTS OF THE NC BUILDING CODE, THE DEPARTMENT OF

THE OWNER'S DIRECTIONS IN THIS REGARD SHALL BE FULLY COMPLIED WITH

CONTRACTORS SHALL OBTAIN FIRE CERTIF. UPON COMPLETION OF WORK.

PERMITS, LICENSES AND PAY ALL REQUIRED FEES AND COMPLETE INSTALLATION.

AND EXISTING CONDITIONS. ANY DISCREPANCIES SHALL BE REPORTED TO THE

ENGINEER BEFORE PROCEEDING WITH THE WORK. ANY WORK STARTED BEFORE

DAMAGE CAUSED TO THE EXISTING STRUCTURE, PIPES, DUCTS, WINDOWS, WALL

CONSULTATION AND ACCEPTANCE BY THE ENGINEER SHALL BE THE SOLE

OTHER INFORMATION AVAILABLE AT THE TIME. ACTUAL FIELD CONDITIONS MAY

ARCHITECT HAS NOT BEEN RETAINED TO SUPERVISE ANY CONSTRUCTION OR

WIRING AND CONDUIT NOTES:

GOVERNING CODES

2018 INTERNATIONAL FIRE CODE

2017 NATIONAL ELECTRICAL CODE

2018 INTERNATIONAL BUILDING CODE

2018 INTERNATIONAL RESIDENTIAL CODE

2018 NORTH CAROLINA STATE BUILDING CODE

ALL CONDUIT SIZES AND TYPES, SHALL BE LISTED FOR ITS PURPOSE AND APPROVED FOR THE SITE APPLICATIONS.

AUTHORITY HAVING JURISDICTION (AHJ): HARNETT COUNTY

- ALL PV CABLES AND HOME RUN WIRES BE #10AWG *USE-2, PV WIRE, OR PROPRIETARY SOLAR CABLING SPECIFIED BY MFR, OR EQUIVALENT; ROUTED TO SOURCE CIRCUIT COMBINER BOXES AS REQUIRED.
- ALL CONDUCTORS AND OCPD SIZES AND TYPES SPECIFIED ACCORDING TO [NEC 690.8 (A)(1) & (B)(1)], [NEC 240] [NEC 690.7] FOR MULTIPLE CONDUCTORS.
- ALL PV DC CONDUCTORS IN CONDUIT EXPOSED TO SUNLIGHT SHALL BE DERATED ACCORDING TO [NEC TABLE 310.15 (B)(2)(C)] BLACK ONLY**
- EXPOSED ROOF PV DC CONDUCTORS SHALL BE USE-2, 90°C RATED, WET AND UV RESISTANT, AND UL LISTED RATED FOR 600V, UV RATED SPIRAL WRAP SHALL BE USED TO PROTECT WIRE FROM SHARP EDGES.
- PHASE AND NEUTRAL CONDUCTORS SHALL BE DUAL RATED THHN/THWN-2 INSULATED, 90°C RATED, WET AND UV RESISTANT, RATED FOR 600V PER NEC 2008 OR 1000V PER NEC 2011.
- 4-WIRE DELTA CONNECTED SYSTEMS HAVE THE PHASE WITH THE HIGHER VOLTAGE TO GROUND MARKED ORANGE OR IDENTIFIED BY OTHER EFFECTIVE MEANS.
- ALL SOURCE CIRCUITS SHALL HAVE INDIVIDUAL SOURCE CIRCUIT PROTECTION.
- **VOLTAGE DROP LIMITED TO 2%**
- AC CONDUCTORS >4AWG COLOR CODED OR MARKED: PHASE A OR L1- BLACK, PHASE B OR L2- RED, PHASE C OR L3- BLUE, NEUTRAL- WHITE/GRAY.


ALL EQUIPMENT TO BE LISTED BY UL OR OTHER NRTL, AND LABELED FOR ITS APPLICATION.

- ALL CONDUCTORS SHALL BE COPPER, RATED FOR 600 V AND 90 DEGREE C WET ENVIRONMENT.
- WIRING, CONDUIT, AND RACEWAYS MOUNTED ON ROOFTOPS SHALL BE ROUTED DIRECTLY TO, AND LOCATED AS CLOSE AS POSSIBLE TO THE NEAREST RIDGE, HIP, OR VALLEY.
- WORKING CLEARANCES AROUND ALL NEW AND EXISTING ELECTRICAL EQUIPMENT SHALL COMPLY WITH NEC 110.26.
- WHERE SIZES OF JUNCTION BOXES, RACEWAYS, AND CONDUITS ARE NOT SPECIFIED, THE CONTRACTOR SHALL SIZE THEM ACCORDINGLY.
- ALL WIRE TERMINATIONS SHALL BE APPROPRIATELY LABELED AND READILY VISIBLE.
- MODULE GROUNDING (UFO) FASTENER TO BE INSTALLED BETWEEN MODULE FRAME AND MODULE SUPPORT RAIL, PER THE (UFO) FASTENER MANUFACTURE'S INSTRUCTION.

SHEET INDEX						
PV-0	COVER PAGE					
PV-1	SITE PLAN					
PV-2	ROOF PLAN & MODULES					
PV-3	ATTACHMENT DETAIL					
PV-4	ELECTRICAL LINE DIAGRAM & CALCS.					
PV-5	ELECTRICAL PHOTOS					
PV-6	SPECIFICATIONS & CALCS.					
PV-7	LABLE & PLACARDS					
D\/_8+	FOLUPMENT SPECIFICATIONS					

PROJECT SITE	
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1 PV-0	HOUSE PHOTO	SCALE: NTS

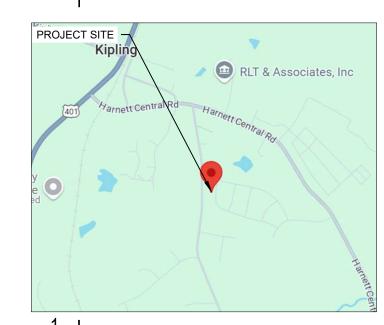

VICINITY MAP

CAROLINA CONNECTIONS 422 HUFFMAN MILL ROAD, SUITE 105, BURLINGTON,

NC 27215, UNITED STATES PHONE: (336) 585-1314

SYSTEM INFO.
(28) LONGI SOLAR
LR5-54HABB-400M
(14) DURACELL POWER CENTE
SOLAR PV DUAL D700-M2 (240
DC SYSTEM SIZE: 11.200 KWI

AC SVSTEM SIZE: 0 744 KIMA

AC STSTEW SIZE, 9.744 KWAC							
REVISIONS							
DESCRIPTION	DATE	REV					
REVISION	11/21/2024	Α					
REVISION	11/27/2024	В					

Signature with Seal

PROJECT NAME & ADDRESS

27526 :#: (919) 394 3610 446wolfe@gmail.com WOLFE E DR, S RESIDENCE DAVINHALL I AY-VARINA, N :#: (919) 394 3 BRUCE 40 L FUQUAN H. Email:

> DATE: 11/27/2024 SHEET NAME


COVER PAGE


SHEET SIZE

ANSI B 11" X 17"

SHEET NUMBER

SCALE: NTS

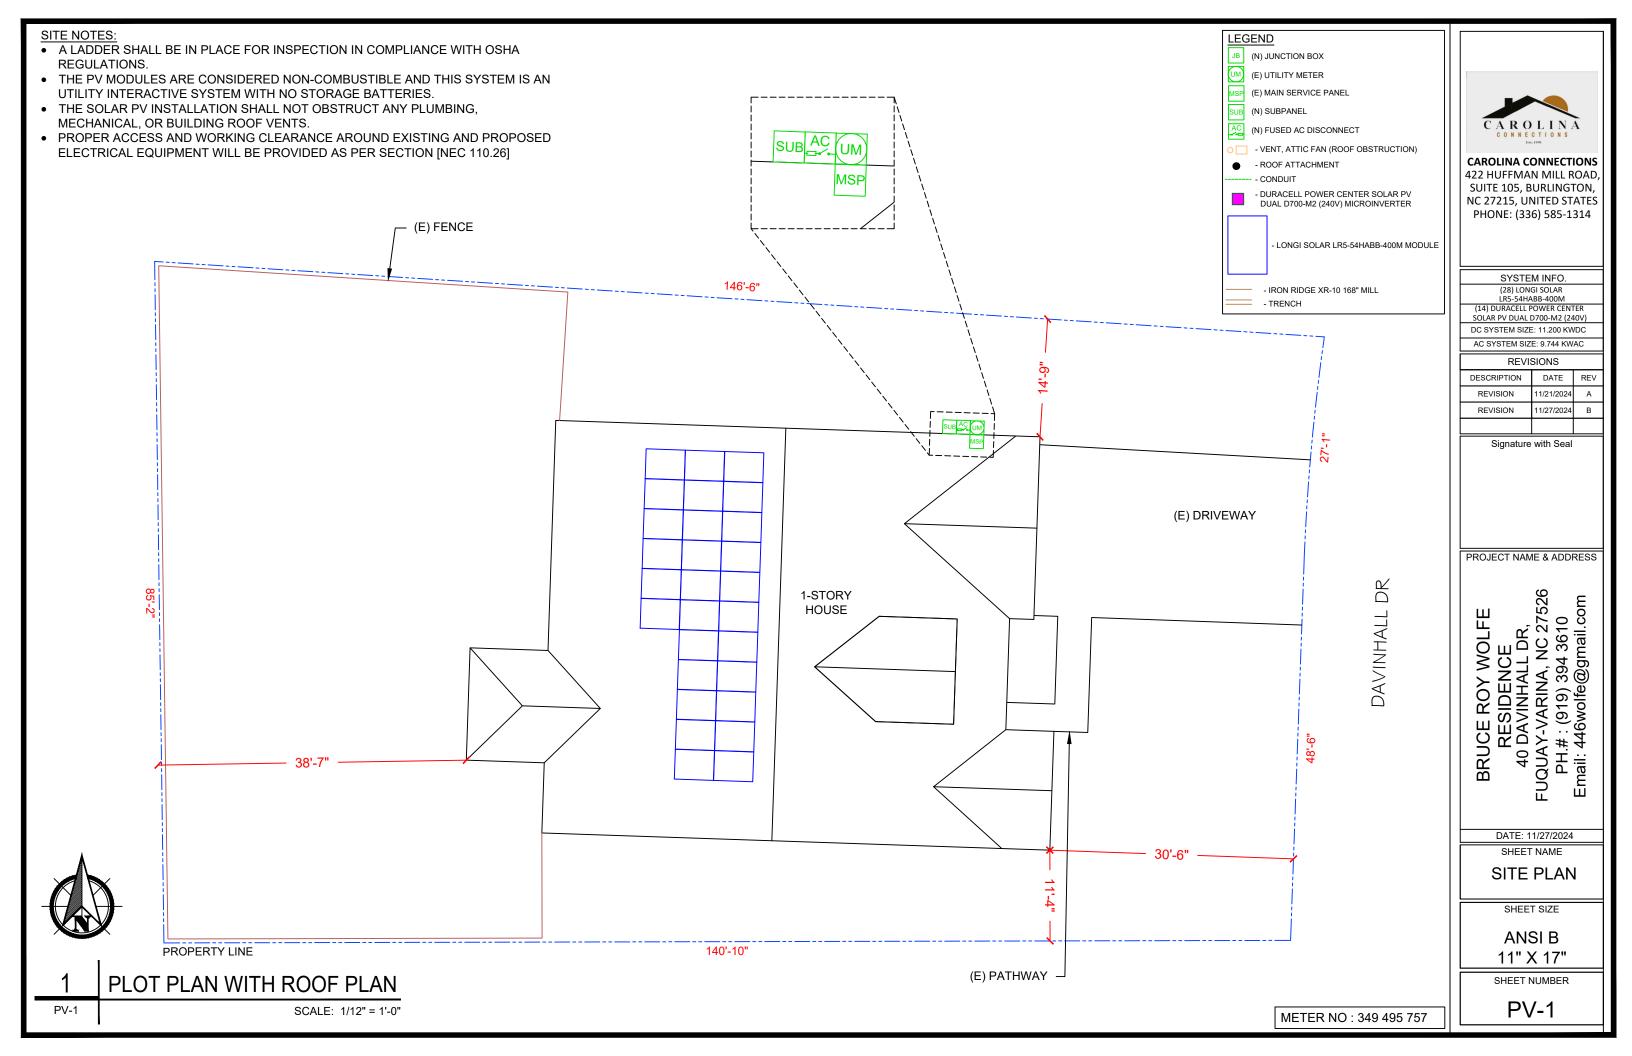

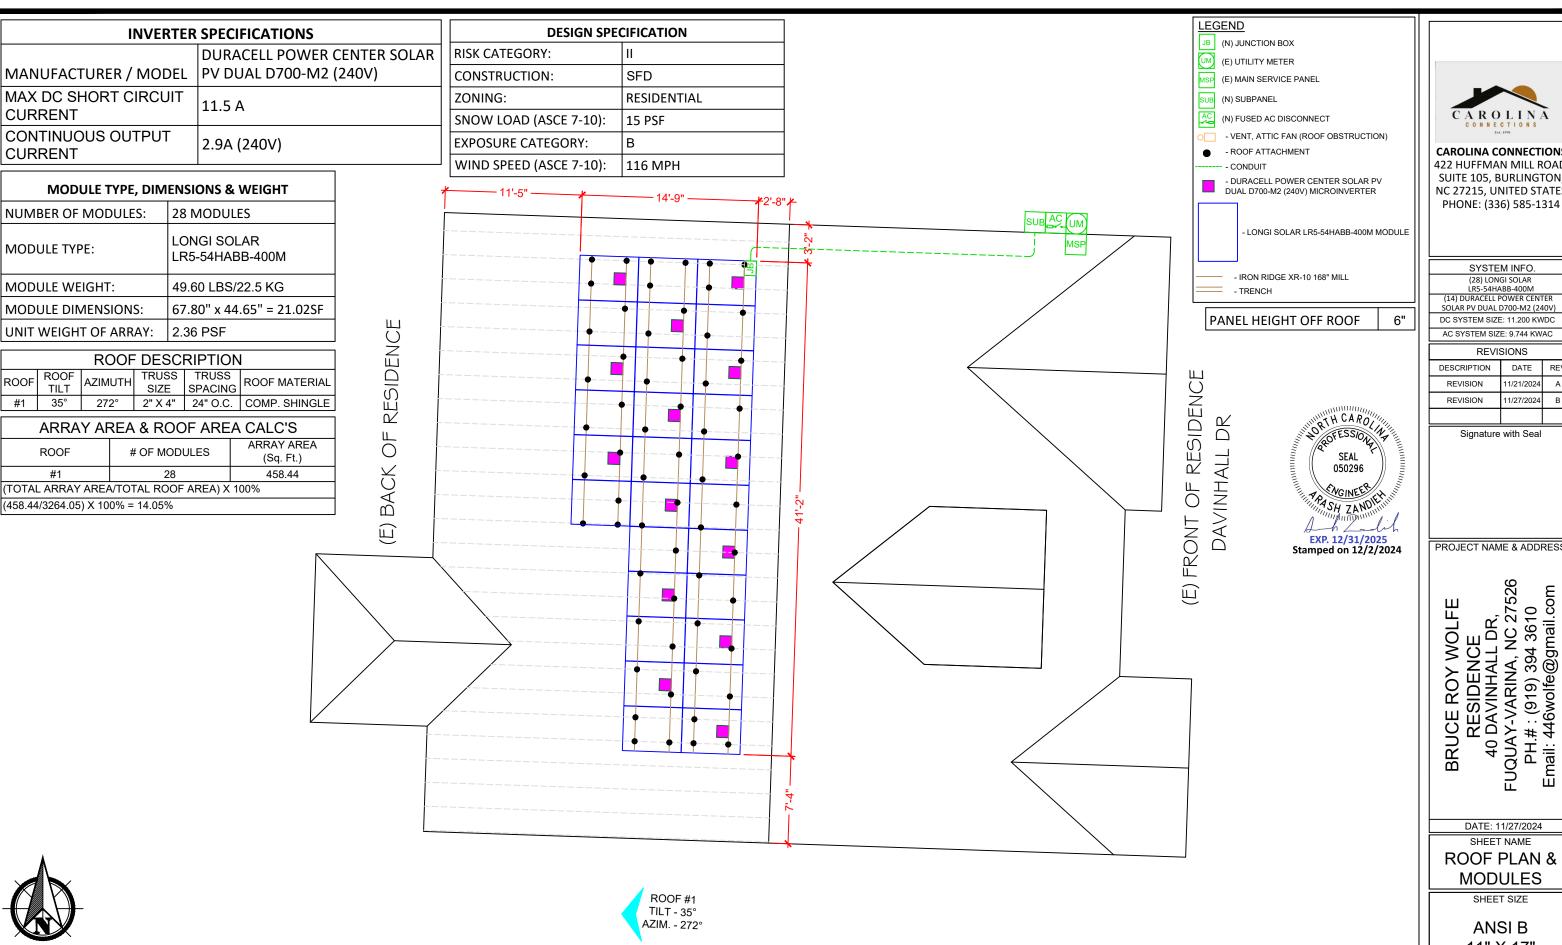

CAROLINA CONNECTIONS 422 HUFFMAN MILL ROAD, SUITE 105, BURLINGTON, NC 27215, UNITED STATES

SYSTEM INFO. (28) LONGI SOLAR LR5-54HABB-400M (14) DURACELL POWER CENTER

SOLAR PV DUAL D700-M2 (240V) DC SYSTEM SIZE: 11.200 KWDC

AC SYSTEM SIZE: 9.744 KWAC

REVISIONS DESCRIPTION DATE REVISION 11/21/2024 REVISION 11/27/2024

Signature with Seal

PROJECT NAME & ADDRESS

RESIDENCE
40 DAVINHALL DR,
FUQUAY-VARINA, NC 27526
PH.#: (919) 394 3610
Email: 446wolfe@gmail.com 27526 BRUCE ROY WOLFE

DATE: 11/27/2024

SHEET NAME

ROOF PLAN & MODULES

SHEET SIZE

ANSI B 11" X 17"

SHEET NUMBER


PV-2

ROOF PLAN & MODULES

PV-2

SCALE: 1/8" = 1'-0"

METER NO: 349 495 757

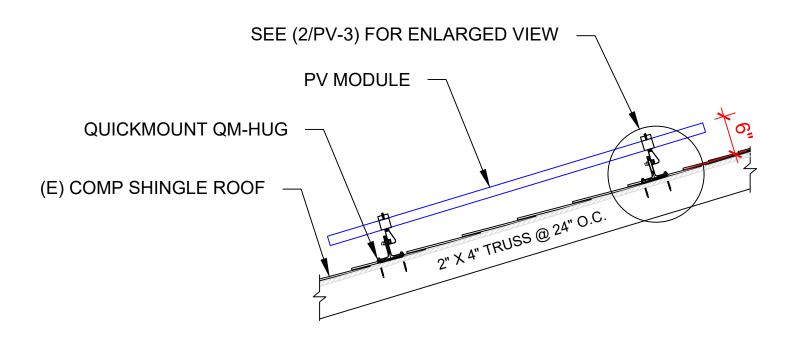

SEAL 050296

SEAL 050296

EXP. 12/31/2025

Stamped on 12/2/2024

ATTACHMENT DETAILS

ENLARGED VIEW OF ATTACHMENT

SCALE: NTS

PV-3

PV-3

MID CLAMP/END CLAMP

(N) BND T-BOLT & NUT
3/8"X1" SS W/SS SERRATED
FLANGE NUT

(N) LONGI SOLAR
LR5-54HABB-400M MODULE

IRONRIDGE XR-10 RAIL

(E) COMP. SHINGLE
(N) ROOF / DECK MEMBRANE
SELF DRILLING SCREW, #14, WOOD TIP
WITH EPDM BACKED WASHER, MIN 2.5"
EMBEDMENT

(E) 2" X 4" TRUSS @ 24" O.C.

CAROLINA
CONNECTIONS
CAROLINA
CONNECTIONS

CAROLINA CONNECTIONS 422 HUFFMAN MILL ROAD, SUITE 105, BURLINGTON, NC 27215, UNITED STATES PHONE: (336) 585-1314

SYSTEM INFO.
(28) LONGI SOLAR
LR5-54HABB-400M
(14) DURACELL POWER CENTER

SOLAR PV DUAL D700-M2 (240V)
DC SYSTEM SIZE: 11.200 KWDC
AC SYSTEM SIZE: 9.744 KWAC

 REVISIONS

 DESCRIPTION
 DATE
 REV

 REVISION
 11/21/2024
 A

 REVISION
 11/27/2024
 B

Signature with Seal

PROJECT NAME & ADDRESS

BRUCE ROY WOLFE
RESIDENCE
40 DAVINHALL DR,
FUQUAY-VARINA, NC 27526
PH.#: (919) 394 3610
Email: 446wolfe@gmail.com

DATE: 11/27/2024

ATTACHMENT

DETAIL

SHEET SIZE

ANSI B 11" X 17"

SHEET NUMBER

ī	TVDIOAL	INITIAL CONDUCTOR	FINAL CONDUCTOR		CONDUCTO	ND.	CONDUIT	# OF	CURRENT-CARRYING	CONDUIT FILL	0000		-00	TEMF	P. CORR.	CONDUIT	CONT.	MAX.	BASE	DERATED	TERM.	LENOT	VOLTAGE	
ID	TYPICAL	LOCATION	LOCATION		CONDUCTO	JK	CONDUIT	PARALLEL CIRCUITS	CONDUCTORS IN CONDUIT	PERCENT	OCPD	<u> </u>	EGC		CTOR	FILL FACTOR		CURRENT	AMP.	AMP.	TEMP. RATING	LENGTH	DROP	
1	3	ARRAY	JUNCTION BOX		AC CABLE	-	-	1	2	N/A	N/A	6 AWG	BARE COPPER THWN-2,	0.71	(57°C)	N/A	14.50A	18.13A	N/A	N/A	90°C	32FT	0.48%	
2	1	JUNCTION BOX	SUBPANEL FUSED AC	10 AWG	THWN-2	COPPER	MIN 0.75" Dia	3	6	26.72%	20A	10 AWG	COPPER THWN-2,	0.96	(35°C)	0.8	14.50A	18.13A	40A	30.7A	75°C	37FT	0.56%	CAROLINA
3	1	SUBPANEL	DISCONNECT	6 AWG	THWN-2	COPPER	MIN 0.75" Dia	1	3	31.21%	50A	10 AWG	COPPER	0.96	(35°C)	1	40.60A	50.75A	75A	72.0A	75°C	5FT	0.08%	CONNECTIONS Ext. 1991
4	1	FUSED AC DISCONNECT	MAIN SERVICE PANEL	6 AWG	THWN-2	COPPER	MIN 0.75" Dia	1	3	31.21%	50A	10 AWG	THWN-2, COPPER	0.96	(35°C)	1	40.60A	50.75A	75A	72.0A	75°C	5FT	0.08%	422 HUFFMAN MILL RO
INVERTER SPECIFICATIONS NC 27215, U										SUITE 105, BURLINGTO NC 27215, UNITED STAT														
MAN	JFACTUF		DLAR PV DUAL D70		40V)				mann H	CAR"	<i>'</i> ''.													PHONE: (336) 585-131
MAX CURF		RT CIRCUIT 11	5 A						aring 7	ESSION.	The same													
CONTINUOUS OUTPUT 2 9A (240V)									SYSTEM INFO. (28) LONGI SOLAR															
MAX	CONTIN		96W						Exp	_12/31/2024														LR5-54HABB-400M (14) DURACELL POWER CENTER SOLAR PV DUAL D700-M2 (240V
OUTF	PUT POV	ER 0							\$ (1) · CX	hand ER.	Z													DC SYSTEM SIZE: 11.200 KWDC AC SYSTEM SIZE: 9.744 KWAC
		(N) 28 - LON	GI SOLAR LR5-54H						MAIN OD	GINEER.	junin.													REVISIONS
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					8 MODUL				STAMPE	ED 12/02/2	024							(E) 1441						REVISION 11/21/2024 REVISION 11/27/2024
													N) SUBPANEL,					PANEL	N SERVIC , 200A RAT					
						10							125A RATED, -PH, 3-W, 240V	,				1-27, 3	-W, 240V					Signature with Seal
							PV WIRE	\neg	JUNCTIO		2)												
									600 V, NI UL LIS		\mathcal{L}	/ 												
							₋	<u> </u>			\wedge	20.	A/2P		AC	DISCONNEC	T:	12		TO UTI GRII				
(N) 05 - DURACELL POWER CENTER SOLAR PV DUAL 240V, 60A FUSED NEW ASS AN ASSESSMENT OF THE PROPERTY OF THE P																								
D700-M2 (240V) MICROINVERTERS Value Value									PROJECT NAME & ADDRE															
20A/2P								ے و																
						10				L2		L2		<u>-[2</u>			$-\sqrt{-}-$							E 7526
10 NOCOCC NOCOCC									OLFE OLFE DR, VC 273 3610															
(E) MAIN BREAKER TO HOUSE 240 V, 200A/2P									N C B S B S B S B S B S B S B S B S B S B															
																INTERCO	POINT OF —	<i></i>		_i_		,		\ Z \ Z \ \ \ \ \ \ \ \
	(N)	05 - DURACELL	POWER CENTER S	OLAR P\	/ DUAL —	_	<u> </u>										Y SIDE TAP		EXISTI	_ NG GROUI	ND			E ROY ESIDE AVINH, VARIN (919)
FLECTRODE CONDUCTOR									当															
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						08	 		the inverter, t															BRUCE RES 40 DAY FUQUAY-V PH.#: (
																	SOL	AR MODU	JI F SPI	FCIFICA	TIONS			
							İ													GI SOLA				DATE 44/07/0004
																MANUI	FACTURER	/ MODEL			3-400M			DATE: 11/27/2024 SHEET NAME
	(N)	04 - DURACELL	POWER CENTER S	OLAR P\	/ DUAL —	_		\bigcirc				SERVIC	E INFO			VMP			30.9	4 V				ELECTRICAL LIN
	` '		0700-M2 (240V) MIC					\smile	L	JTILITY PRC	VIDER:		DUKE ENE	RGY		IMP			12.9	3 A				& CALCS.
										AHJ NAME:			HARNETT	COUNT	Υ	VOC			37.0					SHEET SIZE
									N	/IAIN PANE	L BRAN	D:	EATON			ISC			13.7	2 A				ANSI B
									<u> </u>	ΛΑΙΝ SERVI			200A			TEMP.	COEFF. VC	C	-0.26	65 %/C				11" X 17"
1	E	LECTRIC	AL LINE DI	IAGR	AM				<u> </u>	/IAIN PANE			NORTH			MODU	LE DIMENS	ION	67.8	0" (L) x	44.65"	(W)		SHEET NUMBER
PV-				SCALE					<u> </u>	ERVICE FE			UNDERGRO	DUND		_	WATTAGE		400\	N				PV-4
	1											l				- _								



NNECTIONS MILL ROAD, RLINGTON, TED STATES) 585-1314

INFO.
SOLAR
3-400M
WER CENTER
700-M2 (240V)
1.200 KWDC
9.744 KWAC

DNS

DATE REV
/21/2024 A
/27/2024 B

& ADDRESS

27/2024
NAME
CAL LINE
LCS.
SIZE





CAROLINA CONNECTIONS 422 HUFFMAN MILL ROAD,

SUITE 105, BURLINGTON, NC 27215, UNITED STATES PHONE: (336) 585-1314

SYSTEM INFO.
(28) LONGI SOLAR
LR5-54HABB-400M
(14) DURACELL POWER CENTER
SOLAR PV DUAL D700-M2 (240V)
DC SYSTEM SIZE: 11.200 KWDC

AC SYSTEM SIZE: 9.744 KWAC
REVISIONS

DESCRIPTION	DATE	REV
REVISION	11/21/2024	Α
REVISION	11/27/2024	В

Signature with Seal

PROJECT NAME & ADDRESS

BRUCE ROY WOLFE
RESIDENCE
40 DAVINHALL DR,
FUQUAY-VARINA, NC 27526
PH.#: (919) 394 3610
Email: 446wolfe@gmail.com

DATE: 11/27/2024

SHEET NAME
ELECTRICAL

PHOTOS

SHEET SIZE

ANSI B 11" X 17"

SHEET NUMBER

SOLAR MODULE SPECIFICATIONS						
MANUFACTURER / MODEL	LONGI SOLAR LR5-54HABB-400M					
VMP	30.94 V					
IMP	12.93 A					
VOC	37.05 V					
ISC	13.72 A					
TEMP. COEFF. VOC	-0.265 %/C					
MODULE DIMENSION	67.80" (L) x 44.65" (W)					
PANEL WATTAGE	400W					

INVERTER SPECIFICATIONS							
	DURACELL POWER CENTER SOLAR						
MANUFACTURER / MODEL	PV DUAL D700-M2 (240V)						
MAX DC SHORT CIRCUIT CURRENT	11.5 A						
CONTINUOUS OUTPUT CURRENT	2.9A (240V)						

AMBIENT TEMPERATURE SPECS						
RECORD LOW TEMP	-10°C					
AMBIENT TEMP (HIGH TEMP 2%)	35°C					
CONDUIT HEIGHT	7/8"					
ROOF TOP TEMP	90°C					
CONDUCTOR TEMPERATURE RATE	57°C					
MODULE TEMPERATURE COEFFICIENT OF VOC	-0.265 %/C					

PERCENT OF VALUES	NUMBER OF CURRENT CARRYING CONDUCTORS IN EMT
0.80	4-6
0.70	7-9
0.50	10-20

Voltage rise from the Microinverters to the Junction Box

For branch circuit #1 of 05 D700-M2 Micros, the voltage rise on the 240 VAC AC Cable is 0.48% For branch circuit #2 of 05 D700-M2 Micros, the voltage rise on the 240 VAC AC Cable is 0.48% For branch circuit #3 of 04 D700-M2 Micros, the voltage rise on the 240 VAC AC Cable is 0.31%

Voltage rise from the Junction Box to the Subpanel

VRise = (amps/inverter × number of inverters) × (resistance in Ω /ft) × (2-way wire length in ft)

- = $(2.9 \text{ amp} \times 5) \times (0.00129 \Omega/\text{ft}) \times (36 \text{ ft} \times 2)$
- = 14.50 amps × 0.00129 Ω /ft × 72 ft
- = 1.35 volts

 $%VRise = 1.35 \text{ volts} \div 240 \text{ volts} = 0.56\%$

The voltage rise from the Junction Box to the Subpanel is 0.56%

Voltage rise from the Subpanel to Fused AC Disconnect

VRise = (amps/inverter × number of inverters) × (resistance in $\Omega/\text{ft.}$) × (2-way wire length in ft.)

- = $(2.9 \text{ amp} \times 14) \times (0.000491 \Omega/\text{ft}) \times (5 \text{ ft.} \times 2)$
- = $40.60 \text{ amps} \times 0.000491 \Omega/\text{ft} \times 10 \text{ ft}$.
- = 0.20 volts

%VRise = 0.20 volts ÷ 240 volts = 0.08%

The voltage rise from the Subpanel to the Fused AC Disconnect is 0.08%

Voltage rise from the Fused AC Disconnect to Main Service Panel

VRise = (amps/inverter × number of inverters) × (resistance in $\Omega/\text{ft.}$) × (2-way wire length in ft.)

- = $(2.9 \text{ amp} \times 14) \times (0.000491 \Omega/\text{ft}) \times (5 \text{ ft.} \times 2)$
- = $40.60 \text{ amps} \times 0.000491 \Omega/\text{ft} \times 10 \text{ ft}$.
- = 0.20 volts

%VRise = 0.20 volts ÷ 240 volts = 0.08%

The voltage rise from the Fused AC Disconnect to the Main Service Panel is 0.08%

Total system voltage rise for all wire sections

0.48% + 0.56% + 0.08% + 0.08% = 1.20%



SYSTEM INFO.
(28) LONGI SOLAR
LRS-54HABB-400M
(14) DURACELL POWER CENTER
SOLAR PV DUAL D700-M2 (240V)
DC SYSTEM SIZE: 11.200 KWDC
AC SYSTEM SIZE: 9.744 KWAC

REVISIONS						
DESCRIPTION	DATE	REV				
REVISION	11/21/2024	Α				
REVISION	11/27/2024	В				

Signature with Seal

PROJECT NAME & ADDRESS

BRUCE ROY WOLFE
RESIDENCE
40 DAVINHALL DR,
FUQUAY-VARINA, NC 27526
PH.#: (919) 394 3610
Email: 446wolfe@gmail.com

047345

STAMPED 12/02/2024

DATE: 11/27/2024

SHEET NAME
SPECIFICATIONS
& CALC.

SHEET SIZE

ANSI B 11" X 17"

SHEET NUMBER

▲ WARNING

ELECTRIC SHOCK HAZARD

TERMINALS ON BOTH LINE AND LOAD SIDES MAY BE ENERGIZED IN THE OPEN POSITION

LABEL LOCATION:

MAIN SERVICE PANEL/AC DISCONNECT/AC COMBINER (PER CODE: NEC 2017 690.13(B))

2

WARNING: PHOTOVOLTAIC POWER SOURCE

LABEL LOCATION:

EVERY 10' AND ON CONDUIT BODIES WHEN EXPOSED (PER CODE: NEC2017 690.31(G)(3)(4))

3

PHOTOVOLTAIC SYSTEM AC DISCONNECT RATED AC OUTPUT CURRENT 40.60 AMPS NOMINAL OPERATING AC VOLTAGE 240 VOLTS

LABEL LOCATION:
MAIN SERVICE PANEL/AC DISCONNECT
NEC2017, 690.53

4

RAPID SHUTDOWN SWITCH FOR SOLAR PV SYSTEM

LABEL LOCATION:
INVERTER
AT OR WITHIN 3' OF THE AC/DC COMBINER SWITCH
PER CODE: NEC 690.58(C)(3)

5



DUAL POWER SOURCE SECOND SOURCE IS PHOTOVOLTAIC SYSTEM


LABEL LOCATION:
MAIN SERVICE PANEL/AC DISCONNECT/AC
COMBINER/REVENUE METER
2017 NEC 705.12(B)(3)

ADHESIVE FASTENED SIGNS

- ANSI Z535.4-2011 PRODUCT SAFETY SIGNS AND LABELS, PROVIDES GUIDELINES FOR SUITABLE FONT SIZES, WORDS COLORS, SYMBOLS, AND LOCATION REQUIREMENTS FOR LABELS. NEC 110.21(B)(1).
- THE LABEL SHALL BE OF SUFFICIENT DURABILITY TO WITHSTAND THE ENVIRONMENT INVOLVED. NEC 110.21(B)(3).
- ADHESIVE FASTENED SIGNS MAY BE ACCEPTABLE IF PROPERLY ADHERED. VINYL SIGNS SHALL BE WEATHER RESISTANT.

SOLAR PV SYSTEM EQUIPPED WITH RAPID SHUTDOWN

TURN RAPID SHUTDOWN SWITCH TO THE "OFF" POSITION TO SHUT DOWN PV SYSTEM AND REDUCE SHOCK HAZARD IN THE ARRAY

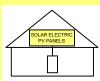

MAIN SERVICE PANEL
IF MSD IS OUTSIDE PLACE IT THERE / IF
MSD IS INSIDE PLACE ON THE AC DISCONNECT
PER CODE: NEC 690.56(C)(1)

7

6

PHOTOVOLTAIC SYSTEM UTILITY DISCONNECT SWITCH

LABEL LOCATION: AC DISCONNECT 2017 NEC 690.56(C)(3) 8

SERVICE DISCONNECT

SECTIONNEUR PRINCIPALE


SERVICIO DE DESCONEXION

LABEL LOCATION: AC DISCONNECT 2017 NEC 230.66

STAMPED 12/02/2024

CAUTION

POWER TO THIS BUILDING IS ALSO SUPPLIED FROM THE FOLLOWING SOURCES WITH DISCONNECTS LOCATED AS SHOWN:

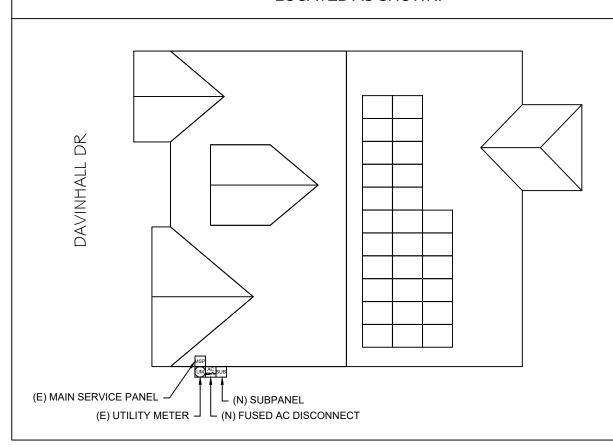



CAROLINA CONNECTIONS
422 HUFFMAN MILL ROAD,

SUITE 105, BURLINGTON, NC 27215, UNITED STATES PHONE: (336) 585-1314

SYSTEM INFO.
(28) LONGI SOLAR
LR5-54HABB-400M
(14) DURACELL POWER CENTER
SOLAR PV DUAL D700-M2 (240V)

DC SYSTEM SIZE: 11.200 KWDC

AC SYSTEM SIZE: 9.744 KWAC

 REVISIONS

 DESCRIPTION
 DATE
 REV

 REVISION
 11/21/2024
 A

 REVISION
 11/27/2024
 B

Signature with Seal

PROJECT NAME & ADDRESS

BRUCE ROY WOLFE
RESIDENCE
40 DAVINHALL DR,
FUQUAY-VARINA, NC 27526
PH.#: (919) 394 3610
Email: 446wolfe@gmail.com

DATE: 11/27/2024

SHEET NAME SIGNAGE

SHEET SIZE

ANSI B 11" X 17"

SHEET NUMBER













LR5-54HABB 390~415M


21.3% MAX MODULE EFFICIENCY

0~3%

0.45%YEAR 2-30
POWER DEGRADATION


HALF-CELL Lower operating temperature

Additional Value

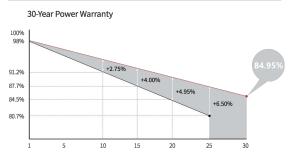

Mechanical Parameters Cell Orientation 108 (6×18) Junction Box IP68, three diodes 4mm², ±1200mm Output Cable length can be customized Glass Dual glass, 2.0+1.6mm heat strengthened glass Frame Anodized aluminum alloy frame 22.5kg Weight 1722×1134×30mm

Packaging 36pcs per pallet / 216pcs per 20' GP / 936pcs or 792pcs (Only for USA) per 40' HC

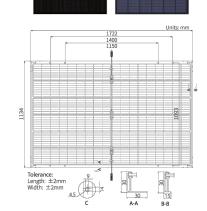

Module Type	LR5-54H	ABB-390M	LR5-54H	ABB-395M	LR5-54H	ABB-400M	LR5-54H	ABB-405M	LR5-54H/	ABB-410M	LR5-54H/	ABB-415M
Testing Condition	STC	NOCT	STC	NOCT	STC	NOCT	STC	NOCT	STC	NOCT	STC	NOCT
Maximum Power (Pmax/W)	390	291.5	395	295.2	400	299.0	405	302.7	410	306.5	415	310.2
Open Circuit Voltage (Voc/V)	36.58	34.39	36.81	34.61	37.05	34.84	37.29	35.06	37.53	35.29	37.77	35.51
Short Circuit Current (Isc/A)	13.57	10.95	13.65	11.01	13.72	11.07	13.79	11.13	13.87	11.19	13.94	11.25
Voltage at Maximum Power (Vmp/V)	30.47	28.43	30.70	28.64	30.94	28.86	31.18	29.09	31.42	29.31	31.66	29.54
Current at Maximum Power (Imp/A)	12.80	10.26	12.87	10.31	12.93	10.36	12.99	10.41	13.05	10.45	13.11	10.50
Module Efficiency(%)	2	0.0	20	0.2	2	0.5	2	0.7	2	1.0	2	1.3

Electrical criaracteristics	checulical characteristics with different real side power gain (reference to 400w front)						
Pmax /W	Voc/V	Isc /A	Vmp/V	Imp /A	Pmax gain		
420	37.05	14.41	30.94	13.58	5%		
440	37.05	15.09	30.94	14.22	10%		
460	37.15	15.78	31.04	14.87	15%		
480	37.15	16.46	31.04	15.52	20%		
500	37.15	17.15	31.04	16.16	25%		

Mechanical Loading

Hailstone Test

Front Side Maximum Static Loading

Rear Side Maximum Static Loading

Temperature Ratings (STC)

Temperature Coefficient of Isc

Temperature Coefficient of Voc

Temperature Coefficient of Pmax

Operating Parameters		
Operational Temperature	-40°C ~ +85°C	
Power Output Tolerance	0~3%	
Voc and Isc Tolerance	±3%	
Maximum System Voltage	DC1500V (IEC/UL)	
Maximum Series Fuse Rating	30A	
Nominal Operating Cell Temperature	45±2℃	
Protection Class	Class II	
Bifaciality	70±5%	
Eiro Pating	UL Similar type 38 *	

IEC Class C

Reference Standard: UL61730 Second	d Edition, Da	ited October 2	8, 2022



Fire Rating

No.8369 Shangyuan Road, Xi'an Economic And Technological Development Zone, Xi'an, Shaanxi, China. Web: www.longi.com

Specifications included in this datasheet are subject to change without notice. LONGi reserves the right of final interpretation (20230115V17) Only for North America

5400Pa

2400Pa

25mm Hailstone at the speed of 23m/s

+0.050%/°C

-0.265%/°C

-0.340%/°C



CAROLINA CONNECTIONS 422 HUFFMAN MILL ROAD, SUITE 105, BURLINGTON, NC 27215, UNITED STATES PHONE: (336) 585-1314

SYSTEM INFO.
(28) LONGI SOLAR
LR5-54HABB-400M
(14) DURACELL POWER CENTER
SOLAR PV DUAL D700-M2 (240V)
OC SYSTEM SIZE: 11 200 KWDC

AC SYSTEM SIZE: 9.744 KWAC

REVISIONS						
DESCRIPTION	DATE	REV				
REVISION	11/21/2024	Α				
REVISION	11/27/2024	В				

Signature with Seal

PROJECT NAME & ADDRESS

RESIDENCE 40 DAVINHALL DR, FUQUAY-VARINA, NC 27526 PH.#: (919) 394 3610 Email: 446wolfe@gmail.com 27526 BRUCE

DATE: 11/27/2024

SHEET NAME **EQUIPMENT**

SPECIFICATION

SHEET SIZE

ANSI B 11" X 17"

SHEET NUMBER



Fast, Easy & Flexible Installation

Duracell Power Center's family of single, dual, and quad microinverters delivers the lowest cost, highest yield per panel PV installation. The AC trunk cable format permits any combination of the three models to optimize even the most complex rooftop installations.

Reactive Power Control CA Rule 21 compliant Compliant with U.S. NEC-2017 & NEC-2020 690.12 rapid shutdown High reliability: NEMA 6 (IP67) enclosure, 6000V surge protection

DURACELL° POWER CENTER

Solar PV Microinverters D350-M1/D700-M2/D1500-M4

Technical Data

		D350-M1		D700-M2		D1500-M4	
Input Data (DC)							
Number of PV inputs		Ī	1	2		4	
Module power range, typical (W)	280 t	o 470+	280 to 470+		300 to 505+		
Maximum input voltage (V)			6	0			
MPPT voltage range (V)			16-	-60			
Start-up voltage (V)			2	.2			
Maximum input current (A)			11	.5			
Output Data (AC)							
Peak output power (VA)	3	50	7(00	1500	1350	
Maximum continuous output power (VA)	3	49	69	96	1438	1246	
Maximum continuous output current (A)	1.45	1.68	2.9	3.35	5.99	5.99	
Nominal output voltage(V)	240	208	240	208	240	208	
Nominal output voltage range1 (V)	211-264	183-228	211-264	183-228	211-264	183-22	
Nominal frequency/range1 (Hz)		·	60/5	55-65			
Power factor (adjustable)	В	>0	.99 default (0.	8 lead to 0.8 l	ag)		
Total harmonic distortion	Ì			5%			
Maximum units per branch2 (10 AWG)	16	14	8	7	4	4	
Efficiency			}				
CEC peak efficiency (%)			96	5.7			
CEC weighted efficiency (%)	Ī			5.5			
Nominal MPPT efficiency (%)	1			2.8			
Nighttime power consumption (mW)			</td <td>50</td> <td></td> <td></td>	50			
Mechanical Data							
Ambient temperature range (°C)	<i>!</i>		-40 +	o +65	rr		
Dimensions (W × H × D) mm	182 x 16	64 x 29.5		70 x 28	280 x	176 x 33	
Weight (kg)	ħ.,	75		.6	3.35		
Enclosure rating		, 0		· NEMA 6		.00	
Cooling			Natural conve		5		
Features							
Communication		2	.4 GHz proprie	tary RF (Nordi	c)		
Monitoring				es			
Warranty				25 years			
Compliance	UL 1741, IEEE	1547, UL 1741 SA	4 (240 Vac), CA		/ac), CSA C22	.2 No. 107.1	
PV Rapid Shutdown	Conforms		and NEC-2020 Rapid Shutdow	Article 690.12		Sec 64-21	

Become a Duracell Partner Today

sales@duracellpowercenter.com

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422 HUFFMAN MILL ROAD,
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SYSTEM INFO.
(28) LONGI SOLAR
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(14) DURACELL POWER CENTER
SOLAR PV DUAL D700-M2 (240V)
DC SYSTEM SIZE: 11.200 KWDC

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QuickMount® HUG



The Respect Your Roof Deserves

When integrating with a home, solar attachments must be dependable for the lifetime of the rooftop. Due to recent innovations, many asphalt shingles have bonded courses. A mount that protects without the need to pry shingles can really speed things up.

Its Halo is a cast-aluminum barrier that encases the UltraGrip, our industrial-grade, foam-and-mastic seal. This allows HUG to accelerate the installation process and provide the utmost in waterproofing









Rafter & Deck Mounting Options

Mount HUG to the roof rafters, the roof deck, or both with our custom-engineered RD (rafter-or-deck) Structural Screw. The RD Structural Screw anchors HUG to the roof with an EPDM sealing washer, completing the stack of waterproofing barriers. See


Adaptive, Rafter-Friendly Installation







Trusted Strength & Less Hassle

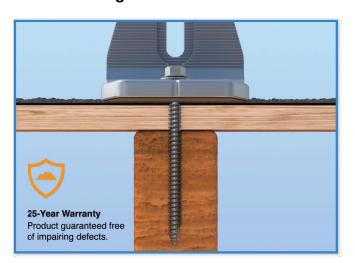

Structural capacities of HUG™ were reviewed in many load directions, with racking rail running cross-slope or up-slope in relation to roof pitch.

For further details, see the HUG certification letters for attaching to rafters and decking.

IronRidge designed the HUG, in combination with the RD Structural Screw to streamline installs, which means the following:

- · No prying shingles
- · No roof nail interference
- No pilot holes necessary
- · No sealant (in most cases)
- No butyl shims needed

Attachment Loading



The rafter-mounted HUG has been tested and rated to support 1004 (lbs) of uplift and 368 (lbs) of lateral load.

Parts are designed and certified for compliance with the International

Building Code &

ASCE/SEI-7.

H

Structural

Water Seal Ratings 11111

HUG passed both the UL 441 Section 27 "Rain Test" and TAS 100(A)-95 "Wind Driven Rain Test" by Intertek.

UL 2703 System



Systems conform to UL 2703 mechanical and bonding requirements. See Flush Mount Manual for more info.





CAROLINA CONNECTIONS

422 HUFFMAN MILL ROAD, SUITE 105, BURLINGTON, NC 27215, UNITED STATES PHONE: (336) 585-1314

SYSTEM INFO. (28) LONGI SOLAR LR5-54HABB-400M (14) DURACELL POWER CENTER SOLAR PV DUAL D700-M2 (240V) DC SYSTEM SIZE: 11.200 KWDC

AC SYSTEM SIZE: 9.744 KWAC

REVISIONS DESCRIPTION DATE REVISION 11/21/2024 REVISION 11/27/2024

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DATE: 11/27/2024

SHEET NAME

EQUIPMENT SPECIFICATION


SHEET SIZE

ANSI B 11" X 17"

SHEET NUMBER **PV-10**



XR10® Rail

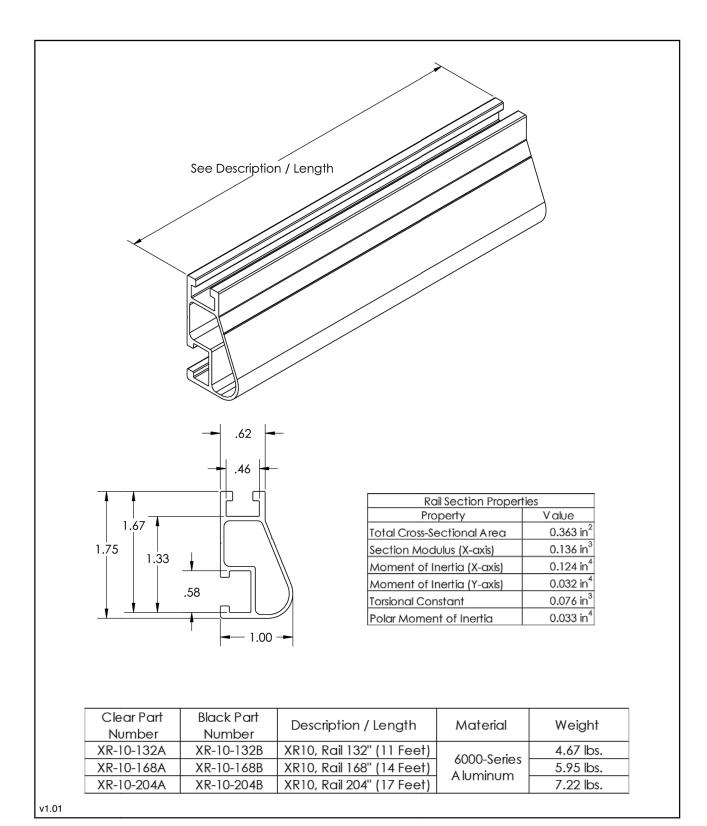



CAROLINA CONNECTIONS

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DC SYSTEM SIZE: 11.200 KWDC

AC SYSTEM SIZE: 9.744 KWAC

REVISIONS DATE DESCRIPTION

REVISION 11/21/2024 REVISION 11/27/2024

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RESIDENCE 40 DAVINHALL DR, FUQUAY-VARINA, NC 27526 PH.#: (919) 394 3610 Email: 446wolfe@gmail.com BRUCE ROY WOLFE

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EQUIPMENT SPECIFICATION

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