SCOPE OF WORK:

TO INSTALL A ROOF MOUNTED SOLAR PHOTOVOLTAIC SYSTEM AT THE OWNER RESIDENCE LOCATED AT 166, CLYDE DOG CT, LILINGTON, NC 27546 THE POWER GENERATED BY THE PV SYSTEM WILL BE INTERCONNECTED WITH THE UTILITY GRID THROUGH THE EXISTING ELECTRICAL SERVICE EQUIPMENT.

THE PV SYSTEM DOES NOT INCLUDE STORAGE BATTERIES

EQUIPMENT SUMMARY	SYSTEM RATING
19 LONGI SOLAR LR5-54HABB-400M MODULES	7.600 KWDC
10 DURACELL POWER CENTER SOLAR PV DUAL D700-M2	6.960 KWAC
(240V) MICROINVERTERS	

2018 INTERNATIONAL FIRE CODE
2018 INTERNATIONAL BUILDING CODE
2018 INTERNATIONAL RESIDENTIAL CODE
2018 NORTH CAROLINA STATE BUILDING CODE
2017 NATIONAL ELECTRICAL CODE

PV-0	COVER PAGE
PV-1	SITE PLAN
PV-2	ROOF PLAN & MODULES
PV-3	ATTACHMENT DETAIL
PV-4	ELECTRICAL LINE DIAGRAM & CALCS.
PV-5	ELECTRICAL PHOTOS
PV-6	SPECIFICATIONS & CALCS.
PV-7	LABLE & PLACARDS
PV-8+	EQUIPMENT SPECIFICATIONS

SHEET INDEX

GENERAL NOTES:

- THESE CONSTRUCTION DOCUMENTS HAVE BEEN BASED ON FIELD INSPECTIONS AND OTHER INFORMATION AVAILABLE AT THE TIME. ACTUAL FIELD CONDITIONS MAY REQUIRE MODIFICATIONS IN CONSTRUCTION DETAILS.
- ARCHITECT HAS NOT BEEN RETAINED TO SUPERVISE ANY CONSTRUCTION OR INSTALLATION OF ANY EQUIPMENT AT SITE.
- CONTRACTOR SHALL FURNISH ALL LABOR, MATERIAL, EQUIPMENT, TOOLS, OBTAINS ALL PERMITS, LICENSES AND PAY ALL REQUIRED FEES AND COMPLETE INSTALLATION.
- CONTRACTOR HAS THE FULL RESPONSIBILITY TO CHECK AND VERIFY ALL DIMENSIONS AND EXISTING CONDITIONS. ANY DISCREPANCIES SHALL BE REPORTED TO THE ENGINEER BEFORE PROCEEDING WITH THE WORK. ANY WORK STARTED BEFORE CONSULTATION AND ACCEPTANCE BY THE ENGINEER SHALL BE THE SOLE RESPONSIBILITY OF THE CONTRACTOR AND SHALL BE SUBJECT TO CORRECTION BY THEM WITHOUT ADDITIONAL COMPENSATION.
- DAMAGE CAUSED TO THE EXISTING STRUCTURE, PIPES, DUCTS, WINDOWS, WALL FLOORS, ETC. SHALL BE REPAIRED TO THE ORIGINAL CONDITION OR REPLACED BY THE CONTRACTOR AT NO ADDITIONAL COST
- THE CONTRACTOR SHALL BE HELD RESPONSIBLE FOR THE PROPER INSTALLATION AND COMPLETION OF THE WORK WITH APPROVED MATERIALS.
- NO CHANGES ARE TO BE MADE WITHOUT THE CONSULTATION AND APPROVAL OF THE **ARCHITECT**
- CONTRACTOR SHALL OBTAIN BULDING PERMIT. NO WORK TO START UNLESS BUILDING PERMIT IS PROPERLY DISPLAYED
- ALL WORKMANSHIP AND MATERIALS SHALL BE OF FIRST QUALITY AND IN COMPLIANCE WITH THE REQUIREMENTS OF THE NC BUILDING CODE, THE DEPARTMENT OF ENVIRONMENTAL PROTECTION AND ALL PERTINENT AGENCIES.
- IT IS ESSENTIAL THAT ALL WORK PROCEED WITH THE MAXIMUM COOPERATION OF ALL PARTIES AND WITH MINIMUM INTERFERENCE TO THE OCCUPANTS WITHIN THE BUILDING. THE OWNER'S DIRECTIONS IN THIS REGARD SHALL BE FULLY COMPLIED WITH
- ALL EXPOSED PLUMBING, HVAC, ELECTRICAL DUCTWORK, PIPING AND CONDUITS ARE TO BE PAINTED BY GENERAL CONTRACTOR.
- THE CONTRACTOR SHALL PERFORM THE WORK IN STRICT CONFORMANCE WITH THE LOCAL LAWS, REGULATIONS AND THE NATIONAL ELECTRIC CODE.
- THE CONTRACTOR SHALL OBTAIN ALL PERMITS, APPROVALS, AFFIDAVITS, CERTIFICATIONS, ETC. AND PAY ALL FEES AS REQUIRED BY THE LOCAL AUTHORITIES.
- CONTRACTORS SHALL OBTAIN FIRE CERTIF. UPON COMPLETION OF WORK.

WIDING	VND	CONDIN	ΓNOTES:
VVIRING	AINU	CONDU	INVIES.

GOVERNING CODES

ALL CONDUIT SIZES AND TYPES, SHALL BE LISTED FOR ITS PURPOSE AND APPROVED FOR THE SITE APPLICATIONS.

AUTHORITY HAVING JURISDICTION (AHJ): HARNETT COUNTY

- ALL PV CABLES AND HOME RUN WIRES BE #10AWG *USE-2, PV WIRE, OR PROPRIETARY SOLAR CABLING SPECIFIED BY MFR, OR EQUIVALENT; ROUTED TO SOURCE CIRCUIT COMBINER BOXES AS REQUIRED.
- ALL CONDUCTORS AND OCPD SIZES AND TYPES SPECIFIED ACCORDING TO [NEC 690.8 (A)(1) & (B)(1)], [NEC 240] [NEC 690.7] FOR MULTIPLE CONDUCTORS.
- ALL PV DC CONDUCTORS IN CONDUIT EXPOSED TO SUNLIGHT SHALL BE DERATED ACCORDING TO [NEC TABLE 310.15 (B)(2)(C)] BLACK ONLY**
- EXPOSED ROOF PV DC CONDUCTORS SHALL BE USE-2, 90°C RATED, WET AND UV RESISTANT, AND UL LISTED RATED FOR 600V, UV RATED SPIRAL WRAP SHALL BE USED TO PROTECT WIRE FROM SHARP EDGES.
- PHASE AND NEUTRAL CONDUCTORS SHALL BE DUAL RATED THHN/THWN-2 INSULATED, 90°C RATED, WET AND UV RESISTANT, RATED FOR 600V PER NEC 2008 OR 1000V PER NEC 2011.
- 4-WIRE DELTA CONNECTED SYSTEMS HAVE THE PHASE WITH THE HIGHER VOLTAGE TO GROUND MARKED ORANGE OR IDENTIFIED BY OTHER EFFECTIVE MEANS.
- ALL SOURCE CIRCUITS SHALL HAVE INDIVIDUAL SOURCE CIRCUIT PROTECTION.
- **VOLTAGE DROP LIMITED TO 2%**
- AC CONDUCTORS >4AWG COLOR CODED OR MARKED: PHASE A OR L1- BLACK, PHASE B OR L2- RED, PHASE C OR L3- BLUE, NEUTRAL- WHITE/GRAY.

PROJECT SITE	
	The same of



SCALE: NTS



VICINITY MAP

SCALE: NTS

PH.#: (845) 401 3635 Email: Krsult29@gmail.co \Box RESIDENCE 166 CLYDE DOG C LILINGTON, NC 278 DATE: 11/27/2024

CAROLINA CONNECTIONS 422 HUFFMAN MILL ROAD, SUITE 105, BURLINGTON,

NC 27215, UNITED STATES

PHONE: (336) 585-1314

(19) LONGI SOLAR

(10) DURACELL POWER CENTER SOLAR PV DUAL D700-M2 (240V)

DC SYSTEM SIZE: 7.600 KWDC

AC SYSTEM SIZE: 6.960 KWAC

DESCRIPTION

REVISION

REVISIONS

Signature with Seal

047345

STAMPED 12/02/2024

PROJECT NAME & ADDRESS

DATE

11/27/2024

LR5-54HABB-400M

ANSI B 11" X 17"


SHEET SIZE

COVER PAGE

SHEET NUMBER



- ALL EQUIPMENT TO BE LISTED BY UL OR OTHER NRTL, AND LABELED FOR ITS APPLICATION.
- ALL CONDUCTORS SHALL BE COPPER, RATED FOR 600 V AND 90 DEGREE C WET ENVIRONMENT.
- WIRING, CONDUIT, AND RACEWAYS MOUNTED ON ROOFTOPS SHALL BE ROUTED DIRECTLY TO, AND LOCATED AS CLOSE AS POSSIBLE TO THE NEAREST RIDGE, HIP, OR VALLEY.
- WORKING CLEARANCES AROUND ALL NEW AND EXISTING ELECTRICAL EQUIPMENT SHALL COMPLY WITH NEC 110.26
- WHERE SIZES OF JUNCTION BOXES, RACEWAYS, AND CONDUITS ARE NOT SPECIFIED, THE CONTRACTOR SHALL SIZE THEM ACCORDINGLY.
- ALL WIRE TERMINATIONS SHALL BE APPROPRIATELY LABELED AND READILY VISIBLE.
- MODULE GROUNDING (UFO) FASTENER TO BE INSTALLED BETWEEN MODULE FRAME AND MODULE SUPPORT RAIL, PER THE (UFO) FASTENER MANUFACTURE'S INSTRUCTION.

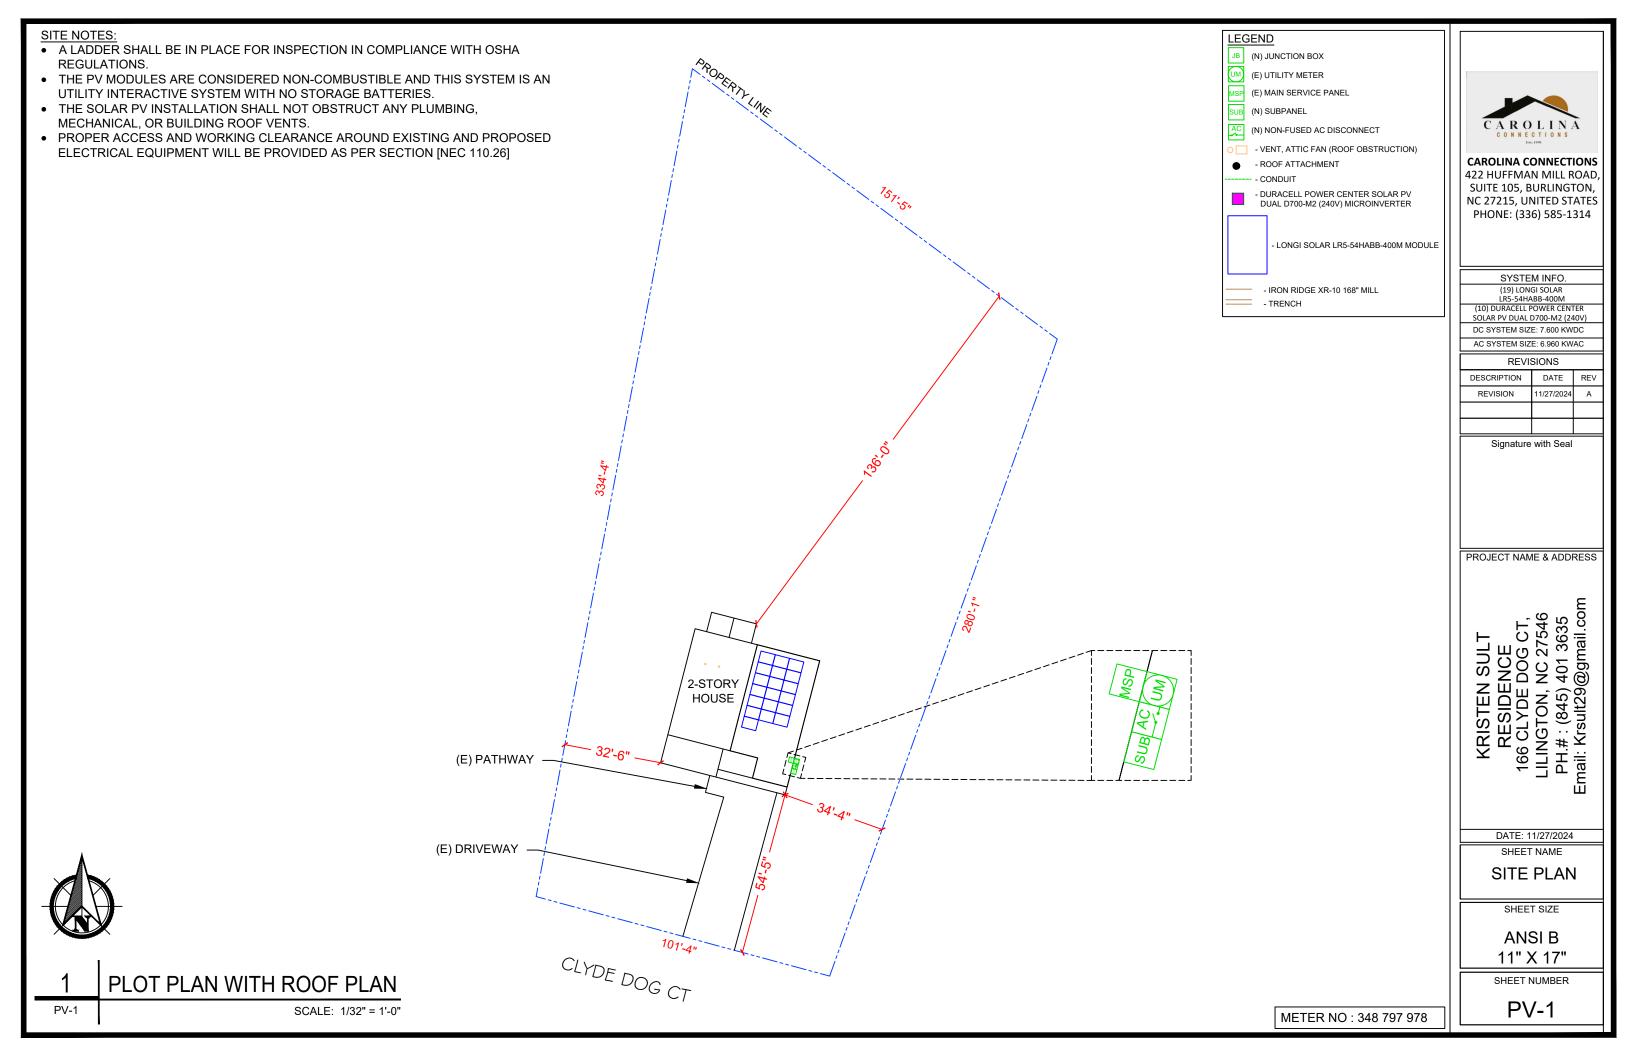

INVERTER SPECIFICATIONS									
MANUFACTURER / MODEL	DURACELL POWER CENTER SOLAR PV DUAL D700-M2 (240V)								
MAX DC SHORT CIRCUIT CURRENT	11.5 A								
CONTINUOUS OUTPUT CURRENT	2.9A (240V)								


MODULE TYPE, DIMENSIONS & WEIGHT											
NUMBER OF MODULES:	19 MODULES										
MODULE TYPE:	LONGI SOLAR LR5-54HABB-400M										
MODULE WEIGHT:	49.60 LBS/22.5 KG										
MODULE DIMENSIONS:	67.80" x 44.65" = 21.02SF										
UNIT WEIGHT OF ARRAY:	2.36 PSF										


ROOF	ROOF	AZIMUTH	TRUSS	TRUSS	ROOF MATERIAL					
KOOF	TILT	AZIIVIOTA	SIZE	SPACING	ROOF WATERIAL					
#1	30°	104°	2" X 4"	24" O.C.	COMP. SHINGLE					
ARRAY AREA & ROOF AREA CALC'S										
	ROOF	#	OF MOD	ULES	ARRAY AREA (Sq. Ft.)					
	11.4		40		0.40, 4.4					

ROOF DESCRIPTION

#1 19 348.4 (TOTAL ARRAY AREA/TOTAL ROOF AREA) X 100% (348.44/2080.92) X 100% = 16.74%

DESIGN SPECIFICATION									
RISK CATEGORY:	II								
CONSTRUCTION:	SFD								
ZONING:	RESIDENTIAL								
SNOW LOAD (ASCE 7-10):	15 PSF								
EXPOSURE CATEGORY:	В								
WIND SPEED (ASCE 7-10):	117 MPH								

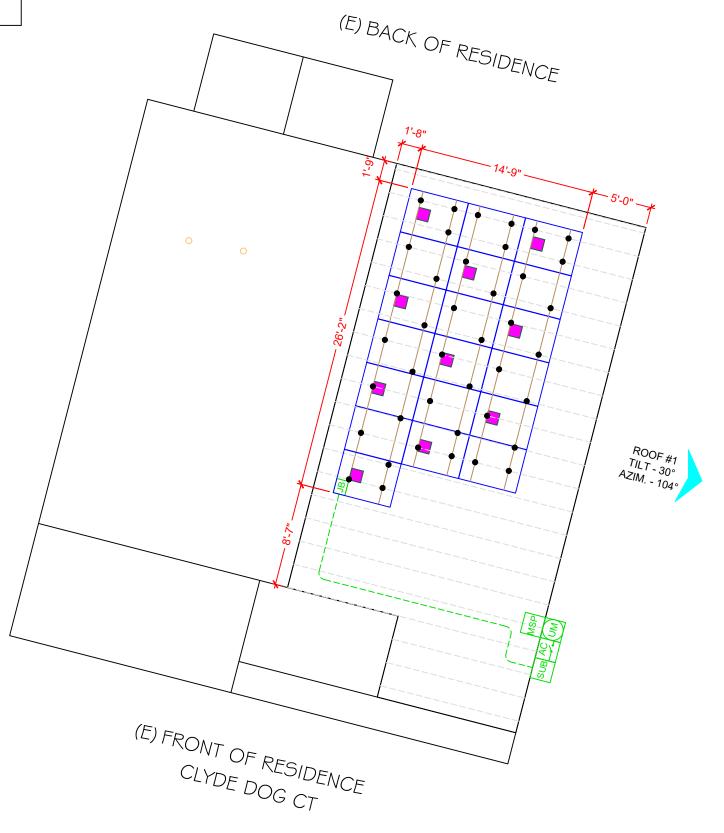

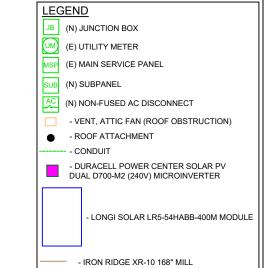

PANEL HEIGHT OFF ROOF

- TRENCH

SEAL 050296

EXP. 12/31/2025

Stamped on 12/2/2024

6"



CAROLINA CONNECTIONS 422 HUFFMAN MILL ROAD, SUITE 105, BURLINGTON, NC 27215, UNITED STATES PHONE: (336) 585-1314

SYSTEM INFO.
(19) LONGI SOLAR
LRS-54HABB-400M
(10) DURACELL POWER CENTER
SOLAR PV DUAL D700-M2 (240V)
DC SYSTEM SIZE: 7.600 KWDC

 AC SYSTEM SIZE: 6.960 KWAC

 REVISIONS

 DESCRIPTION
 DATE
 REV

 REVISION
 11/27/2024
 A

Signature with Seal

PROJECT NAME & ADDRESS

KRISTEN SULT RESIDENCE 166 CLYDE DOG CT, LILINGTON, NC 27546 PH.#: (845) 401 3635 Email: Krsult29@gmail.com

DATE: 11/27/2024

SHEET NAME

ROOF PLAN & MODULES

SHEET SIZE

ANSI B

11" X 17"

SHEET NUMBER

PV-2




ROOF PLAN & MODULES


PV-2

SCALE: 1/8" = 1'-0"

METER NO: 348 797 978

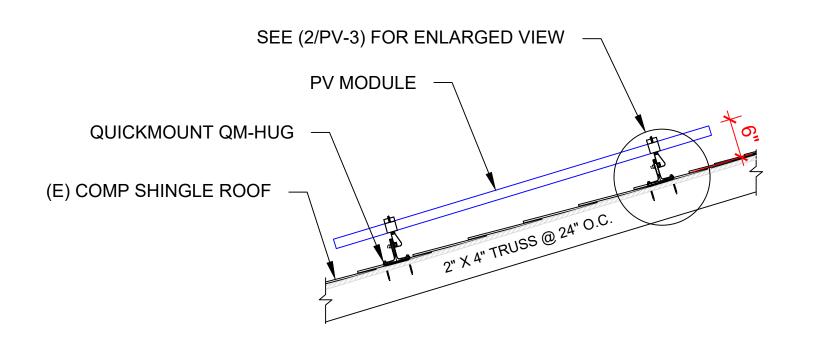

1 ATTACHMENT DETAILS
PV-3

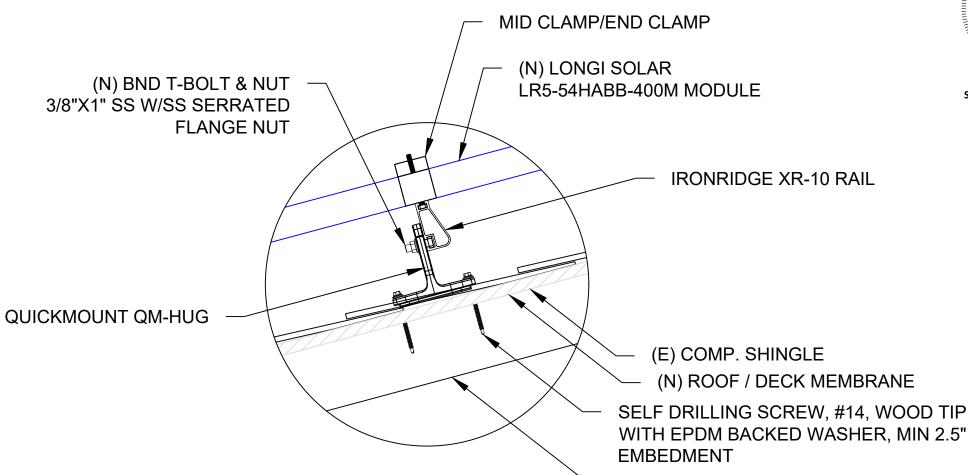

(E) 2" X 4" TRUSS @ 24" O.C.

SEAL 050296

SEAL 050296

EXP. 12/31/2025

Stamped on 12/2/2024

CAROLINA
CONNECTIONS

CAROLINA CONNECTIONS 422 HUFFMAN MILL ROAD, SUITE 105, BURLINGTON, NC 27215, UNITED STATES PHONE: (336) 585-1314

	SYSTEM INFO.
	(19) LONGI SOLAR
	LR5-54HABB-400M
Ī	(10) DURACELL POWER CENTER
	COLAR BY DUAL D700 M2 (240V)

SOLAR PV DUAL D700-M2 (240V)
DC SYSTEM SIZE: 7.600 KWDC
AC SYSTEM SIZE: 6.960 KWAC

REVISIONS									
DESCRIPTION	DATE	REV							
REVISION	11/27/2024	Α							

Signature with Seal

PROJECT NAME & ADDRESS

KRISTEN SULT
RESIDENCE
166 CLYDE DOG CT,
LILINGTON, NC 27546
PH.#: (845) 401 3635

DATE: 11/27/2024

SHEET NAME
ATTACHMENT

DETAIL SHEET SIZE

ANSI B 11" X 17"

SHEET NUMBER


PV-3

2 | ENLARGED VIEW OF ATTACHMENT

PV-3

SCALE: NTS

ID	TYPICAL	INITIAL CONDUCTOR LOCATION	FINAL CONDUCTOR LOCATION	CONDUCTOR		CONDUIT	# OF PARALLEL CIRCUITS	CURRENT-CARRYING CONDUCTORS IN CONDUIT		OCPD	E	GC		CORR.	CONDUIT FILL FACTOR	CONT. CURRENT	MAX. CURRENT	BASE AMP.	DERATED AMP.	TERM. TEMP. RATING	LENGTH	VOLTAGE DROP		
1	2	ARRAY	JUNCTION BOX	10 AWG	AC CABLE	-	-	1	2	N/A	N/A	6 AWG	BARE COPPER	0.71	(58°C)	N/A	14.50A	18.13A	N/A	N/A	90°C	35FT	0.53%	
2	1	JUNCTION BOX	SUBPANEL	10 AWG	THWN-2	COPPER	MIN 0.75" Dia	2	4	19.09%	20A	10 AWG	THWN-2, COPPER	0.91	(36°C)	0.8	14.50A	18.13A	40A	29.1A	75°C	49FT	0.79%	
3	1	SUBPANEL	NON-FUSED AC DISCONNECT	8 AWG	THWN-2	COPPER	MIN 0.75" Dia	1	3	23.86%	N/A	10 AWG	THWN-2, COPPER	0.91	(36°C)	1	29.00A	36.25A	55A	50.1A	75°C	5FT	0.10%	
4	1	NON-FUSED AC DISCONNECT	MAIN SERVICE PANEL	8 AWG	THWN-2	COPPER	MIN 0.75" Dia	1	3	23.86%	40A	10 AWG	THWN-2, COPPER	0.91	(36°C)	1	29.00A	36.25A	55A	50.1A	75°C	5FT	0.10%	C

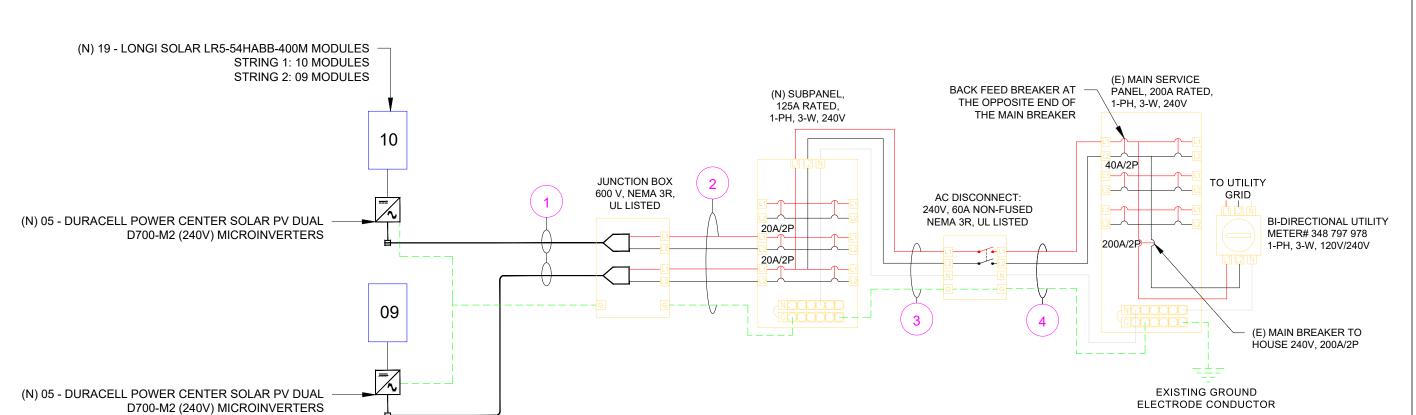

INTERCONNECTION

120% RULE - NEC 705.12(B)(2)(3)(b)

UTILITY FEED + SOLAR BACKFEED

200A + 40A = 240A**BUS RATING X 120%**

200A x 120% = 240A

INVERTER SPECIFICATIONS				
MANUFACTURER / MODEL	DURACELL POWER CENTER SOLAR PV DUAL D700-M2 (240V)			
MAX DC SHORT CIRCUIT CURRENT	11.5 A			
CONTINUOUS OUTPUT CURRENT	2.9A (240V)			
MAX CONTINUOUS OUTPUT POWER	696W			

SERVICE INFO					
UTILITY PROVIDER: DUKE ENERGY					
AHJ NAME:	HARNETT COUNTY				
MAIN PANEL BRAND:	SQUARE D				
MAIN SERVICE PANEL:	200A				
MAIN PANEL LOCATION:	SOUTH EAST				
SERVICE FEED SOURCE:	UNDERGROUND	F			

SOLAR MODULE SPECIFICATIONS					
MANUFACTURER / MODEL	LONGI SOLAR LR5-54HABB-400M				
VMP	30.94 V				
IMP	12.93 A				
VOC	37.05 V				
ISC	13.72 A				
TEMP. COEFF. VOC	-0.265 %/C				
MODULE DIMENSION	67.80" (L) x 44.65" (W)				
PANEL WATTAGE 400W					



CAROLINA CONNECTIONS

422 HUFFMAN MILL ROAD, SUITE 105, BURLINGTON, NC 27215, UNITED STATES PHONE: (336) 585-1314

SYSTEM INFO.										
(19) LONGI SOLAR LR5-54HABB-400M										
(10) DURACELL POWER CENTER SOLAR PV DUAL D700-M2 (240V)										
DC SYSTEM SIZE: 7.600 KWDC										
AC SYSTEM SIZE: 6.960 KWAC										
REVISIONS										
DESCRIPTION DATE RE										
REVISION 11/27/2024										
ann ming.										
Signature with Seal										
SEAL 7										
Exp. 1	INEER GUY	, state of the sta								

STAMPED 12/02/2024 PROJECT NAME & ADDRESS

DATE REV

KRISTEN SULT RESIDENCE 166 CLYDE DOG CT, LILINGTON, NC 27546 PH.#: (845) 401 3635 Email: Krsult29@gmail.com

DATE: 11/27/2024

SHEET NAME

ELECTRICAL LINE & CALCS.

SHEET SIZE

ANSI B 11" X 17"

SHEET NUMBER

PV-4

ELECTRICAL LINE DIAGRAM
COALE, NTO

SCALE: NTS





CAROLINA CONNECTIONS

422 HUFFMAN MILL ROAD, SUITE 105, BURLINGTON, NC 27215, UNITED STATES PHONE: (336) 585-1314

SYSTEM INFO.
(19) LONGI SOLAR
LR5-54HABB-400M
(10) DURACELL POWER CENTER
SOLAR PV DUAL D700-M2 (240V)

DC SYSTEM SIZE: 7.600 KWDC
AC SYSTEM SIZE: 6.960 KWAC

REVISIONS

REVISION	11/27/2024	Α
DESCRIPTION	DATE	REV



PROJECT NAME & ADDRESS

KRISTEN SULT RESIDENCE 166 CLYDE DOG CT, LILINGTON, NC 27546 PH.#: (845) 401 3635 Email: Krsult29@gmail.com

DATE: 11/27/2024

SHEET NAME ELECTRICAL PHOTOS

SHEET SIZE

ANSI B 11" X 17"

SHEET NUMBER

SOLAR MODULE SPECIFICATIONS					
MANUFACTURER / MODEL	LONGI SOLAR LR5-54HABB-400M				
VMP	30.94 V				
IMP	12.93 A				
VOC	37.05 V				
ISC	13.72 A				
TEMP. COEFF. VOC	-0.265 %/C				
MODULE DIMENSION	67.80" (L) x 44.65" (W)				
PANEL WATTAGE	400W				

INVERTER SPECIFICATIONS					
	DURACELL POWER CENTER SOLAR				
MANUFACTURER / MODEL	PV DUAL D700-M2 (240V)				
MAX DC SHORT CIRCUIT CURRENT	11.5 A				
CONTINUOUS OUTPUT CURRENT	2.9A (240V)				

AMBIENT TEMPERATURE SPECS					
RECORD LOW TEMP	-10°C				
AMBIENT TEMP (HIGH TEMP 2%)	36°C				
CONDUIT HEIGHT	7/8"				
ROOF TOP TEMP	90°C				
CONDUCTOR TEMPERATURE RATE	58°C				
MODULE TEMPERATURE COEFFICIENT OF VOC	-0.265 %/C				

	NUMBER OF CURRENT
PERCENT OF VALUES	CARRYING CONDUCTORS
	IN EMT
0.80	4-6
0.70	7-9
0.50	10-20

Voltage rise from the Microinverters to the Junction Box

For branch circuit #1 of 05 D700-M2 Micros, the voltage rise on the 240 VAC AC Cable is 0.53% For branch circuit #2 of 05 D700-M2 Micros, the voltage rise on the 240 VAC AC Cable is 0.47%

Voltage rise from the Junction Box to the Subpanel

VRise = (amps/inverter × number of inverters) × (resistance in Ω/ft) × (2-way wire length in ft)

- = $(2.9 \text{ amp} \times 5) \times (0.00129 \Omega/\text{ft}) \times (49 \text{ ft} \times 2)$
- = 14.50 amps × 0.00129 Ω/ft × 98 ft
- = 1.83 volts

 $%VRise = 1.83 \text{ volts} \div 240 \text{ volts} = 0.76\%$

The voltage rise from the Junction Box to the Subpanel is 0.76%

Voltage rise from the Subpanel to Non-Fused AC Disconnect

VRise = (amps/inverter × number of inverters) × (resistance in $\Omega/\text{ft.}$) × (2-way wire length in ft.)

- = $(2.9 \text{ amp} \times 10) \times (0.000809 \Omega/\text{ft}) \times (5 \text{ ft.} \times 2)$
- = 29.00 amps × 0.000809 Ω/ft × 10 ft.
- = 0.23 volts

 $%VRise = 0.23 \text{ volts} \div 240 \text{ volts} = 0.10\%$

The voltage rise from the Subpanel to the Non-Fused AC Disconnect is 0.10%

Voltage rise from the Non-Fused AC Disconnect to Main Service Panel

VRise = (amps/inverter × number of inverters) × (resistance in $\Omega/\text{ft.}$) × (2-way wire length in ft.)

- = $(2.9 \text{ amp} \times 10) \times (0.000809 \Omega/\text{ft}) \times (5 \text{ ft.} \times 2)$
- = 29.00 amps × 0.000809 Ω/ft × 10 ft.
- = 0.23 volts

 $%VRise = 0.23 \text{ volts} \div 240 \text{ volts} = 0.10\%$

The voltage rise from the Non-Fused AC Disconnect to the Main Service Panel is 0.10%

Total system voltage rise for all wire sections

0.53% + 0.76% + 0.10% + 0.10% = 1.49%



CAROLINA CONNECTIONS 422 HUFFMAN MILL ROAD SUITE 105, BURLINGTON,

SUITE 105, BURLINGTON, NC 27215, UNITED STATES PHONE: (336) 585-1314

SYSTEM INFO.
(19) LONGI SOLAR
LR5-54HABB-400M
(10) DURACELL POWER CENTER
SOLAR PV DUAL D700-M2 (240V)
DC SYSTEM SIZE: 7.600 KWDC
AC SYSTEM SIZE: 6.960 KWAC

REVISIONS

DESCRIPTION DATE REV

REVISION 11/27/2024 A



PROJECT NAME & ADDRESS

RKISTEN SULT RESIDENCE 166 CLYDE DOG CT, LILINGTON, NC 27546 PH.#: (845) 401 3635

DATE: 11/27/2024

SPECIFICATIONS & CALC.

SHEET SIZE

ANSI B 11" X 17"

SHEET NUMBER

WARNING

ELECTRIC SHOCK HAZARD

TERMINALS ON BOTH LINE AND LOAD SIDES MAY BE ENERGIZED IN THE OPEN POSITION

LABEL LOCATION:

MAIN SERVICE PANEL/AC DISCONNECT/AC COMBINER (PER CODE: NEC 2017 690.13(B))

2

WARNING: PHOTOVOLTAIC POWER SOURCE

LABEL LOCATION:

EVERY 10' AND ON CONDUIT BODIES WHEN EXPOSED (PER CODE: NEC2017 690.31(G)(3)(4))

3

PHOTOVOLTAIC SYSTEM AC DISCONNECT RATED AC OUTPUT CURRENT 29.00 AMPS NOMINAL OPERATING AC VOLTAGE 240 VOLTS

MAIN SERVICE PANEL/AC DISCONNECT NEC2017, 690,53

4

RAPID SHUTDOWN SWITCH FOR SOLAR PV SYSTEM

LABEL LOCATION: AT OR WITHIN 3' OF THE AC/DC COMBINER SWITCH PER CODE: NEC 690.58(C)(3)

5



DUAL POWER SOURCE SECOND SOURCE IS PHOTOVOLTAIC SYSTEM

LABEL LOCATION: MAIN SERVICE PANEL/AC DISCONNECT/AC COMBINER/REVENUE METER 2017 NEC 705.12(B)(3)

ADHESIVE FASTENED SIGNS

- ANSI Z535.4-2011 PRODUCT SAFETY SIGNS AND LABELS, PROVIDES GUIDELINES FOR SUITABLE FONT SIZES, WORDS COLORS, SYMBOLS, AND LOCATION REQUIREMENTS FOR LABELS. NEC 110.21(B)(1).
- THE LABEL SHALL BE OF SUFFICIENT DURABILITY TO WITHSTAND THE ENVIRONMENT INVOLVED. NEC 110.21(B)(3).
- ADHESIVE FASTENED SIGNS MAY BE ACCEPTABLE IF PROPERLY ADHERED. VINYL SIGNS SHALL BE WEATHER RESISTANT.

SOLAR PV SYSTEM EQUIPPED WITH RAPID SHUTDOWN

URN RAPID SHUTDOWN SWITCH TO THE "OFF" POSITION TO HUT DOWN PV SYSTEM AND REDUCE SHOCK HAZARD IN THE ARRAY



MAIN SERVICE PANEL IF MSD IS OUTSIDE PLACE IT THERE / IF MSD IS INSIDE PLACE ON THE AC DISCONNECT PER CODE: NEC 690.56(C)(1)

7

6

PHOTOVOLTAIC SYSTEM UTILITY DISCONNECT SWITCH

LABEL LOCATION: 2017 NEC 690.56(C)(3)

8

PV SOLAR BREAKER

DO NOT RELOCATE THIS **OVERCURRENT DEVICE**

LABEL LOCATION: MAIN SERVICE PANEL 2017 NEC 705.12(B)(2)(3)(B)



CAUTION

9

POWER TO THIS BUILDING IS ALSO SUPPLIED FROM THE FOLLOWING SOURCES WITH DISCONNECTS LOCATED AS SHOWN:


SERVICIO DE

DESCONEXION

LABEL LOCATION:

AC DISCONNECT

2017 NEC 230.66

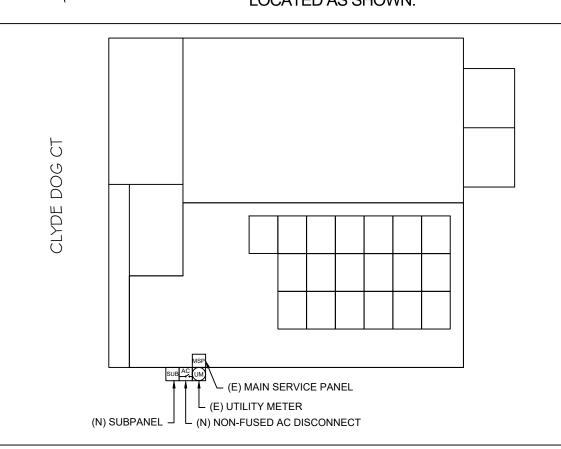



CAROLINA CONNECTIONS

422 HUFFMAN MILL ROAD, SUITE 105, BURLINGTON, NC 27215, UNITED STATES PHONE: (336) 585-1314

SYSTEM INFO. (19) LONGI SOLAR LR5-54HABB-400M (10) DURACELL POWER CENTER

SOLAR PV DUAL D700-M2 (240V) DC SYSTEM SIZE: 7.600 KWDC

AC SYSTEM SIZE: 6.960 KWAC

REVISIONS DESCRIPTION DATE 11/27/2024 Signature with Seal

047345 **STAMPED 12/02/2024**

PROJECT NAME & ADDRESS

KRISTEN SULT RESIDENCE 166 CLYDE DOG CT, LILINGTON, NC 27546 PH.#: (845) 401 3635 Email: Krsult29@gmail.com

DATE: 11/27/2024

SHEET NAME SIGNAGE

SHEET SIZE

ANSI B 11" X 17"

SHEET NUMBER













LR5-54HABB 390~415M


21.3% MAX MODULE EFFICIENCY

0~3%


0.45%YEAR 2-30
POWER DEGRADATION

HALF-CELL Lower operating temperature

Additional Value

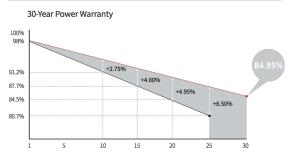

Mechanical Parameters Cell Orientation 108 (6×18) Junction Box IP68, three diodes 4mm², ±1200mm Output Cable length can be customized Dual glass, 2.0+1.6mm heat strengthened glass Glass Frame Anodized aluminum alloy frame 22.5kg Weight 1722×1134×30mm Packaging 36pcs per pallet / 216pcs per 20' GP / 936pcs or 792pcs (Only for USA) per 40' HC

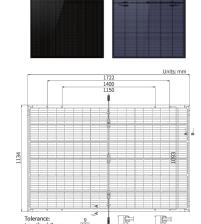

Electrical Characteristic	s sto	: AM1.5 10	000W/m ²	25°C	NOCT : AM	1.5 800W/	m² 20°C	1m/s ⊤e	st uncertainty fo	or Pmax: ±3%		
Module Type	LR5-54H	ABB-390M	LR5-54H	ABB-395M	LR5-54H	ABB-400M	LR5-54H	IABB-405M	LR5-54H	ABB-410M	LR5-54H	ABB-415M
Testing Condition	STC	NOCT	STC	NOCT	STC	NOCT	STC	NOCT	STC	NOCT	STC	NOCT
Maximum Power (Pmax/W)	390	291.5	395	295.2	400	299.0	405	302.7	410	306.5	415	310.2
Open Circuit Voltage (Voc/V)	36.58	34.39	36.81	34.61	37.05	34.84	37.29	35.06	37.53	35.29	37.77	35.51
Short Circuit Current (Isc/A)	13.57	10.95	13.65	11.01	13.72	11.07	13.79	11.13	13.87	11.19	13.94	11.25
Voltage at Maximum Power (Vmp/V)	30.47	28.43	30.70	28.64	30.94	28.86	31.18	29.09	31.42	29.31	31.66	29.54
Current at Maximum Power (Imp/A)	12.80	10.26	12.87	10.31	12.93	10.36	12.99	10.41	13.05	10.45	13.11	10.50
Module Efficiency(%)	2	0.0	2	0.2	2	10.5	2	10.7	2	21.0	2	1.3
Electrical characteristics with d	lifferent re	ar side pov	ver gain (re	eference t	o 400W fror	nt)						
Pmax /W	Voc/V		Is	c /A		Vmp/V		Imp	/A		Pmax gair	1
420	37.05		14	4.41		30.94		13.	58		5%	
440	37.05		15	5.09		30.94		14.	22		10%	

31.04

31.04

31.04

Mechanical Loading

Front Side Maximum Static Loading

Operating Parameters		
Operational Temperature	-40°C ~ +85°C	
Power Output Tolerance	0~3%	
Voc and Isc Tolerance	±3%	
Maximum System Voltage	DC1500V (IEC/UL)	
Maximum Series Fuse Rating	30A	
Nominal Operating Cell Temperature	45±2℃	
Protection Class	Class II	
Bifaciality	70±5%	
Fire Rating	UL Similar type 38 *	

37.15

37.15

37.15

0	N	G	

*Reference Standard: UL61730 Second Edition, Dated October 28, 2022

460

480

Rear Side Maximum Static Loading Hailstone Test

Temperature Ratings (STC)

Temperature Coefficient of Isc	+0.050%/°C
Temperature Coefficient of Voc	-0.265%/°C
Temperature Coefficient of Pmax	-0.340%/°C

14.87

No.8369 Shangyuan Road, Xi'an Economic And Technological Development Zone, Xi'an, Shaanxi, China.

Web: www.longi.com

IEC Class C

15.78

16.46

17.15

Specifications included in this datasheet are subject to change without notice. LONGi reserves the right of final interpretation. (20230115V17) Only for North America

15%

20%

25%

5400Pa

2400Pa

25mm Hailstone at the speed of 23m/s



CAROLINA CONNECTIONS 422 HUFFMAN MILL ROAD, SUITE 105, BURLINGTON, NC 27215, UNITED STATES PHONE: (336) 585-1314

SYSTEM INFO.
(19) LONGI SOLAR
LR5-54HABB-400M
(10) DURACELL POWER CENTER
SOLAR PV DUAL D700-M2 (240V)
DC SYSTEM SIZE: 7.600 KWDC

AC SYSTEM SIZE: 6,960 KWAC

REVI	SIONS			
DESCRIPTION	DATE	REV		
REVISION	11/27/2024	Α		

Signature with Seal

PROJECT NAME & ADDRESS

KRISTEN SULT RESIDENCE 166 CLYDE DOG CT, LILINGTON, NC 27546 PH.#: (845) 401 3635 Email: Krsult29@gmail.com


DATE: 11/27/2024

SHEET NAME **EQUIPMENT SPECIFICATION**

SHEET SIZE

ANSI B 11" X 17"

SHEET NUMBER

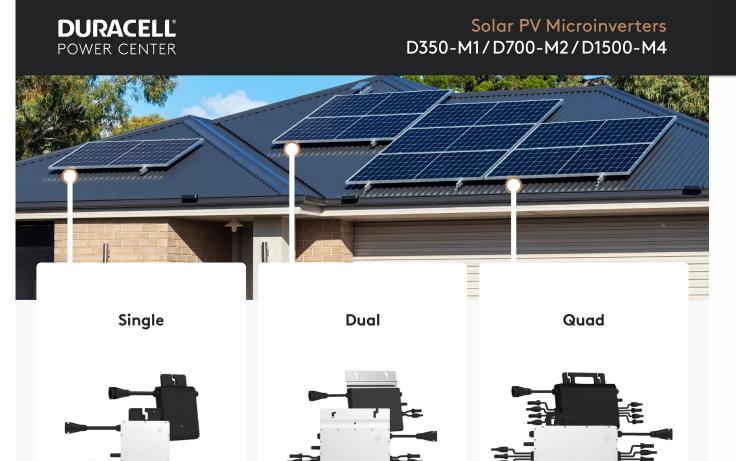

Fast, Easy & Flexible Installation

Duracell Power Center's family of single, dual, and quad microinverters delivers the lowest cost, highest yield per panel PV installation. The AC trunk cable format permits any combination of the three models to optimize even the most complex rooftop installations.

Reactive Power Control CA Rule 21 compliant Compliant with U.S. NEC-2017 & NEC-2020 690.12 rapid shutdown

High reliability: NEMA 6 (IP67) enclosure, 6000V surge protection

DURACELL° POWER CENTER

Solar PV Microinverters D350-M1/D700-M2/D1500-M4

Technical Data

4odel	D35	0-M1	D700)-M2	D150	0-M4
Input Data (DC)						
Number of PV inputs	-	1		2		4
Module power range, typical (W)	280 to 470+		280 to 470+		300 to 505+	
Maximum input voltage (V)			6	0		
MPPT voltage range (V)			16-	-60		
Start-up voltage (V)			2	2		
Maximum input current (A)			11	.5		
Output Data (AC)						
Peak output power (VA)	3!	50	700		1500	1350
Maximum continuous output power (VA)	34	49	69	96	1438	1246
Maximum continuous output current (A)	1.45	1.68	2.9	3.35	5.99	5.99
Nominal output voltage(V)	240	208	240	208	240	208
Nominal output voltage range1 (V)	211-264	183-228	211-264	183-228	211-264	183-22
Nominal frequency/range1 (Hz)			60/5	5-65		
Power factor (adjustable)		>0	.99 default (0.	8 lead to 0.8 le	ag)	
Total harmonic distortion			<3		<i>.</i>	
Maximum units per branch2 (10 AWG)	16	14	8	7	4	4
Efficiency						
CEC peak efficiency (%)			96	5.7		
CEC weighted efficiency (%)	7		96			
Nominal MPPT efficiency (%)			99	2.8		
Nighttime power consumption (mW)			<5	50		
Mechanical Data						
Ambient temperature range (°C)			-40 to	o +65	/L	
Dimensions (W × H × D) mm	182 x 164 x 29.5		250 x 170 x 28		280 x 176 x 33	
Weight (kg)		75	2.6		3.35	
Enclosure rating		· -	Outdoor	NEMA 6		
Cooling			Natural conve	ction - no fans	5	
Features						
Communication		2	.4 GHz proprie	tary RF (Nordi	c)	
Monitoring				es	•	
Warranty			Up to 2			
Compliance	UL 1741, IEEE 1547, UL 1741 SA (240 Vac), CA Rule 21 (240 Vac), CSA C22.2 No. 107.1-1 FCC Part 15B, FCC Part 15C					
PV Rapid Shutdown	Conforms with NEC-2017 and NEC-2020 Article 690.12 and CEC-2021 Sec 64-218 Rapid Shutdown of PV Systems					

©2022 Power Center

Duracell is a registered trademark of Duracell U.S. Operations, Inc., used under license. All rights reserved.



CAROLINA CONNECTIONS
422 HUFFMAN MILL ROAD,
SUITE 105, BURLINGTON,
NC 27215, UNITED STATES
PHONE: (336) 585-1314

SYSTEM INFO.
(19) LONGI SOLAR LR5-54HABB-400M
(10) DURACELL POWER CENTER SOLAR PV DUAL D700-M2 (240V)
DC SYSTEM SIZE: 7.600 KWDC

REVISIONS			
DESCRIPTION	DATE	REV	
REVISION	11/27/2024	Α	

AC SYSTEM SIZE: 6.960 KWAC

Signature with Seal

PROJECT NAME & ADDRESS

RESIDENCE 166 CLYDE DOG CT, LILINGTON, NC 27546 PH.#: (845) 401 3635 Email: Krsult29@gmail.com

DATE: 11/27/2024

SHEET NAME
EQUIPMENT
SPECIFICATION

SHEET SIZE

ANSI B 11" X 17"

SHEET NUMBER

PV-9

Become a Duracell Partner Today

sales@duracellpowercenter.com



QuickMount® HUG



The Respect Your Roof Deserves

When integrating with a home, solar attachments must be dependable for the lifetime of the rooftop. Due to recent innovations, many asphalt shingles have bonded courses. A mount that protects without the need to pry shingles can really speed things up.

Its Halo is a cast-aluminum barrier that encases the UltraGrip, our industrial-grade, foam-and-mastic seal. This allows HUG to accelerate the installation process and provide the utmost in waterproofing





Triple Rated & Certified to Respect the Roof™ UL 2703, 441 (27) TAS 100(A)-95





Rafter & Deck Mounting Options

Mount HUG to the roof rafters, the roof deck, or both with our custom-engineered RD (rafter-or-deck) Structural Screw. The RD Structural Screw anchors HUG to the roof with an EPDM sealing washer, completing the stack of waterproofing barriers. See

Adaptive, Rafter-Friendly Installation



When you find a rafter, you can move on. Only 2 RD Structural Screws are needed.



Miss the rafter? Try it again. Place another screw to the left or right. If rafter is found, install 3rd and final screw.



Still no luck? Install the rest. If more than 3 screws miss the rafter secure six screws to deck mount it.

Trusted Strength & Less Hassle



Structural capacities of HUG™ were reviewed in many load directions, with racking rail running cross-slope or up-slope in relation to roof pitch.

For further details, see the HUG certification letters for attaching to rafters and decking.

IronRidge designed the HUG, in combination with the RD Structural Screw to streamline installs, which means the following:

· No prying shingles

11111

- · No roof nail interference
- No pilot holes necessary
- · No sealant (in most cases)
- No butyl shims needed

Attachment Loading



The rafter-mounted HUG has been tested and rated to support 1004 (lbs) of uplift and 368 (lbs) of lateral load.

Structural Design H

Parts are designed and certified for compliance with the International **Building Code &** ASCE/SEI-7.

Water Seal Ratings

HUG passed both the UL 441 Section 27 "Rain Test" and TAS 100(A)-95 "Wind Driven Rain Test" by Intertek.

UL 2703 System



Systems conform to UL 2703 mechanical and bonding requirements. See Flush Mount Manual for more info.



© 2023 IronRidge, Inc. All rights reserved. Visit www.ir-patents.com for patent information. Version 1.02



CAROLINA CONNECTIONS

422 HUFFMAN MILL ROAD, SUITE 105, BURLINGTON, NC 27215, UNITED STATES PHONE: (336) 585-1314

SYSTEM INFO. (19) LONGI SOLAR LR5-54HABB-400M (10) DURACELL POWER CENTER

SOLAR PV DUAL D700-M2 (240V) DC SYSTEM SIZE: 7.600 KWDC

AC SYSTEM SIZE: 6.960 KWAC REVISIONS

DESCRIPTION DATE REVISION 11/27/2024

Signature with Seal

PROJECT NAME & ADDRESS

KRISTEN SULT RESIDENCE 166 CLYDE DOG CT, LILINGTON, NC 27546 PH.#: (845) 401 3635 Email: Krsult29@gmail.com

DATE: 11/27/2024

SHEET NAME

EQUIPMENT SPECIFICATION


SHEET SIZE

ANSI B 11" X 17"

SHEET NUMBER **PV-10**



XR10® Rail

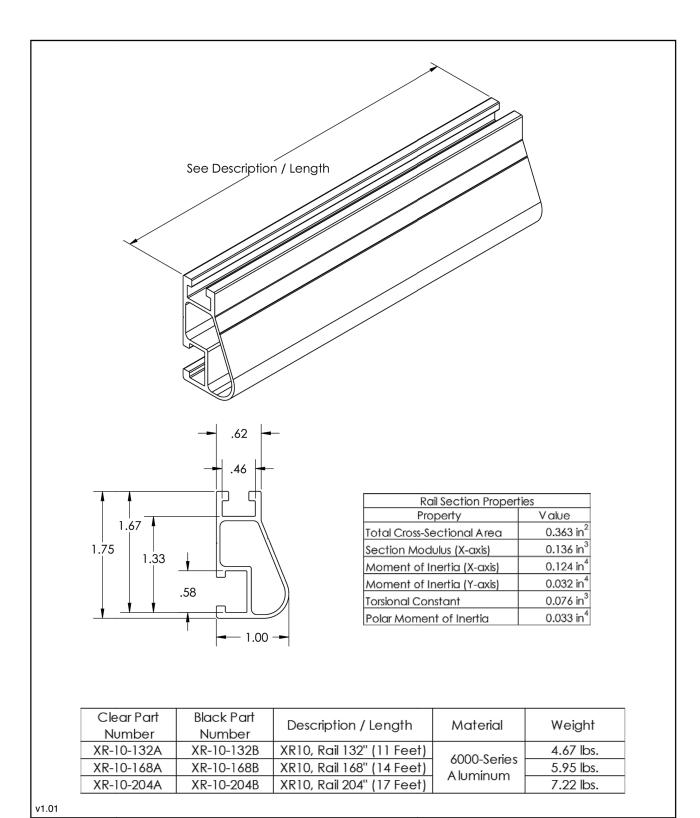



CAROLINA CONNECTIONS

422 HUFFMAN MILL ROAD, SUITE 105, BURLINGTON, NC 27215, UNITED STATES PHONE: (336) 585-1314

SYSTEM INFO.

(19) LONGI SOLAR LR5-54HABB-400M (10) DURACELL POWER CENTER SOLAR PV DUAL D700-M2 (240V)

DC SYSTEM SIZE: 7.600 KWDC

AC SYSTEM SIZE: 6.960 KWAC REVISIONS

DATE DESCRIPTION REVISION 11/27/2024

Signature with Seal

PROJECT NAME & ADDRESS

KRISTEN SULT RESIDENCE 166 CLYDE DOG CT, LILINGTON, NC 27546 PH.#: (845) 401 3635 Email: Krsult29@gmail.com

DATE: 11/27/2024

SHEET NAME

EQUIPMENT SPECIFICATION

SHEET SIZE

ANSI B 11" X 17"

SHEET NUMBER