TESLA POWERWALL BATTERY SYSTEM

494 HOBSON RD, DUNN, NC 28334, USA

SYSTEM SUMMARY:

(N) 01 - TESLA POWERWALL 3 (1807000-XX-Y) BATTERY

(N) 200A TESLA GATEWAY 3 (1841000-X1-Y)

(E) 200A MAIN SERVICE PANEL WITH (E) 200A MAIN BREAKER

(N) 60A NON FUSED AC DISCONNECT

EXISTING SYSTEM SUMMARY:

(E) BREAKER BOX

DESIGN CRITERIA:

STORY: - ONE STORY SNOW LOAD: - 10 PSF WIND SPEED: - 120 MPH WIND EXPOSURE:- C **EXPOSURE CATEGORY:- II** COORDINATES:- 35.359342, -78.597885

GOVERNING CODES:

2018 NORTH CAROLINA ADMINISTRATIVE CODE 2018 NORTH CAROLINA BUILDING CODE 2018 NORTH CAROLINA RESIDENTIAL CODE 2018 NORTH CAROLINA ENERGY CONSERVATION CODE 2018 NORTH CAROLINA EXISTING BUILDING CODE 2018 NORTH CAROLINA FIRE CODE 2018 NORTH CAROLINA FUEL GAS CODE 2018 NORTH CAROLINA MECHANICAL CODE 2018 NORTH CAROLINA PLUMBING CODE 2017 NORTH CAROLINA ELECTRICAL CODE

2018 NORTH CAROLINA ACCESSIBILITY CODE

SHEET INDEX

COVER SHEET

PV-1 SITE PLAN WITH ROOF PLAN

PV-1.1 **ENLARGE VIEW**

PV-2 **BATTERY MOUNTING DETAIL ELECTRICAL LINE DIAGRAM** PV-3

WIRE CALCULATION

PV-4 PLACARD & WARNING LABEL PV-5+ **EQUIPMENT SPEC SHEETS**

VERSION DESCRIPTION INITIAL RELEASE 10/01/2024

YES SOLAR SOLUTIONS

202 NORTH DIXON AVENUE. **CARY. NC 27513 USA** PHONE: 919-804-1490

LICENSE: 67356

PROJECT NAME

021518013202 494 HOBSON RD UTILITY: N/A DUNN,

AHJ: HARNETT COUNTY

SHEET NAME

COVER SHEET

SHEET SIZE

ANSIB 11" X 17"

SHEET NUMBER PV-0

- (E) 48 SILFAB SOLAR SLA-M (310W) MODULES
- (E) 48 ENPHASE ENERGY IQ8PLUS-72-2-US MICRO-INVERTERS
- (E) AC DISCONNECT
- (E) ENPHASE IQ COMBINER BOX

GENERAL NOTES

- THE CONTRACTOR/INSTALLER OF THE SOLAR PV SYSTEM OVER EXISTING ROOF SHALL CONFORM TO OSHA REQUIREMENTS DURING THE CONSTRUCTION PHASE. JOB SAFETY AND CONSTRUCTION PROCEDURES ARE THE SOLE RESPONSIBILITY OF THE CONTRACTOR/INSTALLER.
- REFER TO ELECTRICAL DRAWING PV-3 FOR PANEL DETAILED INFORMATION.
- IN CASE OF CONFLICT BETWEEN STRUCTURAL DRAWINGS AND ELECTRICAL DRAWINGS, THE MOST RIGID REQUIREMENTS SHALL GOVERN.
- THE CONTRACTOR/INSTALLER SHALL VERIFY ALL EXISTING BUILDING INFORMATION SHOWN (DIMENSIONS, ROOF TOP PROJECTIONS, ETC.) AND NOTIFY THE ENGINEER OF ANY DISCREPANCIES PRIOR TO INSTALLATIONS OF PV SYSTEM.
- THE CONTRACTOR/INSTALLER SHALL VERIFY AND COORDINATE EXISTING OPENINGS, ROOF TOP UNITS, VENT PIPES, ETC. SHOWN ON DRAWINGS. IF THERE IS A DISCREPANCY BETWEEN DRAWINGS, IT IS THE CONTRACTORS/INSTALLER'S RESPONSIBILITY TO NOTIFY ENGINEER PRIOR TO PERFORMING THE WORK.
- ALL CONSTRUCTION IS TO BE PERFORMED IN STRICT CONFORMANCE WITH ALL APPLICABLE TOWN, COUNTY & STATE REGULATIONS AND/OR ANY OTHER **GOVERNING BODIES.**
- DO NOT SCALE THESE DRAWINGS. USE DIMENSIONS. CONTRACTOR MUST CONDUCT ROOF SURVEY TO VERIFY DIMENSIONS SHOWN ON PLAN PRIOR TO INSTALLATION. IF THERE IS A DISCREPANCY IT IS CONTRACTOR/INSTALLER'S RESPONSIBILITY TO NOTIFY THE ENGINEER IMMEDIATELY.

ELECTRICAL NOTES

- 1.) ALL EQUIPMENT TO BE LISTED BY UL OR OTHER NRTL, AND LABELED FOR ITS APPLICATION.
- 2.) ALL CONDUCTORS SHALL BE COPPER, RATED FOR 600 V AND 90 & 75 DEGREE C WET ENVIRONMENT.
- 3.) WIRING, CONDUIT, AND RACEWAYS MOUNTED ON ROOFTOPS SHALL BE ROUTED DIRECTLY TO, AND LOCATED AS CLOSE AS POSSIBLE TO THE NEAREST RIDGE, HIP, OR
- 4.) WORKING CLEARANCES AROUND ALL NEW AND EXISTING ELECTRICAL EQUIPMENT SHALL COMPLY WITH NEC 110.26.
- 5.) DRAWINGS INDICATE THE GENERAL ARRANGEMENT OF SYSTEMS. CONTRACTOR SHALL FURNISH ALL NECESSARY OUTLETS, SUPPORTS, FITTINGS AND ACCESSORIES TO FULFILL APPLICABLE CODES AND STANDARDS.
- 6.) WHERE SIZES OF JUNCTION BOXES, RACEWAYS, AND CONDUITS ARE NOT SPECIFIED. THE CONTRACTOR SHALL SIZE THEM ACCORDINGLY.
- 7.) ALL WIRE TERMINATIONS SHALL BE APPROPRIATELY LABELED AND READILY VISIBLE.
- 8.) MODULE GROUNDING CLIPS TO BE INSTALLED BETWEEN MODULE FRAME AND MODULE SUPPORT RAIL, PER THE GROUNDING CLIP MANUFACTURER'S INSTRUCTION.
- 9.) MODULE SUPPORT RAIL TO BE BONDED TO CONTINUOUS COPPER E.G.C. VIA WEEB LUG OR ILSCO GBL-4DBT LAY-IN LUG.
- 10.) THE POLARITY OF THE GROUNDED CONDUCTORS IS NEGATIVE











NOTE

HOBSON RD

ALL ELECTRICAL EQUIPMENT, INVERTERS,
 DISCONNECTS, MAIN SERVICE PANELS, ETC. SHALL
 NOT BE INSTALLED WITHIN 3' OF THE GAS METERS'
 SUPPLY OR DEMAND PIPING.



202 NORTH DIXON AVENUE, CARY, NC 27513 USA PHONE: 919-804-1490 LICENSE: 67356

VERSION						
DESCRIPTION	DATE	REV				
INITIAL RELEASE	10/01/2024	UR				

PROJECT NAME


KASPER, KAREN 494 HOBSON RD, DUNN, NC 28334, USA APN# 021518013202 UTILITY: N/A AHJ: HARNETT COUNTY

SHEET NAME

SITE PLAN WITH ROOF PLAN

SHEET SIZE ANSI B 11" X 17"

SHEET NUMBER
PV-1

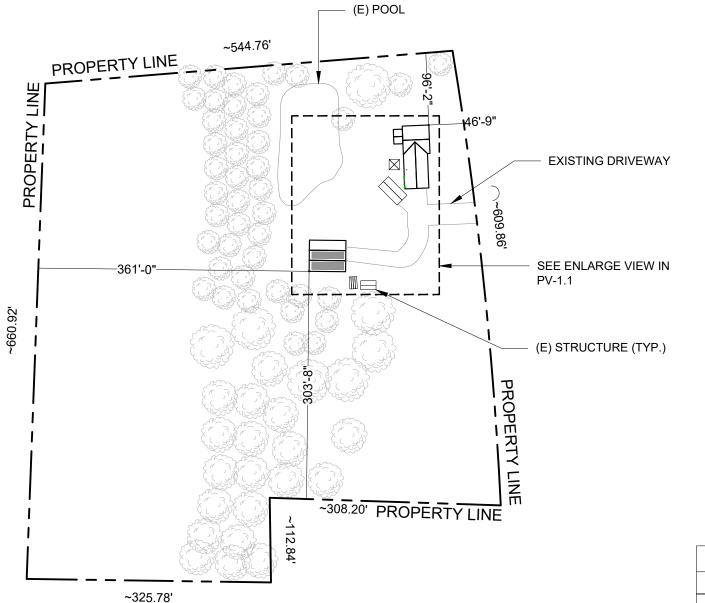

LEGEND

UM UTILITY METER

MSP MAIN SERVICE PANEL

ACD EXISTING AC DISCONNECT

CB EXISTING COMBINER BOX

BB EXISTING BREAKER BOX

TESLA POWERWALL 3 (1807000-XX-Y)
BATTERY

TG TESLA GATEWAY 3 (1841000-X1-Y)


ACD AC DISCONNECT

PROPERTY LINE

VENT, ATTIC FAN
(ROOF OBSTRUCTION)

TREE

1 SITE PLAN WITH ROOF PLAN
SCALE: 1/128" = 1'-0"

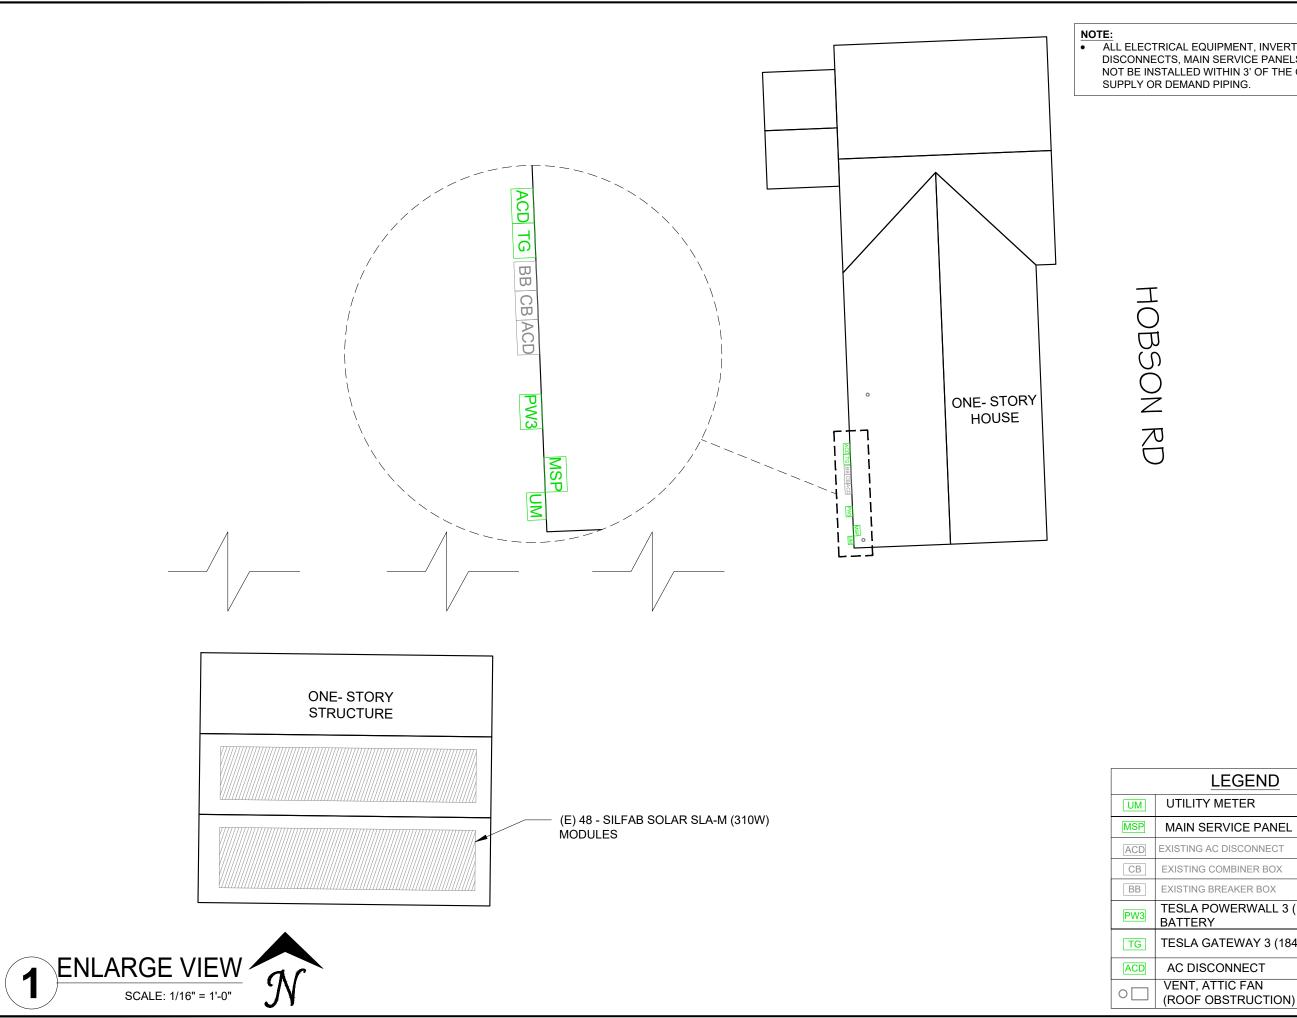

• ALL ELECTRICAL EQUIPMENT, INVERTERS, DISCONNECTS, MAIN SERVICE PANELS, ETC. SHALL NOT BE INSTALLED WITHIN 3' OF THE GAS METERS' SUPPLY OR DEMAND PIPING.



202 NORTH DIXON AVENUE, **CARY, NC 27513 USA** PHONE: 919-804-1490 LICENSE: 67356

VERSION DESCRIPTION INITIAL RELEASE 10/01/2024

PROJECT NAME

494 HOBSON RD, DUNN, NC 28334, USA APN# 021518013202 AHJ: HARNETT COUNTY KASPER, KAREN UTILITY: N/A


SHEET NAME

ENLARGE VIEW

SHEET SIZE **ANSI B** 11" X 17"

SHEET NUMBER PV-1.1

LEGEND UTILITY METER MAIN SERVICE PANEL EXISTING AC DISCONNECT EXISTING COMBINER BOX EXISTING BREAKER BOX TESLA POWERWALL 3 (1807000-XX-Y) TESLA GATEWAY 3 (1841000-X1-Y) AC DISCONNECT

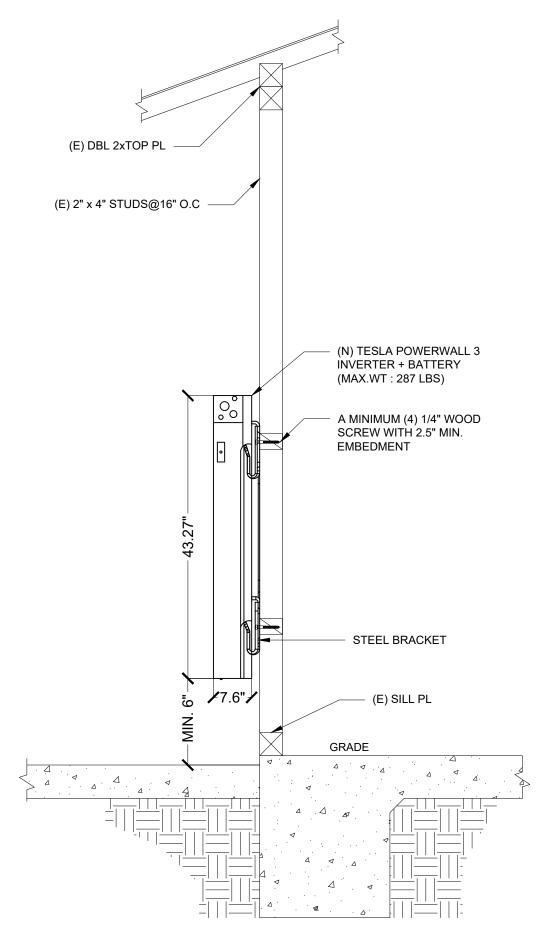



202 NORTH DIXON AVENUE, CARY, NC 27513 USA PHONE: 919-804-1490 LICENSE: 67356

VERSION						
DESCRIPTION DATE REV						
INITIAL RELEASE	10/01/2024	UR				

PROJECT NAME

494 HOBSON RD, DUNN, NC 28334, USA APN# 021518013202 UTILITY: N/A AHJ: HARNETT COUNTY

KASPER, KAREN

SHEET NAME


BATTERY MOUNTING DETAIL

> SHEET SIZE ANSI B 11" X 17"

SHEET NUMBER PV-2

BATTERY MOUNTING DETAIL SCALE: NTS

SIDE VIEW

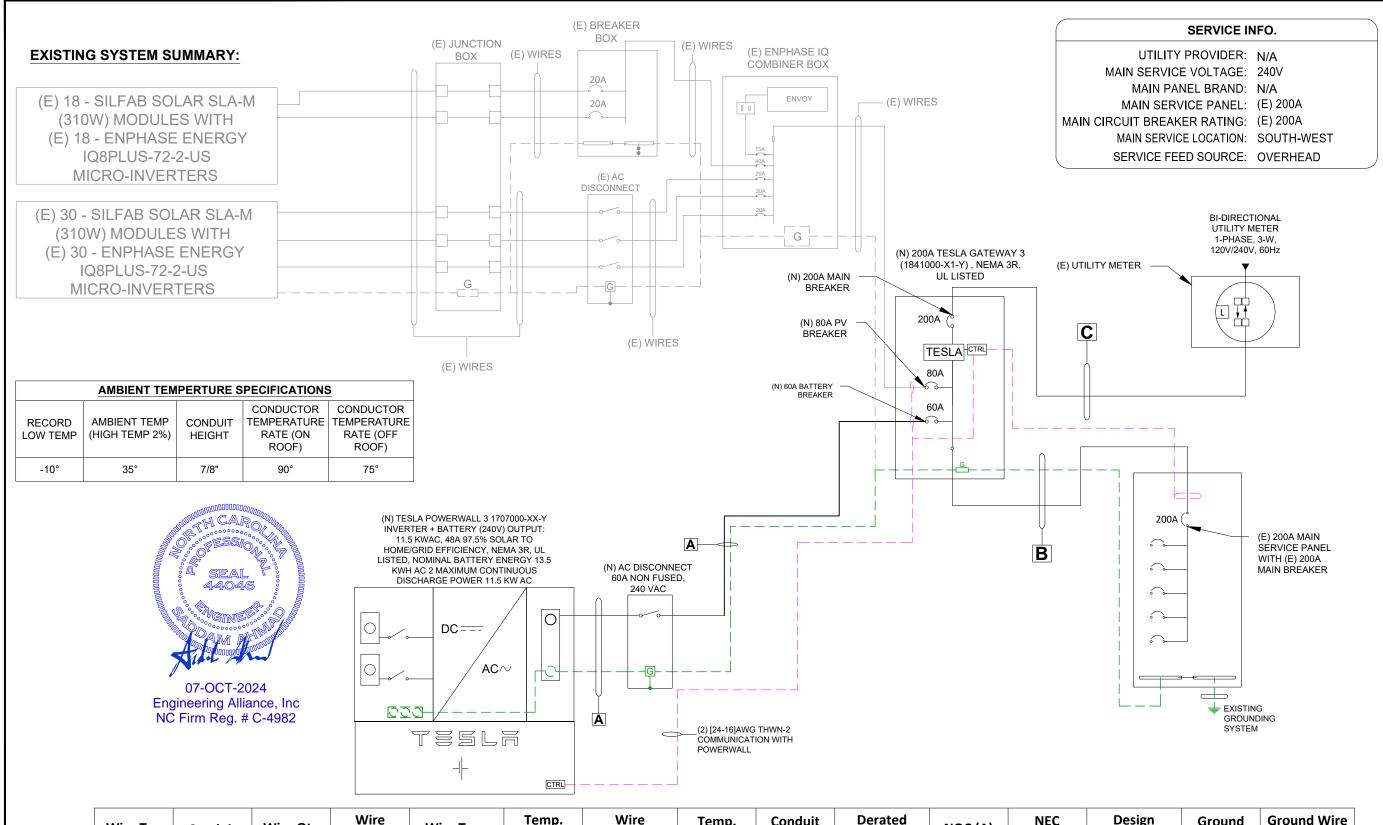

Wire Tag	Conduit	Wire Qty	Wire Gauge	Wire Type	Temp. Rating	Wire Ampacity (A)	Temp. Derate	Conduit Fill Derate	Derated Ampacity (A)	NOC (A)	NEC Correction	Design Current (A)	Ground Size	Ground Wire Type
А	3/4" EMT	3+G	6 AWG	THWN	75°C	65	0.94	1.0	61.10	48	1.25	60.00	10 AWG	THWN
В	2" EMT	3+G	4/0 AWG	THWN	75°C	230	0.94	1.0	216.20	-	-	200.00	6 AWG	THWN
С	2" EMT	3	4/0 AWG	THWN	75°C	230	0.94	1.0	216.20	-	-	200.00	-	-

ELECTRICAL LINE DIAGRAM WITH WIRE CALCULATION

SCALE: NTS



202 NORTH DIXON AVENUE, CARY, NC 27513 USA PHONE: 919-804-1490 LICENSE: 67356

VERSION						
DESCRIPTION	DATE	REV				
INITIAL RELEASE	10/01/2024	UR				

PROJECT NAME

494 HOBSON RD, DUNN, NC 28334, USA APN# 021518013202 UTILITY: N/A AHJ: HARNETT COUNTY

KASPER, KAREN

SHEET NAME
ELECTRICAL LINE
DIAGRAM WITH
WIRE CALCULATION

SHEET SIZE

ANSI B

11" X 17"
SHEET NUMBER

PV-3

ENERGY STORAGE SYSTEM DISCONNECT

NOMINAL VOLTAGE: 240 VAC
MAX AVAILABLE ISC: AAC
ISC CLEAR TIME: MS
DATE:


REQ'D BY NEC 706.7(D)

APPLY TO: BATTERY


CAUTION TRI POWER SOURCE

FIRST SOURCE IS UTILITY ELECTRICAL GRID SECOND SOURCE IS AC BATTERY THIRD SOURCE IS PV INVERTER

LABEL LOCATION:
POINT OF INTERCONNECTION
MAIN SERVICE PANEL
(NEC 705.12(C) & NEC 690.59)

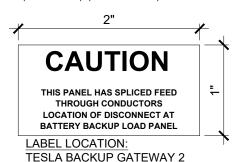



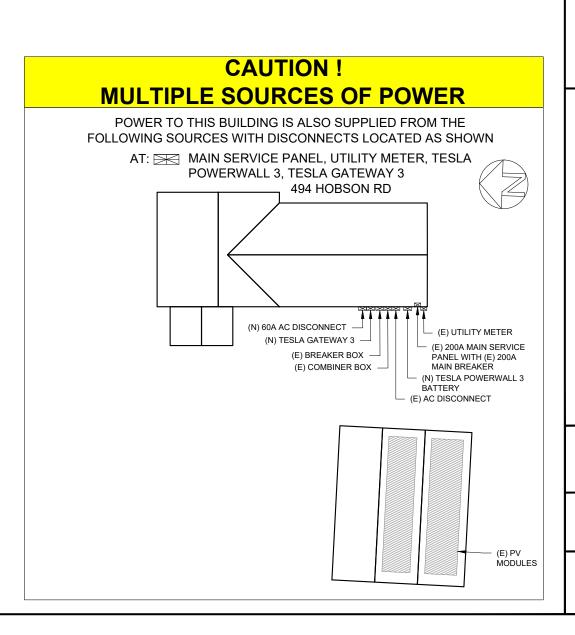



202 NORTH DIXON AVENUE, CARY, NC 27513 USA PHONE: 919-804-1490 LICENSE: 67356

VERSION						
DESCRIPTION	DATE	REV				
INITIAL RELEASE	10/01/2024	UR				

PROJECT NAME

494 HOBSON RD, DUNN, NC 28334, USA APN# 021518013202 UTILITY: N/A AHJ: HARNETT COUNTY

KASPER, KAREN

SHEET NAME

WARNING LABELS & PLACARD

SHEET SIZE ANSI B

11" X 17"
SHEET NUMBER

PV-4

Powerwall 3

2024

Power Everything

Powerwall 3 is a fully integrated solar and battery system, designed to accelerate the transition to sustainable energy. Customers can receive whole home backup, cost savings, and energy independence by producing and consuming their own energy while participating in grid services. Once installed, customers can manage their system using the Tesla App to customize system behavior to meet their energy goals.

Powerwall 3 achieves this by supporting up to 20 kW DC of solar and providing up to 11.5 kW AC of continuous power per unit. It has the ability to start heavy loads rated up to 185 LRA, meaning a single unit can support the power needs of most homes. Powerwall 3 Expansions make it easier and more affordable to scale up customers' systems to meet their current or future needs. Powerwall 3 is designed for fast and efficient installations, modular system expansion, and simple connection to any electrical service.



Powerwall 3 Expansion Technical Specifications

Battery Technical	
Specifications	

Model Number	1807000-xx-y
Nominal Battery Energy	13.5 kWh
/oltage Range	52 - 92 V DC ⁹

⁹ Powerwall 3 Expansion units are connected in parallel and are not field serviceable

Environmental Specifications

-20°C to 50°C (-4°F to 122°F) 10			
Up to 100%, condensing			
–20°C to 30°C (–4°F to 86°F), up to 95% RH, non- condensing, State of Energy (SOE): 25% initial			
3000 m (9843 ft)			
Indoor and outdoor rated			
NEMA 3R			
IP67			
PD3			

¹⁰ Performance may be de-rated at operating temperatures above 40°C (104°F).

Compliance Information

Certifications

UL 1973, UL 9540

Mechanical **Specifications**

Dimensions	1105 x 609 x 168 mm (43.5 x 24 x 6.6 in) 11	<u> </u>		
Total Weight of Wall- Mounted Expansion Unit	118.5 kg (261.2 lb)		***	
Weight of Expansion Unit	110 kg (242.5 lb)		ļ ,	
Weight of Glass Front Cover	6.5 kg (14.5 lb)			
Weight of Wall Bracket	1.9 kg (4.2 lb)	1105 mm		
Weight of Expansion Accessories	0.7 kg (1.5 lb)			
Mounting Options	Floor or wall mount			
Stacking Capability (Floor Mount Only)	Up to (3) Expansion units behind a Powerwall 3			-
Compatibility with Other Systems	Only compatible with Powerwall 3			
Connection to Powerwall 3 or Expansions	Powerwall 3 Expansion harness 12	<u> </u>		168

installed on Powerwall 3 Expansion.

yes solar solutions

202 NORTH DIXON AVENUE, **CARY, NC 27513 USA** PHONE: 919-804-1490 LICENSE: 67356

VERSION						
DESCRIPTION DATE REV						
INITIAL RELEASE	10/01/2024	UR				

PROJECT NAME

AHJ: HARNETT COUNTY 494 HOBSON RD, JNN, NC 28334, USA

SHEET NAME

SPEC SHEETS

SHEET SIZE **ANSIB**

11" X 17"

SHEET NUMBER PV-5

2024 Powerwall 3 Datasheet

¹²The Powerwall 3 Expansion harness is a listed component of the UL 9540 certification.

Gateway 3

Tesla Gateway 3 controls connection to the grid in a Powerwall system, automatically detecting outages and providing seamless transition to backup power. It provides energy monitoring that is used by Powerwall for solar self-consumption, time-based control, and backup operation.

Performance	
Specifications	;

Model Number	1841000-x1-y	AC Meter	+/- 0.5%		
Nominal Grid Voltage	120/240 V AC	Communication	CAN		
Grid Configuration	Split phase	User Interface	Tesla App		
Grid Frequency	60 Hz	Backup Transition	Automatic disconnect for seamless backup		
Continuous Current Rating	200 A	Overcurrent	100–200 A		
Maximum Supply Short Circuit Current	22 kA with Square D or Eaton main breaker 25 kA with Eaton main	Protection Device	Service entrance rated Eaton CSR, BWH, or BW, or Square D QOM breakers		
	breaker ¹⁵	Internal Panelboard	200 A		
IEC Protective Class	Class I		8-space/16 circuit breakers Eaton BR, Siemens QP, or		
Overvoltage Category	Category IV	_	Square D HOM breakers rated to 10–125A		
¹⁵ Only Eaton CSR or BWH m	nain breakers are 25 kA rated.	Warranty	10 years		

Environmental Specifications


Operating Temperature	-20°C to 50°C (-4°F to 122°F)
Operating Humidity (RH)	Up to 100%, condensing
Maximum Elevation	3000 m (9843 ft)
Environment	Indoor and outdoor rated
Enclosure Type	NEMA 3R

Compliance **Information**

Certifications	UL 67, UL 869A, UL 916, UL 1741 PCS, CSA 22.2 107.1, CSA 22.2 29
Emissions	FCC Part 15, Class B, ICES 003

Mechanical **Specifications**

Dimensions	660 x 411 x 149 mm (26 x 16 x 6 in) 16.3 kg (36 lb)	
Weight		
Mounting options	Wall mount	

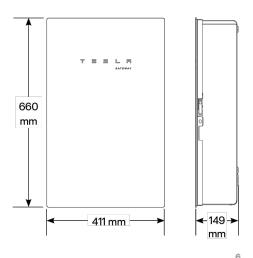

yes solar solutions

202 NORTH DIXON AVENUE, **CARY, NC 27513 USA** PHONE: 919-804-1490 LICENSE: 67356

VERSION				
DESCRIPTION	DATE	REV		
INITIAL RELEASE	10/01/2024	UR		

PROJECT NAME

KASPER, KAREN 494 HOBSON RD, DUNN, NC 28334, USA APN# 021518013202 AHJ: HARNETT COUNTY UTILITY: N/A

SHEET NAME

SPEC SHEETS

SHEET SIZE ANSI B 11" X 17"

SHEET NUMBER PV-6

Powerwall 3 Datasheet