

76 North Meadowbrook Drive Alpine, UT 84004 office (201) 874-3483 swyssling@wysslingconsulting.com

July 27, 2022

Legacy Solar 3333 Digital Drive #600 Lehi, UT 84043

Re: Engineering Services
Calvacamp Residence
1005 Clarendon Street, Durham NC
7.040 kW System

To Whom It May Concern:

We have received information regarding solar panel installation on the roof of the above referenced structure. Our evaluation of the structure is to verify the existing capacity of the roof system and its ability to support the additional loads imposed by the proposed solar system.

A. Site Assessment Information

- 1. Site visit documentation identifying attic information including size and spacing of framing for the existing roof structure.
- Design drawings of the proposed system including a site plan, roof plan and connection details for the solar panels. This information will be utilized for approval and construction of the proposed system.

B. Description of Structure:

Roof Framing: 2x4 dimensional lumber at 24" on center with purlin supports at midspan.

Roof Material: Composite Asphalt Shingles

Roof Slope: 30 degrees
Attic Access: Accessible
Foundation: Permanent

C. Loading Criteria Used

- Dead Load
 - Existing Roofing and framing = 7 psf
 - New Solar Panels and Racking = 3 psf
 - TOTAL = 10 PSF
- Live Load = 20 psf (reducible) 0 psf at locations of solar panels
- Ground Snow Load = 15 psf
- Wind Load based on ASCE 7-10
 - Ultimate Wind Speed = 115 mph (based on Risk Category II)
 - Exposure Category C

Analysis performed of the existing roof structure utilizing the above loading criteria is in accordance with the North Carolina Residential Code (2015 IRC), including provisions allowing existing structures to not require strengthening if the new loads do not exceed existing design loads by 105% for gravity elements and 110% for seismic elements. This analysis indicates that the existing framing will support the additional panel loading without damage, if installed correctly.

D. Solar Panel Anchorage

1. The solar panels shall be mounted in accordance with the most recent Unirac installation manual. If during solar panel installation, the roof framing members appear unstable or deflect non-uniformly, our office should be notified before proceeding with the installation.

2. Connection on the roof is utilizing (4) ½" or #14 screws into the existing decking to resist uplift forces. Contractor to verify installation to be performed in accordance with the Unirac recommendations. Pull out values per screw are based on National Design Specification values for CDX plywood and are identified as 208 lbs/inch. Based on ½" sheathing the value per screw would be 104 lbs providing 416 lbs uplift resistance per attachment.

3. Considering the wind speed, roof slopes, size and spacing of framing members, and condition of

the roof, the panel supports shall be placed no greater than 60" on center.

4. Panel supports connections shall be staggered to distribute load to adjacent framing members.

Based on the above evaluation, this office certifies that with the racking and mounting specified, the existing roof system will adequately support the additional loading imposed by the solar system. This evaluation is in conformance with the North Carolina Residential Code, current industry standards, and is based on information supplied to us at the time of this report.

Should you have any questions regarding the above or if you require further information do not hesitate to contact me.

C. Vyse

Scott E. Wyssling, PE North Carolina License 3. 46546



Wyssling Consulting, PLLC 76 N Meadowbrook Drive Alpine UT 84004 North Carolina COA # P-2308

Signed 7/27/2022

THIS PLAN HAS BEEN ELECTRONICALLY SIGNED AND SEALED BY SCOTT WYSSLING, PE USING A DIGITAL SIGNATURE AND DATE. PRINTED COPIES OF THIS DOCUMENT ARE NOT CONSIDERED SIGNED AND SEALED AND THE SIGNATURE MUST BE VERIFIED ON ANY ELECTRONIC COPIES.



SCOPE OF WORK:

TO INSTALL A ROOF MOUNTED SOLAR PHOTOVOLTAIC SYSTEM AT THE OWNER RESIDENCE LOCATED AT 1005 CLARENDON ST, DURHAM, NC 27705, USA.

THE POWER GENERATED BY THE PV SYSTEM WILL BE INTERCONNECTED WITH THE UTILITY GRID THROUGH THE EXISTING ELECTRICAL SERVICE EQUIPMENT.

THE PV SYSTEM DOES NOT INCLUDE STORAGE BATTERIES.

EQUIPMENT SUMMARY

16 APTOS DNA-120-MF10-440W MODULES

16 ENPHASE IQ8PLUS -72-2-US (240V) MICROINVERTERS

GENERAL NOTES

- THESE CONSTRUCTION DOCUMENTS HAVE BEEN BASED ON FIELD INSPECTIONS AND OTHER INFORMATION AVAILABLE AT THE TIME, ACTUAL FIELD CONDITIONS MAY REQUIRE MODIFICATIONS IN CONSTRUCTION DETAILS.
- ARCHITECT HAS NOT BEEN RETAINED TO SUPERVISE ANY CONSTRUCTION OR INSTALLATION OF ANY EQUIPMENT AT SITE.
- CONTRACTOR SHALL FURNISH ALL LABOR, MATERIAL, EQUIPMENT, TOOLS, OBTAINS ALL PERMITS, LICENSES AND PAY ALL REQUIRED FEES AND COMPLETE INSTALLATION.
- CONTRACTOR HAS THE FULL RESPONSIBILITY TO CHECK AND VERIFY ALL DIMENSIONS AND EXISTING CONDITIONS. ANY DISCREPANCIES SHALL BE REPORTED TO THE ENGINEER BEFORE PROCEEDING WITH THE WORK. ANY WORK STARTED BEFORE CONSULTATION AND ACCEPTANCE BY THE ENGINEER SHALL BE THE SOLE RESPONSIBILITY OF THE CONTRACTOR AND SHALL BE SUBJECT TO CORRECTION BY THEM WITHOUT ADDITIONAL COMPENSATION.
- DAMAGE CAUSED TO THE EXISTING STRUCTURE, PIPES, DUCTS, WINDOWS, WALL, FLOORS, ETC. SHALL BE REPAIRED TO THE ORIGINAL CONDITION OR REPLACED BY THE CONTRACTOR AT NO ADDITIONAL COST.
- THE CONTRACTOR SHALL BE HELD RESPONSIBLE FOR THE PROPER INSTALLATION AND COMPLETION OF THE WORK WITH APPROVED MATERIALS.
- NO CHANGES ARE TO BE MADE WITHOUT THE CONSULTATION AND APPROVAL OF THE ARCHITECT.
- CONTRACTOR SHALL OBTAIN BULDING PERMIT. NO WORK TO START UNLESS BUILDING PERMIT IS PROPERLY DISPLAYED.
- ALL WORKMANSHIP AND MATERIALS SHALL BE OF FIRST QUALITY AND IN COMPLIANCE WITH * THE REQUIREMENTS OF THE NORTH CAROLINA BUILDING CODE, THE DEPARTMENT OF ENVIRONMENTAL PROTECTION AND ALL PERTINENT AGENCIES.
- IT 1S ESSENTIAL THAT ALL WORK PROCEED WITH THE MAXIMUM COOPERATION OF ALL PARTIES AND WITH MINIMUM INTERFERENCE TO THE OCCUPANTS WITHIN THE BUILDING. THE OWNER'S DIRECTIONS IN THIS REGARD SHALL BE FULLY COMPLIED WITH.
- ALL EXPOSED PLUMBING, HVAC, ELECTRICAL DUCTWORK, PIPING AND CONDUITS ARE TO BE PAINTED BY GENERAL CONTRACTOR.
- THE CONTRACTOR SHALL PERFORM THE WORK IN STRICT CONFORMANCE WITH THE LOCAL LAWS, REGULATIONS AND THE NATIONAL ELECTRIC CODE.
- THE CONTRACTOR SHALL OBTAIN ALL PERMITS, APPROVALS, AFFIDAVITS, CERTIFICATIONS, ETC. AND PAY ALL FEES AS REQUIRED BY THE LOCAL AUTHORITIES.
- CONTRACTORS SHALL OBTAIN FIRE CERTIF. UPON COMPLETION OF WORK.

ELECTRICAL NOTES:

- ALL EQUIPMENT TO BE LISTED BY UL OR OTHER NRTL, AND LABELED FOR ITS APPLICATION.
- ALL CONDUCTORS SHALL BE COPPER, RATED FOR 600 V AND 90 DEGREE C WET ENVIRONMENT.
- WIRING, CONDUIT, AND RACEWAYS MOUNTED ON ROOFTOPS SHALL BE ROUTED DIRECTLY TO, AND LOCATED AS CLOSE AS POSSIBLE TO THE NEAREST RIDGE, HIP, OR VALLEY.
- WORKING CLEARANCES AROUND ALL NEW AND EXISTING ELECTRICAL EQUIPMENT SHALL COMPLY WITH NEC 110.26.
- WHERE SIZES OF JUNCTION BOXES, RACEWAYS, AND CONDUITS ARE NOT SPECIFIED, THE CONTRACTOR SHALL SIZE THEM ACCORDINGLY.
- ALL WIRE TERMINATIONS SHALL BE APPROPRIATELY LABELED AND READILY VISIBLE.
- MODULE GROUNDING CLIPS TO BE INSTALLED BETWEEN MODULE FRAME AND MODULE SUPPORT RAIL, PER THE GROUNDING CLIP MANUFACTURERS INSTRUCTION.
- MODULE SUPPORT RAIL SHALL BE BONDED TO THE MODULE

GOVERNING CODES

2018 INTERNATIONAL FIRE CODE 2018 INTERNATIONAL BUILDING CODE 2018 INTERNATIONAL RESIDENTIAL CODE 2018 NORTH CAROLINA STATE BUILDING CODE 2020 NATIONAL ELECTRICAL CODE

AUTHORITY HAVING JURISDICTION (AHJ): DURHAM CITY

WIRING AND CONDUIT NOTES:

- ALL CONDUIT SIZES AND TYPES SHALL BE LISTED FOR ITS PURPOSE AND APPROVAL FOR THE SITE APPLICATIONS
- ALL PV CABLES AND HOMERUN WIRES BE #10AWG *USE-2, PV WIRE, OR PROPRIETARY SOLAR CABLING SPECIFIED BY MFR, OR EQUIVALENT; ROUTED TO SOURCE CIRCUIT COMBINER BOXES AS REQUIRED
- ALL PV DC CONDUCTORS IN CONDUIT EXPOSED TO SUNLIGHT SHALL BE DERATED ACCORDING TO AS PER LATEST NEC CODE.
- EXPOSED ROOF PV DC CONDUCTORS SHALL BE USE-2, 90°C RATED, WET AND UV RESISTANT, AND UL LISTED RATED FOR 600V, UV RATED SPIRAL WRAP SHALL BE USED TO PROTECT WIRE FROM SHARP EDGES
- PHASE AND NEUTRAL CONDUCTORS SHALL BE DUAL RATED THHN/THWN-2 INSULATED, 90°C RATED, WET AND UV RESISTANT, RATED FOR 1000V AS PER APPLICABLE NEC CODE
- 4-WIRE DELTA CONNECTED SYSTEMS HAVE THE PHASE WITH THE HIGHER VOLTAGE TO GROUND MARKED ORANGE OR IDENTIFIED BY OTHER EFFECTIVE **MEANS**
- ALL SOURCE CIRCUITS SHALL HAVE INDIVIDUAL SOURCE CIRCUIT PROTECTION
- VOLTAGE DROP LIMITED TO 2%
- AC CONDUCTORS >4AWG COLOR CODED OR MARKED: PHASE A OR L1- BLACK, PHASE B OR L2- RED, PHASE C OR L3- BLUE, NEUTRAL- WHITE/GRAY
- **VOLTAGE DROP LIMITED TO 2%**
- AC CONDUCTORS >4AWG COLOR CODED OR MARKED: PHASE AOR L1- BLACK, PHASE B OR L2- RED, PHASE C OR L3- BLUE, NEUTRAL- WHITE/GRAY


SYSTEM RATING 7.04 kWDC 4.64 kWAC

	SHEET INDEX					
PV-0	COVER PAGE					
PV-1 SITE PLAN						
PV-2 ROOF PLAN & MODULES						
PV-3-4	ATTACHMENT DETAILS					
PV-5	ELECTRICAL LINE & CALCS.					
PV-6	ELECTRICAL PHOTOS					
PV-7	SPECIFICATIONS & NOTES					
PV-8	LABELS					
PV-9 JOB HAZARD ANALYSIS						
PV-10+	EQUIPMENT SPECIFICATIONS					



HOUSE PHOTO PV-0

SCALE: NTS

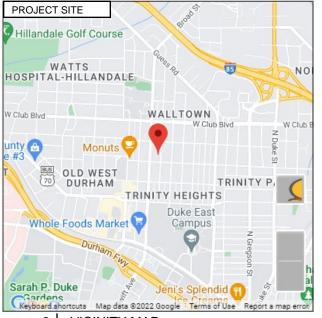

VICINITY MAP

PV-0

SCALE: NTS

4 LGCY POWER **LGCY POWER**

3333 DIGITAL DR#600, LEHI. UT 84043, UNITED STATES

PHONE: (855) 353-4899

Flectrical LIC#: U3487:

SYSTEM INFO

Wyssling Consulting, PLLC Meadowbrook Drive Alpine UT 84004 North Carolina COA # P-2308 \$igned 7/27/2022

TE WYSS

PROJECT NAME & ADDRES SIGNATURE MUST BE VERIFIED

CALVACAMP J., USA caroline.r.toney@gmail 234-2389 ST

(980)

PHONE

 $\overset{\dots}{\underline{\square}}$

CLARENDON S AM, NC 27705, I : DE SIDE CAROLINE RES DURHAM, 005

DATE: 7/27/2022

SHEET NAME **COVER PAGE**


SHEET SIZE


ANSI B 11" X 17'

SHEET NUMBER

SITE NOTES

- A LADDER SHALL BE IN PLACE FOR INSPECTION IN COMPLIANCE WITH OSHA REGULATIONS.
- THE PV MODULES ARE CONSIDERED NON-COMBUSTIBLE AND THIS SYSTEM IS AN UTILITY INTERACTIVE SYSTEM WITH NO STORAGE BATTERIES.
- THE SOLAR PV INSTALLATION SHALL NOT OBSTRUCT ANY PLUMBING, MECHANICAL, OR BUILDING ROOF VENTS.
- PROPER ACCESS AND WORKING CLEARANCE AROUND EXISTING AND PROPOSED ELECTRICAL EQUIPMENT WILL BE PROVIDED AS PER SECTION [NEC 110.26]

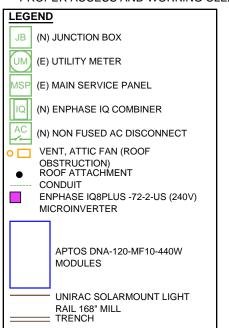

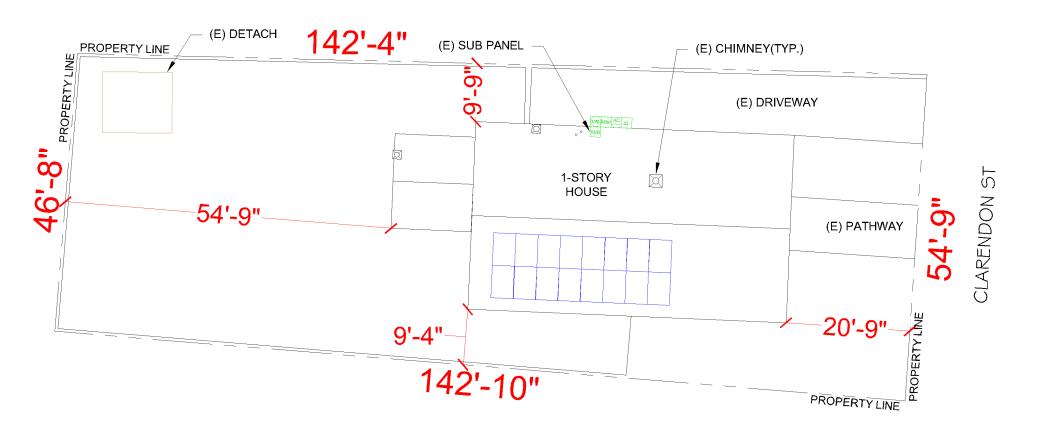



CAROLINE DE CALVACAMP 1005 CLARENDON ST, DURHAM, NC 27705, USA

DATE: 7/27/2022

EMAIL ID:

SHEET NAME SITE PLAN

SHEET SIZE

ANSI B 11" X 17"

SHEET NUMBER

DESIGN SPECIFICA	TION	INVERTER SPECIFICATIONS			
RISK CATEGORY:	Ш	MANUFACTURER /	ENPHASE IQ8PLUS -72-2-US		
CONSTRUCTION:	SFD	MODEL	(240V)		
ZONING:	RESIDENTIAL	MAX DC SHORT	15 A		
SNOW LOAD (ASCE7-10):	15 PSF	CIRCUIT CURRENT			
EXPOSURE CATEGORY:	С	CONTINUOUS OUTPUT CURRENT	1.21 A		
WIND SPEED (ASCE7-10):	115 MPH				

|--|

ROOF	ROOF TILT	AZIMUTH	RAFTER SIZE	RAFTER SPACING	ROOF MATERIAL
#1	30°	182°	2" x 4"	24" o.c.	COMP SHINGLE


	ARRAY AREA & ROOF AREA CALC's									
ROOF	# OF MODULES	ARRAY AREA (Sq. Ft.)								
#1	#1 16 371.69									
(TOTAL ARRAY AREA/TOTAL ROOF AREA) X 100%										

= (371.69/1889.24) X 100% = 19.68%

MODULE TYPE, DIMENSIONS & WEIGHT					
NUMBER OF MODULES:	16 MODULES				
MODULE TYPE:	APTOS DNA-120-MF10-440W				
MODULE WEIGHT:	52.9 LBS				
MODULE DIMENSIONS:	74.92" X 44.65" = 23.23 SF				
UNIT WEIGHT OF AREA:	2.28 PSF				

LEGEND JB (N) JUNCTION BOX (E) UTILITY METER (E) MAIN SERVICE PANEL (N) ENPHASE IQ COMBINER (N) NON FUSED AC DISCONNECT VENT, ATTIC FAN (ROOF OBSTRUCTION) ROOF ATTACHMENT CONDUIT ENPHASE IQ8PLUS -72-2-US (240V) MICROINVERTER APTOS DNA-120-MF10-440W UNIRAC SOLARMOUNT LIGHT RAIL 168" MILL TRENCH

PANEL HEIGHT OFF ROOF

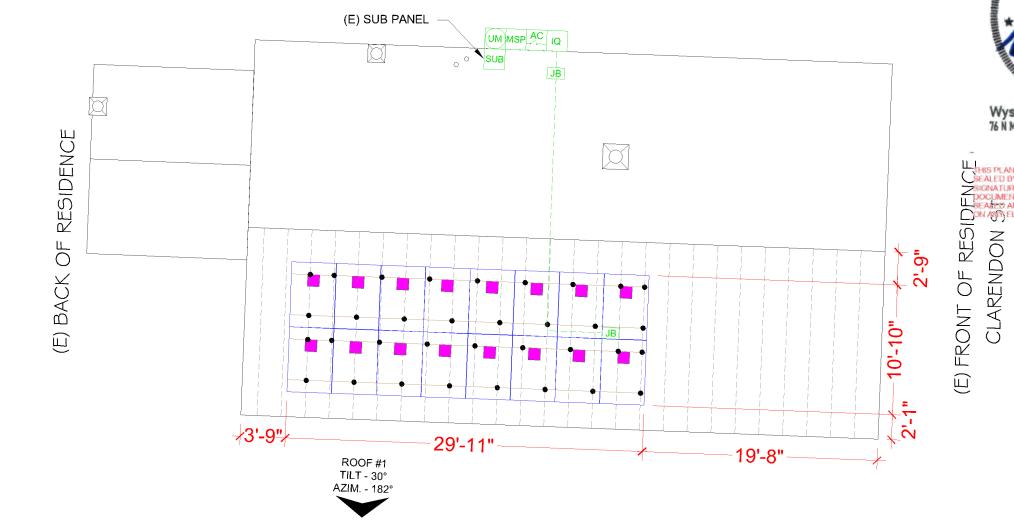

4 LGCY POWER **LGCY POWER** 3333 DIGITAL DR#600, LEHI, UT 84043, UNITED STATES PHONE: (855) 353-4899 Electrical LIC#: U34871 SYSTEM INFO (16) APTOS DNA-120-MF10-440W E. WYSS Wyssling Consulting, PLLC 76 N Meadowbrook Drive Alpine UT 84004 North Carolina COA # P-2308 \$igned 7/27/2022 PROJECT NAME & ADDRES PHONE NO. (980) 234-2389 EMAIL ID: caroline.r.toney@gmail.

CAROLINE DE CALVACAMP 1005 CLARENDON ST, DURHAM, NC 27705, USA

DATE: 7/27/2022


SHEET NAME

ROOF PLAN & MODULES


SHEET SIZE

ANSI B 11" X 17"

SHEET NUMBER

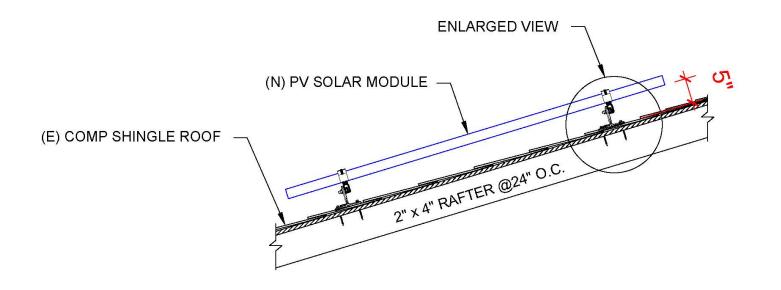

ATTACHMENT DETAILS

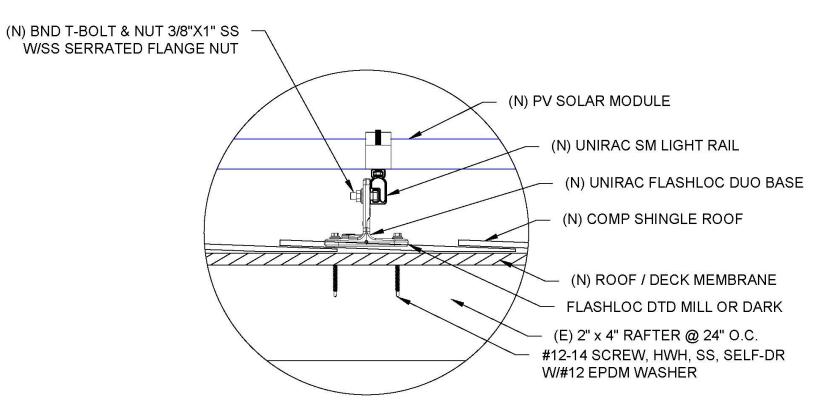

ENLARGED VIEW OF ATTACHMENT

SCALE: NTS

4 LGCY POWER

LGCY POWER

3333 DIGITAL DR#600, LEHI, UT 84043, UNITED STATES PHONE: (855) 353-4899



Electrical LIC#: U34871

SYSTEM INFO

E. WYSS

Wyssling Consulting, PLLC 76 N Meadowbrook Drive Alpine UT 84004 North Carolina COA # P-2308 \$igned 7/27/2022

DOCUMENT ARE SEALED AND JIH ON ANY ELECTR

RESIDENCE
1005 CLARENDON ST,
DURHAM, NC 27705, USA
PHONE NO. (980) 234-2389
EMAIL ID: caroline.r.toney@gmail.corrected

DATE: 7/27/2022


SHEET NAME

ATTACHMENT DETAILS

SHEET SIZE

ANSI B 11" X 17"

SHEET NUMBER

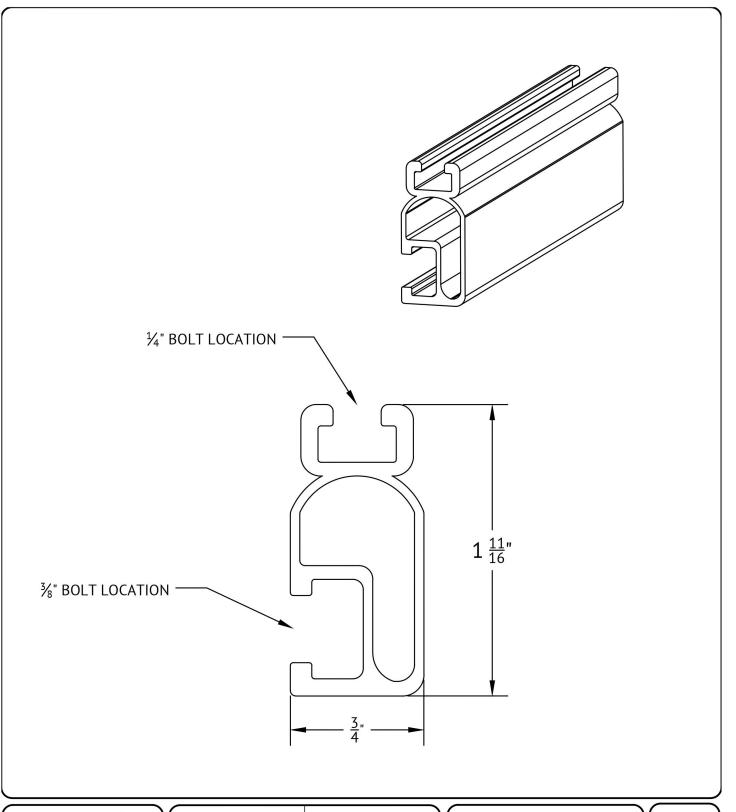

#UNIRAC

1411 BROADWAY BLVD NE ALBUQUERQUE, NM 87102 USA

WWW.UNIRAC.COM

PRODUCT LINE: SOLARMOUNT **DRAWING TYPE:** PART DETAIL LIGHT RAIL **DESCRIPTION: REVISION DATE:** APRIL 2016

DRAWING NOT TO SCALE ALL DIMENSIONS ARE NOMINAL

PRODUCT PROTECTED BY ONE OR MORE US PATENTS

LEGAL NOTICE

SM-P02

SHEET

4 LGCY POWER

LGCY POWER

3333 DIGITAL DR#600, LEHI, UT 84043, UNITED STATES PHONE: (855) 353-4899



Electrical LIC#: U34871

SYSTEM INFO

(16) APTOS DNA-120-MF10-440W

E. WYSS

Wyssling Consulting, PLLC 76 N Meadowbrook Drive Alpine UT 84004 North Carolina COA # P-2308 Signed 7/27/2022

CAROLINE DE CALVACAMPOS DE CALVACAMP

DATE: 7/27/2022

SHEET NAME

ATTACHMENT DETAILS

SHEET SIZE

ANSI B 11" X 17"

SHEET NUMBER


ID	TYPICAL	INITIAL CONDUCTOR LOCATION	FINAL CONDUCTOR LOCATION		CONDUCTOR		CONDUIT	# OF PARALLEL CIRCUITS	CURRENT-CARRYING CONDUCTORS IN CIRCUIT	CONDUIT FILL PERCENT	OCPD	E	GC	TEMP. FAC	CORR. CTOR	CONDUIT FILL FACTOR	CONT. CURRENT	MAX. CURRENT	BASE AMP.	DERATED AMP.	TERM. TEMP. RATING	LENGTH	VOTAGE DROP	4
1	2	ARRAY	JUNCTION BOX	12 AWG	Q CABLE	-	-	1	2	N/A	N/A	6 AWG	BARE COPPER	0.71	(56°C)	N/A	9.68A	12.1A	N/A	N/A	90°C	30FT	0.30%	╢
2	1	JUNCTION BOX	JUNCTION BOX 1	12-2 GAUGE	ROMEX	-	-	1	2	N/A	N/A	6 AWG	BARE COPPER	0.71	(56°C)	N/A	9.68A	12.1A	N/A	N/A	90°C	26FT	0.30%	333: UT
3	1	JUNCTION BOX 1	IQ COMBINER BOX	10 AWG	THWN 2	COPPER	MIN 0.75" DIA EMT"	2	4	24.20%	20A	10 AWG	THWN-2 COPPER	0.96	(34°C)	0.8	9.68A	12.1A	40A	30.72A	90°C	12FT	0.12%	∭ F
4	1	IQ COMBINER BOX	NON FUSED AC DISCONNECT	10 AWG	THWN 2	COPPER	MIN 0.75" DIA EMT"	1	3	20.45%	N/A	10 AWG	THWN-2 COPPER	0.96	(34°C)	1	19.36A	24.2A	40A	38.40A	90°C	5FT	0.10%	
5	1	NON FUSED AC DISCONNECT	MSP	10 AWG	THWN 2	COPPER	MIN 0.75" DIA EMT"	1	3	20.45%	30A	10 AWG	THWN-2 COPPER	0.96	(34°C)	1	19.36A	24.2A	40A	38.40A	90°C	5FT	0.10%	<u> </u>

LGCY POWER

LGCY POWER

333 DIGITAL DR#600, LEHI, UT 84043, UNITED STATES PHONE: (855) 353-4899

Electrical LIC#: U34871

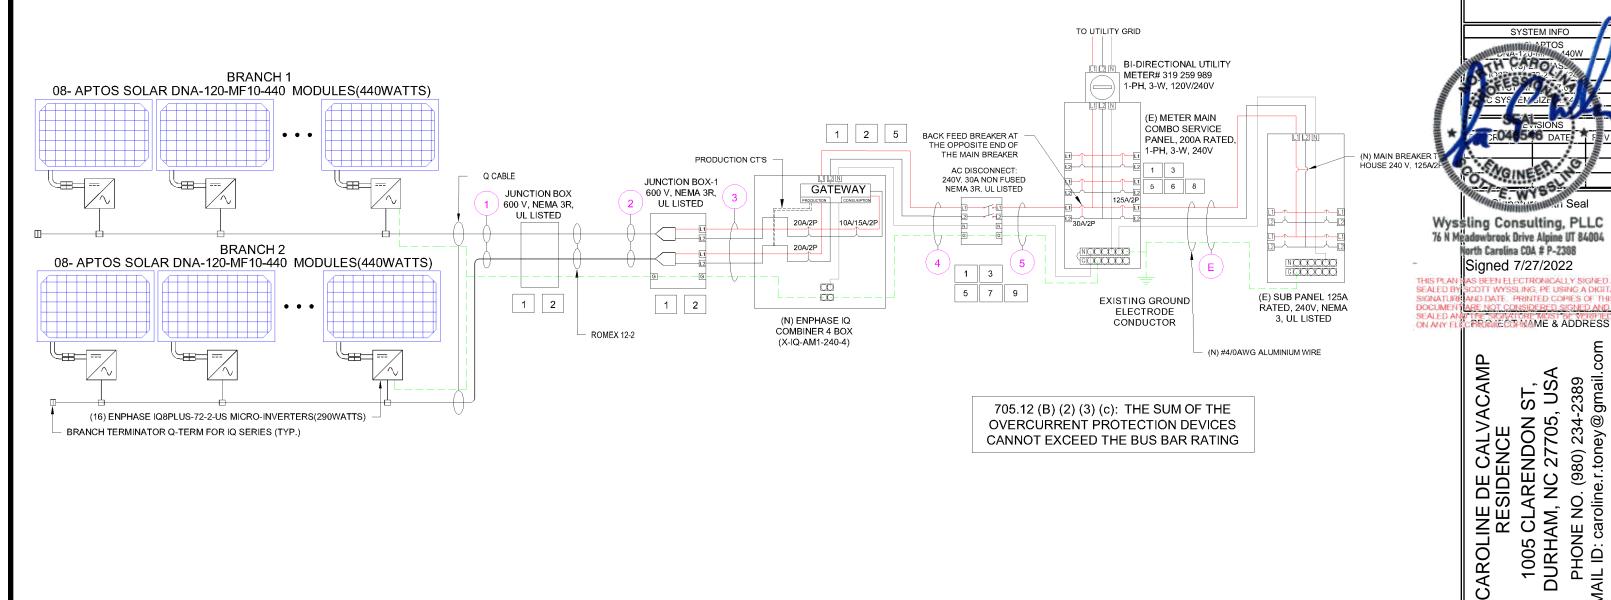

SERVICE INFO					
UTILITY PROVIDER:	DUKE ENERGY				
AHJ NAME:	DURHAM CITY				
MAIN SERVICE VOLTAGE:	240V				
MAIN PANEL BRAND:	SIEMENS				
MAIN SERVICE PANEL:	200A				
MAIN SERVICE LOCATION:	NORTH				
SERVICE FEED SOURCE:	OVERHEAD				

DATE: 7/27/2022

PHONE NO. (980) 234-2389 EMAIL ID: caroline.r.toney@gmail.

SHEET NAME

ELECTRICAL LINE & CALCS.

SHEET SIZE

ANSI B 11" X 17"

SHEET NUMBER

PV-5

SCALE: NTS

SIEMENS

Rainproof Combination Metering

MC0606L1200R

Type 3R

Panelboard Risting 300 Amps Max 100 480 V AC 1 Phase, 3 Wire 2001/120 V AC 1 Phase, 3 Wire 2001/120 V AC 1 Phase, 3 Wire (Derived from 3 phase - 4 wire system) Maker Socker Rating 300 Amps - Centinuous 300 Amos Continuous OVERHEAD AND UNDERGROUND

Suitable For Use Only As Service Equipment

Line Terminals A and B have wire connectors installed for overhead and underground.

Use Copper or Aluminum Wire

Line Terminals A. B. and N. Switcher for 60 into C. Conductors Wire Size #4 AWG-250 kcmill Terous Terminals to 250 Lb. less

Neutral Bar Wire Size
Suitable for 60 (75 C Conductive
Small Terremete
14 10 AW0 20 Lib Ins.
8 AW0 25 Lib Ins.
6 AWG 36 Lib Ins.

6 AWG 20 Lb Pres
Large Terminals:
14 10 AWG 25 Lb Pres
8 AWG 40 Lb - Pres
4 1/6 AWG 65 Lb - Pres
4 1/6 AWG 65 Lb - Pres

Ander to Blassin Breater markings for whe size rating and trouve Blanch Breater Terminals Suitable for 60/75° Conductors. Left view suitable for 604 breakers with CU wire. 504 breakers with CU wire. 504 breakers with CU wire and accessory left ECLKO.

All unused neutral branch terminals can be used as equipment glowering were terminals. These terminals can be described by the green or bare grounding wire and wit accept the wire state lated under "Equipment Ground Bar Terminals".

Ground Bot Terminals
Accessories
Files Place Cat. No. GPS or ECOPS
2016 44 wire range lug let. ECIA2
Str. Jaw Assembly. ECS/2
Mechanical Beating Institute Cognition
Wester Social Jumpse ECO
Equipment Ground Bot Terminals to
Tighten Equipment Ground Bot Terminals to
the forcus shown below for the wire installed Ground Bar Wille Size Ine #14.#4 AWG or Two or Three #14.#10 AWG

Aluminam One #12:#4 AWG or Two or Three #12:#10 AWG

If a RX Hub is required on Top End War the cetalog riss labed belowing to used on this enclosure 1.14" EC38697 1.10" EC38500 EC38500 2107


if a HC Huk is required on the bottom end wall, the cetaing has liked below flay be used on this enclosure.

2.12 3 ECHC200 ECHC200

General Information.
Remove twistbulk from tirm only where breakers, will be installed. All openings must be filled with breakers or filter plates. Orbut treaker overload top position is indicated by hardle position is mid-cated by hardle position midway between CN and OFF. To reset, move handle to OFF position then have CN.

For installation by a qualified person in accordance with all local electrical codes and/or the National Electrical Codes and/or the National Electrical Codes are getered hademark of the National Five Protection Association 6 2010 COMMICH Seemens industry, no. DNA 68310866

DH1 49310845

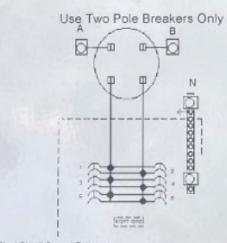

Short Circuit Current Rating (Wathout Meter not included in short circuit current rating). This perelosed has a maximum short circuit rating of 10,000 RMD symmetrical emperes 240 volts maximum. Any product beginning the placed or added in this panelosed must be manufact and by Sierriens and must be disherent short beginning to the perelose of the types listed below.

BRANCH BREAKER	THE MAXIMUM SHORT COURT QUENERY PLYTING IN RVS SYMMETRICAL ASPERES 120290- IS
OF OFH OFHE HOP OAF. OAFH OPE ON R	10,000

WARNING:


This equipment has been designed for use only with circuit breakers lasted above. Use of other discust breakers in this equipment could less if in personal injury of properly damps and will void the

IMPORTANT:

Do not allow petroleum based (hydrocenton) sprays, chemicals, solvents or any paint to contact interior components. Petroleum based of emicals can be selve addition of electrical insulating materials.

© 2010 COPYRIGHT Siemens Industry Inc.

DH1

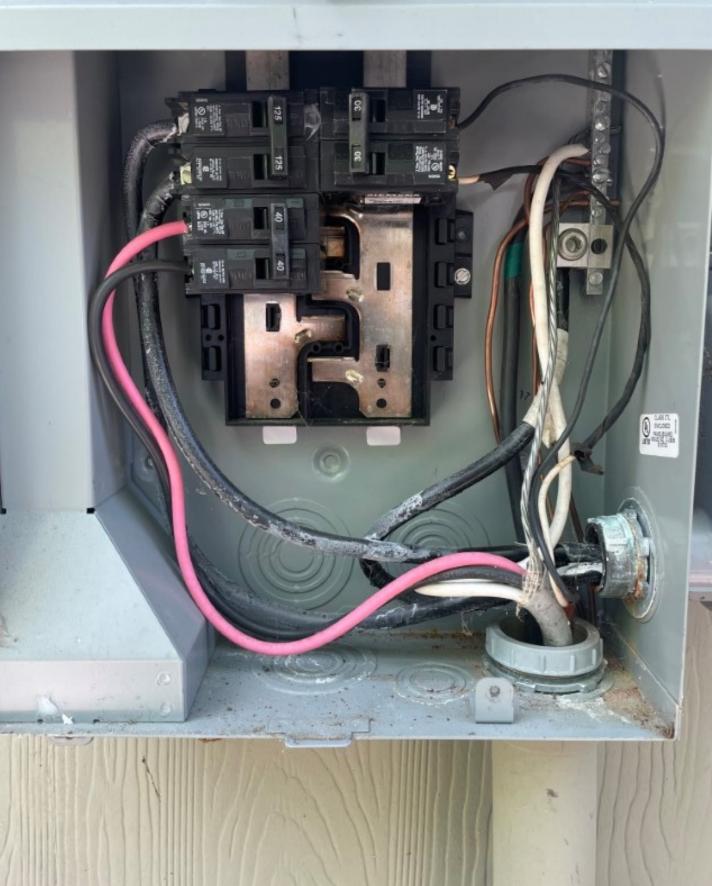



LGCY POWER

3333 DIGITAL DR#600, LEHI. UT 84043, UNITED STATES PHONE: (855) 353-4899



Electrical LIC#: U34871

SYSTEM INFO	
(16) APTOS DNA-120-MF10-440W	
(16) ENPHASE IQ8PLUS -72-2-US (240V)	
DC SYSTEM SIZE: 7.04 kWDC	_
AC SYSTEM SIZE: 4.64 kWAC	_
	_

REVISIONS					
SCRIPTION	DATE	REV			

Signature with Seal

PROJECT NAME & ADDRESS

CAROLINE DE CALVACAMP RESIDENCE 1005 CLARENDON ST, DURHAM, NC 27705, USA PHONE NO. (980) 234-2389 EMAIL ID: caroline.r.toney@gmail.

DATE: 7/27/2022

SHEET NAME

ELECTRICAL PHOTOS

SHEET SIZE

ANSI B 11" X 17"

SHEET NUMBER

SOLAR MODULE SPECIFICATIONS						
APTOS DNA-120-MF10-440W						
33.82 V						
13.01 A						
40.8 V						
13.61 A						
-0.31%/K						
406 W						
74.92"(L) x 44.65"(W)						
440 W						

INVERTER SPECIFICATIONS		
MANUFACTURER / MODEL ENPHASE IQ8PLUS -72-2-US (240V)		
MAX DC SHORT CIRCUIT CURRENT	15 A	
CONTINUOUS OUTPUT CURRENT	1.21 A	

AMBIENT TEMPERATURE SPECS		
RECORD LOW TEMP	-12°C	
AMBIENT TEMP (HIGH TEMP 2%)	34°C	
CONDUIT HEIGHT	7/8"	
ROOF TOP TEMP	90°C	
CONDUCTOR TEMPERATURE RATE	56°C	
MODULE TEMPERATURE COEFFICIENT OF VOC	-0.31%/K	

PERCENT OF VALUES	NUMBER OF CURRENT CARRYING CONDUCTORS IN EMT
0.80	4-6
0.70	7-9
0.50	10-20

Voltage rise in Q Cable from the Microinverters to the Junction Box

For branch circuit #1 of 8 IQ 8+ Micros, the voltage rise on the 240 VAC Q Cable is 0.30% For branch circuit #2 of 8 IQ 8+ Micros, the voltage rise on the 240 VAC Q Cable is 0.30%

Voltage rise from the Junction Box 1 to the IQ Combiner Box

VRise = (amps/inverter x number of inverters) x (resistance in ohms/ft.) x (2-way wire length in ft.)

- $= (1.21 \text{ amp x 8}) \times (0.00129 \text{ ohms/ft}) \times (12 \text{ ft x 2})$
- $= 9.68 \text{ amps } \times 0.00129 \text{ ohms/ft}) \times 24 \text{ ft}$
- = 0.30 volts

 $%VRise = 0.30 \text{ volts} \div 240 \text{ volts} = 0.12\%$

The voltage rise from the Junction Box 1 to the IQ Combiner Box is 0.12%

Voltage rise from the IQ Combiner Box to the Non Fused AC Disconnect

VRise = (amps/inverter x number of inverters) x (resistance in ohms/ft.) x (2-way wire length in ft.)

- $= (1.21 \text{ amp x } 16) \times (0.00129 \text{ ohms/ft}) \times (5 \text{ ft x } 2)$
- $= 19.36 \text{ amps } \times 0.00129 \text{ ohms/ft} \times 10 \text{ ft}$
- = 0.25 volts

 $%VRise = 0.25 \text{ volts} \div 240 \text{ volts} = 0.10\%$

The voltage rise from the IQ Combiner Box to the Non Fused AC Disconnect is 0.10%

Voltage rise from the Non Fused AC Disconnect to the MSP

VRise = (amps/inverter x number of inverters) x (resistance in ohms/ft.) x (2-way wire length in ft.)

- = (1.21 amp x 16) x (0.00129 ohms/ft) x (5 ft x 2)
- $= 19.36 \text{ amps } \times 0.00129 \text{ ohms/ft}) \times 10 \text{ ft}$
- = 0.25 volts

 $%VRise = 0.25 \text{ volts} \div 240 \text{ volts} = 0.10\%$

The voltage rise from the Non Fused AC Disconnect to the MSP is 0.10%

Total system voltage rise for all wire sections

0.3% + 0.12% + 0.1% + 0.1% = 0.62%

4 LGCY POWER

LGCY POW

3333 DIGITAL DR#600, LEHI, UT 84043, UNITED STATES PHONE: (855) 353-4899



Electrical LIC#: U348

SYSTEM INFO	
(16) APTOS DNA-120-MF10-440W	
(16) ENPHASE IQ8PLUS -72-2-US (240V)	
DC SYSTEM SIZE: 7.04 kWDC	
AC SYSTEM SIZE: 4.64 kWAC	

REVISIONS			
DESCRIPTION DATE REV			

Signature with Seal

PROJECT NAME & ADDRESS

CAROLINE DE CALVACAMP RESIDENCE 1005 CLARENDON ST, DURHAM, NC 27705, USA

DATE: 7/27/2022

SHEET NAME

SPECIFICATIONS & NOTES

SHEET SIZE

ANSI B 11" X 17"

SHEET NUMBER

TERMINALS ON BOTH LINE AND LOAD SIDES MAY BE ENERGIZED IN THE OPEN POSITION

LABEL LOCATION:

MAIN SERVICE PANEL/AC DISCONNECT/AC COMBINER (PER CODE: NEC 706.15(C)(4), 690.13(B), NEC2020)

WARNING PHOTOVOLTAIC POWER SOURCE

LABEL LOCATION:

DC CONDUIT

EVERY 10' AND ON CONDUIT BODIES WHEN EXPOSED (PER CODE: NEC2020 690.31(O)(2), 690.31(D)(2), NEC2020)

PHOTOVOLTAIC AC DISCONNECT RATED AC OUTPUT CURRENT 19.36 A NOMINAL OPERATING AC VOLTAGE 240 VAC

LABEL LOCATION:

MAIN SERVICE PANEL/AC DISCONNECT 690.54, NEC2020

RAPID SHUTDOWN SWITCH FOR SOLAR PV SYSTEM

LABEL LOCATION:

INVERTER AT OR WITHIN 3' OF THE DC COMBINER SWITCH

PER CODE: NEC 690.56(C)(2), NEC2020

5

CAUTION

DUAL POWER SOURCE SECOND SOURCE IS PHOTOVOLTAIC SYSTEM

LABEL LOCATION:


MAIN SERVICE PANEL/AC DISCONNECT/AC COMBINER/REVENUE METER 2020 NEC 705.12(C) & NEC 690.59

ADHESIVE FASTENED SIGNS:

- ANSI Z535.4-2011 PRODUCT SAFETY SIGNS AND LABELS, PROVIDES GUIDELINES FOR SUITABLE FONT SIZES, WORDS, COLORS, SYMBOLS, AND LOCATION REQUIREMENTS FOR LABELS. NEC 110.21(B)(1)
- THE LABEL SHALL BE OF SUFFICIENT DURABILITY TO WITHSTAND THE ENVIRONMENT INVOLVED. NEC 110.21(B)(3)
- ADHESIVE FASTENED SIGNS MAY BE ACCEPTABLE IF PROPERLY ADHERED. VINYL SIGNS SHALL BE WEATHER RESISTANT.

SOLAR PV SYSTEM EQUIPPED 6 WITH RAPID SHUTDOWN

> TURN RAPID SHUTDOWN SWITCH TO THE 'OFF' POSITION TO SHUT DOWN PV SYSTEM AND REDUCE SHOCK HAZARD IN THE ARRAY

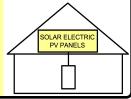

MAIN SERVICE PANEL
IF MSD IS OUTSIDE PLACE IT THERE / IF
MSD IS INSIDE PLACE ON THE AC DISCONNECT
PER CODE: IFC 605.11.3.1(1) & NEC 690.56(C), NEC2020

7

PHOTOVOLTAIC SYSTEM UTILITY DISCONNECT SWITCH

LABEL LOCATION: AC DISCONNECT 2020 NEC 690.13(B)

8

PV SOLAR BREAKER


DO NOT RELOCATE THIS **OVERCURRENT DEVICE**

LABEL LOCATION:

MAIN SERVICE PANEL 2020 NEC 705.12 (B)(3)(2) 9

LABEL LOCATION: AC DISCONNECT 2020 NEC 230.66



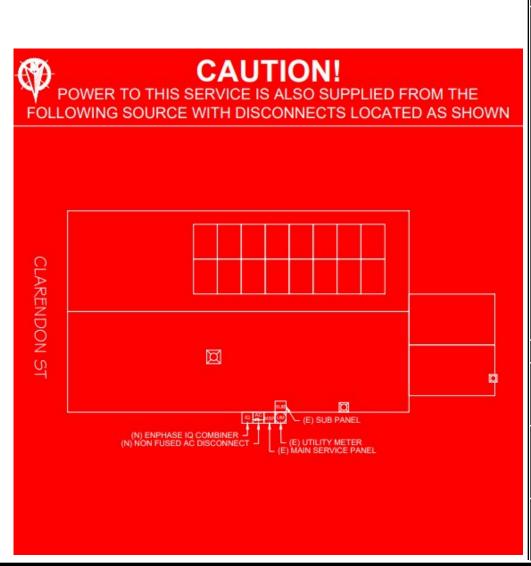



LGCY POWER

3333 DIGITAL DR#600. LEHI. UT 84043, UNITED STATES PHONE: (855) 353-4899



Electrical LIC#: U34871

(16) APTOS DNA-120-MF10-440W (16) ENPHASE DC SYSTEM SIZE: 7.04 kWDC AC SYSTEM SIZE: 4.64 kWAC REVISIONS

SYSTEM INFO

DESCRIPTION DATE

Signature with Seal

PROJECT NAME & ADDRESS

CAROLINE DE CALVACAMP RESIDENCE 1005 CLARENDON ST, DURHAM, NC 27705, USA PHONE NO. (980) 234-2389 IL ID: caroline.r.toney@gmail. EMAIL ID:

DATE: 7/27/2022

SHEET NAME **LABELS**

SHEET SIZE

ANSI B 11" X 17'

SHEET NUMBER



FIELD DESIGN REQUEST FORM

JOB INFORMATION	
JOB NAME:	
ADDRESS:	

WHO AUTHORIZED THE CHANGE: DESCRIBE THE NEEDED CHANGE & WHY: NEW DESIGN LAYOUT: DRAW THE MOUNTING PLANE SHOWING THE NEW MODULE LAYOUT: INSTALLER NAME (PRINT) I UNDERSTAND AND AGREE TO THE CHANGES MADE ABOVE CUSTOMER NAME CUSTOMER NAME CUSTOMER NAME CUSTOMER SIGNATURE DATE	CHANGE REQUEST:				
NEW DESIGN LAYOUT: DRAW THE MOUNTING PLANE SHOWING THE NEW MODULE LAYOUT: INSTALLER NAME (PRINT) I UNDERSTAND AND AGREE TO THE CHANGES MADE ABOVE	WHO AUTHORIZED THE CHANGE:	WHO AUTHORIZED THE CHANGE:			
INSTALLER NAME (PRINT) I UNDERSTAND AND AGREE TO THE CHANGES MADE ABOVE	DESCRIBE THE NEEDED CHANGE & WHY:				
INSTALLER NAME (PRINT) I UNDERSTAND AND AGREE TO THE CHANGES MADE ABOVE	NEW DESIGN LAYOUT:				
I UNDERSTAND AND AGREE TO THE CHANGES MADE ABOVE	DRAW THE MOUNTING PLANE SHOWING T	THE NEW MODULE LAYOUT:			
I UNDERSTAND AND AGREE TO THE CHANGES MADE ABOVE					
I UNDERSTAND AND AGREE TO THE CHANGES MADE ABOVE					
	INSTALLER NAME (PRINT)				
CUSTOMER NAME CUSTOMER SIGNATURE DATE	I UNDERSTAND AND AGREE TO THE CHANGES MADE ABOVE				
CUSTOMER NAME CUSTOMER SIGNATURE DATE					
CUSTOMER NAME CUSTOMER SIGNATURE DATE					
CUSTOMER NAME CUSTOMER SIGNATURE DATE					
CUSTOMER NAME CUSTOMER SIGNATURE DATE					
	CUSTOMER NAME	CUSTOMER SIGNATURE	DATE		



JOB HAZARD ANALYSIS

CUSTOMER NAME/JOB ID:					
CUSTOMER ADDRESS:					
INSTALL DATE:		TIME:	:am/pm		

HAZARD CATEGORY	HAZARD TYPE	HAZARD CONTROL MEASURES
LADDER SAFETY	LOCATION CONDITION WORKING CLEARANCE	
FALL PROTECTION	WORKING 6' OR HIGHER	
ELECTRICAL SAFETY	ARCH FLASH ELECTRIC SHOCK/ELECTROCUTION	
WEATHER CONDITIONS	HEAT/COLD TEMP RAINY/ICY/WINDY	
PUBLIC SAFETY	WORK/OBJECTS OVERHEAD SLIPS/TRIPS/FALLS ACCESS TO LIVE ELECTRICAL	

NEAREST EMERGENCY FACILITY	
CONTACT IMMEDIATELY IN EMERGENCY (911 AND/OR)	

GENERAL SITE DESCRIPTION/NOTES

GENERAL SITE DESCRIPTION/NOTES		
	I	
	I	
CREW MEMBERS ON SITE FOR INSTALL

NAME	SIGNATURE
FMU/LMD-	

ELECTRICAL COMPLETION PHOTOS QR CODE



ROOFTOP INSTALLATION PHOTOS QR CODE



MPU COMPLETION PHOTOS QR CODE



4 LGCY POWER

LGCY POWER

3333 DIGITAL DR#600, LEHI, UT 84043, UNITED STATES PHONE: (855) 353-4899

Les Holy

Electrical LIC#: U34871

	SYSTEM INFO	
	(16) APTOS DNA-120-MF10-440W	
IC	(16) ENPHASE Q8PLUS -72-2-US (240V)	
DC	SYSTEM SIZE: 7.04 kWDC	
AC	SYSTEM SIZE: 4.64 kWAC	

REVISIONS				
DESCRIPTION	DATE	REV		

Signature with Seal

PROJECT NAME & ADDRESS

CAROLINE DE CALVACAMP RESIDENCE 1005 CLARENDON ST, DURHAM, NC 27705, USA

PHONE NO. (980) 234-2389 EMAIL ID: caroline.r.toney@gmail.com

DATE: 7/27/2022

SHEET NAME

JOB HAZARD ANALYSIS

SHEET SIZE

ANSI B 11" X 17"

SHEET NUMBER

Solar for Innovators


Residential | Commercia



Designed & Engineered in Silicon Valley 440W | 435W | 430W

Our DNA Split Cell Series uses advanced selective emitter PERC technology with thin film layers to improve heat tolerance, increase photon capture, minimize resistive loss, and use 5% more of the available active area for optimal power performance. Our panels exceed IEC standards and come with an industry leading, 30-year warranty.

Linear Performance Warranty

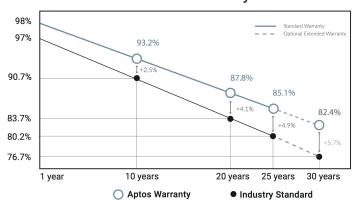

Features



Advanced Technology

Patented DNA[™] technology boosts power performance & module efficiency



Maximum Panel Density

Advanced split cell technology with 9 ultra-thin busbars allows for less resistance and more photon capture



Durable Design

Robust product design is resilient in extreme weather. Up to 5400 Pa snow load and 5400 Pa wind load




A Safe Investment

Industry leading 30 year warranty



3140 De La Cruz Blvd., Ste 200 Santa Clara, CA 95054 www.aptossolar.com | info@aptossolar.com

DN4TM 120

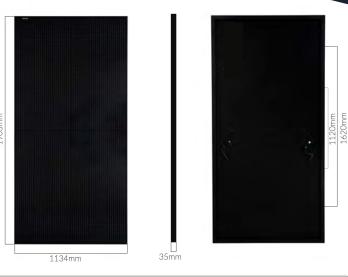


Electrical Specifications	DNA-120-MF10-440W	DNA-120-MF10-445W	DNA-120-MF10-440W
STCrated Output P _{mpp} (W)	440W	445W	450W
Module Efficiency	20.39%	20.62%	20.85%
Open Circuit Voltage V_{VOC} (V)	40.80	41.10	41.34
Short Circuit Current I_{SC} (A)	13.61	13.70	13.80
Rated Voltage V _{mmp} (V)	33.82	34.02	34.16
Rated Voltage I _{maz} (A)	13.01	13.09	13.17
Standard Test Conditions for front-face of panel: 1000 W.	/m², 25°C, measurement und	certainty <3%	


Temperature Coefficients	
Temperature Coefficients P _{mmp}	-0.35%/°C
Temperature Coefficients I _{sc}	+0.06%/°C
Temperature Coefficients $V_{\rm OC}$	-0.31%/°C
Nominal Operating Cell Temperature (NOCT)	45°C

	Test Operating Conditions	
	Maximum Series Fuse	25A
	Maximum System Voltage	1,500 VDC (UL&IEC)
	Maximum Load Capacity (Per UL 1703)	5400 PA Snow Load / 5400 Pa Wind Load
	Fire Performance Class	Class C/Type 1
(

Packaging Configuration	
Number of Modules per Pallet	31
Number of Pallets per 40ft. Container	24
Pallet Dimensions	2030 X 1220 X 1200
Pallet Weight (kg)	766
Container Weight (kg)	18,384

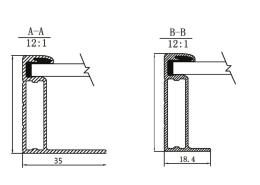

Mechanica	l Properties	
Cell Type	Monocrystalline	
Glass	3.2mm, anti-reflection coating, high transmission, low iron, tempered glass	
Frame	Anodized Aluminum Alloy	
Junction Box	IP68	
Dimensions	1903 X 1134 X 35 mm	
Output Cable	4mm2 (EU)12AWG,39.37in.(1200mm)	
Weight	52.9lbs.(24kg)	
Cable Length	1200mm	
Encapsulant	POE	,

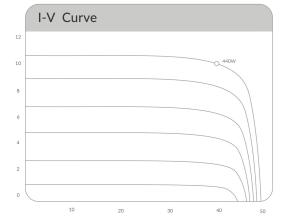





LGCY POWER

LGCY POWER

3333 DIGITAL DR#600, LEHI, UT 84043, UNITED STATES PHONE: (855) 353-4899



SYSTEM INFO

Electrical LIC#: U3487

(16) APTOS DNA-120-MF10-440W				
(16) ENPHASE IQ8PLUS -72-2-US (240V)				
DC SYSTEM	SIZE: 7.04 kW	/DC		
AC SYSTEM SIZE: 4.64 kWAC				
REVISIONS				
DESCRIPTION	DATE	REV		

Signature with Seal

PROJECT NAME & ADDRESS

CAROLINE DE CALVACAMP RESIDENCE 1005 CLARENDON ST, DURHAM, NC 27705, USA PHONE NO. (980) 234-2389 EMAIL ID: caroline.r.toney@gmail.con

DATE: 7/27/2022

SHEET NAME

EQUIPMENT SPECIFICATION

SHEET SIZE

ANSI B 11" X 17"

SHEET NUMBER







IQ8 and IQ8+ Microinverters

Our newest IQ8 Microinverters are the industry's first microgrid-forming, software-defined microinverters with split-phase power conversion capability to convert DC power to AC power efficiently. The brain of the semiconductor-based microinverter is our proprietary application-specific integrated circuit (ASIC) which enables the microinverter to operate in grid-tied or off-grid modes. This chip is built in advanced 55nm technology with high speed digital logic and has super-fast response times to changing loads and grid events, alleviating constraints on battery sizing for home energy systems.



Part of the Enphase Energy System, IQ8 Series Microinverters integrate with the Enphase IQ Battery, Enphase IQ Gateway, and the Enphase App monitoring and analysis software.



Connect PV modules quickly and easily to IQ8 Series Microinverters using the included Q-DCC-2 adapter cable with plug-n-play MC4 connectors.



IQ8 Series Microinverters redefine reliability standards with more than one million cumulative hours of power-on testing, enabling an industry-leading limited warranty of up to 25 years.



IQ8 Series Microinverters are UL Listed as PV Rapid Shut Down Equipment and conform with various regulations, when installed according to manufacturer's instructions.

© 2021 Enphase Energy. All rights reserved. Enphase, the Enphase logo, IQ8 microinverters, and other names are trademarks of Enphase Energy, Inc. Data subject to change.

IQ8SP-DS-0002-01-EN-US-2021-10-19

Easy to install

- Lightweight and compact with plug-n-play connectors
- Power Line Communication (PLC) between components
- Faster installation with simple two-wire cabling

High productivity and reliability

- Produce power even when the grid is down
- More than one million cumulative hours of testing
- Class II double-insulated
 enclosure
- Optimized for the latest highpowered PV modules

Microgrid-forming

- Complies with the latest advanced grid support
- Remote automatic updates for the latest grid requirements
- Configurable to support a wide range of grid profiles
- Meets CA Rule 21 (UL 1741-SA) requirements

IQ8 and IQ8+ Microinverters

INPUT DATA (DC)		108-60-2-U\$	108PLUS-72-2-US
Commonly used module pairings ¹	w	235 – 350	235 – 440
Module compatibility		60-cell/120 half-cell	60-cell/120 half-cell and 72-cell/144 half-cell
MPPT voltage range	V	27 - 37	29 - 45
Operating range	V	25 – 48	25 – 58
Min/max start voltage	V	30 / 48	30 / 58
Max input DC voltage	V	50	60
Max DC current² [module lsc]	А	1:	5
Overvoltage class DC port		1	I
DC port backfeed current	mA		
PV array configuration		1x1 Ungrounded array; No additional DC side protection requ	ired; AC side protection requires max 20A per branch circu
OUTPUT DATA (AC)		108-60-2-US	108PLUS-72-2-US
Peak output power	VA	245	300
Max continuous output power	VA	240	290
Nominal (L-L) voltage/range ³	V	240 / 2	11 – 264
Max continuous output current	А	1.0	1.21
Nominal frequency	Hz	6	0
Extended frequency range	Hz	50-	- 68
Max units per 20 A (L-L) branch circu	ıit ⁴	16	13
Total harmonic distortion		<5	;%
Overvoltage class AC port		I	I
AC port backfeed current	mA	3	0
Power factor setting		1.0	
Grid-tied power factor (adjustable)		0.85 leading -	
Peak efficiency	%	97.5	97.6
CEC weighted efficiency	%	97	97
Night-time power consumption	mW	6	
MECHANICAL DATA			
Ambient temperature range		-40°C to +60°C	(-40°F to +140°F)
Relative humidity range		4% to 100% (
DC Connector type		Mo	-
Dimensions (HxWxD)		212 mm (8.3") x 175 mm	
Weight		1.08 kg (:	
Cooling		Natural conve	
Approved for wet locations		Ye	
Acoustic noise at 1 m			
Pollution degree		<60 dBA	
Enclosure		PD3 Class II double-insulated, corrosion resistant polymeric enclosure	
Environ. category / UV exposure rational category / UV exposur	na	NEMA Type 6 / outdoor	
COMPLIANCE	19	NEWA TYPE	07 Satassi
CONTENUICE .		CA Rule 21 (UL 1741-SA), UL 62109-1, UL1741/IEEE1547, FCC Part	15 Class B ICES-0003 Class B CAN/CSA-C32 2 NO 1071
Certifications		This product is UL Listed as PV Rapid Shut Down Equipment and conforms with NEC 2014, NEC 2017, and NEC 2020 section 690.12 and C22.1-2018 Rule 64-218 Rapid Shutdown of PV Systems, for AC and DC conductors, when installed according to manufacturer's instructions.	

(1) No enforced DC/AC ratio. See the compatibility calculator at https://link.enphase.com/module-compatibility (2) Maximum continuous input DC current is 10.6A (3) Nominal voltage range can be extended beyond nominal if required by the utility. (4) Limits may vary. Refer to local requirements to define the number of microinverters per branch in your area.

IQ8SP-DS-0002-01-EN-US-2021-10-19

4 LGCY POWER

LGCY POWER

3333 DIGITAL DR#600, LEHI, UT 84043, UNITED STATES PHONE: (855) 353-4899



Electrical LIC#: U34871

SYSTEM INFO
(16) APTOS DNA-120-MF10-440W
(16) ENPHASE IQ8PLUS -72-2-US (240V)
DC SYSTEM SIZE: 7.04 kWDC
AC SYSTEM SIZE: 4.64 kWAC

REVISIONS				
ESCRIPTION	DATE	REV		

Signature with Seal

PROJECT NAME & ADDRESS

CAROLINE DE CALVACAMP RESIDENCE 1005 CLARENDON ST, DURHAM, NC 27705, USA

PHONE NO. (980) 234-2389 IL ID: caroline.r.toney@gmail.

DATE: 7/27/2022

SHEET NAME

EQUIPMENT SPECIFICATION

SHEET SIZE

ANSI B 11" X 17"

SHEET NUMBER

Data Sheet **Enphase Networking**

Enphase IQ Combiner 4/4C

X-IQ-AM1-240-4 X-IQ-AM1-240-4C



The Enphase IQ Combiner 4/4C with Enphase IQ Gateway and integrated LTE-M1 cell modem (included only with IQ Combiner 4C) consolidates interconnection equipment into a single enclosure and streamlines IQ microinverters and storage installations by providing a consistent, pre-wired solution for residential applications. It offers up to four 2-pole input circuits and Eaton BR series busbar assembly.

Smart

- Includes IQ Gateway for communication and control
- Includes Enphase Mobile Connect cellular modem (CELLMODEM-M1-06-SP-05), included only with IQ Combiner 4C
- Includes solar shield to match Enphase IQ Battery aesthetics and deflect heat
- Flexible networking supports Wi-Fi, Ethernet, or cellular
- · Optional AC receptacle available for PLC bridge
- Provides production metering and consumption monitoring

Simple

- Centered mounting brackets support single stud mounting
- · Supports bottom, back and side conduit entry
- Up to four 2-pole branch circuits for 240 VAC plug-in breakers (not included)
- 80A total PV or storage branch circuits

Reliable

- Durable NRTL-certified NEMA type 3R enclosure
- Five-year limited warranty
- Two years labor reimbursement program coverage included for both the IQ Combiner SKU's
- UL listed



Enphase IQ Combiner 4/4C

MODEL NUMBER	
IQ Combiner 4 (X-IQ-AM1-240-4)	IQ Combiner 4 with Enphase IQ Gateway printed circuit board for integrated revenue grade PV production metering (ANS C12.20 +/- 0.5%) and consumption monitoring (+/- 2.5%). Includes a silver solar shield to match the IQ Battery system ar IQ System Controller 2 and to deflect heat.
IQ Combiner 4C (X-IQ-AM1-240-4C)	IQ Combiner 4C with Enphase IQ Gateway printed circuit board for integrated revenue grade PV production metering (ANSI C12, 20 4/- 0.5%) and consumption monitoring (+/- 2.5%). Includes Enphase Mobile Connect cellular modem (CELLMODEM-M1-06-SP-05), a plug-and-play industrial-grade cell modem for systems up to 60 microinverters. (Available in the US, Canada, Mexico, Puerto Rico, and the US Virgin Islands, where there is adequate cellular service in the installation area.) Includes a silver solar shield to match the IQ Battery and IQ System Controller and to deflect hea
ACCESSORIES AND REPLACEMENT PARTS	(not included, order separately)
Ensemble Communications Kit COMMS-CELLMODEM-M1-06 CELLMODEM-M1-06-SP-05 CELLMODEM-M1-06-AT-05	- Includes COMMS-KIT-01 and CELLMODEM-M1-06-SP-05 with 5-year Sprint data plan for Ensemble sites - 4G based LTE-M1 cellular modem with 5-year Sprint data plan - 4G based LTE-M1 cellular modem with 5-year AT&T data plan
Circuit Breakers BRK-10A-2-240V BRK-15A-2-240V BRK-20A-2P-240V BRK-15A-2P-240V-B BRK-20A-2P-240V-B	Supports Eaton BR210, BR215, BR220, BR230, BR240, BR250, and BR260 circuit breakers. Circuit breaker, 2 pole, 10A, Eaton BR210 Circuit breaker, 2 pole, 15A, Eaton BR215 Circuit breaker, 2 pole, 20A, Eaton BR220 Circuit breaker, 2 pole, 15A, Eaton BR215B with hold down kit support Circuit breaker, 2 pole, 20A, Eaton BR220B with hold down kit support
EPLC-01	Power line carrier (communication bridge pair), quantity - one pair
XA-SOLARSHIELD-ES	Replacement solar shield for IQ Combiner 4/4C
XA-PLUG-120-3	Accessory receptacle for Power Line Carrier in IQ Combiner 4/4C (required for EPLC-01)
XA-ENV-PCBA-3	Replacement IQ Gateway printed circuit board (PCB) for Combiner 4/4C
X-IQ-NA-HD-125A	Hold down kit for Eaton circuit breaker with screws.
ELECTRICAL SPECIFICATIONS	
Rating	Continuous duty
System voltage	120/240 VAC, 60 Hz
Eaton BR series busbar rating	125 A
Max. continuous current rating	65 A
Max. continuous current rating (input from PV/storage)	64 A
Max. fuse/circuit rating (output)	90 A
Branch circuits (solar and/or storage)	Up to four 2-pole Eaton BR series Distributed Generation (DG) breakers only (not included)
Max. total branch circuit breaker rating (input) Production metering CT	80A of distributed generation / 95A with IQ Gateway breaker included 200 A solid core pre-installed and wired to IQ Gateway
Consumption monitoring CT (CT-200-SPLIT)	A pair of 200 A split core current transformers
MECHANICAL DATA	27 5 1/40 5 1/40 0 are (44.75") 1/40 5" 1/4 6 60"\
Dimensions (WxHxD)	37.5 x 49.5 x 16.8 cm (14.75" x 19.5" x 6.63"). Height is 21.06" (53.5 cm) with mounting brackets.
Weight	7.5 kg (16.5 lbs)
Ambient temperature range	-40° C to +46° C (-40° to 115° F)
Cooling	Natural convection, plus heat shield
Enclosure environmental rating	Outdoor, NRTL-certified, NEMA type 3R, polycarbonate construction
Wire sizes	 20 A to 50 A breaker inputs: 14 to 4 AWG copper conductors 60 A breaker branch input: 4 to 1/0 AWG copper conductors Main lug combined output: 10 to 2/0 AWG copper conductors Neutral and ground: 14 to 1/0 copper conductors Always follow local code requirements for conductor sizing.
Altitude	To 2000 meters (6,560 feet)
INTERNET CONNECTION OPTIONS	000441
Integrated Wi-Fi	802.11b/g/n
Cellular	CELLMODEM-M1-06-SP-05, CELLMODEM-M1-06-AT-05 (4G based LTE-M1 cellular modem). Note that an Enphase Mobile Connect cellular modem is required for all Ensemble installations.
Ethernet	Optional, 802.3, Cat5E (or Cat 6) UTP Ethernet cable (not included)
COMPLIANCE	
Compliance, IQ Combiner	UL 1741, CAN/CSA C22.2 No. 107.1, 47 CFR, Part 15, Class B, ICES 003 Production metering: ANSI C12.20 accuracy class 0.5 (PV production) Consumption metering: accuracy class 2.5
Compliance, IQ Gateway	UL 60601-1/CANCSA 22.2 No. 61010-1

To learn more about Enphase offerings, visit $\underline{\textbf{enphase.com}}$

© 2021 Enphase Energy. All rights reserved. Enphase, the Enphase logo, IQ Combiner 4/4C, and other names are trademarks of Enphase Energy, Inc. Data subject to change. 10-21-2021



4 LGCY POWER

UT 84043, UNITED STATES
PHONE: (855) 353-4899

Les Harly

Electrical LIC#: U34871

SYSTEM	/ INFO
(16) AI DNA-120-M	PTOS F10-440W
(16) ENI IQ8PLUS -72-	PHASE 2-US (240V)
DC SYSTEM SIZ	ZE: 7.04 kWDC
AC SYSTEM SI	ZE: 4.64 kWAC

REVISIONS		
DESCRIPTION	DATE	REV

Signature with Seal

PROJECT NAME & ADDRESS

PHONE NO. (980) 234-2389 IL ID: caroline.r.toney@gmail.

CAROLINE DE CALVACAMP RESIDENCE 1005 CLARENDON ST, DURHAM, NC 27705, USA

DATE: 7/27/2022

SHEET NAME

EQUIPMENT SPECIFICATION

SHEET SIZE

ENPHASE

ANSI B 11" X 17"

SHEET NUMBER

FLASHLOC™ DUO

#UNIRAC

THE MOST VERSATILE DIRECT TO DECK ATTACHMENT



FLASHLOC™ DUO is the most versatile direct to deck and rafter attachment for composition shingle and rolled comp roofs. The all-in-one mount installs fast — no kneeling on hot roofs to install flashing, no prying or cutting shingles, no pulling nails. Simply drive the required number of screws to secure the mount and inject sealant into the base. **FLASH**LOC's patented TRIPLE SEAL technology preserves the roof and protects the penetration with a permanent pressure seal. Kitted with two rafter screws, sealant and hardware for maximum convenience (deck screws sold separately). Don't just divert water, **LOC** it out!





PROTECT THE ROOF

Install a high-strength waterproof attachment without lifting, prying or damaging shingles.

APRIL2021_FLASHLOCDUO_V1



LOC OUT WATER

With an outer shield contour-conforming gasket and pressurized sealant chamber the Triple Seal technology delivers a 100% waterproof connection.



HIGH-SPEED INSTALL

Simply drive the required number of screws and inject sealant into the port 4 to create a permanent pressure

FASTER INSTALLATION. 25-YEAR WARRANTY.

FOR QUESTIONS OR CUSTOMER SERVICE VISIT UNIRAC.COM OR CALL (505) 248-2702

FLASHLOC™ DUO

INSTALLATION GUIDE





PRE-INSTALL: CLEAN SURFACE AND MARK LOCATION

Ensure existing roof structure is capable of supporting loads prescribed in Flashloc Duo D&E Guide. Clean roof surface of dirt, debris, snow and ice.

Snap chalk lines for attachment rows. On shingle roofs, snap lines 1/4" below upslope edge of shingle coarse. This line will be used to align the upper edge of the mount.

NOTE: Space mounts per span charts found in Flashloc Duo D&E Guide.

STEP ONE: SECURE

ATTACHING TO A RAFTER: Place FLASHLOC DUO over rafter location and align upper edge of mount with horizontal chalk line. Secure mount with the two (2) provided rafter screws. BACKFILL ALL PILOT HOLES WITH SEALANT.

ATTACHING TO SHEATHING: Place FLASHLOC DUO over desired location and align upper edge of mount with horizontal chalk line. Secure mount with the two (2) provided rafter screws. Next, secure mount with four (4) deck screws by drilling through the FLASHLOC DUO deck mount hole locations. Unirac recommends using a drill as opposed to an impact gun to prevent over-tightening or stripping roof sheathing.

IMPORTANT: SECURELY ATTACH MOUNT BUT DO NOT OVERTIGHTEN SCREWS.

STEP TWO: SEAL

Insert tip of UNIRAC approved sealant into port and inject until sealant exits vent. Continue array installation, attaching rails to mounts with provided T-bolts.

NOTE: When FLASHLOC DUO is installed over gap between shingle tabs or vertical joints, fill gap/joint with sealant between mount and upslope edge of shingle course.

CUT SHINGLES AS REQUIRED: DO NOT INSTALL THE FLASHLOC SLIDER ACCROSS THICKNESS VARIATIONS GREATER THAN 1/8" SUCH AS THOSE FOUND IN HIGH DEFINITION SHINGLES.

NOTE: When installing included rail attachment hardware, torque T-bolt nut to 30 ft-lbs. NOTE: If an exploratory hole falls outside of the area covered by the sealant, flash hole accordingly.

USE ONLY UNIRAC APPROVED SEALANTS. PLEASE CONTACT UNIRAC FOR FULL LIST OF COMPATIBLE SEALANTS.





FASTER INSTALLATION. 25-YEAR WARRANTY.

FOR QUESTIONS OR CUSTOMER SERVICE VISIT UNIRAC.COM OR CALL (505) 248-2702

4 LGCY POWER

LGCY POWER 3333 DIGITAL DR#600, LEHI, UT 84043, UNITED STATES



SYSTEM INFO
(16) APTOS DNA-120-MF10-440W
(16) ENPHASE IQ8PLUS -72-2-US (240V)
DC SYSTEM SIZE: 7.04 kWDC
AC SYSTEM SIZE: 4.64 kWAC

DEVICIONS			
REVISIONS			
DESCRIPTION	DATE	REV	

Signature with Seal

PROJECT NAME & ADDRESS

CALVACAMP 1005 CLARENDON ST, DURHAM, NC 27705, USA PHONE NO. (980) 234-2389 IL ID: caroline.r.toney@gmail. CAROLINE DE CAL RESIDENCI

DATE: 7/27/2022


SHEET NAME

EQUIPMENT SPECIFICATION

SHEET SIZE

ANSI B 11" X 17"

SHEET NUMBER

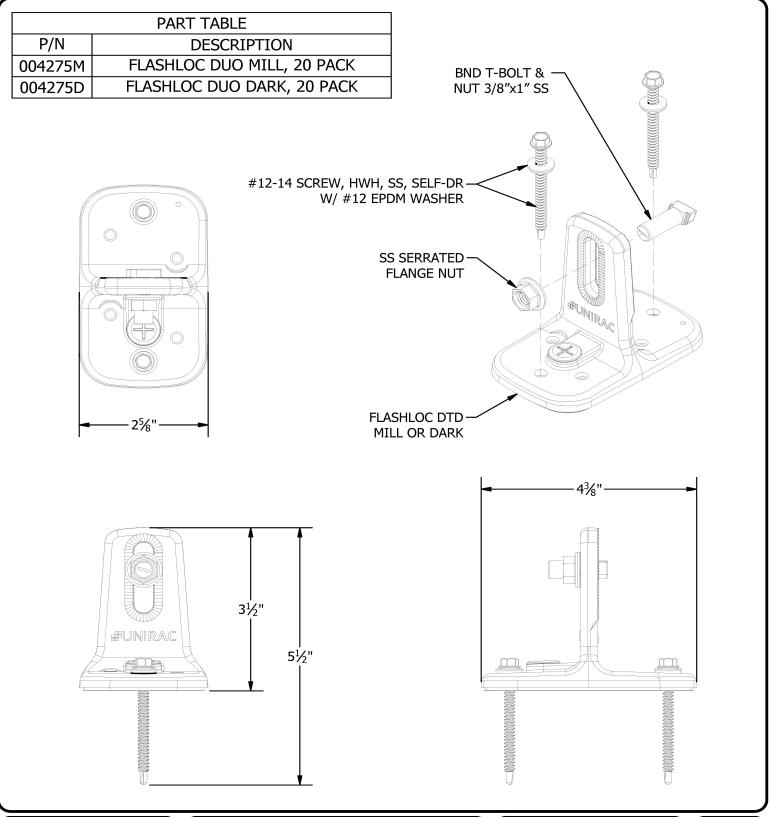



1411 BROADWAY BLVD. NE ALBUQUERQUE, NM 87102 USA PHONE: 505.242.6411 WWW.UNIRAC.COM PRODUCT LINE: SOLARMOUNT

DRAWING TYPE: ASSEMBLY DETAIL

DESCRIPTION: FLASHLOC DUO KIT

REVISION DATE: 4/29/2021

DRAWING NOT TO SCALE ALL DIMENSIONS ARE NOMINAL

PRODUCT PROTECTED BY
ONE OR MORE US PATENTS
LEGAL NOTICE

FL-A04

SHEET

4 LGCY POWER

LGCY POWER

3333 DIGITAL DR#600, LEHI, UT 84043, UNITED STATES PHONE: (855) 353-4899



Electrical LIC#: U34871

REVISIONS			
DESCRIPTION	DATE	REV	

Signature with Seal

PROJECT NAME & ADDRESS

CAROLINE DE CALVACAMP RESIDENCE 1005 CLARENDON ST, DURHAM, NC 27705, USA PHONE NO. (980) 234-2389 EMAIL ID: caroline.r.toney@gmail.com

DATE: 7/27/2022

SHEET NAME

EQUIPMENT SPECIFICATION

SHEET SIZE

ANSI B 11" X 17"

SHEET NUMBER

SOLARMOUNT



SOLARMOUNT defined the standard in solar racking. Features are designed to get installers off the roof faster. Our grounding & bonding process eliminates copper wire and grounding straps to reduce costs. Systems can be configured with standard or light rail to meet your design requirements at the lowest cost possible. The superior aesthetics package provides a streamlined clean edge for enhanced curb appeal, with no special brackets required for installation.









Light Rail is Fully Compatible with all SM Components



ENHANCED DESIGN & LAYOUT TOOLS

FAST INSTALLATION. SUPERIOR AESTHETICS

OPTIMIZED COMPONENTS • VERSATILITY • DESIGN TOOLS • QUALITY PROVIDER

SOLARMOUNT

#UNIRAC

OPTIMIZED COMPONENTS


INTEGRATED BONDING & PRE-ASSEMBLED PARTS

labor time. Our new grounding & bonding process eliminates copper wire and grounding straps or bonding jumpers to reduce costs. Utilize the microinverter mount with a wire management clip for an easier installation.

ONE PRODUCT - MANY APPLICATIONS

orientation to portrait or landscape while securing a large variety of framed modules on flat, low slope or steep pitched roofs. Available in mill, clear and dark anodized finishes to outperform your projects financial and aesthetic aspirations

when you log in. You will enjoy the ability to share projects with customers; there's no need to print results and send to a distributor, just click and share

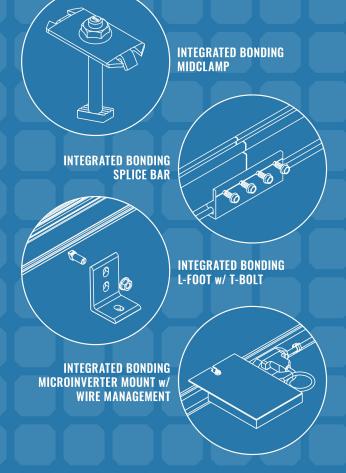



UNMATCHED EXPERIENCE

TECHNICAL SUPPORT

BUL2703 BONDING & GROUNDING MECHANICAL LOADING SYSTEM FIRE CLASSIFICATION

(A)

CERTIFIED QUALITY

UNIRAC CUSTOMER SERVICE MEANS THE HIGHEST LEVEL OF PRODUCT SUPPORT

BANKABLE WARRANTY

DESIGN TOOLS



CERTIFIED OUALITY PROVIDER

BANKABLE WARRANTY

strength to back our products and reduce your risk. Have peace limited product warranty and a five (5) year limited finish warranty.

PROTECT YOUR REPUTATION WITH OUALITY RACKING SOLUTIONS BACKED BY ENGINEERING EXCELLENCE AND A SUPERIOR SUPPLY CHAIN

4 LGCY POWER **LGCY POWER**

3333 DIGITAL DR#600. LEHI. UT 84043, UNITED STATES



SYSTEM INFO (16) ENPHASE DC SYSTEM SIZE: 7.04 kWDC AC SYSTEM SIZE: 4.64 kWAC

REVISIONS

Signature with Seal

PROJECT NAME & ADDRESS

CAROLINE DE CALVACAMP RESIDENCE 1005 CLARENDON ST, DURHAM, NC 27705, USA EMAIL ID: caroline.r.toney@gmail. PHONE NO. (980) 234-2389

DATE: 7/27/2022

SHEET NAME

EQUIPMENT SPECIFICATION

SHEET SIZE

ANSI B 11" X 17'

SHEET NUMBER

SOLARMOUNT



SOLARMOUNT is the professionals' choice for residential PV mounting applications. Every aspect of the system is designed for an easier, faster installation experience. **SOLAR**MOUNT is a complete solution with revolutionary universal clamps, **FLASHKIT** PRO, full system UL 2703 certification and 25-year warranty. Not only is **SOLAR**MOUNT easy to install, but best-in-class aesthetics make it the most attractive on any block!





NOW FEATURING FLASHKIT PRO The Complete Roof Attachment Solution FEATURING O SHED & SEAL TECHNOLOGY



NOW WITH UNIVERSAL MIDCLAMPS Accommodates 30mm-51mm module frames One tool, one-person installs are here!



REVOLUTIONARY NEW ENDCLAMPS Concealed design and included End Caps

THE PROFESSIONALS' CHOICE FOR RESIDENTIAL RACKING

BEST INSTALLATION EXPERIENCE • CURB APPEAL • COMPLETE SOLUTION • UNIRAC SUPPORT

FOR QUESTIONS OR CUSTOMER SERVICE VISIT UNIRAC.COM OR CALL (505) 248-2702

SOLARMOUNT

#UNIRAC

BETTER DESIGNS

TRUST THE INDUSTRY'S BEST DESIGN TOOL

Start the design process for every project in our U-Builder on-line design tool. It's a great way to save time and money.

BETTER SYSTEMS

ONE SYSTEM - MANY APPLICATIONS

Quickly set modules flush to the roof on steep pitched roofs. Orient a large variety of modules in Portrait or Landscape. Tilt the system up on flat or low slow roofs. Components available in mill, clear, and dark finishes to optimize your design financials

BETTER RESULTS

MAXIMIZE PROFITABILITY ON EVERY JOB

Trust Unirac to help you minimize both system and labor costs from the time the job is quoted to the time your teams get off the roof. Faster installs. Less Waste. More Profits.

BETTER SUPPORT

WORK WITH THE INDUSTRIES MOST EXPERIENCED TEAM


Professional support for professional installers and designers. You have access to our technical support and training groups. Whatever your support needs, we've got you covered. Visit Unirac.com/solarmount for more information



CONCEALED UNIVERSAL ENDCLAMPS



UNIVERSAL SELF STANDING MIDCLAMPS **END CAPS INCLUDED** WITH EVERY ENDCLAMP

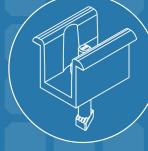

U-BUILDER ONLINE DESIGN TOOL SAVES TIME & MONEY

UNIRAC CUSTOMER SERVICE MEANS THE HIGHEST LEVEL OF PRODUCT SUPPORT



UNMATCHED EXPERIENCE

TECHNICAL SUPPORT

Unirac's technical support team is dedicated to answering

questions & addressing issues in real time. An online

library of documents including engineering reports,

stamped letters and technical data sheets greatly

simplifies your permitting and project planning process



ENGINEERING EXCELLENCE



CERTIFIED QUALITY PROVIDER

Unirac is the only PV mounting vendor with ISO

certifications for 9001:2008, 14001:2004 and OHSAS

18001:2007, which means we deliver the highest standards

for fit, form, and function. These certifications demonstrate

BANKABLE WARRANTY



PERMIT DOCUMENTATION

BANKABLE WARRANTY

Don't leave your project to chance, Unirac has the financial strength to back our products and reduce your risk. Have peace of mind knowing you are providing products of exceptional quality. SOLARMOUNT is covered by a 25 year limited product warranty and a 5 year limited finish warranty.

ENHANCE YOUR REPUTATION WITH OUALITY RACKING SOLUTIONS BACKED BY ENGINEERING EXCELLENCE AND A SUPERIOR SUPPLY CHAIN

PUBZOBAUGSI-PRINTEDUPDATE FOR OUESTIONS OR CUSTOMER SERVICE VISIT UNIRAC.COM OR CALL (505) 248-2702

4 LGCY POWER

LGCY POWER

3333 DIGITAL DR#600. LEHI. UT 84043, UNITED STATES PHONE: (855) 353-4899



Electrical LIC#: U3487

SYSTEM INFO (16) ENPHASE DC SYSTEM SIZE: 7.04 kWDC AC SYSTEM SIZE: 4.64 kWAC

REVISIONS DESCRIPTION DATE

Signature with Seal

PROJECT NAME & ADDRESS

CAROLINE DE CALVACAMP RESIDENCE 1005 CLARENDON ST, DURHAM, NC 27705, USA PHONE NO. (980) 234-2389 EMAIL ID: caroline.r.toney@gmail.

DATE: 7/27/2022

SHEET NAME

EQUIPMENT SPECIFICATION


SHEET SIZE

ANSI B 11" X 17'


SHEET NUMBER






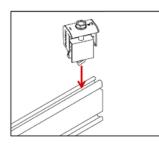


1. Position clamp to align T-bolt with rail slot. Lower clamp and Insert T-bolt into

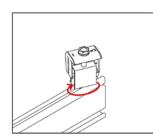


2. Rotate clamp clockwise 2/3 of a turn to engage T-bolt inside rail slot.

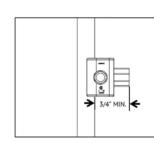


3. Place module at least 3/4" from end of rail and position clamp against module

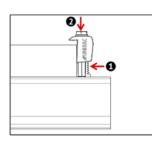


4. While applying pressure to hold the clamp against the module, push down on the module side of the clamp cap.

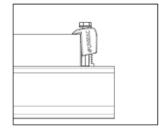

5. When the cap contacts the module frame, release and it will re-engage to the clamp base.

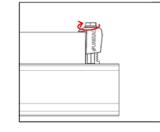

6. Tighten bolt and torque to 15 ft-lbs.

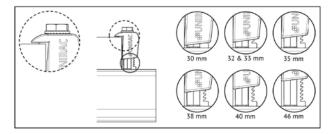

7. Confirm clamp is engaged in correct module height position and that the top of the cap is sitting level with the module frame.

NOTE: When installing 46mm modules, loosen bolt by 1 turn before positioning clamp against module frame. Do not force clamp onto module frame as this may damage the bonding pin.



and Mitigation Requirements are listed below:

1 & 2

4 & 5

UL2703 CERTIFICATION MARKING LABEL

Module Fire Types

1, 2, 3 with Metal Frame, 10 with Metal Frame, 19, 22, 25, 29, & 30

grounding and/or mounting in compliance with the included instructions.

system being installed must be removed so that only the installed system type is showing.

Note: The sticker label should be placed such that it is visible, but not outward facing

SYSTEM LEVEL FIRE CLASSIFICATION

Rail Type

Light Rail

Standard & HD Rails

Standard, Light, & HD Rails

SM STANDARD RAIL

CODE COMPLIANCE NOTES | C | PAGE

The system fire class rating requires installation in the manner specified in the SOLARMOUNT Installation Guide. SOLARMOUNT has been classified to the system level fire portion of UL2703. SOLARMOUNT has achieved system level performance for steep sloped roofs. The fire classification rating is only valid on roof pitches

greater than 2:12 (slopes ≥ 2 inches per foot, or 9.5 degrees). The system is to be mounted over fire resistant roof covering rated for the application. There is no required minimum or maximum height limitation above the roof deck to maintain the system fire rating for SOLARMOUNT. Module Types, System Level Fire Ratings,

Rail Direction

East-West

East-West

East-West

North-South

North-South

Orientation

Landscape OR Portrait

System Level Fire Rating

Class A, Class B & Class C

Class A, Class B & Class C

This racking system may be used to ground and/or mount a PV module complying with UL1703 or UL61730 only when the specific module has been

Unirac SOLARMOUNT is listed to UL 2703. Certification marking is embossed on all mid clamps as shown. Labels with additional information will be provided . After the racking system is fully assembled, a single label should be applied to the SOLARMOUNT rail at the edge of the array. Before applying the label, the corners of the label that do not pertain to the

REVISIONS DESCRIPTION DATE

4 LGCY POWER **LGCY POWER** 3333 DIGITAL DR#600. LEHI. UT 84043, UNITED STATES PHONE: (855) 353-4899

Electrical LIC#: U34871

SYSTEM INFO (16) APTOS DNA-120-MF10-440W (16) ENPHASE IQ8PLUS -72-2-US (240V) DC SYSTEM SIZE: 7.04 kWDC AC SYSTEM SIZE: 4.64 kWAC

Signature with Seal

PROJECT NAME & ADDRESS

CAROLINE DE CALVACAMP RESIDENCE 1005 CLARENDON ST, DURHAM, NC 27705, USA PHONE NO. (980) 234-2389 EMAIL ID: caroline.r.toney@gmail.

266909

Mitigation Required

None Required

None Required

None Required

None Required

Trim installation per Solar

Mount Installation Guide



SM LIGHT RAIL

DATE: 7/27/2022

SHEET NAME

EQUIPMENT SPECIFICATION


SHEET SIZE

ANSI B 11" X 17"

SHEET NUMBER



BONDING CONNECTION GROUND PATHS | 0

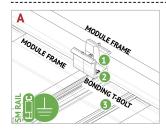


BONDING MIDCLAMP ASSEMBLY



BONDING MIDCLAMP ASSEMBLY

- Aluminum mid clamp with stainless steel bonding pins that pierce module frame anodization to bond module to module through clamp
- Serrated T-bolt head penetrates rail anodization to bond T-bolt, nut, clamp, and

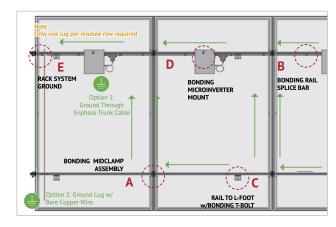



BONDING RAIL SPLICE BAR


- Bonding Hardware creates bond betw bar and each rail section
- Aluminum splice bar spans across rail gap to create rail to rail bond. Rail on at least one side of splice will be grounded.

Note: Splice bar and bolted connection are non-structural. The splice bar function is rail



BONDING MICROINVERTER MOUNT

- Hex nut with captive lock washer bonds metal microinverter flange to stainless steel T-bolt
- Serrated T-bolt head penetrates rail anodization to bond T-bolt, nut, and L-foot to grounded SM rail System ground including racking and modules may be achieved through the trunk cable

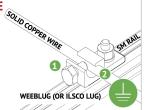

RAIL TO L-FOOT w/BONDING T-BOLT

2 Serrated T-bolt head penetrates rail anodization to bond T-bolt, nut, and L-foot to grounded


Serrated flange nut removes L-foot anodiz to bond L-Foot to stainless steel T-bolt

RACK SYSTEM GROUND

- WEEB washer dimples pierce anodized rail to create bond between rail and lug
- Solid copper wire connected to lug is routed to NOTE: Ilsco lug can also be used when secured to the side of the rail. See page K for details





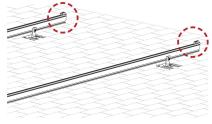

INSTALL MODULE END CLAMPS: The End clamp is supplied as an assembly with a 1/2" hex head bolt that is accessible at the ends of rails. The clamp should be installed on the rails prior to installing end modules.




Slide end clamp on to rail by engaging the two t-guide brackets on to rail until bolt head with the top slot of the rails. Ensure engages with end of rail bolt is extended as far as possible so that clamp is positioned at max. distance from end of rail.


8




Slide end clamp assembly End clamps are positioned on rails prior to the first end module and prior to the last end module.

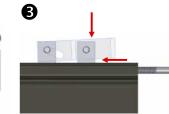

NOTE: To assist insertion of clamp into rail slot, Pressure may be applied to top or side of bracket as shown. Do not force clamp into rail by pushing on bolt with excessive force.

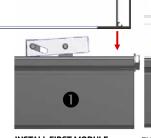


INSTALL FIRST MODULE: Install the first end module onto rails with the flange of the module frame positioned between end clamps an ends of rails.

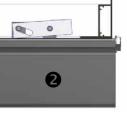

ENGAGE CLAMP: While holding module in position and with flange in full contact with rail, rotate end clamp bolt until clamp engages with flange to provide clamp force. To ensure bolt is not over-torqued, use low torque setting on drill or If using an impact driver, stop rotation as soon as

impact action of driver begins. TORQUE VALUE (See table and notes on PG. A) End clamp bolt to 5 ft-lbs, No anti-seize

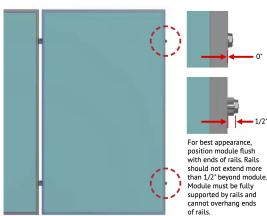

3333 DIGITAL DR#600. LEHI. UT 84043, UNITED STATES PHONE: (855) 353-4899

4 LGCY POWER **LGCY POWER**

Electrical LIC#: U34871

(16) ENPHASE DC SYSTEM SIZE: 7.04 kWDC AC SYSTEM SIZE: 4.64 kWAC

SYSTEM INFO

REVISIONS DESCRIPTION DATE

Signature with Seal

PROJECT NAME & ADDRESS

CAROLINE DE CALVACAMP RESIDENCE 1005 CLARENDON ST, DURHAM, NC 27705, USA PHONE NO. (980) 234-2389 EMAIL ID: caroline.r.toney@gmail.

DATE: 7/27/2022

SHEET NAME

EQUIPMENT SPECIFICATION


SHEET SIZE

ANSI B 11" X 17"

SHEET NUMBER



STANDARD SYSTEM GROUNDING | K | PAGE

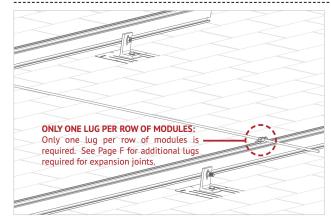

GROUNDING LUG MOUNTING DETAILS:


Details are provided for both the WEEB and Ilsco products. The WEEBLug has a grounding symbol located on the lug assembly. The Ilsco lug has a green colored set screw for grounding indication purposes. Installation must be in accordance with NFPA NEC 70, however the electrical designer of record should refer to the latest revision of NEC for actual grounding conductor cable size.

Required if not using approved integrated grounding microinveters

GROUNDING LUG - BOLT SIZE & DRILL SIZE			
	GROUND LUG BOLT SIZE		DRILL SIZE
	WEEBLug	1/4"	N/A - Place in Top SM Rail Slot
	ILSCO Lug	#10-32	7/32"
	·		

- Torque value depends on conductor size.
- See product data sheet for torque value.



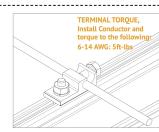


WEEBLUG CONDUCTOR - UNIRAC P/N 008002S:

Apply Anti Seize and insert a bolt in the aluminum rail and through the clearance hole in the stainless steel flat washer. Place the stainless steel flat washer on the bolt, oriented so the dimples will contact the aluminum rail. Place the lug portion on the bolt and stainless steel flat washer, lost washer and nut. Tighten the nut until the dimples are completely embedded into the rail and lug. TORQUE VALUE 10 ft lbs. (See Note on PG. A)

See product data sheet for more details, Model No. WEEB-LUG-6.7



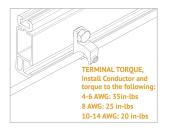

ILSCO LAY-IN LUG CONDUCTOR - UNIRAC P/N 008009P: Alternate Grounding Lug - Drill, deburr hole and bolt thru both rail walls per table.


TORQUE VALUE 5 ft lbs. (See Note on PG. A)

See ILSCO product data sheet for more details, Model No. GBL-4DBT.


NOTE: ISOLATE COPPER FROM ALUMINUM CONTACT TO PREVENT CORROSION






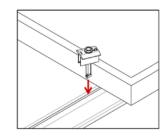


 Position clamp to align T-bolt with rail slot. Lower clamp and insert T-bolt into rail slot

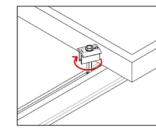


2. Rotate clamp clockwise 2/3 of a turn to engage T-bolt inside rail slot.

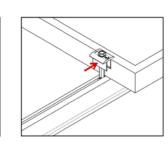


3. Slide clamp into position against module.

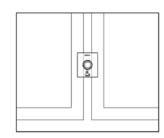

4. Place second module.

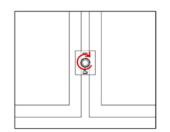

5. Tighten bolt and torque to 15 ft-lbs.

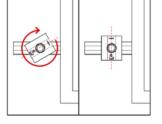

NOTE: If excessive force is applied in step 2, the cap may over-rotate causing it to be mis-aligned with the module frame. If this occurs, keep rotating the cap clockwise until it returns to the original position.



LGCY POWER

3333 DIGITAL DR#600, LEHI, UT 84043, UNITED STATES PHONE: (855) 353-4899



Electrical LIC#: U34871

SYSTEM INFO
(16) APTOS DNA-120-MF10-440W
(16) ENPHASE IQ8PLUS -72-2-US (240V)
DC SYSTEM SIZE: 7.04 kWDC
AC SYSTEM SIZE: 4.64 kWAC

REVISIONS			
DESCRIPTION	DATE	REV	

Signature with Seal

PROJECT NAME & ADDRESS

CAROLINE DE CALVACAMP RESIDENCE 1005 CLARENDON ST, DURHAM, NC 27705, USA PHONE NO. (980) 234-2389 EMAIL ID: caroline.r.toney@gmail.cor

DATE: 7/27/2022

SHEET NAME

EQUIPMENT SPECIFICATION

SHEET SIZE

ANSI B 11" X 17"

SHEET NUMBER



October 3, 2019

UniRac 1411 Broadway Boulevard NE Albuquerque, New Mexico 87102-1545

TEL: (505) 242-6411 FAX: (505) 242-6412

Attn.: Unirac Engineering Department,

Re: Engineering Certification for UniRac's SolarMount Design & Engineering Guide

PZSE, Inc.-Structural Engineers has reviewed UniRac's "SolarMount Design & Engineering Guide" and specifically the enhancements of the SolarMount Flush-to-Roof System, Pressure Lookup Tables, and Downward & Upward Span Length Tables.

This certification excludes connections to building structures and the effects on building structure components. All information, data and analysis contained within the Installation Manual are based on, and comply with the following:

- 1. 2018 North Carolina Building Code, by The North Carolina State Building Code Council
- 2. 2009, 2012, 2012, & 2015 International Building Code, by International Code Council, Inc.
- 3. ASCE/SEI 7-05 & 7-10: Minimum Design Loads for Buildings and other Structures
- 4. 2010 & 2015 Aluminum Design Manual, by The Aluminum Association, 2015

This letter certifies that the structural calculations contained within UniRac's "SolarMount Design & Engineering Guide" are in compliance with the above Codes.

If you have any questions on the above, do not hesitate to call.

Prepared By: PZSE, Inc. – Structural Engineers Roseville, CA



4 LGCY POWER

LGCY POWER

3333 DIGITAL DR#600, LEHI, UT 84043, UNITED STATES PHONE: (855) 353-4899



Electrical LIC#: U3487

SYSTEM INFO	
(16) APTOS DNA-120-MF10-440W	
(16) ENPHASE IQ8PLUS -72-2-US (240V)	
DC SYSTEM SIZE: 7.04 kWDC	
AC SYSTEM SIZE: 4.64 kWAC	

REVISIONS		
DESCRIPTION	DATE	REV

Signature with Seal

PROJECT NAME & ADDRESS

caroline.r.toney@gmail.

CAROLINE DE CALVACAMP RESIDENCE 1005 CLARENDON ST, DURHAM, NC 27705, USA

DATE: 7/27/2022

SHEET NAME

EQUIPMENT SPECIFICATION

SHEET SIZE

ANSI B 11" X 17"

SHEET NUMBER