

76 North Meadowbrook Drive Alpine, UT 84004 office (201) 874-3483 swyssling@wysslingconsulting.com

September 15, 2022 Revised: January 9, 2023

Legacy Solar 3333 Digital Drive #600 Lehi, UT 84043

> Re: Engineering Services Wade Residence 705 Denim Drive, Erwin NC 11.440 kW System

To Whom It May Concern:

We have received information regarding solar panel installation on the roof of the above referenced structure. Our evaluation of the structure is to verify the existing capacity of the roof system and its ability to support the additional loads imposed by the proposed solar system.

A. Site Assessment Information

- 1. Site visit documentation identifying attic information including size and spacing of framing for the existing roof structure.
- Design drawings of the proposed system including a site plan, roof plan and connection details for the solar panels. This information will be utilized for approval and construction of the proposed system.

B. Description of Structure:

Roof Framing: Prefabricated wood trusses at 24" on center. All truss members are

constructed of 2x4 dimensional lumber.

Roof Material: Composite Asphalt Shingles

Roof Slope: 40 & 35 degrees
Attic Access: Accessible
Foundation: Permanent

C. Loading Criteria Used

Dead Load

- Existing Roofing and framing = 7 psf
- New Solar Panels and Racking = 3 psf
- TOTAL = 10 PSF
- Live Load = 20 psf (reducible) 0 psf at locations of solar panels
- Ground Snow Load = 10 psf
- Wind Load based on ASCE 7-10
 - Ultimate Wind Speed = 119 mph (based on Risk Category II)
 - Exposure Category C

Analysis performed of the existing roof structure utilizing the above loading criteria is in accordance with the North Carolina Residential Code (2015 IRC), including provisions allowing existing structures to not require strengthening if the new loads do not exceed existing design loads by 105% for gravity elements and 110% for seismic elements. This analysis indicates that the existing framing will support the additional panel loading without damage, if installed correctly.

D. Solar Panel Anchorage

1. The solar panels shall be mounted in accordance with the most recent Unirac installation manual. If during solar panel installation, the roof framing members appear unstable or deflect nonuniformly, our office should be notified before proceeding with the installation.

2. Connection on the roof is utilizing (4) 1/2" or #14 screws into the existing decking to resist uplift forces. Contractor to verify installation to be performed in accordance with the Unirac recommendations. Pull out values per screw are based on National Design Specification values for CDX plywood and are identified as 208 lbs/inch. Based on ½" sheathing the value per screw would be 104 lbs providing 416 lbs uplift resistance per attachment.

Considering the wind speed, roof slopes, size and spacing of framing members, and condition of

the roof, the panel supports shall be placed no greater than 60" on center.

Panel supports connections shall be staggered to distribute load to adjacent framing members.

Based on the above evaluation, this office certifies that with the racking and mounting specified, the existing roof system will adequately support the additional loading imposed by the solar system. This evaluation is in conformance with the North Carolina Residential Code, current industry standards, and is based on information supplied to us at the time of this report.

Should you have any questions regarding the above or if you require further information do not hesitate to contact me.

Scott E. Wyssling, PE North Carolina License ?



Wyssling Consulting, PLLC 76 N Meadowbrook Drive Alpine UT 84004 North Carolina COA # P-2308

Signed 1/09/2023

THIS PLAN HAS BEEN ELECTRONICALLY SIGNED AND SEALED BY SCOTT WYSSLING, PE USING A DIGITAL SIGNATURE AND DATE. PRINTED COPIES OF THIS DOCUMENT ARE NOT CONSIDERED SIGNED AND SEALED AND THE SIGNATURE MUST BE VERIFIED ON ANY ELECTRONIC COPIES



SCOPE OF WORK

TO INSTALL A ROOF MOUNTED SOLAR PHOTOVOLTAIC SYSTEM AT THE OWNER RESIDENCE LOCATED AT 705 DENIM DR, ERWIN, NC 28339, USA.

THE POWER GENERATED BY THE PV SYSTEM WILL BE INTERCONNECTED WITH THE UTILITY GRID THROUGH THE EXISTING ELECTRICAL SERVICE EQUIPMENT.

THE PV SYSTEM DOES NOT INCLUDE STORAGE BATTERIES.

EQUIPMENT SUMMARY

26 APTOS DNA-120-MF10-440W MODULES

26 ENPHASE IQ8PLUS -72-2-US (240V) MICROINVERTERS

GENERAL NOTES

- THESE CONSTRUCTION DOCUMENTS HAVE BEEN BASED ON FIELD INSPECTIONS AND OTHER INFORMATION AVAILABLE AT THE TIME. ACTUAL FIELD CONDITIONS MAY REQUIRE MODIFICATIONS IN CONSTRUCTION DETAILS.
- ARCHITECT HAS NOT BEEN RETAINED TO SUPERVISE ANY CONSTRUCTION OR INSTALLATION OF ANY EQUIPMENT AT SITE.
- CONTRACTOR SHALL FURNISH ALL LABOR, MATERIAL, EQUIPMENT, TOOLS, OBTAINS ALL PERMITS, LICENSES AND PAY ALL REQUIRED FEES AND COMPLETE INSTALLATION.
- CONTRACTOR HAS THE FULL RESPONSIBILITY TO CHECK AND VERIFY ALL DIMENSIONS AND EXISTING CONDITIONS. ANY DISCREPANCIES SHALL BE REPORTED TO THE ENGINEER BEFORE PROCEEDING WITH THE WORK. ANY WORK STARTED BEFORE CONSULTATION AND ACCEPTANCE BY THE ENGINEER SHALL BE THE SOLE RESPONSIBILITY OF THE CONTRACTOR AND SHALL BE SUBJECT TO CORRECTION BY THEM WITHOUT ADDITIONAL COMPENSATION.
- DAMAGE CAUSED TO THE EXISTING STRUCTURE, PIPES, DUCTS, WINDOWS, WALL, FLOORS, ETC. SHALL BE REPAIRED TO THE ORIGINAL CONDITION OR REPLACED BY THE CONTRACTOR AT NO ADDITIONAL COST.
- THE CONTRACTOR SHALL BE HELD RESPONSIBLE FOR THE PROPER INSTALLATION AND COMPLETION OF THE WORK WITH APPROVED MATERIALS.
- NO CHANGES ARE TO BE MADE WITHOUT THE CONSULTATION AND APPROVAL OF THE ARCHITECT.
- CONTRACTOR SHALL OBTAIN BULDING PERMIT. NO WORK TO START UNLESS BUILDING PERMIT IS PROPERLY DISPLAYED.
- ALL WORKMANSHIP AND MATERIALS SHALL BE OF FIRST QUALITY AND IN COMPLIANCE WITH THE REQUIREMENTS OF THE FLORIDA BUILDING CODE, THE DEPARTMENT OF ENVIRONMENTAL PROTECTION AND ALL PERTINENT AGENCIES.
- IT 1S ESSENTIAL THAT ALL WORK PROCEED WITH THE MAXIMUM COOPERATION OF ALL PARTIES AND WITH MINIMUM INTERFERENCE TO THE OCCUPANTS WITHIN THE BUILDING. THE OWNER'S DIRECTIONS IN THIS REGARD SHALL BE FULLY COMPLIED WITH.
- ALL EXPOSED PLUMBING, HVAC, ELECTRICAL DUCTWORK, PIPING AND CONDUITS ARE TO BE PAINTED BY GENERAL CONTRACTOR.
- THE CONTRACTOR SHALL PERFORM THE WORK IN STRICT CONFORMANCE WITH THE LOCAL LAWS, REGULATIONS AND THE NATIONAL ELECTRIC CODE.
- THE CONTRACTOR SHALL OBTAIN ALL PERMITS, APPROVALS, AFFIDAVITS, CERTIFICATIONS, ETC. AND PAY ALL FEES AS REQUIRED BY THE LOCAL AUTHORITIES.
- CONTRACTORS SHALL OBTAIN FIRE CERTIF. UPON COMPLETION OF WORK.

ELECTRICAL NOTES

- ALL EQUIPMENT TO BE LISTED BY UL OR OTHER NRTL, AND LABELED FOR ITS APPLICATION.
- ALL CONDUCTORS SHALL BE COPPER, RATED FOR 600 V AND 90 DEGREE C WET ENVIRONMENT.
- WIRING, CONDUIT, AND RACEWAYS MOUNTED ON ROOFTOPS SHALL BE ROUTED DIRECTLY TO, AND LOCATED AS CLOSE AS POSSIBLE TO THE NEAREST RIDGE, HIP, OR VALLEY.
- WORKING CLEARANCES AROUND ALL NEW AND EXISTING ELECTRICAL EQUIPMENT SHALL COMPLY WITH NEC 110.26.
- WHERE SIZES OF JUNCTION BOXES, RACEWAYS, AND CONDUITS ARE NOT SPECIFIED, THE CONTRACTOR SHALL SIZE THEM ACCORDINGLY.
- ALL WIRE TERMINATIONS SHALL BE APPROPRIATELY LABELED AND READILY VISIBLE.
- MODULE GROUNDING CLIPS TO BE INSTALLED BETWEEN MODULE FRAME AND MODULE SUPPORT RAIL, PER THE GROUNDING CLIP MANUFACTURERS INSTRUCTION.
- MODULE SUPPORT RAIL SHALL BE BONDED TO THE MODULE

GOVERNING CODES

2020 NATIONAL ELECTRICAL CODE

2018 NORTH CAROLINA BUILDING CODE / 2015 IBC

2018 NORTH CAROLINA RESIDENTIAL CODE / 2015 IRC 2018 NORTH CAROLINA FIRE CODE / 2015 IFC

AHJ NAME : ERWIN TOWN

WIRING AND CONDUIT NOTES

- ALL CONDUIT SIZES AND TYPES SHALL BE LISTED FOR ITS PURPOSE AND APPROVAL FOR THE SITE APPLICATIONS
- ALL PV CABLES AND HOMERUN WIRES BE #10AWG *USE-2, PV WIRE, OR PROPRIETARY SOLAR CABLING SPECIFIED BY MFR, OR EQUIVALENT; ROUTED TO SOURCE CIRCUIT COMBINER BOXES AS REQUIRED
- ALL PV DC CONDUCTORS IN CONDUIT EXPOSED TO SUNLIGHT SHALL BE DERATED ACCORDING TO AS PER LATEST NEC CODE.
- EXPOSED ROOF PV DC CONDUCTORS SHALL BE USE-2, 90°C RATED, WET AND UV RESISTANT, AND UL LISTED RATED FOR 600V, UV RATED SPIRAL WRAP SHALL BE USED TO PROTECT WIRE FROM SHARP EDGES
- PHASE AND NEUTRAL CONDUCTORS SHALL BE DUAL RATED THHN/THWN-2 INSULATED, 90°C RATED, WET AND UV RESISTANT, RATED FOR 1000V PER NEC 2017
- 4-WIRE DELTA CONNECTED SYSTEMS HAVE THE PHASE WITH THE HIGHER VOLTAGE TO GROUND MARKED ORANGE OR IDENTIFIED BY OTHER EFFECTIVE MEANS
- ALL SOURCE CIRCUITS SHALL HAVE INDIVIDUAL SOURCE CIRCUIT PROTECTION
- VOLTAGE DROP LIMITED TO 2%
- AC CONDUCTORS >4AWG COLOR CODED OR MARKED: PHASE A OR L1- BLACK, PHASE B OR L2- RED, PHASE C OR L3- BLUE, NEUTRAL- WHITE/GRAY
- VOLTAGE DROP LIMITED TO 2%
- AC CONDUCTORS >4AWG COLOR CODED OR MARKED: PHASE AOR L1- BLACK, PHASE B OR L2- RED, PHASE C OR L3- BLUE, NEUTRAL- WHITE/GRAY

AN COMPART TO CONTRACTOR.
And common the subject to field respection and verification.



Wyssling Consulting, PLLC 76 N Meadowbrook Drive Alpine UT 84004 North Carolina COA # P-2308

Signed 1/09/2023

THIS PLAN HAS BEEN ELECTRONICALLY SIGNED AND SEALED BY SCOTT WYSSLING, PE USING A DIGITAL SIGNATURE AND DATE. PRINTED COPIES OF THIS DOCUMENT ARE NOT CONSIDERED SIGNED AND SEALED AND THE SIGNATURE MUST BE VERIFIED ON ANY ELECTRONIC COPIES

YSTEM RATING	
1.440 kWDC	

7.540 kWAC

PHOTOVOLTAIC SYSTEM FIRE CLASSIFICATION LISTING IN ACCORDANCE WITH UL 1703 STANDARD.

SHEET INDEX							
PV1	COVER PAGE						
PV2	SITE PLAN						
PV3	ROOF PLAN						
PV4-PV5	ATTACHMENT DETAILS						
PV6	ELECTRICAL LINE & CALCS.						
PV7	SPECIFICATIONS & NOTES						
PV8	ELECTRICAL PHOTOS						
PV9-PV10	SIGNAGE						
PV11	JOB HAZARD ANALYSIS						
PV12-PV22	EQUIPMENT SPECIFICATIONS						



HOUSE PHOTO

SCALE: NTS



VICINITY MAP

SCALE: NTS

LGCY POWER

LGCY POWER

3333 DIGITAL DR#600, LEHI,
UT 84043, UNITED STATES
PH#: (855) 353-4899

ELECTRICAL LIC#: U.21498

SYSTEM INFO

(26) APTOS
DNA-120-MF10-440W

(26) ENPHASE
IQ8PLUS -72-2-US (240V)

DC SYSTEM SIZE: 11.440 kWDC

AC SYSTEM SIZE: 7.540 kWAC

METER: 332 302 331

REVISIONS

DESCRIPTION DATE REV

PROJECT NAME & ADDRESS

RESIDENCE 705 DENIM DR, ERWIN, NC 28339, USA EMAIL ID: SHANAMONK76@GMAIL.COM PHONE NO. (910) 723-3810

DATE: 9/1/2022

SHEET NAME

COVER PAGE


SHEET SIZE


ANSI B 11" X 17"

SHEET NUMBER

SITE NOTES

- A LADDER SHALL BE IN PLACE FOR INSPECTION IN COMPLIANCE WITH OSHA REGULATIONS.
- THE PV MODULES ARE CONSIDERED NON-COMBUSTIBLE AND THIS SYSTEM IS AN UTILITY INTERACTIVE SYSTEM WITH NO STORAGE BATTERIES.
- THE SOLAR PV INSTALLATION SHALL NOT OBSTRUCT ANY PLUMBING, MECHANICAL, OR BUILDING ROOF VENTS.
- PROPER ACCESS AND WORKING CLEARANCE AROUND EXISTING AND PROPOSED ELECTRICAL EQUIPMENT WILL BE PROVIDED AS PER SECTION [NEC 110.26]

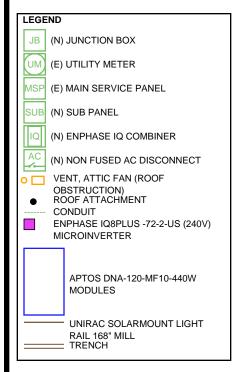

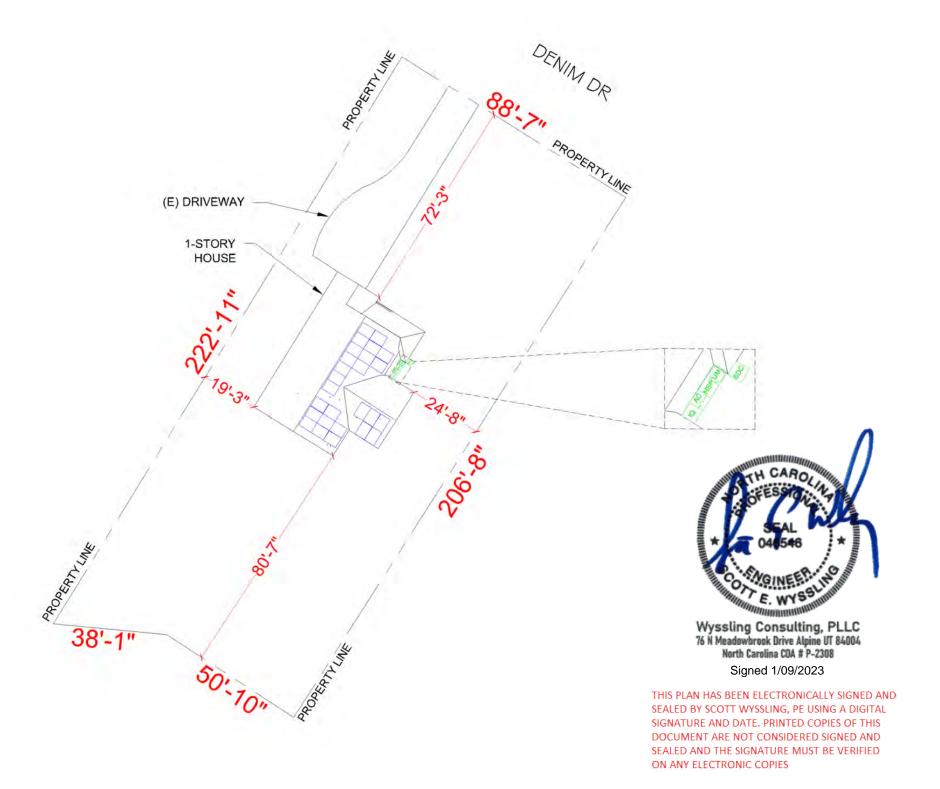



4 LGCY POWER LGCY POWER 3333 DIGITAL DR#600, LEHI, UT 84043, UNITED STATES PH#: (855) 353-4899

ELECTRICAL LIC#: U.21498

SYSTEM INFO (26) APTOS DNA-120-MF10-440W

(26) ENPHASE IQ8PLUS -72-2-US (240V)

DC SYSTEM SIZE: 11.440 kWDC

AC SYSTEM SIZE: 7.540 kWAC

METER: 332 302 331

REVISIONS										
DESCRIPTION	DATE	REV								

PROJECT NAME & ADDRESS

EMAIL ID: SHANAMONK76@GMAIL.COM PHONE NO. (910) 723-3810 705 DENIM DR, ERWIN, NC 28339, USA RESIDENCE

DATE: 9/1/2022

SHEET NAME

SITE PLAN

SHEET SIZE

ANSI B 11" X 17"

SHEET NUMBER


DESIGN SPECIFICA		
RISK CATEGORY:	П	NUMBI
CONSTRUCTION:	SFD	MODU
ZONING:	RESIDENTIAL	MODU
SNOW LOAD (ASCE7-10):	10 PSF	MODU
EXPOSURE CATEGORY:	С	UNIT V
WIND SPEED (ASCE7-10):	119 MPH	


MODULE TYPE, DIMENSIONS & WEIGHT								
NUMBER OF MODULES:	26 MODULES							
MODULE TYPE:	APTOS DNA-120-MF10-440W							
MODULE WEIGHT:	52.9 LBS							
MODULE DIMENSIONS:	74.92" X 44.65" = 23.23 SF							
UNIT WEIGHT OF AREA:	2.28 PSF							

				ROOF DES	CRIPTION	
1	ROOF	ROOF TILT	AZIMUTH		TRUSS SPACING	ROOF MATERIAL
1	#1	40°	122°	2" x 4"	24" o.c.	COMP SHINGLE
1	#2	35°	212°	2" x 4"	24" o.c.	COMP SHINGLE
ı						

ARRAY AREA & ROOF AREA CALC'S								
ROOF # OF MODULES ARRAY AREA (So								
#1	21	487.84						
#2	5	116.16						
(TOTAL ARRAY AREA/TOTAL ROOF AREA) X 100%								
= (604/1970.26) X 100% = 30.66%								

INVERTER SPECIFICATIONS								
MANUFACTURER / MODEL	ENPHASE IQ8PLUS -72-2-US (240V)							
MAX DC SHORT CIRCUIT CURRENT	15 A							
CONTINUOUS OUTPUT CURRENT	1.21 A							

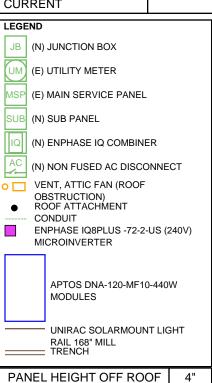

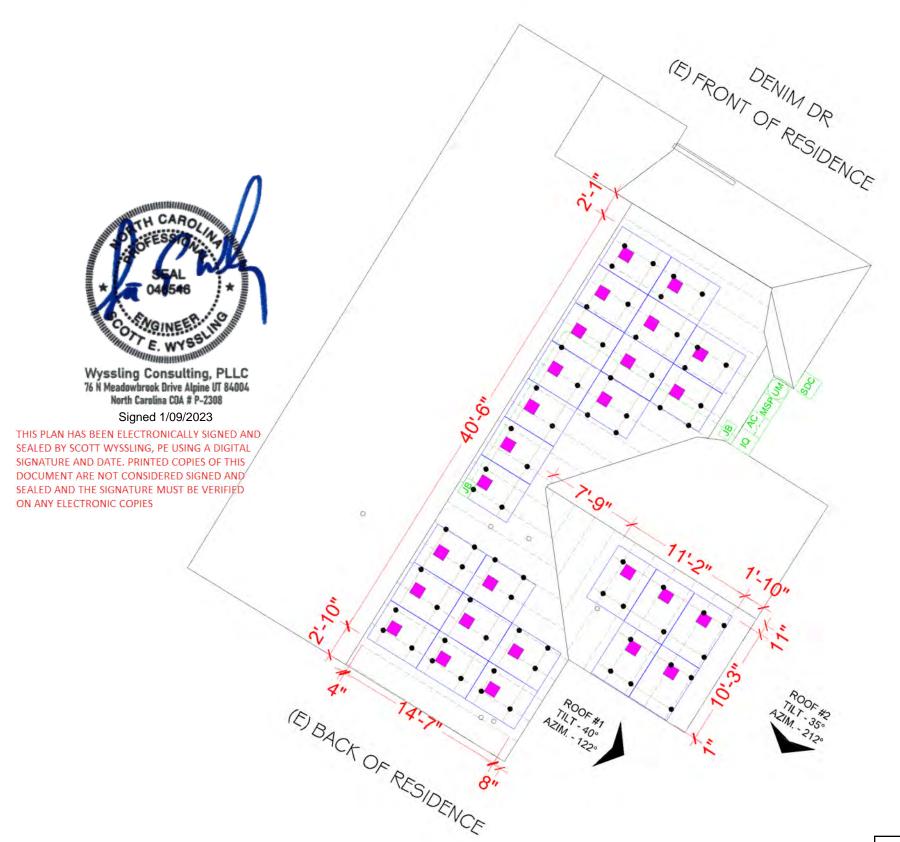


LGCY POWER

LGCY POWER

3333 DIGITAL DR#600, LEHI.

LGCY POWER
3333 DIGITAL DR#600, LEHI,
UT 84043, UNITED STATES
PH#: (855) 353-4899

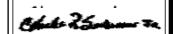

ELECTRICAL LIC#: U.21498

SYSTEM INFO (26) APTOS DNA-120-MF10-440W

(26) ENPHASE IQ8PLUS -72-2-US (240V)

DC SYSTEM SIZE: 11.440 kWDC
AC SYSTEM SIZE: 7.540 kWAC

METER: 332 302 331

REVISIONS									
ESCRIPTION	DATE	REV							

PROJECT NAME & ADDRESS

705 DENIM DR, ERWIN, NC 28339, USA EMAIL ID: SHANAMONK76@GMAIL.COM PHONE NO. (910) 723-3810

RESIDENCE

DATE: 9/1/2022


SHEET NAME

ROOF PLAN


SHEET SIZE

ANSI B 11" X 17"

SHEET NUMBER

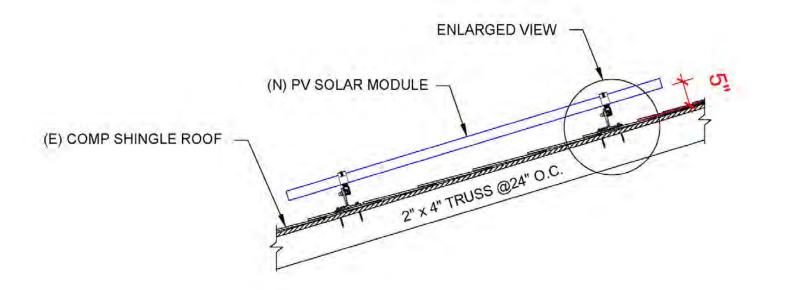

1 ATTACHMENT DETAILS

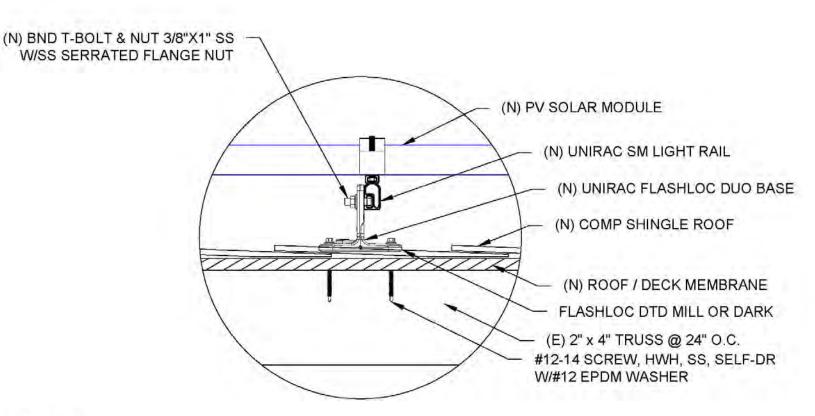



Wyssling Consulting, PLLC
76 N Meadowbrook Drive Alpine UT 84004
North Carolina CDA # P-2308
Signed 1/09/2023

THIS PLAN HAS BEEN ELECTRONICALLY SIGNED AS SEALED BY SCOTT WYSSLING, PE USING A DIGITAL SIGNATURE AND DATE. PRINTED COPIES OF THIS DOCUMENT ARE NOT CONSIDERED SIGNED AND SEALED AND THE SIGNATURE MUST BE VERIFIED ON ANY ELECTRONIC COPIES

LGCY POWER

LGCY POWER
3333 DIGITAL DR#600, LEHI,
UT 84043, UNITED STATES
PH#: (855) 353-4899



ELECTRICAL LIC#: U.21498

SYSTEM INFO

(26) APTOS DNA-120-MF10-440W

(26) ENPHASE IQ8PLUS -72-2-US (240V)

DC SYSTEM SIZE: 11.440 kWDC

AC SYSTEM SIZE: 7.540 kWAC

METER: 332 302 331

REVISIONS										
ESCRIPTION	DATE	REV								

PROJECT NAME & ADDRESS

RESIDENCE 705 DENIM DR, ERWIN, NC 28339, USA EMAIL ID: SHANAMONK76@GMAIL.COM PHONE NO. (910) 723-3810

WADE

DATE: 9/1/2022

SHEET NAME

ATTACHMENT DETAILS


SHEET SIZE

ANSI B 11" X 17"

SHEET NUMBER

PV-4

2 ENLARGED VIEW OF ATTACHMENT
SCALE: NTS

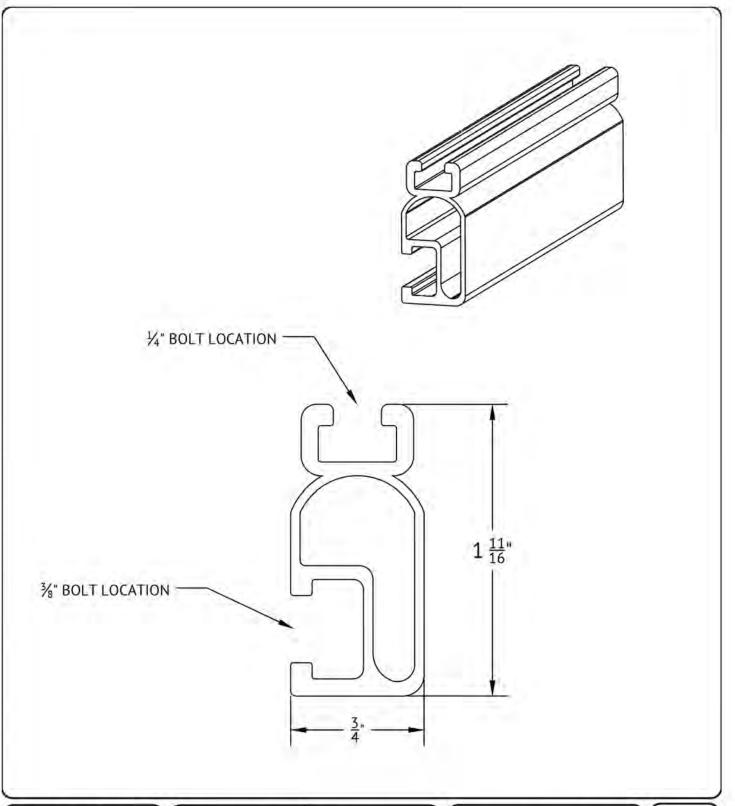



Wyssling Consulting, PLLC 76 N Meadowbrook Drive Alpine UT 84004 North Carolina COA # P-2308

Signed 1/09/2023

THIS PLAN HAS BEEN ELECTRONICALLY SIGNED AND SEALED BY SCOTT WYSSLING, PE USING A DIGITAL SIGNATURE AND DATE. PRINTED COPIES OF THIS DOCUMENT ARE NOT CONSIDERED SIGNED AND SEALED AND THE SIGNATURE MUST BE VERIFIED ON ANY ELECTRONIC COPIES

#UNIRAC

1411 BROADWAY BLVD NE ALBUQUERQUE, NM 87102 USA

WWW.UNIRAC.COM

PRODUCT LINE: SOLARMOUNT

DRAWING TYPE: PART DETAIL

DESCRIPTION: LIGHT RAIL

REVISION DATE: APRIL 2016

DRAWING NOT TO SCALE ALL DIMENSIONS ARE NOMINAL

PRODUCT PROTECTED BY ONE OR MORE US PATENTS

LEGAL NOTICE

SM-P02

SHEET

4 LGCY POWER

LGCY POWER
3333 DIGITAL DR#600, LEHI,
UT 84043, UNITED STATES
PH#: (855) 353-4899



ELECTRICAL LIC#: U.21498

SYSTEM INFO

(26) APTOS DNA-120-MF10-440W

(26) ENPHASE IQ8PLUS -72-2-US (240V)

DC SYSTEM SIZE: 11.440 kWDC

AC SYSTEM SIZE: 7.540 kWAC

METER: 332 302 331

REVISIONS												
DESCRIPTION	DATE	REV										

PROJECT NAME & ADDRESS

RESIDENCE 705 DENIM DR, ERWIN, NC 28339, USA EMAIL ID: SHANAMONK76@GMAIL.COM PHONE NO. (910) 723-3810

WADE

DATE: 9/1/2022

SHEET NAME


ATTACHMENT DETAILS

SHEET SIZE

ANSI B 11" X 17"

SHEET NUMBER

	ID	TYPICAL	INITIAL CONDUCTOR LOCATION	FINAL CONDUCTOR LOCATION		CONDUCTO	R	CONDUIT	# OF PARALLEL CIRCUITS	CURRENT-CARRYING CONDUCTORS IN CIRCUIT	CONDUIT FILL PERCENT	OCPD	E	GC		. CORR. CTOR	CONDUIT FILL FACTOR	CONT. CURRENT	MAX. CURRENT		AMP.	TERM. TEMP. RATING	LENGTH	VOTAGE DROP	4 LGCY POWER
	1	2	ARRAY	JUNCTION BOX	12 AWG	Q CABLE	COPPER	-	1	2	N/A	N/A	6 AWG	BARE COPPER	0.71	(57°C)	N/A	15.73A	19.66A	N/A	N/A	75°C	64FT	0.76%	LGCY POWER 3333 DIGITAL DR#600, LEHI, UT 84043, UNITED STATES
	2	1	JUNCTION BOX	JUNCTION BOX 1	12-2 GAUGE	ROMEX	COPPER	-	1	2	N/A	N/A	6 AWG	THWN-2 COPPER	0.71	(57°C)	N/A	15.73A	19.66A	N/A	N/A	75°C	30FT	0.76%	PH# : (855) 353-4899
П	3	1	JUNCTION BOX 1	IQ COMBINER BOX	8 AWG	THWN 2	COPPER	MIN 0.75" DIA EMT	2	4	36.21%	40A	6 AWG	THWN-2 COPPER	0.96	(35°C)	0.8	31.46A	39.33A	55A	42.24A	75°C	12FT	0.13%	Chile 25 mars to
	4	1	IQ COMBINER BOX	NON FUSED AC DISCONNECT	8 AWG	THWN 2	COPPER	MIN 0.75" DIA EMT	1	3	29.46%	N/A	6 AWG	THWN-2 COPPER	0.96	(35°C)	1	31.46A	39.33A	55A	52.80A	75°C	5FT	0.11%	ELECTRICAL LIC#: U.21498
	5	1	NON FUSED AC DISCONNECT	MSP	8 AWG	THWN 2	COPPER	MIN 0.75" DIA EMT	1	3	29.46%	N/A	6 AWG	THWN-2 COPPER	0.96	(35°C)	1	31.46A	39.33A	55A	52.80A	75°C	5FT	0.11%	ELECTRICAL LIGH. 0.21490
	6	1	MSP	SUB PANEL DISCONNECT	3/0 AWG	THWN 2	COPPER	MIN 2" DIA EMT	1	3	9.87%	200A	6 AWG	THWN-2 COPPER	0.96	(35°C)	1	31.46A	200A	225A	216.00A	75°C	5FT	0.16%	

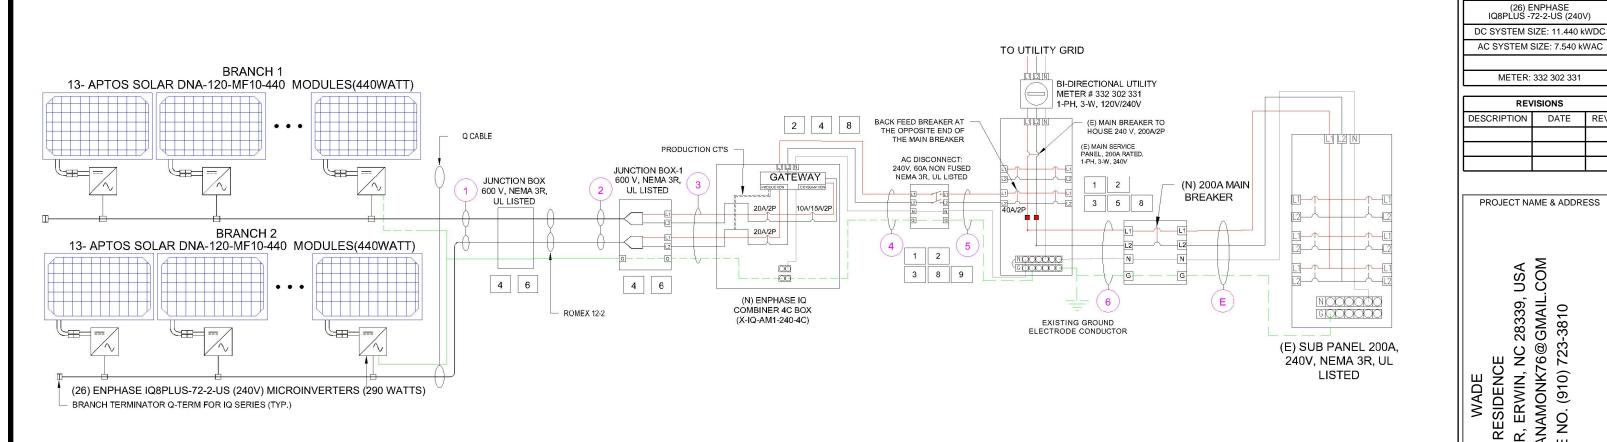

UTILITY PROVIDER:	PROGRESS
AHJ NAME:	ERWIN TOWN
MAIN SERVICE VOLTAGE:	240V
MAIN PANEL BRAND:	CUTLER HAMMER
MAIN SERVICE PANEL:	200 A
MAIN BREAKER RATING:	200 A
MAIN SERVICE LOCATION:	EAST

SERVICE INFO LITH ITY DDAVIDED DLIKE ENERGY SERVICE FEED SOURCE: UNDERGROUND

INTERCONNECTION 120% RULE - NEC 705.12(B)(2)(3)(b) UTILITY FEED + SOLAR BACKFEED

200A + 40A = 240A

BUSS RATING X 120% $200A \times 120\% = 240A$

METER NO#: 332 302 331 SCALE: NTS

705 DENIM DR, ERWIN, NC 28339, USA EMAIL ID: SHANAMONK76@GMAIL.COM PHONE NO. (910) 723-3810 DATE: 9/1/2022 SHEET NAME SHEET SIZE ANSI B

SYSTEM INFO (26) APTOS DNA-120-MF10-440W

METER: 332 302 331

REVISIONS

DATE

ELECTRICAL LINE & CALCS.

11" X 17"

SHEET NUMBER

SOLAR MODULE SPECIFICATIONS			
MANUFACTURER / MODEL	APTOS DNA-120-MF10-440W		
VMP	33.82 V		
IMP	13.01 A		
VOC	40.8 V		
ISC	13.61 A		
TEMP. COEFF. VOC	-0.31%/K		
PTC RATING	406 W		
MODULE DIMENSION	74.92"(L) x 44.65"(W)		
PANEL WATTAGE	440 W		

INVERTER SPECIFICATIONS			
MANUFACTURER / MODEL	ENPHASE IQ8PLUS -72-2-US (240V)		
MAX DC SHORT CIRCUIT CURRENT	15 A		
CONTINUOUS OUTPUT CURRENT	1.21 A		

AMBIENT TEMPERATURE SPECS				
RECORD LOW TEMP	-10°C			
AMBIENT TEMP (HIGH TEMP 2%)	35°C			
CONDUIT HEIGHT	7/8"			
ROOF TOP TEMP	90°C			
CONDUCTOR TEMPERATURE RATE	57°C			
MODULE TEMPERATURE COEFFICIENT OF VOC	-0.31%/K			
·				

PERCENT OF VALUES	NUMBER OF CURRENT CARRYING CONDUCTORS IN EMT
0.80	4-6
0.70	7-9
0.50	10-20

VOLTAGE RISE IN Q CABLE FROM THE MICROINVERTERS TO THE JUNCTION BOX

FOR BRANCH CIRCUIT #1 OF 13 IQ8PLUS MICROS, THE VOLTAGE RISE ON THE 240 VAC Q CABLE IS 0.76% FOR BRANCH CIRCUIT #2 OF 13 IQ8PLUS MICROS, THE VOLTAGE RISE ON THE 240 VAC Q CABLE IS 0.76%

VOLTAGE RISE FROM THE JUNCTION BOX 1 TO THE IQ COMBINER BOX

VRISE = (AMPS/INVERTER X NUMBER OF INVERTERS) X (RESISTANCE IN OHMS/FT.) X (2-WAY WIRE LENGTH IN FT.)

- = (1.21 AMP X 13) X (0.000809 OHMS/FT) X (12 FT X 2)
- = 15.73 AMPS X 0.000809 OHMS/FT) X 24 FT
- = 0.31 VOLTS

%VRISE = 0.31 VOLTS ÷ 240 VOLTS = 0.13%

THE VOLTAGE RISE FROM THE JUNCTION BOX 1 TO THE IQ COMBINER BOX IS 0.13%

VOLTAGE RISE FROM THE IQ COMBINER BOX TO THE NON FUSED AC DISCONNECT

VRISE = (AMPS/INVERTER X NUMBER OF INVERTERS) X (RESISTANCE IN OHMS/FT.) X (2-WAY WIRE LENGTH IN FT.)

- = (1.21 AMP X 26) X (0.000809 OHMS/FT) X (5 FT X 2)
- = 31.46 AMPS X 0.000809 OHMS/FT) X 10 FT
- = 0.25 VOLTS

%VRISE = 0.25 VOLTS ÷ 240 VOLTS = 0.11%

THE VOLTAGE RISE FROM THE IQ COMBINER BOX TO THE NON FUSED AC DISCONNECT IS 0.11%

VOLTAGE RISE FROM THE NON FUSED AC DISCONNECT TO THE MSP

VRISE = (AMPS/INVERTER X NUMBER OF INVERTERS) X (RESISTANCE IN OHMS/FT.) X (2-WAY WIRE LENGTH IN FT.)


- = (1.21 AMP X 26) X (0.000809 OHMS/FT) X (5 FT X 2)
- = 31.46 AMPS X 0.000809 OHMS/FT) X 10 FT
- = 0.25 VOLTS

%VRISE = 0.25 VOLTS ÷ 240 VOLTS = 0.11%

THE VOLTAGE RISE FROM THE NON FUSED AC DISCONNECT TO THE MSP IS 0.11%

TOTAL SYSTEM VOLTAGE RISE FOR ALL WIRE SECTIONS

0.76% + 0.13% + 0.11% + 0.11% = 1.11%

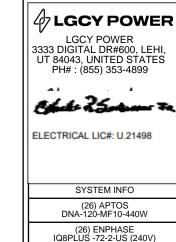

REV	REVISIONS				
DESCRIPTION	DATE	REV			

DC SYSTEM SIZE: 11.440 kWDC

AC SYSTEM SIZE: 7.540 kWAC

METER: 332 302 331

PROJECT NAME & ADDRESS

RESIDENCE
705 DENIM DR, ERWIN, NC 28339, USA
EMAIL ID: SHANAMONK76@GMAIL.COM
PHONE NO. (910) 723-3810

DATE: 9/1/2022

SHEET NAME

SPECIFICATIONS & NOTES

SHEET SIZE

ANSI B 11" X 17"

SHEET NUMBER





ution-Hammer

MB816B200BTS MB816P200BTSD
MB816B200BTSD
MB816B200BTSCU
MB816P200BTSCU

MB816P200BTSCUD

200 AMPS MAX
USE HAIN CROUT BREMIN HATMON
MAX 200 AMPS
WERE CARREST AND DISH, INTOR PRINCIPAL

120/245 VAC 1 PHASE-3W V~12/245, 60 HZ MONOFASIOA 3 HIEF S 7/120 VAC 1 PHASE-3W

V. 208Y/120, 60 HZ MONOFÁSICA-3 HTC IS

TYPE 3R ENCLOSURE-OUTDOOR GABINETE TIPO 3R - PARA EXTERIOS ES

SHORT CIRCUIT RATING WITH MAIN BREAKER:

10,000 AMPS WITH CUTLER HAMMER TYPE BY MAIN OR

127.0 AMPS WITH CUTLER HAMMER TYPE BWH MAIN OR

127.0 AMPS WITH CUTLER HAMMER TYPE BWH MAIN OR

127.0 AMPS WITH CUTLER HAMMER TYPE BW

TO A CC. BEYONTOR PRINCES OF THE RANGER THE BWO CSRMANO
THE A CCN DISYUNTOR PRINCES AL CUTLER-HAMMER TIPO BWH Y
THE A CCN DISYUNTOR PRINCES AL CUTLER-HAMMER TIPO BWH Y
TO BE A CCN DISYUNTOR PRINCES AL CUTLER-HAMMER TIPO BWH Y
TO BE A CCN DISYUNTOR PRINCES AL CUTLER-HAMMER TIPO BWH Y
TO BE A CCN DISYUNTOR

SHALL OR REPLACEMENT BREAKERS SHALL
IF THE AME MANUFACTURER AND TYPE AND
SHALL HAVE AN INTERRUPTING RATING LOUAL TO
CREATER THAN THE INTERRUPTING RATING
ANY CIRCUIT BREAKER INSTALLED
DISYUNTORES ADICIONALES OF ALPUESTO

PÁN SER DE LA MISMA MARCA Y TIPO Y T. MER UNA CAPACIDAD DE INTERRUPCIÓN IGUAL SUPERIOR A LA DE GUALQUIER DISTUNTOR STALADO

WATTHOUR METER NOT INCLUDED IN SHORT CIPCUIT RATING.

EL VATICHOISMETRO NO ESTA INCLUDIO EN LA ENPACIDAD DE CORTOCIRCUITO.

BREAKER HANDLE IN MID-POSITION INDICATES
SIN ASSLUT DE RETENCION
MAIN BREAKER
DISTUNTOR PRINCIPAL
MOVE HANDLE TO EXTREME OFF, THEN TO ON.

MATERIAL

INSTALLMAIN BREAKER
INSTAL

JISTICADO DISYUNTOR FRINCIPA

MAIN BREMER

THE SUNTOF PRINCIPAL

INSTALL MAIN BREAKER

INSTALL DO DISTRIBUTOR PRINCIPAL

NESTALL MAIN BREAKER

(CJ) COPPER BUS

GUI BURRAS A MENTADORAS DE COSRE

(D) SIN JAW INSTALLED

(MACUNITA NORQUZE

VENE MSTANSO

PUEDE HABILITARSE PARA CONECTAR EL EQUIPO A TIERRA. LOS ORIFICIOS DE CABLEADO ADMITEN UN CONDUCTOR N 14-4 O HASTA TRES NÚM. 10-14. LOS DIFERENTES HILOS INSERTOS EN UN SOLO ORIFICIO DEBEN SER DEL MISMO CALIBRE Y MATERIAL.

CUALQUIERA DE LOS ORIFICIOS NEUTROS NO UTILZADOS

DISPARADO, PARA RESTABLECER EL SERVICIO, MOVER"

LA PALANCA AL EXTREMEO <<OFF>>, LUEGO A <<ON>>

UNUSED NEUTRAL HOLES MAY BE USED FOR

EQUIPMENT GROUNDING. WIRE HOLES ARC

#10-14 WIRES. MULTIPLE WIRES IN A SINGLE

HOLE MUST BE OF THE SAME SIZE AND

CUANDO SE COMO EQUIPO DE SERVICIO,

SUITABLE FOR (1) 14-4 OR UP TO (3)

WHEN USED AS SERVICE EQUIPMENT, ANY

INSTALLATION AND USE OF THIS EQUIPMENT SHOULD BE IN ACCORDANCE WITH ALL APPLICABLE LOCAL AND NATIONAL CODES.

LA INSTALACIÓN Y EL USO DE ESTE EQUIPO DEBERÁN AJUSTARSE A TODOS LOS CÓDIGOS LOCALES Y NACIONALES APLICABLES.

TO CLOSE UNUSED OPENINGS IN COVER-USE CUTLER-HAMMER CAT, NO. BRFP.

PARA CUBRIR LAS ABERTURAS NO EMPLEADAS EN LA CUBIERTA, UTILIZAR EL NÚM. DE CAT. BREP DE CUTLER-HAMMER.

SUITABLE FOR UNDERGROUND OR OVERHEAD SERVICE ENTRY. APTO PAPA ENTRALMS DE GERVICIO SUBTERRÁNEAS O AÉREAS.

BREAKER TERMINALS SUITABLE FOR AL-CU WIRE WHEN SO MARKED, REFER TO MARKINGS ON BREAKERS.

LOS BORNÉS DEL DISYUNTOR SON APTOS PARA CABLE CU/AL CJANDO ESTÁ ASÍ INDICADO. VER LAS MARCAS ESTAMPADAS EN LOS DISYUNTORES.

METER SOCKET RATED 200 AMPS CONTINUOUS
UNLESS NOTED
ANOTOLOS DE MEDICIÓN: 200 A EN RÉGIMENTE SMANENTE
A MENOS QUE RE LO INDIQUE

LGCY POWER

3333 DIGITAL DR#600, LEHI, UT 84043, UNITED STATES PH#: (855) 353-4899



ELECTRICAL LIC#: U.21498

SYSTEM INFO

(26) APTOS DNA-120-MF10-440W

E

WIF

60

CABL

AWA

#1

#3

#6-3

(26) ENPHASE IQ8PLUS -72-2-US (240V)

Q8PLUS -72-2-US (240V)

DC SYSTEM SIZE: 11.440 kWDC AC SYSTEM SIZE: 7.540 kWAC

METER: 332 302 331

REVISIONS				
ESCRIPTION	DATE	REV		

PROJECT NAME & ADDRESS

RESIDENCE 705 DENIM DR, ERWIN, NC 28339, USA EMAIL ID: SHANAMONK76@GMAIL.COM PHONE NO. (910) 723-3810

DATE: 9/1/2022

SHEET NAME

ELECTRICAL PHOTOS

SHEET SIZE

ANSI B 11" X 17"

SHEET NUMBER



LABEL LOCATION:

MAIN SERVICE PANEL/MAIN SERVICE DISCONNECT/AC DISCONNECT PER CODE: NEC 690.13(B)

2



ELECTRIC SHOCK HAZARD

TERMINALS ON BOTH LINE AND LOAD SIDES MAY BE ENERGIZED IN THE OPEN POSITION

LABEL LOCATION:

POINT OF INTERCONNECTION, MAIN SERVICE DISCONNECT, AC DISCONNECT, AC COMBINER, INVERTER

PER CODE: NEC 690.13(B)

3

WARNING

INVERTER OUTPUT CONNECTION DO NOT RELOCATE THIS OVERCURRENT DEVICE

LABEL LOCATION:


PLACE THIS LABEL AT P.O.C. TO SERVICE DISTRIBUTION EQUIPMENT (I.E. MAIN PANEL (AND SUBPANEL IF APPLICABLE))

PER CODE: NEC705.12(D)(2)(b)

4

SOLAR PV SYSTEM EQUIPPED WITH RAPID SHUTDOWN

TURN RAPID SHUTDOWN SWITCH TO THE "OFF" POSITION TO SHUT DOWN PV SYSTEM AND REDUCE SHOCK HAZARD IN THE ARRAY

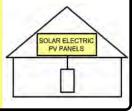

LABEL LOCATION:

MAIN SERVICE DISCONNECT IF MSD IS OUTSIDE PLACE IT THERE / IF MSD IS INSIDE PLACE ON THE AC DISCONNECT

PER CODE: NEC 690.56(C)(1)(a)

5

CAUTION: SOLAR CIRCUIT

LABEL LOCATION:

MARKINGS PLACED ON ALL INTERIOR AND EXTERIOR CONDUIT, RACEWAYS, ENCLOSURES, AND CABLE ASSEMBLIES AT LEAST EVERY 10 FT, AT TURNS AND ABOVE/BELOW PENETRATIONS AND ALL COMBINER/JUNCTION BOXES PER CODE: IFC 606.11.1.4

6

CAUTION: SOLAR ELECTRIC SYSTEM CONNECTED

LABEL LOCATION

POINT OF INTERCONNECTION & INVERTER PER CODE: NEC 690.15 & 690.13(B)



WARNING - Electric Shock Hazard

No user serviceable parts inside

Contact authorized service provider for assistance

LABEL LOCATION:

INVERTER & JUNCTION BOXES (ROOF)
PER CODE: NEC 690.13 (G)(3) & 690.13 (G)(4)

8

WARNING: PHOTOVOLTAIC POWER SOURCE

LABEL LOCATION:

CONDUIT

PER CODE: 2017 NEC 690.31(G)(3)

9



DUAL POWER SOURCE SECOND SOURCE IS PHOTOVOLTAIC

LABEL LOCATION:

MAIN SERVICE DISCONNECT/ AC DISCONNECT/ MAIN SERVICE PANEL/ REVENUE METER/ AC COMBINER

PER CODE: NEC 705.12(B)(3)

10

PHOTOVOLTAIC SYSTEM UTILITY DISCONNECT SWITCH

LABEL LOCATION: AC DISCONNECT

AC DISCONNECT PER CODE: NEC 690.56(C)(3)

1339, USA MAIL.COM 810

SYSTEM INFO

(26) APTOS
DNA-120-MF10-440W

(26) ENPHASE
IQ8PLUS -72-2-US (240V)

DC SYSTEM SIZE: 11.440 kWDC

AC SYSTEM SIZE: 7.540 kWAC

4 LGCY POWER

LGCY POWER

3333 DIGITAL DR#600, LEHI, UT 84043, UNITED STATES

PH#: (855) 353-4899

REVISIONS

DESCRIPTION DATE REV

METER: 332 302 331

PROJECT NAME & ADDRESS

RESIDENCE
705 DENIM DR, ERWIN, NC 28339, USA
EMAIL ID: SHANAMONK76@GMAIL.COM
PHONE NO. (910) 723-3810

DATE: 9/1/2022

SHEET NAME

SIGNAGE

SHEET SIZE


ANSI B 11" X 17"

SHEET NUMBER

PV-9

ADHESIVE FASTENED SIGNS

- THE LABEL SHALL BE SUITABLE FOR THE ENVIRONMENT WHERE IT IS INSTALLED.
- WHERE REQUIRED ELSEWHERE IN THIS CODE, ALL FIELD APPLIED LABELS, WARNING AND MARKINGS SHOULD COMPLY WITH ANSI 2535.4 [NEC 110.21(B) FIELD MARKING].
- ADHESIVE FASTENED SIGNS MAY BE ACCEPTABLE IF PROPERLY ADHERED. VINYL SIGNS SHALL BE WEATHER RESISTANT [IFC 605.11.1.3]

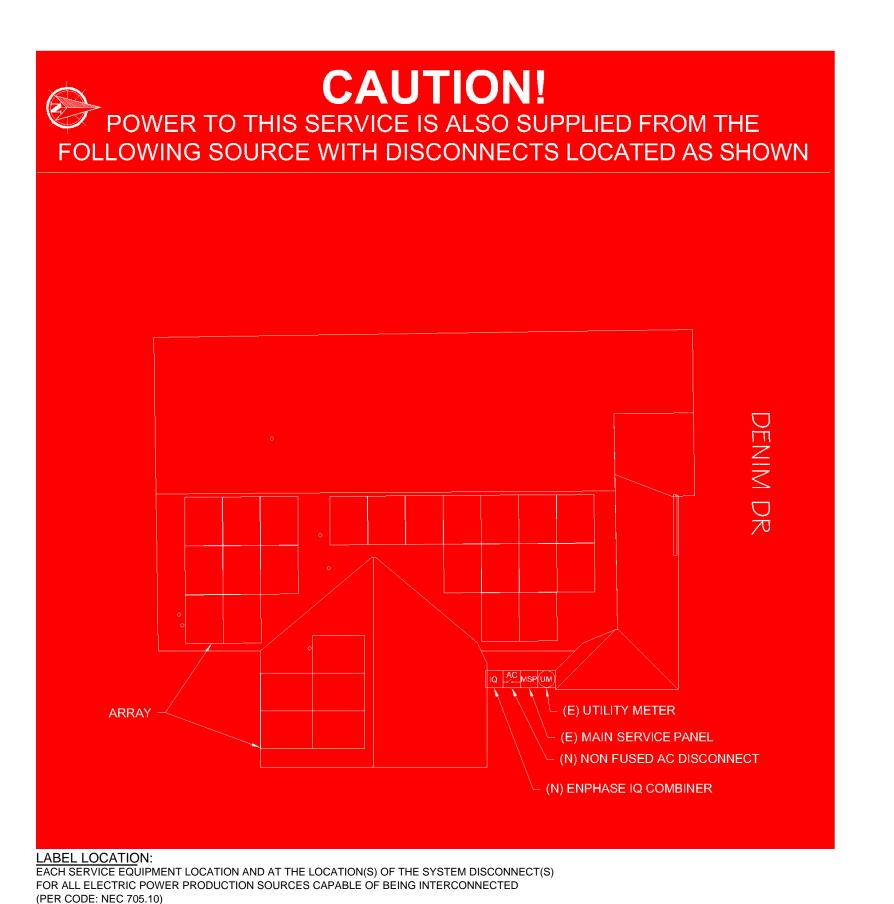

4 LGCY POWER

LGCY POWER
3333 DIGITAL DR#600, LEHI,
UT 84043, UNITED STATES
PH#: (855) 353-4899



ELECTRICAL LIC#: U.21498

SYSTEM INFO

(26) APTOS DNA-120-MF10-440W

(26) ENPHASE IQ8PLUS -72-2-US (240V)

DC SYSTEM SIZE: 11.440 kWDC

AC SYSTEM SIZE: 7.540 kWAC

METER: 332 302 331

REVISIONS				
DESCRIPTION	DATE	REV		

PROJECT NAME & ADDRESS

RESIDENCE 705 DENIM DR, ERWIN, NC 28339, USA EMAIL ID: SHANAMONK76@GMAIL.COM PHONE NO. (910) 723-3810

DATE: 9/1/2022

SHEET NAME

SIGNAGE

SHEET SIZE

ANSI B 11" X 17"

SHEET NUMBER



DATE

FIELD DESIGN REQUEST FORM

CUSTOMER NAME

IOR INCORMATION		
JOB INFORMATION		
JOB NAME:		
ADDRESS:		
CHANGE REQUEST:	·	
WHO AUTHORIZED THE CHANGE:		
DESCRIBE THE NEEDED CHANGE & WHY:		
NEW DESIGN LAYOUT:		
DRAW THE MOUNTING PLANE SHOWING THE NE	W MODULE LAYOUT:	
DIAN THE MODITING TENESTICS THE RE	T WODGE ENTOO!	
INSTALLER NAME (PRINT)		
I UNDERSTAND AND AGREE TO THE CHANGES M	IADE ABOVE	

CUSTOMER SIGNATURE



JOB HAZARD ANALYSIS

CUSTOMER NAME/JOB I	D:			
CUSTOMER ADDRESS:				
INSTALL DATE:	1.6	TIME:	am/pm	

HAZARD CATEGORY	HAZARD TYPE	HAZARD CONTROL MEASURES
LADDER SAFETY	LOCATION CONDITION WORKING CLEARANCE	
FALL PROTECTION	WORKING 6' OR HIGHER	
ELECTRICAL SAFETY	ARCH FLASH ELECTRIC SHOCK/ELECTROCUTION	
WEATHER CONDITIONS	HEAT/COLD TEMP RAINY/ICY/WINDY	
PUBLIC SAFETY	WORK/OBJECTS OVERHEAD SLIPS/TRIPS/FALLS ACCESS TO LIVE ELECTRICAL	

NEAREST EMERGENCY FACILITY	
CONTACT IMMEDIATELY IN EMERGENCY (911 AND/OR)	

GENERAL SITE DESCRIPTION/NOTES

CREW MEMBERS ON SITE FOR INSTALL

NAME	SIGNATURE	
FMU/LMD-		
	34 (1	

ELECTRICAL COMPLETION PHOTOS QR CODE



ROOFTOP INSTALLATION PHOTOS QR CODE



MPU COMPLETION PHOTOS QR CODE



LGCY POWER

LGCY POWER
3333 DIGITAL DR#600, LEHI,
UT 84043, UNITED STATES
PH#: (855) 353-4899



ELECTRICAL LIC#: U.21498

SYSTEM INFO

(26) APTOS
DNA-120-MF10-440W

(26) ENPHASE
IQ8PLUS -72-2-US (240V)

DC SYSTEM SIZE: 11.440 kWDC

AC SYSTEM SIZE: 7.540 kWAC

METER: 332 302 331

REVISIONS				
DESCRIPTION	DATE	REV		

PROJECT NAME & ADDRESS

WADE RESIDENCE 705 DENIM DR, ERWIN, NC 28339, USA EMAIL ID: SHANAMONK76@GMAIL.COM PHONE NO. (910) 723-3810

DATE: 9/1/2022

SHEET NAME

JOB HAZARD ANALYSIS

SHEET SIZE

ANSI B 11" X 17"

SHEET NUMBER


Solar for Innovators



Designed & Engineered in Silicon Valley 440W | 435W | 430W

Our DNA Split Cell Series uses advanced selective emitter PERC technology with thin film layers to improve heat tolerance, increase photon capture, minimize resistive loss, and use 5% more of the available active area for optimal power performance. Our panels exceed IEC standards and come with an industry leading, 30-year warranty.

Linear Performance Warranty

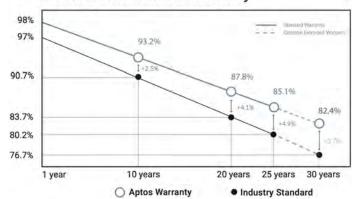

Features



Advanced Technology

Patented DNA™ technology boosts power performance & module efficiency



Maximum Panel Density

Advanced split cell technology with 9 ultra-thin busbars allows for less resistance and more photon capture



Durable Design

Robust product design is resilient in extreme weather. Up to 5400 Pa snow load and 5400 Pa wind load



A Safe Investment

Industry leading 30 year warranty





3140 De La Cruz Blvd., Ste 200 Santa Clara, CA 95054 www.aptossolar.com | info@aptossolar.com

DNATM 120





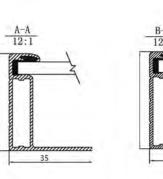

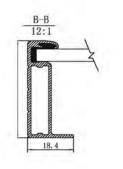



Electrical Specifications	DNA-120-MF10-440W	DNA-120-MF10-445W	DNA-120-MF10-440W
STCrated Output P _{mop} (W)	440W	445W	450W
Module Efficiency	20.39%	20.62%	20.85%
Open Circuit Voltage V _{voc} (V)	40.80	41.10	41.34
Short Circuit Current I _{sc} (A)	13.61	13.70	13.80
Rated Voltage V _{mate} (V)	33.82	34.02	34.16
Rated Voltage I _{max} (A)	13.01	13.09	13.17
Standard Test Conditions for front-face of panel: 1000 V	I/m², 25°C, measurement un	certainty < 3%	

Temperature Coefficients	
Temperature Coefficients P _{mmp}	-0.35%/°C
Temperature Coefficients I	+0,06%/°C
Temperature Coefficients V _{DC}	-0.31%/°C
Nominal Operating Cell Temperature (NOCT)	45°C

	Test Operating Conditions		
	Maximum Series Fuse	25A	Ī
	Maximum System Völtage	1,500 VDC (UL&IEC)	
	Maximum Load Capacity (Per UL 1703)	5400 PA Snow Load / 5400 Pa Wind Load	
	Fire Performance Class	Class C/Type 1	
Š,			1

Packaging Configuration	
Number of Modules per Pallet	31
Number of Pallets per 40ft. Container	24
Pallet Dimensions	2030 X 1220 X 1200
Pallet Weight (kg)	766
Container Weight (kg)	18,384

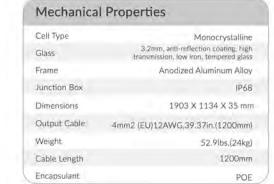

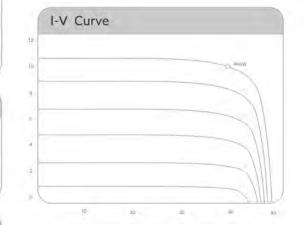





LGCY POWER 3333 DIGITAL DR#600, LEHI, UT 84043, UNITED STATES PH#: (855) 353-4899

4 LGCY POWER

ELECTRICAL LIC#: U.21498

SYSTEM INFO (26) APTOS DNA-120-MF10-440W

(26) ENPHASE IQ8PLUS -72-2-US (240V)

DC SYSTEM SIZE: 11.440 kWDC AC SYSTEM SIZE: 7.540 kWAC

METER: 332 302 331

REVISIONS				
DESCRIPTION	DATE	REV		

PROJECT NAME & ADDRESS

705 DENIM DR, ERWIN, NC 28339, USA EMAIL ID: SHANAMONK76@GMAIL.COM PHONE NO. (910) 723-3810 RESIDENCE

DATE: 9/1/2022

SHEET NAME

EQUIPMENT SPECIFICATIONS

SHEET SIZE

ANSI B 11" X 17"

SHEET NUMBER







IQ8 and IQ8+ Microinverters

Our newest IQ8 Microinverters are the industry's first microgrid-forming, softwaredefined microinverters with split-phase power conversion capability to convert DC power to AC power efficiently. The brain of the semiconductor-based microinverter is our proprietary application-specific integrated circuit (ASIC) which enables the microinverter to operate in grid-tied or off-grid modes. This chip is built in advanced 55nm technology with high speed digital logic and has super-fast response times to changing loads and grid events, alleviating constraints on battery sizing for home energy systems.



Part of the Enphase Energy System, IQ8 Series Microinverters integrate with the Enphase IQ Battery, Enphase IQ Gateway, and the Enphase App monitoring and analysis software.



Connect PV modules quickly and easily to IQ8 Series Microinverters using the included Q-DCC-2 adapter cable with plug-n-play MC4 connectors.



IQ8 Series Microinverters redefine reliability standards with more than one million cumulative hours of power-on testing, enabling an industry-leading limited warranty of up to 25 years.



IQ8 Series Microinverters are UL Listed as PV Rapid Shut Down Equipment and conform with various regulations, when installed according to manufacturer's instructions.

© 2021 Enphase Energy. All rights reserved. Enphase, the Enphase logo, IQ8 microinverters, and other names are trademarks of Enphase Energy, Inc. Data subject to change.

IQ8SP-DS-0002-01-EN-US-2021-10-19

Easy to install

- · Lightweight and compact with plug-n-play connectors
- · Power Line Communication (PLC) between components
- · Faster installation with simple two-wire cabling

High productivity and reliability

- · Produce power even when the grid is down
- More than one million cumulative hours of testing
- · Class II double-insulated enclosure
- · Optimized for the latest highpowered PV modules

Microgrid-forming

- · Complies with the latest advanced grid support
- · Remote automatic updates for the latest grid requirements
- · Configurable to support a wide range of grid profiles
- Meets CA Rule 21 (UL 1741-SA) requirements

IQ8 and IQ8+ Microinverters

INPUT DATA (DC)		108-60-2-05		108PLUS-72-2-US
Commonly used module pairings ¹	W	235 - 350		235 - 440
Module compatibility		60-cell/120 half-cell		60-cell/120 half-cell and 72-cell/144 half-cell
MPPT voltage range	V	27 - 37		29 - 45
Operating range	V	25 - 48		25 - 58
Min/max start voltage	v	30 / 48		30 / 58
Max input DC voltage	V	50		60
Max DC current ² [module lsc]	А		15	
Overvoltage class DC port			II	
DC port backfeed current	mA		0	
PV array configuration		1x1 Ungrounded array; No additional DC side prof	ection required;	AC side protection requires max 20A per branch circu

DUTPUT BATA (AC)		108-60-2-05		108PLUS-72-2-US
Peak output power	VA	245		300
Max continuous output power	VA	240		290
Nominal (L-L) voltage/range ³	V		240 / 211 - 264	
Max continuous output current	Α	1.0		1.21
Nominal frequency	Hz		60	
Extended frequency range	Hz		50 - 68	
Max units per 20 A (L-L) branch circ	uit ⁴	16		13
Total harmonic distortion			<5%	
Overvoltage class AC port			401	
AC port backfeed current	mA		30	
Power factor setting			1.0	
Grid-tied power factor (adjustable)			0.85 leading - 0.85 lagging	
Peak efficiency	%	97.5		97.6
CEC weighted efficiency	%	97		97
Night-time power consumption	mW		60	

MECHANICAL DATA	
Ambient temperature range	-40°C to +60°C (-40°F to +140°F)
Relative humidity range	4% to 100% (condensing)
DC Connector type	MC4
Dimensions (HxWxD)	212 mm (8.3") x 175 mm (6.9") x 30.2 mm (1.2")
Weight	1.08 kg (2.38 lbs)
Cooling	Natural convection - no fans
Approved for wet locations	Yes
Acoustic noise at 1 m	<60 dBA
Pollution degree	PD3
Enclosure	Class II double-insulated, corrosion resistant polymeric enclosure
Environ. category / UV exposure rating	NEMA Type 6 / outdoor
COMPLIANCE	

CA Rule 21 (UL 1741-SA), UL 62109-1, UL1741/IEEE1547, FCC Part 15 Class B, ICES-0003 Class B, CAN/CSA-C22.2 NO. 107.1-01 Certifications This product is UL Listed as PV Rapid Shut Down Equipment and conforms with NEC 2014, NEC 2017, and NEC 2020 section

690.12 and C22.1-2018 Rule 64-218 Rapid Shutdown of PV Systems, for AC and DC conductors, when installed according to

(I) No enforced DC/AC ratio. See the compatibility calculator at https://link.enphase.com/ module-compatibility (2) Maximum continuous input DC current is 10.6A (3) Nominal voltage range can be extended beyond nominal if required by the utility. (4) Limits may vary. Refer to local requirements to define the number of microinverters per branch in your area.

IQ8SP-DS-0002-01-EN-US-2021-10-19

4 LGCY POWER LGCY POWER 3333 DIGITAL DR#600, LEHI, UT 84043, UNITED STATES

PH#: (855) 353-4899

ELECTRICAL LIC#: U.21498

SYSTEM INFO (26) APTOS DNA-120-MF10-440W

(26) ENPHASE IQ8PLUS -72-2-US (240V) DC SYSTEM SIZE: 11.440 kWDC

AC SYSTEM SIZE: 7.540 kWAC

METER: 332 302 331

REVISIONS				
ESCRIPTION	DATE	REV		

PROJECT NAME & ADDRESS

705 DENIM DR, ERWIN, NC 28339, USA EMAIL ID: SHANAMONK76@GMAIL.COM PHONE NO. (910) 723-3810 RESIDENCE

DATE: 9/1/2022

SHEET NAME

EQUIPMENT SPECIFICATIONS

SHEET SIZE

ANSI B 11" X 17"

SHEET NUMBER

Dala Sheet Enphase Networking

Enphase IQ Combiner 4/4C

X-IQ-AM1-240-4 X-IQ-AM1-240-4C

LISTED



To learn more about Enphase offerings, visit enphase.com

The Enphase IQ Combiner 4/4C with Enphase

IQ Gateway and integrated LTE-M1 cell modem (included only with IQ Combiner 4C) consolidates interconnection equipment into a single enclosure and streamlines IQ microinverters and storage installations by providing a consistent, pre-wired solution for residential applications. It offers up to four 2-pole input circuits and Eaton BR series busbar assembly.

Smart

- · Includes IQ Gateway for communication and control
- · Includes Enphase Mobile Connect cellular modem (CELLMODEM-M1-06-SP-05), included only with IQ Combiner 4C
- · Includes solar shield to match Enphase IQ Battery aesthetics and deflect heat
- · Flexible networking supports Wi-Fi, Ethernet, or cellular
- · Optional AC receptacle available for PLC bridge
- · Provides production metering and consumption monitoring

Simple

- . Centered mounting brackets support single
- · Supports bottom, back and side conduit entry
- · Up to four 2-pole branch circuits for 240 VAC plug-in breakers (not included)
- · 80A total PV or storage branch circuits

- · Durable NRTL-certified NEMA type 3R enclosure
- · Five-year limited warranty
- · Two years labor reimbursement program coverage included for both the IQ Combiner SKU's
- · UL listed



Enphase IQ Combiner 4/4C MODEL NUMBER IQ Combiner 4 (X-IQ-AM1-240-4)

IQ Combiner 4 with Enphase IQ Gateway printed circuit board for integrated revenue grade PV production metering (ANSI C12.20 +/- 0.5%) and consumption monitoring (+/- 2.5%). Includes a silver solar shield to match the IQ Battery system and IO System Controller 2 and to deflect heat. IQ Combiner 4C (X-IQ-AM1-240-4C) IQ Combiner 4C with Enphase IQ Gateway printed circuit board for integrated revenue grade PV production metering (ANSI C12.20 +/- 0.5%) and consumption monitoring (+/- 2.5%). Includes Enphase Mobile Connect cellular modern (CELLMODEM-M1-06-SP-05), a plug-and-play industrial-grade cell modem for systems up to 60 microinverters. (Available in the US, Canada, Mexico, Puerto Rico, and the US Virgin Islands, where there is adequate cellular service in the installation area.) Includes a silver solar shield to match the IQ Battery and IQ System Controller and to deflect heat,

ACCESSORIES AND REPLACEMENT PARTS (not included, order separately) Includes COMMS-KIT-01 and CELLMODEM-M1-06-SP-05 with 5-year Sprint data plan for COMMS-CELLMODEM-M1-06 - 4G based LTE-M1 cellular modern with 5-year Sprint data plan CELLMODEM-M1-06-SP-05 - 4G based LTE-M1 cellular modem with 5-year AT&T data plan CELLMODEM-M1-06-AT-05 Circuit Breakers Supports Eaton BR210, BR215, BR220, BR230, BR240, BR250, and BR260 circuit breakers. BRK-10A-2-240V Circuit breaker, 2 pole, 10A, Eaton BR210 BRK-15A-2-240V Circuit breaker, 2 pole, 15A, Eaton BR215 BRK-20A-2P-240V Circuit breaker, 2 pole, 20A, Eaton BR220 Circuit breaker, 2 pole, 15A, Eaton BR215B with hold down kit support BRK-15A-2P-240V-B Circuit breaker, 2 pole, 20A, Eaton BR220B with hold down kit support BRK-20A-2P-240V-B EPLC-01 Power line carrier (communication bridge pair), quantity - one pair XA-SOLARSHIELD-ES Replacement solar shield for IQ Combiner 4/4C XA-PLUG-120-3 Accessory receptacle for Power Line Carrier in IO Combiner 4/4C (required for EPLC-01) XA-ENV-PCBA-3 Replacement IQ Gateway printed circuit board (PCB) for Combiner 4/4C

Hold down kit for Eaton circuit breaker with screws.

ELECTRICAL SPECIFICATIONS

Rating Continuous duty 120/240 VAC, 60 Hz System voltage Eaton BR series busbar rating 125 A Max. continuous current rating 65 A 64 A Max. continuous current rating (input from PV/storage) Max. fuse/circuit rating (output) Branch circuits (solar and/or storage) Up to four 2-pole Eaton BR series Distributed Generation (DG) breakers only (not included) Max. total branch circuit breaker rating (input) 80A of distributed generation / 95A with IO Gateway breaker included Production metering CT 200 A solid core pre-installed and wired to IQ Gateway A pair of 200 A split core current transformers

X-IQ-NA-HD-125A

Consumption monitoring CT (CT-200-SPLIT) MECHANICAL DATA 37.5 x 49.5 x 16.8 cm (14.75" x 19.5" x 6.63"). Height is 21.06" (53.5 cm) with mounting brackets Dimensions (WxHxD) 7.5 kg (16.5 lbs) Weight -40° C to +46° C (-40° to 115° F) Ambient temperature range Cooling Natural convection, plus heat shield Outdoor, NRTL-certified, NEMA type 3R, polycarbonate construction Enclosure environmental rating · 20 A to 50 A breaker inputs: 14 to 4 AWG copper conductors Wire sizes 60 A breaker branch input: 4 to 1/0 AWG copper conductors Main lug combined output: 10 to 2/0 AWG copper conductors Neutral and ground: 14 to 1/0 copper conductors Always follow local code requ nents for conductor sizing To 2000 meters (6,560 feet)

INTERNET CONNECTION OPTIONS

Integrated Wi-Fi 802.11b/g/n Cellular CELLMODEM-M1-06-SP-05, CELLMODEM-M1-06-AT-05 (4G based LTE-M1 cellular modem). Note that an Enphase Mobile Connect cellular modern is required for all Ensemble installations Optional, 802.3, Cat5E (or Cal 6) UTP Ethernet cable (not included) Ethernet

COMPLIANCE

UL 1741, CAN/CSA C22.2 No. 107.1, 47 CFR, Part 15, Class B, ICES 003 Compliance, IQ Combiner Production metering: ANSI C12.20 accuracy class 0.5 (PV production) Consumption metering: accuracy class 2.5 Compliance, IQ Gateway UL 60601-1/CANCSA 22.2 No. 61010-1

To learn more about Enphase offerings, visit enphase.com

© 2021 Enphase Energy, All rights reserved. Enphase, the Enphase logo, IQ Combiner 4/4C, and other names are trademarks of Enphase Energy, Inc. Data subject to change, 10-21-2021



3333 DIGITAL DR#600, LEHI, UT 84043, UNITED STATES PH#: (855) 353-4899



ELECTRICAL LIC#: U.21498

SYSTEM INFO

(26) APTOS DNA-120-MF10-440W

(26) ENPHASE IQ8PLUS -72-2-US (240V)

AC SYSTEM SIZE: 7.540 kWAC

DC SYSTEM SIZE: 11.440 kWDC

METER: 332 302 331

REVISIONS				
ESCRIPTION	DATE	REV		

PROJECT NAME & ADDRESS

705 DENIM DR, ERWIN, NC 28339, USA EMAIL ID: SHANAMONK76@GMAIL.COM PHONE NO. (910) 723-3810 RESIDENCE **EMAIL** I

DATE: 9/1/2022

SHEET NAME

EQUIPMENT SPECIFICATIONS

= ENPHASE

SHEET SIZE

ANSI B 11" X 17"

SHEET NUMBER

FLASHLOC™ DUO



FLASHLOC™ DUO is the most versatile direct to deck and rafter attachment for composition shingle and rolled comp roofs. The all-in-one mount installs fast — no kneeling on hot roofs to install flashing, no prying or cutting shingles, no pulling nails. Simply drive the required number of screws to secure the mount and inject sealant into the base. **FLASH**LOC's patented TRIPLE SEAL technology preserves the roof and protects the penetration with a permanent pressure seal. Kitted with two rafter screws, sealant and hardware for maximum convenience (deck screws sold separately). Don't just divert water, **LOC** it out!





PROTECT THE ROOF

Install a high-strength waterproof attachment without lifting, prying or damaging shingles.

APRIL2021_FLASHLOCDUO_V1



LOC OUT WATER

With an outer shield 1 contour-conf<u>orm</u>ing gasket technology delivers a 100% waterproof connection.



HIGH-SPEED INSTALL

With an outer shield 1 contour-conforming gasket 2 and pressurized sealant chamber 3 the Triple Seal sealant into the port 4 to create a permanent pressure

FLASHLOC™ DUO

INSTALLATION GUIDE





PRE-INSTALL: CLEAN SURFACE AND MARK LOCATION

Ensure existing roof structure is capable of supporting loads prescribed in Flashloc Duo D&E Guide. Clean roof surface of dirt, debris, snow and ice.

Snap chalk lines for attachment rows. On shingle roofs, snap lines 1/4" below upslope edge of shingle coarse. This line will be used to align the upper edge of the mount.

NOTE: Space mounts per span charts found in Flashloc Duo D&E Guide.



ATTACHING TO A RAFTER: Place FLASHLOC DUO over rafter location and align upper edge of mount with horizontal chalk line. Secure mount with the two (2) provided rafter screws. BACKFILL ALL PILOT HOLES WITH SEALANT.

ATTACHING TO SHEATHING: Place FLASHLOC DUO over desired location and align upper edge of mount with horizontal chalk line. Secure mount with the two (2) provided rafter screws. Next, secure mount with four (4) deck screws by drilling through the FLASHLOC DUO deck mount hole locations. Unirac recommends using a drill as opposed to an impact gun to prevent over-tightening or stripping roof sheathing.

IMPORTANT: SECURELY ATTACH MOUNT BUT DO NOT OVERTIGHTEN SCREWS.

STEP TWO: SEAL

Insert tip of UNIRAC approved sealant into port and inject until sealant exits vent. Continue array installation, attaching rails to mounts with provided T-bolts.

NOTE: When FLASHLOC DUO is installed over gap between shingle tabs or vertical joints, fill gap/joint with sealant between mount and upslope edge of shingle course.

CUT SHINGLES AS REQUIRED: DO NOT INSTALL THE FLASHLOC SLIDER ACCROSS THICKNESS VARIATIONS GREATER THAN 1/8" SUCH AS THOSE FOUND IN HIGH DEFINITION SHINGLES.

NOTE: When installing included rail attachment hardware, torque T-bolt nut to 30 ft-lbs. NOTE: If an exploratory hole falls outside of the area covered by the sealant, flash hole accordingly.

USE ONLY UNIRAC APPROVED SEALANTS. PLEASE CONTACT UNIRAC FOR FULL LIST OF COMPATIBLE SEALANTS.





FASTER INSTALLATION. 25-YEAR WARRANTY.


FOR QUESTIONS OR CUSTOMER SERVICE VISIT UNIRAC.COM OR CALL (505) 248-2702

FASTER INSTALLATION. 25-YEAR WARRANTY.

FOR QUESTIONS OR CUSTOMER SERVICE VISIT UNIRAC.COM OR CALL (505) 248-2702

ALGCY POWER

LGCY POWER 3333 DIGITAL DR#600, LEHI, UT 84043, UNITED STATES PH#: (855) 353-4899

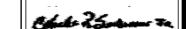

ELECTRICAL LIC#: U.21498

SYSTEM INFO

(26) APTOS DNA-120-MF10-440W

(26) ENPHASE IQ8PLUS -72-2-US (240V)

DC SYSTEM SIZE: 11.440 kWDC

AC SYSTEM SIZE: 7.540 kWAC

METER: 332 302 331

REVISIONS			
DESCRIPTION DATE REV			

PROJECT NAME & ADDRESS

705 DENIM DR, ERWIN, NC 28339, USA EMAIL ID: SHANAMONK76@GMAIL.COM PHONE NO. (910) 723-3810 RESIDENCE

DATE: 9/1/2022


SHEET NAME

EQUIPMENT SPECIFICATIONS

SHEET SIZE

ANSI B 11" X 17"

SHEET NUMBER

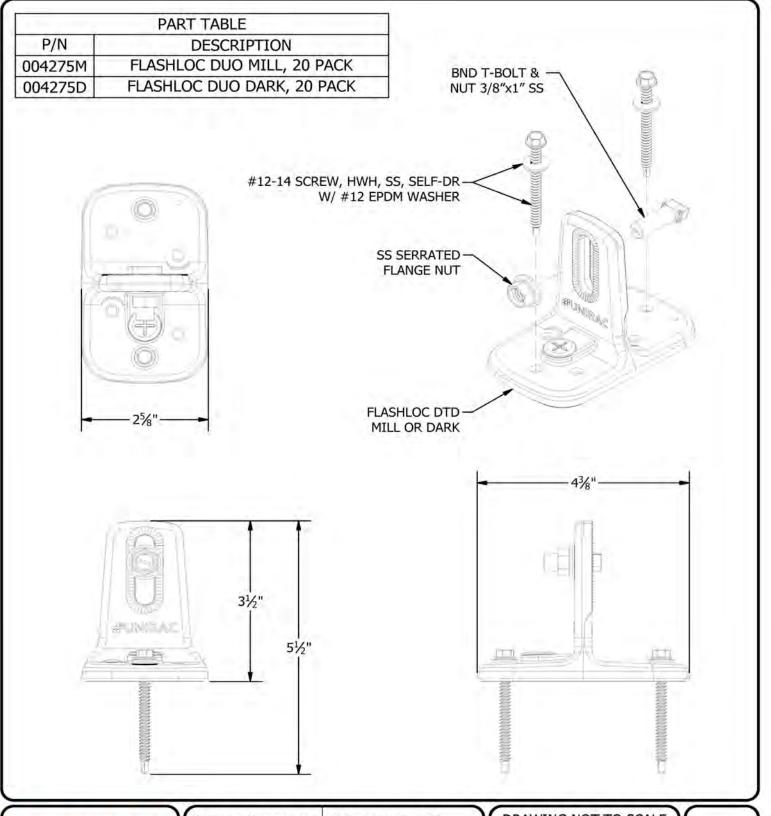

#UNIRAC

1411 BROADWAY BLVD. NE ALBUQUERQUE, NM 87102 USA PHONE: 505.242.6411 WWW.UNIRAC.COM

PRODUCT LINE: SOLARMOUNT

DRAWING TYPE: ASSEMBLY DETAIL

DESCRIPTION: FLASHLOC DUO KIT

REVISION DATE: 4/29/2021

DRAWING NOT TO SCALE ALL DIMENSIONS ARE NOMINAL

PRODUCT PROTECTED BY ONE OR MORE US PATENTS LEGAL NOTICE

FL-A04

4 LGCY POWER

LGCY POWER
3333 DIGITAL DR#600, LEHI,
UT 84043, UNITED STATES
PH#: (855) 353-4899



ELECTRICAL LIC#: U.21498

SYSTEM INFO

(26) APTOS DNA-120-MF10-440W

(26) ENPHASE IQ8PLUS -72-2-US (240V)

DC SYSTEM SIZE: 11.440 kWDC

AC SYSTEM SIZE: 7.540 kWAC

METER: 332 302 331

REVISIONS					
DESCRIPTION	DATE	REV			

PROJECT NAME & ADDRESS

RESIDENCE
705 DENIM DR, ERWIN, NC 28339, USA
EMAIL ID: SHANAMONK76@GMAIL.COM
PHONE NO. (910) 723-3810

DATE: 9/1/2022

SHEET NAME

EQUIPMENTSPECIFICATIONS

SHEET SIZE

ANSI B 11" X 17"

SHEET NUMBER

SOLARMOUNT



SOLARMOUNT defined the standard in solar racking. Features are designed to get installers off the roof faster. Our grounding & bonding process eliminates copper wire and grounding straps to reduce costs. Systems can be configured with standard or light rail to meet your design requirements at the lowest cost possible. The superior aesthetics package provides a streamlined clean edge for enhanced curb appeal, with no special brackets required for installation.









Light Rail is Fully Compatible with all SM Components



ENHANCED DESIGN & LAYOUT TOOLS Featuring Google Map Capabilities within U-Builde

FAST INSTALLATION. SUPERIOR AESTHETICS

OPTIMIZED COMPONENTS . VERSATILITY . DESIGN TOOLS . QUALITY PROVIDER

SOLARMOUNT

#UNIRAC


OPTIMIZED COMPONENTS

labor time. Our new grounding & bonding process eliminates copper wire and grounding straps or bonding jumpers to reduce costs. Utilize the microinverter mount with a wire management clip for an easier installation.

ONE PRODUCT - MANY APPLICATIONS

Quickly set modules flush to the roof or at a desired tilt angle. Change module orientation to portrait or landscape while securing a large variety of framed modules on flat, low slope or steep pitched roofs. Available in mill, clear and dark anodized finishes to outperform your projects financial and aesthetic aspirations.

tool that streamlines the process of designing a code compliant solar mounting system. Save time by creating a user profile, and recall preferences and projects automatically when you log in. You will enjoy the ability to share projects with customers; there's no need to print results and send to a distributor, just click and share

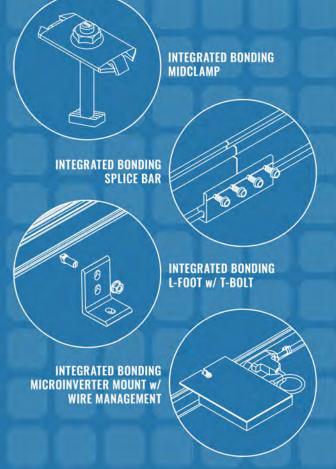



UNIRAC CUSTOMER SERVICE MEANS THE HIGHEST LEVEL OF PRODUCT SUPPORT





TECHNICAL SUPPORT





CERTIFIED QUALITY PROVIDER







BANKABLE WARRANTY

limited product warranty and a five (5) year limited finish warranty

PROTECT YOUR REPUTATION WITH QUALITY RACKING SOLUTIONS BACKED BY ENGINEERING EXCELLENCE AND A SUPERIOR SUPPLY CHAIN

4 LGCY POWER

3333 DIGITAL DR#600, LEHI, UT 84043, UNITED STATES PH#: (855) 353-4899



ELECTRICAL LIC#: U.21498

SYSTEM INFO

(26) APTOS DNA-120-MF10-440W

(26) ENPHASE IQ8PLUS -72-2-US (240V)

DC SYSTEM SIZE: 11.440 kWDC

AC SYSTEM SIZE: 7.540 kWAC

METER: 332 302 331

REVISIONS				
DESCRIPTION	DATE	REV		

PROJECT NAME & ADDRESS

705 DENIM DR, ERWIN, NC 28339, USA EMAIL ID: SHANAMONK76@GMAIL.COM PHONE NO. (910) 723-3810 RESIDENCE

DATE: 9/1/2022

SHEET NAME

EQUIPMENT SPECIFICATIONS

SHEET SIZE

ANSI B 11" X 17'

SHEET NUMBER

SOLARMOUNT



SOLARMOUNT is the professionals' choice for residential PV mounting applications. Every aspect of the system is designed for an easier, faster installation experience. **SOLAR**MOUNT is a complete solution with revolutionary universal clamps, **FLASHKIT** PRO, full system UL 2703 certification and 25-year warranty. Not only is **SOLAR**MOUNT easy to install, but best-in-class aesthetics make it the most attractive on any block!









NOW WITH UNIVERSAL MIDCLAMPS Accommodates 30mm-51mm module frames One tool, one-person installs are here!



REVOLUTIONARY NEW ENDCLAMPS Concealed design and included End Caps

THE PROFESSIONALS' CHOICE FOR RESIDENTIAL RACKING

BEST INSTALLATION EXPERIENCE • CURB APPEAL • COMPLETE SOLUTION • UNIRAC SUPPORT

FOR QUESTIONS OR CUSTOMER SERVICE VISIT UNIRAC.COM OR CALL (505) 248-2702

SOLARMOUNT

#UNIRAC

BETTER DESIGNS

TRUST THE INDUSTRY'S BEST DESIGN TOOL

Start the design process for every project in our U-Builder on-line design tool. It's a great way to save time and money.

BETTER SYSTEMS

Quickly set modules flush to the roof on steep pitched roofs. Orient a large variety of modules in Portrait or Landscape. Tilt the system up on flat or low slow roofs. Components available in mill, clear, and dark finishes to optimize your design financials

BETTER RESULTS

MAXIMIZE PROFITABILITY ON EVERY JOB

Trust Unirac to help you minimize both system and labor costs from the time the job is quoted to the time your teams get off the roof. Faster installs. Less Waste. More Profits.

BETTER SUPPORT

WORK WITH THE INDUSTRIES MOST EXPERIENCED TEAM

Professional support for professional installers and designers. You have access to our technical support and training groups. Whatever your support needs, we've got you covered. Visit Unirac.com/solarmount for more information



CONCEALED UNIVERSAL



UNIVERSAL SELF STANDING MIDCLAMPS



U-BUILDER ONLINE DESIGN TOOL SAVES TIME & MONEY Visit design.unirac.com

UNIRAC CUSTOMER SERVICE MEANS THE HIGHEST LEVEL OF PRODUCT SUPPORT





TECHNICAL SUPPORT

Unirac's technical support team is dedicated to answering

questions & addressing issues in real time. An online

library of documents including engineering reports,

stamped letters and technical data sheets greatly

simplifies your permitting and project planning process.







BANKABLE

9

CERTIFIED QUALITY PROVIDER

Unirac is the only PV mounting vendor with ISO certifications for 9001:2008, 14001:2004 and OHSAS 18001:2007, which means we deliver the highest standards for fit, form, and function. These certifications demonstrate

BANKABLE WARRANTY

Don't leave your project to chance, Unirac has the financial strength to back our products and reduce your risk. Have peace of mind knowing you are providing products of limited product warranty and a 5 year limited finish warranty

ENHANCE YOUR REPUTATION WITH QUALITY RACKING SOLUTIONS BACKED BY ENGINEERING EXCELLENCE AND A SUPERIOR SUPPLY CHAIN PUBZOIRAUSSI-PRINTEDUPDATE FOR QUESTIONS OR CUSTOMER SERVICE VISIT UNIRAC.COM OR CALL (505) 248-2702

ELECTRICAL LIC#: U.21498

4 LGCY POWER

3333 DIGITAL DR#600, LEHI, UT 84043, UNITED STATES PH#: (855) 353-4899

> SYSTEM INFO (26) APTOS DNA-120-MF10-440W

(26) ENPHASE IQ8PLUS -72-2-US (240V)

DC SYSTEM SIZE: 11.440 kWDC

AC SYSTEM SIZE: 7.540 kWAC

METER: 332 302 331

REVISIONS			
ESCRIPTION	DATE	REV	

PROJECT NAME & ADDRESS

705 DENIM DR, ERWIN, NC 28339, USA EMAIL ID: SHANAMONK76@GMAIL.COM PHONE NO. (910) 723-3810 RESIDENCE

DATE: 9/1/2022

SHEET NAME

EQUIPMENT SPECIFICATIONS


SHEET SIZE

ANSI B 11" X 17'


SHEET NUMBER




APPENDIX C PAGE JNIVERSAL AF ENDCLAMP INSTALLATION GUIDE PAGE

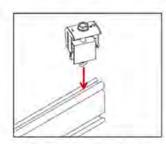


 Position clamp to align T-bolt with rail slot, Lower clamp and Insert T-bolt into rail slot.

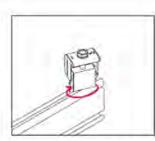


2. Rotate clamp clockwise 2/3 of a turn to engage T-bolt inside rail slot.

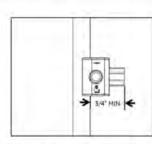


3. Place module at least 3/4" from end of rail and position clamp against module frame.

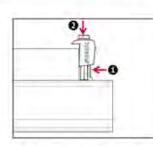


 While applying pressure to hold the clamp against the module, push down on the module side of the clamp cap.

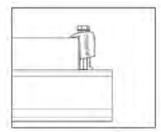

5. When the cap contacts the module frame, release and it will re-engage to the clamp base.

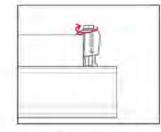

6. Tighten bolt and torque to 15 ft-lbs.

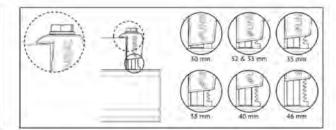

7. Confirm clamp is engaged in correct module height position and that the top of the cap is sitting level with the module frame.

NOTE: When installing 46mm modules, loosen bolt by 1 turn before positioning clamp against module frame. Do not force clamp onto module frame as this may damage the bonding pin.



CODE COMPLIANCE NOTES

SYSTEM LEVEL FIRE CLASSIFICATION

The system fire class rating requires installation in the manner specified in the SOLARMOUNT Installation Guide. SOLARMOUNT has been classified to the system level fire portion of UL2703. SOLARMOUNT has achieved system level performance for steep sloped roofs. The fire classification rating is only valid on roof pitches greater than 2:12 (slopes ≥ 2 inches per foot, or 9.5 degrees). The system is to be mounted over fire resistant roof covering rated for the application. There is no required minimum or maximum height limitation above the roof deck to maintain the system fire rating for SOLARMOUNT. Module Types, System Level Fire Ratings, and Mitigation Requirements are listed below:

Module Fire Types	System Level Fire Rating	Rail Direction	Module Orientation	Mitigation Required
1, 2, 3 with Metal Frame, 10 with Metal	Class A, Class B & Class C	East-West	Landscape OR Portrait	None Required
Frame, 19, 22, 25, 29, & 30		North-South	Landscape OR Portrait	None Required
1 & 2	Class A, Class B & Class C	East-West	Landscape OR Portrait	None Required
		North-South	Landscape OR Portrait	None Required
Standard, Light, & 4 & 5 HD Rails	Class A, Class B & Class C	East-West	Landscape OR Portrait	Trim installation per Solar
		North-South	Landscape OR Portrait	Mount Installation Guide
	Frame, 19, 22, 25, 29, & 30	Frame, 19, 22, 25, 29, & 30 1 & 2 Class A, Class B & Class C	Frame, 19, 22, 25, 29, & 30 North-South 1 & 2 Class A, Class B & Class C East-West North-South 4 & 5 Class A, Class B & Class C East-West	1, 2, 3 with Metal Frame, 10 with Metal Frame, 19, 22, 25, 29, & 30 Class A, Class B & Class C East-West Landscape OR Portrait North-South Landscape OR Portrait 1 & 2 Class A, Class B & Class C East-West Landscape OR Portrait North-South Landscape OR Portrait 4 & 5 Class A, Class B & Class C East-West Landscape OR Portrait Landscape OR Portrait

This racking system may be used to ground and/or mount a PV module complying with UL1703 or UL61730 only when the specific module has been evaluated for grounding and/or mounting in compliance with the included instructions.

UL2703 CERTIFICATION MARKING LABEL

SM STANDARD RAIL

Unirac SOLARMOUNT is listed to UL 2703. Certification marking is embossed on all mid clamps as shown. Labels with additional information will be provided .After the racking system is fully assembled, a single label should be applied to the SOLARMOUNT rail at the edge of the array. Before applying the label, the corners of the label that do not pertain to the system being installed must be removed so that only the installed system type is showing.

Note: The sticker label should be placed such that it is visible, but not outward facing











4 LGCY POWER

LGCY POWER
3333 DIGITAL DR#600, LEHI,
UT 84043, UNITED STATES
PH#: (855) 353-4899



ELECTRICAL LIC#: U.21498

SYSTEM INFO

(26) APTOS DNA-120-MF10-440W

(26) ENPHASE IQ8PLUS -72-2-US (240V)

DC SYSTEM SIZE: 11.440 kWDC

AC SYSTEM SIZE: 7.540 kWAC

METER: 332 302 331

REVISIONS					
DESCRIPTION DATE REV					

PROJECT NAME & ADDRESS

RESIDENCE 705 DENIM DR, ERWIN, NC 28339, USA EMAIL ID: SHANAMONK76@GMAIL.COM PHONE NO. (910) 723-3810

DATE: 9/1/2022

SHEET NAME

EQUIPMENT SPECIFICATIONS


SHEET SIZE

ANSI B 11" X 17"

SHEET NUMBER



BONDING CONNECTION GROUND PATHS

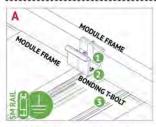



BONDING MIDCLAMP ASSEMBLY

BONDING MIDCLAMP ASSEMBLY

RAIL TO L-FOOT

- Aluminum mid clamp with stainless steel bonding pins that pierce module frame anodization to bond module to module through clamp
- Stainless steel nut bonds aluminum clamp to stainless steel T-bolt
- Serrated T-bolt head penetrates rail anodization to bond T-bolt, nut, clamp, and modules to SM rail




BONDING RAIL SPLICE BAR



BONDING MICROINVERTER MOUNT

- Hex nut with captive lock washer bonds meta microinverter flange to stainless steel T-bolt
- Serrated T-bolt head penetrates rail anodizatio to bond T-bolt, nut, and L-foot to grounded SM rail System ground including racking and

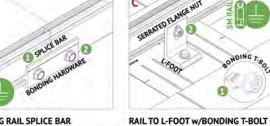

BONDING RAIL SPLICE BAR



Serrated flange nut removes L-foot anodization to bond L-Foot to stainless steel T-bolt

Serrated T-bolt head penetrates rail anodization to bond T-bolt, nut, and L-foot to grounded


RACK SYSTEM GROUND

- WEEB washer dimples pierce anodized rail to create bond between rail and lug
- Solid copper wire connected to lug is routed to provide final system ground connection.

 **OTE: Ilsto lug can also be used wires secured to me tide of the tree.



ENDCLAMP, FIRST MODULE INSTALLATION GUIDE PAGE

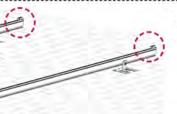

INSTALL MODULE END CLAMPS: The End clamp is supplied as an assembly with a 1/2" hex head bolt that is accessible at the ends of rails. The clamp should be installed on the rails prior to installing end modules.



INSTALL END CLAMPS ON RAIL: Slide end clamp on to rail by engaging the two t-guide brackets on to rail until bolt head with the top slot of the rails. Ensure engages with end of rail bolt is extended as far as possible so that clamp is positioned at max. rails prior to the first end distance from end of rail.



Slide end clamp assembly End clamps are positioned on module and prior to the last



rail slot, Pressure may be applied to top or side of bracket as shown. Do not force clamp into rail by pushing on bolt with excessive force.




INSTALL FIRST MODULE: Install the first end module onto rails with the flange of the module frame positioned between end clamps an ends

of rails.



ENGAGE CLAMP: While holding module in position and with flange in full contact with rail, rotate end clamp bolt until clamp engages with flange to provide clamp force. To ensure bolt is not over-torqued, use low torque setting on drill or If using an impact driver, stop rotation as soon as impact action of driver begins.

TORQUE VALUE (See table and notes on PG. A) End clamp bolt to 5 ft-lbs, No anti-seize

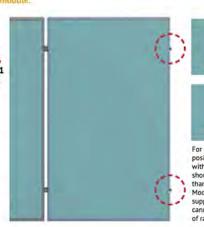

position module flush with ends of rails. Rails should not extend more than 1/2" beyond module Module must be fully supported by rails and cannot overhang ends

4 LGCY POWER LGCY POWER

3333 DIGITAL DR#600, LEHI, UT 84043, UNITED STATES PH#: (855) 353-4899

ELECTRICAL LIC#: U.21498

SYSTEM INFO

(26) APTOS DNA-120-MF10-440W

(26) ENPHASE IQ8PLUS -72-2-US (240V)

DC SYSTEM SIZE: 11.440 kWDC

AC SYSTEM SIZE: 7.540 kWAC

METER: 332 302 331

REVISIONS				
DESCRIPTION	DATE	REV		

PROJECT NAME & ADDRESS

705 DENIM DR, ERWIN, NC 28339, USA EMAIL ID: SHANAMONK76@GMAIL.COM PHONE NO. (910) 723-3810 RESIDENCE

DATE: 9/1/2022

SHEET NAME

EQUIPMENT SPECIFICATIONS


SHEET SIZE

ANSI B 11" X 17"

SHEET NUMBER



STANDARD SYSTEM GROUNDING NSTALLATION GUIDE PAGE

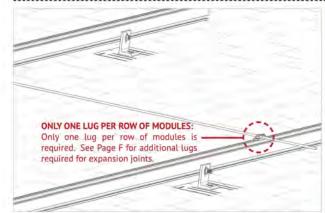

WEEBLUG CONDUCTOR - UNIRAC P/N 008002S:

Single Use Only

Apply Anti Seize and insert a bolt in the aluminum rail and through the clearance hole in the stainless steel flat washer. Place the stainless steel flat washer on the bolt, oriented so the dimples will contact the aluminum rail. Place the lug portion on the bolt and stainless steel flat washer, Install stainless steel flat washer, lock washer and nut. Tighten the nut until the dimples are completely embedded into the rail and lug. TORQUE VALUE 10 ft lbs. (See Note on PG. A)

See product data sheet for more details, Model No. WEEB-LUG-6.7

GROUNDING LUG MOUNTING DETAILS:

Details are provided for both the WEEB and Ilsco products. The WEEBLug has a grounding symbol located on the lug assembly. The Ilsco lug has a green colored set screw for grounding indication purposes. Installation must be in accordance with NFPA NEC 70, however the electrical designer of record should refer to the latest revision of NEC for actual grounding conductor cable size.

Required if not using approved integrated grounding microinveters

GROUNDING LUG - BOLT SIZE & DRILL SIZE		
GROUND LUG	BOLT SIZE	DRILL SIZE
WEEBLug	1/4"	N/A - Place in Top SM Rail Slot
ILSCO Lug	#10-32	7/32*

- Torque value depends on conductor size.
- See product data sheet for torque value.





ILSCO LAY-IN LUG CONDUCTOR - UNIRAC P/N 008009P: Alternate Grounding Lug - Drill, deburr hole and bolt thru both rail walls per table.


TOROUE VALUE 5 ft lbs. (See Note on PG. A)

See ILSCO product data sheet for more details, Model No. GBL-4DflT.


NOTE: ISOLATE COPPER FROM ALUMINUM CONTACT TO PREVENT CORROSION






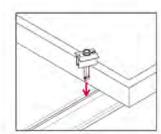


1. Position clamp to align T-bolt with rail slot. Lower clamp and insert T-bolt into rail slot

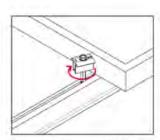


2. Rotate clamp clockwise 2/3 of a turn to engage T-bolt inside rail slot.

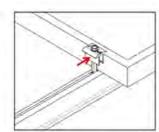


3. Slide clamp into position against module.

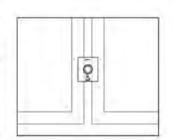

4. Place second module.

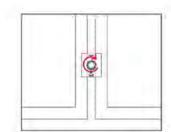

5. Tighten bolt and torque to 15 ft-lbs.

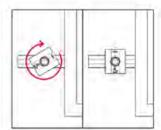

NOTE: If excessive force is applied in step 2, the cap may over-rotate causing it to be mis-aligned with the module frame. If this occurs, keep rotating the cap clockwise until it returns to the original position.



LGCY POWER 3333 DIGITAL DR#600, LEHI, UT 84043, UNITED STATES PH#: (855) 353-4899



ELECTRICAL LIC#: U.21498

SYSTEM INFO

(26) APTOS DNA-120-MF10-440W

(26) ENPHASE IQ8PLUS -72-2-US (240V)

DC SYSTEM SIZE: 11.440 kWDC

AC SYSTEM SIZE: 7.540 kWAC

METER: 332 302 331

REVISIONS				
DESCRIPTION	DATE	REV		

PROJECT NAME & ADDRESS

705 DENIM DR, ERWIN, NC 28339, USA EMAIL ID: SHANAMONK76@GMAIL.COM PHONE NO. (910) 723-3810 RESIDENCE

DATE: 9/1/2022

SHEET NAME

EQUIPMENT SPECIFICATIONS

SHEET SIZE

ANSI B 11" X 17"

SHEET NUMBER



October 3, 2019

UniRac 1411 Broadway Boulevard NE Albuquerque, New Mexico 87102-1545

TEL: (505) 242-6411 FAX: (505) 242-6412

Attn.: Unirac Engineering Department,

Re: Engineering Certification for UniRac's SolarMount Design & Engineering Guide

PZSE, Inc.-Structural Engineers has reviewed UniRac's "SolarMount Design & Engineering Guide" and specifically the enhancements of the SolarMount Flush-to-Roof System, Pressure Lookup Tables, and Downward & Upward Span Length Tables.

This certification excludes connections to building structures and the effects on building structure components. All information, data and analysis contained within the Installation Manual are based on, and comply with the following:

- 1. 2018 North Carolina Building Code, by The North Carolina State Building Code Council
- 2. 2009, 2012, 2012, & 2015 International Building Code, by International Code Council, Inc.
- 3. ASCE/SEI 7-05 & 7-10: Minimum Design Loads for Buildings and other Structures
- 4. 2010 & 2015 Aluminum Design Manual, by The Aluminum Association, 2015

This letter certifies that the structural calculations contained within UniRac's "SolarMount Design & Engineering Guide" are in compliance with the above Codes.

If you have any questions on the above, do not hesitate to call.

Prepared By: PZSE, Inc. - Structural Engineers Roseville, CA



4 LGCY POWER LGCY POWER

3333 DIGITAL DR#600, LEHI, UT 84043, UNITED STATES PH#: (855) 353-4899



ELECTRICAL LIC#: U.21498

SYSTEM INFO

(26) APTOS DNA-120-MF10-440W

(26) ENPHASE IQ8PLUS -72-2-US (240V)

DC SYSTEM SIZE: 11.440 kWDC AC SYSTEM SIZE: 7.540 kWAC

METER: 332 302 331

REVISIONS					
DESCRIPTION	DATE	REV			

PROJECT NAME & ADDRESS

705 DENIM DR, ERWIN, NC 28339, USA EMAIL ID: SHANAMONK76@GMAIL.COM PHONE NO. (910) 723-3810 RESIDENCE

DATE: 9/1/2022

SHEET NAME

EQUIPMENT SPECIFICATIONS

SHEET SIZE

ANSI B 11" X 17"

SHEET NUMBER