PHOTOVOLTAIC ROOF MOUNT SYSTEM

23 MODULES - SYSTEM SIZE STC (8.855 KW DC / 6.67 KW AC) 300 NORTH 11TH STREET, ERWIN, NC 28339, USA (35.3307682°, -78.6730033°)

SYSTEM SUMMARY STC DC/AC

(8.855 KW DC / 6.67 KW AC)

- 1X STRING OF 12 CONNECTED IN PARALLEL
- 1X STRING OF 11 CONNECTED IN PARALLEL
- (23) MISSION SOLAR ENERGY MSE385SX5R 385W MODULES
- (23) ENPHASE IQ8PLUS-72-2-US [240V] MICROINVERTERS
- STC DC: (23) 385 = 8.855 KW STC AC: (23) 290 = 6.67 KW

GOVERNING CODES

- ALL WORK SHALL CONFIRM TO THE FOLLOWING CODES

 1. 2015 INTERNATIONAL BUILDING CODE
- 2. 2018 NORTH CAROLINA STATE BUILDING CODE
- 2018 INTERNATIONAL RESIDENTIAL CODE
- 2018 INTERNATIONAL FIRE CODE 5. 2020 NORTH CAROLINA ELECTRICAL CODE

GENERAL NOTES


- 1) ALL PANELS, SWITCHES, ETC. SHALL HAVE SUFFICIENT GUTTER SPACE AND LUGS IN COMPLIANCE WITH UL REQUIREMENTS TO ACCOMMODATE
- THIS SYSTEM WILL NOT BE INTERCONNECTED UNTIL APPROVAL FROM THE LOCAL JURISDICTION AND UTILITY IS OBTAINED.
- ALL EXTERIOR ELECTRICAL DEVICES AND EQUIPMENT INCLUDING THOSE THAT ARE EXPOSED TO OUTSIDE ENVIRONMENT SHALL BE WEATHERPROOF AND SHALL BE LISTED BY 'UL' FOR THE TYPE OF APPLICATION AND 'UL' LABEL SHALL APPEAR ON ALL ELECTRICAL
- WIRING METHOD SHALL BE EMT ABOVE GROUND MOUNTED IN CONCEALED SPACES (UNLESS APPROVED OTHERWISE) AND SCHEDULE-40 PVC FOR BELOW GROUND INSTALLATIONS UNLESS NOTED OTHERWISE
- AN OSHA APPROVED LADDER PROVIDING ACCESS TO ALL PORTIONS OF THE ARRAY SHALL BE SECURED IN PRIOR TO REQUESTING INSPECTION.
- 6) IT IS THE CONTRACTOR'S RESPONSIBILITY TO INSTALL A SUPPLEMENTAL GROUNDING ELECTRODE CONDUCTOR IF NECESSARY.

SAFETY PLAN NOTES


- INSTALLERS SHALL DRAW IN DESIGNATED SAFETY AREA AROUND HOME. - INSTALLERS SHALL UPDATE NAME, ADDRESS AND PHONE NUMBER OF NEAREST URGENT CARE FACILITY RELATIVE TO THE SITE BEFORE

LOCATION OF NEAREST URGENT CARE FACILITY (FOR INSTALLER USE ONLY)

- ADDRESS
- PHONE NUMBER

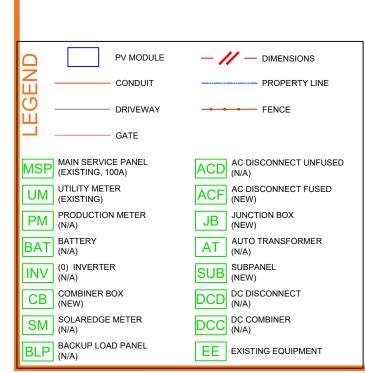



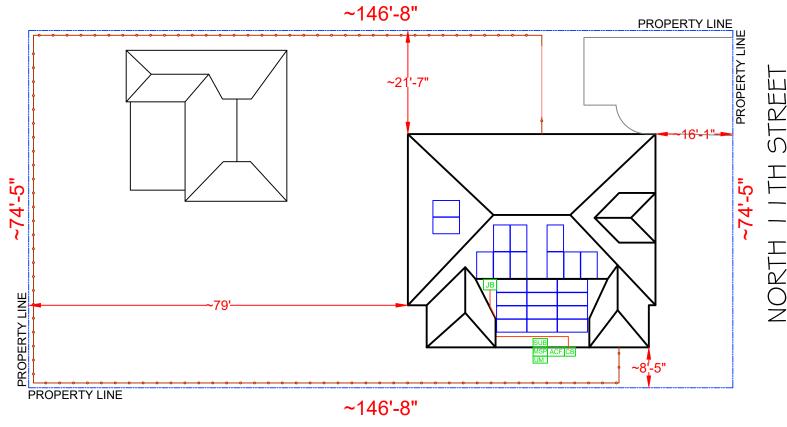

STREE 드

HOUSE PHOTO SCALE: NTS

SHEET INDEX
PV-1 COVER PAGE

ROOF PLAN WITH MODULES

EQUIPMENT SPECIFICATION

(PROGRESS ENERGY CAROLINAS

ARRAY LOCATIONS

ATTACHMENT DETAIL

SINGLE LINE DIAGRAM

WIRING CALCULATION

PLACARDS

AHJ: TOWN OF ERWIN

UTILITY: DUKE ENERGY

PV-2

PV-3

PV-4

PV-5

PV-6

PV-7+

INC)



VICINITY MAP SCALE: NTS



CONTRACTOR

NAME: TOP TIER SOLAR SOLUTIONS

ADDRESS: 1530 CENTER PARK DR, CHARLOTTE, NC 28217, USA

PHONE: 855-997-1213

CONTRACTOR LICENSE #: SC - CLG.12388

ELECTRICAL LICENSE #: NC - 87345

EMAIL : bdunford@toptiersolarsolutions.c

REVISIONS DESCRIPTION DATE RE\

SIGNATURE & SEAL

HOMEOWNER INFO

11TH STREET, C 28339, USA 300 NORTH 11 ERWIN, NC 2

APN: 6059711090001 FMAII ·

JON WHITE

PHONE: **SHEET NAME**

COVER PAGE

SHEET SIZE **ANSIB**

11" X 17" SHEET NUMBER



MODULE AREA & WEIGHT CALCULATIONS

PANEL TYPES (COUNT, AREA, WEIGHT):

- (23x) MISSION SOLAR ENERGY MSE385SX5R 385W (75.1" x 41.1", 49 LBS)

MICRO-INVERTER TYPES (COUNT, WEIGHT): - (23x) ENPHASE IQ8PLUS-72-2-US [240V] (2.38 LBS)

MOUNTING SYSTEM WEIGHT/MODULE: 1.5 LBS TOTAL ROOF AREA: 2501 SF

PV MODULE

FIRE SETBACK

MICRO-INVERTER

MSP MAIN SERVICE PANEL (EXISTING, 100A)

PM PRODUCTION METER (N/A)

UM UTILITY METER (EXISTING)

BAT BATTERY (N/A)

(0) INVERTER (N/A)

CB COMBINER BOX (NEW)

SM SOLAREDGE METER (N/A)

BLP BACKUP LOAD PANEL (N/A)

ROOF ATTACHMENT

TOTAL ARRAY AREA: (23) 75.1" x 41.1" = 493.00 SF TOTAL ARRAY WEIGHT: (23) 49.0 + (23) 2.4 + (23) 1.5 = 1216 LBS

WEIGHT AT EACH CONNECTION: 1216 LBS / 74 = 16.43 LBS DISTRIBUTED LOAD: 1216 LBS / 493.00 SF = 2.47 PSF ROOF AREA COVERED BY ARRAY: 493 SF / 2501 SF = 19.7%

	BIL	L OF MATERIALS
SOLAR PV MODULES	23	MISSION SOLAR ENERGY MSE385SX5R 385W
MICRO INVERTERS	23	ENPHASE IQ8PLUS-72-2-US [240V]
JUNCTION BOX	01	600V, NEMA 3R RATED JBOX
LOAD CENTER	01	ENPHASE IQ COMBINER BOX 4/4C
AC DISCONNECT	01	PV VISIBLE LOCKABLE LABELED DISCONNECT (60A FUSED/40A FUSES 1PH 240VAC)
ATTACHMENTS	74	IRONRIDGE - SLOTTED L-FEET
RAIL	17	IRONRIDGE RESOURCES - XR10
RAIL SPLICES	08	RAIL SPLICES
MID CLAMPS	28	MID CLAMP
END CLAMPS	36	END CLAMP
GROUNDING LUG	09	GROUNDING LUG

	ROOF DESCRIPTION TABLE										
ROOF TRUSS TRUSS ATTACHMENT MODULE ARRAY AZ PLANE SIZE SPACING SPACING COUNT TILT											
#1	2" x 4"	24" O.C.	48" O.C	09	30°	180°					
#2	2" x 4"	24" O.C.	48" O.C	12	26°	180°					
#3	2" x 4"	24" O.C.	48" O.C	02	30°	270°					

— /// — DIMENSIONS

ACD (N/A)

TRUSS

CONDUIT

ACF AC DISCONNECT FUSED (NEW)

AT AUTO TRANSFORMER (N/A)

EE EXISTING EQUIPMENT

JB JUNCTION BOX (NEW)

DCD DC DISCONNECT (N/A)


DCC DC COMBINER (N/A)

SUBPANEL (NEW)

AC DISCONNECT UNFUSED

DESIGN CRITERIA

EXPOSURE CATEGORY = B WIND SPEED = 119 MPH SNOW LOAD = 10 PSF

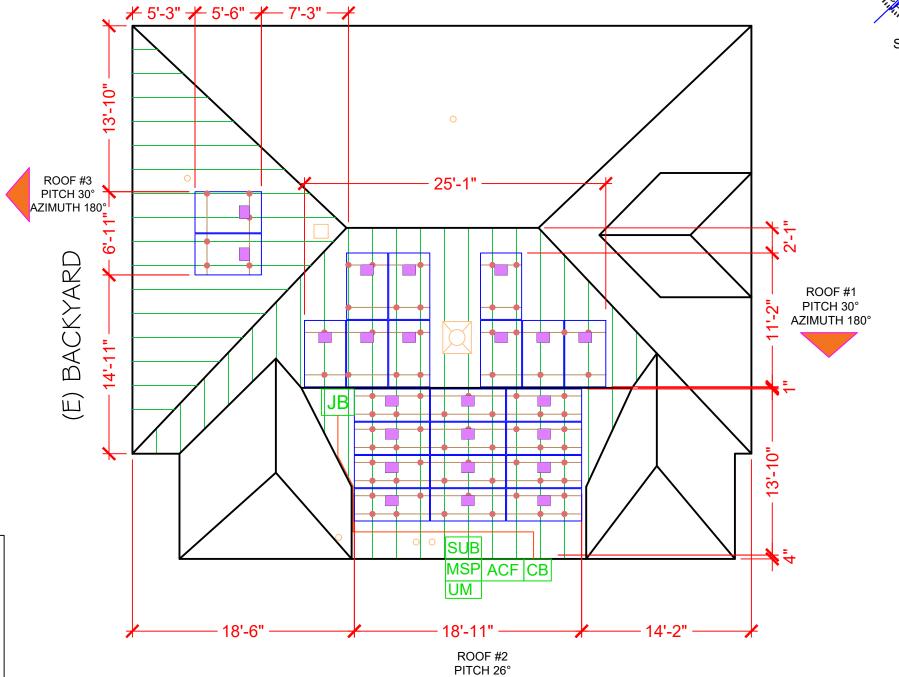

AZIMUTH 180°

ROOF PLAN WITH MODULES

SCALE: 1/8" = 1'-0"



STREET

NORTH

MWUM MANUTE Signed 4/28/2023

(E) FRONT YARD

CONTRACTOR NAME: TOP TIER SOLAR SOLUTIONS

ADDRESS: 1530 CENTER PARK DR, CHARLOTTE, NC 28217, USA

PHONE: 855-997-1213

CONTRACTOR LICENSE #: SC - CLG.123883 ELECTRICAL LICENSE #: NC - 87345

= .						
REVISIONS						
ESCRIPTION DATE REV						

SIGNATURE & SEAL

HOMEOWNER INFO

300 NORTH 11TH STREET ERWIN, NC 28339, USA JON WHITE


APN: 6059711090001 PHONE: -

SHEET NAME

ROOF PLAN WITH MODULES

> SHEET SIZE **ANSI B** 11" X 17"

SHEET NUMBER PV-2

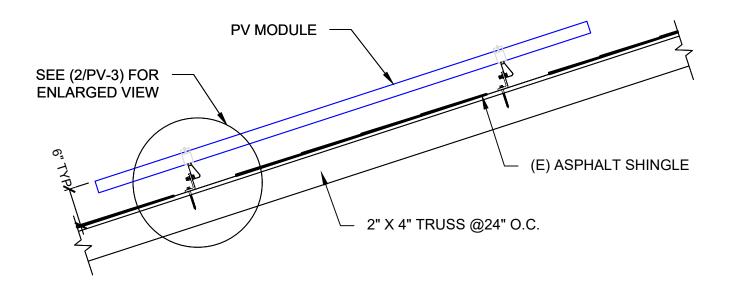





CONTRACTOR
NAME: TOP TIER SOLAR SOLUTIONS

ADDRESS: 1530 CENTER PARK DR, CHARLOTTE, NC 28217, USA

PHONE: 855-997-1213

CONTRACTOR LICENSE #: SC - CLG.123883 ELECTRICAL LICENSE #: NC - 87345


FMAIL : hdunford@tontiersolarsolution

REVISIONS							
DESCRIPTION DATE REV							

SIGNATURE & SEAL

ATTACHMENT DETAIL

SCALE: NTS

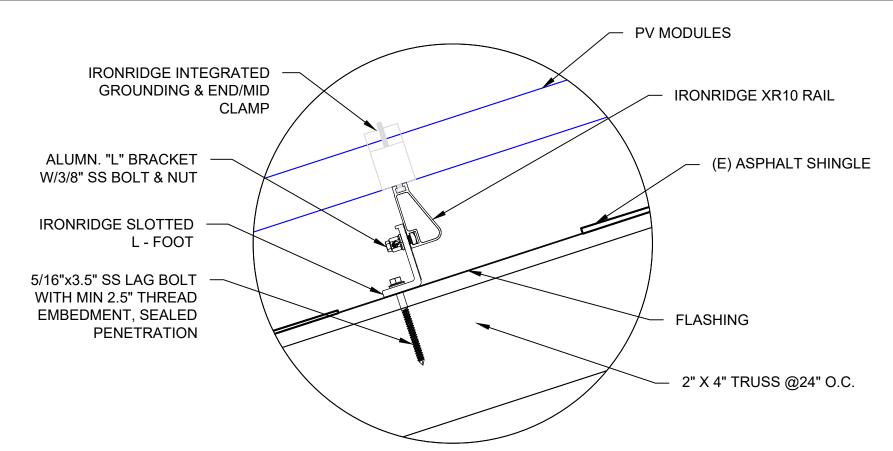

ATTACHMENT DETAIL (ENLARGED SECTION VIEW)

SCALE: NTS

HOMEOWNER INFO

JON WHITE 300 NORTH 11TH STREET, ERWIN, NC 28339, USA

APN: 605971109000

PHONE: - SHEET NAME

ATTACHMENT

DETAIL SHEET SIZE

ANSI B 11" X 17"

SHEET NUMBER PV-3

SYSTEM SUMMARY STC DC/AC (8.855 KW DC / 6.67 KW AC)

- 1X STRING OF 12 CONNECTED IN PARALLEL
- 1X STRING OF 11 CONNECTED IN PARALLEL
- (23) MISSION SOLAR ENERGY MSE385SX5R 385W MODULES - (23) ENPHASE IQ8PLUS-72-2-US [240V] MICROINVERTERS STC DC: (23) 385 = 8.855 KW STC AC: (23) 290 = 6.67 KW


NO.

- ALL GROUNDING TO COMPLY WITH NEC 690.47.
- ROOF TOP CONDUIT SHALL BE LOCATED MIN. 7/8" ABOVE ROOF SURFACE.
- ALL TERMINALS SHALL BE MIN. 75 DEG. C RATED.

NOTE

 HOLD ON KITS FOR PV BREAKERS IS MANDATORY FOR IQ COMBINER 4 / 4C.

CONDUIT RUN THROUGH ATTIC

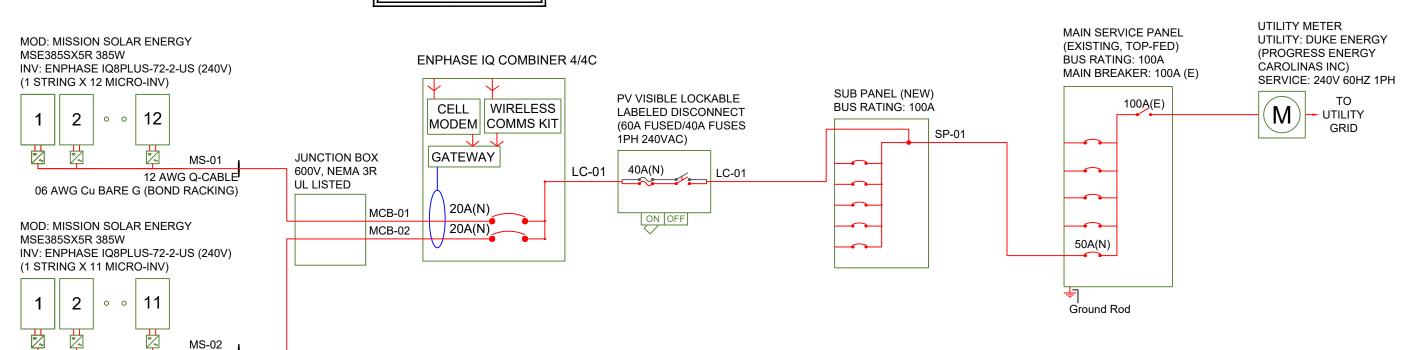

	AC wire details											
Wire	Min Ampacity	Live	Neutral	Ground	Min EMT	Min PVC	Min RMC					
MS-01	18.15A	12 AWG (Q-Cable)	-	06 AWG BARE (NOT IN CONDUIT)	-	-	-					
MS-02	16.64A	12 AWG (Q-Cable)	-	06 AWG BARE (NOT IN CONDUIT)	-	-	-					
MCB-01	18.15A	(2) 10 AWG THWN-2	10 AWG THWN-2	10 AWG THWN-2	0.50 in	0.50 in	0.50 in					
MCB-02	16.64A	(2) 10 AWG THWN-2	10 AWG THWN-2	10 AWG THWN-2	0.50 in	0.50 in	0.50 in					
LC-01	34.79A	(2) 06 AWG THWN-2	06 AWG THWN-2	10 AWG THWN-2	0.75 in	0.75 in	0.75 in					
SP-01	50A	(2) 04 AWG THWN-2	04 AWG THWN-2	08 AWG THWN-2	1 in	1 in	1 in					

INTERCONNECTION 120% RULE (SUB PANEL)

INTERCONNECTION 120% RULE NOT APPLICABLE

LINE-SIDE TAP DOES NOT AFFECT MAIN PANEL

EXTREME CASE MODULE OUTPUT (MISSION SOLAR ENERGY MSE385SX5R 385W)

Isc(25°C) = 10.97A, Tisc = 0.039%/°C Isc(T) = Isc(25°C) x [1 + Tisc x (T-25°C)] Isc(-10°C) = 10.82A, Isc(35°C) = 11.01A

 $Voc(25^{\circ}C) = 45.03V$, $Tvoc = -0.262\%/^{\circ}C$ $Voc(T) = Voc(25^{\circ}C) \times [1 + Tvoc \times (T-25^{\circ}C)]$ $Voc(-10^{\circ}C) = 49.16V$, $Voc(35^{\circ}C) = 43.85V$ TOP TIER

CONTRACTOR

NAME: TOP TIER SOLAR SOLUTIONS ADDRESS: 1530 CENTER PARK DR, CHARLOTTE, NC 28217, USA

PHONE: 855-997-1213

CONTRACTOR LICENSE #: SC - CLG.123883 ELECTRICAL LICENSE #: NC - 87345

AIL : bdunford@toptiersolarsolut

REVISIONS							
ESCRIPTION	DATE	REV					

SIGNATURE & SEAL

HOMEOWNER INFO

300 NORTH 11TH STREET ERWIN, NC 28339, USA

APN: 605971109000° EMAIL: -PHONE: -

JON WHITE

SHEET NAME

SINGLE LINE DIAGRAM

> SHEET SIZE ANSI B

11" X 17"
SHEET NUMBER

PV-4

ELECTRICAL SINGLE LINE DIAGRAM

12 AWG Q-CABLE

06 AWG Cu BARE G (BOND RACKING)

SCALE: NTS

SYSTEM SUMMARY STC DC/AC (8.855 KW DC / 6.67 KW AC)

- 1X STRING OF 12 CONNECTED IN PARALLEL
- 1X STRING OF 11 CONNECTED IN PARALLEL
- (23) MISSION SOLAR ENERGY MSE385SX5R 385W MODULES
- (23) ENPHASE IQ8PLUS-72-2-US [240V] MICROINVERTERS

STC DC: (23) 385 = 8.855 KW

STC AC: (23) 290 = 6.67 KW

									AC wire details								
WireID	#Modules	Nominal	Backfeed *1.25	Min	Total	Conductor	ccConductors	Expected	Adjusted ampacity (ampacity x temp	Conductor &	EGC size	Conductor	Max	V drop	Min EMT	Min PVC	Min RMC
VVIIGID	#IVIOGUIES	Voltage	/cond. set	OCPD	Power	sets	/conduit	max temp	derate x conduit fill derate)	neutral size	(Cu)	metal	length		size	size	size
MS-01	12	240 V	18.15 A	20 A	3.5 kW	1	2	35	25 x 0.94 x 1.00 = 23.50 A	12 AWG (Q-Cable)	06 AWG BARE (NOT IN CONDUIT)	Cu	50 ft	1.05 %	-	-	-
MS-02	11	240 V	16.64 A	20 A	3.2 kW	1	2	35	25 x 0.94 x 1.00 = 23.50 A	12 AWG (Q-Cable)	06 AWG BARE (NOT IN CONDUIT)	Cu	50 ft	0.97 %	-	-	-
MCB-01	12	240 V	18.15 A	20 A	3.5 kW	1	2	35	35 x 0.94 x 1.00 = 32.90 A	10 AWG THWN-2	10 AWG THWN-2	Cu	50 ft	0.63 %	0.50 in	0.50 in	0.50 in
MCB-02	11	240 V	16.64 A	20 A	3.2 kW	1	2	35	35 x 0.94 x 1.00 = 32.90 A	10 AWG THWN-2	10 AWG THWN-2	Cu	50 ft	0.58 %	0.50 in	0.50 in	0.50 in
LC-01	23	240 V	34.79 A	40 A	6.7 kW	1	2	35	50 x 0.94 x 1.00 = 47.00 A	08 AWG THWN-2	10 AWG THWN-2	Cu	10 ft	0.16 %	0.75 in	0.75 in	0.75 in
SP-01	23	240 V	34.79 A	50 A	6.7 kW	1	2	35	65 x 0.94 x 1.00 = 61.10 A	06 AWG THWN-2	06 AWG THWN-2	Cu	10 ft	0.05 %	1 in	1 in	1 in

INTERCONNECTION 120% RULE (SUB PANEL)

> INTERCONNECTION 120% RULE **NOT APPLICABLE**

LINE-SIDE TAP DOES NOT AFFECT MAIN PANEL

EXTREME CASE MODULE OUTPUT (MISSION SOLAR ENERGY MSE385SX5R 385W)

 $Isc(25^{\circ}C) = 10.97A$, $Tisc = 0.039\%/^{\circ}C$ $Isc(T) = Isc(25^{\circ}C) \times [1 + Tisc \times (T-25^{\circ}C)]$ Isc(-10°C) = 10.82A, Isc(35°C) = 11.01A

 $Voc(25^{\circ}C) = 45.03V$, Tvoc = -0.262%/°C $Voc(T) = Voc(25^{\circ}C) \times [1 + Tvoc \times (T-25^{\circ}C)]$ $Voc(-10^{\circ}C) = 49.16V, Voc(35^{\circ}C) = 43.85V$

ELECTRICAL NOTES

- ALL EQUIPMENT TO BE LISTED BY UL OR OTHER NRTL, AND LABELED FOR ITS APPLICATION.
- ALL CONDUCTORS SHALL BE COPPER, RATED FOR 600 V AND 90 DEGREE C WET ENVIRONMENT.
- WIRING, CONDUIT, AND RACEWAYS MOUNTED ON ROOFTOPS SHALL BE ROUTED DIRECTLY TO, AND LOCATED AS CLOSE AS POSSIBLE TO THE NEAREST RIDGE, HIP, OR VALLEY.
- WORKING CLEARANCES AROUND ALL NEW AND EXISTING ELECTRICAL EQUIPMENT SHALL COMPLY WITH NEC 110.26.
- DRAWINGS INDICATE THE GENERAL ARRANGEMENT OF SYSTEMS. CONTRACTOR SHALL FURNISH ALL NECESSARY OUTLETS, SUPPORTS, FITTINGS AND ACCESSORIES TO FULFILL APPLICABLE CODES AND STANDARDS.
- WHERE SIZES OF JUNCTION BOXES, RACEWAYS, AND CONDUITS ARE NOT SPECIFIED, THE CONTRACTOR SHALL SIZE THEM ACCORDINGLY.
- ALL WIRE TERMINATIONS SHALL BE APPROPRIATELY LABELED AND READILY VISIBLE.
- MODULE GROUNDING CLIPS TO BE INSTALLED BETWEEN MODULE FRAME AND MODULE SUPPORT RAIL, PER THE GROUNDING CLIP MANUFACTURER'S INSTRUCTION.
- MODULE SUPPORT RAIL TO BE BONDED TO CONTINUOUS COPPER G.E.C. VIA WEEB LUG OR ILSCO GBL-4DBT LAY-IN LUG.
- 10) PV EQUIPMENT SHALL BE DESIGNED AND INSTALLED IN ACCORDANCE WITH NEC 690.
- 11) EXACT LOCATION OF AUXILIARY GROUNDING TO BE DETERMINED AT TIME OF INSTALL.
- 12) EXISTING WIRES MUST BE REPLACED IF SMALLER THAN LISTED MINIMUM SIZES PER NEC 310.15(B)(16).
- 13) AC DISCONNECT LOCATED WITHIN 10' OR LESS FROM UTILITY METER
- 14) IF ENVOY PRESENT, ENVOY BREAKER DETERMINED AT FACTORY BY MANUFACTURER.
- 15) IF ENVOY PRESENT, FOR IQ COMBINER USE SINGLE CT ON L1. AT SYSTEM CONTROLLER MAIN USE DOUBLE CT ON L1 AND L2.



CONTRACTOR

NAME: TOP TIER SOLAR SOLUTIONS ADDRESS: 1530 CENTER PARK DR, CHARLOTTE, NC 28217, USA

PHONE: 855-997-1213

CONTRACTOR LICENSE #: SC - CLG.123883 ELECTRICAL LICENSE #: NC - 87345

EMAIL : bdunford@toptiersolarsolutions.com

REVISIONS							
DESCRIPTION DATE REV							

SIGNATURE & SEAL

HOMEOWNER INFO

| 11TH STREET, C 28339, USA JON WHITE 300 NORTH 11 ERWIN, NC 2

APN: 6059711090001

FMAII ·

PHONE:

SHEET NAME

WIRING CALCULATION

> SHEET SIZE **ANSIB**

11" X 17" SHEET NUMBER



ELECTRICAL SHOCK HAZARD

TERMINALS ON LINE AND LOAD SIDES MAY BE ENERGIZED IN THE OPEN POSITION

LABEL LOCATION:
INVERTER(S), AC DISCONNECT(S), AC
COMBINER PANEL (IF APPLICABLE).
PER CODE(S): NEC 2020: NEC 706.15
(C)(4) & NEC 690.13(B)

RAPID SHUTDOWN SWITCH FOR SOLAR PV SYSTEM



POWER SOURCE OUTPUT CONNECTION

DO NOT RELOCATE THIS OVERCURRENT DEVICE



LABEL LOCATION:
POINT OF INTERCONNECTION
PRODUCTION METER
NEC 705.12(B)(3)(3)

PHOTOVOLTAIC

AC DISCONNECT

LABEL LOCATION: AC DISCONNECT/BREAKER/ POINT OF CONNECTION (PER CODE: NEC 690.13(B)

A WARNING

ELECTRIC SHOCK HAZARD

TERMINALS ON BOTH LINE AND LOAD SIDES MAY BE ENERGIZED IN THE OPEN POSITION

DC VOLTAGE IS ALWAYS PRESENT WHEN SOLAR MODULES ARE EXPOSED TO SUNLIGHT

LABEL LOCATION:

DC DISCONNECT, POINT OF INTERCONNECTION (PER CODE: NEC 690.13(B))

A WARNING

THIS EQUIPMENT FED BY

MULTIPLE SOURCES:

TOTAL RATING OF ALL OVERCURRENT

DEVICES EXCLUDING MAIN POWER

SUPPLY SHALL NOT EXCEED

AMPACITY OF BUSBAR

LABEL LOCATION:
POINTS OF CONNECTION/BREAKER
CODE: NEC 705.12(B)(3)(3)

LABEL LOCATION:
SERVICE PANEL IF SUM OF BREAKERS EXCEEDS PANEL
RATING
NEC 705.12 (B)(3)(2)

PHOTOVOLTAIC AC DISCONNECT

RATED AC OPERATING CURRENT: 27.83 AMPS

NOMINAL OPERATING AC VOLTAGE: 240 VAC

LABEL LOCATION: MAIN PANEL AC DISCONNECT(S) CODE REF: NEC 690.54

NOTES AND SPECIFICATIONS:

- SIGNS AND LABELS SHALL MEET THE REQUIREMENTS OF THE 2020 ARTICLE 110.21(B), UNLESS SPECIFIC INSTRUCTIONS ARE REQUIRED BY SECTION 690, OR IF REQUESTED BY THE LOCAL AHJ.
- SIGNS AND LABELS SHALL ADEQUATELY WARN OF HAZARDS USING EFFECTIVE WORDS, COLORS AND SYMBOLS.
- LABELS SHALL BE PERMANENTLY AFFIXED TO THE EQUIPMENT OR WIRING METHOD AND SHALL NOT BE HAND WRITTEN.
- LABEL SHALL BE OF SUFFICIENT DURABILITY TO WITHSTAND THE ENVIRONMENT INVOLVED.
- SIGNS AND LABELS SHALL COMPLY WITH ANSI Z535.4-2011, PRODUCT SAFETY SIGNS AND LABELS, UNLESS OTHERWISE SPECIFIED.
- DO NOT COVER EXISTING MANUFACTURER LABELS.

A CAUTION

PHOTOVOLTAIC SYSTEM CIRCUIT IS BACKFED

LABEL LOCATION: MSP (PER CODE: NEC 705.12(D) & NEC 690.59

MAIN PHOTOVOLTAIC SYSTEM DISCONNECT

LABEL LOCATION:


MAIN SERVICE DISCONNECT / UTILITY METER (PER CODE: NEC 690.13(B))

WARNING: PHOTOVOLTAIC POWER SOURCE

LABEL LOCATION: EMT / CONDUIT RACEWAYS (PER CODE: NEC690.31(D)(2)

SOLAR PV SYSTEM EQUIPPED WITH RAPID SHUTDOWN

TURN RAPID SHUTDOWN SWITCH TO THE "OFF" POSITION TO SHUT DOWN PV SYSTEM AND REDUCE SHOCK HAZARD IN THE ARRAY.

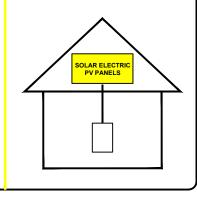

LABEL LOCATION:

ಹ

ON OR NO MORE THAT 1 M (3 FT) FROM THE SERVICE DISCONNECTING MEANS TO WHICH THE PV SYSTEMS ARE CONNECTED. PER CODE(S): NEC 2020: IFC 690.56(C)

TOP TIER

CONTRACTOR
NAME: TOP TIER SOLAR SOLUTIONS

ADDRESS: 1530 CENTER PARK DR, CHARLOTTE, NC 28217, USA

PHONE: 855-997-1213

CONTRACTOR LICENSE #: SC - CLG.123883 ELECTRICAL LICENSE #: NC - 87345

EMAIL : bdunford@toptiersolarsolu

REVISIONS							
DESCRIPTION	DATE	REV					

SIGNATURE & SEAL

HOMEOWNER INFO

300 NORTH 11TH STREET, ERWIN, NC 28339, USA

APN: 6059711090001 EMAIL: -

PHONE:

WHITE

NOC

SHEET NAME

PLACARDS

SHEET SIZE ANSI B 11" X 17"

SHEET NUMBER





Class leading power output

-0 to +3%



True American Quality True American Brand

Mission Solar Energy is headquartered in San Antonio, Texas where we manufacture our modules. We produce American, high-quality solar modules ensuring the highest-in-class power output and best-in-class reliability. Our product line is tailored for residential, commercial and utility applications. Every Mission Solar Energy solar module is certified and surpasses industry standard regulations, proving excellent performance over the long term.

Demand the best. Demand Mission Solar Energy.



Certified Reliability

- Tested to UL 61730 & IEC Standards
- PID resistant
- Resistance to salt mist corrosion



Advanced Technology

- 6 Busbar
- Passivated Emitter Rear Contact
- Ideal for all applications



Extreme Weather Resilience

- Up to 5,400 Pa front load & 3,600 Pa back load
- Tested load to UL 61730
- 40 mm frame



BAA Compliant for Government Projects

- Buy American Act
- American Recovery & Reinvestment Act





CERTIFICATIONS

FRAME-TO-FRAME WARRANTY

Degradation guaranteed not to exceed 2% in year one and 0.58% annually from years two to 30 with 84.08% capacity guaranteed in year 25. For more information, visit www.missionsolar.com/warranty






If you have questions or concerns about certification of our products in your area.

UL 61730 / IEC 61215 / IEC 61730 / IEC 61701

www.missionsolar.com | info@missionsolar.com

Class Leading 375-385W

FRONT VIEW

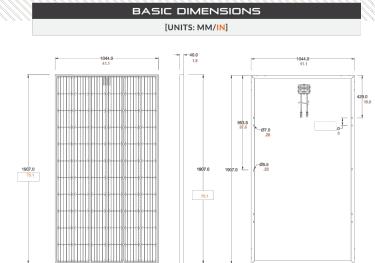


CURRENT-VOLTAGE CURVE	
MSE385SX5R: 385WP, 66 CELL SOLAR MODULE	

REAR VIEW

Current-voltage characteristics with dependence on irradiance and module temperature

SIDE VIEW

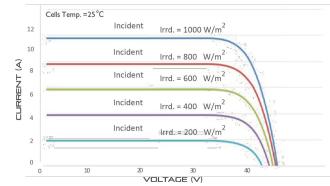

CERTIFICATIONS AND TESTS					
IEC	61215, 61730, 61701				
UL	61730				







Mission Solar Energy

8303 S. New Braunfels Ave., San Antonio, Texas 78235 www.missionsolar.com | info@missionsolar.com

Mission Solar Energy reserves the right to make specification changes without notice.

MSE PERC 66

ELECTRI	CAL	. SF	PECIFIC	ATION	
PRODUCT TYPE	MSE	(XXSX	5R (xxx=P	max)	
Power Output	P _{max}	W_p	375	380	385
Module Efficiency		%	18.8	19.1	19.3
Tolerance		%	0/+3	0/+3	0/+3
Short Circuit Current	Isc	V	10.85	10.91	10.97
Open Circuit Voltage	Voc	Α	44.64	44.84	45.03
Rated Current	Imp	V	10.26	10.34	10.42
Rated Voltage	V_{mp}	V	36.56	36.75	36.93
Fuse Rating		Α	20	20	20
System Voltage		V	1,000	1,000	1,000

TEMPERATURE COEFF	ICIENTS
Normal Operating Cell Temperature (NOCT)	44.43°C (±3.7%)
Temperature Coefficient of Pmax	-0.361%/°C
Temperature Coefficient of Voc	-0.262%/°C
Temperature Coefficient of Isc	0.039%/°C

OPERATING CONDITIONS			
Maximum System Voltage	1,000Vdc		
Operating Temperature Range	-40°C (-40°F) to +85°C (185°F)		
Maximum Series Fuse Rating	20A		
Fire Safety Classification	Type 1		
Front & Back Load (UL Standard)	Up to 5,400 Pa front and 3,600 Pa back load, Tested to UL 61730		
Hail Safety Impact Velocity	25mm at 23 m/s		

MECHANICAL DATA			
Solar Cells	P-type mono-crystalline silicon		
Cell Orientation	66 cells (6x11)		
Module Dimension	1,907mm x 1,044mm x 40mm		
Weight	22 kg (49 lbs.)		
Front Glass	3.2mm, tempered, low-iron, anti-reflective		
Frame	Anodized		
Encapsulant	Ethylene vinyl acetate (EVA)		
Junction Box	Protection class IP67 with 3 bypass-diodes		
Cable	1.0m, Wire 4mm2 (12AWG)		
Connector	Staubli PV-KBT4/6II-UR and PV-KST4/6II-UR, MC4, Renhe 05-8		

SHIPPING INFORMATION					
Container Feet	Ship To	Pallet	Panels	380 W Bin	
53'	Most States	30	780	296.40 kW	
Double Stack	CA	26	676	256.88 kW	
PALLET [26 PANELS]					
Weight 1,274 lbs. (572 kg)	Height 47.56 in (120.80 cm		Width 46 in 16.84 cm)	Length 77 in (195.58 cm)	

www.missionsolar.com | info@missionsolar.com

C-SA2-MKTG-0027 REV 2 05/05/2021

TOP TIER

CONTRACTOR

NAME: TOP TIER SOLAR SOLUTIONS ADDRESS: 1530 CENTER PARK DR, CHARLOTTE, NC 28217, USA

PHONE: 855-997-1213

CONTRACTOR LICENSE #: SC - CLG.123883 ELECTRICAL LICENSE #: NC - 87345 EMAIL: bdunford@toptiersolarsolutions.com

REVISIONS			
DESCRIPTION	DATE	REV	

SIGNATURE & SEAL

HOMEOWNER INFO

11TH STREET, C 28339, USA WHITE 300 NORTH 11 ERWIN, NC 2 NOC

APN: 6059711090001 FMAII · PHONE:

SHEET NAME

EQUIPMENT SPECIFICATION

> SHEET SIZE **ANSIB** 11" X 17"

SHEET NUMBER PV-7

C-SA2-MKTG-0027 REV 2 05/05/2021







IQ8 and IQ8+ Microinverters

Our newest IQ8 Microinverters are the industry's first microgrid-forming, software-defined microinverters with split-phase power conversion capability to convert DC power to AC power efficiently. The brain of the semiconductor-based microinverter is our proprietary application-specific integrated circuit (ASIC) which enables the microinverter to operate in grid-tied or off-grid modes. This chip is built in advanced 55nm technology with high speed digital logic and has super-fast response times to changing loads and grid events, alleviating constraints on battery sizing for home energy systems.



Part of the Enphase Energy System, IQ8 Series Microinverters integrate with the Enphase IQ Battery, Enphase IQ Gateway, and the Enphase App monitoring and analysis software.



Connect PV modules quickly and easily to IQ8 Series Microinverters using the included Q-DCC-2 adapter cable with plug-n-play MC4

IQ8 Series Microinverters redefine reliability standards with more than one million cumulative hours of power-on testing, enabling an industry-leading limited warranty of up to 25 years.

CERTIFIED

IQ8 Series Microinverters are UL Listed as PV Rapid Shut Down Equipment and conform with various regulations, when installed according to manufacturer's instructions.

© 2021 Enphase Energy. All rights reserved. Enphase, the Enphase logo, IQ8 microinverters, and other names are trademarks of Enphase Energy, Inc. Data subject to change.

IQ8SP-DS-0002-01-EN-US-2021-10-19

Easy to install

- Lightweight and compact with plug-n-play connectors
- Power Line Communication (PLC) between components
- Faster installation with simple two-wire cabling

High productivity and reliability

- Produce power even when the grid is down
- More than one million cumulative hours of testing
- Class II double-insulated enclosure
- Optimized for the latest highpowered PV modules

Microgrid-forming

- Complies with the latest advanced grid support
- Remote automatic updates for the latest grid requirements
- Configurable to support a wide range of grid profiles
- Meets CA Rule 21 (UL 1741-SA) requirements

IQ8 and IQ8+ Microinverters

INPUT DATA (DC)		108-60-2-US	IQ8PLUS-72-2-US	
Commonly used module pairings ¹	W	235 - 350	235 - 440	
Module compatibility		60-cell/120 half-cell	60-cell/120 half-cell and 72-cell/144 half-cell	
MPPT voltage range	٧	27 - 37	29 - 45	
Operating range	٧	25 - 48	25 - 58	
Min/max start voltage	٧	30 / 48	30 / 58	
Max input DC voltage	٧	50	60	
Max DC current ² [module lsc]	Α	1	5	
Overvoltage class DC port			I	
DC port backfeed current	mA		0	
PV array configuration		1x1 Ungrounded array; No additional DC side protection requ	ired; AC side protection requires max 20A per branch circuit	
OUTPUT DATA (AC)		108-60-2-US	108PLUS-72-2-US	
Peak output power	VA	245	300	
Max continuous output power	VA	240	290	
Nominal (L-L) voltage/range ³	٧	240 / 2	11 – 264	
Max continuous output current	Α	1.0	1.21	
Nominal frequency	Hz	6	0	
Extended frequency range	Hz	50	- 68	
Max units per 20 A (L-L) branch circuit		16	13	
Total harmonic distortion		<5	5%	
Overvoltage class AC port		1	П	
AC port backfeed current	mA	3	0	
Power factor setting		1.	0	
Grid-tied power factor (adjustable)		0.85 leading	- 0.85 lagging	
Peak efficiency	%	97.5	97.6	
CEC weighted efficiency	%	97	97	
Night-time power consumption	mW	6	0	
MECHANICAL DATA				
Ambient temperature range		-40°C to +60°C	(-40°F to +140°F)	
Relative humidity range		4% to 100% (condensing)		
DC Connector type		M	C4	
Dimensions (HxWxD)		212 mm (8.3") x 175 mm	n (6.9") x 30.2 mm (1.2")	
Weight		1.08 kg (2.38 lbs)		
Cooling		Natural convection – no fans		
Approved for wet locations		Yes		
Acoustic noise at 1 m		<60 dBA		
Pollution degree		PI	03	
Enclosure		Class II double-insulated, corros	ion resistant polymeric enclosure	
Environ. category / UV exposure rating		NEMA Type	6 / outdoor	
COMPLIANCE				
		CA Rule 21 (UL 1741-SA), UL 62109-1, UL1741/IEEE1547, FCC Part	15 Class B, ICES-0003 Class B, CAN/CSA-C22.2 NO. 107.1-01	
Certifications		This product is UL Listed as PV Rapid Shut Down Equipment and	conforms with NEC 2014 NEC 2017 and NEC 2020 section	

690.12 and C22.1-2018 Rule 64-218 Rapid Shutdown of PV Systems, for AC and DC conductors, when installed according to

(1) No enforced DC/AC ratio. See the compatibility calculator at https://link.enphase.com/module-compatibility (2) Maximum continuous input DC current is 10.6A (3) Nominal voltage range can be extended beyond nominal if required by the utility. (4) Limits may vary. Refer to local requirements to define the number of microinverters per branch in your area.

manufacturer's instructions.

IQ8SP-DS-0002-01-EN-US-2021-10-19



CONTRACTOR

NAME: TOP TIER SOLAR SOLUTIONS
ADDRESS: 1530 CENTER PARK DR,
CHARLOTTE, NC 28217, USA

PHONE: 855-997-1213

CONTRACTOR LICENSE #: SC - CLG.123883 ELECTRICAL LICENSE #: NC - 87345

EMAIL : bdunford@toptiersolarsolutions.com

REVISIONS						
DESCRIPTION DATE REV						

SIGNATURE & SEAL

HOMEOWNER INFO

300 NORTH 11TH STREET, ERWIN, NC 28339, USA

APN: 6059711090001 EMAIL: -

JON WHITE

PHONE: SHEET NAME

EQUIPMENT SPECIFICATION

ANSI B

SHEET NUMBER

Data Sheet **Enphase Networking**

Enphase IQ Combiner 4/4C

X-IQ-AM1-240-4 X-IQ-AM1-240-4C



The Enphase IQ Combiner 4/4C with Enphase IQ Gateway and integrated LTE-M1 cell modem (included only with IQ Combiner 4C) consolidates interconnection equipment into a single enclosure and streamlines IQ microinverters and storage installations by providing a consistent, pre-wired solution for residential applications. It offers up to four 2-pole input circuits and Eaton BR series busbar assembly.

Smart

- · Includes IQ Gateway for communication and control
- Includes Enphase Mobile Connect cellular modem (CELLMODEM-M1-06-SP-05), included only with IQ Combiner 4C
- Includes solar shield to match Enphase IQ Battery aesthetics and deflect heat
- Flexible networking supports Wi-Fi, Ethernet, or cellular
- · Optional AC receptacle available for PLC bridge
- Provides production metering and consumption monitoring

Simple

- Centered mounting brackets support single stud mounting.
- Supports bottom, back and side conduit entry
- Up to four 2-pole branch circuits for 240 VAC plug-in breakers (not included)
- 80A total PV or storage branch circuits

Reliable

- Durable NRTL-certified NEMA type 3R enclosure
- · Five-year limited warranty
- Two years labor reimbursement program coverage included for both the IQ Combiner SKU's
- UL listed



Enphase IQ Combiner 4/4C

MODEL NUMBER	
IQ Combiner 4 (X-IQ-AM1-240-4)	IQ Combiner 4 with Enphase IQ Gateway printed circuit board for integrated revenue grade PV production metering (ANSI C12.20 +/- 0.5%) and consumption monitoring (+/- 2.5%). Includes a silver solar shield to match the IQ Battery system and IQ System Controller 2 and to deflect heat.
IQ Combiner 4C (X-IQ-AM1-240-4C)	IQ Combiner 4C with Enphase IQ Gateway printed circuit board for integrated revenue grade PV production metering (ANSI C12.20 +/- 0.5%) and consumption monitoring (+/- 2.5%). Includes Enphase Mobile Connect cellular modem (CELLMODEM-M1-06-SP-05), a plug-and-play industrial-grade cell modem for systems up to 60 microinverters. (Availlable in the US, Canada, Mexico, Puerto Rico, and the US Virgin Islands, where there is adequate cellular service in the installation area.) Includes a silver solar shield to match the IQ Battery and IQ System Controller and to deflect heat.
ACCESSORIES AND REPLACEMENT PARTS	(not included, order separately)
Ensemble Communications Kit COMMS-CELLMODEM-M1-06 CELLMODEM-M1-06-SP-05 CELLMODEM-M1-06-AT-05	- Includes COMMS-KIT-01 and CELLMODEM-M1-06-SP-05 with 5-year Sprint data plan for Ensemble sites - 4G based LTE-M1 cellular modem with 5-year Sprint data plan - 4G based LTE-M1 cellular modem with 5-year AT&T data plan
Circuit Breakers BRK-10A-2-240V BRK-15A-2-240V BRK-20A-2P-240V BRK-15A-2P-240V-B BRK-20A-2P-240V-B	Supports Eaton BR210, BR215, BR220, BR230, BR240, BR250, and BR260 circuit breakers. Circuit breaker, 2 pole, 10A, Eaton BR215 Circuit breaker, 2 pole, 15A, Eaton BR215 Circuit breaker, 2 pole, 20A, Eaton BR220 Circuit breaker, 2 pole, 15A, Eaton BR215B with hold down kit support Circuit breaker, 2 pole, 20A, Eaton BR220B with hold down kit support
EPLC-01	Power line carrier (communication bridge pair), quantity - one pair
XA-SOLARSHIELD-ES	Replacement solar shield for IQ Combiner 4/4C
XA-PLUG-120-3	Accessory receptacle for Power Line Carrier in IQ Combiner 4/4C (required for EPLC-01)
XA-ENV-PCBA-3	Replacement IQ Gateway printed circuit board (PCB) for Combiner 4/4C
X-IQ-NA-HD-125A	Hold down kit for Eaton circuit breaker with screws.
ELECTRICAL SPECIFICATIONS	
Rating	Continuous duty
System voltage	120/240 VAC, 60 Hz
Eaton BR series busbar rating	125 A
Max. continuous current rating	65 A
Max. continuous current rating (input from PV/storage)	64 A
Max. fuse/circuit rating (output)	90 A
Branch circuits (solar and/or storage)	Up to four 2-pole Eaton BR series Distributed Generation (DG) breakers only (not included)
Max. total branch circuit breaker rating (input)	80A of distributed generation / 95A with IQ Gateway breaker included
Production metering CT	200 A solid core pre-installed and wired to IQ Gateway
Consumption monitoring CT (CT-200-SPLIT)	A pair of 200 A split core current transformers
MECHANICAL DATA	
Dimensions (WxHxD)	37.5 x 49.5 x 16.8 cm (14.75" x 19.5" x 6.63"). Height is 21.06" (53.5 cm) with mounting brackets.
Weight	7.5 kg (16.5 lbs)
Ambient temperature range	-40° C to +46° C (-40° to 115° F)
Cooling	Natural convection, plus heat shield
Enclosure environmental rating	Outdoor, NRTL-certified, NEMA type 3R, polycarbonate construction
Wire sizes	 20 A to 50 A breaker inputs: 14 to 4 AWG copper conductors 60 A breaker branch input: 4 to 1/0 AWG copper conductors Main lug combined output: 10 to 2/0 AWG copper conductors Neutral and ground: 14 to 1/0 copper conductors Always follow local code requirements for conductor sizing.
Altitude	To 2000 meters (6,560 feet)
INTERNET CONNECTION OPTIONS	
Integrated Wi-Fi	802.11b/g/n
Cellular	CELLMODEM-M1-06-SP-05, CELLMODEM-M1-06-AT-05 (4G based LTE-M1 cellular modem). Note that an Enphase Mobile Connect cellular modem is required for all Ensemble installations.
Ethernet	Optional, 802.3, Cat5E (or Cat 6) UTP Ethernet cable (not included)
COMPLIANCE	
Compliance, IQ Combiner	UL 1741, CAN/CSA C22.2 No. 107.1, 47 CFR, Part 15, Class B, ICES 003 Production metering: ANSI C12.20 accuracy class 0.5 (PV production) Consumption metering: accuracy class 2.5
Compliance, IQ Gateway	UL 60601-1/CANCSA 22.2 No. 61010-1

To learn more about Enphase offerings, visit $\underline{\text{\bf enphase.com}}$

© 2021 Enphase Energy. All rights reserved. Enphase, the Enphase logo, IQ Combiner 4/4C, and other names are trademarks of Enphase Energy, Inc. Data subject to change. 10-21-2021



CONTRACTOR

NAME: TOP TIER SOLAR SOLUTIONS ADDRESS: 1530 CENTER PARK DR, CHARLOTTE, NC 28217, USA

PHONE: 855-997-1213

CONTRACTOR LICENSE #: SC - CLG.123883 ELECTRICAL LICENSE #: NC - 87345

EMAIL : bdunford@toptiersolarsolutions.com

REVISIONS				
DESCRIPTION	DATE	REV		

SIGNATURE & SEAL

HOMEOWNER INFO

300 NORTH 11TH STREET ERWIN, NC 28339, USA

APN: 6059711090001 EMAIL: -PHONE: -

ENPHASE.

JON WHITE

SHEET NAME

EQUIPMENT SPECIFICATION

SHEET SIZE ANSI B

11" X 17"
SHEET NUMBER

TOP TIER

CONTRACTOR NAME: TOP TIER SOLAR SOLUTIONS ADDRESS: 1530 CENTER PARK DR, CHARLOTTE, NC 28217, USA PHONE: 855-997-1213

CONTRACTOR LICENSE #: SC - CLG.123883 ELECTRICAL LICENSE #: NC - 87345 EMAIL : bdunford@toptiersolarsolutions.co **REVISIONS**

SIGNATURE & SEAL

HOMEOWNER INFO

JON WHITE

APN: 6059711090001

FMAII ·

PHONE:

300 NORTH 11TH STREET ERWIN, NC 28339, USA

DATE REV

DESCRIPTION



Flush Mount System



Built for solar's toughest roofs.

IronRidge builds the strongest mounting system for pitched roofs in solar. Every component has been tested to the limit and proven in extreme environments.

Our rigorous approach has led to unique structural features, such as curved rails and reinforced flashings, and is also why our products are fully certified, code compliant and backed by a 20-year warranty.



Strength Tested

All components evaluated for superior structural performance.



PE Certified

Pre-stamped engineering letters available in most states.

Online software makes it simple to

create, share, and price projects.



Class A Fire Rating

Certified to maintain the fire resistance rating of the existing roof.





20-Year Warranty

Design Assistant

Twice the protection offered by competitors.

XR Rails 🖶 -

XR10 Rail



A low-profile mounting rail for regions with light snow.

- · 6' spanning capability
- · Moderate load capability
- Clear and black finish

UFOs

XR100 Rail



The ultimate residential solar mounting rail.

- 8' spanning capability
- · Heavy load capability
- · Clear and black finish

XR1000 Rail



A heavyweight mounting rail for commercial projects.

- · 12' spanning capability
- · Extreme load capability
- · Clear anodized finish

Bonded Splices



All rails use internal splices for seamless connections.

- Self-drilling screws
- · Varying versions for rails
- Forms secure bonding

Grounding Lugs

Clamps & Grounding



Universal Fastening Objects bond modules to rails.

- Fully assembled & lubed
- · Single, universal size
- · Clear and black finish

Stopper Sleeves



Snap onto the UFO to turn into a bonded end clamp.

- · Bonds modules to rails
- · Sized to match modules · Clear and black finish

equipment ground. Low profile

Connect arrays to

- Single tool installation
- · Mounts in any direction

Microinverter Kits



Mount MIs or POs to XR Rails.

- · Bonds devices to rails
- Kit comes assembled
- · Listed to UL 2703

Attachments

FlashFoot2



Flash and mount XR Rails with superior waterproofing.

- Twist-on Cap eases install

Resources

- Wind-driven rain tested · Mill and black finish

Slotted L-Feet



Drop-in design for rapid rail attachment.

- Secure rail connections
- Slot for vertical adjusting
- · Clear and black finish

Go from rough layout to fully

engineered system. For free.

Go to IronRidge.com/design

Design Assistant

Bonding Hardware



Bond and attach XR Rails to roof attachments.

- T & Square Bolt options
- · Nut uses 7/16" socket
- Assembled and lubricated

Flush Standoffs



Raise Flush Mount System to various heights.

- · Works with vent flashing
- 4" and 7" lengths
- Ships assembled

NABCEP Certified Training



Earn free continuing education credits. while learning more about our systems. Go to IronRidge.com/training



ANSIB 11" X 17"

SHEET NAME

EQUIPMENT


SPECIFICATION


SHEET SIZE

SHEET NUMBER **PV-10**



L-Foot

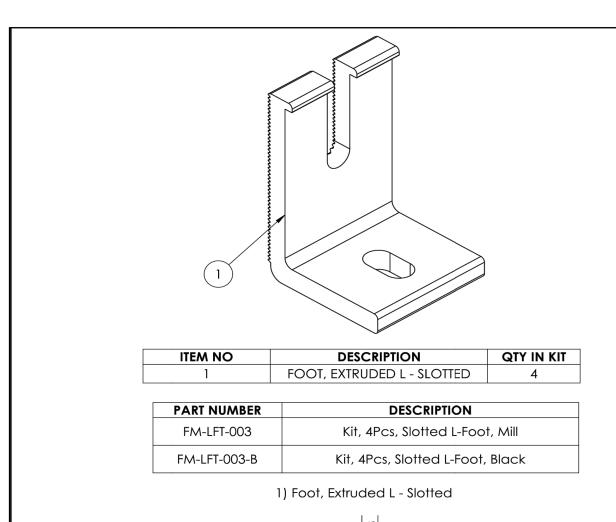

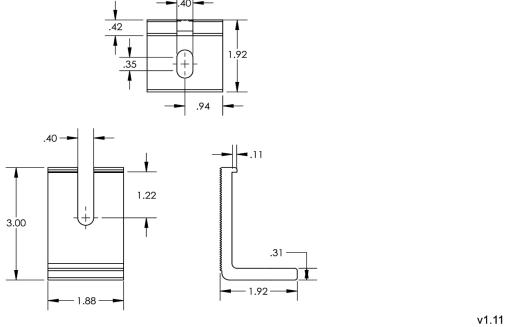



CONTRACTOR
NAME: TOP TIER SOLAR SOLUTIONS ADDRESS: 1530 CENTER PARK DR, CHARLOTTE, NC 28217, USA

PHONE: 855-997-1213

CONTRACTOR LICENSE #: SC - CLG.123883 ELECTRICAL LICENSE #: NC - 87345

EMAIL : bdunford@toptiersolarsolutions.com

REVISIONS						
DESCRIPTION DATE REV						

SIGNATURE & SEAL

HOMEOWNER INFO

300 NORTH 11TH STREET, ERWIN, NC 28339, USA

APN: 6059711090001 EMAIL: -PHONE: -

JON WHITE

SHEET NAME

EQUIPMENT SPECIFICATION

> SHEET SIZE ANSI B 11" X 17"

SHEET NUMBER