PHOTOVOLTAIC ROOF MOUNT SYSTEM

23 MODULES - SYSTEM SIZE STC (8.855 KW DC / 6.67 KW AC) 300 NORTH 11TH STREET, ERWIN, NC 28339, USA (35.3307682°, -78.6730033°)

SYSTEM SUMMARY STC DC/AC

(8.855 KW DC / 6.67 KW AC)

- 1X STRING OF 12 CONNECTED IN PARALLEL
- 1X STRING OF 11 CONNECTED IN PARALLEL
- (23) MISSION SOLAR ENERGY MSE385SX5R 385W MODULES
- (23) ENPHASE IQ8PLUS-72-2-US [240V] MICROINVERTERS
- STC DC: (23) 385W = 8.855 KW
- STC AC: (23) 290W = 6.67 KW

GOVERNING CODES

- 2018 NORTH CAROLINA STATE FIRE PREVENTION CODE
 2018 NORTH CAROLINA STATE BUILDING CODE
- 2018 NORTH CAROLINA STATE RESIDENTIAL CODE
- 2017 NATIONAL ELECTRICAL CODE

GENERAL NOTES

- ALL PANELS, SWITCHES, ETC. SHALL HAVE SUFFICIENT GUTTER SPACE AND LUGS IN COMPLIANCE WITH UL REQUIREMENTS TO ACCOMMODATE
- THIS SYSTEM WILL NOT BE INTERCONNECTED UNTIL APPROVAL FROM THE LOCAL JURISDICTION AND UTILITY IS OBTAINED.
- ALL EXTERIOR ELECTRICAL DEVICES AND EQUIPMENT INCLUDING THOSE THAT ARE EXPOSED TO OUTSIDE ENVIRONMENT SHALL BE WEATHERPROOF AND SHALL BE LISTED BY 'UL' FOR THE TYPE OF APPLICATION AND 'UL' LABEL SHALL APPEAR ON ALL ELECTRICAL
- WIRING METHOD SHALL BE EMT ABOVE GROUND MOUNTED IN CONCEALED SPACES (UNLESS APPROVED OTHERWISE) AND SCHEDULE-40 PVC FOR BELOW GROUND INSTALLATIONS UNLESS NOTED OTHERWISE
- AN OSHA APPROVED LADDER PROVIDING ACCESS TO ALL PORTIONS OF THE ARRAY SHALL BE SECURED IN PRIOR TO REQUESTING INSPECTION.
- 6) IT IS THE CONTRACTOR'S RESPONSIBILITY TO INSTALL A SUPPLEMENTAL GROUNDING ELECTRODE CONDUCTOR IF NECESSARY.

SAFETY PLAN NOTES

- INSTALLERS SHALL DRAW IN DESIGNATED SAFETY AREA AROUND HOME. - INSTALLERS SHALL UPDATE NAME, ADDRESS AND PHONE NUMBER OF NEAREST URGENT CARE FACILITY RELATIVE TO THE SITE BEFORE

LOCATION OF NEAREST URGENT CARE FACILITY (FOR INSTALLER USE ONLY)

- ADDRESS


- PHONE NUMBER




SCALE: 1"=20'-0"



Signed 3/12/2023

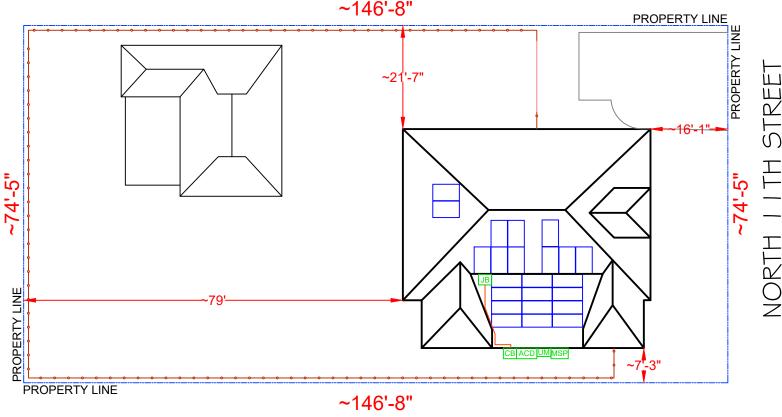

NORTH

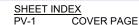

PV-2 **ROOF PLAN WITH MODULES** PV-3 ATTACHMENT DETAIL

PV-4 SINGLE LINE DIAGRAM PV-5 WIRING CALCULATION

PV-6 **PLACARDS** PV-7+ **EQUIPMENT SPECIFICATION**

AHJ: TOWN OF ERWIN UTILITY: DUKE ENERGY (PROGRESS ENERGY CAROLINAS

INC) ARRAY LOCATIONS



HOUSE PHOTO SCALE: NTS



VICINITY MAP SCALE: NTS



NAME: TOP TIER SOLAR SOLUTIONS ADDRESS: 1530 CENTER PARK DR, CHARLOTTE, NC 28217, USA PHONE: 855-997-1213

CONTRACTOR LICENSE #: 87345

ELECTRICAL LICENSE #: U.35673

REVISIONS				
DESCRIPTION	DATE	REV		

SIGNATURE & SEAL

HOMEOWNER INFO

11TH STREET, C 28339, USA JON WHITE 300 NORTH 11 ERWIN, NC 2

APN: 6059711090001 FMAII · PHONE:

SHEET NAME

COVER PAGE

SHEET SIZE **ANSIB** 11" X 17"

SHEET NUMBER

MODULE AREA & WEIGHT CALCULATIONS

PANEL TYPES (COUNT, AREA, WEIGHT):

- (23x) MISSION SOLAR ENERGY MSE385SX5R 385W (75.1" x 41.1", 49 LBS)

MICRO-INVERTER TYPES (COUNT, WEIGHT): - (23x) ENPHASE IQ8PLUS-72-2-US [240V] (2.38 LBS)

MOUNTING SYSTEM WEIGHT/MODULE: 1.5 LBS TOTAL ROOF AREA: 2501 SF

TOTAL ARRAY AREA: (23) 75.1" x 41.1" = 493.00 SF TOTAL ARRAY WEIGHT: (23) 49.0 + (23) 2.4 + (23) 1.5 = 1216 LBS

WEIGHT AT EACH CONNECTION: 1216 LBS / 73 = 16.66 LBS DISTRIBUTED LOAD: 1216 LBS / 493.00 SF = 2.47 PSF ROOF AREA COVERED BY ARRAY: 493 SF / 2501 SF = 19.7%

BILL OF MATERIALS				
SOLAR PV MODULES	23	MISSION SOLAR ENERGY MSE385SX5R 385W		
MICRO INVERTERS	23	ENPHASE IQ8PLUS-72-2-US [240V]		
JUNCTION BOX	01	600V, NEMA 3R RATED JBOX		
LOAD CENTER	01	ENPHASE IQ COMBINER BOX 4		
AC DISCONNECT	01	PV VISIBLE LOCKABLE LABELED DISCONNECT (60A UNFUSED 1PH 240VAC) MAKE: EATON MODEL: DG222URB		
ATTACHMENTS	73	IRONRIDGE - SLOTTED L-FEET		
RAIL	17	IRONRIDGE RESOURCES - XR10		
RAIL SPLICES	08	RAIL SPLICES		
MID CLAMPS	28	MID CLAMP		
END CLAMPS	36	END CLAMP		
GROUNDING LUG	09	GROUNDING LUG		

	ROOF DESCRIPTION TABLE						
ROOF PLANE	TRUSS SIZE	TRUSS SPACING	ATTACHMENT SPACING	MODULE COUNT	ARRAY TILT	AZIMUTH	
#1	2" x 4"	24" O.C.	48" O.C	9	30°	180°	
#2	2" x 4"	24" O.C.	48" O.C	12	26°	180°	
#3	2" x 4"	24" O.C.	48" O.C	2	30°	270°	

DESIGN CRITERIA

EXPOSURE CATEGORY = B WIND SPEED = 119 MPH SNOW LOAD = 10 PSF



STREET

(E) FRONT YARD NORTH

6'-11" 18" FIRE SETBACK 18" FIRE SETBACK BACKYARD ROOF #1 PITCH 30° AZIMUTH 180° (E)4'-4" CB ACD UM MSP 18'-11" ROOF #2 PITCH 26° ROOF #3 PITCH 30° AZIMUTH 180° AZIMUTH 270°

ROOF PLAN WITH MODULES

SCALE: 1/8" = 1'-0"



TOP TIER

CONTRACTOR

NAME: TOP TIER SOLAR SOLUTIONS ADDRESS: 1530 CENTER PARK DR, CHARLOTTE, NC 28217, USA PHONE: 855-997-1213

CONTRACTOR LICENSE #: 87345

ELECTRICAL LICENSE #: U.35673

REVISIONS				
DESCRIPTION	DATE	REV		

SIGNATURE & SEAL

HOMEOWNER INFO

300 NORTH 11TH STREET ERWIN, NC 28339, USA JON WHITE

APN: 6059711090001 PHONE: -


SHEET NAME

ROOF PLAN WITH MODULES

> SHEET SIZE **ANSI B** 11" X 17"

SHEET NUMBER

PV-2

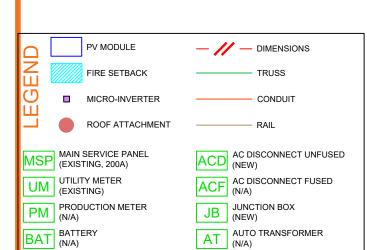


CB COMBINER BOX (NEW) DCD DC DISCONNECT (N/A) SM SOLAREDGE METER (N/A) DCC DC COMBINER (N/A) BLP BACKUP LOAD PANEL (N/A)

(0) INVERTER (N/A)

SUBPANEL (N/A)

EE EXISTING EQUIPMENT

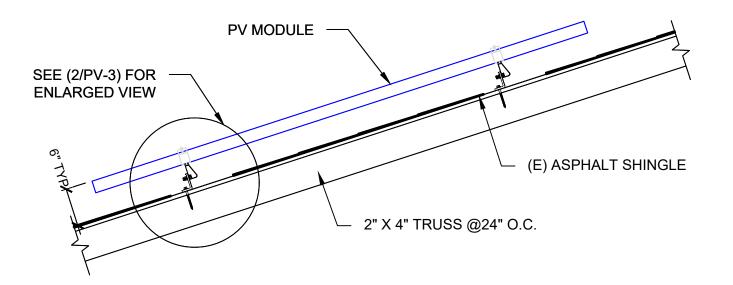



Signed 3/12/2023



CONTRACTO

NAME: TOP TIER SOLAR SOLUTIONS ADDRESS: 1530 CENTER PARK DR, CHARLOTTE, NC 28217, USA PHONE: 855-997-1213


CONTRACTOR LICENSE #: 87345

REVISIONS				
DESCRIPTION	DATE	REV		

SIGNATURE & SEAL

ATTACHMENT DETAIL

SCALE: NTS

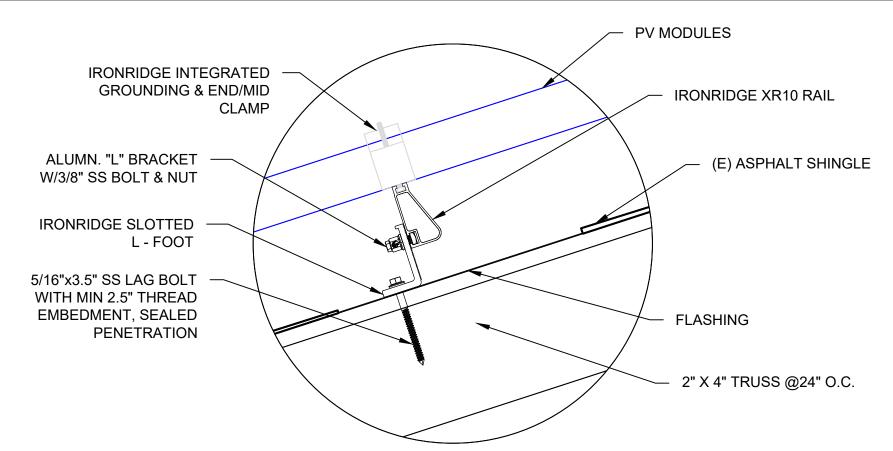

ATTACHMENT DETAIL (ENLARGED SECTION VIEW)

SCALE: NTS

HOMEOWNER INFO

JON WHITE 300 NORTH 11TH STREET, ERWIN, NC 28339, USA

APN: 605971109000 EMAIL: -

PHONE: -

SHEET NAME

ATTACHMENT DETAIL

> SHEET SIZE ANSI B 11" X 17"

SHEET NUMBER


SYSTEM SUMMARY STC DC/AC (8.855 KW DC / 6.67 KW AC)

- 1X STRING OF 12 CONNECTED IN PARALLEL
- 1X STRING OF 11 CONNECTED IN PARALLEL
- (23) MISSION SOLAR ENERGY MSE385SX5R 385W MODULES - (23) ENPHASE IQ8PLUS-72-2-US [240V] MICROINVERTERS STC DC: (23) 385W = 8.855 KW

STC AC: (23) 290W = 6.67 KW

- ALL GROUNDING TO COMPLY WITH NEC 690.47.
- ROOF TOP CONDUIT SHALL BE LOCATED MIN. 7/8" ABOVE ROOF SURFACE.
- ALL TERMINALS SHALL BE MIN. 75 DEG. C RATED.

 HOLD ON KITS FOR PV BREAKERS IS MANDATORY FOR IQ COMBINER 4.

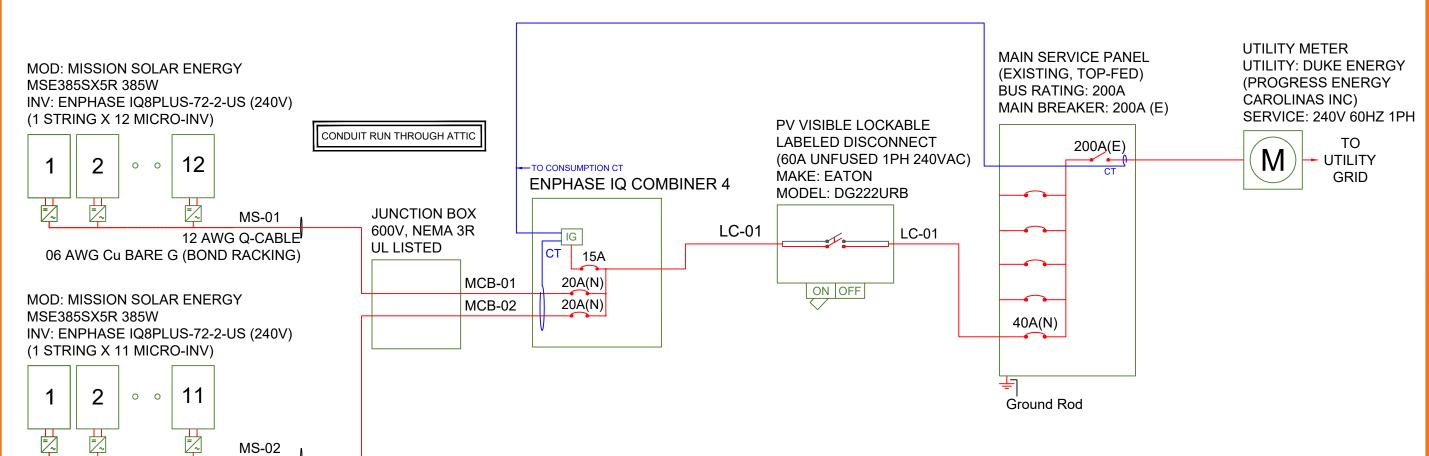

AC wire details								
Wire	Min Ampacity	Live	Neutral	Ground	Min EMT	Min PVC	Min RMC	
MS-01	18.15A	12 AWG (Q-Cable)	-	06 AWG BARE (NOT IN CONDUIT)	-	-	-	
MS-02	16.64A	12 AWG (Q-Cable)	-	06 AWG BARE (NOT IN CONDUIT)	-	-	-	
MCB-01	18.15A	(2) 10 AWG THWN-2	10 AWG THWN-2	10 AWG THWN-2	0.50 in	0.50 in	0.50 in	
MCB-02	16.64A	(2) 10 AWG THWN-2	10 AWG THWN-2	10 AWG THWN-2	0.50 in	0.50 in	0.50 in	
LC-01	34.79A	(2) 08 AWG THWN-2	08 AWG THWN-2	10 AWG THWN-2	0.75 in	0.75 in	0.75 in	

INTERCONNECTION 120% RULE (MAIN PANEL)

UTILITY FEED + TOTAL BACKFEED 200A + 40A = 240A

> LESS OR EQUAL TO BUS RATING x 120% 200A x 120% = 240A

CALCULATION ENSURES BUS IS SAFE REGARDLESS OF LOADS

EXTREME CASE MODULE OUTPUT (MISSION SOLAR ENERGY MSE385SX5R 385W)

 $Isc(25^{\circ}C) = 10.97A$, $Tisc = 0.039\%/^{\circ}C$ $Isc(T) = Isc(25^{\circ}C) \times [1 + Tisc \times (T-25^{\circ}C)]$ $Isc(-10^{\circ}C) = 10.82A, Isc(35^{\circ}C) = 11.01A$

 $Voc(25^{\circ}C) = 45.03V$, $Tvoc = -0.262\%/^{\circ}C$ $Voc(T) = Voc(25^{\circ}C) \times [1 + Tvoc \times (T-25^{\circ}C)]$ $Voc(-10^{\circ}C) = 49.16V, Voc(35^{\circ}C) = 43.85V$

TOP TIER

CONTRACTOR

NAME: TOP TIER SOLAR SOLUTIONS ADDRESS: 1530 CENTER PARK DR, CHARLOTTE, NC 28217, USA PHONE: 855-997-1213

CONTRACTOR LICENSE #: 87345

REVISIONS				
DESCRIPTION	DATE	REV		

SIGNATURE & SEAL

HOMEOWNER INFO

300 NORTH 11TH STREET ERWIN, NC 28339, USA

APN: 6059711090001 FMAII ·

PHONE: -

JON WHITE

SHEET NAME

SINGLE LINE DIAGRAM

> SHEET SIZE **ANSIB** 11" X 17"

SHEET NUMBER PV-4

ELECTRICAL SINGLE LINE DIAGRAM

12 AWG Q-CABLE

06 AWG Cu BARE G (BOND RACKING)

SCALE: NTS

SYSTEM SUMMARY STC DC/AC (8.855 KW DC / 6.67 KW AC)

• 1X STRING OF 12 CONNECTED IN PARALLEL

• 1X STRING OF 11 CONNECTED IN PARALLEL

- (23) MISSION SOLAR ENERGY MSE385SX5R 385W MODULES

- (23) ENPHASE IQ8PLUS-72-2-US [240V] MICROINVERTERS

STC DC: (23) 385W = 8.855 KW STC AC: (23) 290W = 6.67 KW

	AC wire details																
WireID	#Modules	Nominal	Backfeed *1.25	Min	Total	Conductor	ccConductors	Expected	Adjusted ampacity (ampacity x temp	Conductor &	EGC size	Conductor	Max	V drop	Min EMT	Min PVC	Min RMC
VilleiD	#iviodules	Voltage	/cond. set	OCPD	Power	sets	/conduit	max temp	derate x conduit fill derate)	neutral size	(Cu)	metal	length		size	size	size
MS-01	12	240 V	18.15 A	20 A	3.5 kW	1	2	35	25 x 0.94 x 1.00 = 23.50 A	12 AWG (Q-Cable)	06 AWG BARE (NOT IN CONDUIT)	Cu	50 ft	1.05 %	-	-	-
MS-02	11	240 V	16.64 A	20 A	3.2 kW	1	2	35	25 x 0.94 x 1.00 = 23.50 A	12 AWG (Q-Cable)	06 AWG BARE (NOT IN CONDUIT)	Cu	50 ft	0.97 %	-	-	-
MCB-01	12	240 V	18.15 A	20 A	3.5 kW	1	2	35	35 x 0.94 x 1.00 = 32.90 A	10 AWG THWN-2	10 AWG THWN-2	Cu	50 ft	0.63 %	0.50 in	0.50 in	0.50 in
MCB-02	11	240 V	16.64 A	20 A	3.2 kW	1	2	35	35 x 0.94 x 1.00 = 32.90 A	10 AWG THWN-2	10 AWG THWN-2	Cu	50 ft	0.58 %	0.50 in	0.50 in	0.50 in
LC-01	23	240 V	34.79 A	40 A	6.7 kW	1	2	35	50 x 0.94 x 1.00 = 47.00 A	08 AWG THWN-2	10 AWG THWN-2	Cu	10 ft	0.16 %	0.75 in	0.75 in	0.75 in

INTERCONNECTION 120% RULE (MAIN PANEL)

UTILITY FEED + TOTAL BACKFEED 200A + 40A = 240A

> LESS OR EQUAL TO BUS RATING x 120% 200A x 120% = 240A

CALCULATION ENSURES BUS IS SAFE REGARDLESS OF LOADS

EXTREME CASE MODULE OUTPUT (MISSION SOLAR ENERGY MSE385SX5R 385W)

lsc(25°C) = 10.97A, Tisc = 0.039%/°C lsc(T) = lsc(25°C) x [1 + Tisc x (T-25°C)] lsc(-10°C) = 10.82A, lsc(35°C) = 11.01A

Voc(25°C) = 45.03V, Tvoc = -0.262%/°C Voc(T) = Voc(25°C) x [1 + Tvoc x (T-25°C)] Voc(-10°C) = 49.16V, Voc(35°C) = 43.85V

ELECTRICAL NOTES

- ALL EQUIPMENT TO BE LISTED BY UL OR OTHER NRTL, AND LABELED FOR ITS APPLICATION.
- ALL CONDUCTORS SHALL BE COPPER, RATED FOR 600 V AND 90 DEGREE C WET ENVIRONMENT.
- 3) WIRING, CONDUIT, AND RACEWAYS MOUNTED ON ROOFTOPS SHALL BE ROUTED DIRECTLY TO, AND LOCATED AS CLOSE AS POSSIBLE TO THE NEAREST RIDGE, HIP, OR VALLEY.
- 4) WORKING CLEARANCES AROUND ALL NEW AND EXISTING ELECTRICAL EQUIPMENT SHALL COMPLY WITH NEC 110.26.
- 5) DRAWINGS INDICATE THE GENERAL ARRANGEMENT OF SYSTEMS. CONTRACTOR SHALL FURNISH ALL NECESSARY OUTLETS, SUPPORTS, FITTINGS AND ACCESSORIES TO FULFILL APPLICABLE CODES AND STANDARDS.
- 6) WHERE SIZES OF JUNCTION BOXES, RACEWAYS, AND CONDUITS ARE NOT SPECIFIED, THE CONTRACTOR SHALL SIZE THEM ACCORDINGLY.
- 7) ALL WIRE TERMINATIONS SHALL BE APPROPRIATELY LABELED AND READILY VISIBLE.
- 8) MODULE GROUNDING CLIPS TO BE INSTALLED BETWEEN MODULE FRAME AND MODULE SUPPORT RAIL, PER THE GROUNDING CLIP MANUFACTURER'S INSTRUCTION.
- 9) MODULE SUPPORT RAIL TO BE BONDED TO CONTINUOUS COPPER G.E.C.VIA WEEB LUG OR ILSCO GBL-4DBT LAY-IN LUG.
- 10) PV EQUIPMENT SHALL BE DESIGNED AND INSTALLED IN ACCORDANCE WITH NEC 690.
- 11) EXACT LOCATION OF AUXILIARY GROUNDING TO BE DETERMINED AT TIME OF INSTALL.
- 12) EXISTING WIRES MUST BE REPLACED IF SMALLER THAN LISTED MINIMUM SIZES PER NEC 310.15(B)(16).
- 13) AC DISCONNECT LOCATED WITHIN 10' OR LESS FROM UTILITY METER
- 14) IF ENVOY PRESENT, ENVOY BREAKER DETERMINED AT FACTORY BY MANUFACTURER.
- 15) IF ENVOY PRESENT, FOR IQ COMBINER USE SINGLE CT ON L1. AT SYSTEM CONTROLLER MAIN USE DOUBLE CT ON L1 AND L2.



CONTRACTOR

NAME: TOP TIER SOLAR SOLUTIONS ADDRESS: 1530 CENTER PARK DR, CHARLOTTE, NC 28217, USA

PHONE: 855-997-1213 CONTRACTOR LICENSE #: 87345 ELECTRICAL LICENSE #: U.35673

REVISIONS			
DESCRIPTION	DATE	REV	

SIGNATURE & SEAL

HOMEOWNER INFO

JON WHITE
300 NORTH 11TH STREET,
ERWIN, NC 28339, USA

APN: 6059711090001

PHONE:

SHEET NAME

WIRING CALCULATION

ANSI B

SHEET NUMBER



ELECTRICAL SHOCK HAZARD

TERMINALS ON BOTH LINE AND LOAD SIDES MAY BE ENERGIZED IN THE OPEN POSITION

LABEL LOCATION: INVERTERS, AC DISCONNECTS, AC COMBINER BOXES, AC JUNCTION BOXES CODE REF: NEC 2017 - 690.13(B)



ELECTRICAL SHOCK HAZARI

IF GROUND FAULT IS INDICATED
ALL NORMALLY GROUNDED
CONDUCTORS MAY BE
UNGROUNDED AND ENERGIZED

LABEL LOCATION: AC DISCONNECTS, AC COMBINER BOXES, SERVICE PANELS CODE REF: NEC 2017 - 690.5(C)

PV SYSTEM DISCONNECT

MAXIMUM AC OPERATING CURRENT: 27.83 AMPS NOMINAL OPERATING AC VOLTAGE: 240.0 VAC

LABEL LOCATION: INTERCONNECTION Placard (MSP BACKFEED BREAKER OR TAP BOX IF LINE SIDE TAP), AC DISCONNECTS

CODE REF: NEC 2017 - 690.54

PHOTOVOLTAIC SYSTEM UTILITY DISCONNECT SWITCH

LABEL LOCATION: AC DISCONNECTS FOR UTILITY ACCESS

CODE REF: UTILITY

PHOTOVOLTAIC SYSTEM METER

LABEL LOCATION: PV PRODUCTION METER CODE REF: NEC 2017 - 690.4(B)



LABEL LOCATION: AC COMBINER BOX CODE REF: NEC 2017 - 690.12(B)

IVERTER OUTPUT CONNECTION DO NOT RELOCATE THIS OVERCURRENT DEVICE

LABEL LOCATION: FIRST BACKFEED BREAKER (MSP/SUBPANEL) IF NO LINE SIDE TAP CODE REF: NEC 2017 - 705.12(B)(2)(3)(b), NEC 2017 - 705.12(B)(3), CEC 2019 - 705.12(B)(2)(3)(b), CEC 2019 - 705.12(B)(3)

CAUTION PHOTOVOLTAIC SYSTEM CIRCUIT IS BACKFED

LABEL LOCATION: INTERCONNECTION Placard (MSP BACKFEED BREAKER OR TAP BOX IF LINE SIDE TAP) CODE REF: NEC 2017 - 705.2(4)

PV SOLAR BREAKER

DO NOT RELOCATE THIS OVERCURRENT DEVICE

LABEL LOCATION: FIRST BACKFEED BREAKER (MSP/SUBPANEL) IF NO LINE SIDE TAP CODE REF: NEC 2017 - 705.12(B)(2)(3)(b)

RAPID SHUTDOWN SWITCH FOR SOLAR PV SYSTEM

LABEL LOCATION: MSP CODE REF: NEC 2017 - 690.56(C)(3)




DUAL POWER SOURCE SECOND SOURCE IS PHOTOVOLTIC

LABEL LOCATION: MSP, UTILITY METER (IF SEPARATE) CODE REF: UTILITY



SOLAR PV SYSTEM EQUIPPED WITH RAPID SHUTDOWN

TURN RAPID SHUTDOWN SWITCH TO THE "OFF" POSITION TO SHUT DOWN PV SYSTEM AND REDUCE SHOCK HAZARD IN THE ARRAY.

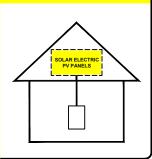

LABEL LOCATION: INTERCONNECTION POINT (MSP OR AC DISCONNECT IF LINE SIDE TAP)
CODE REF: NEC 2017 - 690.12, NEC 2017 - 690.56(C)

POWER TO THIS BUILDING IS ALSO SUPPLIED FROM THE FOLLOWING SOURCES WITH DISCONNECTS LOCATED AS SHOWN AT: MAIN SERVICE PANEL & UTILITY METER AC DISCONNECT & COMBINER BOX PV ARRAYS (E) MAIN SERVICE PANEL (E) UTILITY METER (N) UNFUSED AC DISCONNECT (N) COMBINER BOX

LABEL LOCATION: MSP CODE REF: NEC 2017 - 705.10

NOTES AND SPECIFICATIONS

- 1) SIGNS AND LABELS SHALL MEET THE REQUIREMENTS OF NEC 110.21(B), UNLESS SPECIFIC INSTRUCTIONS ARE REQUIRED BY SECTION 690, OR IF REQUESTED BY THE LOCAL AHJ.
- SIGNS AND LABELS SHALL ADEQUATELY WARN OF HAZARDS USING EFFECTIVE WORDS, COLORS AND SYMBOLS.
- LABELS SHALL BE PERMANENTLY AFFIXED TO THE EQUIPMENT OR WIRING METHOD AND SHALL NOT BE HAND WRITTEN.
- 4) LABEL SHALL BE OF SUFFICIENT DURABILITY TO WITHSTAND THE ENVIRONMENT INVOLVED.
- 5) SIGNS AND LABELS SHALL COMPLY WITH ANSI Z535.4 2011, PRODUCT SAFETY SIGNS AND LABELS, UNLESS OTHERWISE SPECIFIED.
- 6) DO NOT COVER EXISTING MANUFACTURER LABELS.



CONTRACTOR

NAME: TOP TIER SOLAR SOLUTIONS ADDRESS: 1530 CENTER PARK DR, CHARLOTTE, NC 28217, USA PHONE: 855-997-1213

CONTRACTOR LICENSE #: 87345 ELECTRICAL LICENSE #: U.35673

REVISIONS				
DESCRIPTION	DATE	REV		

SIGNATURE & SEAL

HOMEOWNER INFO

WHITE

NOC

300 NORTH 11TH STREET, ERWIN, NC 28339, USA

PHONE: -

APN: 6059711090001

FMAII ·

SHEET NAME

PLACARDS

ANSI B

SHEET NUMBER PV-6





Class leading power output

-0 to +3%



FRAME-TO-FRAME WARRANTY

Degradation guaranteed not to exceed 2% in year one and 0.58% annually

from years two to 30 with 84.08% capacity guaranteed in year 25. For more information, visit www.missionsolar.com/warranty

manufacture our modules. We produce American, high-quality solar modules ensuring the highest-in-class power output and best-in-class reliability. Our product line is tailored for residential, commercial and utility applications. Every Mission Solar Energy solar module is certified and surpasses industry

Demand the best. Demand Mission Solar Energy.

standard regulations, proving excellent performance over the long term.

True American Quality

Mission Solar Energy is headquartered in San Antonio, Texas where we

True American Brand



Certified Reliability

- Tested to UL 61730 & IEC Standards
- PID resistant
- · Resistance to salt mist corrosion



Advanced Technology

- 6 Busbar
- Passivated Emitter Rear Contact
- Ideal for all applications




Extreme Weather Resilience

- Up to 5,400 Pa front load & 3,600 Pa back load
- Tested load to UL 61730
- 40 mm frame



BAA Compliant for Government Projects

- Buy American Act
- American Recovery & Reinvestment Act

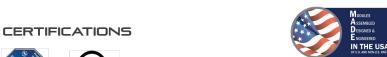



UL 61730 / IEC 61215 / IEC 61730 / IEC 61701

If you have questions or concerns about certification of our products in your area.

Class Leading 375-385W

FRONT VIEW

MSE PERC 66

Temperature Coefficient of Isc

Maximum System Voltage

Operating Temperature Range

Maximum Series Fuse Rating

Fire Safety Classification

Hail Safety Impact Velocity

Solar Cells

Weight

Frame

Cable

CA

Height

47.56 in

(120.80 cm)

Front Glass

Encapsulant Junction Box

53'

Double Stack

Weight

1,274 lbs.

Cell Orientation

Module Dimension

Front & Back Load

(UL Standard)

OPERATING CONDITIONS

MECHANICAL DATA

1.907mm x 1.044mm x 40mm

Ethylene vinyl acetate (EVA)

1.0m, Wire 4mm2 (12AWG)

MC4, Renhe 05-8

SHIPPING INFORMATION

26

PALLET [26 PANELS]

3.2mm, tempered, low-iron, anti-reflective

Protection class IP67 with 3 bypass-diodes

Staubli PV-KBT4/6II-UR and PV-KST4/6II-UR.

676

www.missionsolar.com | info@missionsolar.com

Width

46 in

(116.84 cm)

380 W Bin

296.40 kW

256.88 kW

Length


(195.58 cm)

66 cells (6x11)

22 kg (49 lbs.)

1,000Vdc

25mm at 23 m/s

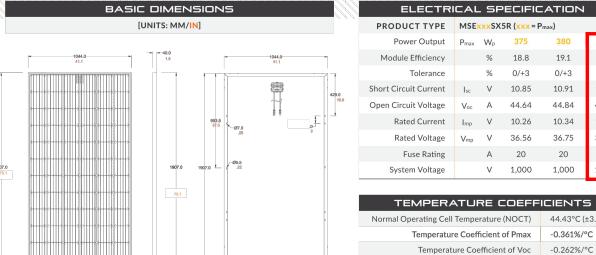


REAR VIEW

CURRENT-VOLTAGE CURVE
MSE385SX5R: 385WP, 66 CELL SOLAR MODULE

Current-voltage characteristics with dependence on irradiance and module temperature

SIDE VIEW

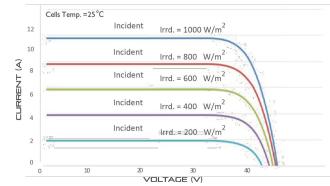

CERTIFICATIONS AND TESTS				
IEC	61215, 61730, 61701			
UL	61730			







Mission Solar Energy

8303 S. New Braunfels Ave., San Antonio, Texas 78235 www.missionsolar.com | info@missionsolar.com

Mission Solar Energy reserves the right to make specification changes without notice. C-SA2-MKTG-0027 REV 2 05/05/2021

19.3

0/+310.97

45.03

10.42

36.93

20

1,000

0.039%/°C

-40°C (-40°F) to +85°C (185°F)

Up to 5,400 Pa front and 3,600 Pa

CONTRACTOR

NAME: TOP TIER SOLAR SOLUTIONS ADDRESS: 1530 CENTER PARK DR, CHARLOTTE, NC 28217, USA PHONE: 855-997-1213

TOP TIER

CONTRACTOR LICENSE #: 87345 ELECTRICAL LICENSE #: U.35673

REVIS	REVISIONS				
DESCRIPTION	DATE	REV			

SIGNATURE & SEAL

HOMEOWNER INFO

11TH STREET, C 28339, USA JON WHITE 300 NORTH 11 ERWIN, NC 2

APN: 6059711090001 FMAII · PHONE:

SHEET NAME

EQUIPMENT SPECIFICATION

> SHEET SIZE **ANSIB** 11" X 17"

SHEET NUMBER PV-7







IQ8 and IQ8+ Microinverters

Our newest IQ8 Microinverters are the industry's first microgrid-forming, software-defined microinverters with split-phase power conversion capability to convert DC power to AC power efficiently. The brain of the semiconductor-based microinverter is our proprietary application-specific integrated circuit (ASIC) which enables the microinverter to operate in grid-tied or off-grid modes. This chip is built in advanced 55nm technology with high speed digital logic and has super-fast response times to changing loads and grid events, alleviating constraints on battery sizing for home energy systems.



Part of the Enphase Energy System, IQ8 Series Microinverters integrate with the Enphase IQ Battery, Enphase IQ Gateway, and the Enphase App monitoring and analysis software.



Connect PV modules quickly and easily to IQ8 Series Microinverters using the included Q-DCC-2 adapter cable with plug-n-play MC4

IQ8 Series Microinverters redefine reliability standards with more than one million cumulative hours of power-on testing, enabling an industry-leading limited warranty of up to 25 years.



IQ8 Series Microinverters are UL Listed as PV Rapid Shut Down Equipment and conform with various regulations, when installed according to manufacturer's instructions.

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IQ8SP-DS-0002-01-EN-US-2021-10-19

Easy to install

- Lightweight and compact with plug-n-play connectors
- Power Line Communication (PLC) between components
- Faster installation with simple two-wire cabling

High productivity and reliability

- Produce power even when the grid is down
- More than one million cumulative hours of testing
- Class II double-insulated enclosure
- Optimized for the latest highpowered PV modules

Microgrid-forming

- Complies with the latest advanced grid support
- Remote automatic updates for the latest grid requirements
- Configurable to support a wide range of grid profiles
- Meets CA Rule 21 (UL 1741-SA) requirements

IQ8 and IQ8+ Microinverters

NPUT DATA (DC)		108-60-2-U\$	IQ8PLUS-72-2-US		
Commonly used module pairings ¹	W	235 - 350	235 - 440		
Module compatibility		60-cell/120 half-cell	60-cell/120 half-cell and 72-cell/144 half-cell		
MPPT voltage range	V	27 - 37	29 - 45		
Operating range	V	25 – 48	25 – 58		
Min/max start voltage	V	30 / 48	30 / 58		
Max input DC voltage	V	50	60		
Max DC current² [module lsc]	А		15		
Overvoltage class DC port			II		
DC port backfeed current	mA		0		
PV array configuration		1x1 Ungrounded array; No additional DC side protection re	equired; AC side protection requires max 20A per branch circu		
DUTPUT DATA (AC)		108-60-2-US	108PLUS-72-2-US		
Peak output power	VA	245	300		
Max continuous output power	VA	240	290		
Nominal (L-L) voltage/range³	V	240	/ 211 – 264		
Max continuous output current	А	1.0	1.21		
Nominal frequency	Hz		60		
Extended frequency range	Hz	Ę	50 - 68		
Max units per 20 A (L-L) branch circu	uit ⁴	16	13		
Total harmonic distortion			<5%		
Overvoltage class AC port			III		
AC port backfeed current	mA		30		
Power factor setting			1.0		
Grid-tied power factor (adjustable)		0.85 leadir	ng – 0.85 lagging		
Peak efficiency	%	97.5	97.6		
CEC weighted efficiency	%	97	97		
Night-time power consumption	mW		60		
MECHANICAL DATA					
Ambient temperature range		-40°C to +60°	°C (-40°F to +140°F)		
Relative humidity range		4% to 100	% (condensing)		
OC Connector type			MC4		
Dimensions (HxWxD)		212 mm (8.3") x 175	mm (6.9") x 30.2 mm (1.2")		
Weight		1.08 k	g (2.38 lbs)		
Cooling		Natural convection - no fans			
Approved for wet locations		Yes			
Acoustic noise at 1 m		<	60 dBA		
Pollution degree			PD3		
Enclosure		Class II double-insulated, corr	rosion resistant polymeric enclosure		
Environ. category / UV exposure rati		NITAAA T.	pe 6 / outdoor		

This product is UL Listed as PV Rapid Shut Down Equipment and conforms with NEC 2014, NEC 2017, and NEC 2020 section 690.12 and C22.1-2018 Rule 64-218 Rapid Shutdown of PV Systems, for AC and DC conductors, when installed according to

(1) No enforced DC/AC ratio. See the compatibility calculator at https://link.enphase.com/module-compatibility (2) Maximum continuous input DC current is 10.6A (3) Nominal voltage range can be extended beyond nominal if required by the utility. (4) Limits may vary. Refer to local requirements to define the number of microinverters per branch in your area.

manufacturer's instructions.

Certifications

IQ8SP-DS-0002-01-EN-US-2021-10-19



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PHONE: 855-997-1213
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ELECTRICAL LICENSE #: U.35673

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JON WHITE

SHEET NAME

EQUIPMENT SPECIFICATION

ANSI B

SHEET NUMBER PV-8

Data Sheet **Enphase Networking**

Enphase IQ Combiner 4/4C

X-IQ-AM1-240-4 X-IQ-AM1-240-4C



The Enphase IQ Combiner 4/4C with Enphase IQ Gateway and integrated LTE-M1 cell modem (included only with IQ Combiner 4C) consolidates interconnection equipment into a single enclosure and streamlines IQ microinverters and storage installations by providing a consistent, pre-wired solution for residential applications. It offers up to four 2-pole input circuits and Eaton BR series busbar assembly.

Smart

- · Includes IQ Gateway for communication and control
- Includes Enphase Mobile Connect cellular modem (CELLMODEM-M1-06-SP-05), included only with IQ Combiner 4C
- Includes solar shield to match Enphase IQ Battery aesthetics and deflect heat
- Flexible networking supports Wi-Fi, Ethernet, or cellular
- · Optional AC receptacle available for PLC bridge
- Provides production metering and consumption monitoring

Simple

- Centered mounting brackets support single stud mounting
- Supports bottom, back and side conduit entry
- Up to four 2-pole branch circuits for 240 VAC plug-in breakers (not included)
- 80A total PV or storage branch circuits

Reliable

- Durable NRTL-certified NEMA type 3R enclosure
- · Five-year limited warranty
- Two years labor reimbursement program coverage included for both the IQ Combiner SKU's
- UL listed



Enphase IQ Combiner 4/4C

MODEL NUMBER	
IQ Combiner 4 (X-IQ-AM1-240-4)	IQ Combiner 4 with Enphase IQ Gateway printed circuit board for integrated revenue grade PV production metering (ANSI C12.20 +/- 0.5%) and consumption monitoring (+/- 2.5%). Includes a silver solar shield to match the IQ Battery system and IQ System Controller 2 and to deflect heat.
IQ Combiner 4C (X-IQ-AM1-240-4C)	IQ Combiner 4C with Enphase IQ Gateway printed circuit board for integrated revenue grade PV production metering (ANSI C12.20 +/- 0.5%) and consumption monitoring (+/- 2.5%). Includes Enphase Mobile Connect cellular modem (CELLMODEM-M1-06-SP-05), a plug-and-play industrial-grade cell modem for systems up to 60 microinverters. (Available in the US, Canada, Mexico, Puerto Rico, and the US Virgin Islands, where there is adequate cellular service in the installation area.) Includes a silver solar shield to match the IQ Battery and IQ System Controller and to deflect heat.
ACCESSORIES AND REPLACEMENT PARTS	(not included, order separately)
Ensemble Communications Kit COMMS-CELLMODEM-M1-06 CELLMODEM-M1-06-SP-05 CELLMODEM-M1-06-AT-05	- Includes COMMS-KIT-01 and CELLMODEM-M1-06-SP-05 with 5-year Sprint data plan for Ensemble sites - 4G based LTE-M1 cellular modem with 5-year Sprint data plan - 4G based LTE-M1 cellular modem with 5-year AT&T data plan
Circuit Breakers BRK-10A-2-240V BRK-15A-2-240V BRK-20A-2P-240V BRK-15A-2P-240V-B BRK-20A-2P-240V-B	Supports Eaton BR210, BR215, BR220, BR230, BR240, BR250, and BR260 circuit breakers. Circuit breaker, 2 pole, 10A, Eaton BR215 Circuit breaker, 2 pole, 20A, Eaton BR215 Circuit breaker, 2 pole, 20A, Eaton BR220 Circuit breaker, 2 pole, 15A, Eaton BR215B with hold down kit support Circuit breaker, 2 pole, 20A, Eaton BR220B with hold down kit support
EPLC-01	Power line carrier (communication bridge pair), quantity - one pair
XA-SOLARSHIELD-ES	Replacement solar shield for IQ Combiner 4/4C
XA-PLUG-120-3	Accessory receptacle for Power Line Carrier in IQ Combiner 4/4C (required for EPLC-01)
XA-ENV-PCBA-3	Replacement IQ Gateway printed circuit board (PCB) for Combiner 4/4C
X-IQ-NA-HD-125A	Hold down kit for Eaton circuit breaker with screws.
ELECTRICAL SPECIFICATIONS	
Rating	Continuous duty
System voltage	120/240 VAC, 60 Hz
Eaton BR series busbar rating	125 A
Max. continuous current rating	65 A
Max. continuous current rating (input from PV/storage)	64 A
Max. fuse/circuit rating (output)	90 A
Branch circuits (solar and/or storage)	Up to four 2-pole Eaton BR series Distributed Generation (DG) breakers only (not included)
Max. total branch circuit breaker rating (input) Production metering CT	80A of distributed generation / 95A with IQ Gateway breaker included 200 A solid core pre-installed and wired to IQ Gateway
Consumption monitoring CT (CT-200-SPLIT)	A pair of 200 A split core current transformers
MECHANICAL DATA	
Dimensions (WxHxD)	37.5 x 49.5 x 16.8 cm (14.75" x 19.5" x 6.63"). Height is 21.06" (53.5 cm) with mounting brackets.
Weight	7.5 kg (16.5 lbs)
Ambient temperature range	-40° C to +46° C (-40° to 115° F)
Cooling	Natural convection, plus heat shield
Enclosure environmental rating	Outdoor, NRTL-certified, NEMA type 3R, polycarbonate construction
Wire sizes	 20 A to 50 A breaker inputs: 14 to 4 AWG copper conductors 60 A breaker branch input: 4 to 1/0 AWG copper conductors Main lug combined output: 10 to 2/0 AWG copper conductors Neutral and ground: 14 to 1/0 copper conductors Always follow local code requirements for conductor sizing.
Altitude	To 2000 meters (6,560 feet)
INTERNET CONNECTION OPTIONS	
Integrated Wi-Fi	802.11b/g/n
Cellular	CELLMODEM-M1-06-SP-05, CELLMODEM-M1-06-AT-05 (4G based LTE-M1 cellular modem). Note that an Enphase Mobile Connect cellular modem is required for all Ensemble installations.
Ethernet	Optional, 802.3, Cat5E (or Cat 6) UTP Ethernet cable (not included)
COMPLIANCE	
Compliance, IQ Combiner	UL 1741, CAN/CSA C22.2 No. 107.1, 47 CFR, Part 15, Class B, ICES 003 Production metering: ANSI C12.20 accuracy class 0.5 (PV production) Consumption metering: accuracy class 2.5
Compliance, IQ Gateway	UL 60601-1/CANCSA 22.2 No. 61010-1

To learn more about Enphase offerings, visit $\underline{\text{\bf enphase.com}}$

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CONTRACTOR

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CONTRACTOR LICENSE #: 87345 ELECTRICAL LICENSE #: U.35673

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DESCRIPTION	DATE	REV				

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300 NORTH 11TH STREET ERWIN, NC 28339, USA

APN: 6059711090001 EMAIL: -PHONE: -

ENPHASE.

JON WHITE

SHEET NAME

EQUIPMENT SPECIFICATION

SHEET SIZE ANSI B 11" X 17"

SHEET NUMBER



JB-1.2 Specification Sheet

PV Junction Box for Composition/Asphalt Shingle Roofs

A. System Specifications and Ratings

Maximum Voltage: 1,000 Volts

Maximum Current: 80 Amps

Allowable Wire: 14 AWG – 6 AWG

Spacing: Please maintain a spacing of at least ½" between uninsulated live parts and fittings for conduit, armored cable, and uninsulated live parts of opposite polarity.

Enclosure Rating: Type 3R
 Roof Slope Range: 2.5 – 12:12
 Max Side Wall Fitting Size: 1"

Max Floor Pass-Through Fitting Size: 1"

Ambient Operating Conditions: (-35°C) - (+75°C)

Compliance:

- JB-1.2: UL1741

- Approved wire connectors: must conform to UL1741

System Marking: Interek Symbol and File #5019942

• Periodic Re-inspections: If re-inspections yield loose components, loose fasteners, or any corrosion between components, components that are found to be affected are to be replaced immediately.

Table 1: Typical Wire Size, Torque Loads and Ratings

	1 Canalizatas	Torqu			Torque	e		
	1 Conductor	2 Conductor	Туре	NM	Inch Lbs	Voltage	Current	
ABB ZS6 terminal block	10-24 awg	16-24 awg	Sol/Str	0.5-0.7	6.2-8.85	600V	30 amp	
ABB ZS10 terminal block	6-24 awg	12-20 awg	Sol/Str	1.0-1.6	8.85-14.16	600V	40 amp	
ABB ZS16 terminal bock	4-24 awg	10-20 awg	Sol/Str	1.6-2.4	14.6-21.24	600V	60 amp	
ABB M6/8 terminal block	8-22 awg		Sol/Str	.08-1	8.85	600V	50 amp	
Ideal 452 Red WING-NUT Wire Connector	8-18 awg		Sol/Str	Self Torque	SelfTorque	600V		
Ideal 451 Yellow WING-NUT Wire Connector	10-18 awg		Sol/Str	Self Torque	SelfTorque	600V		
Ideal, In-Sure Push-In Connector Part #39	10-14 awg		Sol/Str	Self Torque	SelfTorque	600V		
WAGO, 2204-1201	10-20 awg	16-24 awg	Sol/Str	Self Torque	Self Torque	600V	30 amp	
WAGO, 221-612	10-20 awg	10-24 awg	Sol/Str	Self Torque	Self Torque	600V	30 amp	
Dottie DRC75	6-12 awg		Sol/Str	Snap-In	Snap-In			
ESP NG-53	4-6 awg		Sol/Str		45	2000V		
L3F NG-33	10-14 awg		Sol/Str		35	200	,ov	
ESP NG-717	4-6 awg		Sol/Str		45	2000V		
	10-14 awg	·	Sol/Str		35	200	,,,,	
Brumall 4-5,3	4-6 awg	·	Sol/Str		45	200	nov	
Diaman + 5,5	10-14 awg		Sol/Str		35	2000		

Table 2: Minimum wire-bending space for conductors through a wall opposite terminals in mm (inches)

Wire size	e, AWG or	Wires per terminal (pole)									
		1		2		2			3	4 or	More
kcmil	(mm2)	mm	(inch)	mm	(inch)	mm	(inch)	mm	(inch)		
14-10	(2.1-5.3)	Not specified			*		-				
8	(8.4)	38.1	(1-1/2)		-		-		-		
6	(13.3)	50.8	(2)		-		-		-		



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JON WHITE

APN: 6059711090001 EMAIL: -PHONE: -

SHEET NAME

EQUIPMENT SPECIFICATION

ANSI B 11" X 17"

SHEET NUMBER PV-10

Production Specifications

Eaton DG222URB

Catalog number: DG222URB

Eaton General duty non-fusible safety switch, single-throw, 60 A, NEMA 3R, Rainproof, Painted galvanized steel, Two-pole, Two-wire, 240 V

General specifications

Product Length/Depth

Product Name Catalog Number Eaton general duty non-fusible safety DG222URB

UPC

782113144238

Product Height

7.38 in 14.38 in

Product Width Product Weight

8.69 in 9 lb

Warranty Certifications

Eaton Selling Policy 25-000, one (1) year UL Listed

from the date of installation of the

Product or eighteen (18) months from the Catalog Notes

date of shipment of the Product,

whichever occurs first.

WARNING! Switch is not approved for service entrance unless a neutral kit is

installed.

defaultTaxonomyAttributeLabel

Product Category

General duty safety switch

Enclosure material

Painted galvanized steel

Type

Non-fusible, single-throw

Fuse configuration

Non-fusible

Number of wires

2

Enclosure

NEMA 3R

Voltage rating

240V

Amperage Rating

Number Of Poles

Two-pole

Resources

Catalogs

Eaton's Volume 2—Commercial Distribution

Multimedia

Switching Devices Flex Center

Double Up on Safety

Specifications and datasheets

Eaton Specification Sheet - DG222URB

Warranty guides

Selling Policy 25-000 - Distribution and Control Products and Services



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SHEET NAME

JON WHITE

EQUIPMENT SPECIFICATION

> SHEET SIZE **ANSI B** 11" X 17"

SHEET NUMBER



TOP TIER

CONTRACTOR NAME: TOP TIER SOLAR SOLUTIONS ADDRESS: 1530 CENTER PARK DR, CHARLOTTE, NC 28217, USA PHONE: 855-997-1213 CONTRACTOR LICENSE #: 87345 ELECTRICAL LICENSE #: U.35673 **REVISIONS**

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PHONE:

300 NORTH 11TH STREET ERWIN, NC 28339, USA

DATE REV

DESCRIPTION



Flush Mount System



Built for solar's toughest roofs.

IronRidge builds the strongest mounting system for pitched roofs in solar. Every component has been tested to the limit and proven in extreme environments.

Our rigorous approach has led to unique structural features, such as curved rails and reinforced flashings, and is also why our products are fully certified, code compliant and backed by a 20-year warranty.



Strength Tested

All components evaluated for superior structural performance.



PE Certified

Pre-stamped engineering letters available in most states.



Class A Fire Rating

Certified to maintain the fire resistance rating of the existing roof.



Design Assistant

Online software makes it simple to create, share, and price projects.



UL 2703 Listed System

Entire system and components meet newest effective UL 2703 standard.



20-Year Warranty

Twice the protection offered by competitors.

XR Rails 🖶 -

XR10 Rail



A low-profile mounting rail for regions with light snow.

- · 6' spanning capability
- · Moderate load capability
- Clear and black finish

XR100 Rail



The ultimate residential solar mounting rail.

- 8' spanning capability
- · Heavy load capability
- · Clear and black finish

XR1000 Rail



A heavyweight mounting rail for commercial projects.

- · 12' spanning capability
- · Extreme load capability
- · Clear anodized finish

Bonded Splices



All rails use internal splices for seamless connections.

- Self-drilling screws
- · Varying versions for rails
- Forms secure bonding

Grounding Lugs

UFOs



Clamps & Grounding

Universal Fastening Objects bond modules to rails.

- Fully assembled & lubed
- · Single, universal size
- · Clear and black finish

Stopper Sleeves



Snap onto the UFO to turn into a bonded end clamp.

- · Bonds modules to rails
- · Sized to match modules · Clear and black finish

equipment ground. Low profile

Connect arrays to

- Single tool installation
- · Mounts in any direction

Microinverter Kits



Mount MIs or POs to XR Rails.

- · Bonds devices to rails
- Kit comes assembled
- Listed to UL 2703

Attachments

FlashFoot2



Flash and mount XR Rails with superior waterproofing.

- Twist-on Cap eases install
- Wind-driven rain tested

Resources

- · Mill and black finish

Slotted L-Feet



Drop-in design for rapid rail attachment.

- Secure rail connections
- Slot for vertical adjusting
- · Clear and black finish

Design Assistant

Go from rough layout to fully

engineered system. For free.

Go to IronRidge.com/design

Bonding Hardware

Bond and attach XR Rails to roof attachments.

- T & Square Bolt options
- · Nut uses 7/16" socket
- Assembled and lubricated

Flush Standoffs



Raise Flush Mount System to various heights.

- · Works with vent flashing
- 4" and 7" lengths
- Ships assembled

NABCEP Certified Training



Earn free continuing education credits. while learning more about our systems.

Go to IronRidge.com/training



ANSIB 11" X 17"

> SHEET NUMBER **PV-12**

SHEET NAME


EQUIPMENT

SPECIFICATION

SHEET SIZE






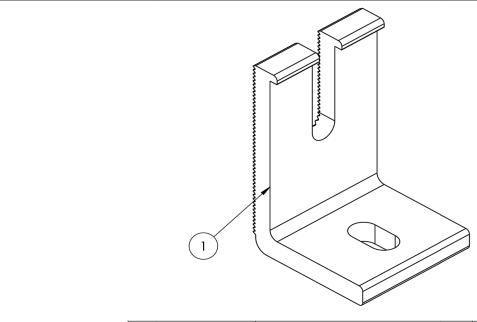

ITEM NO	DESCRIPTION	QTY IN KIT
1	FOOT, EXTRUDED L - SLOTTED	4

PART NUMBER	DESCRIPTION
FM-LFT-003	Kit, 4Pcs, Slotted L-Foot, Mill
FM-LFT-003-B	Kit, 4Pcs, Slotted L-Foot, Black

1) Foot, Extruded L - Slotted

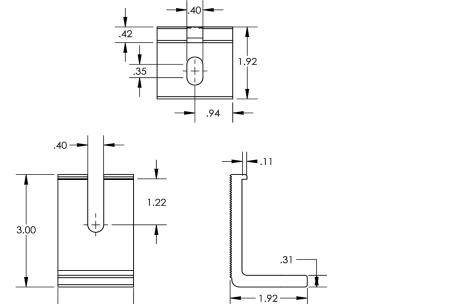

v1.11



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