PHOTOVOLTAIC ROOF MOUNT SYSTEM

30 MODULES - SYSTEM SIZE STC (11.55 kW DC / 8.7 kW AC) 7 RUSHWOOD COURT, COLUMBIA, SC 29209, USA (33.97362, -80.89543)

SYSTEM SUMMARY STC DC/AC

(11.55 kW DC / 8.7 kW AC)

- 3x STRINGS OF 10 CONNECTED IN PARALLEL
- (30) MISSION SOLAR ENERGY MSE385SX5R 385W MODULES
- (30) ENPHASE IQ8PLUS-72-2-US (240V) MICROINVERTERS STC DC: (30) 385 = 11.55 kW
- STC AC: (30) 290 = 8.7 kW

GOVERNING CODES

- 2017 NATIONAL ELECTRIC CODE
- 2018 SOUTH CAROLINA BUILDING CODE
- 2018 INTERNATIONAL BUILDING CODE 2018 SOUTH CAROLINA STATE FIRE CODE
- 2018 SOUTH CAROLINA STATE RESIDENTIAL CODE


- ALL PANELS, SWITCHES, ETC. SHALL HAVE SUFFICIENT GUTTER SPACE AND LUGS IN COMPLIANCE WITH UL REQUIREMENTS TO ACCOMMODATE CONDUCTORS SHOWN.
- THIS SYSTEM WILL NOT BE INTERCONNECTED UNTIL APPROVAL FROM THE LOCAL JURISDICTION AND UTILITY IS OBTAINED.
- ALL EXTERIOR ELECTRICAL DEVICES AND EQUIPMENT INCLUDING THOSE THAT ARE EXPOSED TO OUTSIDE ENVIRONMENT SHALL BE WEATHERPROOF AND SHALL BE LISTED BY 'UL' FOR THE TYPE OF APPLICATION AND 'UL' LABEL SHALL APPEAR ON ALL ELECTRICAL
- WIRING METHOD SHALL BE EMT ABOVE GROUND MOUNTED IN CONCEALED SPACES (UNLESS APPROVED OTHERWISE) AND SCHEDULE-40 PVC FOR BELOW GROUND INSTALLATIONS UNLESS NOTED OTHERWISE.
- AN OSHA APPROVED LADDER PROVIDING ACCESS TO ALL PORTIONS OF THE ARRAY SHALL BE SECURED IN PRIOR TO REQUESTING INSPECTION.
- 6) IT IS THE CONTRACTOR'S RESPONSIBILITY TO INSTALL A SUPPLEMENTAL GROUNDING ELECTRODE CONDUCTOR IF NECESSARY


SAFETY PLAN NOTES

- INSTALLERS SHALL DRAW IN DESIGNATED SAFETY AREA AROUND HOME. - INSTALLERS SHALL UPDATE NAME, ADDRESS AND PHONE NUMBER OF NEAREST URGENT CARE FACILITY RELATIVE TO THE SITE BEFORE

LOCATION OF NEAREST URGENT CARE FACILITY

(FOR INSTALLER USE ONLY)

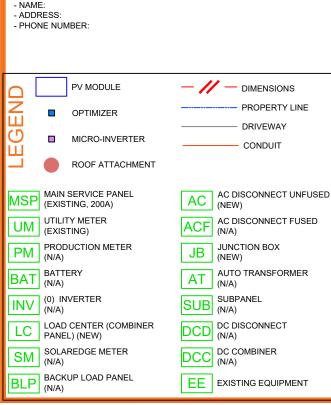

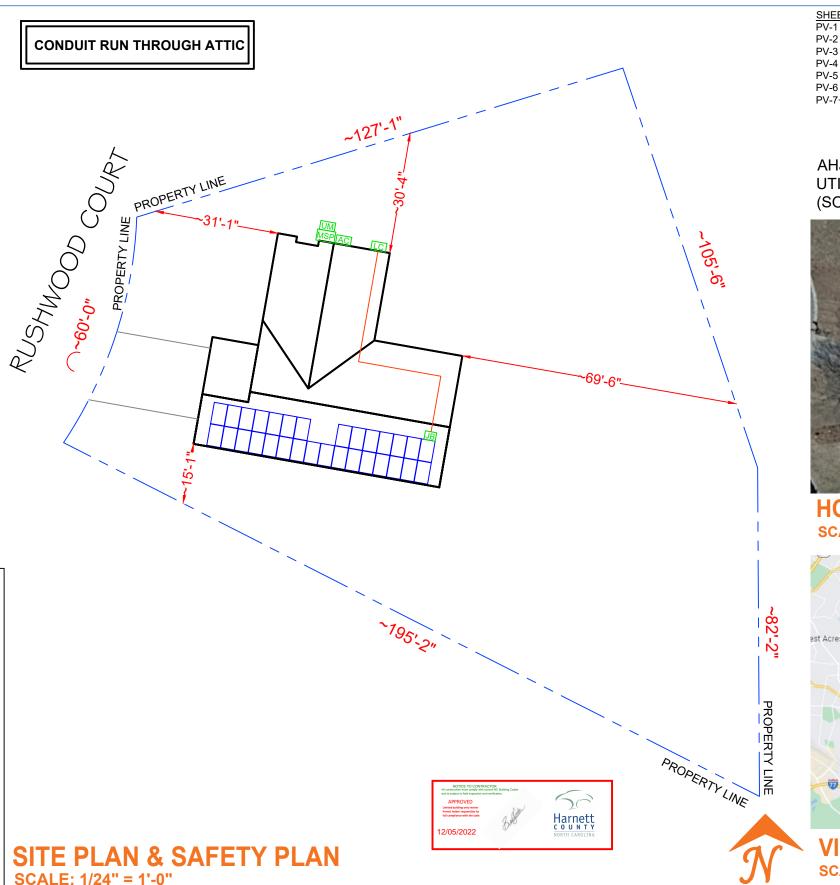



SHEET INDEX
COVER PAGE

PV-2 **ROOF PLAN WITH MODULES** PV-3 ATTACHMENT DETAIL

SINGLE LINE DIAGRAM PV-5 WIRING CALCULATION


PV-6 **PLACARDS**

PV-7+ **EQUIPMENT SPECIFICATION**

AHJ: RICHLAND COUNTY **UTILITY: DOMINION ENERGY** (SOUTH CAROLINA)



HOUSE PHOTO SCALE: NTS

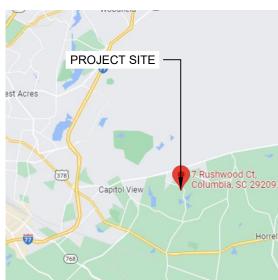

VICINITY MAP **SCALE: NTS**



CONTRACTOR

NAME: TOP TIER SOLAR SOLUTIONS ADDRESS: 1530 CENTER PARK DR, CHARLOTTE, NC 28217, USA PHONE: 855-997-1213

LICENSE #: SC - CLG.123883 ELEC. LICENSE #: NC - 87345

EMAIL #: bdunford@toptiersolarsolutions

REVISIONS				
DESCRIPTION	DATE	REV		

SIGNATURE & SEAL



HOMEOWNER INFO

7 RUSHWOOD COURT, COLUMBIA, SC 29209, USA JOHN WHITE

APN: 22002032 FMAII · . PHONE:

SHEET NAME

COVER PAGE

SHEET SIZE **ANSIB** 11" X 17"

SHEET NUMBER

MODULE AREA & WEIGHT CALCULATIONS

PANEL TYPES (COUNT, AREA, WEIGHT):

- (30x) MISSION SOLAR ENERGY MSE385SX5R 385W (75.1" x 41.1", 49 LBS)

MICRO-INVERTER TYPES (COUNT, WEIGHT): - (30x) ENPHASE IQ8PLUS-72-2-US (240V) (2.38 LBS)

MOUNTING SYSTEM WEIGHT/MODULE: 1.5 LBS TOTAL ROOF AREA: 2628 SF

TOTAL ARRAY AREA: (30) 75.1" x 41.1" = 643.04 SF TOTAL ARRAY WEIGHT: (30) 49.0 + (30) 2.4 + (30) 1.5 = 1586 LBS


WEIGHT AT EACH CONNECTION: 1586 LBS / 58 = 27.34 LBS DISTRIBUTED LOAD: 1586 LBS / 643.04 SF = 2.47 PSF ROOF AREA COVERED BY ARRAY: 643 SF / 2628 SF = 24.46%

	BIL	L OF MATERIALS
SOLAR PV MODULES	30	MISSION SOLAR ENERGY MSE385SX5R 385W
MICRO INVERTERS	30	ENPHASE IQ8PLUS-72-2-US (240V)
LOAD CENTER	01	ENPHASE IQ COMBINER PANEL 4/4C
JUNCTION BOX	01	JUNCTION BOX 600V, NEMA 3R UL LISTED
AC DISCONNECT	01	PV VISIBLE LOCKABLE LABELED DISCONNECT (60A UNFUSED 1PH 240VAC)
ATTACHMENTS	58	IRONRIDGE - SLOTTED L-FEET
RAIL	16	IRONRIDGE RESOURCES - XR10
RAIL SPLICE	10	RAIL SPLICE
MID CLAMP	54	MID CLAMP
END CLAMP	12	END CLAMP
GROUNDING LUG	3	GROUNDING LUG

ROOF DESCRIPTION TABLE					
ROOF PLANE	TRUSS SIZE	TRUSS SPACING (ATTACHMENT SPACING)	MODULE COUNT	ARRAY TILT	AZIMUTH
#1	2" x 4"	24" O.C. (48" O.C.)	30	30°	190°

DESIGN CRITERIA

EXPOSURE CATEGORY = B WIND SPEED = 117 MPH

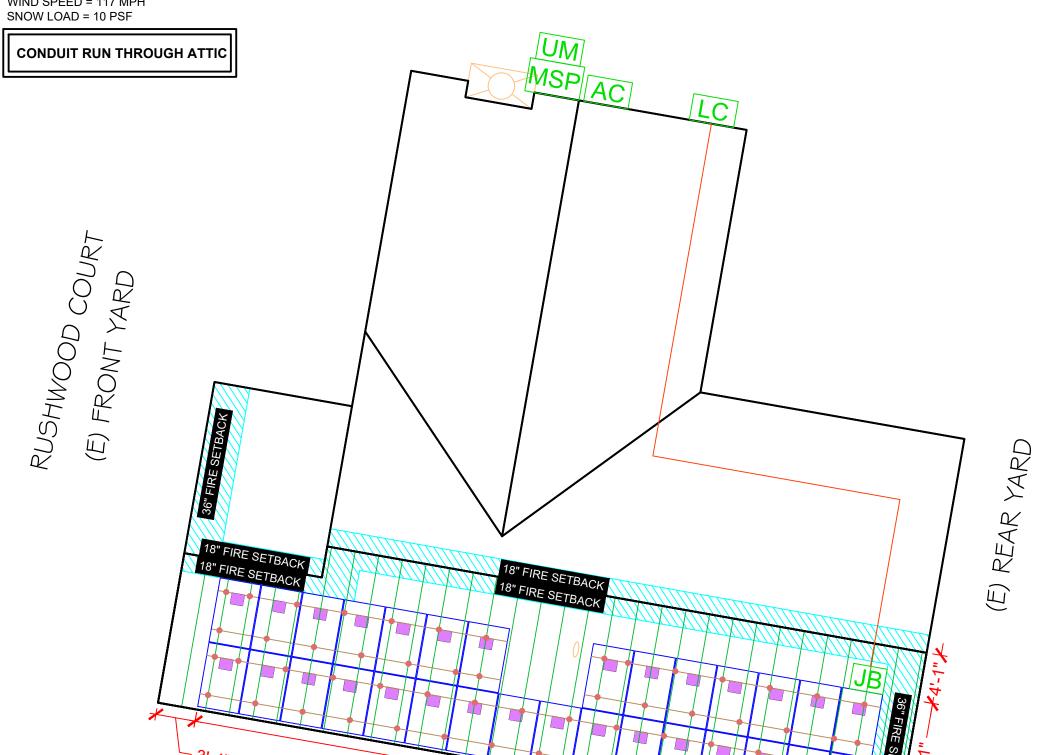

ROOF #1 PITCH 30° AZIMUTH 190°

ROOF PLAN WITH MODULES



NAME: TOP TIER SOLAR SOLUTIONS ADDRESS: 1530 CENTER PARK DR, CHARLOTTE, NC 28217, USA PHONE: 855-997-1213

LICENSE #: SC - CLG.123883 ELEC. LICENSE #: NC - 87345 EMAIL #: bdunford@toptiersolar:

REVISIONS			
DESCRIPTION	DATE	REV	

SIGNATURE & SEAL



HOMEOWNER INFO

7 RUSHWOOD COURT, COLUMBIA, SC 29209, USA JOHN WHITE

APN: 220020321 EMAIL: -

PHONE: -

SHEET NAME

ROOF PLAN WITH MODULES

> SHEET SIZE **ANSI B** 11" X 17"

SHEET NUMBER PV-2

3'-0"



ROOF ATTACHMENT

MSP MAIN SERVICE PANEL (EXISTING, 200A) UTILITY METER

PV MODULE

OPTIMIZER

MICRO-INVERTER

UTILLET INIL. (EXISTING) PM PRODUCTION METER (N/A)

BAT BATTERY (N/A)

INV (0) INVERTER (N/A) LOAD CENTER (COMBINER PANEL) (NEW)

SM SOLAREDGE METER (N/A)

BLP BACKUP LOAD PANEL (N/A)

DCC DC COMBINER (N/A)

EE EXISTING EQUIPMENT

- DIMENSIONS

RAIL

TRUSS

CONDUIT

ACF AC DISCONNECT FUSED (N/A)

AT AUTO TRANSFORMER (N/A)

JB JUNCTION BOX (NEW)


DCD DC DISCONNECT (N/A)

SUBPANEL (N/A)

AC DIS (NEW)

AC DISCONNECT UNFUSED


SCALE: 1/8" = 1'-0"

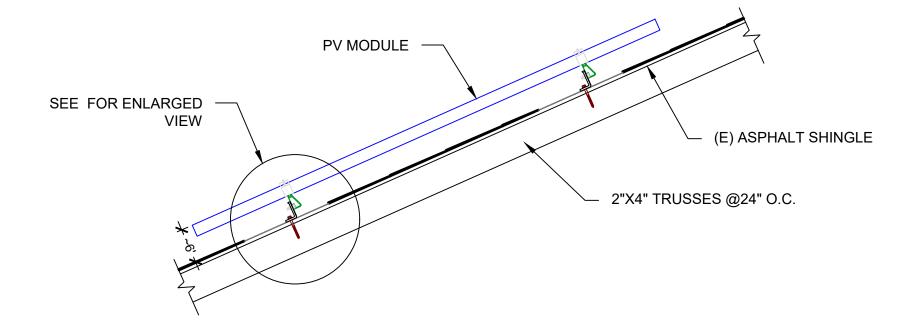

ATTACHMENT DETAIL

SCALE: NTS

SCALE: NTS

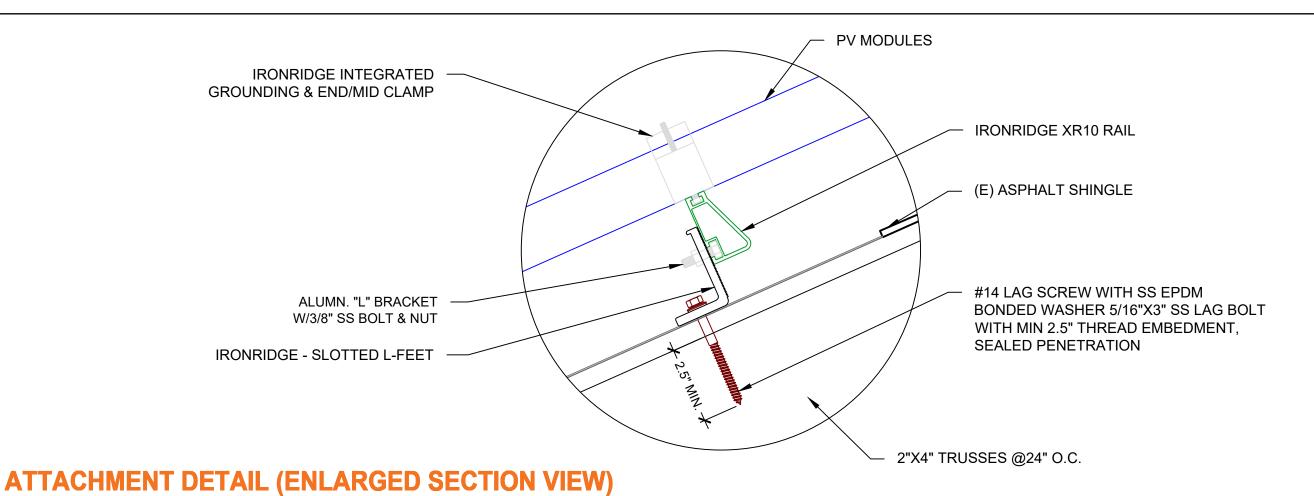

TOP TIER

CONTRACTOR

NAME: TOP TIER SOLAR SOLUTIONS ADDRESS: 1530 CENTER PARK DR, CHARLOTTE, NC 28217, USA PHONE: 855-997-1213

LICENSE #: SC - CLG.123883 ELEC. LICENSE #: NC - 87345 EMAIL #: bdunford@toptiersolarsolutions.

REVISIONS			
DATE	REV		

SIGNATURE & SEAL



HOMEOWNER INFO

JOHN WHITE
7 RUSHWOOD COURT,
COLUMBIA, SC 29209, USA

APN: 220020321 EMAIL: -PHONE: -

SHEET NAME

ATTACHMENT DETAIL

ANSI B 11" X 17"

SHEET NUMBER


SYSTEM SUMMARY STC DC/AC (11.55 kW DC / 8.7 kW AC)

• 3x STRINGS OF 10 CONNECTED IN PARALLEL

- (30) MISSION SOLAR ENERGY MSE385SX5R 385W MODULES - (30) ENPHASE IQ8PLUS-72-2-US (240V) MICROINVERTERS

STC DC: (30) 385 = 11.55 kW STC AC: (30) 290 = 8.7 kW

> MOD: MISSION SOLAR ENERGY MSE385SX5R 385W INV: ENPHASE IQ8PLUS-72-2-US (240V) (1 STRING X 10 MICRO-INV)

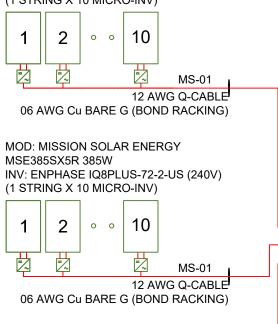

MOD: MISSION SOLAR ENERGY

(1 STRING X 10 MICRO-INV)

INV: ENPHASE IQ8PLUS-72-2-US (240V)

10

06 AWG Cu BARE G (BOND RACKING)

MS-01 12 AWG Q-CABLE

MSE385SX5R 385W

2

CONDUIT RUN THROUGH ATTIC


DERATE MAIN BREAKER 200A TO 175A FOR PV BACKFEED

NOT

- ALL GROUNDING TO COMPLY WITH NEC 690.47.
- ROOF TOP CONDUIT SHALL BE LOCATED MIN. 7/8" ABOVE ROOF SURFACE.
- ALL TERMINALS SHALL BE MIN. 75 DEG. C RATED.

NOTE

HOLD ON KITS FOR PV BREAKERS IS MANDATORY FOR IQ COMBINER 4 / 4C.

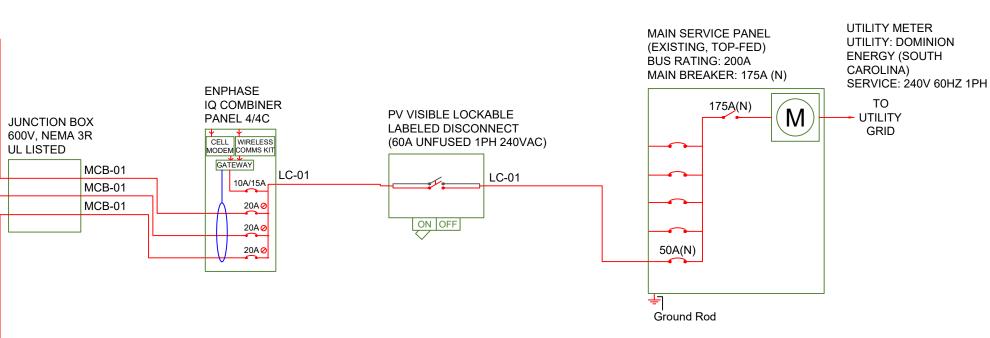

	AC wire details						
Wire	Min Ampacity	Live	Neutral	Ground	Min EMT	Min PVC	Min RMC
MS-01	15.13A	12 AWG (Q-Cable)	-	06 AWG BARE (NOT IN CONDUIT)	-	-	-
MCB-01	15.13A	(2) 10 AWG THWN-2	-	10 AWG THWN-2	0.50 in	0.50 in	0.50 in
LC-01	45.38A	(2) 06 AWG THWN-2	06 AWG THWN-2	10 AWG THWN-2	0.75 in	0.75 in	0.75 in

INTERCONNECTION 120% RULE (MAIN PANEL)

UTILITY FEED + TOTAL BACKFEED 175A + 50A = 225A

> LESS OR EQUAL TO BUS RATING x 120% 200A x 120% = 240A

CALCULATION ENSURES BUS IS SAFE REGARDLESS OF LOADS

EXTREME CASE MODULE OUTPUT (MISSION SOLAR ENERGY MSE385SX5R 385W)

Isc(25°C) = 10.97A, Tisc = 0.039%/°C Isc(T) = Isc(25°C) x [1 + Tisc x (T-25°C)] Isc(-10°C) = 10.82A, Isc(36°C) = 11.02A

Voc(25°C) = 45.03V, Tvoc = -0.262%/°C Voc(T) = Voc(25°C) x [1 + Tvoc x (T-25°C)] Voc(-10°C) = 49.16V, Voc(36°C) = 43.73V



CONTRACTOR

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HOMEOWNER INFO

7 RUSHWOOD COURT, COLUMBIA, SC 29209, USA

JOHN WHITE

APN: 220020321 EMAIL: -PHONE: -

SHEET NAME

SINGLE LINE DIAGRAM

SHEET SIZE ANSI B

11" X 17"
SHEET NUMBER

PV-4

ELECTRICAL SINGLE LINE DIAGRAM

SCALE: NTS

SYSTEM SUMMARY STC DC/AC (11.55 kW DC / 8.7 kW AC)

• 3x STRINGS OF 10 CONNECTED IN PARALLEL

- (30) MISSION SOLAR ENERGY MSE385SX5R 385W MODULES

- (30) ENPHASE IQ8PLUS-72-2-US (240V) MICROINVERTERS STC DC: (30) 385 = 11.55 kW

STC DC: (30) 385 = 11.55 kV STC AC: (30) 290 = 8.7 kW

	AC wire details																
WireID	#Modules	Nominal	Backfeed *1.25	Min	Total	Conductor	ccConductors	Expected	Adjusted ampacity (ampacity x temp	Conductor &	EGC size	Conductor	Max	V drop	Min EMT	Min PVC	Min RMC
MILEID	#IVIOGUIES	Voltage	/cond. set	OCPD	Power	sets	/conduit	max temp	derate x conduit fill derate)	neutral size	(Cu)	metal	length	·	size	size	size
MS-01	10	240 V	15.13 A	20 A	2.9 kW	1	2	36	25 x 0.88 x - = 22.00 A	12 AWG (Q-Cable)	06 AWG BARE (NOT IN CONDUIT)	Cu	50 ft	0.88 %	-	-	-
MCB-01	10	240 V	15.13 A	20 A	2.9 kW	1	2	36	35 x 0.88 x 1.00 = 30.80 A	10 AWG THWN-2	10 AWG THWN-2	Cu	50 ft	0.53 %	0.50 in	0.50 in	0.50 in
LC-01	30	240 V	45.38 A	50 A	8.7 kW	1	2	36	65 x 0.88 x 1.00 = 57.20 A	06 AWG THWN-2	10 AWG THWN-2	Cu	10 ft	0.13 %	0.75 in	0.75 in	0.75 in

INTERCONNECTION 120% RULE (MAIN PANEL)

UTILITY FEED + TOTAL BACKFEED 175A + 50A = 225A

> LESS OR EQUAL TO BUS RATING x 120% 200A x 120% = 240A

CALCULATION ENSURES BUS IS SAFE REGARDLESS OF LOADS

EXTREME CASE MODULE OUTPUT (MISSION SOLAR ENERGY MSE385SX5R 385W)

lsc(25°C) = 10.97A, Tisc = 0.039%/°C lsc(T) = lsc(25°C) x [1 + Tisc x (T-25°C)] lsc(-10°C) = 10.82A, lsc(36°C) = 11.02A

 $Voc(25^{\circ}C) = 45.03V$, $Tvoc = -0.262\%/^{\circ}C$ $Voc(T) = Voc(25^{\circ}C) \times [1 + Tvoc \times (T-25^{\circ}C)]$ $Voc(-10^{\circ}C) = 49.16V$, $Voc(36^{\circ}C) = 43.73V$

ELECTRICAL NOTES

- 1) ALL EQUIPMENT TO BE LISTED BY UL OR OTHER NRTL, AND LABELED FOR ITS APPLICATION.
- 2) ALL CONDUCTORS SHALL BE COPPER, RATED FOR 600 V AND 90 DEGREE C WET ENVIRONMENT.
- 3) WIRING, CONDUIT, AND RACEWAYS MOUNTED ON ROOFTOPS SHALL BE ROUTED DIRECTLY TO, AND LOCATED AS CLOSE AS POSSIBLE TO THE NEAREST RIDGE, HIP, OR VALLEY.
- 4) WORKING CLEARANCES AROUND ALL NEW AND EXISTING ELECTRICAL EQUIPMENT SHALL COMPLY WITH NEC 110.26.
- 5) DRAWINGS INDICATE THE GENERAL ARRANGEMENT OF SYSTEMS. CONTRACTOR SHALL FURNISH ALL NECESSARY OUTLETS, SUPPORTS, FITTINGS AND ACCESSORIES TO FULFILL APPLICABLE CODES AND STANDARDS.
- 6) WHERE SIZES OF JUNCTION BOXES, RACEWAYS, AND CONDUITS ARE NOT SPECIFIED, THE CONTRACTOR SHALL SIZE THEM ACCORDINGLY.
- 7) ALL WIRE TERMINATIONS SHALL BE APPROPRIATELY LABELED AND READILY VISIBLE.
- 8) MODULE GROUNDING CLIPS TO BE INSTALLED BETWEEN MODULE FRAME AND MODULE SUPPORT RAIL, PER THE GROUNDING CLIP MANUFACTURER'S INSTRUCTION.
- 9) MODULE SUPPORT RAIL TO BE BONDED TO CONTINUOUS COPPER G.E.C.VIA WEEB LUG OR ILSCO GBL-4DBT LAY-IN LUG.
- 10) PV EQUIPMENT SHALL BE DESIGNED AND INSTALLED IN ACCORDANCE WITH NEC 690.
- 11) EXACT LOCATION OF AUXILIARY GROUNDING TO BE DETERMINED AT TIME OF INSTALL.
- 12) EXISTING WIRES MUST BE REPLACED IF SMALLER THAN LISTED MINIMUM SIZES PER NEC 310.15(B)(16).
- 13) AC DISCONNECT LOCATED WITHIN 10' OR LESS FROM UTILITY METER
- 14) IF ENVOY PRESENT, ENVOY BREAKER DETERMINED AT FACTORY BY MANUFACTURER.
- 15) IF ENVOY PRESENT, FOR IQ COMBINER USE SINGLE CT ON L1. AT SYSTEM CONTROLLER MAIN USE DOUBLE CT ON L1 AND L2.



CONTRACTOR

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LICENSE #: SC - CLG.123883 ELEC. LICENSE #: NC - 87345 EMAIL #: bdunford@toptiersolarsolutions.cc

REVISIONS				
DESCRIPTION	DATE	REV		

SIGNATURE & SEAL

HOMEOWNER INFO

JOHN WHITE
7 RUSHWOOD COURT,
COLUMBIA, SC 29209, USA

APN: 22002032

PHONE:

SHEET NAME

WIRING CALCULATION

ANSI B

SHEET NUMBER



WARNING

ELECTRICAL SHOCK HAZARD

TERMINALS ON BOTH LINE AND LOAD SIDES MAY BE ENERGIZED IN THE OPEN POSITION

LABEL LOCATION: INVERTERS, AC DISCONNECTS, AC COMBINER BOXES, AC JUNCTION BOXES CODE REF: NEC 2017 - 690.13(B)



∕∖\WARNING ∕\

LECTRICAL SHOCK HAZAR

GROUND FAULT IS INDICATED ALL NORMALLY GROUNDED CONDUCTORS MAY BE NGROUNDED AND ENERGIZE

LABEL LOCATION: AC DISCONNECTS, AC COMBINER BOXES, SERVICE PANELS CODE REF: NEC 2017 - 690.5(C)



PV SYSTEM DISCONNECT

MAXIMUM AC OPERATING CURRENT: 36.30 AMPS NOMINAL OPERATING AC VOLTAGE: 240.0 VAC

LABEL LOCATION: INTERCONNECTION Placard (MSP BACKFEED BREAKER OR TAP BOX IF LINE SIDE TAP), AC DISCONNECTS CODE REF: NEC 2017 - 690.54



PHOTOVOLTAIC SYSTEM JTILITY DISCONNECT SWITCH

LABEL LOCATION: AC DISCONNECTS FOR UTILITY **ACCESS** CODE REF: UTILITY



PHOTOVOLTAIC SYSTEM METER

LABEL LOCATION: PV PRODUCTION METER CODE REF: NEC 2017 - 690.4(B)



/\WARNING

PHOTOVOLTAIC SYSTEM **COMBINER PANEL**

DO NOT ADD LOADS

LABEL LOCATION: AC COMBINER BOX CODE REF: NEC 2017 - 690.12(B)



∕ WARNING

IVERTER OUTPUT CONNECTION DO NOT RELOCATE THIS **OVERCURRENT DEVICE**

LABEL LOCATION: FIRST BACKEEED BREAKER (MSP/SUBPANEL) IF NO LINE SIDE TAP CODE REF: NEC 2017 - 705.12(B)(2)(3)(b), NEC 2017 -705.12(B)(3), CEC 2019 - 705.12(B)(2)(3)(b), CEC 2019 -



CAUTION

PHOTOVOLTAIC SYSTEM **CIRCUIT IS BACKFED**

LABEL LOCATION: INTERCONNECTION Placard (MSP BACKFEED BREAKER OR TAP BOX IF LINE SIDE TAP) CODE REF: NEC 2017 - 705.2(4)



V SOLAR BREAKER

DO NOT RELOCATE THIS **OVERCURRENT DEVICE**

LABEL LOCATION: FIRST BACKFEED BREAKER (MSP/SUBPANEL) IF NO LINE SIDE TAP CODE REF: NEC 2017 - 705.12(B)(2)(3)(b)



RAPID SHUTDOWN SWITCH FOR SOLAR PV SYSTEM

LABEL LOCATION: MSP CODE REF: NEC 2017 - 690.56(C)(3)



CAUTION

DUAL POWER SOURCE SECOND SOURCE IS PHOTOVOLTIC

LABEL LOCATION: MSP, UTILITY METER (IF SEPARATE) CODE REF: UTILITY


IAIN BREAKER HAS BEEN DOWNSIZED O 175A DO NOT UPSIZE MAIN BREAKER

> SIGNAGE LOCATIONS: **NEXT TO MAIN BREAKER**



SOLAR PV SYSTEM EQUIPPED WITH RAPID SHUTDOWN

TURN RAPID SHUTDOWN **SWITCH TO THE** "OFF" POSITION TO SHUT DOWN PV SYSTEM AND REDUCE SHOCK HAZARD IN THE ARRAY.

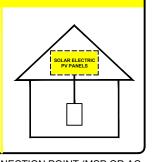


LABEL LOCATION: INTERCONNECTION POINT (MSP OR AC

DISCONNECT IF LINE SIDE TAP) CODE REF: NEC 2017 - 690.12, NEC 2017 - 690.56(C)

NOTES AND SPECIFICATIONS

- 1) SIGNS AND LABELS SHALL MEET THE REQUIREMENTS OF NEC 110.21(B), UNLESS SPECIFIC INSTRUCTIONS ARE REQUIRED BY SECTION 690, OR IF REQUESTED BY THE LOCAL AHJ.
- SIGNS AND LABELS SHALL ADEQUATELY WARN OF HAZARDS USING EFFECTIVE WORDS, COLORS AND SYMBOLS.
- LABELS SHALL BE PERMANENTLY AFFIXED TO THE EQUIPMENT OR WIRING METHOD AND SHALL NOT BE HAND WRITTEN.
- LABEL SHALL BE OF SUFFICIENT DURABILITY TO WITHSTAND THE ENVIRONMENT INVOLVED.
- SIGNS AND LABELS SHALL COMPLY WITH ANSI Z535.4 - 2011, PRODUCT SAFETY SIGNS AND LABELS, UNLESS OTHERWISE SPECIFIED.
- 6) DO NOT COVER EXISTING MANUFACTURER LABELS.

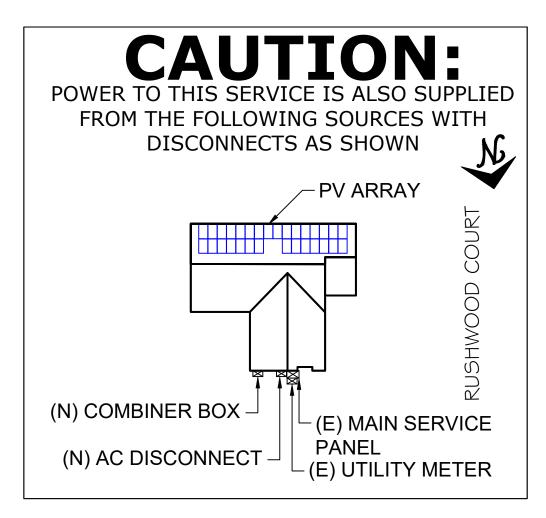

LABEL LOCATION: MSP CODE REF: NEC 2017 - 705.10



CONTRACTOR

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REVISIONS				
DESCRIPTION	DATE	REV		

SIGNATURE & SEAL

HOMEOWNER INFO

29209, USA JOHN WHITE RUSHWOOD SC COLUMBIA,

APN: 220020321 FMAII · . PHONE:

SHEET NAME

PLACARDS

SHEET SIZE **ANSIB** 11" X 17"

SHEET NUMBER PV-6

MSE PERC 66





Class leading power output



FRAME-TO-FRAME WARRANTY

Degradation guaranteed not to exceed 2% in year one and 0.58% annually from years two to 30 with 84.08% capacity guaranteed in year 25. For more information, visit www.missionsolar.com/warranty

CERTIFICATIONS





UL 61730 / IEC 61215 / IEC 61730 / IEC 61701

If you have questions or concerns about certification of our products in your area, please contact Mission Solar Energy.

True American Quality True American Brand

Mission Solar Energy is headquartered in San Antonio, Texas where we manufacture our modules. We produce American, high-quality solar modules ensuring the highest-in-class power output and best-in-class reliability. Our product line is tailored for residential, commercial and utility applications. Every Mission Solar Energy solar module is certified and surpasses industry standard regulations, proving excellent performance over the long term.

Demand the best. Demand Mission Solar Energy.



Certified Reliability

- Tested to UL 61730 & IEC Standards
- Resistance to salt mist corrosion



Advanced Technology

- 6 Busbar
- Passivated Emitter Rear Contact
- Ideal for all applications



Extreme Weather Resilience

- Up to 5,400 Pa front load & 3,600 Pa back load
- Tested load to UL 61730

BAA Compliant for Government Projects

- Buy American Act
- American Recovery & Reinvestment Act






Class Leading 375-385W

[UNITS: MM/IN] FRONT VIEW SIDE VIEW REAR VIEW

BASIC DIMENSIONS

CURRENT-VOLTAGE CURVE	
MSE385SX5R: 385WP, 66 CELL SOLAR MODULE	

Current-voltage characteristics with dependence on irradiance and module temperature

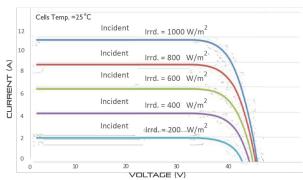

CERTIFICATIO	NS AND TESTS
IEC	61215, 61730, 61701
UL	61730







Mission Solar Energy

8303 S. New Braunfels Ave., San Antonio, Texas 78235 www.missionsolar.com | info@missionsolar.com

Mission Solar Energy reserves the right to make specification changes without notice. C-SA2-MKTG-0027 REV 2 05/05/2021

MSE PERC 66

ELECTR	ICAL	. SF	PECIFIC	ATION	
PRODUCT TYPE	MSE	xxxSX	5R (xxx = P	max)	
Power Output	P _{max}	W_p	375	380	385
Module Efficiency		%	18.8	19.1	19.3
Tolerance		%	0/+3	0/+3	0/+3
Short Circuit Current	Isc	V	10.85	10.91	10.97
Open Circuit Voltage	Voc	Α	44.64	44.84	45.03
Rated Current	Imp	V	10.26	10.34	10.42
Rated Voltage	V _{mp}	V	36.56	36.75	36.93
Fuse Rating		Α	20	20	20
System Voltage		V	1,000	1,000	1,000

TEMPERATURE COEFF	ICIENTS
Normal Operating Cell Temperature (NOCT)	44.43°C (±3.7%)
Temperature Coefficient of Pmax	-0.361%/°C
Temperature Coefficient of Voc	-0.262%/°C
Temperature Coefficient of Isc	0.039%/°C

OPERATINO	CONDITIONS
Maximum System Voltage	1,000Vdc
Operating Temperature Range	-40°C (-40°F) to +85°C (185°F)
Maximum Series Fuse Rating	20A
Fire Safety Classification	Type 1
Front & Back Load (UL Standard)	Up to 5,400 Pa front and 3,600 Pa back load, Tested to UL 61730
Hail Safety Impact Velocity	25mm at 23 m/s

MECHANICAL DATA		
Solar Cells	P-type mono-crystalline silicon	
Cell Orientation	66 cells (6x11)	
Module Dimension	1,907mm x 1,044mm x 40mm	
Weight	22 kg (49 lbs.)	
Front Glass	3.2mm, tempered, low-iron, anti-reflective	
Frame	Anodized	
Encapsulant	Ethylene vinyl acetate (EVA)	
Junction Box	Protection class IP67 with 3 bypass-diodes	
Cable	1.0m, Wire 4mm2 (12AWG)	
Connector	Staubli PV-KBT4/6II-UR and PV-KST4/6II-UR, MC4, Renhe 05-8	

Container Feet	Ship To	Pallet	Panels	380 W Bin
53'	Most States	30	780	296.40 kW
Double Stack	CA	26	676	256.88 kW
PALLET [26 PANELS]				
Weight 1,274 lbs. (572 kg)	Height 47.56 in (120.80 cm)) (1:	Width 46 in 16.84 cm)	Length 77 in (195.58 cm)

www.missionsolar.com | info@missionsolar.com

TOP TIER

CONTRACTOR

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REVIS	REVISIONS		
DESCRIPTION	DATE	REV	

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JOHN WHITE

SHEET NAME

EQUIPMENT SPECIFICATION

> SHEET SIZE **ANSIB** 11" X 17"

SHEET NUMBER PV-7

C-SA2-MKTG-0027 REV 2 05/05/2021

www.missionsolar.com | info@missionsolar.com







IQ8 and IQ8+ Microinverters

Our newest IQ8 Microinverters are the industry's first microgrid-forming, software-defined microinverters with split-phase power conversion capability to convert DC power to AC power efficiently. The brain of the semiconductor-based microinverter is our proprietary application-specific integrated circuit (ASIC) which enables the microinverter to operate in grid-tied or off-grid modes. This chip is built in advanced 55nm technology with high speed digital logic and has super-fast response times to changing loads and grid events, alleviating constraints on battery sizing for home energy systems.



Part of the Enphase Energy System, IQ8 Series Microinverters integrate with the Enphase IQ Battery, Enphase IQ Gateway, and the Enphase App monitoring and analysis software.



Connect PV modules quickly and easily to IQ8 Series Microinverters using the included Q-DCC-2 adapter cable with plug-n-play MC4 connectors.

CERTIFIED SAFETY

Vand easily to 108 Series Microiny

IQ8 Series Microinverters are UL Listed as PV Rapid Shut Down Equipment and conform with various regulations, when installed according to manufacturer's instructions.

IQ8 Series Microinverters redefine reliability

standards with more than one million

cumulative hours of power-on testing, enabling an industry-leading limited warranty

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IQ8SP-DS-0002-01-EN-US-2021-10-19

Easy to install

- Lightweight and compact with plug-n-play connectors
- Power Line Communication (PLC) between components
- Faster installation with simple two-wire cabling

High productivity and reliability

- Produce power even when the grid is down
- More than one million cumulative hours of testing
- Class II double-insulated enclosure
- Optimized for the latest highpowered PV modules

Microgrid-forming

- Complies with the latest advanced grid support
- Remote automatic updates for the latest grid requirements
- Configurable to support a wide range of grid profiles
- Meets CA Rule 21 (UL 1741-SA) requirements

IQ8 and IQ8+ Microinverters

INPUT DATA (DC)		108-60-2-US	IQ8PLUS-72-2-US	
Commonly used module pairings ¹	W	235 - 350	235 - 440	
Module compatibility		60-cell/120 half-cell	60-cell/120 half-cell and 72-cell/144 half-cell	
MPPT voltage range	٧	27 - 37	29 - 45	
Operating range	٧	25 - 48	25 - 58	
Min/max start voltage	٧	30 / 48	30 / 58	
Max input DC voltage	٧	50	60	
Max DC current ² [module lsc]	А	1	5	
Overvoltage class DC port		I I	I	
DC port backfeed current	mA			
PV array configuration		1x1 Ungrounded array; No additional DC side protection requ	ired; AC side protection requires max 20A per branch circuit	
OUTPUT DATA (AC)		108-60-2-US	108PLUS-72-2-US	
Peak output power	VA	245	300	
Max continuous output power	VA	240	290	
Nominal (L-L) voltage/range ³	٧	240 / 2	11 – 264	
Max continuous output current	А	1.0	1.21	
Nominal frequency	Hz	6	0	
Extended frequency range	Hz	50	- 68	
Max units per 20 A (L-L) branch circ	uit ⁴	16	13	
Total harmonic distortion		<5%		
Overvoltage class AC port		1	II	
AC port backfeed current	mA	30		
Power factor setting		1.0		
Grid-tied power factor (adjustable)		0.85 leading	- 0.85 lagging	
Peak efficiency	%	97.5	97.6	
CEC weighted efficiency	%	97	97	
Night-time power consumption	mW	6	0	
MECHANICAL DATA				
Ambient temperature range		-40°C to +60°C	(-40°F to +140°F)	
Relative humidity range		4% to 100%	(condensing)	
DC Connector type		Mo	04	
Dimensions (HxWxD)		212 mm (8.3") x 175 mm	ı (6.9") x 30.2 mm (1.2")	
Weight		1.08 kg (2.38 lbs)	
Cooling		Natural conve	ction – no fans	
Approved for wet locations		Ye	es	
Acoustic noise at 1 m		<60	dBA	
Pollution degree		PI	03	
Enclosure		Class II double-insulated, corrosi	ion resistant polymeric enclosure	
Environ. category / UV exposure rat	ing	NEMA Type	6 / outdoor	
COMPLIANCE				
Certifications		CA Rule 21 (UL 1741-SA), UL 62109-1, UL1741/IEEE1547, FCC Part This product is UL Listed as PV Rapid Shut Down Equipment and		
		690.12 and C22.1-2018 Rule 64-218 Rapid Shutdown of PV Systemanufacturer's instructions.		

(1) No enforced DC/AC ratio. See the compatibility calculator at https://link.enphase.com/module-compatibility (2) Maximum continuous input DC current is 10.6A (3) Nominal voltage range can be extended beyond nominal if required by the utility. (4) Limits may vary. Refer to local requirements to define the number of microinverters per branch in your area.

IQ8SP-DS-0002-01-EN-US-2021-10-19



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EQUIPMENT SPECIFICATION

ANSI B

SHEET NUMBER

Data Sheet Enphase Networking

Enphase IQ Combiner 4/4C

X-IQ-AM1-240-4 X-IQ-AM1-240-4C



To learn more about Enphase offerings, visit enphase.com

The Enphase IQ Combiner 4/4C with Enphase IQ Gateway and integrated LTE-M1 cell modem (included only with IQ Combiner 4C) consolidates interconnection equipment into a single enclosure and streamlines IQ microinverters and storage installations by providing a consistent, pre-wired solution for residential applications. It offers up to four 2-pole input circuits and Eaton BR series busbar assembly.

Smart

- · Includes IQ Gateway for communication and control
- Includes Enphase Mobile Connect cellular modem (CELLMODEM-M1-06-SP-05), included only with IQ Combiner 4C
- Includes solar shield to match Enphase IQ Battery aesthetics and deflect heat
- Flexible networking supports Wi-Fi, Ethernet, or cellular
- · Optional AC receptacle available for PLC bridge
- Provides production metering and consumption monitoring

Simple

- Centered mounting brackets support single stud mounting
- · Supports bottom, back and side conduit entry
- Up to four 2-pole branch circuits for 240 VAC plug-in breakers (not included)
- · 80A total PV or storage branch circuits

Reliable

- Durable NRTL-certified NEMA type 3R enclosure
- · Five-year limited warranty
- Two years labor reimbursement program coverage included for both the IQ Combiner SKU's
- UL listed



Enphase IQ Combiner 4/4C

Enphase IQ Combiner 4/4C	
	IO Combiner 4 with Englace IO Cataway printed girauit heard for integrated revenue grade DV production matering (ANC)
IQ Combiner 4 (X-IQ-AM1-240-4)	IQ Combiner 4 with Enphase IQ Gateway printed circuit board for integrated revenue grade PV production metering (ANSI C12.20 +/- 0.5%) and consumption monitoring (+/- 2.5%). Includes a silver solar shield to match the IQ Battery system and IQ System Controller 2 and to deflect heat.
IQ Combiner 4C (X-IQ-AM1-240-4C)	IQ Combiner 4C with Enphase IQ Gateway printed circuit board for integrated revenue grade PV production metering (ANSI C12.20 4/- 0.5%) and consumption monitoring (+/- 2.5%). Includes Enphase Mobile Connect cellular modem (CELLMODEM-M1-06-SP-05), a plug-and-play industrial-grade cell modem for systems up to 60 microinverters. (Available in the US, Canada, Mexico, Puerto Rico, and the US Virgin Islands, where there is adequate cellular service in the installation area.) Includes a silver solar shield to match the IQ Battery and IQ System Controller and to deflect heat.
ACCESSORIES AND REPLACEMENT PARTS	(not included, order separately)
Ensemble Communications Kit COMMS-CELLMODEM-M1-06 CELLMODEM-M1-06-SP-05 CELLMODEM-M1-06-AT-05	 Includes COMMS-KIT-01 and CELLMODEM-M1-06-SP-05 with 5-year Sprint data plan for Ensemble sites 4G based LTE-M1 cellular modem with 5-year Sprint data plan 4G based LTE-M1 cellular modem with 5-year AT&T data plan
Circuit Breakers BRK-10A-2-240V BRK-15A-2-240V BRK-20A-2P-240V BRK-15A-2P-240V-B BRK-20A-2P-240V-B	Supports Eaton BR210, BR215, BR220, BR230, BR240, BR250, and BR260 circuit breakers. Circuit breaker, 2 pole, 10A, Eaton BR210 Circuit breaker, 2 pole, 15A, Eaton BR215 Circuit breaker, 2 pole, 20A, Eaton BR220 Circuit breaker, 2 pole, 15A, Eaton BR215B with hold down kit support Circuit breaker, 2 pole, 20A, Eaton BR220B with hold down kit support
EPLC-01	Power line carrier (communication bridge pair), quantity - one pair
XA-SOLARSHIELD-ES	Replacement solar shield for IQ Combiner 4/4C
XA-PLUG-120-3	Accessory receptacle for Power Line Carrier in IQ Combiner 4/4C (required for EPLC-01)
XA-ENV-PCBA-3	Replacement IQ Gateway printed circuit board (PCB) for Combiner 4/4C
X-IQ-NA-HD-125A	Hold down kit for Eaton circuit breaker with screws.
ELECTRICAL SPECIFICATIONS	
Rating	Continuous duty
System voltage	120/240 VAC, 60 Hz
Eaton BR series busbar rating	125 A
Max. continuous current rating	65 A
Max. continuous current rating (input from PV/storage)	64 A
Max. fuse/circuit rating (output)	90 A
Branch circuits (solar and/or storage)	Up to four 2-pole Eaton BR series Distributed Generation (DG) breakers only (not included)
Max. total branch circuit breaker rating (input)	80A of distributed generation / 95A with IQ Gateway breaker included
Envoy breaker	10A or 15A rating GE/Siemens/Eaton included
Production metering CT	200 A solid core pre-installed and wired to IQ Gateway
Consumption monitoring CT (CT-200-SPLIT)	A pair of 200 A split core current transformers
MECHANICAL DATA	
Dimensions (WxHxD)	37.5 x 49.5 x 16.8 cm (14.75" x 19.5" x 6.63"). Height is 21.06" (53.5 cm) with mounting brackets.
Weight	7.5 kg (16.5 lbs)
Ambient temperature range	-40° C to +46° C (-40° to 115° F)
Cooling	Natural convection, plus heat shield
Enclosure environmental rating	Outdoor, NRTL-certified, NEMA type 3R, polycarbonate construction
Wire sizes	 20 A to 50 A breaker inputs: 14 to 4 AWG copper conductors 60 A breaker branch input: 4 to 1/0 AWG copper conductors Main lug combined output: 10 to 2/0 AWG copper conductors Neutral and ground: 14 to 1/0 copper conductors Always follow local code requirements for conductor sizing.
Altitude	To 2000 meters (6,560 feet)
INTERNET CONNECTION OPTIONS	
Integrated Wi-Fi	802.11b/g/n
Cellular	CELLMODEM-M1-06-SP-05, CELLMODEM-M1-06-AT-05 (4G based LTE-M1 cellular modem). Note that an Enphase Mobile Connect cellular modem is required for all Ensemble installations.
Ethernet	Optional, 802.3, Cat5E (or Cat 6) UTP Ethernet cable (not included)
COMPLIANCE	
Compliance, IQ Combiner	UL 1741, CAN/CSA C22.2 No. 107.1, 47 CFR, Part 15, Class B, ICES 003 Production metering: ANSI C12.20 accuracy class 0.5 (PV production) Consumption metering: accuracy class 2.5
Compliance, IQ Gateway	UL 60601-1/CANCSA 22.2 No. 61010-1

To learn more about Enphase offerings, visit **enphase.com**

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ENPHASE.

JOHN WHITE

SHEET NAME

EQUIPMENT SPECIFICATION

ANSI B

SHEET NUMBER

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Flush Mount System



Built for solar's toughest roofs.

IronRidge builds the strongest mounting system for pitched roofs in solar. Every component has been tested to the limit and proven in extreme environments.

Our rigorous approach has led to unique structural features, such as curved rails and reinforced flashings, and is also why our products are fully certified, code compliant and backed by a 20-year warranty.



Strength Tested

All components evaluated for superior structural performance.



PE Certified

Pre-stamped engineering letters available in most states.




Class A Fire Rating

Certified to maintain the fire resistance rating of the existing roof.



Design Assistant

Online software makes it simple to create, share, and price projects.

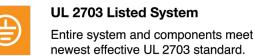

20-Year Warranty

Twice the protection offered by competitors.

XR Rails 🖶

XR10 Rail



A low-profile mounting rail for regions with light snow.

- 6' spanning capability
- · Moderate load capability
- Clear and black finish

XR100 Rail



The ultimate residential solar mounting rail.

- 8' spanning capability
- · Heavy load capability
- · Clear and black finish

XR1000 Rail



A heavyweight mounting rail for commercial projects.

- 12' spanning capability
- Extreme load capability
- · Clear anodized finish

Bonded Splices



All rails use internal splices for seamless connections.

- · Self-drilling screws
- · Varying versions for rails
- · Forms secure bonding

Microinverter Kits

Clamps & Grounding (#)

UFOs



Universal Fastening Objects bond modules to rails.

- · Fully assembled & lubed
- Single, universal size
- · Clear and black finish

Stopper Sleeves



Snap onto the UFO to turn into a bonded end clamp.

- · Bonds modules to rails
- · Sized to match modules
- · Clear and black finish

Grounding Lugs



Connect arrays to equipment ground.

- · Low profile
- · Single tool installation
- · Mounts in any direction



Mount MIs or POs to XR Rails.

- · Bonds devices to rails
- · Kit comes assembled
- Listed to UL 2703

Attachments

FlashFoot2



Flash and mount XR Rails with superior waterproofing

- Twist-on Cap eases instal
- Wind-driven rain tested
- · Mill and black finish

Resources

Slotted L-Feet



Drop-in design for rapid rail attachment.

Design Assistant

Go from rough layout to fully

engineered system. For free.

Go to IronRidge.com/design

- Secure rail connections
- Slot for vertical adjusting
- Clear and black finish

Bonding Hardware



Bond and attach XR Rails to roof attachments.

- · T & Square Bolt options
- · Nut uses 7/16" socket
- · Assembled and lubricated

Flush Standoffs



Raise Flush Mount System to various heights.

- Works with vent flashing
- 4" and 7" lengths
- Ships assembled

NABCEP Certified Training



Earn free continuing education credits, while learning more about our systems. Go to IronRidge.com/training



ANSIB 11" X 17"

SHEET NUMBER

SHEET NAME


EQUIPMENT

SPECIFICATION

SHEET SIZE




Slotted L-Foot

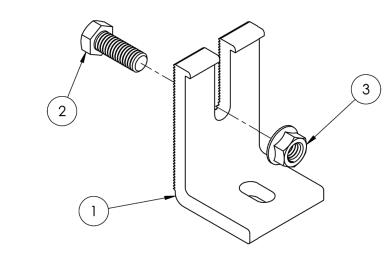


Item Number	Component	Qty in Kit
1	FOOT, EXTRUDED L - SLOTTED	4
2	BOLT, 3/8-16 X 1" HEX CS SS	4
3	NUT, FLANGE HEX 3/8-16 SS	4

Part Number	Description
RS-LFT-001	Kit of 4, Slotted L-Foot (Mill Finish)
RS-LFT-001B	Kit of 4, Slotted L-Foot (Black Finish)




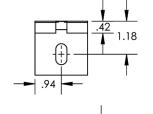

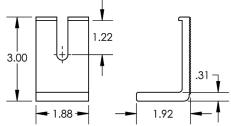


Property	Value
Material	Aluminum
Finish	Mill / Black

2) Bolt, 3/8-16 x 1" Hex CS SS

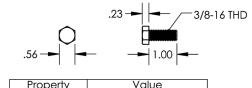

Property	Value
Material	Stainless Steel
Finish	Clear

3) Nut, Flange Hex 3/8-16 SS

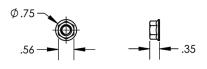

Property	Value
Material	Stainless Steel
Finish	Clear

v1.0

TOP TIER
SOLAR SOLUTIONS

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