PHOTOVOLTAIC ROOF MOUNT SYSTEM

33 MODULES - SYSTEM SIZE STC (11.385 kW DC / 9.57 kW AC) 21 SELBY CT, HOLLY SPRINGS, NC 27540, USA (35.5575358, -78.8925529)

SYSTEM SUMMARY STC DC/AC

(11.385 kW DC / 9.57 kW AC)

2x STRINGS OF 12 CONNECTED IN PARALLEL 1x STRINGS OF 9 CONNECTED IN PARALLEL

- (33) MISSION SOLAR ENERGY MSE345SX5T (345W) MODULES
- (33) ENPHASE IQ8PLUS-72-2-US (240V) MICROINVERTERS
- (1) ENPHASE IQ SYSTEM CONTROLLER 2
- STC DC: (33) 345W = 11 385 kW

STC AC: (33) 290W = 9.57 kW

- **GOVERNING CODES** 2018 NORTH CAROLINA STATE BUILDING CODE
- 2018 NORTH CAROLINA RESIDENTIAL CODE
- 2018 NORTH CAROLINA FIRE CODE
- 2017 NATIONAL ELECTRICAL CODE

GENERAL NOTES

- ALL PANELS, SWITCHES, ETC. SHALL HAVE SUFFICIENT GUTTER SPACE AND LUGS IN COMPLIANCE WITH UL REQUIREMENTS TO ACCOMMODATE CONDUCTORS SHOWN
- 2) THIS SYSTEM WILL NOT BE INTERCONNECTED UNTIL APPROVAL FROM THE LOCAL JURISDICTION AND UTILITY IS OBTAINED.
- ALL EXTERIOR ELECTRICAL DEVICES AND EQUIPMENT INCLUDING THOSE THAT ARE EXPOSED TO OUTSIDE ENVIRONMENT SHALL BE WEATHERPROOF AND SHALL BE LISTED BY 'UL' FOR THE TYPE OF APPLICATION AND 'UL' LABEL SHALL APPEAR ON ALL ELECTRICAL FOUIPMENT
- WIRING METHOD SHALL BE EMT ABOVE GROUND MOUNTED IN CONCEALED SPACES (UNLESS APPROVED OTHERWISE) AND SCHEDULE-40 PVC FOR BELOW GROUND INSTALLATIONS UNLESS NOTED OTHERWISE.
- AN OSHA APPROVED LADDER PROVIDING ACCESS TO ALL PORTIONS OF THE ARRAY SHALL BE SECURED IN PRIOR TO REQUESTING INSPECTION.
- 6) IT IS THE CONTRACTOR'S RESPONSIBILITY TO INSTALL A SUPPLEMENTAL GROUNDING ELECTRODE CONDUCTOR IF NECESSARY.

SAFETY PLAN NOTES

- INSTALLERS SHALL DRAW IN DESIGNATED SAFETY AREA AROUND HOME. - INSTALLERS SHALL UPDATE NAME, ADDRESS AND PHONE NUMBER OF NEAREST URGENT CARE FACILITY RELATIVE TO THE SITE BEFORE

LOCATION OF NEAREST URGENT CARE FACILITY

(FOR INSTALLER USE ONLY)
- NAME:

PV MODULE

OPTIMIZER

MAIN SERVICE PANEL

IQ LOAD CONTROLLER

LOAD CENTER (COMBINER

IQ CONTROLLER 2

(EXISTING, 200A)

(EXISTING)

(NFW)

INV (0) INVERTER (N/A)

LOAD CLIVE.

RSD RAPID SHUTDOWN (NEW)


BLP BACKUP LOAD PANEL

UM

MICRO-INVERTER

ROOF ATTACHMENT

- ADDRESS

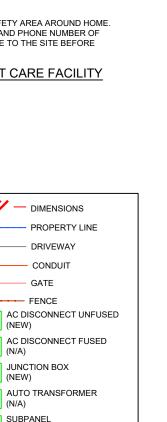

- DIMENSIONS

DRIVEWAY

CONDUIT

GATE

FENCE

JUNCTION BOX

DC DISCONNECT

EE EXISTING EQUIPMENT

SUBPANEL SUBPA (NEW)

DCC DC COMBINER (N/A)

(NEW)

ACF

JB (NEW)

CONDUIT RUN THROUGH ATTIC



Signed 2/21/2023

SELBY **DETACHED** STRUCTURE(TYP.) ~353'-2' PROPERTY LINE (E) POOL



PV-1 COVER PAGE

PV-2 **ROOF PLAN WITH MODULES** PV-3 ATTACHMENT DETAIL

PV-4 SINGLE LINE DIAGRAM PV-5 WIRING CALCULATION

PV-6 **PLACARDS**

PV-7+ **EQUIPMENT SPECIFICATION**

AHJ: HARNETT COUNTY UTILITY: DUKE ENERGY CAROLINAS, LLC



HOUSE PHOTO **SCALE: NTS**







CONTRACTOR

NAME: TOP TIER SOLAR SOLUTIONS ADDRESS: 1530 CENTER PARK DR, CHARLOTTE, NC 28217, USA PHONE: 855-997-1213 CONTRACTOR LICENSE#: 87345 ELECTRICAL LICENSE#: U.35673

REVISIONS							
DESCRIPTION	DATE	REV					

SIGNATURE & SEAL

HOMEOWNER INFO

GRENIER CT, HOLLY 27540, USA 21 SELBY CT SPRINGS, NC 2 $\dot{\mathbf{C}}$ MICHAE

APN: 050635010310 PHONE:

SHEET NAME

COVER PAGE

SHEET SIZE **ANSIB** 11" X 17"

SHEET NUMBER



MODULE AREA & WEIGHT CALCULATIONS

PANEL TYPES (COUNT, AREA, WEIGHT):

- (33x) MISSION SOLAR ENERGY MSE345SX5T (345W) (68.81" x 41.5", 44.8 LBS)

MICRO-INVERTER TYPES (COUNT, WEIGHT): - (33x) ENPHASE IQ8PLUS-72-2-US (240V) (2.38 LBS)

ATTACHMENT COUNT: 108

MOUNTING SYSTEM WEIGHT/MODULE: 1.5 LBS TOTAL ROOF AREA: 1525.21 SF

101AL 1001 ANLA: 1323.2131

TOTAL ARRAY AREA: (33) 68.8" x 41.5" = 654.31 SF TOTAL ARRAY WEIGHT: (33) 44.8 + (33) 2.4 + (33) 1.5 = 1607 LBS

WEIGHT AT EACH CONNECTION: 1607 LBS / 108 = 15.01 LBS DISTRIBUTED LOAD: 1607 LBS / 654.31 SF = 2.45 PSF

ROOF AREA COVERED BY ARRAY: 654.31 SF = 2.45 PSF
800F AREA COVERED BY ARRAY: 654.31 SF / 1525.21 SF = 42.89%

	BIL	L OF MATERIALS
SOLAR PV MODULES	33	MISSION SOLAR ENERGY MSE345SX5T 345W
MICRO INVERTERS	33	ENPHASE IQ8PLUS-72-2-US (240V)
LOAD CENTER	01	ENPHASE IQ COMBINER 4C
JUNCTION BOX	01	JUNCTION BOX 600V, NEMA 3R UL LISTED
ESS	01	IQ SYSTEM CONTROLLER 2
LOAD CONTROLLER	01	IQ LOAD CONTROLLER
SUB PANEL	01	100A, 240V SUB PANEL
		PV VISIBLE LOCKABLE
AC DISCONNECT	01	LABELED DISCONNECT
		(60A UNFUSED 1PH 240VAC)
ATTACHMENTS	108	IRONRIDGE - SLOTTED L-FEET
RAIL	30	IRONRIDGE RESOURCES - XR10
RAIL SPLICE	14	RAIL SPLICE
MID CLAMP	36	MID CLAMP
END CLAMP	60	END CLAMP
GROUNDING LUG	15	GROUNDING LUG

	ROOF DESCRIPTION TABLE								
ROOF PLANE	TRUSS SIZE	TRUSS SPACING (ATTACHMENT SPACING)	MODULE COUNT	ARRAY TILT	AZIMUTH				
#1	2" x 4"	24" O.C. (48" O.C.)	12	30°	175°				
#2	2" x 4"	24" O.C. (48" O.C.)	12	30°	265°				
#3	2" x 4"	24" O.C. (48" O.C.)	7	30°	85°				
#4	2" x 4"	24" O.C. (48" O.C.)	2	30°	175°				

- // - DIMENSIONS

AC (NEW)

TRUSS

RAIL

ACF AC DISCONNECT FUSED (N/A)

EE EXISTING EQUIPMENT

CONDUIT

AC DISCONNECT UNFUSED


DESIGN CRITERIA

EXPOSURE CATEGORY = B WIND SPEED = 116 MPH SNOW LOAD = 15 PSF

CONDUIT RUN THROUGH ATTIC



Signed 2/21/2023

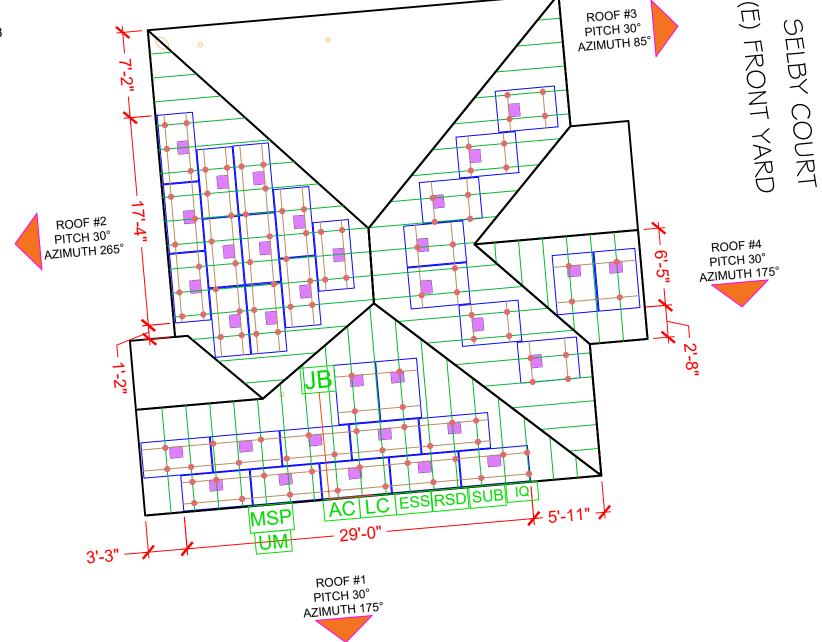



SCALE: 1/8" = 1'-0"



CONTRACTOR

NAME: TOP TIER SOLAR SOLUTIONS ADDRESS: 1530 CENTER PARK DR, CHARLOTTE, NC 28217, USA PHONE: 855-997-1213 CONTRACTOR LICENSE#: 87345 ELECTRICAL LICENSE#: U.35673

REVISIONS								
DESCRIPTION	DATE	REV						

SIGNATURE & SEAL

HOMEOWNER INFO

MICHAEL GRENIER 21 SELBY CT, HOLLY SPRINGS, NC 27540, USA

APN: 050635010310 EMAIL: -PHONE: -

SHEET NAME

ROOF PLAN WITH MODULES

> SHEET SIZE ANSI B 11" X 17"

SHEET NUMBER PV-2



IQ IQ LOAD CONTROLLER (NEW)

ESS IQ CONTROLLER 2 AT AUTO TRANSFORMER (N/A)

INV (0) INVERTER SUB SUBPANEL (NEW)

LC LOAD CENTER (COMBINER PANEL) (NEW)

RSD RAPID SHUTDOWN (NEW)

DCC DC COMBINER (N/A)

PV MODULE

OPTIMIZER

MICRO-INVERTER


ROOF ATTACHMENT

MSP MAIN SERVICE PANEL (EXISTING, 200A)

UM UTILITY METER (EXISTING)

BLP BACKUP LOAD PANEL (N/A)



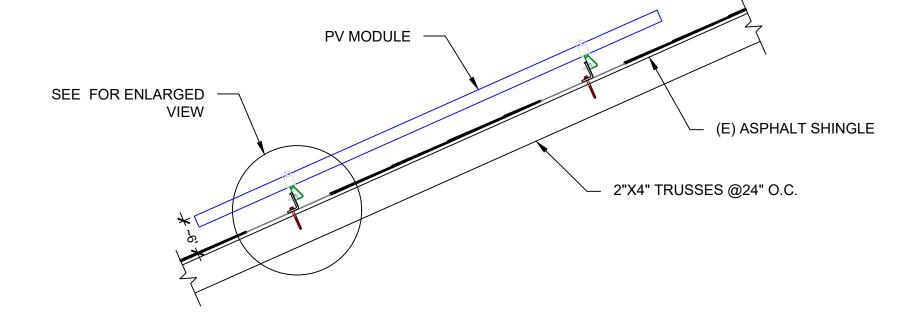



CONTRACTOR


NAME: TOP TIER SOLAR SOLUTIONS ADDRESS: 1530 CENTER PARK DR, CHARLOTTE, NC 28217, USA PHONE: 855-997-1213 CONTRACTOR LICENSE#: 87345 ELECTRICAL LICENSE#: U.35673

REVISIONS									
DESCRIPTION DATE RE									

SIGNATURE & SEAL

ATTACHMENT DETAIL

SCALE: NTS

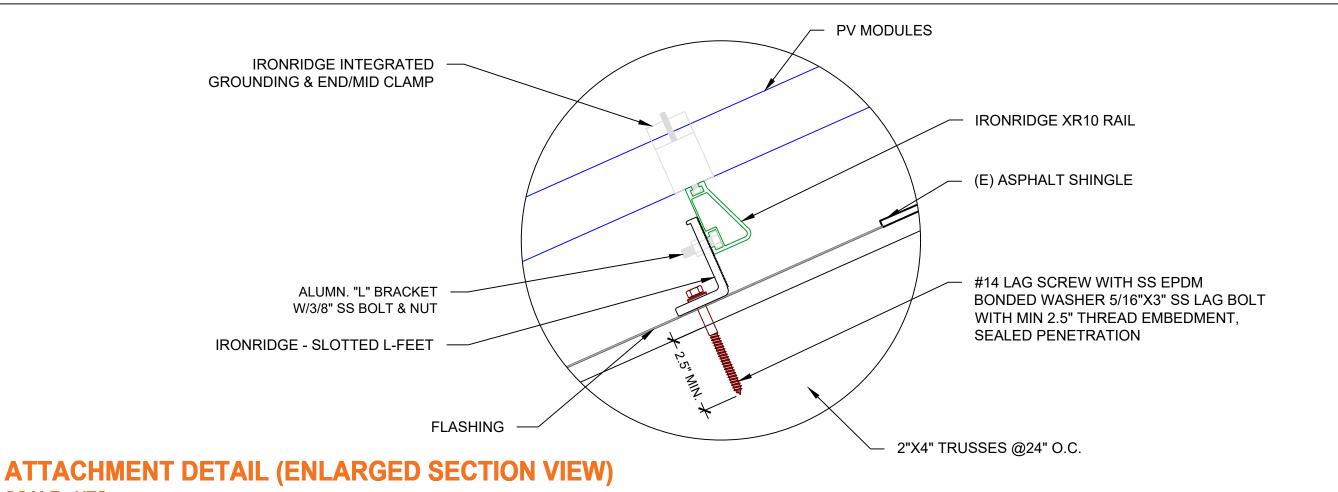

HOMEOWNER INFO

MICHAEL GRENIER 21 SELBY CT, HOLLY SPRINGS, NC 27540, USA

APN: 0506350103 EMAIL: -

PHONE: -

SHEET NAME

ATTACHMENT DETAIL

SHEET SIZE ANSI B 11" X 17"

SHEET NUMBER

PV-3

SCALE: NTS

SYSTEM SUMMARY STC DC/AC (11.385 kW DC / 9.57 kW AC)

2x STRINGS OF 12 CONNECTED IN PARALLEL 1x STRINGS OF 9 CONNECTED IN PARALLEL

- (33) MISSION SOLAR ENERGY MSE345SX5T (345W) MODULES - (33) ENPHASE IQ8PLUS-72-2-US (240V) MICROINVERTERS

ESSENTIAL LOAD 2

ELECTRICAL SINGLE LINE DIAGRAM

SCALE: NTS

(1) ENPHASE IQ SYSTEM CONTROLLER 2

STC DC: (33) 345W = 11.385 kW STC AC: (33) 290W = 9.57 kW

CONDUIT RUN THROUGH ATTIC

QUAD BREAKER TO BE USED TO

- ALL GROUNDING TO COMPLY WITH NEC 690.47.
- ROOF TOP CONDUIT SHALL BE LOCATED MIN. 7/8" ABOVE ROOF SURFACE.
- ALL TERMINALS SHALL BE MIN. 75 DEG. C RATED.

08 AWG THWN-2

1.25 in

EXTREME CASE MODULE OUTPUT

(MISSION SOLAR ENERGY MSE345SX5T 345W)

 $Isc(25^{\circ}C) = 10.92A$, $Tisc = 0.039\%/^{\circ}C$

 $Isc(T) = Isc(25^{\circ}C) \times [1 + Tisc \times (T-25^{\circ}C)]$ $Isc(-11^{\circ}C) = 10.77A$, $Isc(34^{\circ}C) = 10.96A$

 $Voc(25^{\circ}C) = 41.00V$, $Tvoc = -0.262\%/^{\circ}C$ $Voc(T) = Voc(25^{\circ}C) \times [1 + Tvoc \times (T-25^{\circ}C)]$

 $Voc(-11^{\circ}C) = 44.87V, Voc(34^{\circ}C) = 40.03V$

1.25 in

1.25 in

02 AWG THWN-2

INTERCONNECTION 120% RULE

(MAIN PANEL)

INTERCONNECTION

120% RULE NOT APPLICABLE

LINE-SIDE TAP DOES NOT AFFECT

MAIN PANEL

HOLD ON KITS FOR PV BREAKERS IS MANDATORY FOR IQ COMBINER 4 / 4C.

> NAME: TOP TIER SOLAR SOLUTIONS ADDRESS: 1530 CENTER PARK DR, CHARLOTTE, NC 28217, USA PHONE: 855-997-1213 CONTRACTOR LICENSE#: 87345 ELECTRICAL LICENSE#: U.35673

TOP TIER

CONTRACTOR

REVISIONS									
DESCRIPTION DATE REV									

SIGNATURE & SEAL

HOMEOWNER INFO

CT, HOLLY 27540, USA GRENIE 21 SELBY CT SPRINGS, NC 2 $\dot{\mathbf{C}}$ MICHAE

APN: 050635010310 FMAII · PHONE:


SHEET NAME

SINGLE LINE DIAGRAM

> SHEET SIZE **ANSIB**

11" X 17" SHEET NUMBER

PV-4

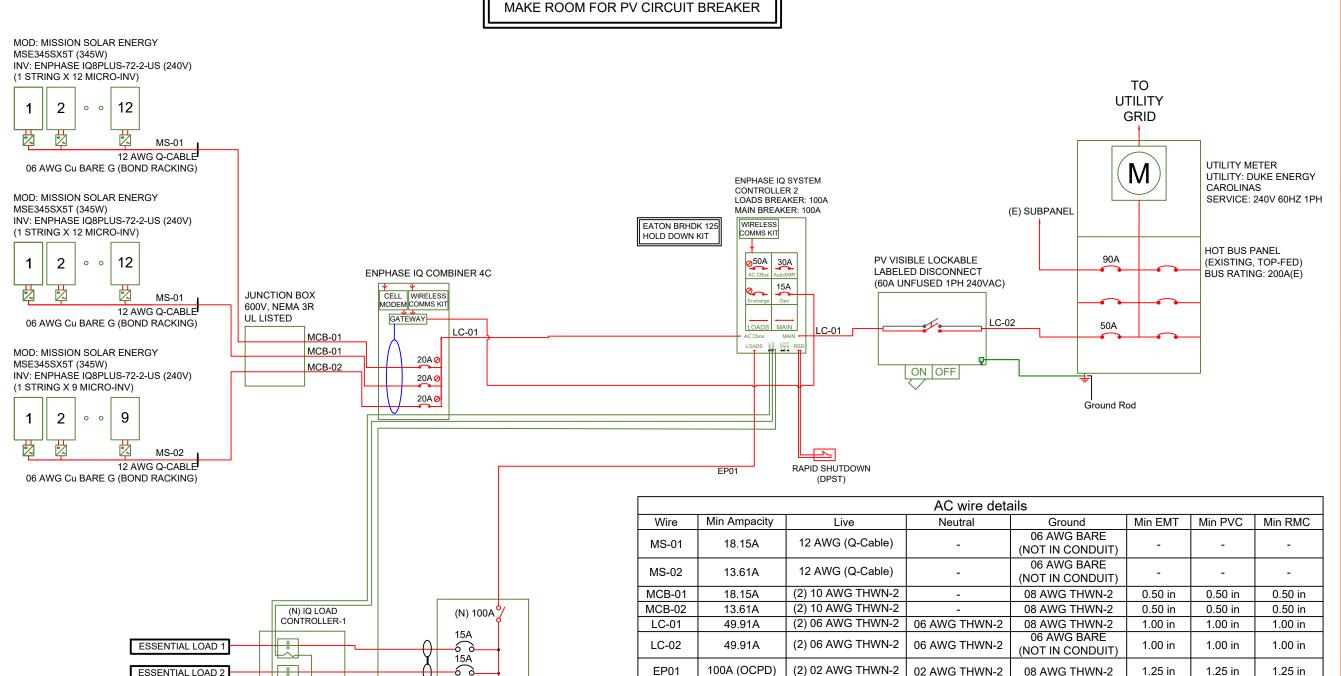

EP01

15A

(12) #12 AWG THWN-2

(1) #12 AWG THHN GND 3/4" EMT CONDUIT

(N) 100A SUB PANEL, 240V

(BACKUP LOADS PANEL)

SYSTEM SUMMARY STC DC/AC (11.385 kW DC / 9.57 kW AC)

2x STRINGS OF 12 CONNECTED IN PARALLEL
1x STRINGS OF 9 CONNECTED IN PARALLEL

- (33) MISSION SOLAR ENERGY MSE345SX5T (345W) MODULES
- (33) ENPHASE IQ8PLUS-72-2-US (240V) MICROINVERTERS

(1) ENPHASE IQ SYSTEM CONTROLLER 2

STC DC: (33) 345W = 11.385 kW STC AC: (33) 290W = 9.57 kW

	AC wire details																
WireID	#Modules	Nominal Voltage	Backfeed *1.25 /cond. set	Min OCPD	Total Power	Conductor sets	ccConductors /conduit	Expected max temp	Adjusted ampacity (ampacity x temp derate x conduit fill derate)	Conductor & neutral size	EGC size (Cu)	Conductor metal	Max length	V drop	Min EMT size	Min PVC size	Min RMC size
MS-01	12	240 V	18.15A	20 A	3.48 kW	1	2	34	25 x 0.94 x 1.00 = 23.50 A	12 AWG (Q-Cable)	06 AWG BARE (NOT IN CONDUIT)	Cu	50 ft	0.43 %	-	-	-
MS-02	09	240 V	13.61A	20 A	2.61 kW	1	2	34	25 x 0.94 x 1.00 = 23.50 A	12 AWG (Q-Cable)	06 AWG BARE (NOT IN CONDUIT)	Cu	50 ft	0.43 %	-	-	-
MCB-01	12	240 V	18.15A	20 A	3.19 kW	1	2	34	35 x 0.94 x 1.00 = 32.90 A	10 AWG THWN-2	10 AWG THWN-2	Cu	50 ft	0.43 %	0.50 in	0.50 in	0.50 in
MCB-02	09	240 V	13.75 A	20 A	2.61 kW	1	2	34	35 x 0.94 x 1.00 = 32.90 A	10 AWG THWN-2	10 AWG THWN-2	Cu	50 ft	0.43 %	0.50 in	0.50 in	0.50 in
LC-01	33	240 V	49.90 A	50 A	9.57 kW	1	2	34	65 x 0.94 x 1.00 = 61.10 A	06 AWG THWN-2	08 AWG THWN-2	Cu	10 ft	0.17 %	0.50 in	0.50 in	0.50 in
LC-02	33	240 V	49.90 A	50 A	9.57 kW	1	2	34	65 x 0.94 x 1.00 = 61.10 A	06 AWG THWN-2	08 AWG THWN-2	Cu	10 ft	0.17 %	0.50 in	0.50 in	0.50 in

INTERCONNECTION 120% RULE (MAIN PANEL)

INTERCONNECTION 120% RULE NOT APPLICABLE

LINE-SIDE TAP DOES NOT AFFECT MAIN PANEL EXTREME CASE MODULE OUTPUT (MISSION SOLAR ENERGY MSE345SX5T 345W)

Isc(25°C) = 10.92A, Tisc = 0.039%/°C Isc(T) = Isc(25°C) x [1 + Tisc x (T-25°C)] Isc(-11°C) = 10.77A, Isc(34°C) = 10.96A

 $\label{eq:voc(25°C)} \begin{array}{l} \mbox{Voc(25°C)} = 41.00\mbox{V, Tvoc} = -0.262\%\mbox{°C} \\ \mbox{Voc(T)} = \mbox{Voc(25°C)} \times [1 + \mbox{Tvoc} \times (\mbox{T-25°C})] \\ \mbox{Voc(-11°C)} = 44.87\mbox{V, Voc(34°C)} = 40.03\mbox{V} \\ \end{array}$

ELECTRICAL NOTES

- 1) ALL EQUIPMENT TO BE LISTED BY UL OR OTHER NRTL, AND LABELED FOR ITS APPLICATION.
-) ALL CONDUCTORS SHALL BE COPPER, RATED FOR 600 V AND 90 DEGREE C WET ENVIRONMENT.
- 3) WIRING, CONDUIT, AND RACEWAYS MOUNTED ON ROOFTOPS SHALL BE ROUTED DIRECTLY TO, AND LOCATED AS CLOSE AS POSSIBLE TO THE NEAREST RIDGE, HIP, OR VALLEY.
- 4) WORKING CLEARANCES AROUND ALL NEW AND EXISTING ELECTRICAL EQUIPMENT SHALL COMPLY WITH NEC 110.26.
- 5) DRAWINGS INDICATE THE GENERAL ARRANGEMENT OF SYSTEMS. CONTRACTOR SHALL FURNISH ALL NECESSARY OUTLETS, SUPPORTS, FITTINGS AND ACCESSORIES TO FULFILL APPLICABLE CODES AND STANDARDS.
- 6) WHERE SIZES OF JUNCTION BOXES, RACEWAYS, AND CONDUITS ARE NOT SPECIFIED, THE CONTRACTOR SHALL SIZE THEM ACCORDINGLY.
- 7) ALL WIRE TERMINATIONS SHALL BE APPROPRIATELY LABELED AND READILY VISIBLE.
- 8) MODULE GROUNDING CLIPS TO BE INSTALLED BETWEEN MODULE FRAME AND MODULE SUPPORT RAIL, PER THE GROUNDING CLIP MANUFACTURER'S INSTRUCTION.
- 9) MODULE SUPPORT RAIL TO BE BONDED TO CONTINUOUS COPPER G.E.C.VIA WEEB LUG OR ILSCO GBL-4DBT LAY-IN LUG.
- 10) PV EQUIPMENT SHALL BE DESIGNED AND INSTALLED IN ACCORDANCE WITH NEC 690.
- 11) EXACT LOCATION OF AUXILIARY GROUNDING TO BE DETERMINED AT TIME OF INSTALL
- 12) EXISTING WIRES MUST BE REPLACED IF SMALLER THAN LISTED MINIMUM SIZES PER NEC 310.15(B)(16).
- 13) AC DISCONNECT LOCATED WITHIN 10' OR LESS FROM UTILITY METER



CONTRACTOR

NAME: TOP TIER SOLAR SOLUTIONS ADDRESS: 1530 CENTER PARK DR, CHARLOTTE, NC 28217, USA PHONE: 855-997-1213 CONTRACTOR LICENSE#: 87345 ELECTRICAL LICENSE#: U.35673

REVISIONS							
DESCRIPTION	DATE	REV					

SIGNATURE & SEAL

HOMEOWNER INFO

MICHAEL GRENIER 21 SELBY CT, HOLLY SPRINGS, NC 27540, USA

APN: 050635010310

PHONE:

SHEET NAME

WIRING CALCULATION

ANSI B

SHEET NUMBER



ELECTRICAL SHOCK HAZARD

TERMINALS ON BOTH LINE AND LOAD SIDES MAY BE ENERGIZED IN THE OPEN POSITION

LABEL LOCATION: INVERTERS, AC DISCONNECTS, AC COMBINER BOXES, AC JUNCTION BOXES CODE REF: NEC 2017 - 690.13(B)



ELECTRICAL SHOCK HAZARD

IF GROUND FAULT IS INDICATED
ALL NORMALLY GROUNDED
CONDUCTORS MAY BE
UNGROUNDED AND ENERGIZED

LABEL LOCATION: AC DISCONNECTS, AC COMBINER BOXES, SERVICE PANELS CODE REF: NEC 2017 - 690.5(C)

PHOTOVOLTAIC SYSTEM UTILITY DISCONNECT SWITCH

LABEL LOCATION: AC DISCONNECTS FOR UTILITY

ACCESS

CODE REF: UTILITY

PHOTOVOLTAIC SYSTEM METER

LABEL LOCATION: PV PRODUCTION METER CODE REF: NEC 2017 - 690.4(B)



PHOTOVOLTAIC SYSTEM COMBINER PANEL

DO NOT ADD LOADS

LABEL LOCATION: AC COMBINER BOX CODE REF: NEC 2017 - 690.12(B)



DUAL POWER SOURCE SECOND SOURCE IS PHOTOVOLTIC

LABEL LOCATION: MSP, UTILITY METER (IF SEPARATE)

CODE REF: UTILITY

WARNING

INVERTER OUTPUT CONNECTION DO NOT RELOCATE THIS OVERCURRENT DEVICE

LABEL LOCATION: FIRST BACKFEED BREAKER (MSP/SUBPANEL) IF NO LINE SIDE TAP CODE REF: NEC 2017 - 705.12(B)(2)(3)(b), NEC 2017 - 705.12(B)(3), CEC 2019 - 705.12(B)(2)(3)(b), CEC 2019 -

705.12(B)(3)

A CAUTION

PHOTOVOLTAIC SYSTEM CIRCUIT IS BACKFEED

LABEL LOCATION: INTERCONNECTION Placard (MSP BACKFEED BREAKER OR TAP BOX IF LINE SIDE TAP) CODE REF: NEC 2017 - 705.2(4)

PV SOLAR BREAKER

DO NOT RELOCATE THIS OVERCURRENT DEVICE

LABEL LOCATION: FIRST BACKFEED BREAKER (MSP/SUBPANEL) IF NO LINE SIDE TAP CODE REF: NEC 2017 - 705.12(B)(2)(3)(b)

RAPID SHUTDOWN SWITCH FOR SOLAR PV SYSTEM

LABEL LOCATION: MSP CODE REF: NEC 2017 - 690.56(C)(3)


PHOTOVOLTAIC AC DISCONNECT

RATED AC OPERATING CURRENT: 39.93 AMPS
NOMINAL OPERATING AC VOLTAGE: 240 VAC

<u>LABEL LOCATION:</u> MAIN PANEL AC DISCONNECT(S) CODE REF: NEC 690.54

SOLAR PV SYSTEM EQUIPPED WITH RAPID SHUTDOWN

TURN RAPID SHUTDOWN
SWITCH TO THE
"OFF" POSITION TO SHUT
DOWN PV SYSTEM
AND REDUCE
SHOCK HAZARD
IN THE ARRAY.

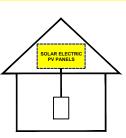

LABEL LOCATION: INTERCONNECTION POINT (MSP OR AC DISCONNECT IF LINE SIDE TAP) CODE REF: NEC 2017 - 690.12, NEC 2017 - 690.56(C)


NOTES AND SPECIFICATIONS:

SIGNS AND LABELS SHALL MEET THE REQUIREMENTS OF NEC 110.21(B), UNLESS SPECIFIC INSTRUCTIONS ARE REQUIRED BY SECTION 690, OR IF REQUESTED BY THE LOCAL AHJ. SIGNS AND LABELS SHALL ADEQUATELY WARN OF HAZARDS USING EFFECTIVE WORDS, COLORS AND SYMBOLS. LABELS SHALL BE PERMANENTLY AFFIXED TO THE EQUIPMENT OR WIRING METHOD AND SHALL NOT BE HAND WRITTEN.

LABEL SHALL BE OF SUFFICIENT DURABILITY TO WITHSTAND THE ENVIRONMENT INVOLVED. SIGNS AND LABELS SHALL COMPLY WITH ANSI Z535.4 - 2011, PRODUCT SAFETY SIGNS AND LABELS, UNLESS OTHERWISE SPECIFIED. DO NOT COVER EXISTING MANUFACTURER LABELS.

CAUTION:

POWER TO THIS SERVICE IS ALSO SUPPLIED FROM THE FOLLOWING SOURCES WITH DISCONNECTS AS SHOWN

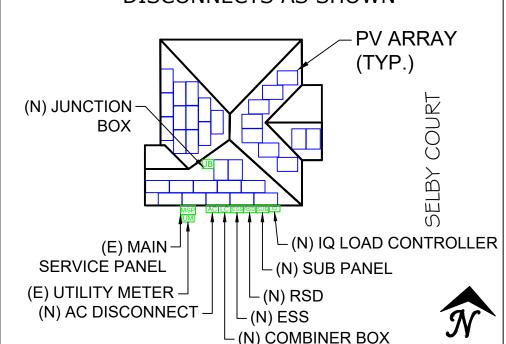



CONTRACTOR

NAME: TOP TIER SOLAR SOLUTIONS
ADDRESS: 1530 CENTER PARK DR,
CHARLOTTE, NC 28217, USA
PHONE: 855-997-1213
CONTRACTOR LICENSE#: 87345
ELECTRICAL LICENSE#: U 35673

REVISIONS							
DESCRIPTION	DATE	REV					

SIGNATURE & SEAL

HOMEOWNER INFO

MICHAEL GRENIER 21 SELBY CT, HOLLY SPRINGS, NC 27540, USA

APN: 050635010310 EMAIL: -PHONE: -

SHEET NAME

PLACARDS

SHEET SIZE ANSI B 11" X 17"

SHEET NUMBER PV-6





Class leading power output

-0 to +3%



True American Quality True American Brand

Mission Solar Energy is headquartered in San Antonio, Texas where we manufacture our modules. We produce American, high-quality solar modules ensuring the highest-in-class power output and best-in-class reliability. Our product line is tailored for residential, commercial and utility applications. Every Mission Solar Energy solar module is certified and surpasses industry standard regulations, proving excellent performance over the long term.

Demand the best. Demand Mission Solar Energy.



Certified Reliability

- Tested to UL 61730 & IEC Standards
- · Resistance to salt mist corrosion



Advanced Technology

- 6 Busbar
- Passivated Emitter Rear Contact
- Ideal for all applications



Extreme Weather Resilience

- Up to 5,600 Pa front load & 5,631 Pa back load
- Tested load to UL 61730

BAA Compliant for Government Projects

- Buy American Act
- American Recovery & Reinvestment Act





For more information, visit www.missionsolar.com/warranty

CERTIFICATIONS

FRAME-TO-FRAME WARRANTY

Degradation guaranteed not to exceed 2% in year one and 0.58% annually from years two to 30 with 84.08% capacity guaranteed in year 25.



C-SA2-MKTG-0025 REV 4 05/05/2021



UL 61730 / IEC 61215 / IEC 61730 / IEC 61701



If you have questions or concerns about products in your area please contact Mission Solar Energy.

www.missionsolar.com | info@missionsolar.com

Class Leading 340-350W


MSE PERC 60

Ø5.5-Grounding Hole (x2) FRONT VIEW SIDE VIEW REAR VIEW

BASIC DIMENSIONS

[UNITS: MM/IN]

	OPERATING	2 CONDI.
CURRENT-VOLTAGE CURVE	Maximum System Voltage	1,000Vdc
MSE345SX5T: 345WP, 60 CELL SOLAR MODULE	Operating Temperature Range	-40°C (-40°F

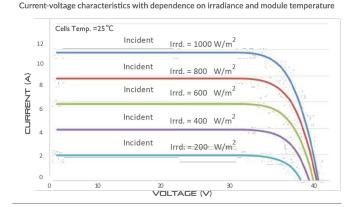

IEC 61215, 61730, 61701 UL 61730	CERTIFICATIONS AND TESTS							
UL 61730	IEC	61215, 61730, 61701						
	UL	61730						



Mission Solar Energy

8303 S. New Braunfels Ave., San Antonio, Texas 78235 www.missionsolar.com | info@missionsolar.com

Mission Solar Energy reserves the right to make specification changes without notice. C-SA2-MKTG-0025 REV 4 05/05/2021

ELECTR	ICAL	. SF	PECIFIC	ATION	1
PRODUCT TYPE	MSE	xxxSX	5T (xxx = P	max)	
Power Output	P _{max}	W_p	340	345	350
Module Efficiency		%	18.5	18.7	19.0
Tolerance		%	0/+3	0/+3	0/+3
Short Circuit Current	Isc	V	10.86	10.92	10.97
Open Circuit Voltage	Voc	Α	40.82	41.00	41.18
Rated Current	Imp	V	10.24	10.34	10.44
Rated Voltage	V _{mp}	V	33.20	33.37	33.52
Fuse Rating		Α	20	20	20
System Voltage		V	1,000	1,000	1,000

TEMPERATURE COEFFICIENTS			
Normal Operating Cell Temperature (NOCT)	44.43°C (±3.7%)		
Temperature Coefficient of Pmax	-0.361%/°C		
Temperature Coefficient of Voc	-0.262%/°C		
Temperature Coefficient of Isc	0.039%/°C		

OPERATING	CONDITIONS
Maximum System Voltage	1,000Vdc
Operating Temperature Range	-40°C (-40°F) to +85°C (185°F)
Maximum Series Fuse Rating	20A
Fire Safety Classification	Type 1
Front & Back Load (UL Standard)	Up to 5,600 Pa front and 5,631 Pa back load, Tested to UL 61730
Hail Safety Impact Velocity	25mm at 23 m/s

MECHANICAL DATA		
Solar Cells	P-type mono-crystalline silicon	
Cell Orientation	60 cells (6x10)	
Module Dimension	1,748mm x 1,054mm x 40mm	
Weight	20.3 kg (44.8 lbs.)	
Front Glass	3.2mm, tempered, low-iron, anti-reflective	
Frame	Anodized	
Encapsulant	Ethylene vinyl acetate (EVA)	
Junction Box	Protection class IP67 with 3 bypass-diodes	
Cable	1.0m, Wire 4mm2 (12AWG)	
Connector	Staubli PV-KBT4/6II-UR and PV-KST4/6II-UR, MC4, Renhe 05-8	

s	HIPPING	INFOF	OITAM	7
Container Feet	Ship To	Pallet	Panels	345 W Bin
53'	Most States	34	884	304.98 kW
Double Stack	CA	28	728	251.16 kW
	PALLET	Γ [26 PAN	ELS]	
Weight 1,263 lbs. (573 kg)	Height 47.5 in (120.65 cm)	(1:	Width 46 in 16.84 cm)	Length 70.25 in (178.43 cm)

www.missionsolar.com | info@missionsolar.com



CONTRACTOR

NAME: TOP TIER SOLAR SOLUTIONS ADDRESS: 1530 CENTER PARK DR, CHARLOTTE, NC 28217, USA PHONE: 855-997-1213 CONTRACTOR LICENSE#: 87345 ELECTRICAL LICENSE#: U.35673

REVISIONS				
DESCRIPTION	DATE	REV		

SIGNATURE & SEAL

HOMEOWNER INFO

GRENIER : 27540, USA 21 SELBY CT SPRINGS, NC 2 MICHAE

APN: 050635010310 FMAII · . PHONE: -

SHEET NAME

EQUIPMENT SPECIFICATION

> SHEET SIZE **ANSIB** 11" X 17"

SHEET NUMBER PV-7







IQ8 and IQ8+ Microinverters

Our newest IQ8 Microinverters are the industry's first microgrid-forming, software-defined microinverters with split-phase power conversion capability to convert DC power to AC power efficiently. The brain of the semiconductor-based microinverter is our proprietary application-specific integrated circuit (ASIC) which enables the microinverter to operate in grid-tied or off-grid modes. This chip is built in advanced 55nm technology with high speed digital logic and has super-fast response times to changing loads and grid events, alleviating constraints on battery sizing for home energy systems.



Part of the Enphase Energy System, IQ8 Series Microinverters integrate with the Enphase IQ Battery, Enphase IQ Gateway, and the Enphase App monitoring and analysis software.



Connect PV modules quickly and easily to IQ8 Series Microinverters using the included Q-DCC-2 adapter cable with plug-n-play MC4 connectors.

IQ8 Series Microinverters are UL Listed as PV Rapid Shut Down Equipment and conform with various regulations, when installed according to manufacturer's instructions.

IQ8 Series Microinverters redefine reliability

enabling an industry-leading limited warranty

standards with more than one million

cumulative hours of power-on testing,

of up to 25 years.

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IQ8SP-DS-0002-01-EN-US-2021-10-19

Easy to install

- Lightweight and compact with plug-n-play connectors
- Power Line Communication (PLC) between components
- Faster installation with simple two-wire cabling

High productivity and reliability

- Produce power even when the grid is down
- More than one million cumulative hours of testing
- Class II double-insulated enclosure
- Optimized for the latest highpowered PV modules

Microgrid-forming

- Complies with the latest advanced grid support
- Remote automatic updates for the latest grid requirements
- Configurable to support a wide range of grid profiles
- Meets CA Rule 21 (UL 1741-SA) requirements

IQ8 and IQ8+ Microinverters

INPUT DATA (DC)		108-60-2-US	IQ8PLUS-72-2-US
Commonly used module pairings ¹	w	235 - 350	235 - 440
Module compatibility		60-cell/120 half-cell	60-cell/120 half-cell and 72-cell/144 half-cell
MPPT voltage range	V	27 - 37	29 - 45
Operating range	V	25 – 48	25 – 58
Min/max start voltage	V	30 / 48	30 / 58
Max input DC voltage	V	50	60
Max DC current² [module lsc]	А	1	5
Overvoltage class DC port			II.
DC port backfeed current	mA		0
PV array configuration		1x1 Ungrounded array; No additional DC side protection requ	uired; AC side protection requires max 20A per branch circuit
OUTPUT DATA (AC)		108-60-2-US	108PLUS-72-2-US
Peak output power	VA	245	300
Max continuous output power	VA	240	290
Nominal (L-L) voltage/range³	٧	240 / 2	211 – 264
Max continuous output current	А	1.0	1.21
Nominal frequency	Hz	6	60
Extended frequency range	Hz	50	- 68
Max units per 20 A (L-L) branch circ	uit ⁴	16	13
Total harmonic distortion		<	5%
Overvoltage class AC port			III
AC port backfeed current	mA	30	
Power factor setting		1	.0
Grid-tied power factor (adjustable)		0.85 leading	- 0.85 lagging
Peak efficiency	%	97.5	97.6
CEC weighted efficiency	%	97	97
Night-time power consumption	mW	6	60
MECHANICAL DATA			
Ambient temperature range		-40°C to +60°C	(-40°F to +140°F)
Relative humidity range		4% to 100%	(condensing)
DC Connector type		М	C4
Dimensions (HxWxD)		212 mm (8.3") x 175 mn	n (6.9") x 30.2 mm (1.2")
Weight		1.08 kg ((2.38 lbs)
Cooling		Natural convection – no fans	
Approved for wet locations		Yes	
Acoustic noise at 1 m		<60 dBA	
Pollution degree		PD3	
Enclosure		Class II double-insulated, corrosion resistant polymeric enclosure	
Environ. category / UV exposure rati	ng	NEMA Type 6 / outdoor	
COMPLIANCE			
Certifications		CA Rule 21 (UL 1741-SA), UL 62109-1, UL1741/IEEE1547, FCC Part This product is UL Listed as PV Rapid Shut Down Equipment and 690.12 and C22.1-2018 Rule 64-218 Rapid Shutdown of PV Syste manufacturer's instructions.	conforms with NEC 2014, NEC 2017, and NEC 2020 section

(1) No enforced DC/AC ratio. See the compatibility calculator at https://link.enphase.com/module-compatibility (2) Maximum continuous input DC current is 10.6A (3) Nominal voltage range can be extended beyond nominal if required by the utility. (4) Limits may vary. Refer to local requirements to define the number of microinverters per branch in your area.

IQ8SP-DS-0002-01-EN-US-2021-10-19



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REVIS	REVISIONS		
DESCRIPTION	DATE	REV	

SIGNATURE & SEAL

HOMEOWNER INFO

MICHAEL GRENIER 21 SELBY CT, HOLLY SPRINGS, NC 27540, USA

APN: 050635010310 EMAIL: -PHONE: -

SHEET NAME

EQUIPMENT SPECIFICATION

> ANSI B 11" X 17"

SHEET NUMBER

Data Sheet **Enphase Networking**

Enphase IQ Combiner 4/4C

X-IQ-AM1-240-4 X-IQ-AM1-240-4C



The Enphase IQ Combiner 4/4C with Enphase IQ Gateway and integrated LTE-M1 cell modem (included only with IQ Combiner 4C) consolidates interconnection equipment into a single enclosure and streamlines IQ microinverters and storage installations by providing a consistent, pre-wired solution for residential applications. It offers up to four 2-pole input circuits and Eaton BR series busbar assembly.

Smart

- · Includes IQ Gateway for communication and control
- Includes Enphase Mobile Connect cellular modem (CELLMODEM-M1-06-SP-05), included only with IQ Combiner 4C
- Includes solar shield to match Enphase IQ Battery aesthetics and deflect heat
- · Flexible networking supports Wi-Fi, Ethernet, or cellular
- · Optional AC receptacle available for PLC bridge
- · Provides production metering and consumption monitoring

Simple

- · Centered mounting brackets support single stud mounting
- · Supports bottom, back and side conduit entry
- Up to four 2-pole branch circuits for 240 VAC
- plug-in breakers (not included)
- 80A total PV or storage branch circuits

Reliable

- Durable NRTL-certified NEMA type 3R enclosure
- · Five-year limited warranty
- · Two years labor reimbursement program coverage included for both the IQ Combiner SKU's
- UL listed



Enphase IQ Combiner 4/4C

MODEL NUMBER	
IQ Combiner 4 (X-IQ-AM1-240-4)	IQ Combiner 4 with Enphase IQ Gateway printed circuit board for integrated revenue grade PV production metering (ANSI C12.20 +/- 0.5%) and consumption monitoring (+/- 2.5%). Includes a silver solar shield to match the IQ Battery system and IQ System Controller 2 and to deflect heat.
IQ Combiner 4C (X-IQ-AM1-240-4C)	IQ Combiner 4C with Enphase IQ Gateway printed circuit board for integrated revenue grade PV production metering (ANSI C12.20 +/- 0.5%) and consumption monitoring (+/- 2.5%). Includes Enphase Mobile Connect cellular modem (CELLMODEM-M1-06-SP-05), a plug-and-play industrial-grade cell modem for systems up to 60 microinverters. (Available in the US, Canada, Mexico, Puerto Rico, and the US Virgin Islands, where there is adequate cellular service in the installation area.) Includes a silver solar shield to match the IQ Battery and IQ System Controller and to deflect heat.
ACCESSORIES AND REPLACEMENT PARTS	(not included, order separately)
Ensemble Communications Kit COMMS-CELLMODEM-M1-06 CELLMODEM-M1-06-SP-05 CELLMODEM-M1-06-AT-05	 Includes COMMS-KIT-01 and CELLMODEM-M1-06-SP-05 with 5-year Sprint data plan for Ensemble sites 4G based LTE-M1 cellular modem with 5-year Sprint data plan 4G based LTE-M1 cellular modem with 5-year AT&T data plan
Circuit Breakers BRK-10A-2-240V BRK-15A-2-240V BRK-20A-2P-240V BRK-15A-2P-240V-B BRK-20A-2P-240V-B	Supports Eaton BR210, BR215, BR220, BR230, BR240, BR250, and BR260 circuit breakers. Circuit breaker, 2 pole, 10A, Eaton BR210 Circuit breaker, 2 pole, 15A, Eaton BR215 Circuit breaker, 2 pole, 20A, Eaton BR220 Circuit breaker, 2 pole, 15A, Eaton BR215B with hold down kit support Circuit breaker, 2 pole, 20A, Eaton BR220B with hold down kit support
EPLC-01	Power line carrier (communication bridge pair), quantity - one pair
XA-SOLARSHIELD-ES	Replacement solar shield for IQ Combiner 4/4C
XA-PLUG-120-3	Accessory receptacle for Power Line Carrier in IQ Combiner 4/4C (required for EPLC-01)
XA-ENV-PCBA-3	Replacement IQ Gateway printed circuit board (PCB) for Combiner 4/4C
X-IQ-NA-HD-125A	Hold down kit for Eaton circuit breaker with screws.
ELECTRICAL SPECIFICATIONS	
Rating	Continuous duty
System voltage	120/240 VAC, 60 Hz
Eaton BR series busbar rating	125 A
Max. continuous current rating	65 A
Max. continuous current rating (input from PV/storage)	64 A
Max. fuse/circuit rating (output)	90 A
Branch circuits (solar and/or storage)	Up to four 2-pole Eaton BR series Distributed Generation (DG) breakers only (not included)
Max. total branch circuit breaker rating (input)	80A of distributed generation / 95A with IQ Gateway breaker included
Envoy breaker	10A or 15A rating GE/Siemens/Eaton included
Production metering CT	200 A solid core pre-installed and wired to IQ Gateway
Consumption monitoring CT (CT-200-SPLIT)	A pair of 200 A split core current transformers
MECHANICAL DATA	
Dimensions (WxHxD)	37.5 x 49.5 x 16.8 cm (14.75" x 19.5" x 6.63"). Height is 21.06" (53.5 cm) with mounting brackets.
Weight	7.5 kg (16.5 lbs)
Ambient temperature range	-40° C to +46° C (-40° to 115° F)
Cooling	Natural convection, plus heat shield
Enclosure environmental rating	Outdoor, NRTL-certified, NEMA type 3R, polycarbonate construction
Wire sizes	 20 A to 50 A breaker inputs: 14 to 4 AWG copper conductors 60 A breaker branch input: 4 to 1/0 AWG copper conductors Main lug combined output: 10 to 2/0 AWG copper conductors Neutral and ground: 14 to 1/0 copper conductors Always follow local code requirements for conductor sizing.
Altitude	To 2000 meters (6,560 feet)
INTERNET CONNECTION OPTIONS	
Integrated Wi-Fi	802.11b/g/n
Cellular	CELLMODEM-M1-06-SP-05, CELLMODEM-M1-06-AT-05 (4G based LTE-M1 cellular modem). Note that an Enphase Mobile Connect cellular modem is required for all Ensemble installations.
Ethernet	Optional, 802.3, Cat5E (or Cat 6) UTP Ethernet cable (not included)
COMPLIANCE	
Compliance, IQ Combiner	UL 1741, CAN/CSA C22.2 No. 107.1, 47 CFR, Part 15, Class B, ICES 003 Production metering: ANSI C12.20 accuracy class 0.5 (PV production) Consumption metering: accuracy class 2.5
Compliance, IQ Gateway	UL 60601-1/CANCSA 22.2 No. 61010-1

To learn more about Enphase offerings, visit **enphase.com**

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REVISIONS		
DESCRIPTION	DATE	REV

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HOMEOWNER INFO

, CT, HOLLY IC 27540, USA GRENIER 21 SELBY CT SPRINGS, NC 2 MICHAE

APN: 050635010310 FMAII · . PHONE: -

ENPHASE.

SHEET NAME

EQUIPMENT SPECIFICATION

> SHEET SIZE **ANSI B** 11" X 17"

SHEET NUMBER

Data Sheet **Enphase Energy System** Compatible with M-Series, IQ6, IQ7, or IQ8 Microinverters

IQ System Controller 2

The IQ System Controller 2 connects the home to grid power, the IQ Battery system, and solar PV. It provides microgrid interconnection device (MID) functionality by automatically detecting and seamlessly transitioning the home energy system from grid power to backup power in the event of a grid failure. It consolidates interconnection equipment into a single enclosure and streamlines grid independent capabilities of PV and storage installations by providing a consistent, pre-wired solution for residential applications.



Easy to Install

- · Connects to service entrance1 or main load center
- · Supports main breaker
- · Includes neutral-forming transformer
- Mounts on single stud with centered brackets
- · Provides conduit entry from bottom, left, or right
- · Includes color coded wires for ease of wiring Enphase Energy System Shutdown Switch

Flexible

- · Can be used for Sunlight Backup, Home Essentials Backup, or Full Energy Independence
- Integrates with select AC standby generators. See Generator Integration Tech Brief for list of generators

Safe and Reliable

- Enphase Energy System Shutdown Switch can be used to disconnect PV, battery, and generator systems
- It acts as a rapid shutdown initiator of grid forming IQ8 PV Microinverters for safety of maintenance technicians/first
- IQ System Controller 2 has a 10-year limited warranty

1. IQ System Controller 2 is not suitable for use as service equipment in Canada.

To learn more about Enphase offerings, visit enphase.com

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IQSC-2-DS-0087-01-EN-US-12-06-2022



MODEL NUMBERS		
EP200G101-M240US01 NOTE: No longer sold separately.	IQ System Controller 2 with neutral-forming transformer (NFT) Streamlines grid-independent capabilities of PV and storage in	-
EP200g-SC2-RSD-KIT	Includes above plus Enphase Energy System Shutdown Switch and purple 12 AWG wires, and breaker for powering IQ Gateway	
EP200G-SC2-RSD-BRK-KIT	Includes above plus three Eaton BR220B breakers for either IQ BR240B breakers and one BR260 breaker for IQ System Contro for IQ Combiner, and two EP200G-NA-HD-200A hold-down kits 2A and 2B).	oller 2, two X-IQ-NA-HD-125A hold-down
ACCESSORIES and REPLACEMENT PARTS (ORDER SEPA	ARATELY AS NEEDED)	
EP200G-NA-XA-E3	Replacement IQ System Controller 2 printed circuit board	
EP200G-NA-HD-200A	Eaton type BR circuit breaker hold-down kit, BRHDK125	
CT-200-SPLIT	200A split core current transformer for generator metering (± 2	2.5% accuracy)
Circuit breakers (as needed) ^{2,3} • BRK-100A-2P-240V: Main breaker, 2 pole, 100A, 25kAIC, Eaton CSR2100N • BRK-125A-2P-240V: Main breaker, 2 pole, 125A, 25kAIC, Eaton CSR2125N	BRK-20A-2P-240V-B: Circuit breaker, 2 pole, 20A, 10kAIC, Eat BRK-30A-2P-240V-B: Circuit breaker, 2 pole, 30A, 10kAIC, Eat	
 BRK-150A-2P-240V: Main breaker, 2 pole, 150A, 25kAIC, Eaton CSR2150N BRK-175A-2P-240V: Main breaker, 2 pole, 175A, 25kAIC, Eaton CSR2175N BRK-200A-2P-240V: Main breaker, 2 pole, 200A, 25kAIC, Eaton CSR2200N 	 BRK-40A-2P-240V-B: Circuit breaker, 2 pole, 40A, 10kAlC, Eat BRK-60A-2P-240V: Circuit breaker, 2 pole, 60A, 10kAlC, Eator BRK-80A-2P-240V: Circuit breaker, 2 pole, 80A, 10kAlC, Eator 	BR260
BRK-20A40A-2P-240V	Quad breaker, 20A/40A, 10kAIC, Eaton BQC220240	
EP200G-HNDL-R1	IQ System Controller 2 installation handle kit	
EP200G-LITKIT	IQ System Controller 2 literature kit, including labels, feed-thro	ugh headers, screws, filler plates, and QI
EP200G-NA-02-RSD	2 pole Enphase Energy System Shutdown Switch	
ELECTRICAL SPECIFICATIONS		
Nominal voltage/range (L-L)	240 VAC/±20%	
Voltage measurement accuracy	±1% (±1.2V L-N and ±2.4V L-L)	
Auxiliary/Dry contact for load control, excess PV control, and generator two-wire control	24V, 1A	
Nominal frequency/range	60 Hz/56 - 63 Hz	
Frequency measurement accuracy	±0.1 Hz	
Maximum continuous current rating	160A	
Maximum input overcurrent protection device4	200A	
Maximum output overcurrent protection device4	200A	
Maximum overcurrent protection device rating for generator circuit	A08	
Maximum overcurrent protection device rating for storage circuit	80A	
Maximum overcurrent protection device rating for PV combiner circuit	A08	
Internal busbar rating	200A	
Neutral Forming Transformer (NFT) • Breaker rating (pre-installed): 40A between L1 and neutral; 40A between L2 and neutral	Maximum continuous unbalanced current: 30A @ 120V Peak rated power: 8800VA for 30 seconds	
Continuous rated power: 3600VA	Peak unbalanced current: 80A @ 120V for 30 seconds	
MECHANICAL DATA		
Dimensions (WxHxD)	50cm x 91.6cm x 24.6cm (19.7 in x 36 in x 9.7 in)	
Weight	39.4 kg (87 lbs)	
Ambient temperature range	-40° C to +50° C (-40° F to 122° F)	
Cooling	Natural convection, solar shield	
Enclosure environmental rating	Outdoor, NEMA type 3R, polycarbonate construction	
Maximum altitude	2500 meters (8200 feet)	
WIRE SIZES		
Connections (All lugs are rated to 90C)	Main lugs and backup load lugs CSR breaker bottom wiring lugs AC combiner lugs, IQ Battery lugs, and generator lugs Neutral lugs	Cu/Al: 1 AWG - 300 KCMIL Cu/Al: 2 AWG - 300 KCMIL 14 AWG - 2 AWG Cu/Al: 6 AWG - 300 KCMIL
Neutral and ground bars	Large holes (5/16-24 UNF) Small holes (10-32 UNF)	14 AWG – 1/0 AWG 14 AWG – 6 AWG
COMPLIANCE		
Compliance	UL1741, UL1741 SA, UL1741 SB, UL1741 PCS CRD, UL1998, UL8 CSA 22.2 No. 107.1, 47 CFR Part 15 Class B, ICES 003, ICC ES A IQ System Controller 2 is approved for use as service equipme IFETEL homologation number: RCPENEP22-2078	AC156.
Compatible with BRHDK125 hold-down kit to comply with 2017 NEC 710.15 The IQ System Controller 2 is rated at 22 kAIC. CSR breakers are not included in EP200G-SC2-RSD-BRK-KIT. Installer mus 5. Sections from these standards were used during the safety evaluation and	5E for back-fed circuit breakers. st provide correctly rated breakers.	IQSC-2-DS-0087-01-EN-US-12-06-



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REVISIONS		
DESCRIPTION	DATE	REV

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HOMEOWNER INFO

, CT, HOLLY IC 27540, USA GRENIER 21 SELBY CT SPRINGS, NC 2 MICHAE

APN: 050635010310 FMAII · . PHONE: -

IOSC-2-DS-0087-01-EN-US-12-06-2022

SHEET NAME

EQUIPMENT SPECIFICATION

> SHEET SIZE **ANSI B** 11" X 17"

SHEET NUMBER **PV-10**

TOP TIER

CONTRACTOR NAME: TOP TIER SOLAR SOLUTIONS ADDRESS: 1530 CENTER PARK DR, CHARLOTTE, NC 28217, USA PHONE: 855-997-1213 CONTRACTOR LICENSE#: 87345 ELECTRICAL LICENSE#: U.35673

REVISIONS

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HOMEOWNER INFO

GRENIER

MICHAEL

APN: 050635010310 FMAII ·

PHONE:

, CT, HOLLY IC 27540, USA

21 SELBY CT SPRINGS, NC 2



Flush Mount System



Built for solar's toughest roofs.

IronRidge builds the strongest mounting system for pitched roofs in solar. Every component has been tested to the limit and proven in extreme environments.

Our rigorous approach has led to unique structural features, such as curved rails and reinforced flashings, and is also why our products are fully certified, code compliant and backed by a 20-year warranty.



Strength Tested

All components evaluated for superior structural performance.



PE Certified

Pre-stamped engineering letters available in most states.



Class A Fire Rating

UL 2703 Listed System

Certified to maintain the fire resistance rating of the existing roof.

Entire system and components meet

newest effective UL 2703 standard.



Design Assistant

Online software makes it simple to create, share, and price projects.



20-Year Warranty

Twice the protection offered by competitors.

- XR Rails ⊕

XR10 Rail



A low-profile mounting rail for regions with light snow.

- 6' spanning capability
- Moderate load capability
- Clear and black finish

XR100 Rail



The ultimate residential solar mounting rail.

- 8' spanning capability
- · Heavy load capability
- · Clear and black finish

XR1000 Rail



A heavyweight mounting rail for commercial projects.

- 12' spanning capability
- Extreme load capability
- · Clear anodized finish

Bonded Splices



All rails use internal splices for seamless connections.

- · Self-drilling screws
- · Varying versions for rails
- Forms secure bonding

Clamps & Grounding (#)

UFOs



Universal Fastening Objects bond modules to rails.

- · Fully assembled & lubed
- · Single, universal size
- · Clear and black finish

Stopper Sleeves



Snap onto the UFO to turn into a bonded end clamp.

- · Bonds modules to rails
- · Sized to match modules
- Clear and black finish

Slotted L-Feet

Grounding Lugs



Connect arrays to equipment ground.

- · Low profile
- · Single tool installation
- · Mounts in any direction

Microinverter Kits



Mount MIs or POs to XR Rails.

- · Bonds devices to rails
- · Kit comes assembled
- · Listed to UL 2703

Attachments

FlashFoot2



Flash and mount XR Rails with superior waterproofing.

- · Twist-on Cap eases install
- · Wind-driven rain tested
- · Mill and black finish

Drop-in design for rapid rail

- attachment. · Secure rail connections
- Slot for vertical adjusting
- Clear and black finish

Bonding Hardware



Bond and attach XR Rails to roof attachments.

- T & Square Bolt options
- Nut uses 7/16" socket
- · Assembled and lubricated

Flush Standoffs



Raise Flush Mount System to various heights.

- · Works with vent flashing
- 4" and 7" lengths
- Ships assembled

SHEET SIZE **ANSIB** 11" X 17"

SHEET NAME

EQUIPMENT

SPECIFICATION

PV-11

SHEET NUMBER

Resources



Design Assistant


Go from rough layout to fully engineered system. For free. Go to IronRidge.com/design

NABCEP Certified Training

Earn free continuing education credits, while learning more about our systems. Go to IronRidge.com/training




Slotted L-Foot

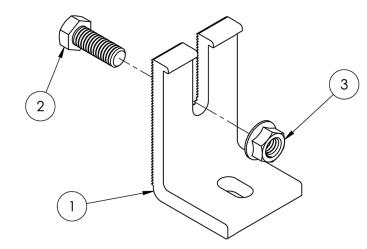

Item Number	Component	Qty in Kit
1	FOOT, EXTRUDED L - SLOTTED	4
2	BOLT, 3/8-16 X 1" HEX CS SS	4
3	NUT, FLANGE HEX 3/8-16 SS	4


Part Number	Description	
RS-LFT-001	Kit of 4, Slotted L-Foot (Mill Finish)	
RS-LFT-001B	Kit of 4, Slotted L-Foot (Black Finish)	



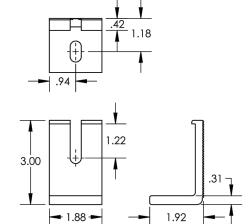


Property	Value
Material	Aluminum
Finish	Mill / Black

2) Bolt, 3/8-16 x 1" Hex CS SS

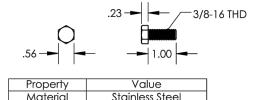

Finish		Clear		

3) Nut, Flange Hex 3/8-16 SS

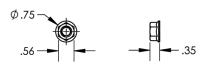

Property	Value
Material	Stainless Steel
Finish	Clear

TOP TIER

CONTRACTOR

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HOMEOWNER INFO

MICHAEL GRENIER

21 SELBY CT, HOLLY SPRINGS, NC 27540, USA

APN: 050635010310 EMAIL: -PHONE: -

SHEET NAME

EQUIPMENT SPECIFICATION

SHEET SIZE ANSI B 11" X 17"

SHEET NUMBER PV-12