

76 North Meadowbrook Drive Alpine, UT 84004 office (201) 874-3483 swyssling@wysslingconsulting.com

June 8, 2022

Legacy Solar 3333 Digital Drive #600 Lehi, UT 84043

Re: Engineering Services
Richards Residence
221 Blue Creek School Road, Jacksonville NC
10.560 kW System

To Whom It May Concern:

We have received information regarding solar panel installation on the roof of the above referenced structure. Our evaluation of the structure is to verify the existing capacity of the roof system and its ability to support the additional loads imposed by the proposed solar system.

A. Site Assessment Information

- 1. Site visit documentation identifying attic information including size and spacing of framing for the existing roof structure.
- Design drawings of the proposed system including a site plan, roof plan and connection details for the solar panels. This information will be utilized for approval and construction of the proposed system.

B. Description of Structure:

Roof Framing: Prefabricated wood trusses at 24" on center. All truss members are

constructed of 2x4 dimensional lumber.

Roof Material: Composite Asphalt Shingles

Roof Slope: 26 degrees
Attic Access: Accessible
Foundation: Permanent

C. Loading Criteria Used

Dead Load

- Existing Roofing and framing = 7 psf
- New Solar Panels and Racking = 3 psf
- TOTAL = 10 PSF
- Live Load = 20 psf (reducible) 0 psf at locations of solar panels
- Ground Snow Load = 10 psf
- Wind Load based on ASCE 7-10
 - Ultimate Wind Speed = 140 mph (based on Risk Category II)
 - Exposure Category C

Analysis performed of the existing roof structure utilizing the above loading criteria is in accordance with the North Carolina Residential Code (2015 IRC), including provisions allowing existing structures to not require strengthening if the new loads do not exceed existing design loads by 105% for gravity elements and 110% for seismic elements. This analysis indicates that the existing framing will support the additional panel loading without damage, if installed correctly.

D. Solar Panel Anchorage

1. The solar panels shall be mounted in accordance with the most recent Unirac installation manual. If during solar panel installation, the roof framing members appear unstable or deflect non-uniformly, our office should be notified before proceeding with the installation.

2. Connection on the roof is utilizing (4) ½" or #14 screws into the existing decking to resist uplift forces. Contractor to verify installation to be performed in accordance with the Unirac recommendations. Pull out values per screw are based on National Design Specification values for CDX plywood and are identified as 208 lbs/inch. Based on ½" sheathing the value per screw would be 104 lbs providing 416 lbs uplift resistance per attachment.

3. Considering the wind speed, roof slopes, size and spacing of framing members, and condition of

the roof, the panel supports shall be placed no greater than 60" on center.

4. Panel supports connections shall be staggered to distribute load to adjacent framing members.

Based on the above evaluation, this office certifies that with the racking and mounting specified, the existing roof system will adequately support the additional loading imposed by the solar system. This evaluation is in conformance with the North Carolina Residential Code, current industry standards, and is based on information supplied to us at the time of this report.

Should you have any questions regarding the above or if you require further information do not hesitate to contact me.

Soot E. Wyseling DE

Scott E. Wyssling, PE North Carolina Licente Rys. 46546 THIS PLAN HAS BEEN ELECTRONICALLY SIGNED AND SEALED BY SCOTT WYSSLING, PE USING A DIGITAL SIGNATURE AND DATE. PRINTED COPIES OF THIS DOCUMENT ARE NOT CONSIDERED SIGNED AND SEALED AND THE SIGNATURE MUST BE VERIFIED ON ANY ELECTRONIC COPIES



Wyssling Consulting, PLLC
76 N Meadowbrook Drive Alpine UT 84004
North Carolina COA # P-2308
Signed 6/8/2022



SCOPE OF WORK:

TO INSTALL A ROOF MOUNTED SOLAR PHOTOVOLTAIC SYSTEM AT THE OWNER RESIDENCE LOCATED AT 221 BLUE CREEK SCHOOL RD, JACKSONVILLE, NC 28540, USA

THE POWER GENERATED BY THE PV SYSTEM WILL BE INTERCONNECTED WITH THE UTILITY GRID THROUGH THE EXISTING ELECTRICAL SERVICE EQUIPMENT.

THE PV SYSTEM DOES NOT INCLUDE STORAGE BATTERIES.

EQUIPMENT SUMMARY

24 APTOS DNA-120-MF10-440W MODULES

24 ENPHASE IQ8PLUS -72-2-US (240V) MICROINVERTERS

GENERAL NOTES

- THESE CONSTRUCTION DOCUMENTS HAVE BEEN BASED ON FIELD INSPECTIONS AND OTHER INFORMATION AVAILABLE AT THE TIME, ACTUAL FIELD CONDITIONS MAY REQUIRE MODIFICATIONS IN CONSTRUCTION DETAILS.
- ARCHITECT HAS NOT BEEN RETAINED TO SUPERVISE ANY CONSTRUCTION OR INSTALLATION . OF ANY EQUIPMENT AT SITE.
- CONTRACTOR SHALL FURNISH ALL LABOR, MATERIAL, EQUIPMENT, TOOLS, OBTAINS ALL PERMITS, LICENSES AND PAY ALL REQUIRED FEES AND COMPLETE INSTALLATION.
- CONTRACTOR HAS THE FULL RESPONSIBILITY TO CHECK AND VERIFY ALL DIMENSIONS AND EXISTING CONDITIONS. ANY DISCREPANCIES SHALL BE REPORTED TO THE ENGINEER BEFORE PROCEEDING WITH THE WORK. ANY WORK STARTED BEFORE CONSULTATION AND ACCEPTANCE BY THE ENGINEER SHALL BE THE SOLE RESPONSIBILITY OF THE CONTRACTOR AND SHALL BE SUBJECT TO CORRECTION BY THEM WITHOUT ADDITIONAL COMPENSATION.
- DAMAGE CAUSED TO THE EXISTING STRUCTURE, PIPES, DUCTS, WINDOWS, WALL, FLOORS, ETC. SHALL BE REPAIRED TO THE ORIGINAL CONDITION OR REPLACED BY THE CONTRACTOR AT NO ADDITIONAL COST.
- THE CONTRACTOR SHALL BE HELD RESPONSIBLE FOR THE PROPER INSTALLATION AND COMPLETION OF THE WORK WITH APPROVED MATERIALS.
- NO CHANGES ARE TO BE MADE WITHOUT THE CONSULTATION AND APPROVAL OF THE ARCHITECT.
- CONTRACTOR SHALL OBTAIN BULDING PERMIT. NO WORK TO START UNLESS BUILDING PERMIT IS PROPERLY DISPLAYED.
- ALL WORKMANSHIP AND MATERIALS SHALL BE OF FIRST QUALITY AND IN COMPLIANCE WITH VOLTAGE DROP LIMITED TO 2% THE REQUIREMENTS OF THE FLORIDA BUILDING CODE, THE DEPARTMENT OF ENVIRONMENTAL PROTECTION AND ALL PERTINENT AGENCIES.
- IT 1S ESSENTIAL THAT ALL WORK PROCEED WITH THE MAXIMUM COOPERATION OF ALL PARTIES AND WITH MINIMUM INTERFERENCE TO THE OCCUPANTS WITHIN THE BUILDING. THE OWNER'S DIRECTIONS IN THIS REGARD SHALL BE FULLY COMPLIED WITH.
- ALL EXPOSED PLUMBING, HVAC, ELECTRICAL DUCTWORK, PIPING AND CONDUITS ARE TO BE PAINTED BY GENERAL CONTRACTOR.
- THE CONTRACTOR SHALL PERFORM THE WORK IN STRICT CONFORMANCE WITH THE LOCAL LAWS, REGULATIONS AND THE NATIONAL ELECTRIC CODE.
- THE CONTRACTOR SHALL OBTAIN ALL PERMITS, APPROVALS, AFFIDAVITS, CERTIFICATIONS, ETC. AND PAY ALL FEES AS REQUIRED BY THE LOCAL AUTHORITIES.
- CONTRACTORS SHALL OBTAIN FIRE CERTIF. UPON COMPLETION OF WORK.

ELECTRICAL NOTES:

- ALL EQUIPMENT TO BE LISTED BY UL OR OTHER NRTL, AND LABELED FOR ITS APPLICATION.
- ALL CONDUCTORS SHALL BE COPPER, RATED FOR 600 V AND 90 DEGREE C WET ENVIRONMENT.
- WIRING, CONDUIT, AND RACEWAYS MOUNTED ON ROOFTOPS SHALL BE ROUTED DIRECTLY TO, AND LOCATED AS CLOSE AS POSSIBLE TO THE NEAREST RIDGE, HIP, OR VALLEY.
- WORKING CLEARANCES AROUND ALL NEW AND EXISTING ELECTRICAL EQUIPMENT SHALL COMPLY WITH NEC 110.26.
- WHERE SIZES OF JUNCTION BOXES, RACEWAYS, AND CONDUITS ARE NOT SPECIFIED, THE CONTRACTOR SHALL SIZE THEM ACCORDINGLY.
- ALL WIRE TERMINATIONS SHALL BE APPROPRIATELY LABELED AND READILY VISIBLE.
- MODULE GROUNDING CLIPS TO BE INSTALLED BETWEEN MODULE FRAME AND MODULE SUPPORT RAIL, PER THE GROUNDING CLIP MANUFACTURERS INSTRUCTION.
- MODULE SUPPORT RAIL SHALL BE BONDED TO THE MODULE

GOVERNING CODES

2018 INTERNATIONAL FIRE CODE 2018 INTERNATIONAL BUILDING CODE 2018 INTERNATIONAL RESIDENTIAL CODE 2018 NORTH CAROLINA STATE BUILDING CODE 2020 NATIONAL ELECTRICAL CODE

AUTHORITY HAVING JURISDICTION (AHJ): ONSLOW COUNTY

WIRING AND CONDUIT NOTES:

- ALL CONDUIT SIZES AND TYPES SHALL BE LISTED FOR ITS PURPOSE AND APPROVAL FOR THE SITE APPLICATIONS
- ALL PV CABLES AND HOMERUN WIRES BE #10AWG *USE-2, PV WIRE, OR PROPRIETARY SOLAR CABLING SPECIFIED BY MFR, OR EQUIVALENT; ROUTED TO SOURCE CIRCUIT COMBINER BOXES AS REQUIRED
- ALL PV DC CONDUCTORS IN CONDUIT EXPOSED TO SUNLIGHT SHALL BE DERATED ACCORDING TO AS PER LATEST NEC CODE.
- EXPOSED ROOF PV DC CONDUCTORS SHALL BE USE-2, 90°C RATED, WET AND UV RESISTANT, AND UL LISTED RATED FOR 600V, UV RATED SPIRAL WRAP SHALL BE USED TO PROTECT WIRE FROM SHARP EDGES
- PHASE AND NEUTRAL CONDUCTORS SHALL BE DUAL RATED THHN/THWN-2 INSULATED, 90°C RATED, WET AND UV RESISTANT, RATED FOR 1000V AS PER APPLICABLE NEC CODE
- 4-WIRE DELTA CONNECTED SYSTEMS HAVE THE PHASE WITH THE HIGHER VOLTAGE TO GROUND MARKED ORANGE OR IDENTIFIED BY OTHER EFFECTIVE **MEANS**
- ALL SOURCE CIRCUITS SHALL HAVE INDIVIDUAL SOURCE CIRCUIT PROTECTION
- VOLTAGE DROP LIMITED TO 2%
- AC CONDUCTORS >4AWG COLOR CODED OR MARKED: PHASE A OR L1- BLACK, PHASE B OR L2- RED, PHASE C OR L3- BLUE, NEUTRAL- WHITE/GRAY
- AC CONDUCTORS >4AWG COLOR CODED OR MARKED: PHASE AOR L1- BLACK, PHASE B OR L2- RED, PHASE C OR L3- BLUE, NEUTRAL- WHITE/GRAY

THIS PLAN HAS BEEN ELECTRONICALLY SIGNED AND SEALED BY SCOTT WYSSLING, PE USING A DIGITAL SIGNATURE AND DATE. PRINTED COPIES OF THIS DOCUMENT ARE NOT CONSIDERED SIGNED AND SEALED AND THE SIGNATURE MUST BE VERIFIED

ON ANY ELECTRONIC COPIES

SHEET INDEX PV-0 COVER PAGE PV-1 SITE PLAN PV-2 **ROOF PLAN & MODULES** PV-3-4 ATTACHMENT DETAILS

SYSTEM RATING

10.56 kWDC

6.96 kWAC


PV-5 **ELECTRICAL LINE & CALCS** PV-6 **ELECTRICAL PHOTOS** PV-7 SPECIFICATIONS & NOTES PV-8 **LABELS** PV-9 JOB HAZARD ANALYSIS PV-10+ **EQUIPMENT SPECIFICATIONS**



HOUSE PHOTO PV-0

SCALE: NTS

SCALE: NTS

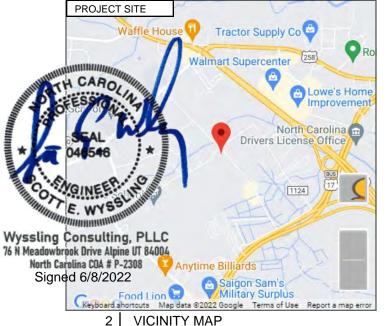

PV-0

DATE: 6/7/2022

SHEET NAME

4 LGCY POWER

LGCY POWER

3333 DIGITAL DR#600, LEHI.

PHONE: (855) 353-4899

Flectrical LIC#: U3487:

SYSTEM INFO

(24) APTOS DNA-120-MF10-440W

(24) ENPHASE

DC SYSTEM SIZE: 10.56 kWDC

AC SYSTEM SIZE: 6.96 kWAC

REVISIONS

Signature with Seal

PROJECT NAME & ADDRESS

RD, US/

SCHOOL

CREEK

BLUE

RICHARDS DENCE

KENNETH R RESIDE

28540,

S

KSONVILLE,

JAC

PHONE NO.

karichards0311@gmail

 $\overset{\cdot \cdot }{\subseteq }$

EMAIL

DATE

DESCRIPTION

UT 84043, UNITED STATES

COVER PAGE

SHEET SIZE


ANSI B 11" X 17'


SHEET NUMBER

SITE NOTES

- A LADDER SHALL BE IN PLACE FOR INSPECTION IN COMPLIANCE WITH OSHA REGULATIONS.
- THE PV MODULES ARE CONSIDERED NON-COMBUSTIBLE AND THIS SYSTEM IS AN UTILITY INTERACTIVE SYSTEM WITH NO STORAGE BATTERIES.
- THE SOLAR PV INSTALLATION SHALL NOT OBSTRUCT ANY PLUMBING, MECHANICAL, OR BUILDING ROOF VENTS.
- PROPER ACCESS AND WORKING CLEARANCE AROUND EXISTING AND PROPOSED ELECTRICAL EQUIPMENT WILL BE PROVIDED AS PER SECTION [NEC 110.26]

(E) DETACH

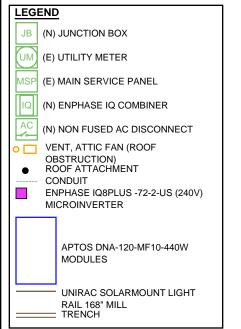

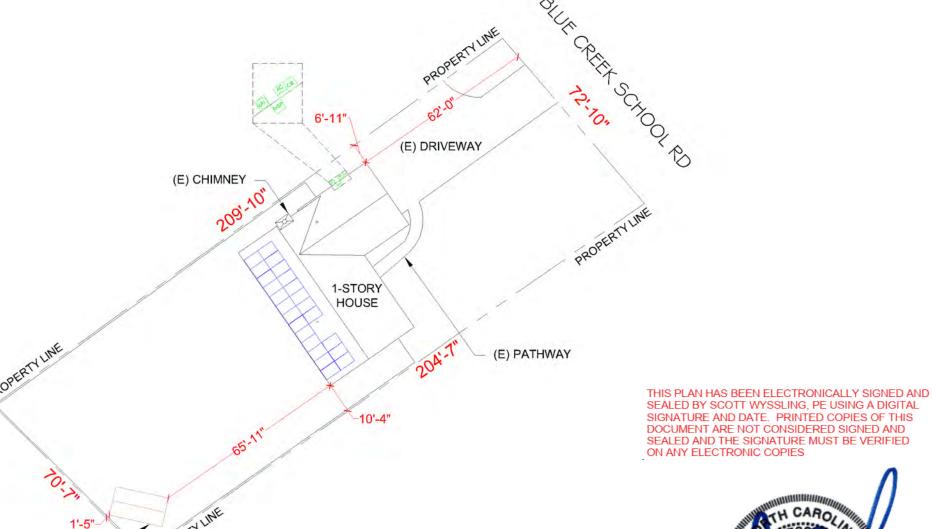

SIGNATURE AND DATE. PRINTED COPIES OF THIS DOCUMENT ARE NOT CONSIDERED SIGNED AND SEALED AND THE SIGNATURE MUST BE VERIFIED ON ANY ELECTRONIC COPIES



Wyssling Consulting, PLLC 76 N Meadowbrook Drive Alpine UT 84004 North Carolina COA # P-2308 Signed 6/8/2022

4 LGCY POWER

LGCY POWER

3333 DIGITAL DR#600, LEHI, UT 84043, UNITED STATES PHONE: (855) 353-4899



Electrical LIC#: U34871

| SYSTEM INFO |
|---|
| (24) APTOS DNA-120-MF10-440W |
| (24) ENPHASE IQ8PLUS -72-2-US (240V) |
| DC SYSTEM SIZE: 10.56 kWDC |
| AC SYSTEM SIZE: 6.96 kWAC |
| |

| REVISIONS | | | | | |
|------------|------|-----|--|--|--|
| ESCRIPTION | DATE | REV | | | |
| | | | | | |
| | | | | | |
| | | | | | |

Signature with Seal

PROJECT NAME & ADDRESS

221 BLUE CREEK SCHOOL RD, JACKSONVILLE, NC 28540, USA PHONE NO. (254) 291-4657 EMAIL ID: karichards0311@gmail. KENNETH RICHARDS RESIDENCE

DATE: 6/7/2022

SHEET NAME SITE PLAN

SHEET SIZE


ANSI B 11" X 17"

SHEET NUMBER

| DESIGN SPECIFICA | ATION | INVERT | TER SPECIFICATIONS | |
|----------------------------------|----------------------|--|---|--|
| RISK CATEGORY: | II | MANUFACTURER / | ENPHASE IQ8PLUS -72-2-US | |
| CONSTRUCTION: | SFD | MODEL | (240V) | |
| ZONING: | RESIDENTIAL | MAX DC SHORT | 15 A | |
| SNOW LOAD (ASCE7-10): | 10 PSF | CIRCUIT CURRENT | | |
| EXPOSURE CATEGORY: | С | CONTINUOUS | 1.21 A | 10 D |
| WIND SPEED (ASCE7-10): | 140 MPH | OUTPUT CURRENT | | |
| | | | | On To |
| | ROOF DESCRIPTIO | | | |
| ROOF ROOF AZIMUTH TILT | TRUSS TRUSS | S ROOF MATERIA | AL | |
| #1 26° 235° | 2" x 4" 24" o.d | c. COMP SHINGL | E | THOU AS CHOOL BY SCHOOL BY |
| ARRAY AREA | & ROOF AREA CA | ALC's | | The state of the s |
| ROOF # OF MODULE | | RAY AREA (Sq. Ft.) | | |
| #1 24 | | 557.53 | | |
| (TOTAL ARRAY AREA/TOTAL R | ROOF ARFA) X 100 | | | |
| = (557.53/2297.31) X 100% = 24. | | | | |
| MODULE TYPE, DIM | | LHT | | |
| | 4 MODULES | ,,,,,,,,,,,,,,,,,,,,,,,,,,,,,,,,,,,,,, | | |
| | PTOS DNA-120-MF | =10-440W | | |
| | | - 10-44000 | | |
| | 2.9 LBS | 00.05 | | |
| | 4.92" X 44.65" = 23. | .23 5F | | × / · · · · · · · · · · · · · · · · · · |
| | .28 PSF | | | 0. |
| LEGEND | | | | 12. X |
| JB (N) JUNCTION BOX | | | Λ | |
| UM (E) UTILITY METER | | anti- | MANUAL INC. | |
| MSP (E) MAIN SERVICE PANEL | | T | CARO | |
| | | | ESSIGNA | |
| (N) ENPHASE IQ COMBINE | R | | | |
| (N) NON FUSED AC DISCO | NNECT | | SEAL | 200F #10 235 |
| VENT, ATTIC FAN (ROOF | | * La | 04 6 5 4 6 * * | ROOF 126 1 |
| OBSTRUCTION) ROOF ATTACHMENT | | 16 LA | | AZIM. |
| CONDUIT ENPHASE IQ8PLUS -72-2-1 | JUS (240V) | M.C. W. | GINEET HA | |
| MICROINVERTER | (2707) | "mm" | GINEER LANGUE | |
| | | | | |
| APTOS DNA-120-MF10 | D-440\W | 76 N Meadowhro | Consulting, PLLC ook Drive Alpine UT 84004 olina COA # P-2308 | Z Zo la |
| MODULES | | North Car | olina COA # P-2308 | |
| | | Signe | ed 6/8/2022 | |
| UNIRAC SOLARMOUN' RAIL 168" MILL | IT LIGHT | | | THE ROLL IN THE RO |
| TRENCH | | . <u></u> | | |
| PANEL HEIGHT OFF ROOF | 5" | | EEN ELECTRONICALLY SIGNED A T WYSSLING, PE USING A DIGITA | |
| | | SIGNATURE AND | DATE. PRINTED COPIES OF THIS | |
| | | SEALED AND THE | NOT CONSIDERED SIGNED AND SIGNATURE MUST BE VERIFIED | |
| | | ON ANY ELECTRO | ONIC COPIES | |
| | | | | |
| | | | | 0,1 |
| | | | | x.2° |
| | | | | |
| | | | | 17:3" |
| | | | | 17:3 |
| | | | | |
| | | | | γ^{*} |
| | | | | |

♦ LGCY POWER

LGCY POWER 3333 DIGITAL DR#600, LEHI, UT 84043, UNITED STATES PHONE: (855) 353-4899

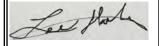

Electrical LIC#: U34871

| SYSTEM INFO |
|---|
| (24) APTOS DNA-120-MF10-440W |
| (24) ENPHASE IQ8PLUS -72-2-US (240V) |
| DC SYSTEM SIZE: 10.56 kWDC |
| AC SYSTEM SIZE: 6.96 kWAC |

| REVISIONS | | | | | | |
|------------|------|-----|--|--|--|--|
| ESCRIPTION | DATE | REV | | | | |
| | | | | | | |
| | | | | | | |
| | | | | | | |

Signature with Seal

PROJECT NAME & ADDRESS

221 BLUE CREEK SCHOOL RD, JACKSONVILLE, NC 28540, USA PHONE NO. (254) 291-4657 EMAIL ID: karichards0311@gmail.com KENNETH RICHARDS RESIDENCE

DATE: 6/7/2022


SHEET NAME

ROOF PLAN & MODULES

SHEET SIZE

ANSI B 11" X 17"

SHEET NUMBER

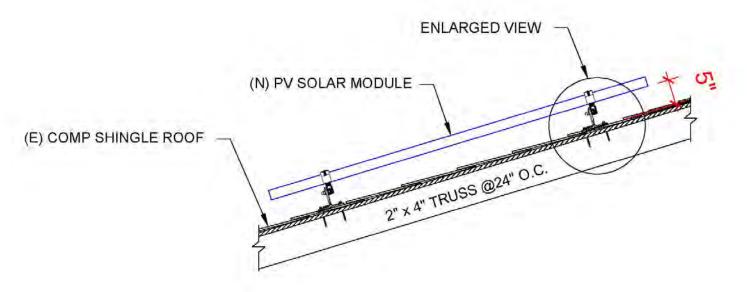


1 ATTACHMENT DETAILS

THIS PLAN HAS BEEN ELECTRONICALLY SIGNED AND SEALED BY SCOTT WYSSLING, PE USING A DIGITAL SIGNATURE AND DATE. PRINTED COPIES OF THIS DOCUMENT ARE NOT CONSIDERED SIGNED AND SEALED AND THE SIGNATURE MUST BE VERIFIED ON ANY ELECTRONIC COPIES



Wyssling Consulting, PLLC 76 N Meadowbrook Drive Alpine UT 84004 North Carolina COA # P-2308 Signed 6/8/2022

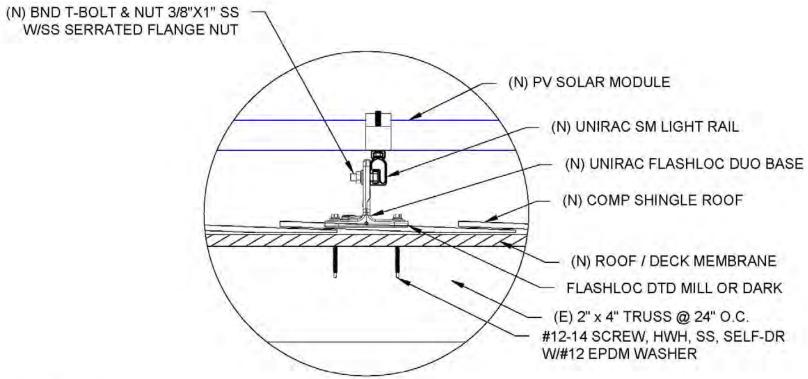


2 ENLARGED VIEW OF ATTACHMENT

SCALE: NTS

4 LGCY POWER

LGCY POWER

3333 DIGITAL DR#600, LEHI, UT 84043, UNITED STATES PHONE: (855) 353-4899

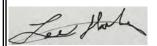

Electrical LIC#: U34871

| SYST | TEM INFO |
|---------------------|---------------------------|
| (24) DNA-120 | APTOS 0-MF10-440W |
| (24) E IQ8PLUS - | ENPHASE 72-2-US (240V) |
| DC SYSTEM | SIZE: 10.56 kWDC |
| AC SYSTEM | SIZE: 6.96 kWAC |
| | • |

| REV | /ISIONS | |
|-------------|---------|-----|
| DESCRIPTION | DATE | REV |
| | | |
| | | |
| | | |

Signature with Seal

PROJECT NAME & ADDRESS

KENNETH RICHARDS RESIDENCE 221 BLUE CREEK SCHOOL RD, JACKSONVILLE, NC 28540, USA PHONE NO. (254) 291-4657 EMAIL ID: karichards0311@gmail.com

DATE: 6/7/2022


SHEET NAME

ATTACHMENT DETAILS

SHEET SIZE

ANSI B 11" X 17"

SHEET NUMBER

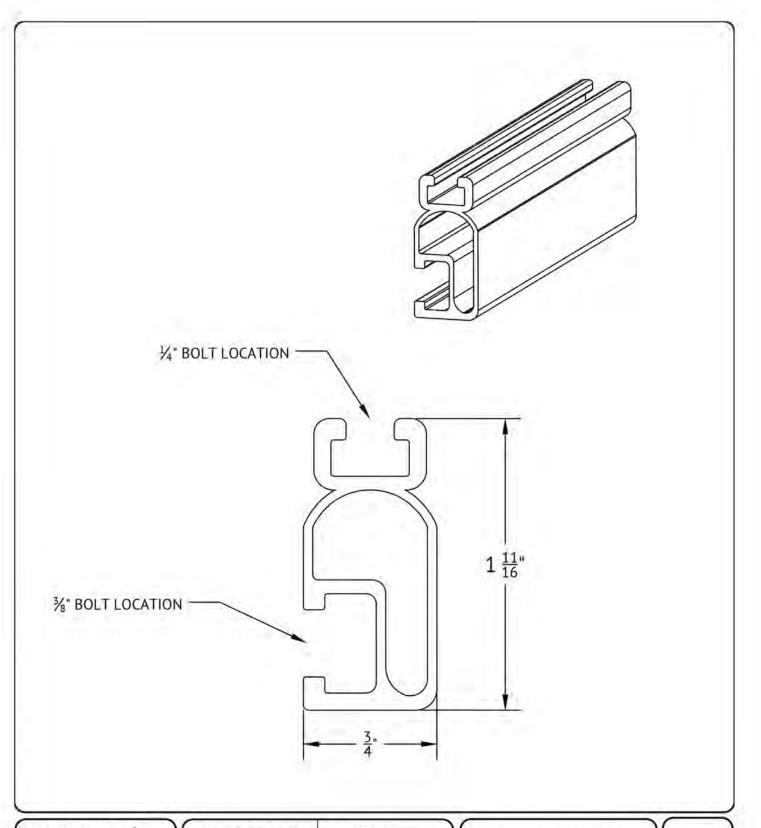

THIS PLAN HAS BEEN ELECTRONICALLY SIGNED AND SEALED BY SCOTT WYSSLING, PE USING A DIGITAL SIGNATURE AND DATE. PRINTED COPIES OF THIS DOCUMENT ARE NOT CONSIDERED SIGNED AND SEALED AND THE SIGNATURE MUST BE VERIFIED ON ANY ELECTRONIC COPIES



Wyssling Consulting, PLLC 76 N Meadowbrook Drive Alpine UT 84004 North Carolina COA # P-2308 Signed 6/8/2022

Electrical LIC#: U34871

4 LGCY POWER **LGCY POWER** 3333 DIGITAL DR#600, LEHI, UT 84043, UNITED STATES PHONE: (855) 353-4899

SYSTEM INFO (24) APTOS DNA-120-MF10-440W (24) ENPHASE IQ8PLUS -72-2-US (240V) DC SYSTEM SIZE: 10.56 kWDC AC SYSTEM SIZE: 6.96 kWAC

REVISIONS DESCRIPTION DATE

Signature with Seal

PROJECT NAME & ADDRESS

221 BLUE CREEK SCHOOL RD, JACKSONVILLE, NC 28540, USA PHONE NO. (254) 291-4657 EMAIL ID: karichards0311@gmail.com KENNETH RICHARDS RESIDENCE

DATE: 6/7/2022

SHEET NAME

ATTACHMENT DETAILS

SHEET SIZE

ANSI B 11" X 17"

SHEET NUMBER

PV-4

#UNIRAC

1411 BROADWAY BLVD NE ALBUQUERQUE, NM 87102 USA

WWW.UNIRAC.COM

SOLARMOUNT PRODUCT LINE: PART DETAIL DRAWING TYPE: LIGHT RAIL DESCRIPTION: **REVISION DATE:** APRIL 2016

DRAWING NOT TO SCALE ALL DIMENSIONS ARE NOMINAL

PRODUCT PROTECTED BY ONE OR MORE US PATENTS

LEGAL NOTICE

SHEET

SM-P02

| ID | TYPI | ICAL | INITIAL CONDUCTOR LOCATION | FINAL CONDUCTOR LOCATION | | CONDUCTOR | | CONDUIT | # OF PARALLEL CIRCUITS | CURRENT-CARRYING CONDUCTORS IN CIRCUIT | CONDUIT FILL PERCENT | OCPD | EC | GC | TEMP. FAC | CORR. TOR | CONDUIT FILL FACTOR | CONT. CURRENT | MAX. CURRENT | BASE AMP. | DERATED AMP. | TERM. TEMP. RATING | LENGTH | VOTAGE DROP | 47 I |
|----|------|------|-------------------------------|-----------------------------|------------|-----------|--------|-----------------------|------------------------------|--|----------------------------|------|--------|------------------|--------------|--------------|---------------------------|------------------|-----------------|--------------|-----------------|--------------------------|--------|----------------|--------------|
| 1 | 2 | 2 | ARRAY | JUNCTION BOX | 12 AWG | Q CABLE | i | 1 | 1 | 2 | N/A | N/A | 6 AWG | BARE COPPER | 0.71 | (56°C) | N/A | 14.52A | 18.15A | N/A | N/A | 90°C | 58FT | 0.65% | |
| 2 | 1 | 1 | JUNCTION BOX | JUNCTION BOX 1 | 12-2 GAUGE | ROMEX | - | - | 1 | 2 | N/A | N/A | 6 AWG | BARE COPPER | 0.71 | (56°C) | N/A | 14.52A | 18.15A | N/A | N/A | 90°C | 40FT | 0.65% | 3333 UT 8 |
| 3 | 1 | 1 | JUNCTION BOX 1 | IQ COMBINER BOX | 10 AWG | THWN 2 | COPPER | MIN 0.75" DIA EMT" | 2 | 4 | 24.20% | 20A | 10 AWG | THWN-2 COPPER | 0.96 | (34°C) | 0.8 | 14.52A | 18.15A | 40A | 30.72A | 90°C | 12FT | 0.19% | Pł |
| 4 | 1 | 1 | IQ COMBINER BOX | NON FUSED AC DISCONNECT | 8 AWG | THWN 2 | COPPER | MIN 0.75" DIA EMT" | 1 | 3 | 29.46% | N/A | 10 AWG | THWN-2 COPPER | 0.96 | (34°C) | 1 | 29.04A | 36.3A | 55A | 52.80A | 90°C | 5FT | 0.10% | |
| 5 | 1 | 1 | NON FUSED AC DISCONNECT | MSP | 8 AWG | THWN 2 | COPPER | MIN 0.75" DIA EMT" | 1 | 3 | 29.46% | 40A | 10 AWG | THWN-2 COPPER | 0.96 | (34°C) | 1 | 29.04A | 36.3A | 55A | 52.80A | 90°C | 5FT | 0.10% | 7 |



LGCY POWER LGCY POWER

Electrical LIC#: U34871

SYSTEM INFO (24) APTOS DNA-120-MF10-440W (24) ENPHASE IQ8PLUS -72-2-US (240V) DC SYSTEM SIZE: 10.56 kWDC AC SYSTEM SIZE: 6.96 kWAC

| REVISIONS | | | | | | |
|------------|------|-----|--|--|--|--|
| ESCRIPTION | DATE | REV | | | | |
| | | | | | | |
| | | | | | | |

Signature with Seal

PROJECT NAME & ADDRESS

PHONE NO. (254) 291-4657 EMAIL ID: karichards0311@gmail.com

221 BLUE CREEK SCHOOL RD, JACKSONVILLE, NC 28540, USA KENNETH RICHARDS RESIDENCE

DATE: 6/7/2022

SHEET NAME


ELECTRICAL LINE & CALCS.

SHEET SIZE

ANSI B 11" X 17"

SHEET NUMBER

PV-5

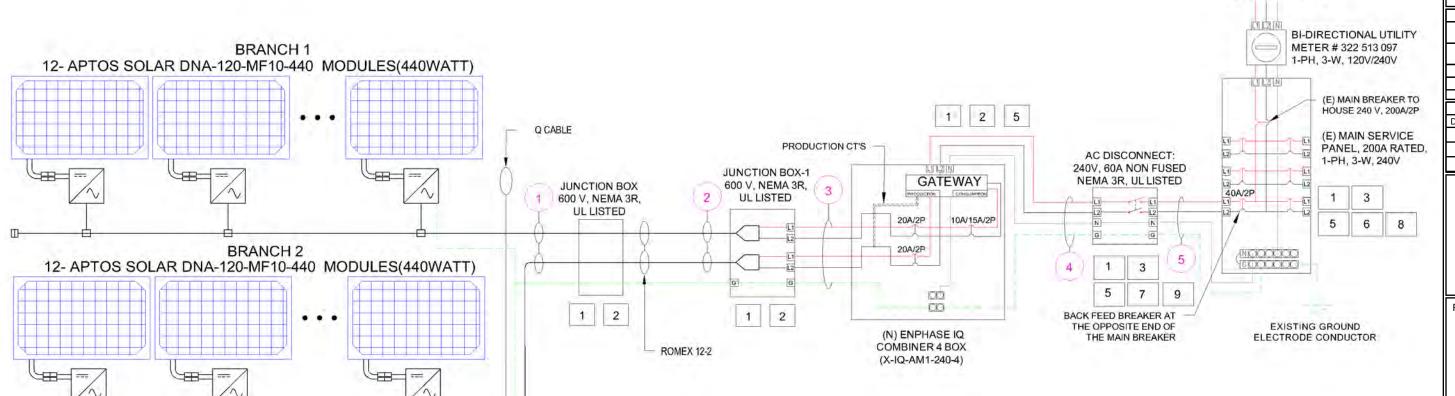

INTERCONNECTION 120% RULE - NEC 705.12(B)(2)(3)(b)

| UTILITY FEED + SOLAR BACKFEE 200A + 40A = 240A |
|---|
| BUSS RATING X 120% 200A x 120% = 240A |


SCALE: NTS

(24) ENPHASE IQ8PLUS-72-2-US MICROINVERTERS(290V)

BRANCH TERMINATOR Q-TERM FOR IQ SERIES (TYP.)


| | SERVICE INFO | | | | | |
|---|--------------------------|-------------|-----|--|--|--|
| | UTILITY PROVIDER: | DUKE ENERGY | | | | |
| | AHJ NAME: ONSLOW COUNTY | | ╎╽┌ | | | |
| | MAIN SERVICE VOLTAGE: | 240V | | | | |
| | MAIN PANEL BRAND: | GE | | | | |
| | MAIN SERVICE PANEL: 200A | | L | | | |
| | MAIN BREAKER RATING: | 200A | | | | |
| _ | MAIN SERVICE LOCATION: | NORTH | | | | |
| | SERVICE FEED SOURCE: | UNDERGROUND | | | | |

TO UTILITY GRID

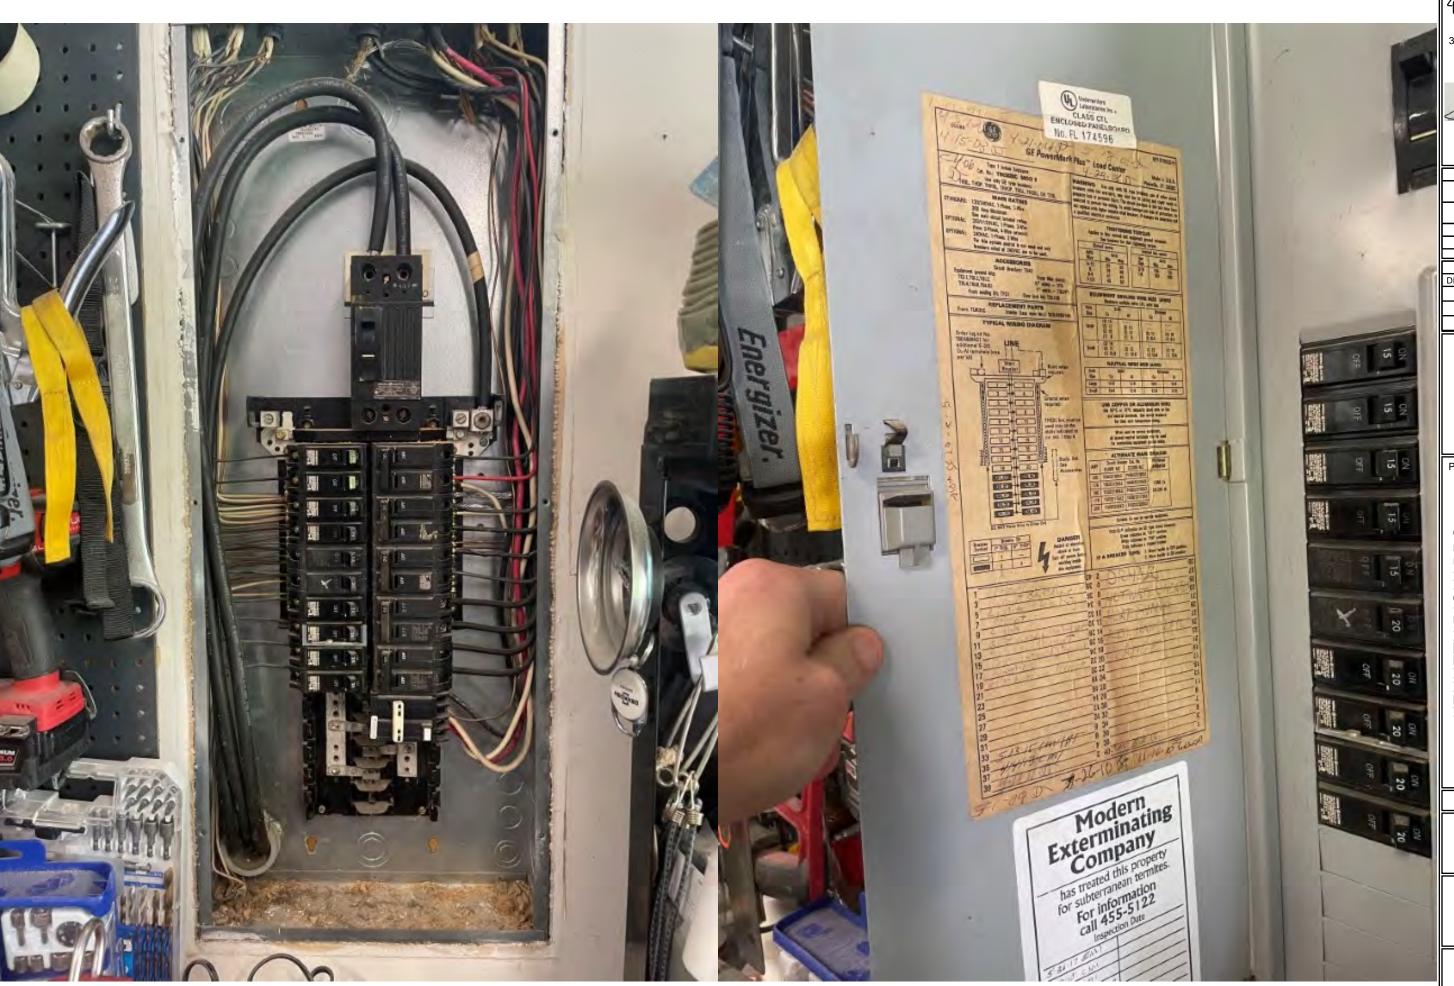

♦ LGCY POWER

LGCY POWER 3333 DIGITAL DR#600, LEHI, UT 84043, UNITED STATES PHONE: (855) 353-4899

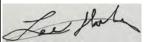

Electrical LIC#: U34871

| SYSTEM INFO |
|---|
| (24) APTOS DNA-120-MF10-440W |
| (24) ENPHASE IQ8PLUS -72-2-US (240V) |
| DC SYSTEM SIZE: 10.56 kWDC |
| AC SYSTEM SIZE: 6.96 kWAC |
| |

| REVISIONS | | | |
|------------|------|-----|--|
| ESCRIPTION | DATE | REV | |
| | | | |
| | | | |
| | | | |

Signature with Seal

PROJECT NAME & ADDRESS

221 BLUE CREEK SCHOOL RD, JACKSONVILLE, NC 28540, USA KENNETH RICHARDS RESIDENCE

DATE: 6/7/2022

SHEET NAME

ELECTRICAL PHOTOS

SHEET SIZE

ANSI B 11" X 17"

SHEET NUMBER

| SOLAR MODULE SPECIFICATIONS | | |
|-----------------------------|-------------------------|--|
| MANUFACTURER / MODEL | APTOS DNA-120-MF10-440W | |
| VMP | 33.82 V | |
| IMP | 13.01 A | |
| VOC | 40.8 V | |
| ISC | 13.61 A | |
| TEMP. COEFF. VOC | -0.31%/K | |
| PTC RATING | 406 W | |
| MODULE DIMENSION | 74.92"(L) x 44.65"(W) | |
| PANEL WATTAGE | 440 W | |
| | | |

| INVERTER SPECIFICATIONS | | |
|------------------------------|---------------------------------|--|
| MANUFACTURER / MODEL | ENPHASE IQ8PLUS -72-2-US (240V) | |
| MAX DC SHORT CIRCUIT CURRENT | 15 A | |
| CONTINUOUS OUTPUT CURRENT | 1.21 A | |

| AMBIENT TEMPERATURE SPECS | | |
|---------------------------------------|----------|--|
| RECORD LOW TEMP | -9°C | |
| AMBIENT TEMP (HIGH TEMP 2%) | 34°C | |
| CONDUIT HEIGHT | 7/8" | |
| ROOF TOP TEMP | 90°C | |
| CONDUCTOR TEMPERATURE RATE | 56°C | |
| MODULE TEMPERATURE COEFFICIENT OF VOC | -0.31%/K | |

| PERCENT OF VALUES | NUMBER OF CURRENT CARRYING CONDUCTORS IN EMT |
|-------------------|---|
| 0.80 | 4-6 |
| 0.70 | 7-9 |
| 0.50 | 10-20 |

<u>Voltage rise in Q Cable from the Microinverters to the Junction Box</u>

For branch circuit #1 of 12 IQ 8+ Micros, the voltage rise on the 240 VAC Q Cable is 0.65% For branch circuit #2 of 12 IQ 8+ Micros, the voltage rise on the 240 VAC Q Cable is 0.65%

Voltage rise from the Junction Box 1 to the IQ Combiner Box

VRise = (amps/inverter x number of inverters) x (resistance in ohms/ft.) x (2-way wire length in ft.)

- = (1.21 amp x 12) x (0.00129 ohms/ft) x (12 ft x 2)
- $= 14.52 \text{ amps } \times 0.00129 \text{ ohms/ft} \times 24 \text{ ft}$
- = 0.45 volts

 $%VRise = 0.45 \text{ volts} \div 240 \text{ volts} = 0.19\%$

The voltage rise from the Junction Box 1 to the IQ Combiner Box is 0.19%

<u>Voltage rise from the IQ Combiner Box to the Non Fused AC Disconnect</u>

VRise = (amps/inverter x number of inverters) x (resistance in ohms/ft.) x (2-way wire length in ft.)

- = (1.21 amp x 24) x (0.000809 ohms/ft) x (5 ft x 2)
- $= 29.04 \text{ amps } \times 0.000809 \text{ ohms/ft} \times 10 \text{ ft}$
- = 0.23 volts

 $%VRise = 0.23 \text{ volts} \div 240 \text{ volts} = 0.10\%$

The voltage rise from the IQ Combiner Box to the Non Fused AC Disconnect is 0.10%

Voltage rise from the Non Fused AC Disconnect to the MSP

VRise = (amps/inverter x number of inverters) x (resistance in ohms/ft.) x (2-way wire length in ft.)

- $= (1.21 \text{ amp x } 24) \times (0.000809 \text{ ohms/ft}) \times (5 \text{ ft x 2})$
- $= 29.04 \text{ amps } \times 0.000809 \text{ ohms/ft} \times 10 \text{ ft}$
- = 0.23 volts

 $%VRise = 0.23 \text{ volts} \div 240 \text{ volts} = 0.10\%$

The voltage rise from the Non Fused AC Disconnect to the MSP is 0.10%

Total system voltage rise for all wire sections

0.65% + 0.19% + 0.1% + 0.1% = 1.04%

4 LGCY POWER

LGCY POWE

3333 DIGITAL DR#600, LEHI, UT 84043, UNITED STATES PHONE: (855) 353-4899



Electrical LIC#: U348

| SYSTEM INFO |
|---|
| (24) APTOS DNA-120-MF10-440W |
| (24) ENPHASE IQ8PLUS -72-2-US (240V) |
| DC SYSTEM SIZE: 10.56 kWDC |
| AC SYSTEM SIZE: 6.96 kWAC |
| |
| DEVIOLONO |

| REVISIONS | | | |
|-------------|------|-----|--|
| DESCRIPTION | DATE | REV | |
| | | | |
| | | | |
| | | | |

Signature with Seal

PROJECT NAME & ADDRESS

221 BLUE CREEK SCHOOL RD, JACKSONVILLE, NC 28540, USA

DATE: 6/7/2022

SHEET NAME

SPECIFICATIONS & NOTES

SHEET SIZE

ANSI B 11" X 17"

SHEET NUMBER

TERMINALS ON BOTH LINE AND LOAD SIDES MAY BE ENERGIZED IN THE OPEN POSITION

LABEL LOCATION:

MAIN SERVICE PANEL/AC DISCONNECT/AC COMBINER (PER CODE: NEC 706.15(C)(4), 690.13(B), NEC2020)

2

WARNING PHOTOVOLTAIC POWER SOURCE

LABEL LOCATION:

DC CONDUIT

EVERY 10' AND ON CONDUIT BODIES WHEN EXPOSED (PER CODE: NEC2020 690.31(O)(2), 690.31(D)(2), NEC2020)

3

PHOTOVOLTAIC AC DISCONNECT
RATED AC OUTPUT CURRENT 29.04 A
NOMINAL OPERATING AC VOLTAGE 240 VAC

LABEL LOCATION:

MAIN SERVICE PANEL/AC DISCONNECT 690.54, NEC2020

4

RAPID SHUTDOWN SWITCH FOR SOLAR PV SYSTEM

LABEL LOCATION:

INVERTER
AT OR WITHIN 3' OF THE DC COMBINER
SWITCH

PER CODE: NEC 690.56(C)(2), NEC2020

5



DUAL POWER SOURCE SECOND SOURCE IS PHOTOVOLTAIC SYSTEM

LABEL LOCATION:


MAIN SERVICE PANEL/AC DISCONNECT/AC COMBINER/REVENUE METER 2020 NEC 705.12(C) & NEC 690.59

ADHESIVE FASTENED SIGNS:

- ANSI Z535.4-2011 PRODUCT SAFETY SIGNS AND LABELS, PROVIDES GUIDELINES FOR SUITABLE FONT SIZES, WORDS, COLORS, SYMBOLS, AND LOCATION REQUIREMENTS FOR LABELS. NEC 110.21(B)(1)
- THE LABEL SHALL BE OF SUFFICIENT DURABILITY TO WITHSTAND THE ENVIRONMENT INVOLVED. NEC 110.21(B)(3)
- ADHESIVE FASTENED SIGNS MAY BE ACCEPTABLE IF PROPERLY ADHERED. VINYL SIGNS SHALL BE WEATHER RESISTANT.

SOLAR PV SYSTEM EQUIPPED WITH RAPID SHUTDOWN

TURN RAPID
SHUTDOWN SWITCH
TO THE 'OFF'
POSITION TO SHUT
DOWN PV SYSTEM
AND REDUCE
SHOCK HAZARD IN
THE ARRAY

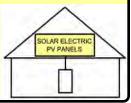

MAIN SERVICE PANEL
IF MSD IS OUTSIDE PLACE IT THERE / IF
MSD IS INSIDE PLACE ON THE AC DISCONNECT
PER CODE: IFC 605.11.3.1(1) & NEC 690.56(C), NEC2020

7

PHOTOVOLTAIC SYSTEM UTILITY DISCONNECT SWITCH

LABEL LOCATION: AC DISCONNECT 2020 NEC 690.13(B)

8

PV SOLAR BREAKER

DO NOT RELOCATE THIS OVERCURRENT DEVICE


LABEL LOCATION:

MAIN SERVICE PANEL 2020 NEC 705.12 (B)(3)(2) 9 SERVICE DISCONNECT

SECTIONNEUR PRINCIPALE

SERVICIO DE DESCONEXION

LABEL LOCATION: AC DISCONNECT 2020 NEC 230.66

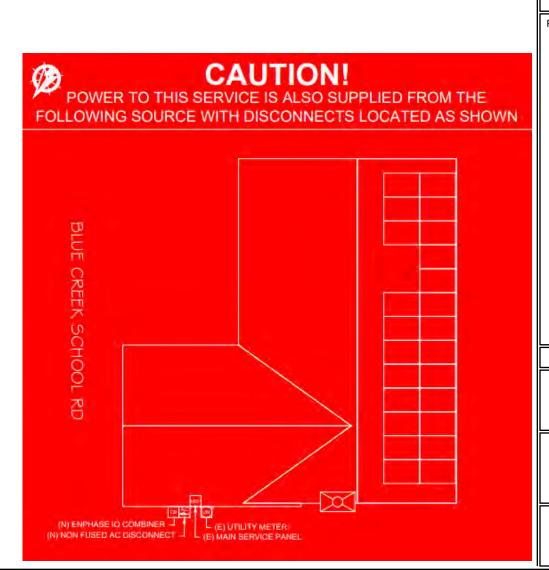

4 LGCY POWER

LGCY POWER

3333 DIGITAL DR#600, LEHI, UT 84043, UNITED STATES PHONE: (855) 353-4899



Electrical LIC#: U34871

(24) APTOS DNA-120-MF10-440W (24) ENPHASE IQ8PLUS -72-2-US (240V) DC SYSTEM SIZE: 10.56 kWDC AC SYSTEM SIZE: 6.96 kWAC

SYSTEM INFO

REVISIONS
DESCRIPTION DATE REV

Signature with Seal

PROJECT NAME & ADDRESS

KENNETH RICHARDS
RESIDENCE
221 BLUE CREEK SCHOOL RD,
JACKSONVILLE, NC 28540, US/
PHONE NO. (254) 291-4657
EMAIL ID: karichards0311@gmail.com

DATE: 6/7/2022

SHEET NAME LABELS

SHEET SIZE

ANSI B 11" X 17'

SHEET NUMBER



FIELD DESIGN REQUEST FORM

| JOB INFORMATION | |
|-----------------|--|
| JOB NAME: | |
| ADDRESS: | |

| CHANGE REQUEST: | | |
|--------------------------------|---------------------------|------|
| WHO AUTHORIZED THE CHANGE: | | |
| DESCRIBE THE NEEDED CHANGE & W | HY: | |
| NEW DESIGN LAYOUT: | | |
| DRAW THE MOUNTING PLANE SHOW | NG THE NEW MODULE LAYOUT: | |
| | | |
| | | |
| NSTALLER NAME (PRINT) | | |
| UNDERSTAND AND AGREE TO THE | CHANGES MADE ABOVE | |
| | | |
| | | |
| | | |
| | | |
| | | |
| CUSTOMER NAME | CUSTOMER SIGNATURE | DATE |



JOB HAZARD ANALYSIS

| CUSTOMER NAME/ | JOB ID: | | | |
|----------------|---------|-------|-------|--|
| CUSTOMER ADDRE | SS: | | | |
| INSTALL DATE: | | TIME: | am/pm | |

| HAZARD CATEGORY | HAZARD TYPE | HAZARD CONTROL MEASURES |
|-----------------------|---|-------------------------|
| LADDER SAFETY | LOCATION CONDITION WORKING CLEARANCE | |
| FALL PROTECTION | WORKING 6' OR HIGHER | |
| ELECTRICAL SAFETY | ARCH FLASH ELECTRIC SHOCK/ELECTROCUTION | |
| WEATHER CONDITIONS | HEAT/COLD TEMP RAINY/ICY/WINDY | |
| PUBLIC SAFETY | WORK/OBJECTS OVERHEAD SLIPS/TRIPS/FALLS ACCESS TO LIVE ELECTRICAL | |

| NEAREST EMERGENCY FACILITY | |
|---|--|
| CONTACT IMMEDIATELY IN EMERGENCY (911 AND/OR) | |

GENERAL SITE DESCRIPTION/NOTES

CREW MEMBERS ON SITE FOR INSTALL

| NAME | SIGNATURE | | |
|----------|-----------|--|--|
| FMU/LMD- | | | |
| | | | |
| | | | |
| | | | |
| | | | |

ELECTRICAL COMPLETION PHOTOS QR CODE



ROOFTOP INSTALLATION PHOTOS QR CODE



MPU COMPLETION PHOTOS QR CODE



4 LGCY POWER

LGCY POWER

3333 DIGITAL DR#600, LEHI, UT 84043, UNITED STATES PHONE: (855) 353-4899

Les Holy

Electrical LIC#: U34871

SYSTEM INFO

(24) APTOS

DNA-120-MF10-440W

(24) ENPHASE

IQ8PLUS -72-2-US (240V)

DC SYSTEM SIZE: 10.56 kWDC

AC SYSTEM SIZE: 6.96 kWAC

REVISIONS
DESCRIPTION DATE REV

Signature with Seal

PROJECT NAME & ADDRESS

KENNETH RICHARDS
RESIDENCE
221 BLUE CREEK SCHOOL RD,
JACKSONVILLE, NC 28540, USA
PHONE NO. (254) 291-4657
EMAIL ID: karichards0311@gmail.com

DATE: 6/7/2022

SHEET NAME

JOB HAZARD ANALYSIS

SHEET SIZE

ANSI B 11" X 17"

SHEET NUMBER

$DN4^{TM}120$


Solar for Innovators



Designed & Engineered in Silicon Valley 440W | 435W | 430W

Our DNA Split Cell Series uses advanced selective emitter PERC technology with thin film layers to improve heat tolerance, increase photon capture, minimize resistive loss, and use 5% more of the available active area for optimal power performance. Our panels exceed IEC standards and come with an industry leading, 30-year warranty.

Linear Performance Warranty

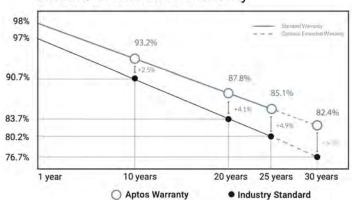

Features



Advanced Technology

Patented DNA™ technology boosts power performance & module efficiency



Maximum Panel Density


Advanced split cell technology with 9 ultra-thin busbars allows for less resistance and more photon capture



Durable Design

Robust product design is resilient in extreme weather. Up to 5400 Pa snow

A Safe Investment

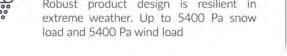




Industry leading 30 year warranty



3140 De La Cruz Blvd., Ste 200 Santa Clara, CA 95054 www.aptossolar.com | info@aptossolar.com

$DNA^{TM}120$

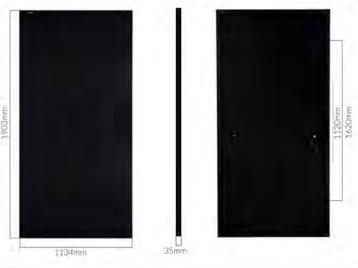

| Electrical Specifications | DNA-120-MF10-440W | DNA-120-MF10-445W | DNA-120-MF10-440W |
|--|----------------------------|-------------------|-------------------|
| STCrated Output P _{eap} (W) | 440W | 445W | 450W |
| Module Efficiency | 20.39% | 20.62% | 20.85% |
| Open Circuit Voltage V _{VDC} (V) | 40.80 | 41.10 | 41.34 |
| Short Circuit Current I _{sc} (A) | 13.61 | 13.70 | 13.80 |
| Rated Voltage V, (V) | 33.82 | 34.02 | 34.16 |
| Rated Voltage I _{max} (A) | 13.01 | 13.09 | 13.17 |
| Standard Test Conditions for Front-face of panels 1000 V | V/m², 25°C, measurement un | certainty < 3% | |


| Temperature Coefficients | | |
|---|-----------|--|
| Temperature Coefficients P _{mmo} | -0.35%/°C | |
| Temperature Coefficients I _{sc} | +0,06%/°C | |
| Temperature Coefficients V _{oc} | -0.31%/°C | |
| Nominal Operating Cell Temperature (NOCT) | 45°C | |
| | | |

| lest Operating Conditions | |
|-------------------------------------|---------------------------------------|
| Maximum Series Fuse | 25A |
| Maximum System Voltage | 1,500 VDC (UL&IEC) |
| Maximum Load Capacity (Per UL 1703) | 5400 PA Snow Load / 5400 Pa Wind Load |
| Fire Performance Class | Class C/Type 1 |
| | |

| Packaging Configuration | |
|---------------------------------------|--------------------|
| Number of Modules per Pallet | 31 |
| Number of Pallets per 40ft. Container | 24 |
| Pallet Dimensions | 2030 X 1220 X 1200 |
| Pallet Weight (kg) | 766 |
| Container Weight (kg) | 18,384 |

| A-A 12:1 | B-B 12:1 |
|-------------|-------------|
| Z | |
| | , |
| | |
| 35 | 18. 4 |

| Cell Type | Monocrystalline |
|--------------|---|
| Glass | 3,2mm, anti-reflection coating, high transmission, low iron, tempered glass |
| Frame | Anodized Aluminum Alloy |
| Junction Box | IP68 |
| Dimensions | 1903 X 1134 X 35 mm |
| Output Cable | 4mm2 (EU)12AWG,39.37in,(1200mm) |
| Weight | 52.9lbs.(24kg) |
| Cable Length | 1200mm |
| Encapsulant | POE |

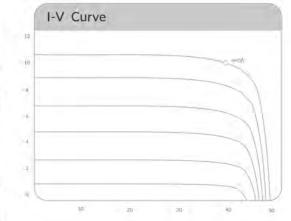





4 LGCY POWER

LGCY POWER

3333 DIGITAL DR#600, LEHI, UT 84043, UNITED STATES PHONE: (855) 353-4899



Electrical LIC#: U34871

| DNA-120-MF10-440W | | | | |
|---|---------|--|--|--|
| (24) ENPHASE IQ8PLUS -72-2-US (240V) | | | | |
| DC SYSTEM SIZE: 10.56 kWDC | | | | |
| AC SYSTEM SIZE: 6.96 kWAC | | | | |
| | | | | |
| REV | /ISIONS | | | |
| DESCRIPTION DATE REV | | | | |
| | | | | |
| | | | | |

SYSTEM INFO

Signature with Seal

PROJECT NAME & ADDRESS

221 BLUE CREEK SCHOOL RD, JACKSONVILLE, NC 28540, USA KENNETH RICHARDS RESIDENCE

DATE: 6/7/2022

SHEET NAME **EQUIPMENT SPECIFICATION**

SHEET SIZE

ANSI B 11" X 17"

SHEET NUMBER







IQ8 and IQ8+ Microinverters

Our newest IQ8 Microinverters are the industry's first microgrid-forming, software-defined microinverters with split-phase power conversion capability to convert DC power to AC power efficiently. The brain of the semiconductor-based microinverter is our proprietary application-specific integrated circuit (ASIC) which enables the microinverter to operate in grid-tied or off-grid modes. This chip is built in advanced 55nm technology with high speed digital logic and has super-fast response times to changing loads and grid events, alleviating constraints on battery sizing for home energy systems.



Part of the Enphase Energy System, IQ8 Series Microinverters integrate with the Enphase IQ Battery, Enphase IQ Gateway, and the Enphase App monitoring and analysis software.



Connect PV modules quickly and easily to IQ8 Series Microinverters using the included Q-DCC-2 adapter cable with plug-n-play MC4 connectors. CERTIFIED

of up to 25 years.

IQ8 Series Microinverters are UL Listed as PV Rapid Shut Down Equipment and conform with various regulations, when installed according to manufacturer's instructions.

IQ8 Series Microinverters redefine reliability

enabling an industry-leading limited warranty

standards with more than one million

cumulative hours of power-on testing,

© 2021 Enphase Energy. All rights reserved. Enphase, the Enphase logo, IQ8 microinverters, and other names are trademarks of Enphase Energy, Inc. Data subject to change.

IQ8SP-DS-0002-01-EN-US-2021-10-19

Easy to install

- Lightweight and compact with plug-n-play connectors
- Power Line Communication (PLC) between components
- Faster installation with simple two-wire cabling

High productivity and reliability

- Produce power even when the grid is down
- More than one million cumulative hours of testing
- Class II double-insulated enclosure
- Optimized for the latest highpowered PV modules

Microgrid-forming

- Complies with the latest advanced grid support
- Remote automatic updates for the latest grid requirements
- Configurable to support a wide range of grid profiles
- Meets CA Rule 21 (UL 1741-SA) requirements

IQ8 and IQ8+ Microinverters

| INPUT DATA (DC) | | 108-60-2-US | 108PLUS-72-2-US |
|--|----|-----------------------|---|
| Commonly used module pairings ¹ | W | 235 – 350 | 235 - 440 |
| Module compatibility | | 60-cell/120 half-cell | 60-cell/120 half-cell and 72-cell/144 half-cell |
| MPPT voltage range | y | 27 – 37 | 29 - 45 |
| Operating range | ٧ | 25 - 48 | 25 - 58 |
| Min/max start voltage | V | 30 / 48 | 30 / 58 |
| Max input DC voltage | V | 50 | 60 |
| Max DC current ² [module lsc] | A | | 15 |
| Overvoltage class DC port | | | II . |
| DC port backfeed current | mA | | 0 |

PV array configuration 1x1 Ungrounded array; No additional DC side protection required; AC side protection requires max 20A per branch circuit

| OUTPUT DATA (AC) | | 108-60-2-US | | 108PLUS-72-2-US |
|--|------------------|-------------|-----------------------------|-----------------|
| Peak output power | VA | 245 | | 300 |
| Max continuous output power | VA | 240 | | 290 |
| Nominal (L-L) voltage/range ³ | V | | 240 / 211 - 264 | |
| Max continuous output current | A | 1.0 | | 1.21 |
| Nominal frequency | Hz | | 60 | |
| Extended frequency range | Hz | | 50 - 68 | |
| Max units per 20 A (L-L) branch circ | uit ⁴ | 16 | | 13 |
| Total harmonic distortion | | | <5% | |
| Overvoltage class AC port | | | W | |
| AC port backfeed current | mA | | 30 | |
| Power factor setting | | | 1.0 | |
| Grid-tied power factor (adjustable) | | | 0.85 leading - 0.85 lagging | |
| Peak efficiency | % | 97.5 | | 97.6 |
| CEC weighted efficiency | % | 97 | | 97 |
| Night-time power consumption | mW | | 60 | |

| MECHANICAL DATA | |
|--|--|
| Ambient temperature range | -40°C to +60°C (-40°F to +140°F) |
| Relative humidity range | 4% to 100% (condensing) |
| DC Connector type | MC4 |
| Dimensions (HxWxD) | 212 mm (8.3") x 175 mm (6.9") x 30.2 mm (1.2") |
| Weight | 1.08 kg (2.38 lbs) |
| Cooling | Natural convection - no fans |
| Approved for wet locations | Yes |
| Acoustic noise at 1 m | <60 dBA |
| Pollution degree | PD3 |
| Enclosure | Class II double-insulated, corrosion resistant polymeric enclosure |
| Environ. category / UV exposure rating | NEMA Type 6 / outdoor |

Environ. category / UV exposure rating

COMPLIANCE

CA Rule 21 (UL 1741-SA), UL 62109-1, UL1741/IEEE1547, FCC Part 15 Class B, ICES-0003 Class B, CAN/CSA-C22.2 NO. 107.1-01

Certifications

This product is UL Listed as PV Rapid Shut Down Equipment and conforms with NEC 2014, NEC 2017, and NEC 2020 section 690.12 and C22.1-2018 Rule 64-218 Rapid Shutdown of PV Systems, for AC and DC conductors, when installed according to manufacturer's instructions.

(1) No enforced DC/AC ratio. See the compatibility calculator at https://link.enphase.com/module-compatibility (2) Maximum continuous input DC current is 10.6A (3) Nominal voltage range can be extended beyond nominal if required by the utility. (4) Limits may vary. Refer to local requirements to define the number of microinverters per branch in your area.

IQ8SP-DS-0002-01-EN-US-2021-10-19

4 LGCY POWER

LGCY POWER

3333 DIGITAL DR#600, LEHI, UT 84043, UNITED STATES PHONE: (855) 353-4899



Electrical LIC#: U34871

| SYSTEM INFO |
|---|
| (24) APTOS DNA-120-MF10-440W |
| (24) ENPHASE IQ8PLUS -72-2-US (240V) |
| DC SYSTEM SIZE: 10.56 kWDC |
| AC SYSTEM SIZE: 6.96 kWAC |
| |
| DEVISIONS. |

| REVISIONS | | | |
|-------------|------|-----|--|
| DESCRIPTION | DATE | REV | |
| | | | |
| | | | |
| | | | |

Signature with Seal

PROJECT NAME & ADDRESS

KENNETH RICHARDS
RESIDENCE
221 BLUE CREEK SCHOOL RD,
JACKSONVILLE, NC 28540, USA
PHONE NO. (254) 291-4657
EMAIL ID: karichards0311@gmail.com

DATE: 6/7/2022

SHEET NAME

EQUIPMENT SPECIFICATION

SHEET SIZE

ANSI B 11" X 17"

SHEET NUMBER

Data Sheet Enphase Networking

Enphase IQ Combiner 4/4C

X-IQ-AM1-240-4 X-IQ-AM1-240-4C



X-IQ-AM1-240-4

To learn more about Enphase offerings, visit enphase.com

LISTED

The Enphase IQ Combiner 4/4C with Enphase IQ Gateway and integrated LTE-M1 cell modem (included only with IQ Combiner 4C) consolidates interconnection equipment into a single enclosure and streamlines IQ microinverters and storage installations by providing a consistent, pre-wired solution for residential applications. It offers up to four 2-pole input circuits and Eaton BR series busbar assembly.

Smart

- · Includes IQ Gateway for communication and control
- Includes Enphase Mobile Connect cellular modem (CELLMODEM-M1-06-SP-05), included only with IQ Combiner 4C
- Includes solar shield to match Enphase IQ Battery aesthetics and deflect heat
- Flexible networking supports Wi-Fi, Ethernet, or cellular
- · Optional AC receptacle available for PLC bridge
- Provides production metering and consumption monitoring

Simple

- Centered mounting brackets support single stud mounting
- · Supports bottom, back and side conduit entry
- Up to four 2-pole branch circuits for 240 VAC plug-in breakers (not included)
- 80A total PV or storage branch circuits

Reliable

- Durable NRTL-certified NEMA type 3R enclosure
- Five-year limited warranty
- Two years labor reimbursement program coverage included for both the IQ Combiner SKU's
- · UL listed



Enphase IQ Combiner 4/4C

| MODEL NUMBER | |
|---|--|
| IQ Combiner 4 (X-IQ-AM1-240-4) | IQ Combiner 4 with Enphase IQ Gateway printed circuit board for integrated revenue grade PV production metering (AN C12.20 +/-0.5%) and consumption monitoring (+/-2.5%), includes a silver solar shield to match the IQ Battery system a IQ System Controller 2 and to deflect heat. |
| IQ Combiner 4C (X-IQ-AM1-240-4C) | IQ Combiner 4C with Enphase IQ Gateway printed circuit board for integrated revenue grade PV production metering (ANSI C12.20 +/- 0.5%) and consumption monitoring (+/- 2.5%). Includes Enphase Mobile Connect cellular modern (CELLMODEM-MT-06-SP-05), a plug-and-play industrial-grade cell modern for systems up to 60 microinverters. (Available in the US, Canada, Mexico, Puerto Rico, and the US Virgin Islands, where there is adequate cellular service in the installation area.) Includes a silver solar shield to match the IQ Battery and IQ System Controller, and to deflect he |
| ACCESSORIES AND REPLACEMENT PARTS | (not included, order separately) |
| Ensemble Communications Kit. COMMS-CELLMODEM-M1-06 CELLMODEM-M1-06-SP-05 CELLMODEM-M1-06-AT-05 | - Includes COMMS-KIT-01 and CELLMODEM-M1-06-SP-05 with 5-year Sprint data plan for Ensemble sites - 4G based LTE-M1 cellular modern with 5-year Sprint data plan - 4G based LTE-M1 cellular modern with 5-year AT&T data plan |
| Circuit Breakers BRK-10A-2-240V BRK-15A-2-240V BRK-20A-2P-240V BRK-15A-2P-240V-B BRK-20A-2P-240V-B | Supports Eaton BR210, BR215, BR220, BR230, BR240, BR250, and BR260 circuit breakers. Circuit breaker, 2 pole, 10A, Eaton BR210 Circuit breaker, 2 pole, 15A, Eaton BR215 Circuit breaker, 2 pole, 20A, Eaton BR220 Circuit breaker, 2 pole, 15A, Eaton BR215B with hold down kit support Circuit breaker, 2 pole, 20A, Eaton BR220B with hold down kit support |
| EPLC-01 | Power line carrier (communication bridge pair), quantity - one pair |
| XA-SOLARSHIELD-ES | Replacement solar shield for IQ Combiner 4/4C |
| XA-PLUG-120-3 | Accessory receptacle for Power Line Carrier in IQ Combiner 4/4C (required for EPLC-01) |
| XA-ENV-PCBA-3 | Replacement IQ Gateway printed circuit board (PCB) for Combiner 4/4C |
| X-IQ-NA-HD-125A | Hold down kit for Eaton circuit breaker with screws |
| ELECTRICAL SPECIFICATIONS | |
| Rating | Continuous duty |
| System voltage | 120/240 VAC, 60 Hz |
| Eaton BR series busbar rating | 125 Å |
| Max. continuous current rating | 65 A |
| Max. continuous current rating (input from PV/storage) | 64 A |
| Max. fuse/circuit rating (output) | 90 A |
| Branch circuits (solar and/or storage) | Up to four 2-pole Eaton BR series Distributed Generation (DG) breakers only (not included) |
| Max. total branch circuit breaker rating (input) Production metering CT | 80A of distributed generation / 95A with IQ Gateway breaker included 200 A solid core pre-installed and wired to IQ Gateway |
| Consumption monitoring CT (CT-200-SPLIT) | A pair of 200 A split core current transformers |
| MECHANICAL DATA | A pair of 200 A Spire core current nonstrainess |
| Dimensions (WxHxD) | 37.5 x 49.5 x 16.8 cm (14.75" x 19.5" x 6.63"). Height is 21.06" (53.5 cm) with mounting brackets. |
| Weight | 7.5 kg (16.5 lbs) |
| Ambient temperature range | -40° C to +46° C (-40° to 115° F) |
| Cooling | Natural convection, plus heat shield |
| Enclosure environmental rating | Outdoor, NRTL-certified, NEMA type 3R, polycarbonate construction |
| Wire sizes | 20 A to 50 A breaker inputs: 14 to 4 AWG copper conductors 60 A breaker branch input: 4 to 1/0 AWG copper conductors Main lug combined output: 10 to 2/0 AWG copper conductors Neutral and ground: 14 to 1/0 copper conductors Always follow local code réquirements for conductor sizing. |
| Altitude | To 2000 meters (6,560 feet) |
| INTERNET CONNECTION OPTIONS | |
| Integrated Wi-Fi | 802.11b/g/n |
| Cellular | CELLMODEM-M1-06-SP-05, CELLMODEM-M1-06-AT-05 (4G based LTE-M1 cellular modem). Note that an Enphase Mobile Connect cellular modem is required for all Ensemble installations. |
| Ethernet | Optional, 802.3, Cat5E (or Cat 6) UTP Ethernet cable (not included) |
| COMPLIANCE | |
| Compliance, IQ Combiner | UL 1741, CAN/CSA C22.2 No. 107.1, 47 CFR, Part 15, Class B, ICES 003 Production metering: ANSI C12.20 accuracy class 0.5 (PV production) Consumption metering: accuracy class 2.5 |
| Compliance, IQ Gateway | UL 60601-1/CANCSA 22.2 No. 61010-1 |

To learn more about Enphase offerings, visit enphase.com

© 2021 Enphase Energy, All rights reserved. Enphase, the Enphase logo, IQ Combiner 4/4C, and other names are trademarks of Enphase Energy, Inc. Data subject to change, 10-21-2021



3333 DIGITAL DR#600, LEHI, UT 84043, UNITED STATES PHONE: (855) 353-4899

Les flore

Electrical LIC#: U34871

SYSTEM INFO
(24) APTOS
DNA-120-MF10-440W
(24) ENPHASE
IQ8PLUS -72-2-US (240V)
DC SYSTEM SIZE: 10.56 kWDC
AC SYSTEM SIZE: 6.96 kWAC

| REVISIONS | | | |
|-------------|------|-----|--|
| DESCRIPTION | DATE | REV | |
| | | | |
| | | | |
| | | | |

Signature with Seal

PROJECT NAME & ADDRESS

KENNETH RICHARDS
RESIDENCE
221 BLUE CREEK SCHOOL RD,
JACKSONVILLE, NC 28540, USA

DATE: 6/7/2022

SHEET NAME

EQUIPMENT SPECIFICATION

ENPHASE

SHEET SIZE

ANSI B 11" X 17"

SHEET NUMBER

FLASHLOC™ DUO



THE MOST VERSATILE DIRECT TO DECK ATTACHMENT



FLASHLOC™ DUO is the most versatile direct to deck and rafter attachment for composition shingle and rolled comp roofs. The all-in-one mount installs fast — no kneeling on hot roofs to install flashing, no prying or cutting shingles, no pulling nails. Simply drive the required number of screws to secure the mount and inject sealant into the base, **FLASH**LOC's patented TRIPLE SEAL technology preserves the roof and protects the penetration with a permanent pressure seal. Kitted with two rafter screws, sealant and hardware for maximum convenience (deck screws sold separately). Don't just divert water, **LOC** it out!





PROTECT THE ROOF

Install a high-strength waterproof attachment without lifting, prying or damaging shingles.

APRIL2021_FLASHLOCDUO_V1



LOC OUT WATER

With an outer shield 1 contour-conforming gasket 2 and pressurized sealant chamber 3 the Triple Seal technology delivers a 100% waterproof connection.



HIGH-SPEED INSTALL

Simply drive the required number of screws and inject sealant into the port 4 to create a permanent pressure

FASTER INSTALLATION. 25-YEAR WARRANTY.

FOR QUESTIONS OR CUSTOMER SERVICE VISIT UNIRAC.COM OR CALL (505) 248-2702

FLASHLOC™ DUO

INSTALLATION GUIDE





PRE-INSTALL: CLEAN SURFACE AND MARK LOCATION

Ensure existing roof structure is capable of supporting loads prescribed in Flashloc Duo D&E Guide. Clean roof surface of dirt, debris, snow and ice.

Snap chalk lines for attachment rows. On shingle roofs, snap lines 1/4" below upslope edge of shingle coarse. This line will be used to align the upper edge of the mount.

NOTE: Space mounts per span charts found in Flashloc Duo D&E Guide.

STEP ONE: SECURE



ATTACHING TO SHEATHING: Place FLASHLOC DUO over desired location and align upper edge of mount with horizontal chalk line. Secure mount with the two (2) provided rafter screws. Next, secure mount with four (4) deck screws by drilling through the FLASHLOC DUO deck mount hole locations. Unirac recommends using a drill as opposed to an impact gun to prevent over-tightening or stripping roof sheathing.

IMPORTANT: SECURELY ATTACH MOUNT BUT DO NOT OVERTIGHTEN SCREWS.

STEP TWO: SEAL

Insert tip of UNIRAC approved sealant into port and inject until sealant exits vent. Continue array installation, attaching rails to mounts with provided T-bolts.

NOTE: When FLASHLOC DUO is installed over gap between shingle tabs or vertical joints, fill gap/joint with sealant between mount and upslope edge of shingle course.

CUT SHINGLES AS REQUIRED: DO NOT INSTALL THE FLASHLOC SLIDER ACCROSS THICKNESS VARIATIONS GREATER THAN 1/8" SUCH AS THOSE FOUND IN HIGH DEFINITION SHINGLES.

NOTE: When installing included rail attachment hardware, torque T-bolt nut to 30 ft-lbs. NOTE: If an exploratory hole falls outside of the area covered by the sealant, flash hole accordingly.

USE ONLY UNIRAC APPROVED SEALANTS. PLEASE CONTACT UNIRAC FOR FULL LIST OF COMPATIBLE SFALANTS.

FASTER INSTALLATION. 25-YEAR WARRANTY.

FOR QUESTIONS OR CUSTOMER SERVICE VISIT UNIRAC.COM OR CALL (505) 248-2702

ALGCY POWER

LGCY POWER 3333 DIGITAL DR#600, LEHI, UT 84043, UNITED STATES



| SYSTEMINFO |
|---|
| (24) APTOS DNA-120-MF10-440W |
| (24) ENPHASE IQ8PLUS -72-2-US (240V) |
| DC SYSTEM SIZE: 10.56 kWDC |
| AC SYSTEM SIZE: 6.96 kWAC |
| |

| REVISIONS | | | |
|-------------|------|-----|--|
| DESCRIPTION | DATE | REV | |
| | | | |
| | | | |
| | | | |

Signature with Seal

PROJECT NAME & ADDRESS

RD, USA PHONE NO. (254) 291-4657 EMAIL ID: karichards0311@gmail.com 221 BLUE CREEK SCHOOL JACKSONVILLE, NC 28540, KENNETH RICHARDS RESIDENCE

DATE: 6/7/2022


SHEET NAME

EQUIPMENT SPECIFICATION

SHEET SIZE

ANSI B 11" X 17"

SHEET NUMBER

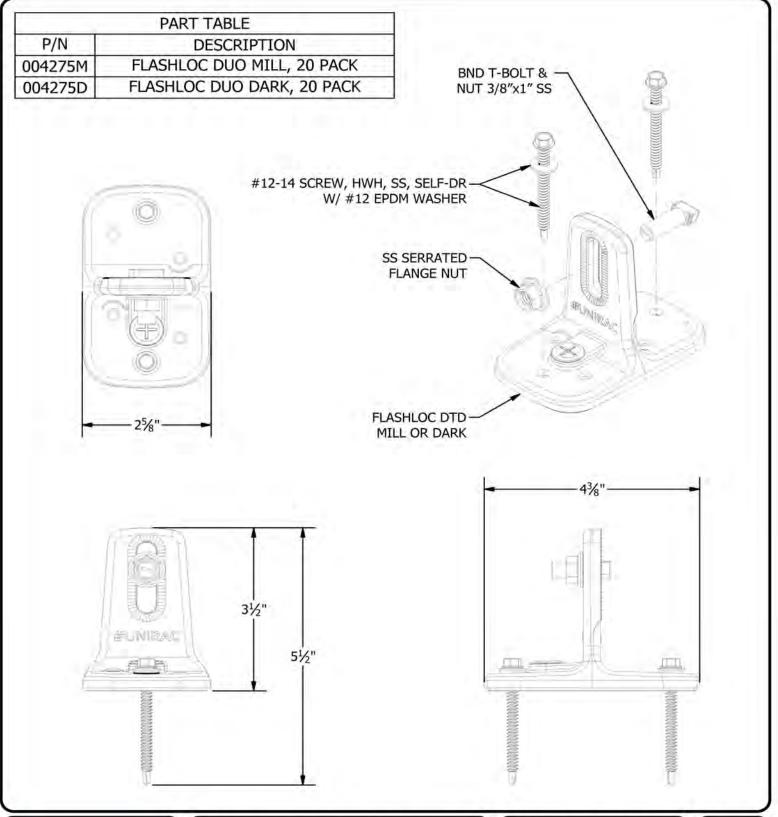



1411 BROADWAY BLVD. NE ALBUQUERQUE, NM 87102 USA PHONE: 505.242.6411 WWW.UNIRAC.COM PRODUCT LINE: SOLARMOUNT

DRAWING TYPE: ASSEMBLY DETAIL

DESCRIPTION: FLASHLOC DUO KIT

REVISION DATE: 4/29/2021

DRAWING NOT TO SCALE ALL DIMENSIONS ARE NOMINAL

PRODUCT PROTECTED BY
ONE OR MORE US PATENTS
LEGAL NOTICE

FL-A04

4 LGCY POWER

LGCY POWER

3333 DIGITAL DR#600, LEHI, UT 84043, UNITED STATES PHONE: (855) 353-4899



Electrical LIC#: U34871

SYSTEM INFO

(24) APTOS
DNA-120-MF10-440W

(24) ENPHASE
IQ8PLUS -72-2-US (240V)
DC SYSTEM SIZE: 10.56 kWDC
AC SYSTEM SIZE: 6.96 kWAC

| REVISIONS | | | |
|-------------|------|-----|--|
| DESCRIPTION | DATE | REV | |
| | | | |
| | | | |
| | | | |

Signature with Seal

PROJECT NAME & ADDRESS

KENNETH RICHARDS RESIDENCE 221 BLUE CREEK SCHOOL RD, JACKSONVILLE, NC 28540, USA PHONE NO. (254) 291-4657 EMAIL ID: karichards0311@gmail.com

DATE: 6/7/2022

SHEET NAME

EQUIPMENT SPECIFICATION

SHEET SIZE

ANSI B 11" X 17"

SHEET NUMBER

SOLARMOUNT



SOLARMOUNT defined the standard in solar racking. Features are designed to get installers off the roof faster. Our grounding & bonding process eliminates copper wire and grounding straps to reduce costs. Systems can be configured with standard or light rail to meet your design requirements at the lowest cost possible. The superior aesthetics package provides a streamlined clean edge for enhanced curb appeal, with no special brackets required for installation.









Light Rail is Fully Compatible with all SM Components



ENHANCED DESIGN & LAYOUT TOOLS

FAST INSTALLATION. SUPERIOR AESTHETICS

OPTIMIZED COMPONENTS . VERSATILITY . DESIGN TOOLS . QUALITY PROVIDER

SOLARMOUNT



OPTIMIZED COMPONENTS


INTEGRATED BONDING & PRE-ASSEMBLED PARTS

labor time. Our new grounding & bonding process eliminates copper wire and grounding straps or bonding jumpers to reduce costs. Utilize the microinverter mount with a wire management clip for an easier installation.

ONE PRODUCT - MANY APPLICATIONS

Quickly set modules flush to the roof or at a desired tilt angle. Change module orientation to portrait or landscape while securing a large variety of framed modules on flat, low slope or steep pitched roofs. Available in mill, clear and dark anodized finishes to outperform your projects financial and aesthetic aspirations

Save time by creating a user profile, and recall preferences and projects automatically when you log in. You will enjoy the ability to share projects with customers: there's no need to print results and send to a distributor, just click and share

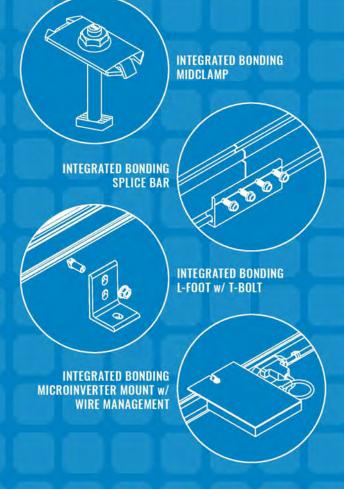



UNIRAC CUSTOMER SERVICE MEANS THE HIGHEST LEVEL OF PRODUCT SUPPORT



UNMATCHED EXPERIENCE

TECHNICAL SUPPORT







CERTIFIED QUALITY PROVIDER





BANKABLE WARRANTY

strength to back our products and reduce your risk. Have peace of mind knowing you are receiving products of exceptional

PROTECT YOUR REPUTATION WITH QUALITY RACKING SOLUTIONS BACKED BY ENGINEERING EXCELLENCE AND A SUPERIOR SUPPLY CHAIN

4 LGCY POWER

LGCY POWER

3333 DIGITAL DR#600. LEHI. UT 84043, UNITED STATES



SYSTEM INFO (24) ENPHASE IQ8PLUS -72-2-US (240V) DC SYSTEM SIZE: 10.56 kWDC AC SYSTEM SIZE: 6.96 kWAC

REVISIONS

Signature with Seal

PROJECT NAME & ADDRESS

221 BLUE CREEK SCHOOL RD, JACKSONVILLE, NC 28540, USA PHONE NO. (254) 291-4657 EMAIL ID: karichards0311@gmail.com KENNETH RICHARDS RESIDENCE

DATE: 6/7/2022

SHEET NAME

EQUIPMENT SPECIFICATION

SHEET SIZE

ANSIB 11" X 17'

SHEET NUMBER

SOLARMOUNT



SOLARMOUNT is the professionals' choice for residential PV mounting applications. Every aspect of the system is designed for an easier, faster installation experience. **SOLAR**MOUNT is a complete solution with revolutionary universal clamps, FLASHKIT PRO, full system UL 2703 certification and 25-year warranty. Not only is **SOLAR**MOUNT easy to install, but best-in-class aesthetics make it the most attractive on any block!





NOW FEATURING FLASHKIT PRO The Complete Roof Attachment Solution. FEATURING O SHED & SEAL TECHNOLOGY



NOW WITH UNIVERSAL MIDCLAMPS Accommodates 30mm-51mm module frames One tool, one-person installs are here!



REVOLUTIONARY NEW ENDCLAMPS Concealed design and included End Caps

THE PROFESSIONALS' CHOICE FOR RESIDENTIAL RACKING

BEST INSTALLATION EXPERIENCE • CURB APPEAL • COMPLETE SOLUTION • UNIRAC SUPPORT

FOR QUESTIONS OR CUSTOMER SERVICE VISIT UNIRAC.COM OR CALL (505) 248-2702

#UNIRAC

BETTER DESIGNS

TRUST THE INDUSTRY'S BEST DESIGN TOOL

Start the design process for every project in our U-Builder on-line design tool It's a great way to save time and money

BETTER SYSTEMS

ONE SYSTEM - MANY APPLICATIONS

Quickly set modules flush to the roof on steep pitched roofs. Orient a large variety of modules in Portrait or Landscape. Tilt the system up on flat or low slow roofs. Components available in mill, clear, and dark finishes to optimize your design financials

BETTER RESULTS

MAXIMIZE PROFITABILITY ON EVERY JOB

Trust Unirac to help you minimize both system and labor costs from the time the job is quoted to the time your teams get off the roof. Faster installs. Less Waste. More Profits.

BETTER SUPPORT

WORK WITH THE INDUSTRIES MOST EXPERIENCED TEAM

Professional support for professional installers and designers. You have access to our technical support and training groups. Whatever your support needs, we've got you covered. Visit Unirac.com/solarmount for more information



CONCEALED UNIVERSAL



UNIVERSAL SELF



UNIRAC CUSTOMER SERVICE MEANS THE HIGHEST LEVEL OF PRODUCT SUPPORT



UNMATCHED EXPERIENCE

TECHNICAL SUPPORT

Unirac's technical support team is dedicated to answering

questions & addressing issues in real time. An online

library of documents including engineering reports,

stamped letters and technical data sheets greatly

simplifies your permitting and project planning process.



ENGINEERING EXCELLENCE

CERTIFIED QUALITY PROVIDER

certifications for 9001:2008, 14001:2004 and OHSAS



DESIGN

PERMIT DOCUMENTATION

DATE: 6/7/2022

SHEET NAME

EQUIPMENT SPECIFICATION

4 LGCY POWER **LGCY POWER** 3333 DIGITAL DR#600. LEHI. UT 84043, UNITED STATES PHONE: (855) 353-4899

Electrical LIC#: U3487

SYSTEM INFO

(24) ENPHASE

DC SYSTEM SIZE: 10.56 kWDC

AC SYSTEM SIZE: 6.96 kWAC

REVISIONS

Signature with Seal

PROJECT NAME & ADDRESS

221 BLUE CREEK SCHOOL RD, JACKSONVILLE, NC 28540, USA

KENNETH RICHARDS RESIDENCE

PHONE NO. (254) 291-4657 EMAIL ID: karichards0311@gmail.com

DATE

DESCRIPTION

SHEET SIZE

ANSI B 11" X 17'

SHEET NUMBER

PV-16

SOLARMOUNT



STANDING MIDCLAMPS

U-BUILDER ONLINE DESIGN TOOL SAVES TIME & MONEY Visit design.unirac.com

Unirac is the only PV mounting vendor with ISO

18001:2007, which means we deliver the highest standards for fit, form, and function. These certifications demonstrate


BANKABLE WARRANTY

Don't leave your project to chance, Unirac has the financial strength to back our products and reduce your risk. Have peace of mind knowing you are providing products of exceptional quality. SOLARMOUNT is covered by a 25 year limited product warranty and a 5 year limited finish warranty.


ENHANCE YOUR REPUTATION WITH DUALITY RACKING SOLUTIONS BACKED BY ENGINEERING EXCELLENCE AND A SUPERIOR SUPPLY CHAIN PUBZONANICKI - PRINTEDUMPANE FOR QUESTIONS OR CUSTOMER SERVICE VISIT UNIRAC.COM OR CALL (505) 248-2702




APPENDIX C A UNIVERSAL AF ENDCLAMP INSTALLATION GUIDE PAGE

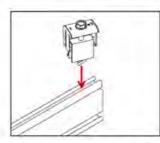


1. Position clamp to align T-bolt with rail slot. Lower clamp and Insert T-bolt into

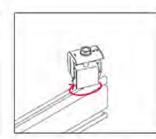


2. Rotate clamp clockwise 2/3 of a turn to engage T-bolt inside rail slot.

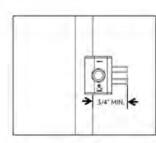


3. Place module at least 3/4" from end of rail and position clamp against module

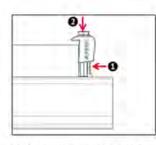


4. While applying pressure to hold the clamp against the module, push down on the module side of the clamp cap.

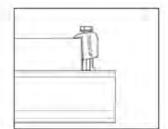

5. When the cap contacts the module frame, release and it will re-engage to the clamp base.

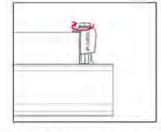

6. Tighten bolt and torque to 15 ft-lbs.

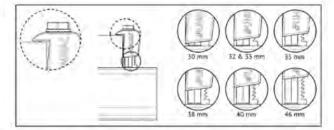

7. Confirm clamp is engaged in correct module height position and that the top of the

NOTE: When installing 46mm modules, loosen bolt by 1 turn before positioning clamp against module frame. Do not force clamp onto module frame as this may damage the bonding pin.



Module Fire Types

1 & 2

1, 2, 3 w metal frame, 10 w metal

frame, 19, 22, 25, 29, & 30

SYSTEM LEVEL FIRE CLASSIFICATION

Rail Type

Standard Rail

Light Rail

CODE COMPLIANCE NOTES PAGE

Mitigation

None Required

None Required

None Required

None Required

REVISIONS DESCRIPTION DATE

4 LGCY POWER **LGCY POWER** 3333 DIGITAL DR#600. LEHI. UT 84043, UNITED STATES PHONE: (855) 353-4899

Electrical LIC#: U34871

SYSTEM INFO (24) APTOS DNA-120-MF10-440W (24) ENPHASE IQ8PLUS -72-2-US (240V) DC SYSTEM SIZE: 10.56 kWDC AC SYSTEM SIZE: 6.96 kWAC

Signature with Seal

PROJECT NAME & ADDRESS

221 BLUE CREEK SCHOOL RD, JACKSONVILLE, NC 28540, USA PHONE NO. (254) 291-4657 EMAIL ID: karichards0311@gmail.com KENNETH RICHARDS RESIDENCE

This racking system may be used to ground end/or mount a PV module complying with UL1703 or UL61730 only When the specific or evaluated for grounding and/or mounting in compliance with the included instructions.

UL2703 CERTIFICATION MARKING LABEL Unirac SOLARMOUNT is listed to UL 2703. Certification marking is embossed on all mid clamps as shown. Labels with additional information will be provided. After the racking system is fully assembled, a single label should be applied to the SOLARMOUNT rail at the edge of the array. Before applying the label, the corners of the label that do not pertain to the system being installed must be removed so that only the installed system type is showing.

The system fire class rating requires installation in the manner specified in the SOLARMOUNT Installation Guide. SOLARMOUNT has been classified to the system level fire portion of UL2703. SOLARMOUNT has achieved system level performance for steep sloped roofs. System level fire performance is inherent in the

SOLARMOUNT design, and no additional mitigation measures are required. The fire classification rating is only valid on roof pitches greater than 2:12 (slopes > 2 inches per foot, or 9.5 degrees). The system is to be mounted over fire resistant roof covering rated for the application. There is no required minimum or maximum height limitation above the roof deck to maintain the system fire rating for SOLARMOUNT. Module Types & System Level Fire Ratings are listed below:

Class A, Class B & Class C East-West

Rail Direction

North-South

North-South

East-West

Module

Landscape OR Portrait

Landscape OR Portrait

Landscape OR Portrait

Landscape OR Portrait

System Level Fire Rating

Class A, Class B & Class C

Note: The sticker label should be placed such that it is visible, but not outward facing





DATE: 6/7/2022

SHEET NAME

EQUIPMENT SPECIFICATION


SHEET SIZE

ANSI B 11" X 17"

SHEET NUMBER



BONDING CONNECTION GROUND PATHS | DINSTALLATION GUIDE | PAGE

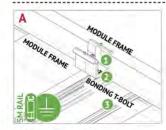


BONDING MIDCLAMP ASSEMBLY



BONDING MIDCLAMP ASSEMBLY

- Aluminum mid clamp with stainless steel bonding pins that pierce module frame anodization to bond module to module through clamp
- Serrated T-bolt head penetrates rail anodization to bond T-bolt, nut, clamp, and

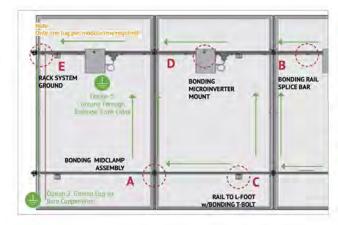



BONDING RAIL SPLICE BAR

- Bonding Hardware creates bond betw bar and each rail section
- Aluminum splice bar spans across rail gap to create rail to rail bond. Rail on at least one side of splice will be grounded.

tural. The splice bar function is rail



Serrated T-bolt head penetrates rail anodization to bond T-bolt, nut, and L-foot to grounded

RAIL TO L-FOOT w/BONDING T-BOLT Serrated flange nut removes L-foot and to bond L-Foot to stainless steel T-bolt



BONDING MICROINVERTER MOUNT

Hex nut with captive lock washer bonds metal microinverter flange to stainless steel T-bolt

ONDING O

Serrated T-bolt head penetrates rail anodization to bond T-bolt, nut, and L-foot to grounded SM rail Section ground including racking and



RACK SYSTEM GROUND

- WEEB washer dimples pierce anodized rail to create bond between rail and lug
- Solid copper wire connected to lug is routed to provide final system ground connection.

ENDCLAMP, FIRST MODULE INSTALLATION GUIDE PAGE

NOTE: To assist insertion of clamp into

For best appearance.

with ends of rails. Rails

Module must be fully

supported by rails and


should not extend more than 1/2" beyond module.

rail slot, Pressure may be applied to

top or side of bracket as shown. Do

not force clamp into rail by pushing

on bolt with excessive force.

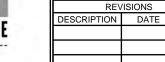

Signature with Seal

4 LGCY POWER **LGCY POWER** 3333 DIGITAL DR#600. LEHI. UT 84043, UNITED STATES PHONE: (855) 353-4899

Electrical LIC#: U34871

SYSTEM INFO (24) APTOS DNA-120-MF10-440W (24) ENPHASE IQ8PLUS -72-2-US (240V) DC SYSTEM SIZE: 10.56 kWDC AC SYSTEM SIZE: 6.96 kWAC

PROJECT NAME & ADDRESS

221 BLUE CREEK SCHOOL RD, JACKSONVILLE, NC 28540, USA PHONE NO. (254) 291-4657 EMAIL ID: karichards0311@gmail.com

KENNETH RICHARDS RESIDENCE

DATE: 6/7/2022

SHEET NAME

EQUIPMENT SPECIFICATION

SHEET SIZE

ANSI B 11" X 17"

SHEET NUMBER

PV-18



INSTALL MODULE END CLAMPS: The End

rails. The clamp should be installed on the

rails prior to installing end modules.

0

INSTALL FIRST MODULE:

of rails.

Install the first end module


onto rails with the flange of


the module frame positioned


between end clamps an ends


clamp is supplied as an assembly with a 1/2"


hex head bolt that is accessible at the ends of

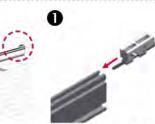


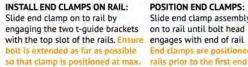

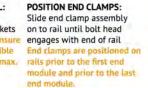


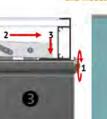


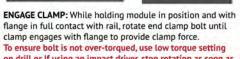

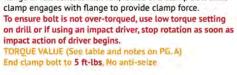



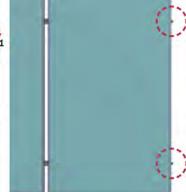


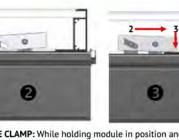

distance from end of rail.



STANDARD SYSTEM GROUNDING | K | PAGE

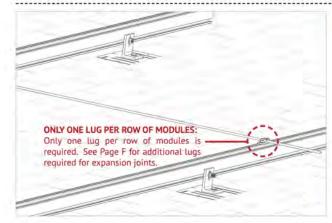

GROUNDING LUG MOUNTING DETAILS:

Details are provided for both the WEEB and Ilsco products. The WEEBLug has a grounding symbol located on the lug assembly. The Ilsco lug has a green colored set screw for grounding indication purposes. Installation must be in accordance with NFPA NEC 70, however the electrical designer of record should refer to the latest revision of NEC for actual grounding conductor cable size.

Required If not using approved Integrated grounding microinveters

| GROUNDING LUG - BOLT SIZE & DRILL SIZE | | | |
|--|-----------|---------------------------------|--|
| GROUND LUG | BOLT SIZE | DRILL SIZE | |
| WEEBLug | 1/4" | N/A - Place in Top SM Rail Slot | |
| ILSCO Lug | #10-32 | 7/32" | |

- Torque value depends on conductor size.
- See product data sheet for torque value.





WEEBLUG CONDUCTOR - UNIRAC P/N 008002S:

Apply Anti Seize and insert a bolt in the aluminum rail and through the clearance hole in the stainless steel flat washer. Place the stainless steel flat washer on the bolt, oriented so the dimples will contact the aluminum rail. Place the lug portion on the bolt and stainless steel flat washer. Install stainless steel flat washer, lock washer and nut. Tighten the nut until the dimples are completely embedded into the rail and lug. TORQUE VALUE 10 ft lbs. (See Note on P.G. A)

See product data sheet for more details, Model No. WEEB-LUG-6.7





ILSCO LAY-IN LUG CONDUCTOR - UNIRAC P/N 008009P: Alternate Grounding Lug - Drill, deburr hole and bolt thru both rail walls per table.


TORQUE VALUE 5 ft lbs. (See Note on PG, A)


See ILSCO product data sheet for more details, Model No. GBL-4DBT.


NOTE: ISOLATE COPPER FROM ALUMINUM CONTACT TO PREVENT CORROSION






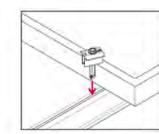

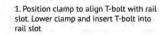


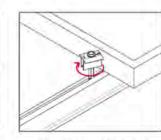


2. Rotate clamp clockwise 2/3 of a turn to engage T-bolt inside rail slot.

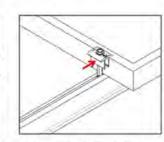


 Slide clamp into position against module.

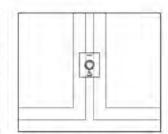

4. Place second module

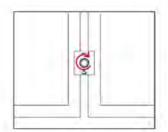

5. Tighten bolt and torque to 15 ft-lbs.

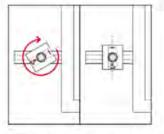

NOTE: If excessive force is applied in step 2, the cap may over-rotate causing it to be mis-aligned with the module frame. If this occurs, keep rotating the cap clockwise until it returns to the original position.

4 LGCY POWER

LGCY POWER

3333 DIGITAL DR#600, LEHI, UT 84043, UNITED STATES PHONE: (855) 353-4899



Electrical LIC#: U34871

SYSTEM INFO
(24) APTOS
DNA-120-MF10-440W
(24) ENPHASE
IQ8PLUS -72-2-US (240V)
DC SYSTEM SIZE: 10.56 kWDC
AC SYSTEM SIZE: 6.96 kWAC

| REVISIONS | | | |
|-------------|------|-----|--|
| DESCRIPTION | DATE | REV | |
| | | | |
| | | | |
| | | | |

Signature with Seal

PROJECT NAME & ADDRESS

KENNETH RICHARDS
RESIDENCE
221 BLUE CREEK SCHOOL RD,
JACKSONVILLE, NC 28540, USA
PHONE NO. (254) 291-4657
EMAIL ID: karichards0311@gmail.com

DATE: 6/7/2022

SHEET NAME

EQUIPMENT SPECIFICATION

SHEET SIZE

ANSI B 11" X 17"

SHEET NUMBER



October 3, 2019

UniRac 1411 Broadway Boulevard NE Albuquerque, New Mexico 87102-1545

TEL: (505) 242-6411 FAX: (505) 242-6412

Attn.: Unirac Engineering Department,

Re: Engineering Certification for UniRac's SolarMount Design & Engineering Guide

PZSE, Inc.-Structural Engineers has reviewed UniRac's "SolarMount Design & Engineering Guide" and specifically the enhancements of the SolarMount Flush-to-Roof System, Pressure Lookup Tables, and Downward & Upward Span Length Tables.

This certification excludes connections to building structures and the effects on building structure components. All information, data and analysis contained within the Installation Manual are based on, and comply with the following:

- 1. 2018 North Carolina Building Code, by The North Carolina State Building Code Council
- 2. 2009, 2012, 2012, & 2015 International Building Code, by International Code Council, Inc.
- 3. ASCE/SEI 7-05 & 7-10: Minimum Design Loads for Buildings and other Structures
- 4. 2010 & 2015 Aluminum Design Manual, by The Aluminum Association, 2015

This letter certifies that the structural calculations contained within UniRac's "SolarMount Design & Engineering Guide" are in compliance with the above Codes.

If you have any questions on the above, do not hesitate to call.

Prepared By: PZSE, Inc. - Structural Engineers Roseville, CA



4 LGCY POWER

LGCY POWER

3333 DIGITAL DR#600, LEHI, UT 84043, UNITED STATES

Electrical LIC#: U3487

SYSTEM INFO (24) ENPHASE IQ8PLUS -72-2-US (240V) AC SYSTEM SIZE: 6.96 kWAC

| - JI | | | |
|------|-------------|---------|-----|
| | REV | /ISIONS | |
| | DESCRIPTION | DATE | REV |
| | | | |
| | | | |
| Ш | | | |

Signature with Seal

PROJECT NAME & ADDRESS

221 BLUE CREEK SCHOOL RD, JACKSONVILLE, NC 28540, USA KENNETH RICHARDS RESIDENCE

DATE: 6/7/2022

SHEET NAME

EQUIPMENT SPECIFICATION

SHEET SIZE

ANSI B 11" X 17"

PV-20

SHEET NUMBER