

SHEET SCHEDULE

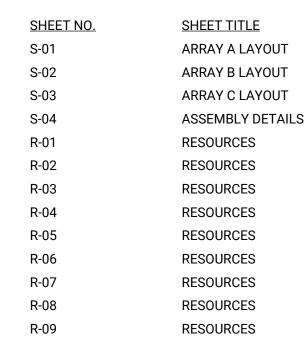

ADDAY O	METER LOCATION
ARRAY C	PHOTOVOLTAIC ARRAY A
	ESS EQUIPMENT IN GARAGE
	ARRAY B

01 SITE SKETCH G-01 SCALE: N/A

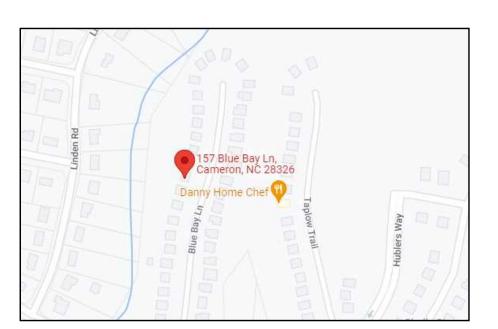

02 LOCATION MAP G-01 SCALE: N/A



PROJECT INFORMATION:

CONTRACTOR

NAME: CAPE FEAR SOLAR SYSTEMS, LLC

PHONE: (910) 409-5533

PROJECT MANAGER: ROBERT PARKER

PHONE: (910) 232-6288

AUTHORITIES HAVING JURISDICTION:

BUILDING: MOORE COUNTY
ZONING: MOORE COUNTY
ELECTRICAL: MOORE COUNTY

UTILITY: CEMC

APPLICABLE CODES & STANDARDS

BUILDING: IRC WITH NORTH CAROLINA AMENDMENTS 2018

ELECTRICAL: NEC 2017

FIRE: IFC WITH NORTH CAROLINA AMENDMENTS 2018, STATEWIDE UNIFORM REQUIREMENTS OF INSPECTION PROCEDURES FOR SOLAR PHOTOVOLTAIC SYSTEMS INSTALLED ON RESIDENTIAL

ROOFTOPS

STRUCTURAL REVIEW PROVIDED BY: RONALD P. BITTLER, PE RB ENGINEERING, INC. (C-2499) 168 QUADE DRIVE CARY, NC 27513 919-677-9662 PROJECT #RB-228151



901 Martin Street, Unit A Wilmington, NC 28401 910-409-5533



GC LIC. NO.: 65677 ELEC. LIC. NO.: U-33321

COVER

7.6KW PV SYSTEM RUFFIER RESIDENCE ' Blue Bay Ln, Cameron, NC 28326



57

	07.00.2022				
	REVIS	SION LIST A			
#	REV. DATE	DESC.			
	DATE:	July 6, 2022			
D	RAWN BY:	ZJP			


Sheet No.

G-01

STRUCTURAL NOTES

- 1. ROOF MOUNT RACKING SYSTEM & PV ARRAY TO BE INSTALLED IN STRICT ACCORDANCE WITH THESE DRAWINGS & MFG'S RECOMMENDATIONS. MINOR SPACING MODIFICATIONS ARE ACCEPTABLE TO ACCOMODATE EXISTING ROOF STRUCTURE MEMBERS
- 2. EXISTING ROOF STRUCTURE HAS BEEN INCLUDED IN THE STRUCTURAL EVALUATION AND FOUND SUITABLE FOR THIS INSTALLATION
- 3. ALL ATTACHMENT BOLTS SHALL BE INSTALLED IN THE MIDDLE THIRD OF THE RAFTER (OR TRUSS) THICKNESS

DESIGN SPECIFICATIONS
GROUND SNOW LOAD: 10 PSF
DESIGN WIND SPEED: 118 MPH (ASCE 7-10)
DESIGN EXPOSURE CATEGORY: B
DEAD LOAD: 2.4 PSF

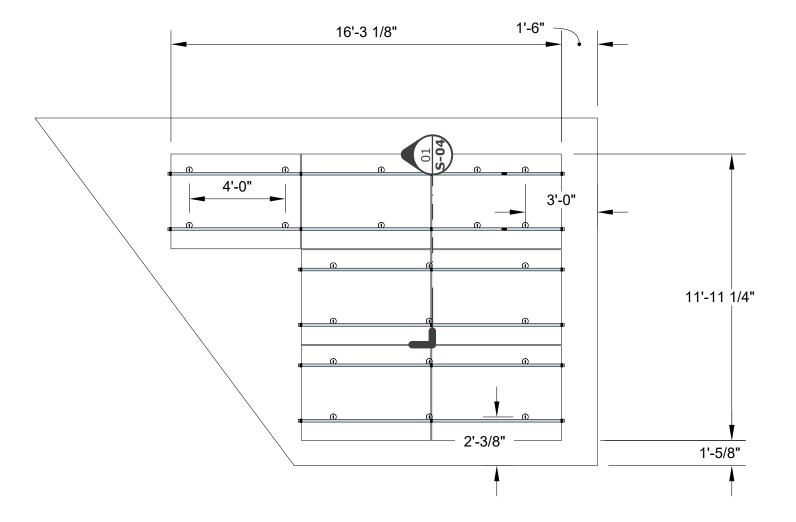



CAPE FEAR SOLAR SYSTEMS

901 Martin Street, Unit A Wilmington, NC 28401 910-409-5533



GC LIC. NO.: 65677

ELEC. LIC. NO.: U-33321

LAYOUT

7.6KW PV SYSTEM RUFFIER RESIDENCE 57 Blue Bay Ln, Cameron, NC 28326


157 Blue Bay Ln.
283.
ARRAY A

07.06.2022

	REVISION LIST A				
#	REV. DATE	DESC.			
	DATE:	July 6, 2022			
D	RAWN BY:	ZJP			

Sheet No.

S-01

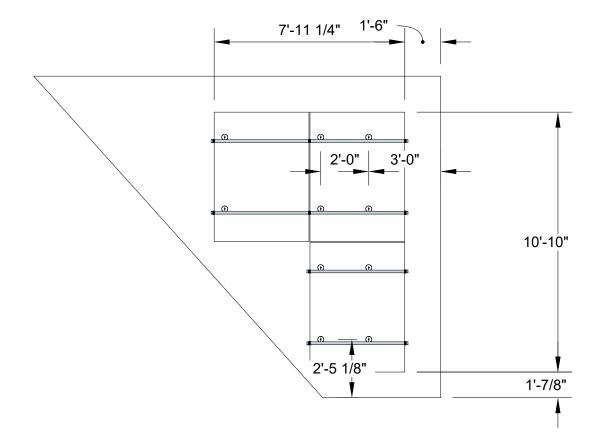



SOLAR SYSTEMS
901 Martin Street, Unit A
Wilmington, NC 28401
910-409-5533




GC LIC. NO.: 65677

ELEC. LIC. NO.: U-33321

157 Blue Bay Ln, Cameron, NC 28326 RUFFIER RESIDENCE 7.6KW PV SYSTEM


ARRAY B LAYOUT

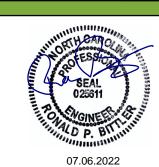

	REVIS	SION LIST A
#	REV. DATE	DESC.
	DATE:	July 6, 2022

DRAWN BY: Sheet No.

S-02

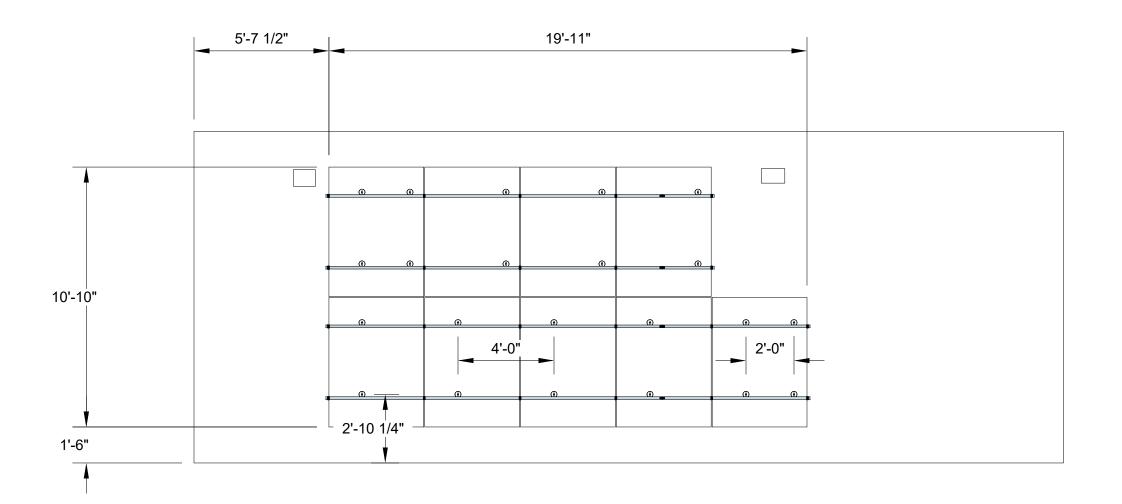



SOLAR SYSTEMS
901 Martin Street, Unit A
Wilmington, NC 28401
910-409-5533



GC LIC. NO.: 65677

ELEC. LIC. NO.: U-33321

ARRAY C LAYOUT

157 Blue Bay Ln, Cameron, NC 28326 RUFFIER RESIDENCE 7.6KW PV SYSTEM




	REVISION LIST \triangle				
#	REV. DATE	DESC.			
DATE:		July 6, 2022			
ח	RAWN BY	7.IP			

Sheet No.

S-03

01 PLAN - ARRAY C LAYOUT S-03 SCALE: 1/4" = 1'

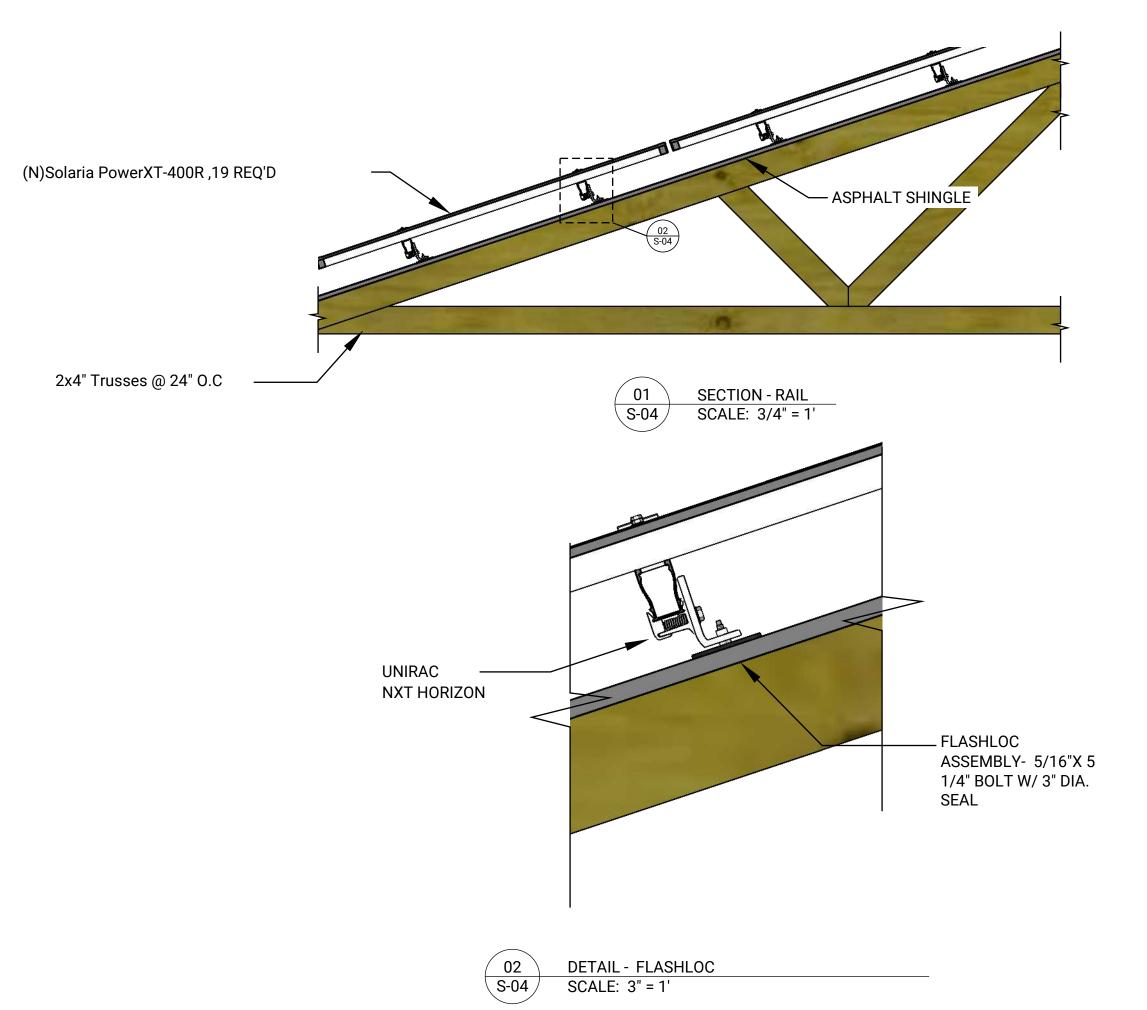




SOLAR SYSTEMS
901 Martin Street, Unit A
Wilmington, NC 28401
910-409-5533



GC LIC. NO.: 65677 ELEC. LIC. NO.: U-33321

ASSEMBLY DETAILS

157 Blue Bay Ln, Cameron, NC 28326 RUFFIER RESIDENCE 7.6KW PV SYSTEM

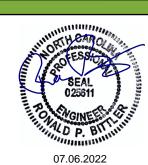

	REVIS	SION LIST	\wedge
#	REV. DATE	DESC.	
	DATE:	July 6, 20	22

DRAWN BY: Sheet No.

S-04





Achieving over 20% efficiency, Solaria PowerXT solar panels are one of the highest power panels in the residential and commercial solar market. Compared to conventional panels, Solaria PowerXT panels have fewer gaps between the solar cells; this leads to higher power and superior aesthetics. Solaria PowerXT Pure Black™ panels are manufactured with black backsheet and frames, enhancing a home or building's architectural beauty. Developed in the USA, Solaria's patented cell cutting creates a highly reliable PowerXT cell where busbars and ribbon interconnections, common failure points, are eliminated. Solaria's patented panel assembly then packages the cells into the PowerXT solar panel, reducing inactive space between the cells. This process leads to an exceptionally cost effective and efficient solar panel.

Higher Efficiency, Higher Power

Solaria PowerXT panels achieve over 20% efficiency; conventional panels achieve 15% – 17% efficiency. Solaria PowerXT panels are one of the highest power panels available.

Lower System Costs

Solaria PowerXT panels produce more power per square meter area. This reduces installation costs due to fewer balance of system components.

Improved Shading Tolerance

Sub-strings are interconnected in parallel, within each of the four panel quadrants, which dramatically lowers the shading losses and boosts energy yield.

Improved Aesthetics

Compared to conventional panels, Solaria PowerXT panels have a more uniform appearance and superior aesthetics.

Durability and Reliability

Solder-less cell interconnections are highly reliable and designed to far exceed the industry leading 25 year warranty.

About Solaria

Established in 2000, The Solaria Corporation has created one of the industry's most respected IP portfolios, with over 250 issued and pending patents encompassing materials, processes, applications, products, manufacturing automation and equipment. Headquartered in California, USA, Solaria has developed a technology platform that unlocks the potential of solar energy. Solaria panels are designed and engineered in USA. Country of Manufacture: China



The Solaria Corporation Level 7, 330 Collins Street Melbourne, Victoria 3000 Australia | www.solaria.com/australia | Copyright © 2021 The Solaria Corporation AUS-DAT-0004 Rev 04 5-2021 Product specifications are subject to change without notice.

Solaria PowerXT® | DC Panel SOLARIA®


PowerXT-		400R-PM
Max Power (Pmax)*	[W]	400
Efficiency	[%]	20.2
Open Circuit Voltage (Voc)*	[V]	51.68
Short Circuit Current (Isc)*	[A]	9.97
Max Power Voltage (Vmp)	[V]	43.08
Max Power Current (Imp)	[A]	9.28

* Measurement Tolerance Pmax +/-3%. Tolera nce Voc +/- 2%, Tolerance Isc +/- 4%


Performance at NOCT (800W/	m², 20°C Amb, Win	d 1 m/s, AM 1.5)
Max Power (Pmax)	[W]	294.2
Open Circuit Voltage (Voc)	[V]	47.73
Short Circuit Current (Isc)	[A]	8.05
Max Power Voltage (Vmp)	[V]	39.22
Max Power Current (Imp)	[A]	7.50
Temperature Characteristic:	S	
NOCT	[°C]	45 +/-2
T 0 ff f D	for / no1	0.00

Temp. Coeff. of Pmax	[% / °C]	-0.39
Temp. Coeff. of Voc	[%/°C]	-0.29
Temp. Coeff. of Isc	[% / °C]	0.04
Design Parameters		
Operating temperature	[90]	-40 to +85

[°C]	-40 to +85
[V]	1000
[A]	20
[#]	4
	[V] [A]

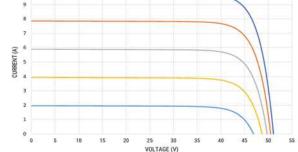



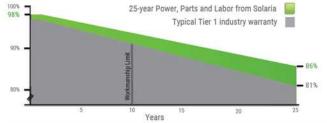

Monocrystalline Silicon Cell Type Dimensions (L x W x H) 1644mm x 1204mm x 40mm 64.7" x 47.4" x 1.6" 21 kg / 46 lbs Glass Type / Thickness AR Coated, Tempered / 2.8mm Black Anodised Aluminum Frame Type Cable Type / Length 12 AWG PV Wire (UL) / 1000mm Genuine MC4 Connector Type (Male: PV-KST4, Female: PV-KBT4) Junction Box IP68 / 4 diodes

PowerXT®-400R-PM

5400 Pa*

3600 Pa*

* Refer to Solaria Installation Manual for details

Front Load

Rear Load


Mechanical Characteristics

Certifications IEC 61215/61730 (Ed. 2016) Fire Class (UL 790) Safety Class IEC 61140, Class II Power, Parts & Labor 25 years*

* Warranty details at www.solaria.com/australia

Stacking Method Horizontal / Palletised Panels/ Pallet Pallet Dims (L x W x H) 67.7" x 49.6" x 49.1"

1720mm x 1260mm x 1246mm 575 kg / 1268 lbs Pallet Weight Pallets / 40-ft Container

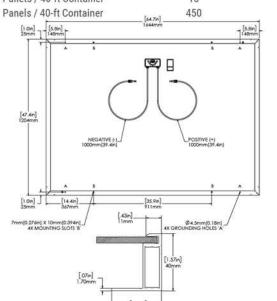

FRAME PROFILE

The Solaria Corporation Level 7, 330 Collins Street Melbourne, Victoria 3000 Australia | www.solaria.com/australia | Copyright @ 2021 The Solaria Corporation AUS-DAT-0004 Rev 04 5-2021 Product specifications are subject to change without notice.

CAPE FEAR SOLAR SYSTEMS

901 Martin Street, Unit A Wilmington, NC 28401 910-409-5533



GC LIC. NO.: 65677 ELEC. LIC. NO.: U-33321

ĬÚ

ESOURCI

/ Ln, Cameron, NC RUFFIER RESIDENCE **SYSTEM** 7.6KW PV Bay I Blue

SUNPOWER®

57

Elite Dealer

REVISION LIST \wedge # REV. DATE DESC. DATE: July 6, 2022

DRAWN BY: Sheet No.

R-01







IQ8 Series Microinverters

Our newest IQ8 Microinverters are the industry's first microgrid-forming, softwaredefined microinverters with split-phase power conversion capability to convert DC power to AC power efficiently. The brain of the semiconductor-based microinverter is our proprietary application-specific integrated circuit (ASIC) which enables the microinverter to operate in grid-tied or off-grid modes. This chip is built in advanced 55nm technology with high speed digital logic and has super-fast response times to changing loads and grid events, alleviating constraints on battery sizing for home energy systems.



Part of the Enphase Energy System, IQ8 Series Microinverters integrate with the Enphase IQ Battery. Enphase IQ Gateway, and the Enphase App monitoring and analysis software.



Connect PV modules quickly and easily to IQ8 Series Microinverters using the included Q-DCC-2 adapter cable with plug-n-play MC4 connectors.

IQ8 Series Microinverters are UL Listed as PV Rapid Shut Down Equipment and conform with various regulations, when installed according to

IQ8 Series Microinverters redefine reliability

leading limited warranty of up to 25 years.

standards with more than one million cumulative

hours of power-on testing, enabling an industry-

© 2022 Enphase Energy. All rights reserved. Enphase, the Enphase logo, IQ8 Microinverters, and other names are trademarks of Enphase Energy, Inc. Data subject to change.

IQ8SE-DS-0001-01-EN-US-2022-03-17

Easy to install

- · Lightweight and compact with plug-n-play connectors
- Power Line Communication (PLC) between components
- · Faster installation with simple two-wire cabling

High productivity and reliability

- · Produce power even when the grid is down*
- · More than one million cumulative hours of testing
- · Class II double-insulated enclosure
- · Optimized for the latest highpowered PV modules

Microgrid-forming

- · Complies with the latest advanced grid support**
- · Remote automatic updates for the latest grid requirements
- · Configurable to support a wide range of grid profiles
- Meets CA Rule 21 (UL 1741-SA) requirements

IQ8 Series Microinverters

INPUT DATA (DC)		108-60-2-US	108PLUS-72-2-US	108M-72-2-US	108A-72-2-US	108H-240-72-2-US	108H-208-72-2
Commonly used module pairings ²	W	235 - 350	235 - 440	260 - 460	295 - 500	320 - 540+	295 - 500
Module compatibility		60-cell/120 half-cell	6	60-cell/120 half-cell, 6	6-cell/132 half-cell a	and 72-cell/144 half-ce	ell
MPPT voltage range	٧	27 - 37	29 - 45	33 - 45	36 - 45	38 - 45	38 - 45
Operating range	٧	25 - 48			25 - 58		
Min/max start voltage	٧	30 / 48			30 / 58		
Max input DC voltage	v	50			60		
Max DC current ³ [module lsc]	А			15	5		
Overvoltage class DC port				ii ii			
DC port backfeed current	mA			0			
PV array configuration		1x1 Ungrounded a	rray; No additional D	C side protection requi	red; AC side protect	ion requires max 20A p	er branch circui
OUTPUT DATA (AC)		108-60-2-US	108PLUS-72-2-US	108M-72-2-US	108A-72-2-US	108H-240-72-2-US	108H-208-72-2
Peak output power	VA	245	300	330	366	384	366
Max continuous output power	VA	240	290	325	349	380	360
Nominal (L-L) voltage/range ⁴	٧			240 / 211 - 264			208 / 183 - 2
Max continuous output current	A	1.0	1.21	1.35	1.45	1.58	1.73
Nominal frequency	Hz			6	0		
Extended frequency range	Hz			50 -	- 68		
AC short circuit fault current over 3 cycles	Arms			2			4.4
Max units per 20 A (L-L) branch circuit ⁶		16	13	11	11	10	9
Total harmonic distortion				<5	%		
Overvoltage class AC port		Ш					
AC port backfeed current	mA	30					
Power factor setting		1.0					
Grid-tied power factor (adjustable)				0.85 leading -	0.85 lagging		
Peak efficiency	%	97.5	97.6	97.6	97.6	97.6	97.4
CEC weighted efficiency	%	97	97	97	97.5	97	97
Night-time power consumption	mW			6	0		
MECHANICAL DATA							
Ambient temperature range				-40°C to +60°C (-40°F to +140°F)		
Relative humidity range		4% to 100% (condensing)					
DC Connector type		MC4					
Dimensions (HxWxD)		212 mm (8.3") x 175 mm (6.9") x 30.2 mm (1.2")					
Weight		1.08 kg (2.38 lbs)					
Cooling		Natural convection - no fans					
Approved for wet locations		Yes					
Pollution degree		PD3					
Enclosure			Class II do	uble-insulated, corrosi	on resistant polymer	ic enclosure	
				NEMA Type	6 / outdoor		
Environ. category / UV exposure rating							

(1) The IQ8H-208 variant will be operating in grid-tied mode only at 208V AC. (2) No enforced DC/AC ratio. See the compatibility calculator at https://link.enphase.com/module-compatibility (3) Maximum continuous input DC current is 10.6A (4) Nominal voltage range can be extended beyond nominal if required by the utility. (5) Limits may vary. Refer to local requirements to define the number of microinverters per branch in your area.

IQ8SE-DS-0001-01-EN-US-2022-03-17

CAPE FEAR SOLAR SYSTEMS

901 Martin Street, Unit A Wilmington, NC 28401 910-409-5533



GC LIC. NO.: 65677 ELEC. LIC. NO.: U-33321

ŬĹ

ESOURCI

Bay Ln, Cameron, NC 28326 RUFFIER RESIDENCE 7.6KW PV SYSTEM Blue

57

SUNPOWER®

Elite Dealer

REVISION LIST \triangle # REV. DATE DESC. DATE: July 6, 2022 DRAWN BY: ZJP

Sheet No.

R-02

^{*} Only when installed with IQ System Controller 2, meets UL 1741. IQ8H-208V operates only in grid-tied mode.

^{**} IQ8 Series Microinverters supports split phase, 240V. IQ8H-208 supports split phase, 208V only.

Data Sheet **Enphase Networking**

Enphase IQ Combiner 4/4C

X-IQ-AM1-240-4 X-IQ-AM1-240-4C



To learn more about Enphase offerings, visit enphase.com

The Enphase IQ Combiner 4/4C with Enphase IQ Gateway and integrated LTE-M1 cell modem (included only with IQ Combiner 4C) consolidates interconnection equipment into a single enclosure and streamlines IQ microinverters and storage installations by providing a consistent, pre-wired solution for residential applications. It offers up to four 2-pole input circuits and Eaton BR series busbar assembly.

Smart

- · Includes IQ Gateway for communication and control
- · Includes Enphase Mobile Connect cellular modem (CELLMODEM-M1-06-SP-05), included only with IQ Combiner 4C
- · Includes solar shield to match Enphase IQ Battery aesthetics and deflect heat
- · Flexible networking supports Wi-Fi, Ethernet, or cellular
- · Optional AC receptacle available for PLC bridge
- · Provides production metering and consumption monitoring

Simple

- · Centered mounting brackets support single stud mounting
- · Supports bottom, back and side conduit entry
- Up to four 2-pole branch circuits for 240 VAC plug-in breakers (not included)
- · 80A total PV or storage branch circuits

Reliable

- · Durable NRTL-certified NEMA type 3R enclosure
- · Five-year limited warranty
- · Two years labor reimbursement program coverage included for both the IQ Combiner SKU's
- · UL listed

ENPHASE.

To learn more about Enphase offerings, visit enphase.com

© 2021 Enphase Energy, All rights reserved. Enphase, the Enphase logo, IQ Combiner 4/4C, and other names are trademarks of Enphase Energy, Inc. Data subject to change. 10-21-2021

Enphase IO Combiner 4/40

MODEL NUMBER	
IQ Combiner 4 (X-IQ-AM1-240-4)	IQ Combiner 4 with Enphase IQ Gateway printed circuit board for integrated revenue grade PV production metering (ANSI C12.20 +/- 0.5%) and consumption monitoring (+/- 2.5%). Includes a silver solar shield to match the IQ Battery system and IQ System Controller 2 and to deflect heat.
IQ Combiner 4C (X-IQ-AM1-240-4C)	IQ Combiner 4C with Enphase IQ Gateway printed circuit board for integrated revenue grade PV production metering (ANSI C12.20 +/-0.5%) and consumption monitoring (+/-2.5%). Includes Enphase Mobile Connect cellular modem (CELLMODEM-M1-06-SP-05), a plug-and-play industrial-grade cell modem for systems up to 60 microinverters. (Available in the US, Canada, Mexico, Puerto Rico, and the US Virgin Islands, where there is adequate cellular service in the installation area.) Includes a silver solar shield to match the IQ Battery and IQ System Controller and to deflect heat.
ACCESSORIES AND REPLACEMENT PARTS	(not included, order separately)
Ensemble Communications Kit COMMS-CELLMODEM-M1-06 CELLMODEM-M1-06-SP-05 CELLMODEM-M1-06-AT-05	 Includes COMMS-KIT-01 and CELLMODEM-M1-06-SP-05 with 5-year Sprint data plan for Ensemble sites 4G based LTE-M1 cellular modem with 5-year Sprint data plan 4G based LTE-M1 cellular modem with 5-year AT&T data plan
Circuit Breakers BRK-10A-2-240V BRK-15A-2-240V BRK-20A-2P-240V BRK-15A-2P-240V-B BRK-20A-2P-240V-B	Supports Eaton BR210, BR215, BR220, BR230, BR240, BR250, and BR260 circuit breakers. Circuit breaker, 2 pole, 10A, Eaton BR210 Circuit breaker, 2 pole, 15A, Eaton BR215 Circuit breaker, 2 pole, 20A, Eaton BR220 Circuit breaker, 2 pole, 15A, Eaton BR215B with hold down kit support Circuit breaker, 2 pole, 20A, Eaton BR220B with hold down kit support

EPLC-01 Power line carrier (communication bridge pair), quantity - one pair XA-SOLARSHIELD-ES Replacement solar shield for IQ Combiner 4/4C

XA-PLUG-120-3 Accessory receptacle for Power Line Carrier in IQ Combiner 4/4C (required for EPLC-01) XA-ENV-PCBA-3 Replacement IQ Gateway printed circuit board (PCB) for Combiner 4/4C

X-IQ-NA-HD-125A Hold down kit for Eaton circuit breaker with screws.

ELECTRICAL SPECIFICATIONS

Manager and the second		_
Rating	Continuous duty	
System voltage	120/240 VAC, 60 Hz	
Eaton BR series busbar rating	125 A	
Max. continuous current rating	65 A	
Max. continuous current rating (input from PV/storage)	64 A	
Max. fuse/circuit rating (output)	90 A	
Branch circuits (solar and/or storage)	Up to four 2-pole Eaton BR series Distributed Generation (DG) breakers only (not included)	
Max. total branch circuit breaker rating (input)	80A of distributed generation / 95A with IQ Gateway breaker included	
Production metering CT	200 A solid core pre-installed and wired to IQ Gateway	

A pair of 200 A split core current transformers

Consumption monitoring CT (CT-200-SPLIT)

MECHANICAL DATA	
Dimensions (WxHxD)	37.5 x 49.5 x 16.8 cm (14.75" x 19.5" x 6.63"). Height is 21.06" (53.5 cm) with mounting brackets.
Weight	7.5 kg (16.5 lbs)
Ambient temperature range	-40° C to +46° C (-40° to 115° F)
Cooling	Natural convection, plus heat shield
Enclosure environmental rating	Outdoor, NRTL-certified, NEMA type 3R, polycarbonate construction
Wire sizes	 20 A to 50 A breaker inputs: 14 to 4 AWG copper conductors 60 A breaker branch input: 4 to 1/0 AWG copper conductors Main lug combined output: 10 to 2/0 AWG copper conductors Neutral and ground: 14 to 1/0 copper conductors Always follow local code requirements for conductor sizing.

To 2000 meters (6,560 feet)

HALFWILL COMMEDITOR OF HO	10	
Integrated Wi-Fi	802.11b/g/n	
Cellular	CELLMODEM-M1-06-SP-05, CELLMODEM-M1-06-AT-05 (4G based LTE-M1 cellular modem). Note that ar Mobile Connect cellular modem is required for all Ensemble installations.	
Ethernet	Optional, 802.3, Cat5E (or Cat 6) UTP Ethernet cable (not included)	
COMPLIANCE		
Compliance, IQ Combiner	UL 1741, CAN/CSA C22.2 No. 107.1, 47 CFR, Part 15, Class B, ICES 003 Production metering: ANSI C12.20 accuracy class 0.5 (PV production)	

Consumption metering: accuracy class 2.5

UL 60601-1/CANCSA 22.2 No. 61010-1

ENPHASE.

CAPE FEAR SOLAR SYSTEMS

> 901 Martin Street, Unit A Wilmington, NC 28401 910-409-5533



GC LIC. NO.: 65677 ELEC. LIC. NO.: U-33321

ŬĹ

ESOURCI

Bay Ln, Cameron, NC 28326 RUFFIER RESIDENCE SYSTEM 7.6KW PV Blue 57

SUNPOWER®

Elite Dealer

REVISION LIST \triangle

REV. DATE DESC.

DATE: July 6, 2022 DRAWN BY: ZJP

Sheet No.

R-03

Compliance, IQ Gateway

Data Sheet Enphase IQ Battery System

Enphase IQ Battery 10

The Enphase IQ Battery 10 all-in-one AC-coupled storage system is reliable, smart, simple, and safe. It is comprised of three base IQ Battery 3 units, has a total usable energy capacity of 10.08 kWh and twelve embedded Grid-forming Microinverters with 3.84 kW power rating. It provides backup capability and installers can quickly design the right system size to meet the needs of both new and retrofit solar customers.



Reliable

- · Proven high reliability IQ Series Microinverters
- · Ten-year limited warranty
- · Three independent IQ Battery base units
- · Twelve embedded IQ8X-BAT Microinverters
- · Passive cooling (no moving parts/fans)

Smart

- · Grid-forming capability for backup operation
- · Remote software and firmware upgrade
- · Mobile app-based monitoring and control
- · Support for self consumption
- · Utility time of use (TOU) optimization

Simple

- Fully integrated AC battery system
- Quick and easy plug-and-play installation
- · Interconnects with standard household AC wiring

Safe

- · Cells safety tested
- Lithium iron phosphate (LFP) chemistry for maximum safety and longevity

ENPHASE.

Enphase IQ Battery 10

ENCHARGE-10-1P-NA	IQ Battery 10 system with integrated Enphase IQ Microinverters and battery management un (BMU). Includes: - Three IQ Battery 3.36 kWh base units (B03-A01-US00-1-3) - One IQ Battery 10 cover kit with cover, wall mounting bracket, watertight conduit hubs, and interconnect kit for wiring between batteries (B10-C-1050-0)
ACCESSORIES	AUG AUG
ENCHARGE-HNDL-R1	One set of IQ Battery base unit installation handles
OUTPUT (AC)	@ 240 VAC1
Rated (continuous) output power	3.84 kVA
Peak output power	5.7 kVA (10 seconds)
Nominal voltage / range	240 / 211 - 264 VAC
Nominal frequency / range	60 / 57 - 61 Hz
Rated output current	16 A
Peak output current	24.6A (10 seconds)
Power factor (adjustable)	0.85 leading 0.85 lagging
Maximum units per 20 A branch circuit	1 unit (single phase)
Interconnection	Single-phase
Maximum AC short circuit fault current over 3 cycles	69.6 Arms
Round trip efficiency²	89%
BATTERY	
Total capacity	10.5 kWh
Usable capacity	10.08 kWh
Round trip efficiency	96%
Nominal DC voltage	67.2 V
Maximum DC voltage	73.5 V
Ambient operating temperature range	-15° C to 55° C (5° F to 131° F) non-condensing
Optimum operating temperature range	0° C to 30° C (32° F to 86° F)
Chemistry	Lithium iron phosphate (LFP)
MECHANICAL DATA	
Dimensions (WxHxD)	1070 mm x 664 mm x 319 mm (42.13 in x 26.14 in x 12.56 in)
Weight	Three individual 44.2 kg (97.4 lbs) base units plus 21.1 kg (48.7 lbs) cover and mounting bracket; total 154.7 kg (341 lbs)
Enclosure	Outdoor – NEMA type 3R
IQ 8X-BAT Microinverter enclosure	NEMA type 6
Cooling	Natural convection - No fans
Altitude	Up to 2500 meters (8200 feet)
Mounting	Wall mount
FEATURES AND COMPLIANCE	
Compatibility	Compatible with grid-tied PV systems. Compatible with Enphase M215/M250 and IQ Series Micros, Enphase IQ System Controller, and Enphase IQ Gateway for backup operation.
Communication	Wireless 2.4 GHz
Services	Backup, self-consumption, TOU, Demand Charge, NEM Integrity
Monitoring	Enphase Installer Platform and Enphase App monitoring options; API integration
Compliance	UL 9540, UN 38.3, UL 9540A, UL 1998, UL 991, NEMA Type 3R, AC156 EMI: 47 CFR, Part 15, Class B, ICES 003 Cell Module: UL 1973, UN 38.3 Inverters: UL 62109-1, IEC 62109-2, UL 1741SA, CAN/CSA C22.2 No. 107.1-16, and IEEE 1547
LIMITED WARRANTY	
Limited Warranty ³	>70% capacity, up to 10 years or 4000 cycles

To learn more about Enphase offerings, visit enphase.com

© 2021 Enphase Energy, All rights reserved. Enphase, the Enphase logo, IQ Battery 10, and other trademarks or service names are the trademarks of Enphase Energy, Inc. Data subject to change. 10-27-2021



CAPE FEAR SOLAR SYSTEMS

901 Martin Street, Unit A Wilmington, NC 28401 910-409-5533



GC LIC. NO.: 65677 ELEC. LIC. NO.: U-33321

ESOURCES

7.6KW PV SYSTEM RUFFIER RESIDENCE 57 Blue Bay Ln, Cameron, NC 28326

SUNPOWER®

Elite Dealer

	REVISION LIST 🔥		
#	REV. DATE	DESC.	
DATE:		July 6, 2022	
DRAWN BY:		ZJP	

Sheet No.

R-04

To learn more about Enphase offerings, visit enphase.com

pe.eaton.com

Eaton general duty cartridge fuse safety switch

DG222NRB

UPC:782113144221

Dimensions:

Height: 14.37 INLength: 7.35 INWidth: 8.4 IN

Weight: 10 LB

Notes:Maximum hp ratings apply only when dual element fuses are used. 3-Phase hp rating shown is a grounded B phase rating, UL listed.

Warranties:

 Eaton Selling Policy 25-000, one (1) year from the date of installation of the Product or eighteen (18) months from the date of shipment of the Product, whichever occurs first.

Specifications:

- Type: General duty, cartridge fused
- Amperage Rating: 60A
- Enclosure: NEMA 3R
- Enclosure Material: Painted galvanized steel
- Fuse Class Provision: Class H fuses
- Fuse Configuration: Fusible with neutral
- Number Of Poles: Two-pole
- Number Of Wires: Three-wire
- Product Category: General duty safety switch
- Voltage Rating: 240V

Supporting documents:

- Eatons Volume 2-Commercial Distribution
- Eaton Specification Sheet DG222NRB

Certifications:

UL Listed

Product compliance: No Data



CAPE FEAR SOLAR SYSTEMS

901 Martin Street, Unit A Wilmington, NC 28401 910-409-5533



GC LIC. NO.: 65677 ELEC. LIC. NO.: U-33321

ESOURCES

7.6KW PV SYSTEM RUFFIER RESIDENCE 57 Blue Bay Ln, Cameron, NC 28326

SUNPOWER®

Elite Dealer

REVISION LIST \wedge			
#	REV. DATE	DESC.	
	DATE:	July 6, 2022	

DRAWN BY: Sheet No.

R-05

Data Sheet Enphase Energy System

Enphase IQ System Controller 2

The Enphase IQ System Controller 2 connects the home to grid power, the IQ Battery system, and solar PV. It provides microgrid interconnection device (MID) functionality by automatically detecting and seamlessly transitioning the home energy system from grid power to backup power in the event of a grid failure. It consolidates interconnection equipment into a single enclosure and streamlines grid independent capabilities of PV and storage installations by providing a consistent, pre-wired solution for residential applications.



Reliable

- · Durable NEMA type 3R enclosure
- · Ten-year limited warranty

Smart

- · Controls safe connectivity to the grid
- · Automatically detects grid outages
- · Provides seamless transition to backup

Simple

- Connects to the load or service equipment¹ side of the main load panel
- · Centered mounting brackets support single stud mounting
- Supports conduit entry from the bottom, bottom left side, and bottom right side
- Supports whole home and partial home backup and subpanel backup
- Up to 200A main breaker support
- Includes neutral-forming transformer for split phase 120/240V backup operation
- IQ System Controller supports backward compatibility with older generation of PV microinverters (M215, M250 and S series), making it simple for home owners to upgrade their
- Easy integration with generator from major manufacturers

1. IQ System Controller 2 is not suitable for use as service equipment in Canada.



Enphase IQ System Controller 2

EP200G101-M240US01	Enphase IQ System Controller 2 with neutral-forming transformer (NFT), Mic breakers, and screws. Streamlines grid-independent capabilities of PV and I	
ACCESSORIES and REPLACEMENT PARTS		AND DESCRIPTION OF THE PARTY OF
EP200G-NA-XA-E3	Replacement IQ System Controller 2 printed circuit board	
EP200G-NA-HD-200A	Eaton type BR circuit breaker hold-down screw kit, BRHDK125	
CT-200-SPLIT	200 A split core current transformers for Generator metering (+/- 2.5%)	
Circuit breakers (as needed) ^{2,5}	Not included, must order separately:	
 BRK-100A-2P-240V: Main breaker, 2 pole, 100A, 25kAIC, CSR2100 	BRK-20A-2P-240V-B: Circuit breaker, 2 pole, 20A, 10kAIC, BR220B	
BRK-125A-2P-240V: Main breaker, 2 pole, 125A, 25kAIC, CSR2125N	BRK-30A-2P-240V: Circuit breaker, 2 pole, 30A, 10kAIC, BR230B	
BRK-150A-2P-240V: Main breaker, 2 pole, 150A, 25kAIC, CSR2150N	BRK-40A-2P-240V: Circuit breaker, 2 pole, 40A, 10kAIC, BR240B	
BRK-175A-2P-240V: Main breaker, 2 pole, 175A, 25kAIC, CSR2175N	BRK-60A-2P-240V: Circuit breaker, 2 pole, 60A, 10kAIC, BR260	
• BRK-200A-2P-240V: Main breaker, 2 pole, 200A, 25kAIC, CSR2200N	BRK-80A-2P-240V: Circuit breaker, 2 pole, 80A, 10kAIC, BR280	
EP200G-HNDL-R1	IQ System Controller 2 Installation handle kit (order separately)	
EP200G-LITKIT	IQ System Controller 2 literature kit, including labels, feed-through headers	s, screws, filler plates, and QIG
BRK-20A40A-2P-240V	2 pole, 20A/40A, 10kAIC, BQC220240	
ELECTRICAL SPECIFICATIONS		
Assembly rating	Continuous operation at 100% of its rating	
Nominal voltage / range (L-L)	240 VAC / 100 - 310 VAC	
Voltage measurement accuracy	±1% V nominal (±1.2V L-N and ±2.4V L-L)	
Auxiliary contact for load control, excess PV control, and generator two-wire control	24V, 1A	
Nominal frequency / range	60 Hz / 56 - 63 Hz	
Frequency measurement accuracy	±0.1 Hz	
Maximum continuous current rating	160A	
Maximum input overcurrent protection device	200A	
Maximum output overcurrent protection device	200A	
Maximum overcurrent protection device rating for Generator circuit*	80A	
Maximum overcurrent protection device rating for storage branch circuit* (the storage branch circuit can be replaced with PV)	80A	
Maximum overcurrent protection device rating for IQ8 PV combiner branch circuit*	80A	
Neutral Forming Transformer (NFT)	Breaker rating (pre-installed): 40A between L1 and Neutral; 40A between L2 and Neutral Continuous rated power: 3600VA Maximum continuous unbalance current: 30A @ 120V Peak rated power: 8800VA for 30 seconds Peak unbalanced current; 80A @ 120V for 30 seconds	
MECHANICAL DATA		
Dimensions (WxHxD)	50cm x 91.6cm x 24.6cm (19.7 in x 36 in x 9.7 in)	
Weight	39.4 kg (87 lbs)	
Ambient temperature range	-40° C to +50° C (-40° F to 122° F)	
Cooling	Natural convection, plus heat shield	
Enclosure environmental rating	Outdoor, NEMA type 3R, polycarbonate construction	
Altitude	To 2500 meters (8200 feet)	
WIRE SIZES	an a	
Connections	Main lugs and backup load lugs	Cu/Al: 1 AWG - 300 KCMIL
(All lugs are rated to 90C)	CSR breaker bottom wiring lugs BR breakers (wire provided) AC combiner lugs, Encharge lugs, and generator lugs Neutral (large lugs)	Cu/Al: 2 AWG - 300 KCMIL 6 AWG 14 AWG - 2 AWG Cu/Al: 6 AWG - 300 KCMIL
Neutral and ground bars	Large holes (5/16-24 UNF) Small holes (10-32 UNF)	14 AWG - 1/0 AWG 14 AWG - 6 AWG
COMPLIANCE		
Compliance	UL 1741, UL 1741 SA, UL 1741 PCS, UL1998, UL869A*, UL67°, UL508°, UL508°, UL50E° CSA 22.2 No. 107.1, 47 CFR, Part 15, Clase B, ICES 003, AC156: IQ System Controller 2 is approved for Use as Service Equipment in the United States°.	

To learn more about Enphase offerings, visit **enphase.com**

Compatible with DKFIDE TO FORD THE RESEARCH STATE OF THE RESE

© 2021 Enphase Energy. All rights reserved. Enphase, the Enphase logo, IQ System Controller 2, and other names are the trademarks of Enphase Energy, Inc. Data subject to change. 10-20-2021



CAPE FEAR SOLAR SYSTEMS

901 Martin Street, Unit A Wilmington, NC 28401 910-409-5533



GC LIC. NO.: 65677 ELEC. LIC. NO.: U-33321

7.6KW PV SYSTEM
RUFFIER RESIDENCE
' Blue Bay Ln, Cameron, NC
28326

ESOURC



Elite Dealer

57

	REVISION LIST \wedge		
#	REV. DATE	DESC.	
DATE:		July 6, 2022	
DRAWN BY:		ZJP	

Sheet No.

R-06

To learn more about Enphase offerings, visit enphase.com

FLASH LOC



FLASHLOC is the ultimate attachment for composition shingle and rolled comp roofs. The all-in-one mount installs fast — no kneeling on hot roofs to install flashing, no prying or cutting shingles, no pulling nails. Simply drive the lag bolt and inject sealant into the base. FLASHLOC's patented TRIPLE SEAL technology preserves the roof and protects the penetration with a permanent pressure seal. Kitted with lag bolts, sealant, and hardware for maximum convenience. Don't just divert water, **LOC** it out!





PROTECT THE ROOF

Install a high-strength waterproof attachment without lifting, prying or damaging shingles.



LOC OUT WATER

and pressurized sealant chamber 3 the Triple-Loc Seal to create a permanent pressure seal. delivers a 100% waterproof connection.



HIGH-SPEED INSTALL

With an outer shield 1 contour-conforming gasket 2 Simply drive lag bolt and inject sealant into the port 4

FLASH LOC

INSTALLATION GUIDE





PRE-INSTALL

Snap chalk lines for attachment rows. On shingle roofs, snap lines 1-3/4" below upslope edge of shingle course. Locate rafters and mark attachment locations.

At each location, drill a 7/32" pilot hole. Clean roof surface of dirt, debris, snow, and ice, then fill pilot hole with sealant.

NOTE: Space mounts per racking system install specifications. When down pressure is ≥34 psf, span may not exceed 2 ft.



STEP 1: SECURE

Place FLASHLOC over pilot hole with lag on down-slope side. Align indicator marks on sides of mount with chalk line. Pass included lag bolt and sealing washer through FLASHLOC into pilot hole. Drive lag bolt until mount is held firmly in place.

NOTE: The EPDM in the sealing washer will expand beyond the edge of the metal washer when proper torque is applied.



Insert tip of UNIRAC provided sealant into port. Inject until sealant exits both vents.

Continue array installation, attaching rails to mounts with provided T-bolts.

NOTE: When FLASHLOC is installed over gap between shingle or tabs or vertical joints, fill gap/joint with sealant between mount and upslope edge of shingle course.

Use only provided sealant.

FASTER INSTALLATION. 25-YEAR WARRANTY.

FOR QUESTIONS OR CUSTOMER SERVICE VISIT UNIRAC.COM OR CALL (505) 248-2702

FASTER INSTALLATION. 25-YEAR WARRANTY.

FOR QUESTIONS OR CUSTOMER SERVICE VISIT UNIRAC.COM OR CALL (505) 248-2702

CAPE FEAR SOLAR SYSTEMS

901 Martin Street, Unit A Wilmington, NC 28401 910-409-5533



GC LIC. NO.: 65677 ELEC. LIC. NO.: U-33321

ESOURCES

Blue Bay Ln, Cameron, NC 28326 RUFFIER RESIDENCE 7.6KW PV SYSTEM 57

SUNPOWER®

Elite Dealer

REVISION LIST \triangle		
#	REV. DATE	DESC.
	DATE:	July 6, 2022
DRAWN BY:		ZJP

Sheet No.

R-07


HORIZON



DISCOVER YOUR NXT HORIZON'

The culmination of over two decades of experience. Thoughtful design, rigorous engineering, world-class support, and a reliable supply chain are the foundation of what makes us confident that NXT HORIZON* is the NXT Level of DESIGN, SIMPLICITY, and VALUE.



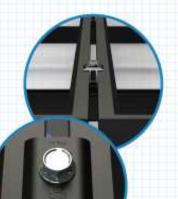

MILL: CCLAMPMI

1/2 Inch module spacing for efficiency.

mid and end clamps.

Untrac-quality bonding that works both as

Clicks into rail anywhere (even where there are cables() Self-standing clamp with spring combines as both mid and end clamp.



CAP KIT

ENDCAPD1

with the end cap let designed to complement the module and clamp and rail ends.



Make the install look clean

Blue Bay Ln, Cameron, NC 28326 RUFFIER RESIDENCE SYSTEM 7.6KW PV 57

SUNPOWER®

CAPE FEAR SOLAR SYSTEMS

901 Martin Street, Unit A

Wilmington, NC 28401

910-409-5533

GC LIC. NO.: 65677

ELEC. LIC. NO.: U-33321

ESOURCES


Elite Dealer

REVISION LIST \triangle # REV. DATE DESC.

DATE: July 6, 2022 ZJP DRAWN BY:

Sheet No.

R-08

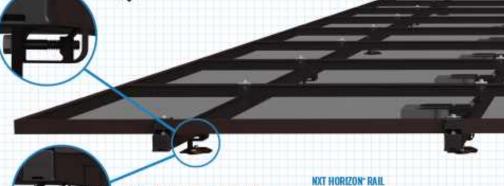

teatures: dick-in rail & open slot L-Foot for



MILL: 168RLM1

rail with invisible, easy, untailing and Integrated wire manager



Structural internal splice that does not interfere with roof connection nor module connection. Pre-assembled thread cutting bolts



NXT HORIZON' MLPE & LUG CLAMP

Works as either MLPE Mount or Grounding Lug connection to the rail. Why source two parts when one can do the job?



HXT HORIZON' WIRE MANAGEMENT CLIP

Aesthetic, yet functional accessory that works to help installers leep wires inside the rail. No zip-ties required. Optional zip tie loop for extra-



NXT HORIZON' NORTH/SOUTH WIRE

An elegant solution to help installers get to the home run. The same hardware works to provide both easy entry to rail and adjustability for cable



STRONGHOLD" ATTACHMENT KIT

DARK: SHCPKTD1

MILL: SHCPKTM1

drop-in rail clamp.






ALL NXT HORIZON* SYSTEMS INCLUDE A FREE PERMITTING PLANSET DESIGN - FOR QUESTIONS OR CUSTOMER SERVICE VISIT UNIRAC.COM OR EMAIL NXTPERMITS@UNIRAC.COM






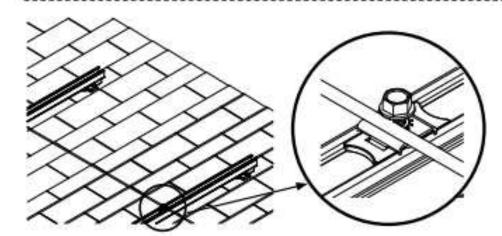

SYSTEM GROUNDING: Rails can be bonded using an NXT Horizon MLPE & Lug Clamp, GROUND WEEBLUG #1 or ILSCO LAY IN LUG (GBL4DBT). At least one rail per row of modules in an array must be bonded to electrical ground. Each additional row of modules must be grounded with at least one rail lug per row or with a row-to-row bonding devise listed here.


Note: See Page F for additional lugs required for expansion joints.

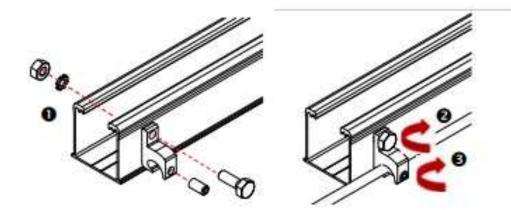

ALTERNATE SYSTEM GROUNDING WITH ILSCO LAY-IN LUG - UNIRAC P/N 008009P: Alternate Grounding Lug. Drill hole in rail 7/32" in diameter, deburr hole and bolt thru one wall of rail.


BOLT TORQUE VALUE: 5 ft lbs.
TERMINAL TORQUE: 4-6 AWG: 35in-lbs. 8 AWG: 25 in-lbs.

WARNING: ISOLATE COPPER FROM ALUMINUM CONTACT TO PREVENT CORROSION

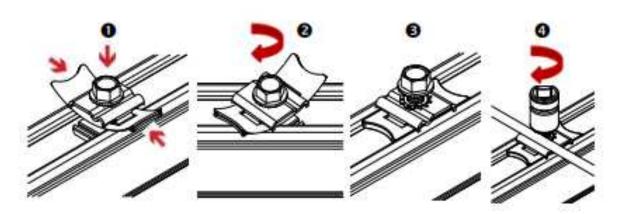

SYSTEM GROUNDING WITH MLPE & LUG CLAMP: Insert the rail nut profile in the opening by lifting the flaps of the plastic clip. Rotate the clamp 90 deg and release the flaps to get flush with rail. Ensure that the rail nut is engaged in the rail profile. Align the ground wire in the depression of the washer. Tighten bolt.


TORQUE VALUE: 6-8 AWG: 12 ft lbs.
CAUTION: MLPE & Lug Clamp cannot be used to simultaneously mount a MLPE and ground wire.

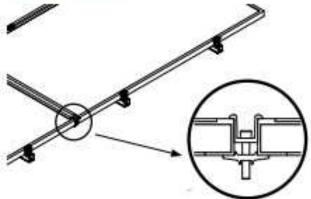

ALTERNATE ROW GROUNDING WITH NXT HORIZON ROW BONDING CLAMP:

Insert clamp between module rows and tighten bolt.

TORQUE VALUE: 20 ft-lbs

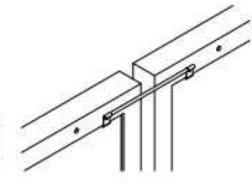

ALTERNATE ROW GROUNDING WITH N/S BONDING CLIP:

Fully seat bonding clip on each module flange to provide bond across N/S module gap.

CAPE FEAR

901 Martin Street, Unit A Wilmington, NC 28401 910-409-5533



GC LIC. NO.: 65677 ELEC. LIC. NO.: U-33321

ESOURCES

7.6KW PV SYSTEM RUFFIER RESIDENCE 57 Blue Bay Ln, Cameron, NC 28326

SUNPOWER®

Elite Dealer

	REVISION LIST \wedge		
#	REV. DATE	DESC.	
DATE:		July 6, 2022	
DRAWN BY:		ZJP	

Sheet No.

R-09